



Building Designers

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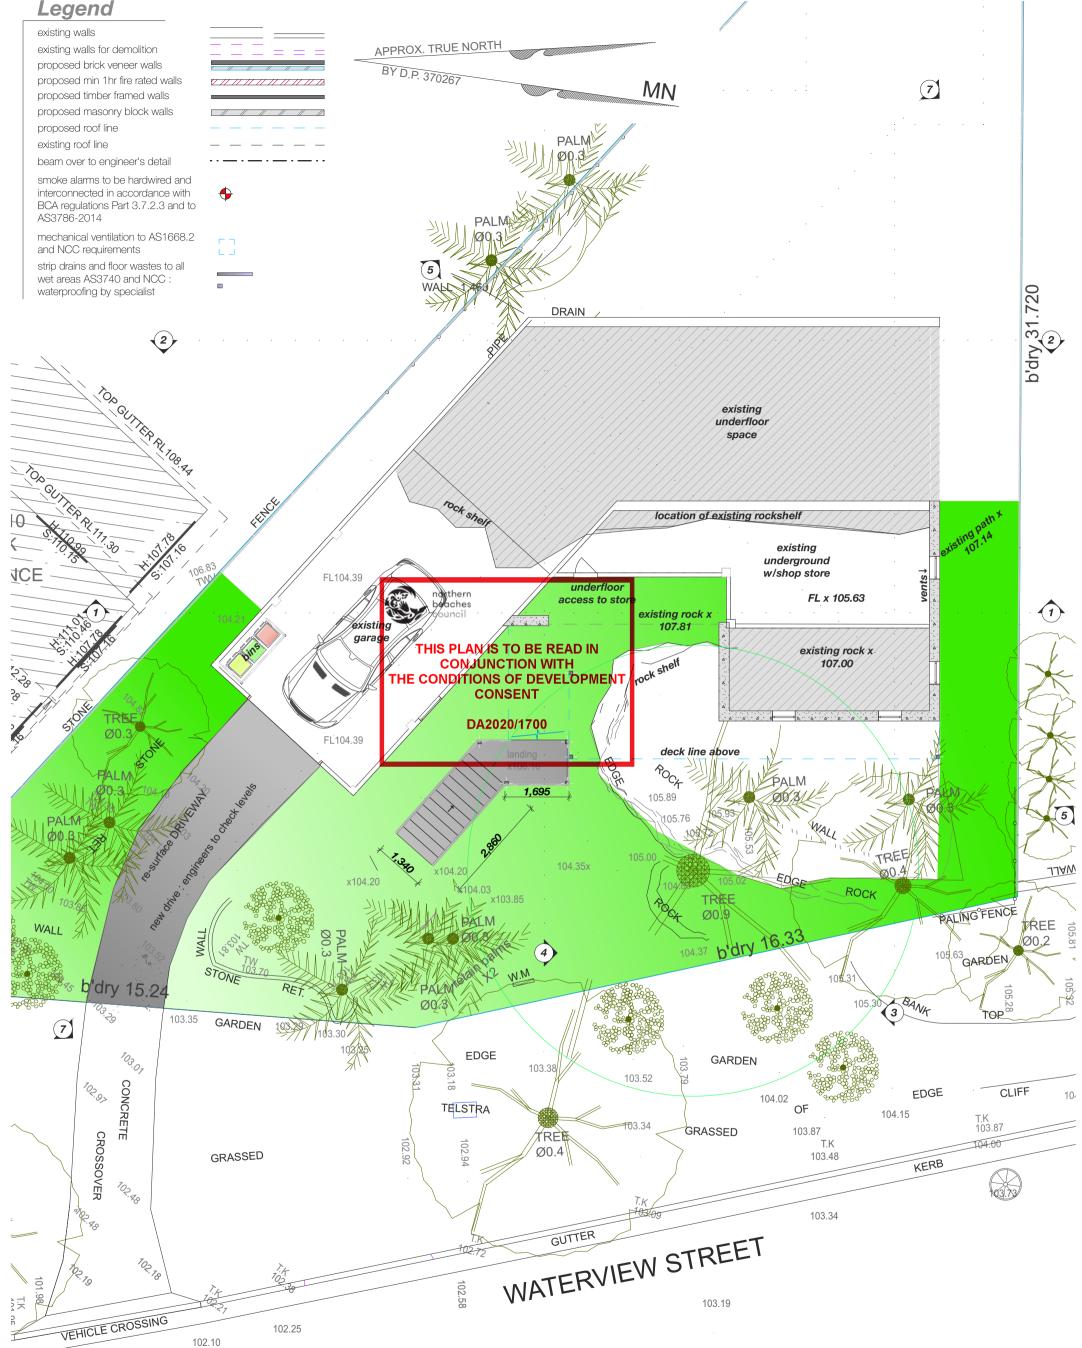
Alteratio		
12 W		
Sea		
Lo		
for Guy		
	revision	date

DA Issue

site, site analysis and location plan

Alterations and Additions 12 Waterview Street, Seaforth NSW 2092 Lot 3, DP 370267 for Guy and Sally Freebody

Date 16/12/20 Drawn DS Checked Scale Scale 1:200 @ A3 Drawing No. #250- 2



proposed sub-ground floor plan



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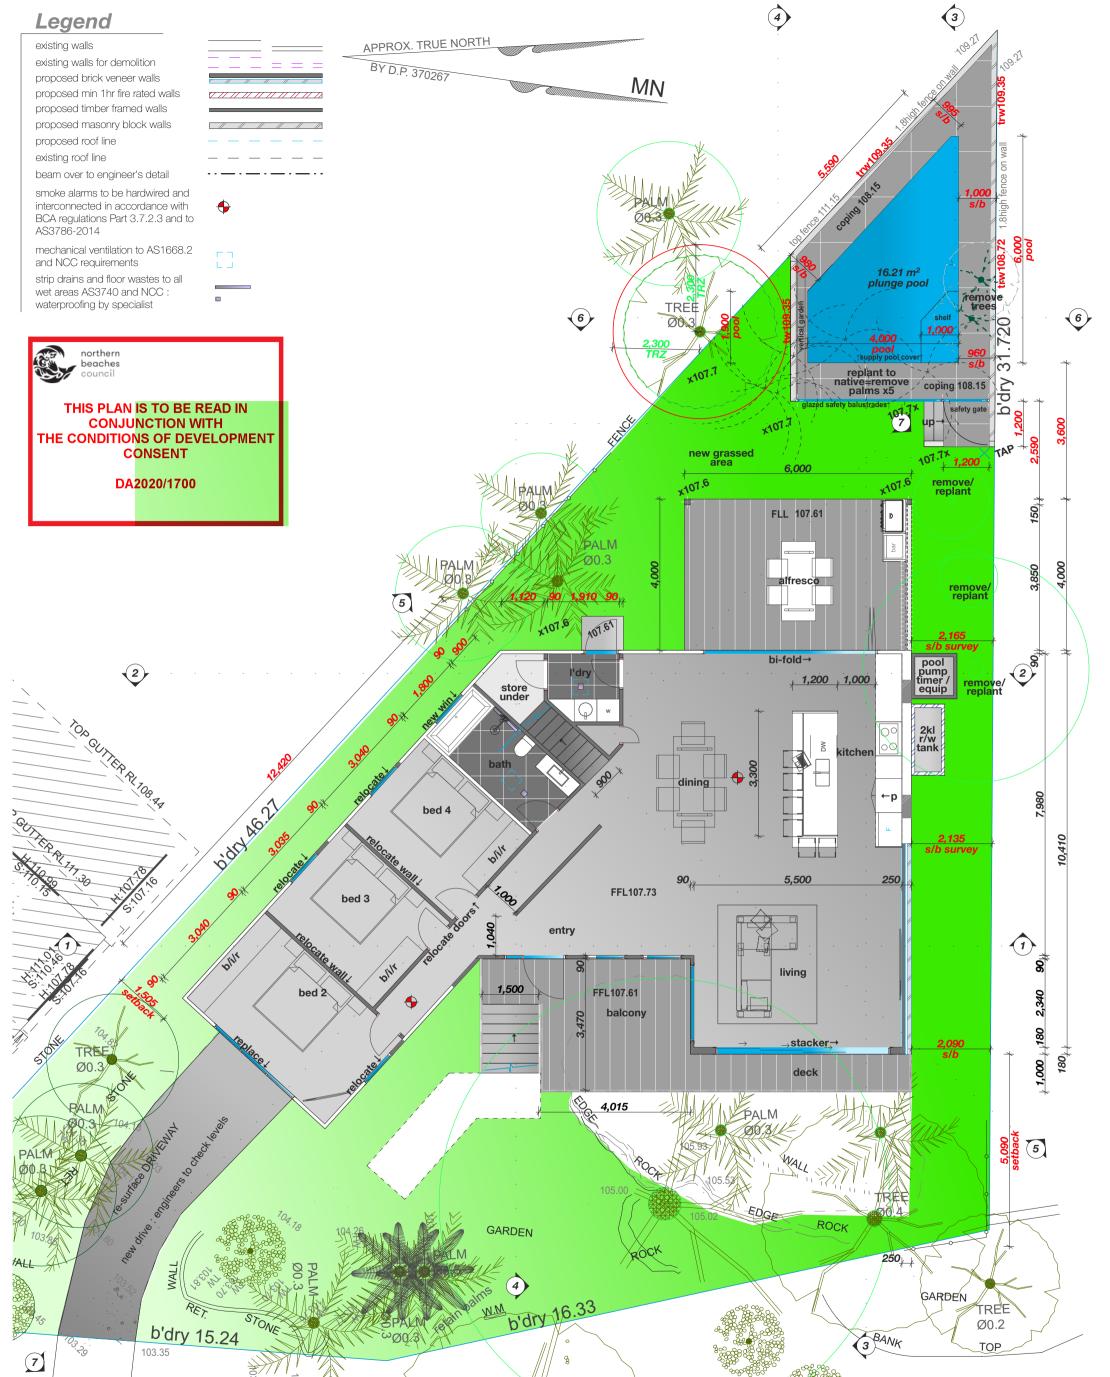
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date	v
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DA Issue

ations and Additions 2 Waterview Street, Seaforth NSW 2092 Lot 3, DP 370267 Guy and Sally Freebody

Date		16/12/20
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Scale		1:100 @ A3
Drawing No.		
#250-	5	



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proposed ground floor plan

by

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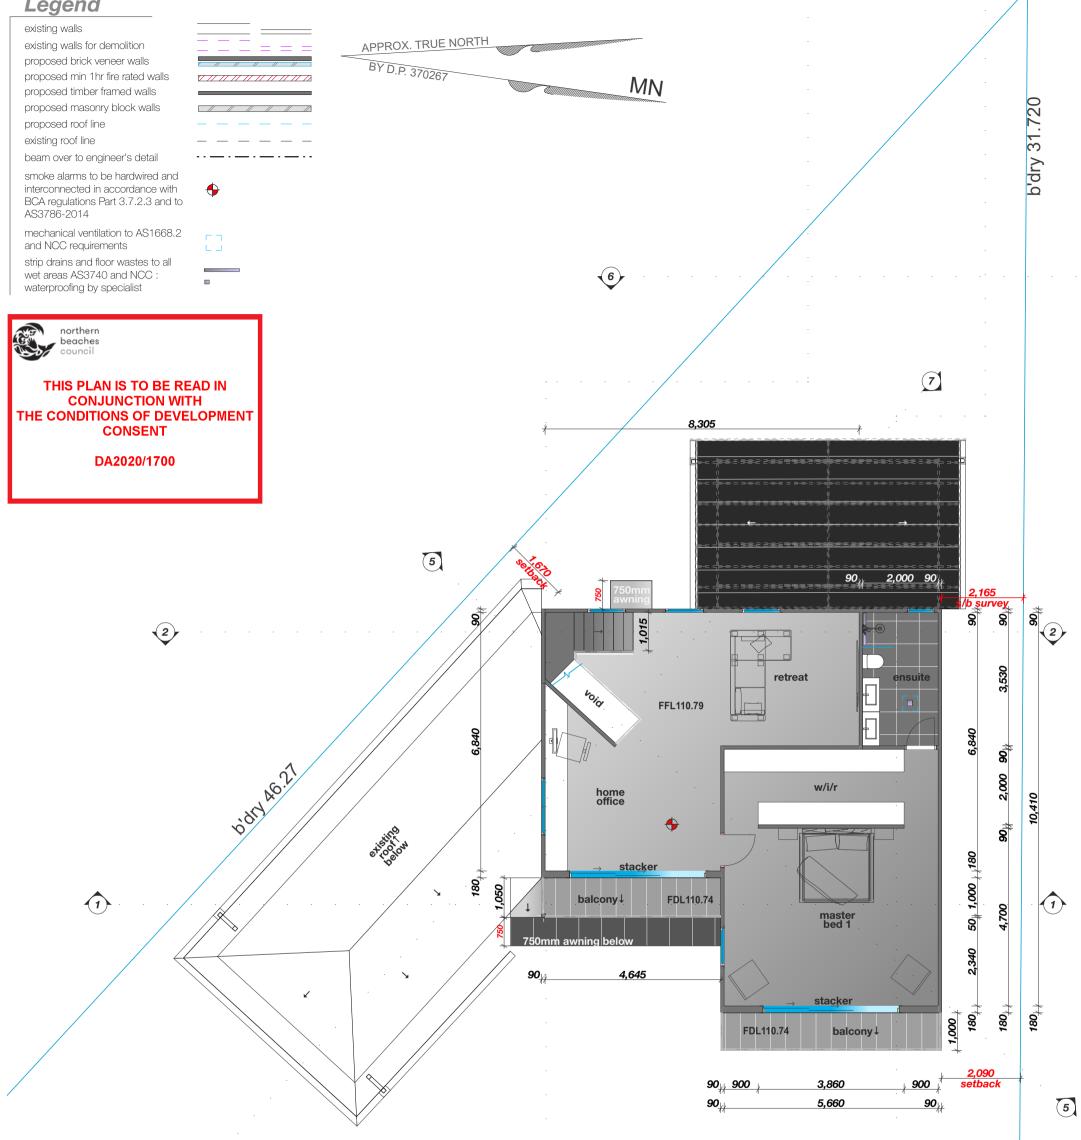
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DA Issue

ons and Additions Vaterview Street, forth NSW 2092 ot 3, DP 370267 and Sally Freebody

Date	16/12/20
Drawn	DS
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Scale	1:100 @ A3
Drawing No.	
#250-	6

Legend



proposed first floor plan

by

date

b'dry 16.33

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b'dry 15.24

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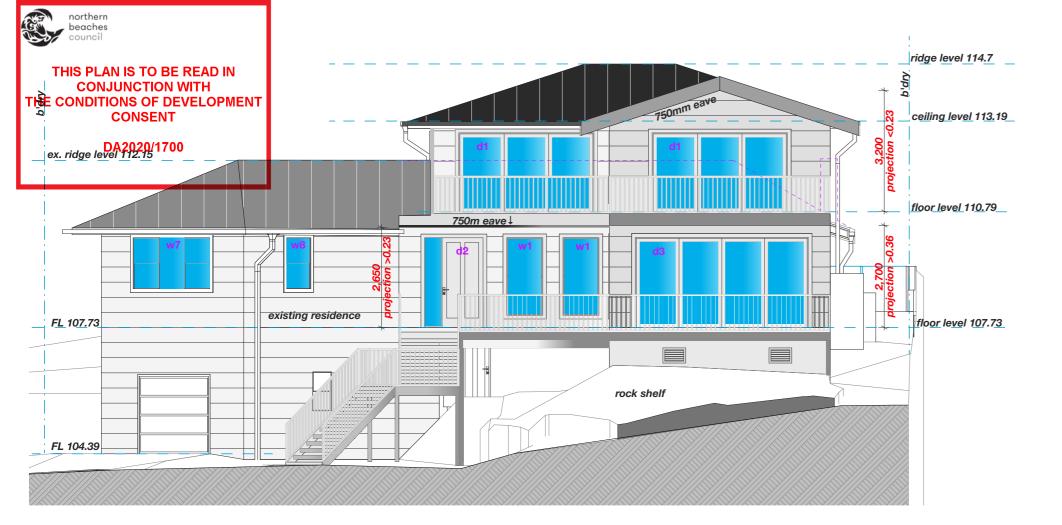
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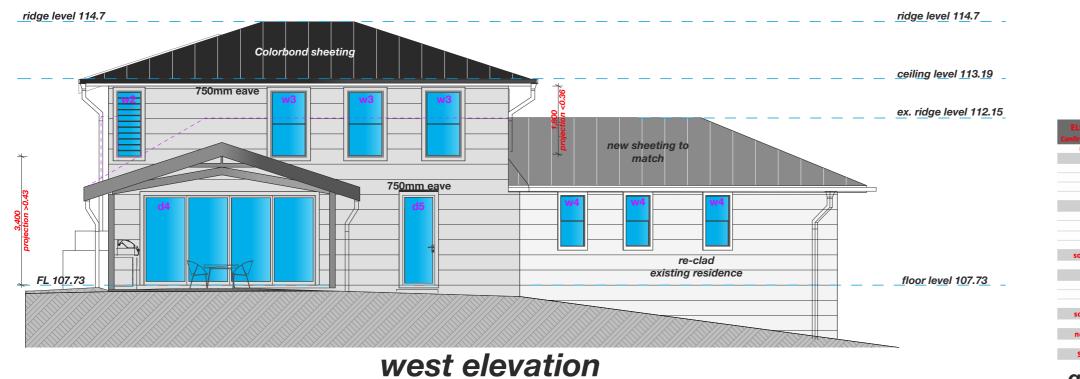
	DA Issue
	Alterations and Additions
	12 Waterview Street,
	Seaforth NSW 2092
	Lot 3, DP 370267
	for Guy and Sally Freebody
revision	

2/20
) @ A3

3



east elevation





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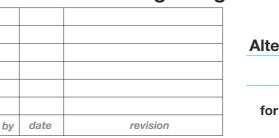
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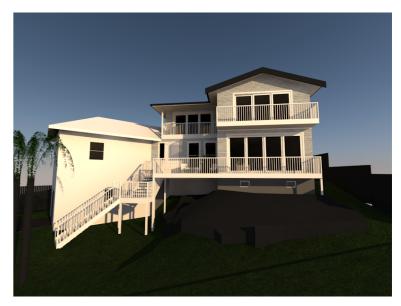
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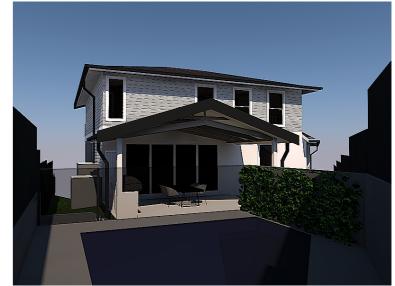
General Notes/ Spec: DISCLAIMER This Plan is intended for Council DA or Certifier Submission (CDC) only Builder and Contractors to check and ensure: - Boundary peg-out and registered survey is completed prior to concrete pour and other construction works, CHECK SETBACKS builder to mark boundaries prior to construction and setout, CONFIRM all dimensions on-site, PRIOR TO BUILDING WORKS Contact Precision Planning with any dimension queries. - Confirm Window/door/skylight sizes prior to order. No underground services search has been conducted. It is advised to do a 'Dial Before You Dig' before construction work commences.

Termite Protection: Termimesh/Kordon Blanket or similar termite protection system is to used in the

protection against subteranean termites in accordance with AS3660.1-2000 and to manufacturer's specifications.







d1

w2 w3

w4

w5 w6 w7 w8 w9

front perspective (concept only)

rear perspective (concept only)


_		-	-		
No.	Width	Height	Sill	Head	Area m2 (BASIX)
Total				AutoCalculates	AutoCalculates
1	1800	500	1600	2100	0.900
2	3600	2100	0	2100	15.120
1	1600	2400	0	2400	3.840
2	1000	2100	300	2400	4.200
1	4600	2400	0	2400	11.040
1	700	1800	300	2100	1.260
3	1000	1800	300	2100	5.400
1	4600	2400	0	2400	11.040
1	900	2400	0	2400	2.160
3	1000	1400	1000	2400	4.200
1	1500	700	1400	2100	1.050
1	1000	1800	300	2100	1.800
1	2000	2100	300	2400	4.200
1	2800	1400	1000	2400	3.920
1	1000	1400	1000	2400	1.400

glazing schedule - builder to confirm sizes prior to order

DA Issue

Alterations and Additions 12 Waterview Street, Seaforth NSW 2092 Lot 3, DP 370267 for Guy and Sally Freebody


Date		16/12/20
Drawn		DS
Checked		
Scale		1:100 @ A3
Drawing No.		
#250-	8	

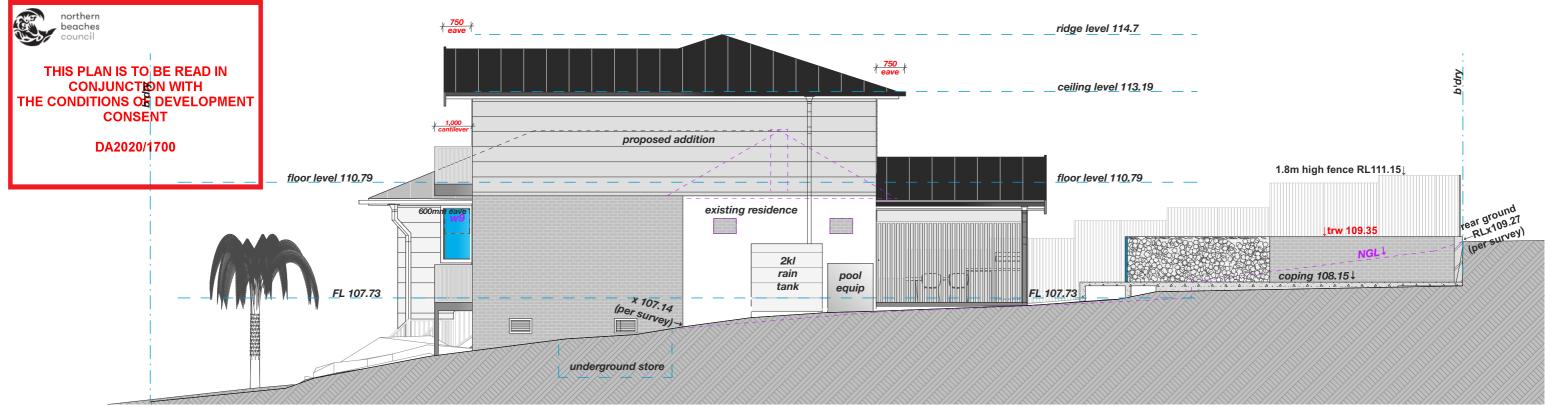

north elevation

ELEVATION	Win. Num.	No.	Width	Height	Sill	Head	Area m2 (BASIX
onfirm Orientation	Tag	Total				AutoCalculates	AutoCalculates
Elevation	W0	1	1800	500	1600	2100	0.900
east							
	d1	2	3600	2100	0	2100	15.120
	d2	1	1600	2400	0	2400	3.840
	w1	2	1000	2100	300	2400	4.200
	d3	1	4600	2400	0	2400	11.040
west							
	w2	1	700	1800	300	2100	1.260
	w3	3	1000	1800	300	2100	5.400
	d4	1	4600	2400	0	2400	11.040
	d5	1	900	2400	0	2400	2.160
south-west							
	w4	3	1000	1400	1000	2400	4.200
south							
	w5	1	1500	700	1400	2100	1.050
	w6	1	1000	1800	300	2100	1.800
	w7	1	2000	2100	300	2400	4.200
south-east							
	w8	1	2800	1400	1000	2400	3.920
north-east							
	w9	1	1000	1400	1000	2400	1.400
Skylights	N/A						

glazing schedule -builder to confirm sizes prior to order

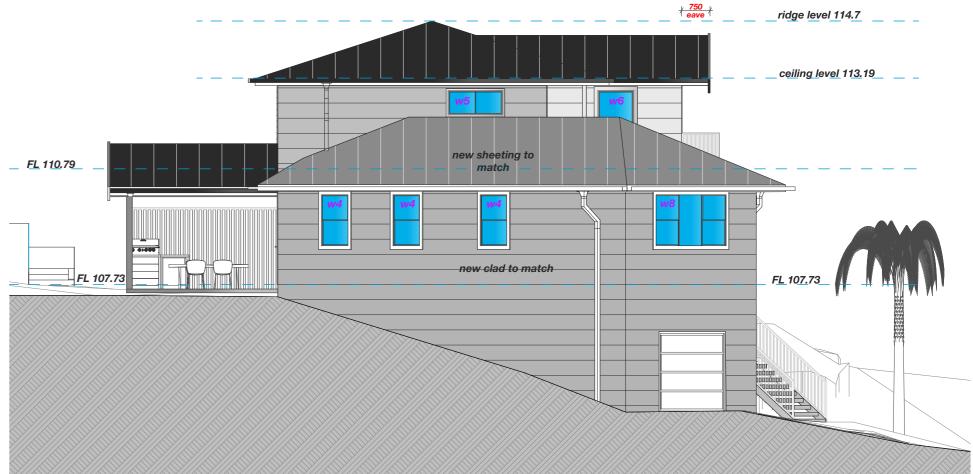

south elevation



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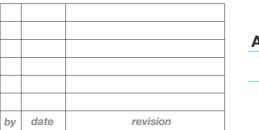
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Contact Precision Planning with any dimension queries. - Confirm Window/door/skylight sizes prior to order.

- No underground services search has been conducted.

It is advised to do a 'Dial Before You Dig' before construction work commences. Termite Protection:


Termimesh/Kordon Blanket or similar termite protection system is to used in the protection against subteranean termites in accordance with AS3660.1-2000 and to manufacturer's specifications.




12 Waterview Street, Seaforth NSW 2092 Lot 3, DP 370267 for Guy and Sally Freebody

Alterations and Additions

Date	16/12/20	
Drawn	DS	
Checked		
Scale	1:100 @ A3	
Drawing No.		
#250-	9	

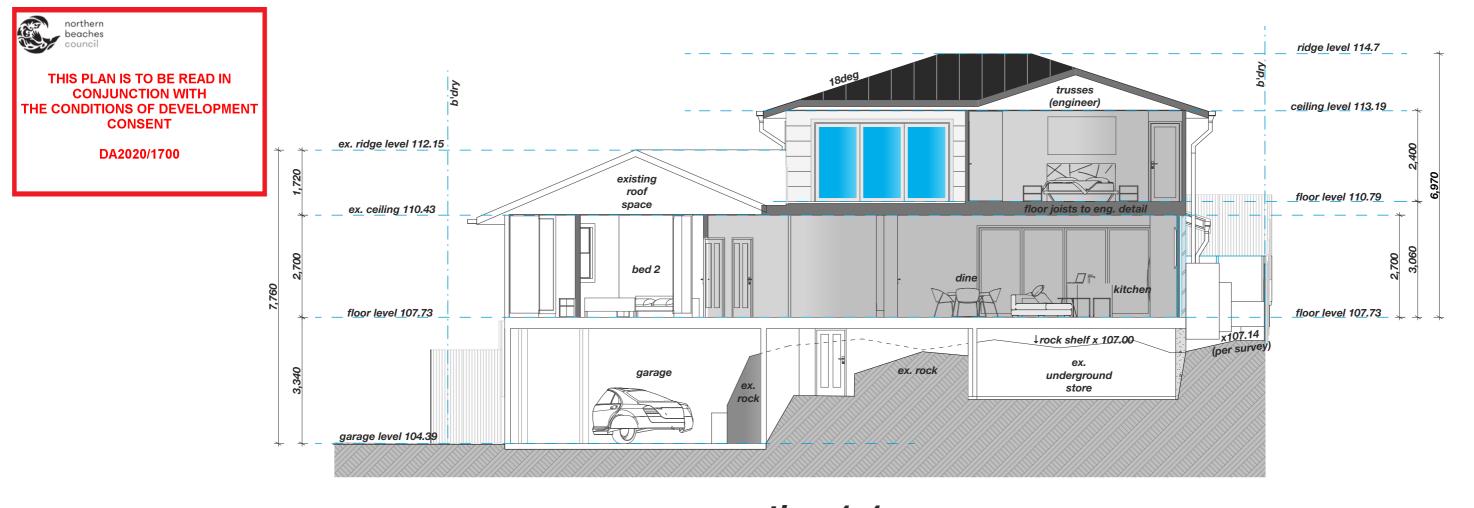

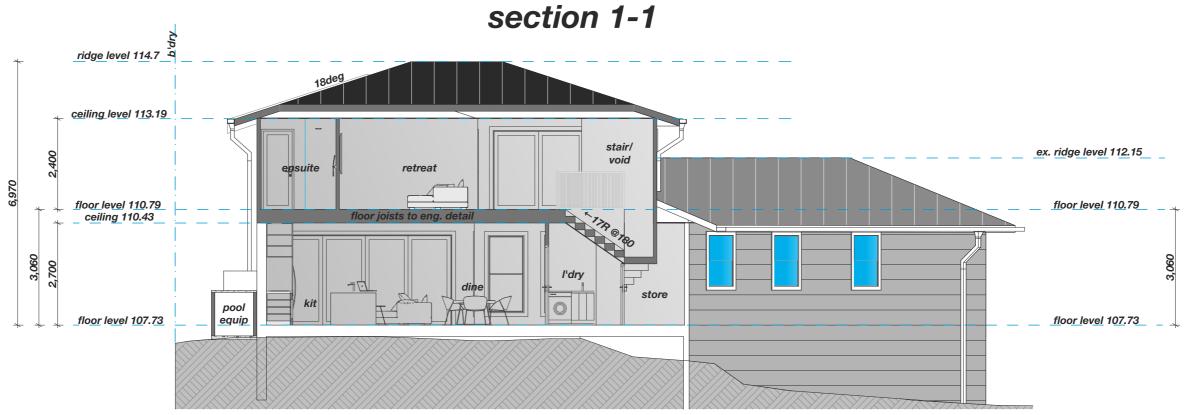

section 2-2



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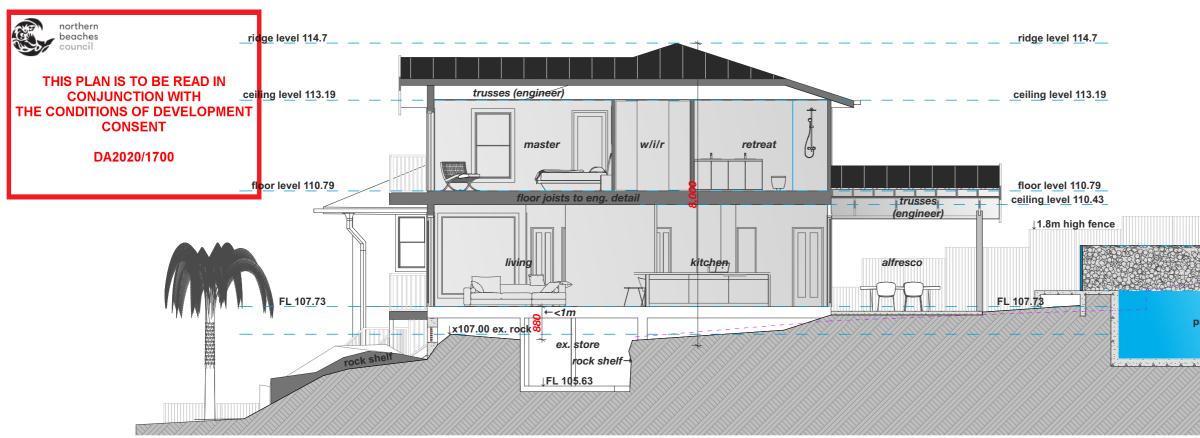
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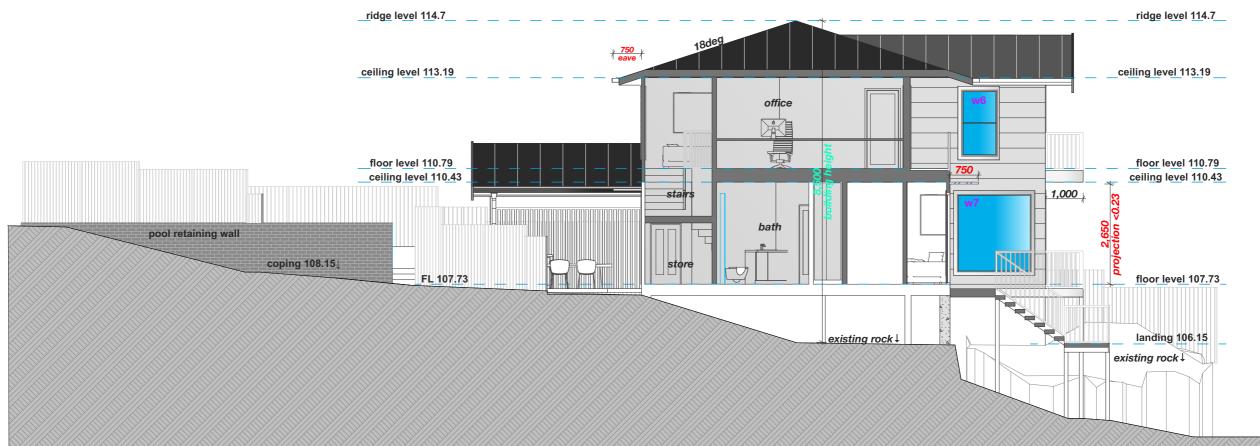


Alterations and Additions 12 Waterview Street, Seaforth NSW 2092 Lot 3, DP 370267 for Guy and Sally Freebody

Date	16/12/20
Drawn	DS
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Scale	1:100 @ A3
Drawing No.	
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section 3-3



section 4-4



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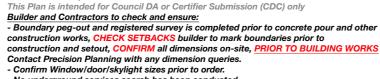
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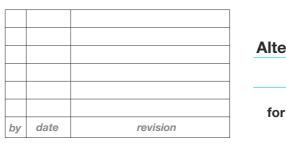
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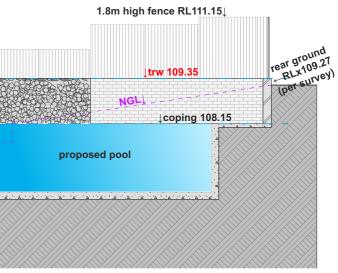


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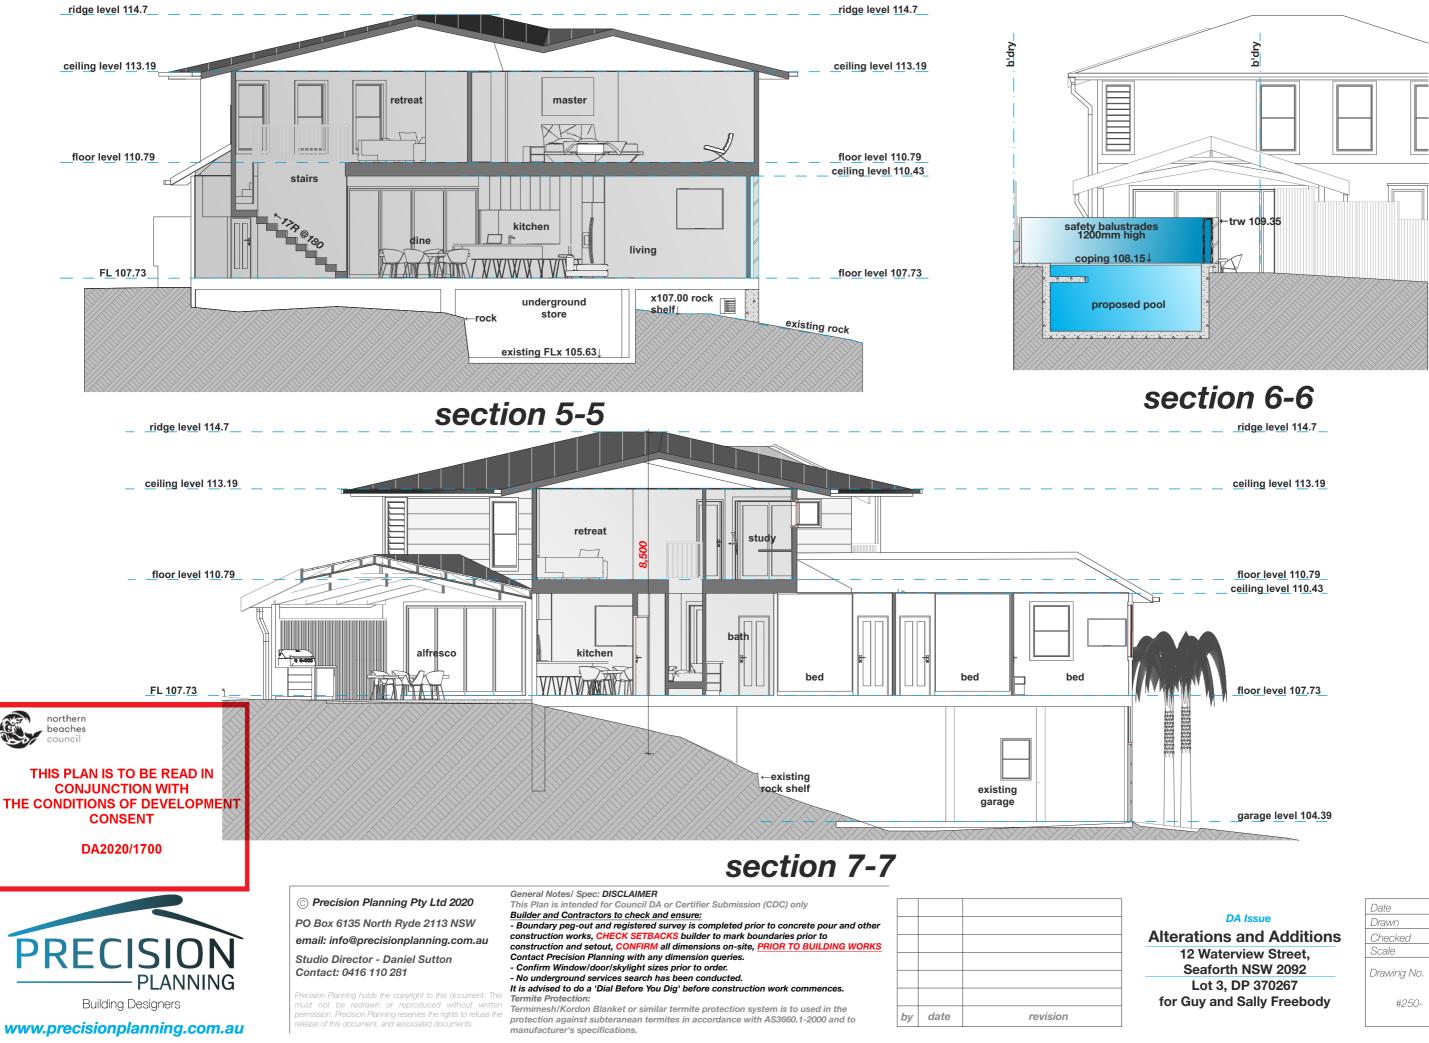


for




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12 Waterview Street,			
Seaforth NSW 2092			
Lot 3, DP 370267			
Guy and Sally Freebody			

Date	16/12/20
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Scale	1:100 @ A3
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16/12/20 DS 1:100 @ A3 #250- 12



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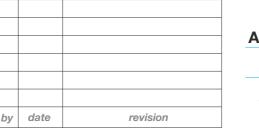
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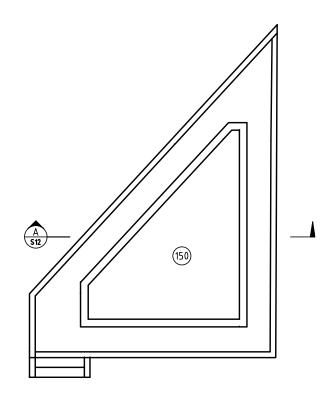
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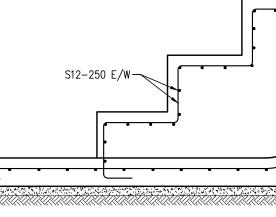
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Alterations and Additions 12 Waterview Street, Seaforth NSW 2092 Lot 3, DP 370267 for Guy and Sally Freebody

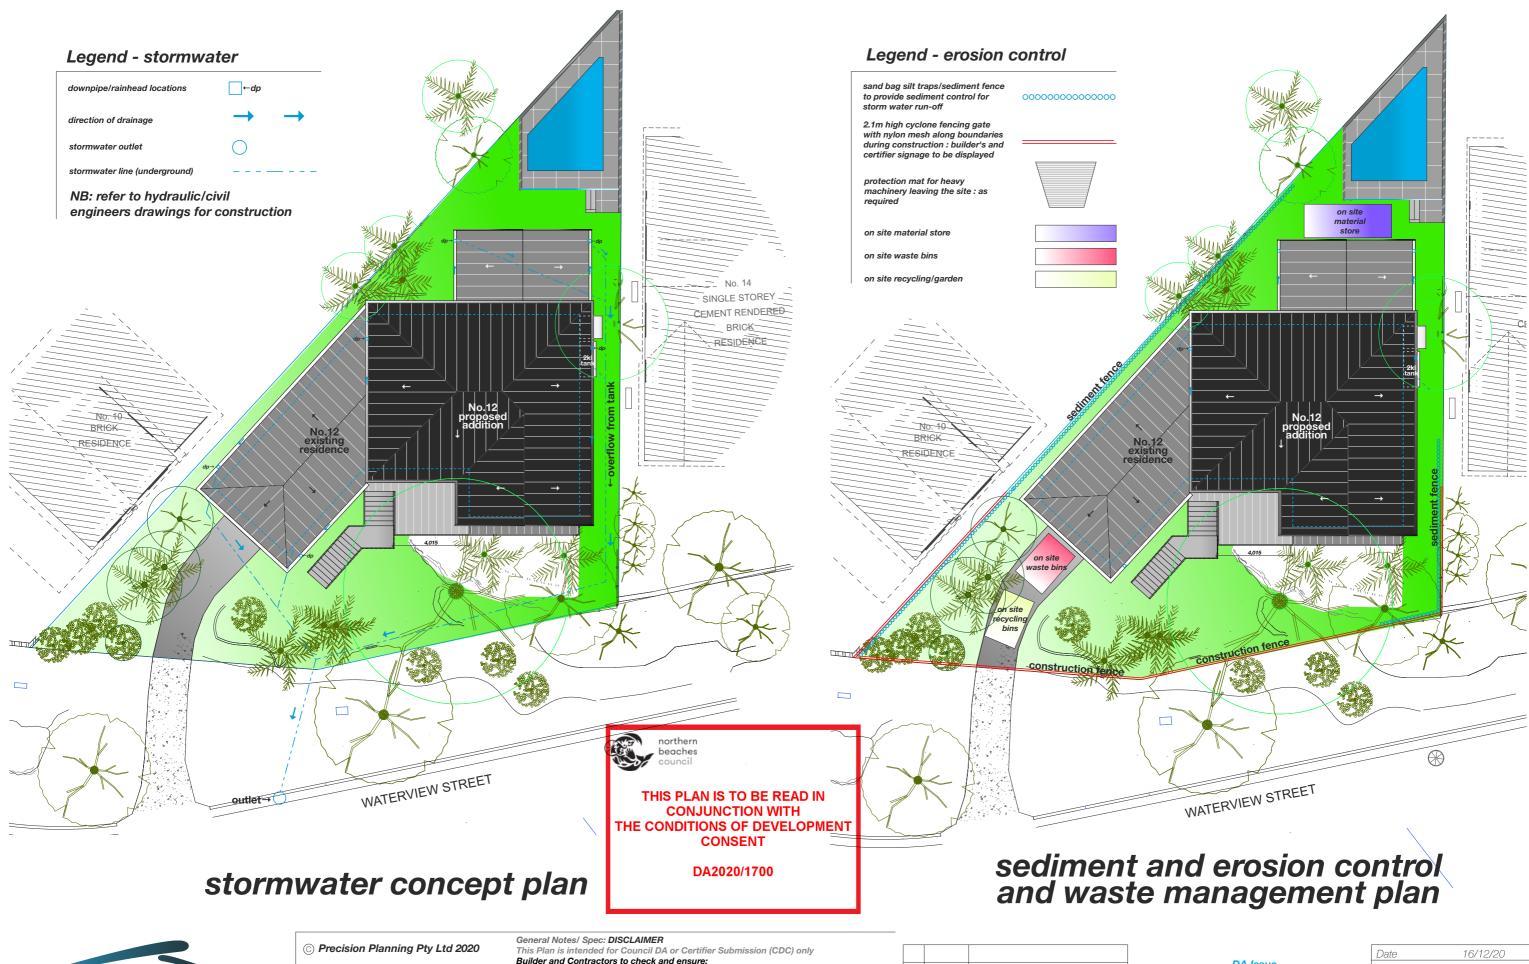Date	16/12/20			
Drawn	DS			
Checked				
Scale	1:200 @ A3			
Drawing No.				
#250-	18			





TYPICAL STEP REINFORCEMENT

SCALE 1:20 CONCRETE STRENGTH f'c = 32 MPa NOTE: THE LAYOUT ABOVE IS INDICATIVE ONLY, REFER TO ARCHITECTURAL DRAWINGS FOR LAYOUT AND NUMER OF STEPS


POOL PLAN

SCALE 1:20 CONCRETE STRENGTH f'c = 40 MPa NOTE: THE LAYOUT ABOVE IS INDICATIVE ONLY, REFER TO ARCHITECTURAL DRAWINGS FOR LAYOUT AND NUMER OF STEPS


(150) DENOTES SLAB THICKNESS



<u>NO.</u> 1	AMENDMENTS ISSUED FOR DA	DATE 19/11/20	PROPOSED ALTS & ADDS 12 WATERVIEW STREET SEAFORTH NSW 2092	CLIENT: RICC DRAWING TITLE:	M/ 0404 719 9 E/ info@structo A/ P0 Box 920	aconsulting.com
			SEALOR IN NOW 2092	POOL PLAN	DRAWN: PB	DESIGNED: PB

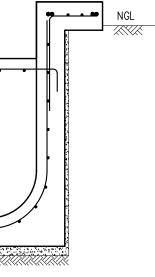



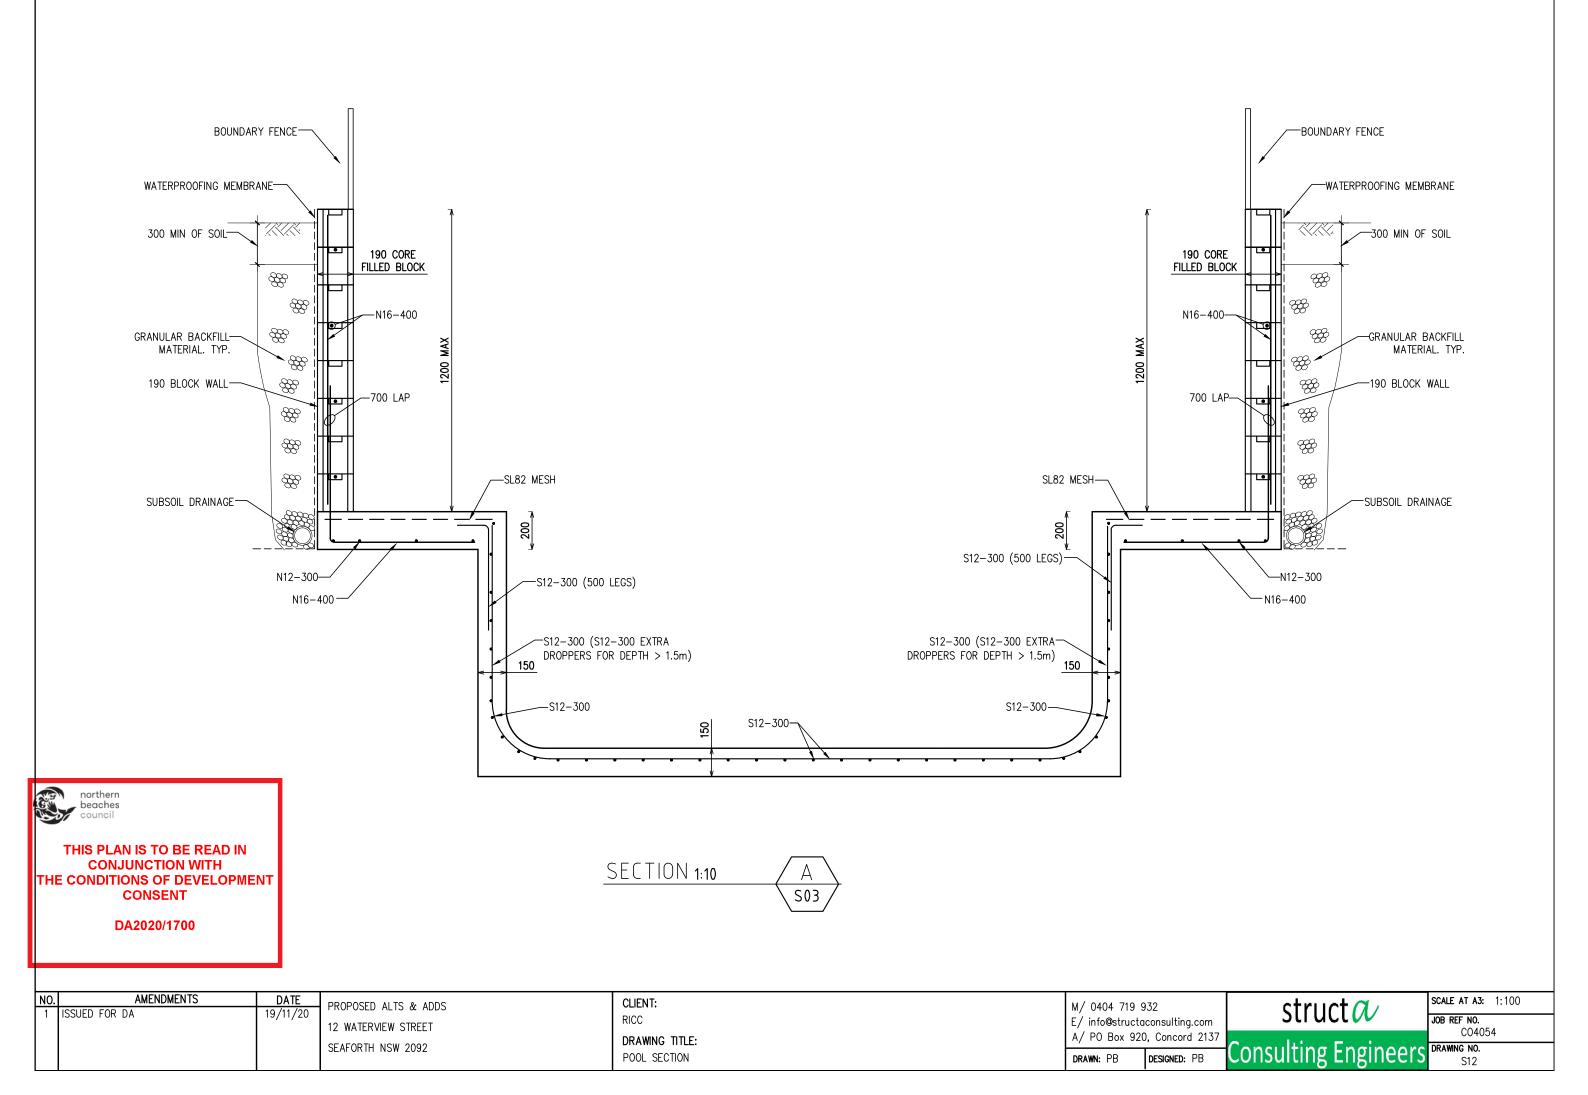

SPECIFICATION

- 1. PLUMING IS TO BE IN ACCORDANCE WITH WRITTEN RECOMMENDATIONS OF FILTER MANUFACTURER
- 2. WALKWAYS ARE NOT DESIGNED TO SUPPORT MASONARY WALLS UNLESS UTHERWISE NOTED
- 3. DESIGN LIVE LOAD FOR WALKWAYS AND CONCOURSES TAKEN AS 2.0 KPa

CONSTRUCTION NOTES

- 1. ALL DIMENSIONS LOCATIONG POOL ARE BE TAKEN FROM ARCHITECTURAL DRAWINGS
- 2. POOL DESIGN AND CONSTRUCTION TO BE IN ACCORDANCE WITH AS2783 & AS3600 AND ALL OTHER RELEVANT STANDARDS
- 3. ENGINEER TO BE ADVISED IF EXCEVATION IS IN FILL OR IF EXCESSIVE GROUND WATER IS ENCOUNTED
- 4. SUPPORTING FOUNDATION MATERIAL TO BE STABLE NATURAL CLAY OF UNIFORM MOISTURE CONTENT WITH SAFE BEARING CAPACITY OF 150 Kpa
- 5. WHERE IT IS CONSIDERED THAT GROUND WATER CAN BUILD UP TO A LEVEL 500mm ABOVE THE FLOOR OF THE EXCAVATION ADEQUATE DRAINAGE SHAL BE PROVIDED UNDER THE POOL FLOOR
- 6. CONCRETE TO HAVE A MINIMUM DESIGN STRENGTH OF F'c 32 MPa AT 28 DAYS WITH 80mm SLUMP, CONCRETE TO BE PNEUMATICALLY APPLIED
- 7. UPON COMPLETION OF CONCRETING THE HYDROSTATIC VALVE IS TO BE CHECKED TO ENSURE EFFECTIVE AND SUFFICIENT OPERATION
- 8. PLASTIC OR NON-RUSTING CHAIRS ARE TO BE USED TO SUPPORT REINFORCEMENT AT 1000 CTRS MAX.
- 9. REINFORCEMENT IS TO BE STRUCTURAL GRADE DEFORMED BAR GRADE S250 OR D500N TO AUSTRALIAN STANDARD AS1302
- 10. WATER FACE REINFORCEMENT TO HAVE 65mm CONCRETE COVER, REAR FACE REINFORCEMENT TO HAVE 50mm COVER IF FORMED AND 65mm COVER IF SPRAYED AGAINST GROUND
- 11. ALL BARS SHALL BE SPLICED 40 BAR DIAMETERS MIN.


12. SPLICES IN BOND BEAM BARS SHALL BE STAGGERED 13. AFTER CONCRETING THE POOL IS TO BE CURED FOR A PREIOD OF 7 DAYS BY WETTING ALL CONCRETE SURFACES TWICE EACH DAY (10 DAYS CURING REQUIRED IN SUMMER).

northern beaches


THIS PLAN IS TO BE READ IN **CONJUNCTION WITH** THE CONDITIONS OF DEVELOPMENT

CONSENT

DA2020/1700

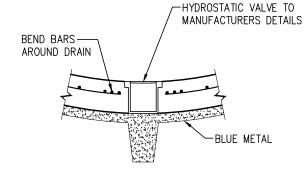



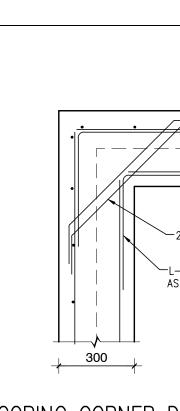


SCALE 1:20

50

WALL CORNER DETAIL (PLAN)


L-BARS 500 LEGS

SCALE 1:20

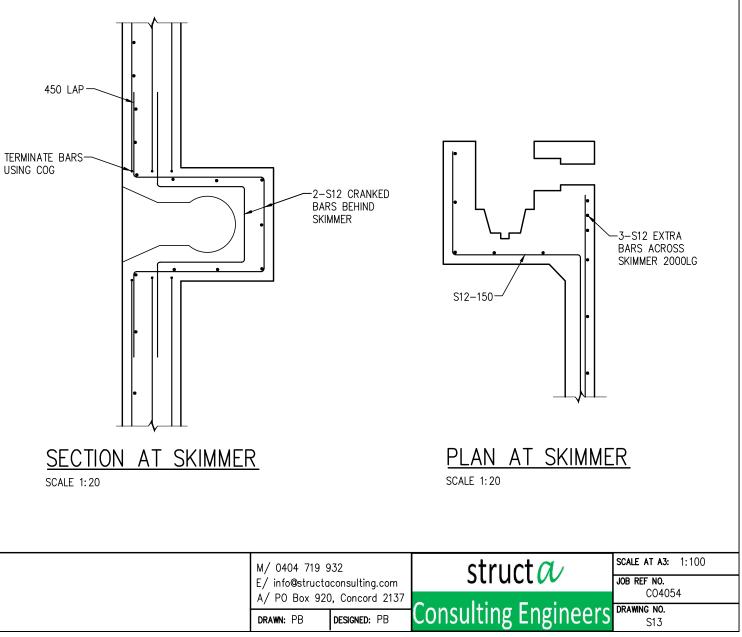



N/ 1	D. AMENDMENTS DA ISSUED FOR DA 19/11		CLIENT: RICC DRAWING TITLE:	M/ 0404 719 9 E/ info@structo A/ P0 Box 920	consulting.c
		SEAFORTH NSW 2092	POOL DETAILS	DRAWN: PB	DESIGNED: P

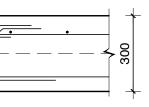

-2-S12 TRIMMERS

-L-BARS LAP AS REQUIRED

COPING CORNER DETAIL (PLAN)