287 Whale Beach Road, Palm Beach NSW 2107

DRAWING SCHEDULE

SHEET	TITLE NOTE	
DA00	Title Sheet and Location Map	
DA01	Site Analysis	
DA02	Site Plan	
DA03	DA Area Calculations	
DA04	Existing + Demolition Plan	
DA05	Roof Plan & Upper Studio Floor Plan	
DA06	Floor Plans Level 1 + 2	
DA07	Floor Plans Level 3 + 4	
DA08	Elevations North & South	
DA09	Elevations East & West	
DA10	Section A	
DA11	Section B, C, D + E	
DA12	Shadow Diagrams 1	
DA13	Shadow Diagrams 2	
DA14	Excavation and Fill Sections	
DA15	3D Perspectives	
DA16	3D Neighbours Perspectives 1	
DA17	3D Neighbours Perspectives 2	
DA18	Window Schedule	
DA19	Exterior Door Schedule	

CONSULTANTS

Energy Assessor Geotechnical Engineer: Landscape Designer: Quantity Surveyor: Stormwater Engineer:

Horton Coastal Engineering White Geotechnical Group Wyer & Co. Newton Fisher Group Adam Clerke Surveyors Pty Ltd Beam Planning

Alex Gunawan

GENERAL SPECIFICATION NOTES

- All general construction to conform to the current BCA and Local Govt conditions of Development Consent.
- Demolition works to be carried out in accordance with AS 2601.
- All masonry work in accordance with AS 3700. - Termite protection to be installed in accordance with AS 3660.1 and the current BCA.
- All roof water and storm-water runoff to be connected to a Council approved system of collection and/or disposal.
- All carpentry work to conform to AS1684 for Light Timber Framing.
- All pre-fabricated timber trusses and frames to utilise sustainable plantation timbers installed to the manufacturer's detail and specification.
- All concrete slabs, retaining walls, structural steel, foundations and footings to be designed & specified by the consulting structural engineer and built strictly in accordance with such details, as
- Plumbing services to be carried out only by licensed tradespersons and in accordance with AS 3500.3.2, AS 3500.2.2, AS 3500.1.2, AG 601 and other associated standards and codes. - All electrical services to be installed by licensed electricians and in accordance with AS3000. Telecommunications cabling to be installed in accordance with AS/ACIF S009:2000 and associated
- standards and guidelines. Upgrade safety switches & smoke alarms as required to meet relevant standards. - All measurements shown and scheduled are nominal. The contractor shall check all measurements on site before ordering materials and check any anomalies with Cadence & Co before
- All insulation to be provided and installed in accordance with AS4859.1, AS3999 (bulk insulation), AS1904 (foil insulation) and associated standards and codes.
- Proposed RL's shown on drawings are to be FINISHED LEVELS. Builder to provide set down's and allowances to accommodate finished levels.

LOCATION PLAN (NTS)



NatHERS and BASIX Incl	usion

Insulation Notes:

All insulation and vapour membranes must be installed in accordance with Part 10.8 Condensation Management and NSW H6P1 (Part 13.2) Building Fabric, NSW H6P2 (Part 13.4) Building Sealing, NSW H6P3 (Part 13.7) Services.

Wall and roof frames

90mm timber frames to all walls, mid floors and roof

External Floors

200mm Concrete slab on ground, with R2.5 slab and slab edge insulation

200mm Suspended concrete, R4.0 rigid board insulation to open and/or enclosed subfloors No insulation required to garage floor

Concrete structure between levels;

Internal Floors

No insulation is required where habitable rooms are below R4.0 rigid board insulation where subfloors and unconditioned zones are below

External Walls

Cavity core filled concrete block and 110m brick wall with cavity insulation and plasterboard lining internally. Kingspan K8 cavity board 40mm utilized in thermal model product R-value 1.75 and total system R-value Rt2.8.

Lightweight cladding 90mm timber frame with R2.7 bulk insulation and plasterboard lining 75mm Hebel panel 90mm timber frame with R2.7 bulk insulation and plasterboard lining No insulation is required to external garage walls

External colours: External walls: Medium

Roof: Medium

Walls within dwellings

Single brick with plasterboard lining Concrete block with plasterboard lining

R2.0 insulation to laundry and studio bathroom

Glazing Doors/Windows

Double hung u-value: 1.99 and SHGC: 0.41

u-value: 1.95 and SHGC:0.47

Sliding doors:

u-value: 1.92 and SHGC: 0.39

Hinged door u-value: 1.90 and SHGC: 0.37

Given values are AFRC total window system values (glass and frame)

Window restrictors are modelled in the first-floor bedrooms to all windows with a sill height under 1.7m and a fall height over 2m from the floor level of the room. Skylights

Skylights are openable U-value: 2.53 and SHGC: 0.21

Roof and Ceilings Metal roof with R1.8 foil-backed blanket

20mm Concrete roof Tiled roof with reflective sarking

Plasterboard ceiling with R4.0 insulation where roof or balcony is above, the insulation must extend

Ceiling Penetrations

Sealed LED downlights, maximum one every 4.0m²

Ceiling fans

1200mm ceiling fans to living areas and bedrooms

Floor coverings As per plans

External Shading As per plans

Ventilation

Weather seals and draft protection to all external windows and doors

Dampers to all exhaust fans and chimneys **BASIX Water Commitments**

Fixtures

Showerheads 3 stars (medium flow >7.5 and <= 9.0 litres/min) Toilet flushing system 4 stars in each toilet

Kitchen taps 5 stars rating

Bathroom taps (bath excluded) minimum 5 stars rating

Alternative water 260m2 of harvested roof area connected to rainwater tank, minimum capacity, 50,000L.

Rain tank connected to at least one outdoor tap, toilets and pool

BASIX Energy Commitments Hot water system

Electric heat pump – 26 to STC's

Cooling system 3-phase air-conditioning to living areas and bedrooms: EER 3.0-3.5

Heating system

3-phase air-conditioning to living areas and bedrooms: EER 3.0-3.5

Bathrooms – individual fan, externally ducted manual on/off switch

Drawn: Chkd:

GC NG

Sheet No:

Kitchen – individual fan, externally ducted manual on/off switch

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Nominated Architects: Michael Kilkeary NSW ARB 12302

Sam Samarghandi NSW ARB 9112

Laundry room – individual fan, externally ducted manual on/off switch

Gas cooktop, electric oven

Outdoor clothes drying line

Alternative energy

Development Application

@A1


8.0kW Solar Photovoltaic system Positioned on northern roof at 25 to 35-degree pitch


Skylight shaft with stud framing and R4.0 insulation Rev Date Issue
A 2/12/2024 DA Submission New Residence, Pool & Associated External Works Title Sheet and Location Map

287 Whale Beach Road, Palm Beach NSW 2107

James & Anna Markham

Lot 187 | DP 15376

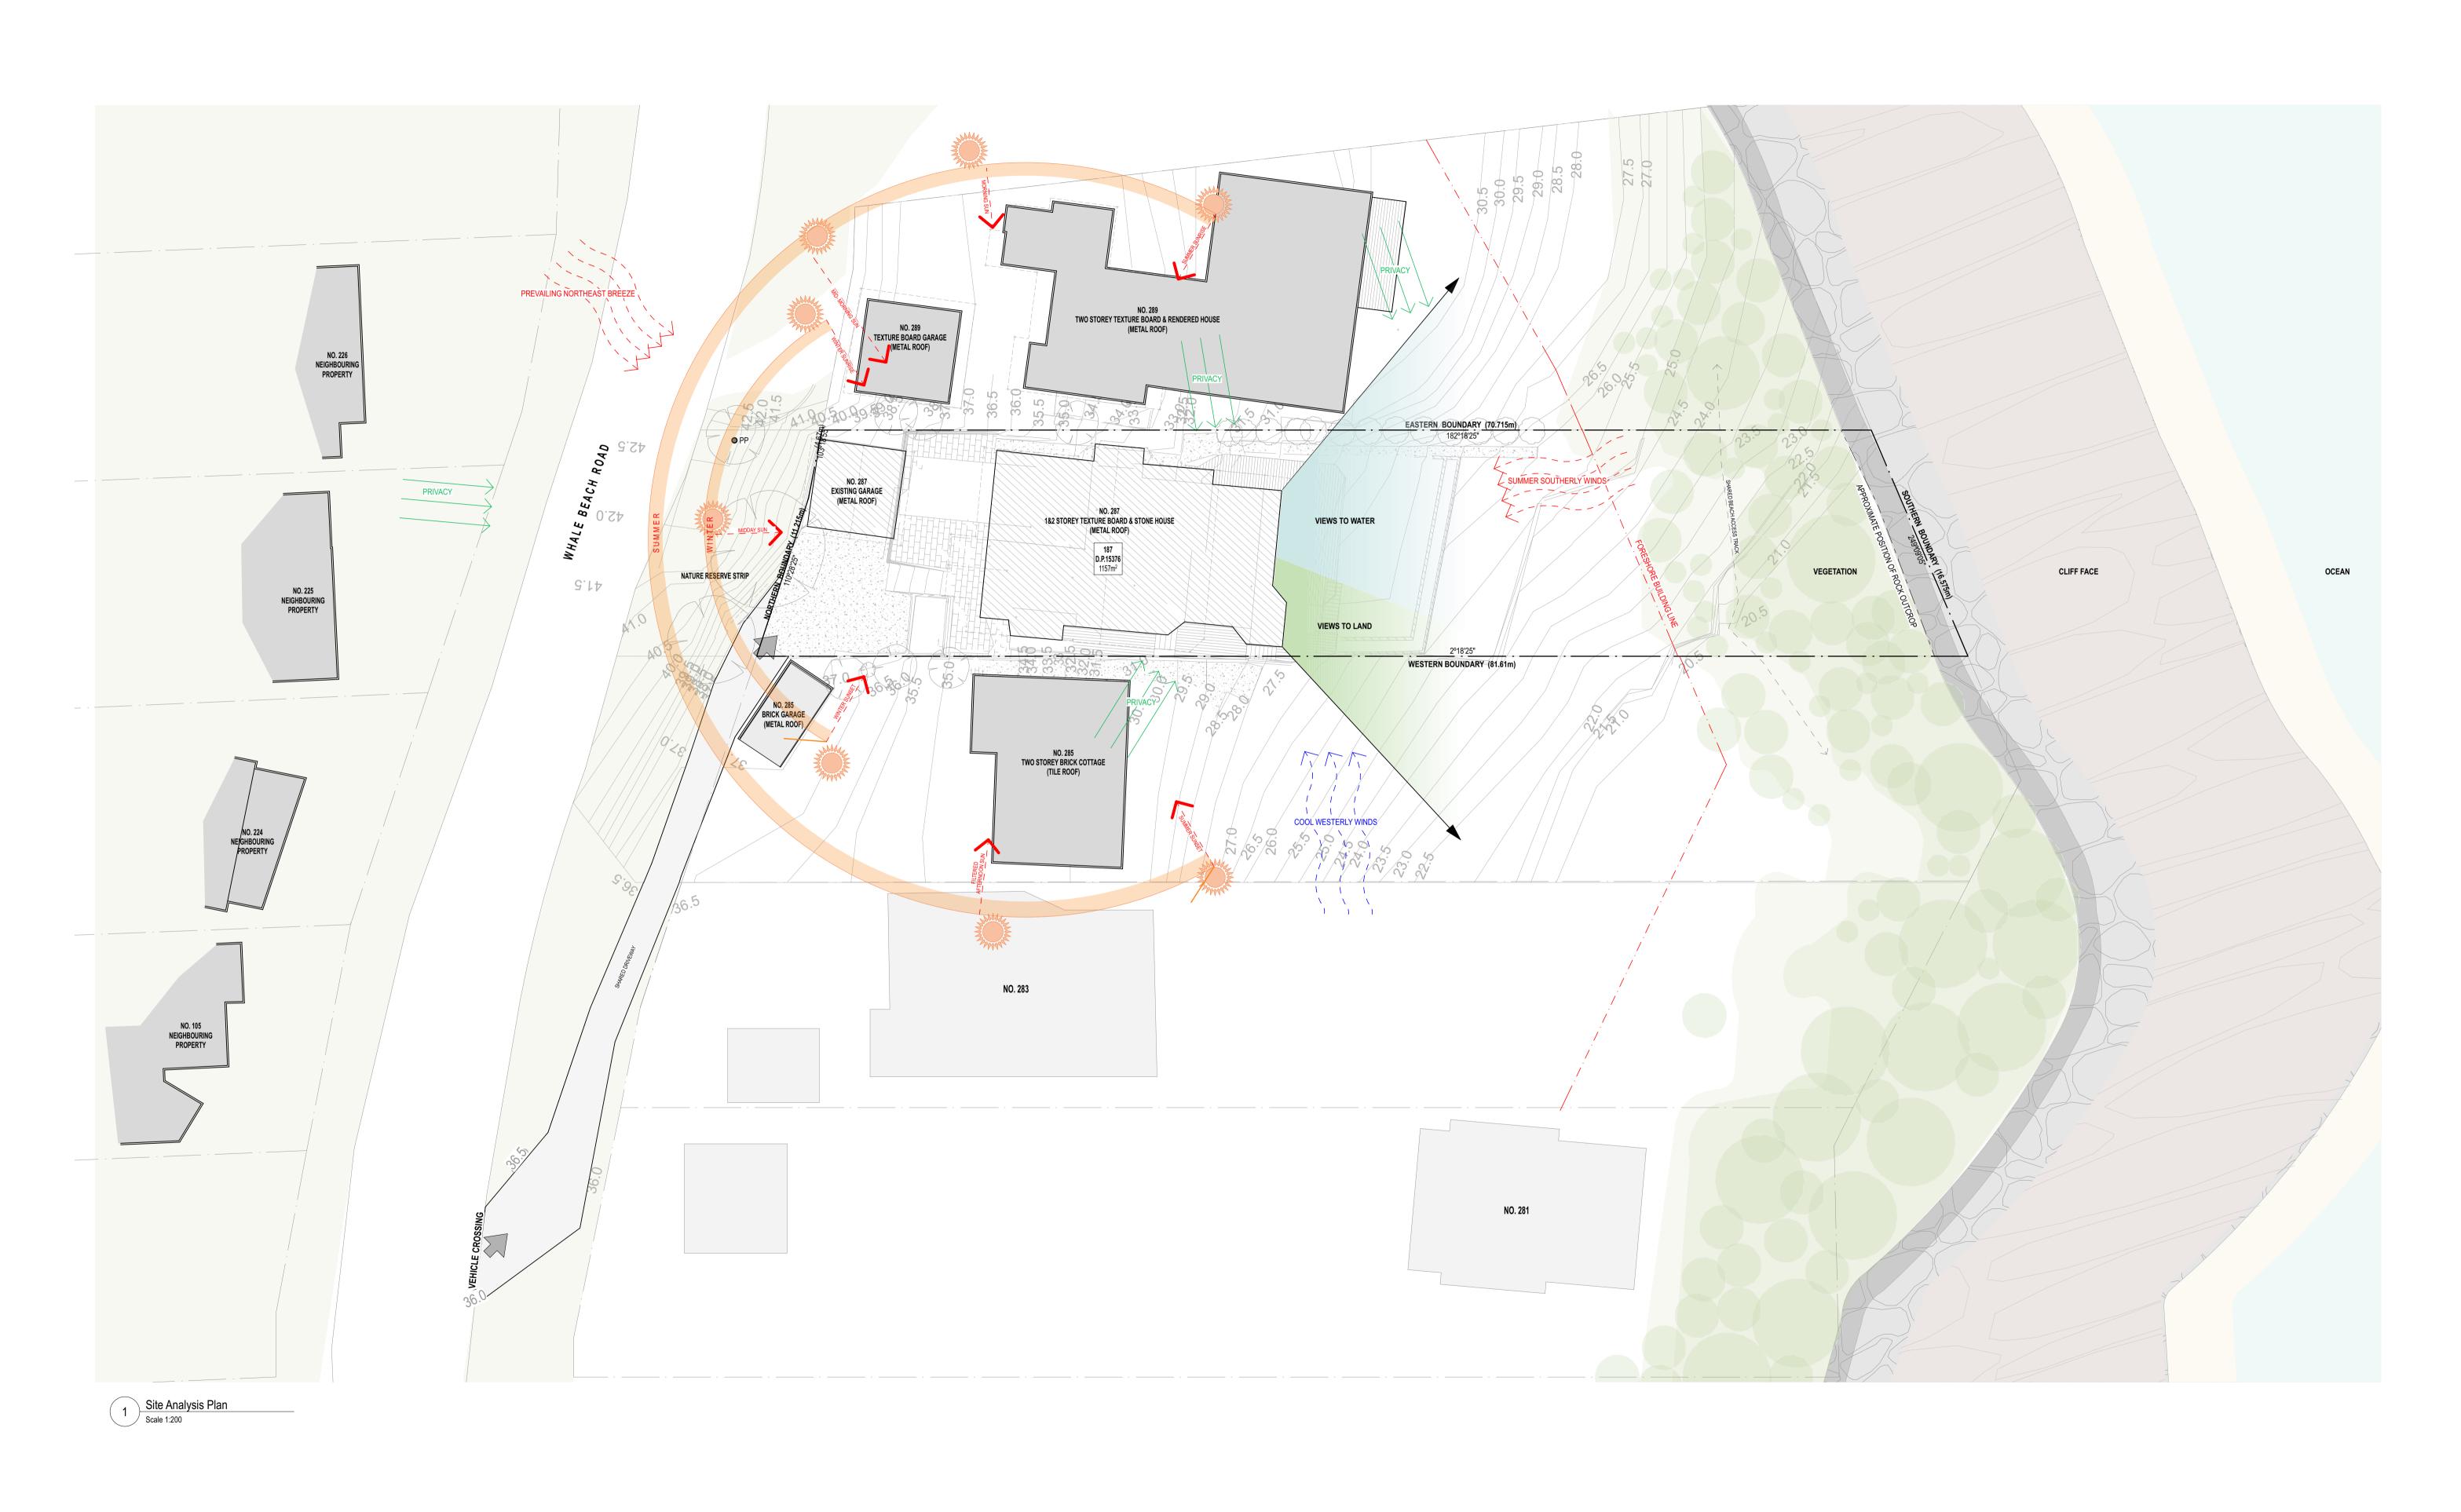

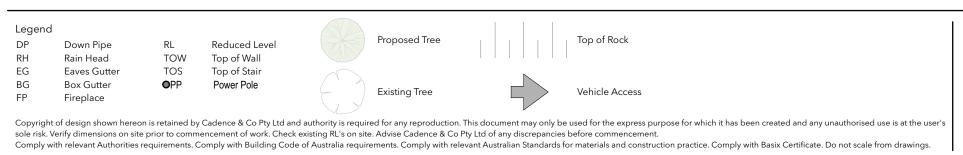

Rev	Date	Issue	Project:	Drawing Title:	
A	2/12/2024	DA Submission	New Residence, Pool & Associated External Works	Site Analysis	
			Client: James & Anna Markham	Stage: Development Applicat	tion
			Address: 287 Whale Beach Road, Palm Beach NSW 2107 Lot 187 DP 15376	Scale: 1:200 @A1]


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DA01

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General Notes

Refer to Stormwater Documentation for Sediment Control Plan. - All erosion and sedimentation control plan in accordance with the NSW Governments policy Managing Urban Stormwater: Soils and Construction (also known as The Blue Book). - All measures to be installed to meet the requirements of Northern Beaches Council. Install

temporary sediment control fences as shown. - Provide temporary haybales where sediment control fence requires dismantling for site access. - Install mesh and drainage inlet protection on stormwater inlets down slope of site - All stormwater requirements and specifications to Stormwater/Hydraulic Engineer's details

- Tree protection measures in accordance with the Arborist reports

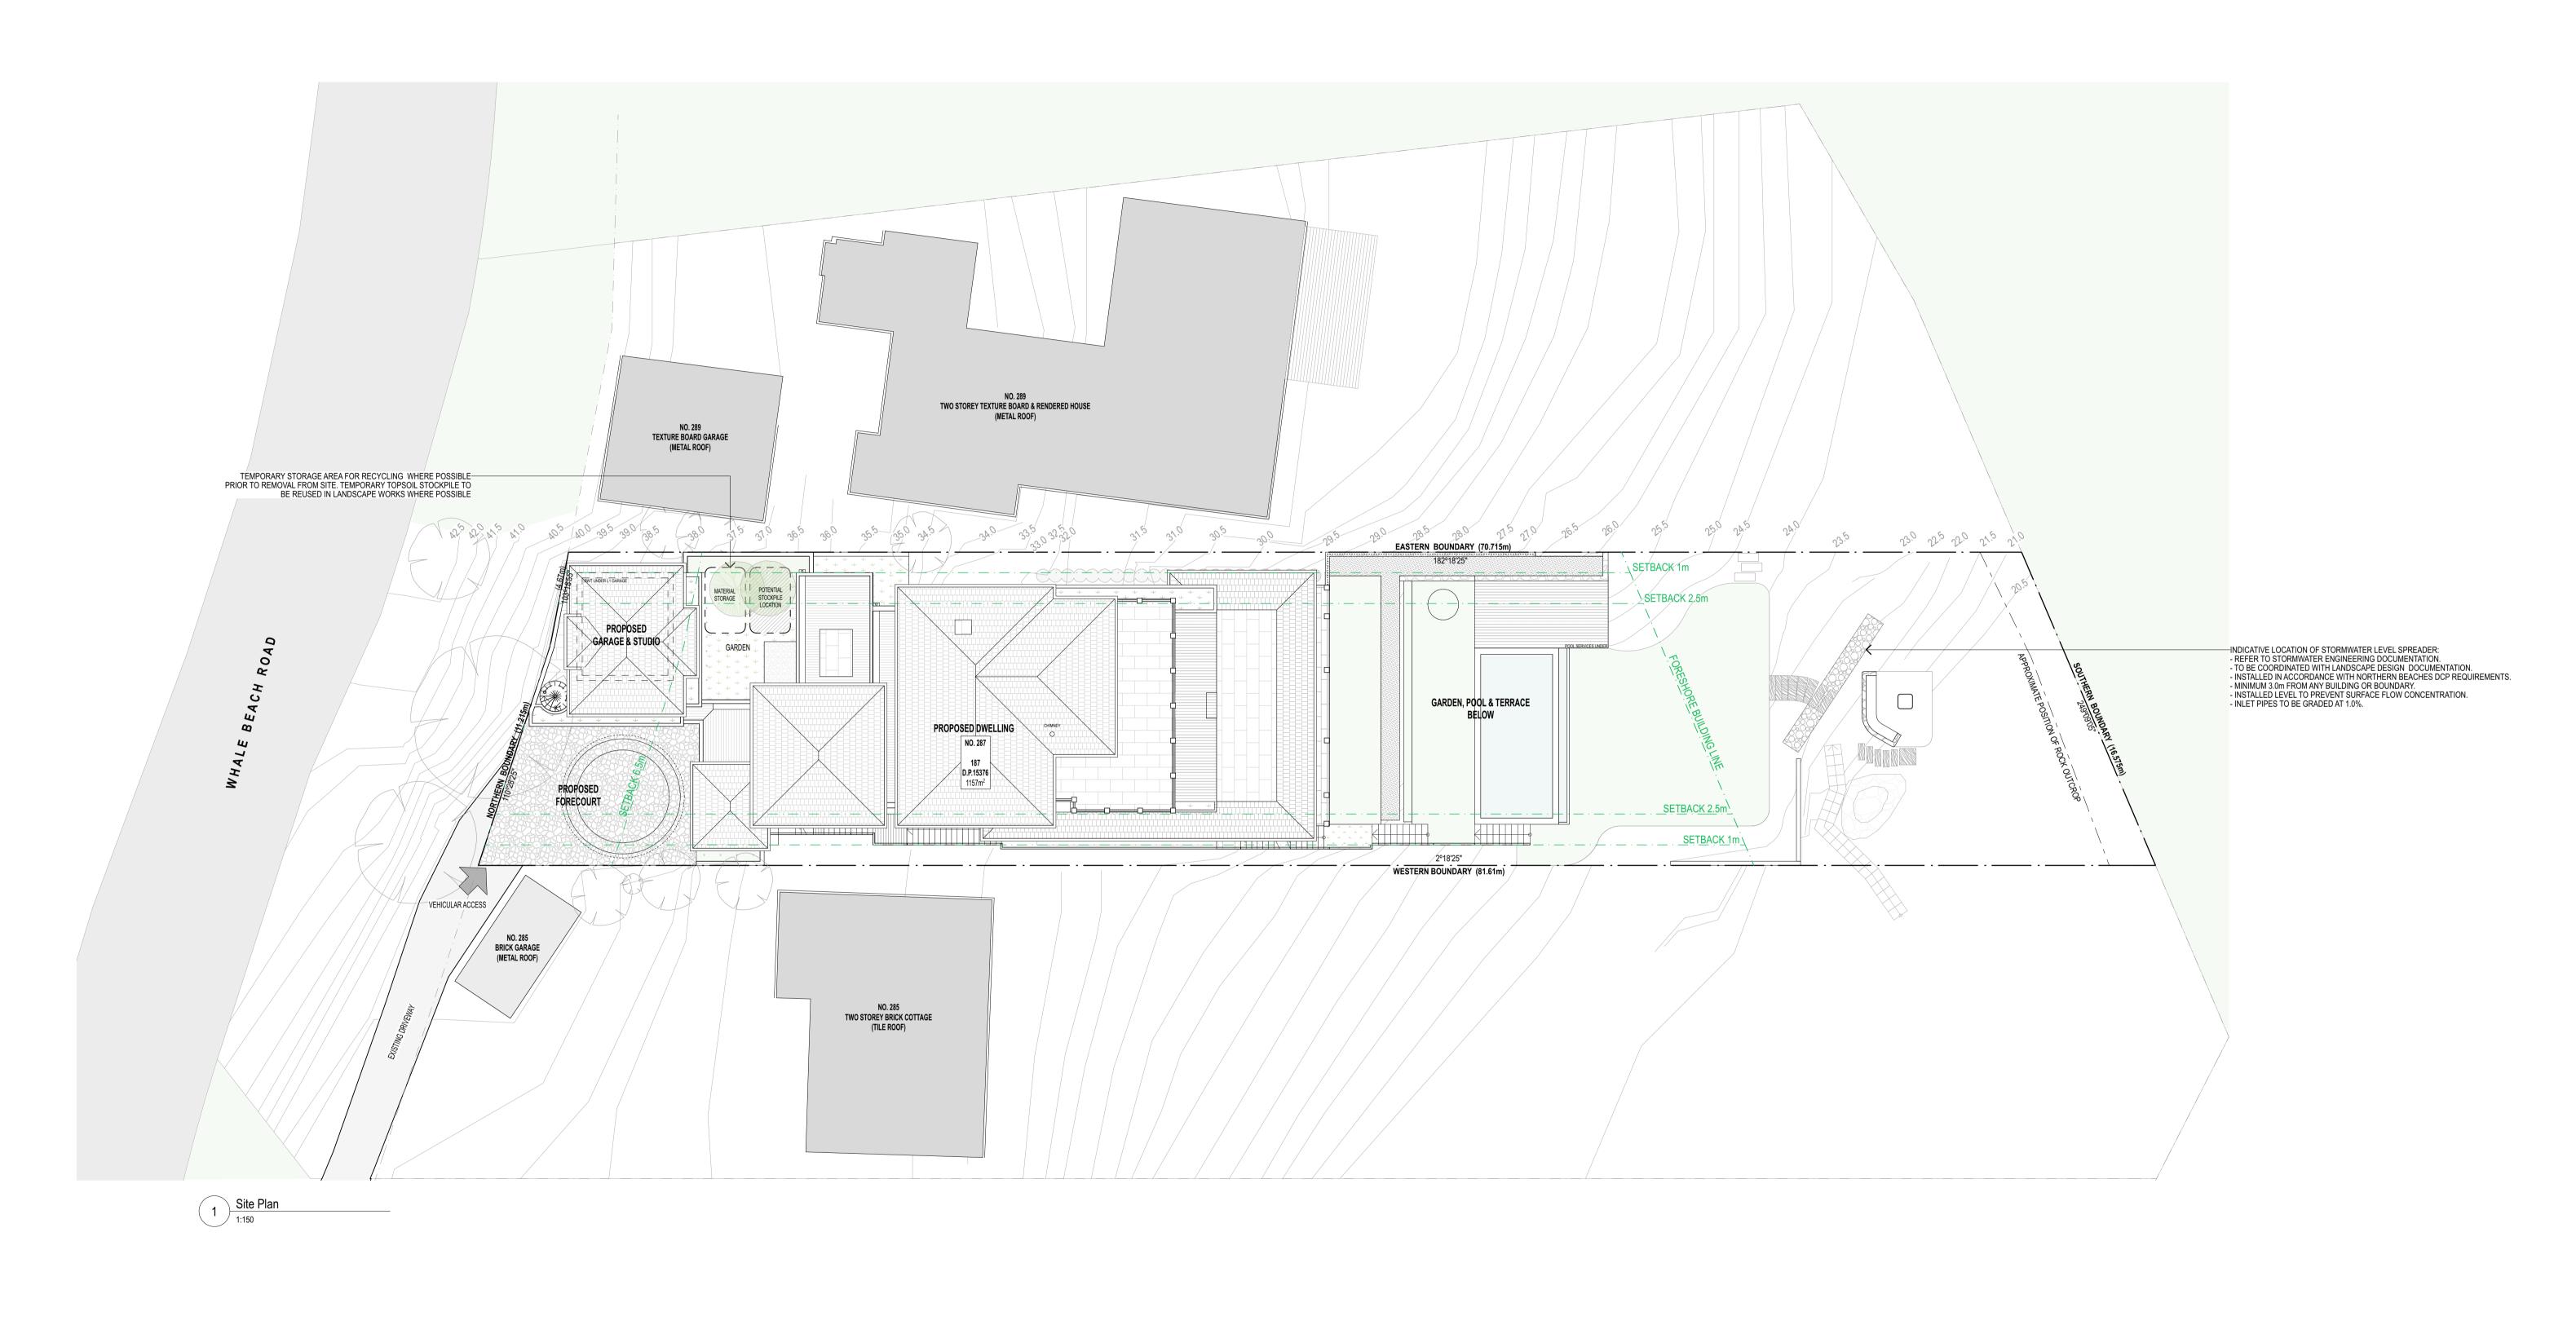Legen DP RH	d Down Pipe Rain Head	RL TOW	Reduced Level Top of Wall		Proposed Tree		Top of Rock				
EG BG FP	Eaves Gutter Box Gutter Fireplace	TOS	Top of Stair		Existing Tree		Vehicle Access				
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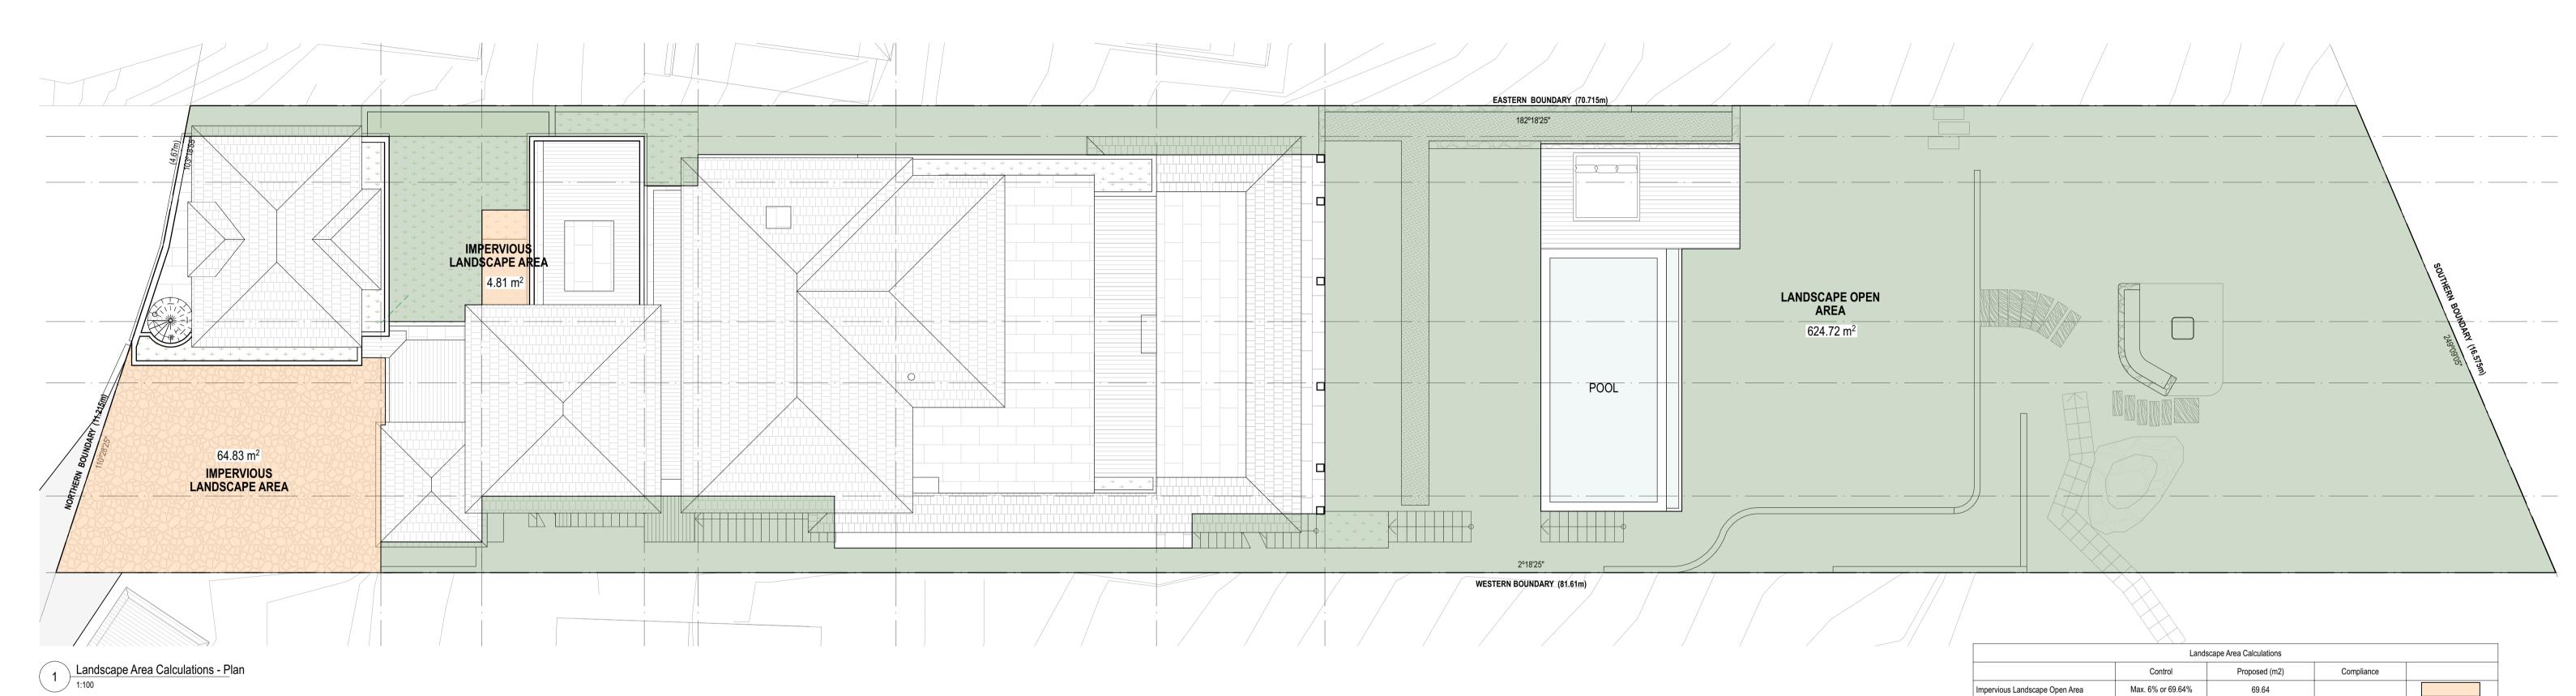
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	Rev	Date 2/12/2024	Issue DA Submission	Project: New Residence, Pool & Associated External Works	Drawing Title: Site Plan
				Client: James & Anna Markham	Stage: Development Applic
				Address: 287 Whale Beach Road, Palm Beach NSW 2107 Lot 187 DP 15376	Scale: 1:150, 1:100 @A1

P 02 9450 1950

Drawn: Chkd: GC NG

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RevDateIssueA2/12/2024DA Submission New Residence, Pool & Associated External Works DA Area Calculations James & Anna Markham 287 Whale Beach Road, Palm Beach NSW 2107 Lot 187 | DP 15376

Drawing Title: Development Application 1:100 @A1

Impervious Landscape Open Area

Landscape Open Area

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69.64

624.72

694.36 m²

Yes

Max. 6% or 69.64% 54% total or 624.78m²

Min. 60% total or 694m²





1 Existing/Demolition Plan
Scale 1:100

Reduced Level - REFER TO SURVEY Rain Head TOW Top of Wall EG Eaves Gutter
BG Box Gutter
FP Fireplace TOS Top of Stair Existing Tree Copyright of design shown hereon is retained by Cadence & Co Pty Ltd and authority is required for any reproduction. This document may only be used for the express purpose for which it has been created and any unauthorised use is at the user's sole risk. Verify dimensions on site prior to commencement of work. Check existing RL's on site. Advise Cadence & Co Pty Ltd of any discrepancies before commencement.

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GENERAL NOTE:

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			Client: James & Anna Markham	Stage: Developmen
			Address: 287 Whale Beach Road, Palm Beach NSW 2107 Lot 187 DP 15376	Scale: 1:100 @A1


ng + Demolition Plan opment Application Drawn: Chkd: GC

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DA04


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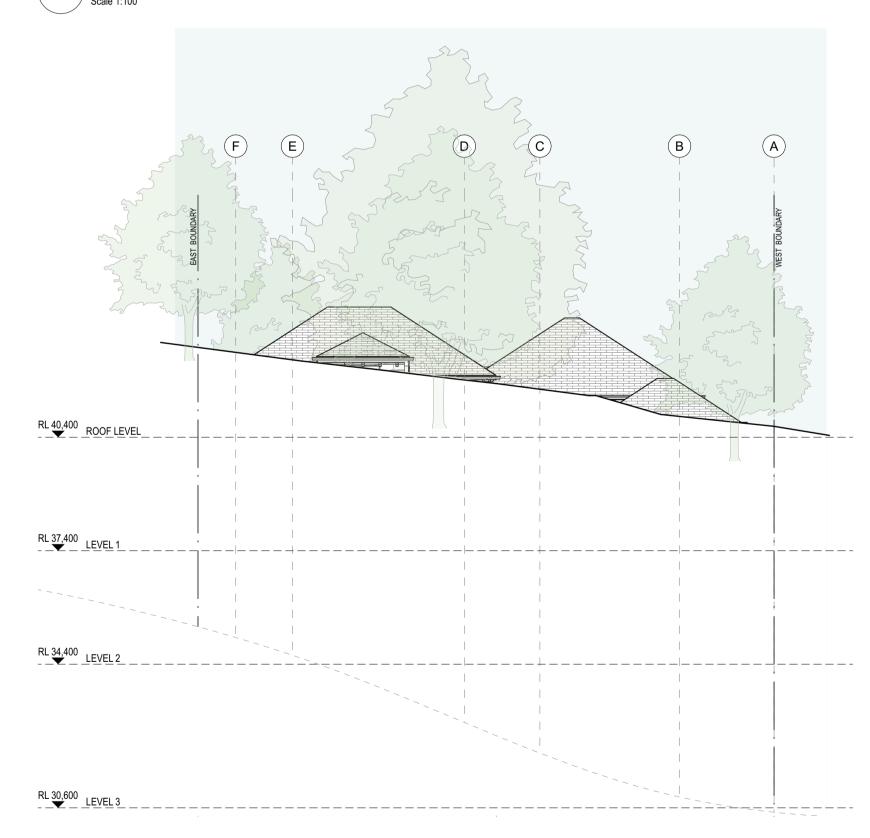






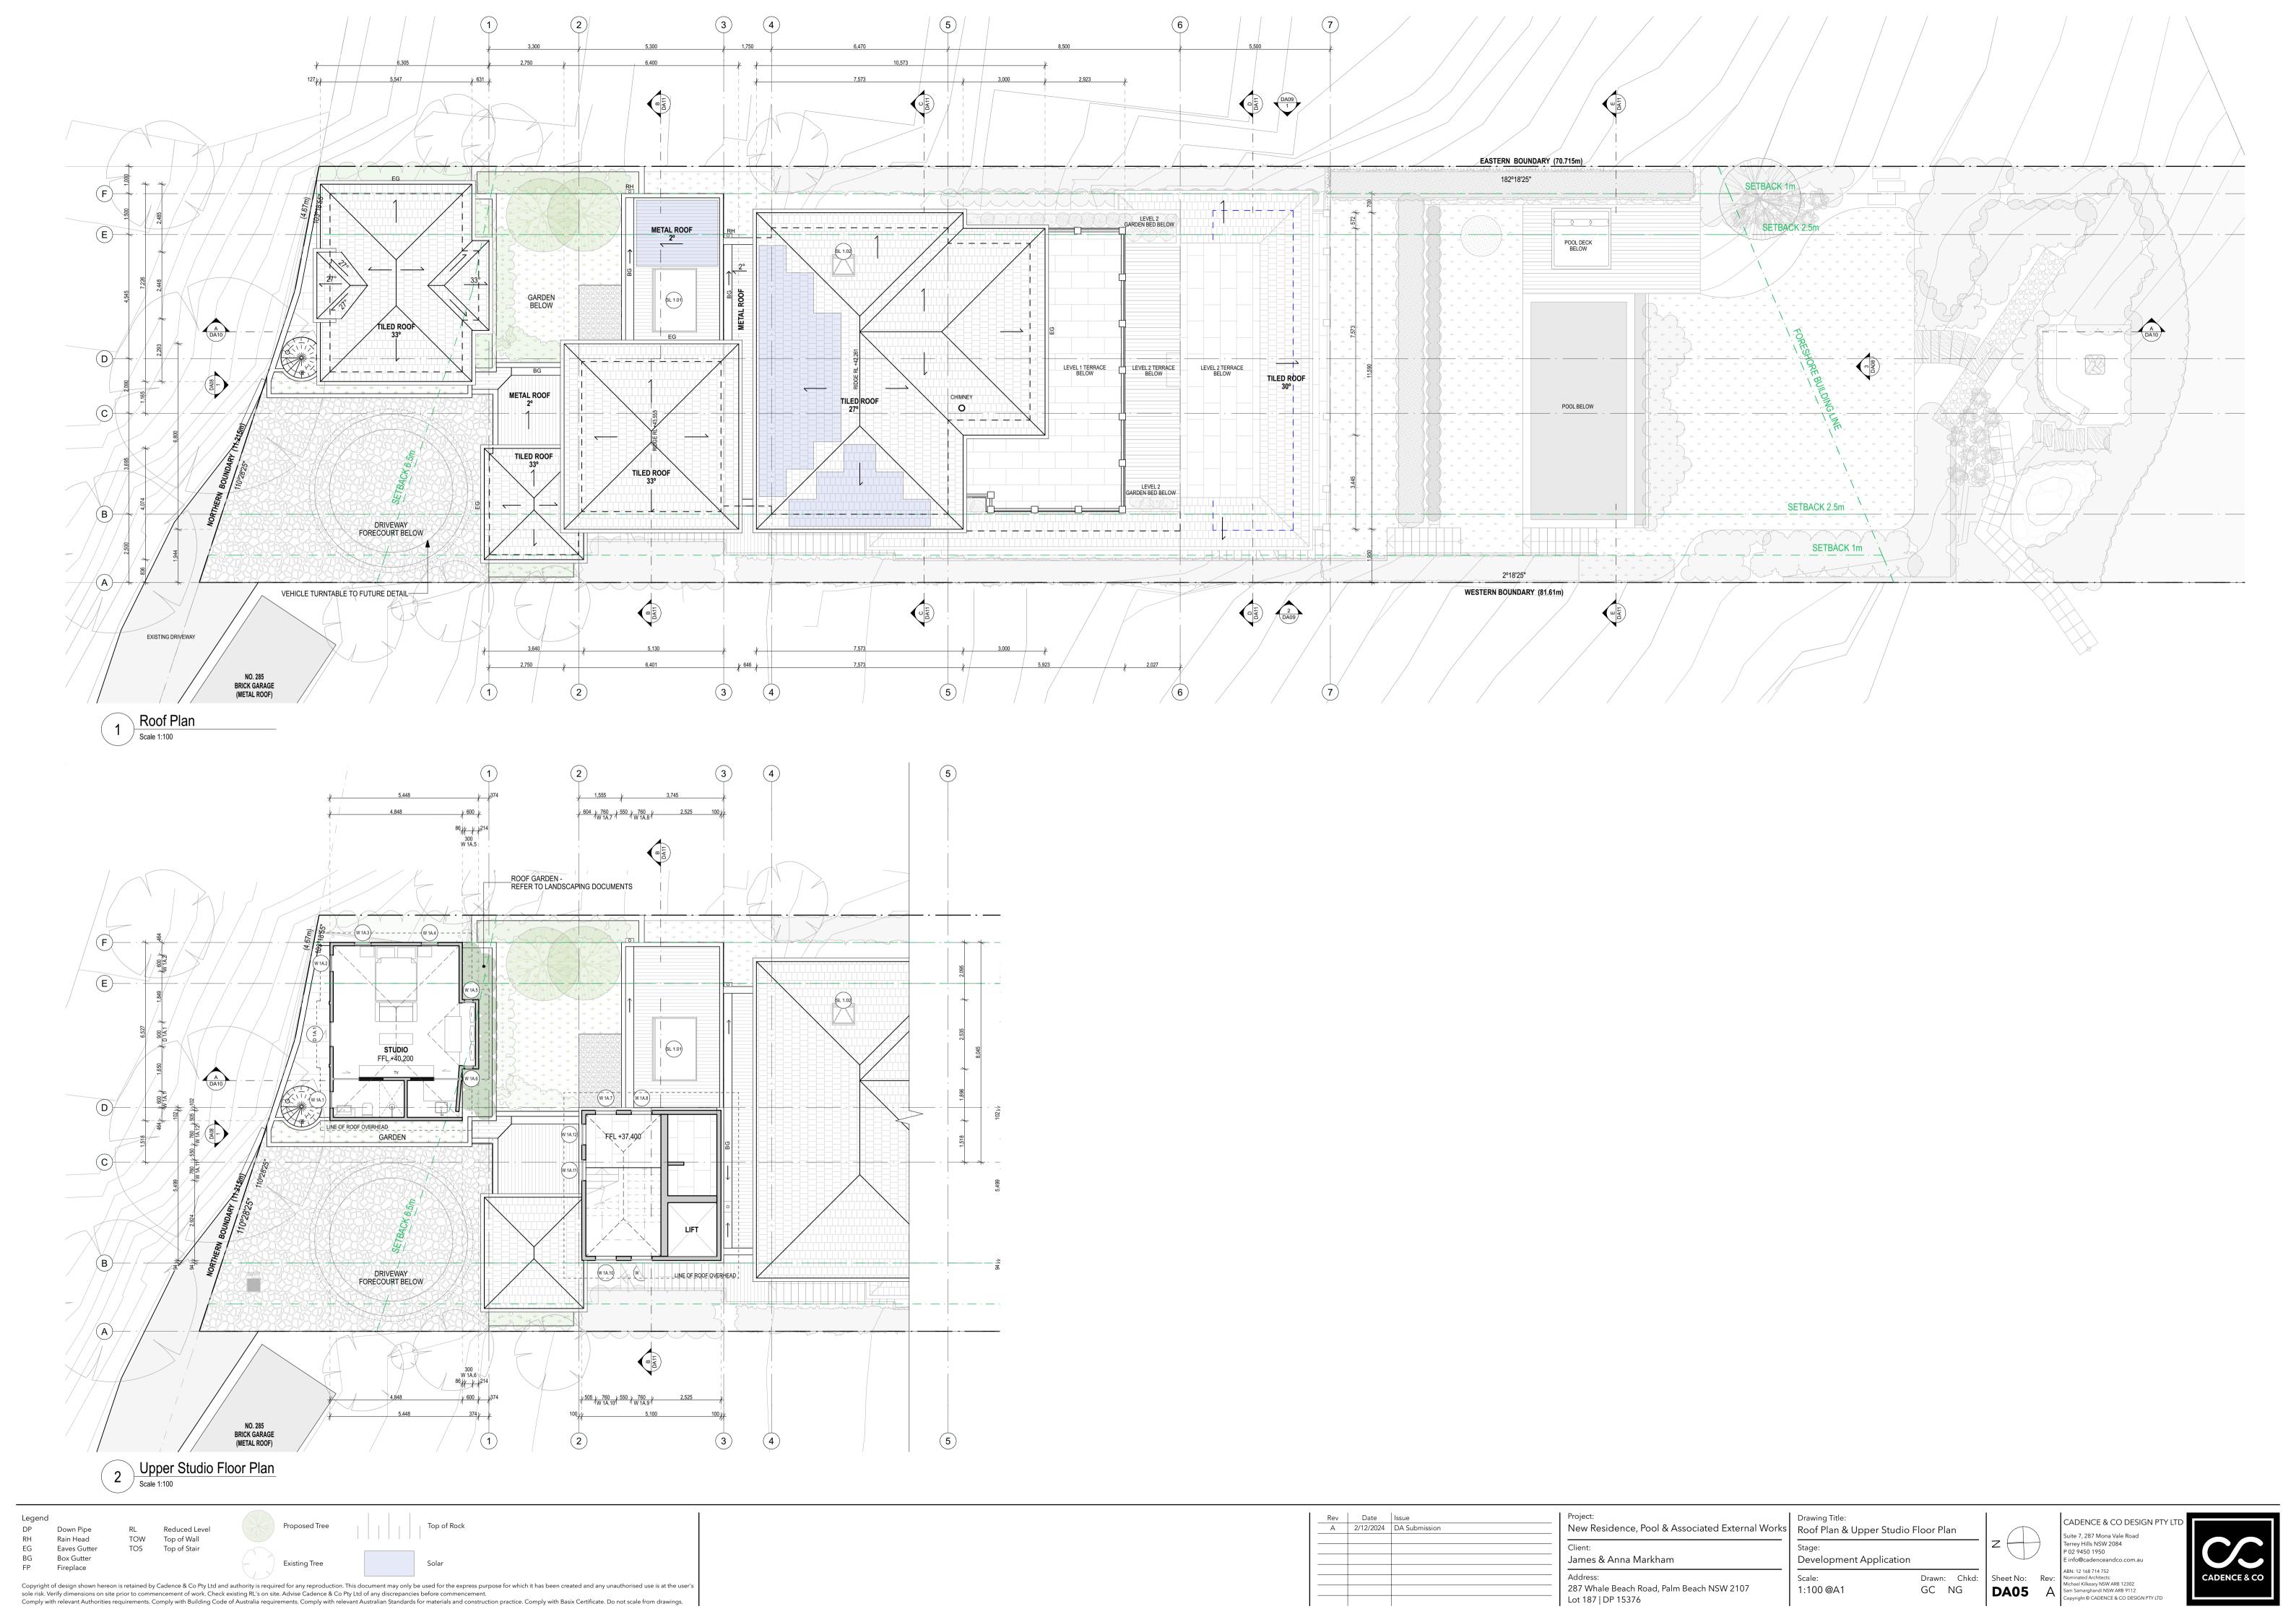



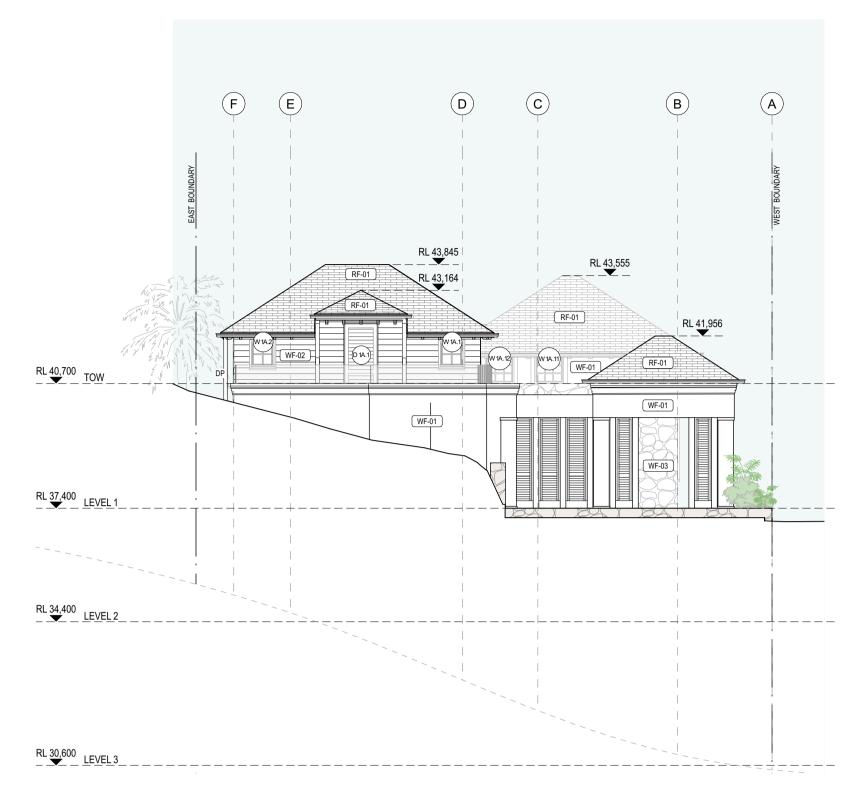


North Elevation from Street Level


Scale 1:100



Legend WF-01 WF-02 WF-03 WF-04	Cement Render Walls Timber Cladding Stone Cladding Chimny	RF-01 RF-02 BAL-01 BAL-02 BAL-03	Roof Finish 1 Metal Roof Timber Balustrade Glass Balustrade Metal Balustrade	DP RH RL TOW	Down Pipe Rain Head Reduced Level Top Of Wall
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24	Issue DA Submission	Project: New Residence, Pool & Associated External Works	Drawing Title: Elevations North & South				CADENCE & CO DESIGN PTY LTD Suite 7, 287 Mona Vale Road	
		Client: James & Anna Markham	Stage: Development Application				Terrey Hills NSW 2084 P 02 9450 1950 E info@cadenceandco.com.au	
		Address: 287 Whale Beach Road, Palm Beach NSW 2107 Lot 187 DP 15376	Scale: 1:100 @A1	Drawn: Chkd: GC NG	Sheet No: DA08	Rev:	ABN: 12 168 714 752 Nominated Architects: Michael Kilkeary NSW ARB 12302 Sam Samarghandi NSW ARB 9112 Copyright © CADENCE & CO DESIGN PTY LTD	С



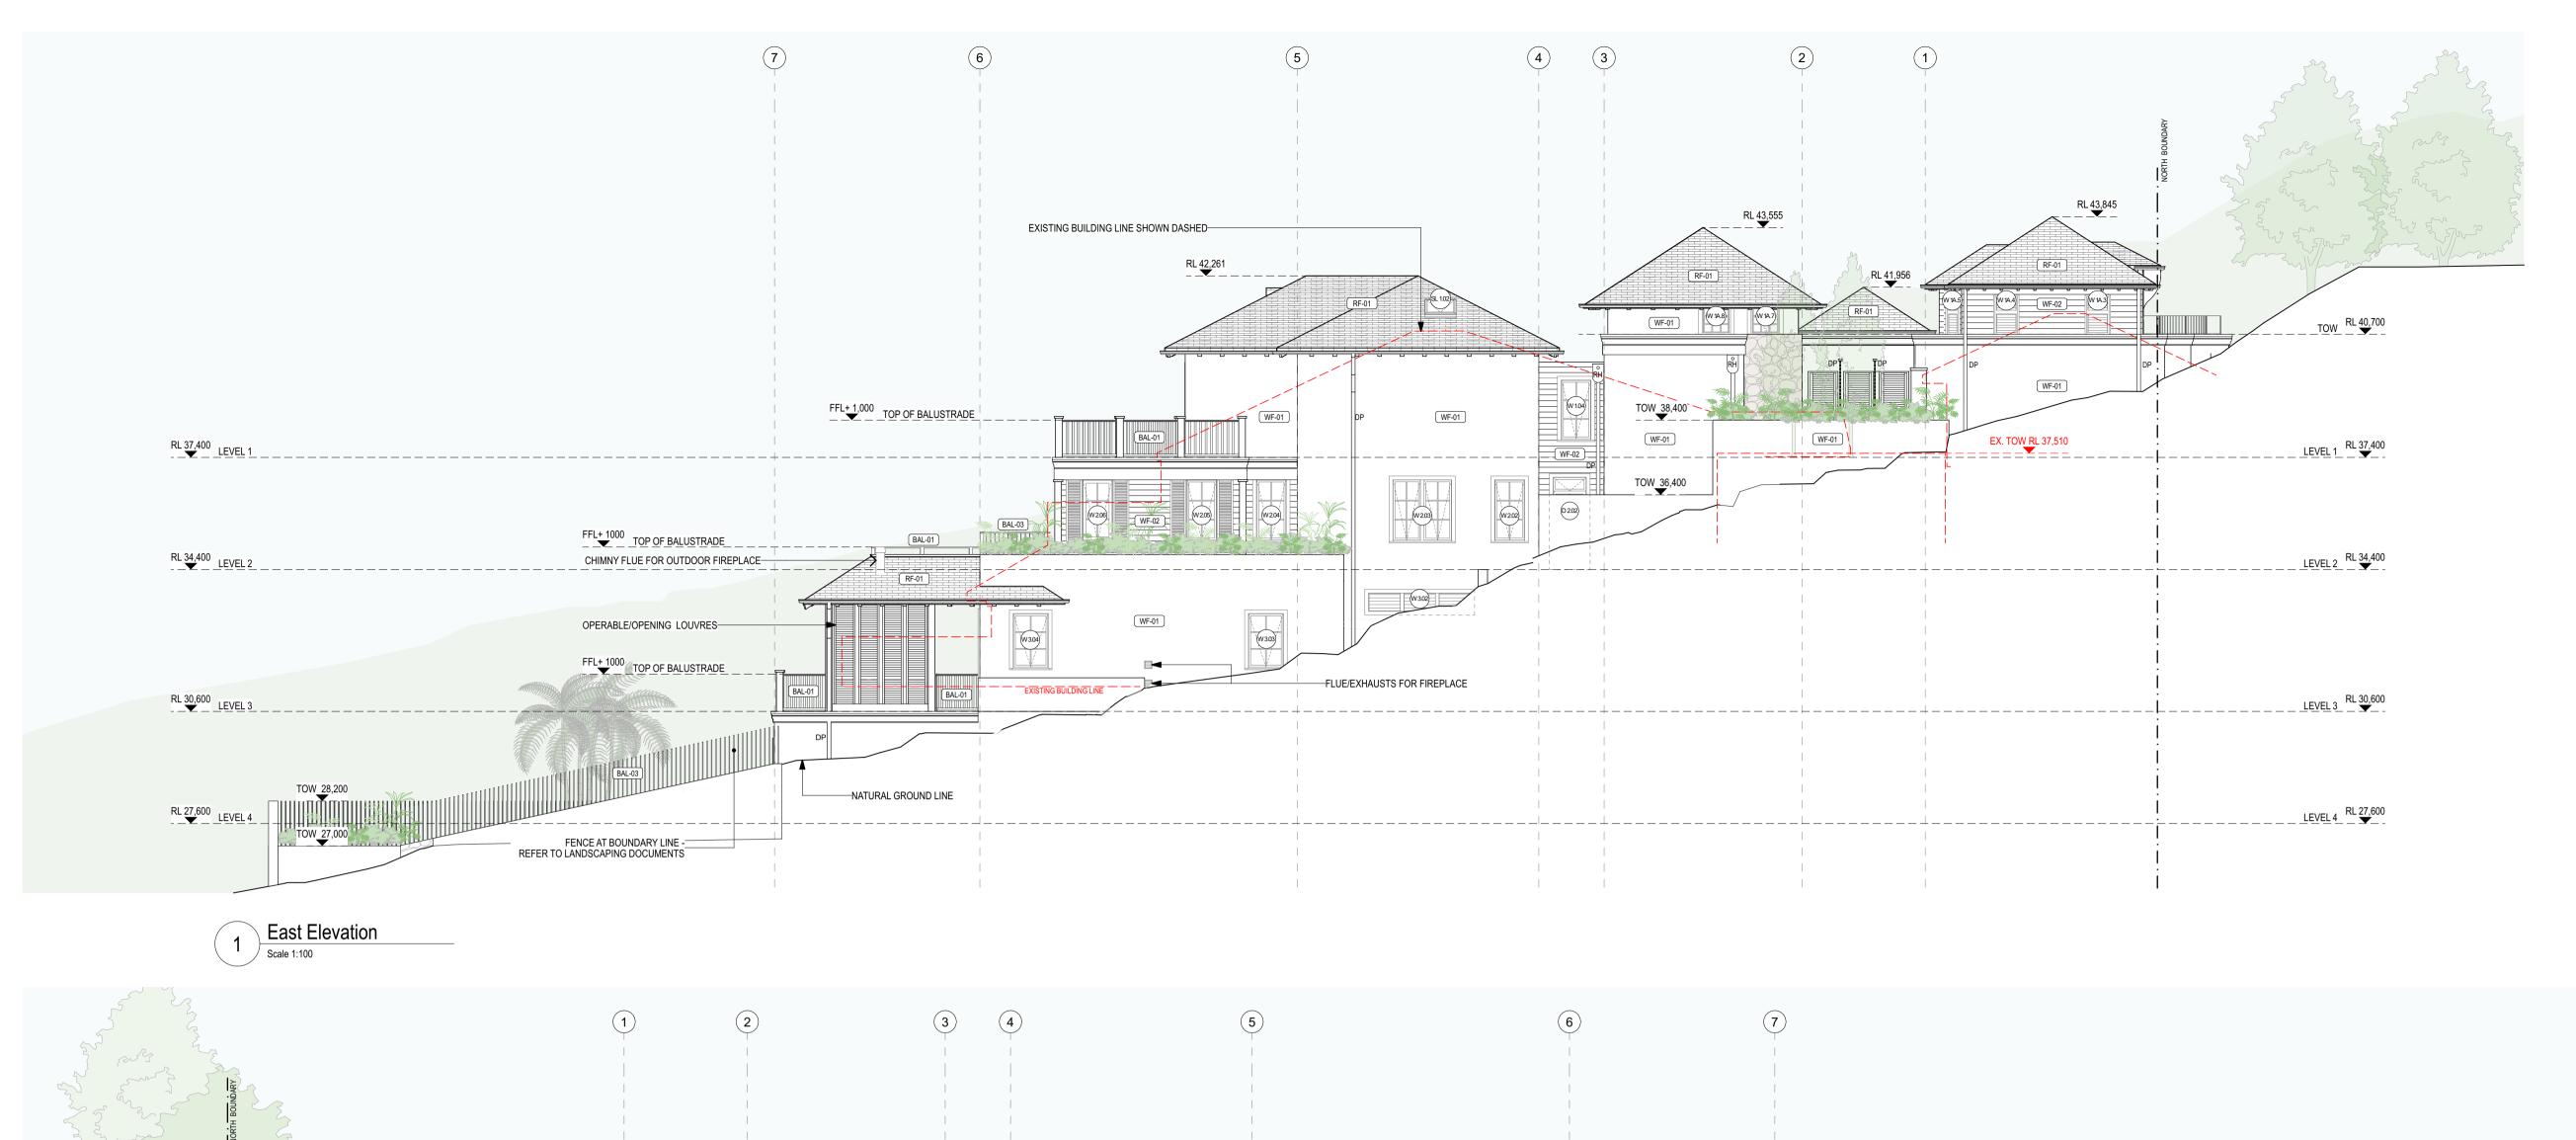

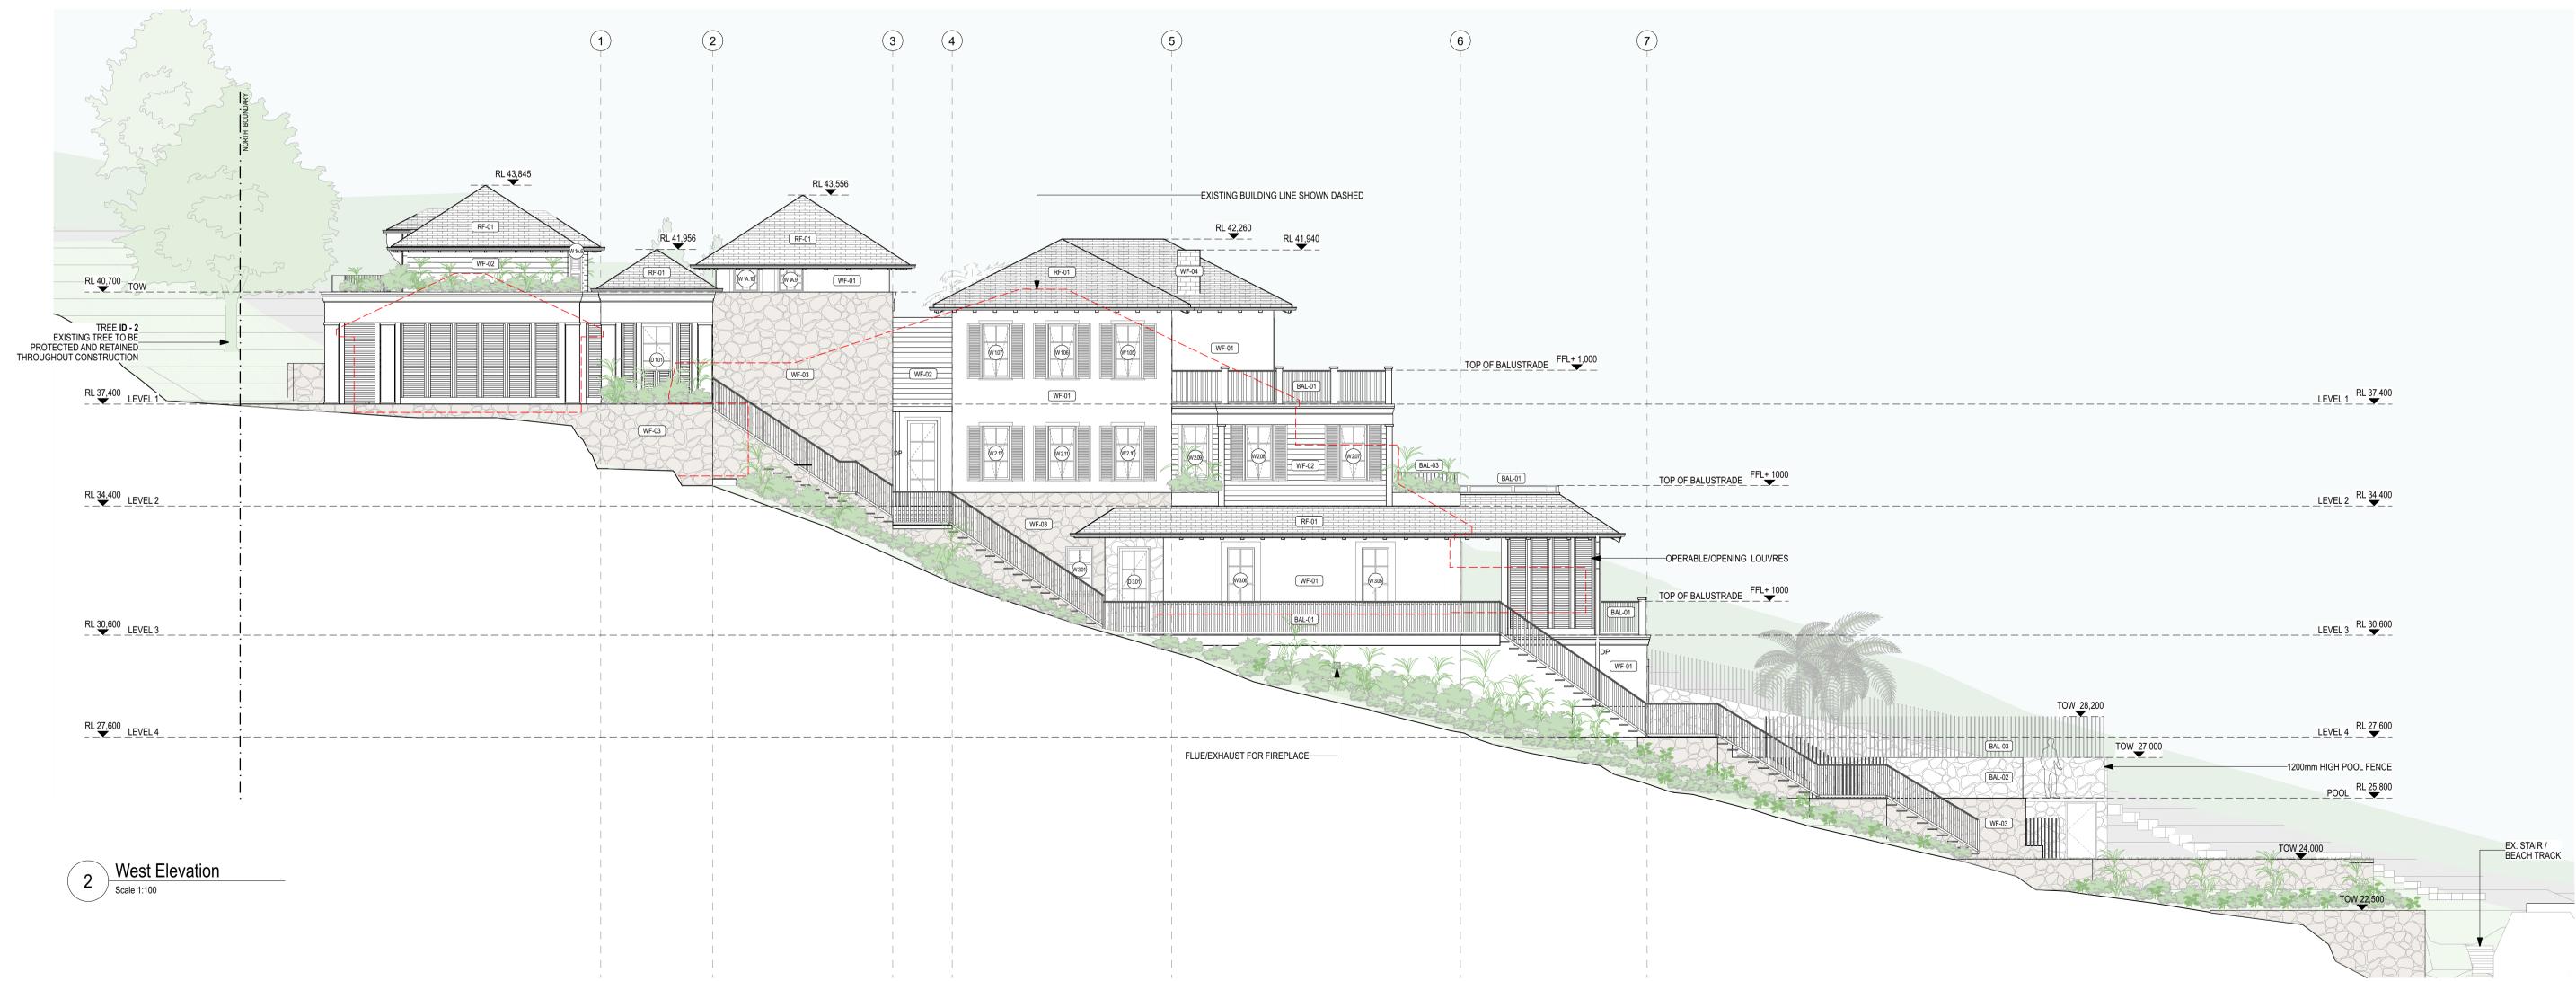Legend
WF-01 Cement Render Walls RF-01 Roof Finish 1 DP Down Pipe
WF-02 Timber Cladding RF-02 Metal Roof RH Rain Head
WF-03 Stone Cladding BAL-01 Timber Balustrade
WF-04 Chimny BAL-02 Glass Balustrade
BAL-03 Metal Balustrade

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A 2/12/2024 DA Submission
Project:
New Residence, Pool & Associated External Works
Client:
James & Anna Markham
Address:
287 Whale Beach Road, Palm Beach NSW 2107
Lot 187 | DP 15376
Drawing Title:
Elevations East & West
Stage:
Development Application
Scale:
1:100 @A1

Drawing Title:

Elevations East & West

Stage:

Development Application

Scale:

1:100 @A1

Drawn: Chkd:


GC NG

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Legend

—————— Outline of Existing

Area of non-compliance

Proposed Area of Site Fill
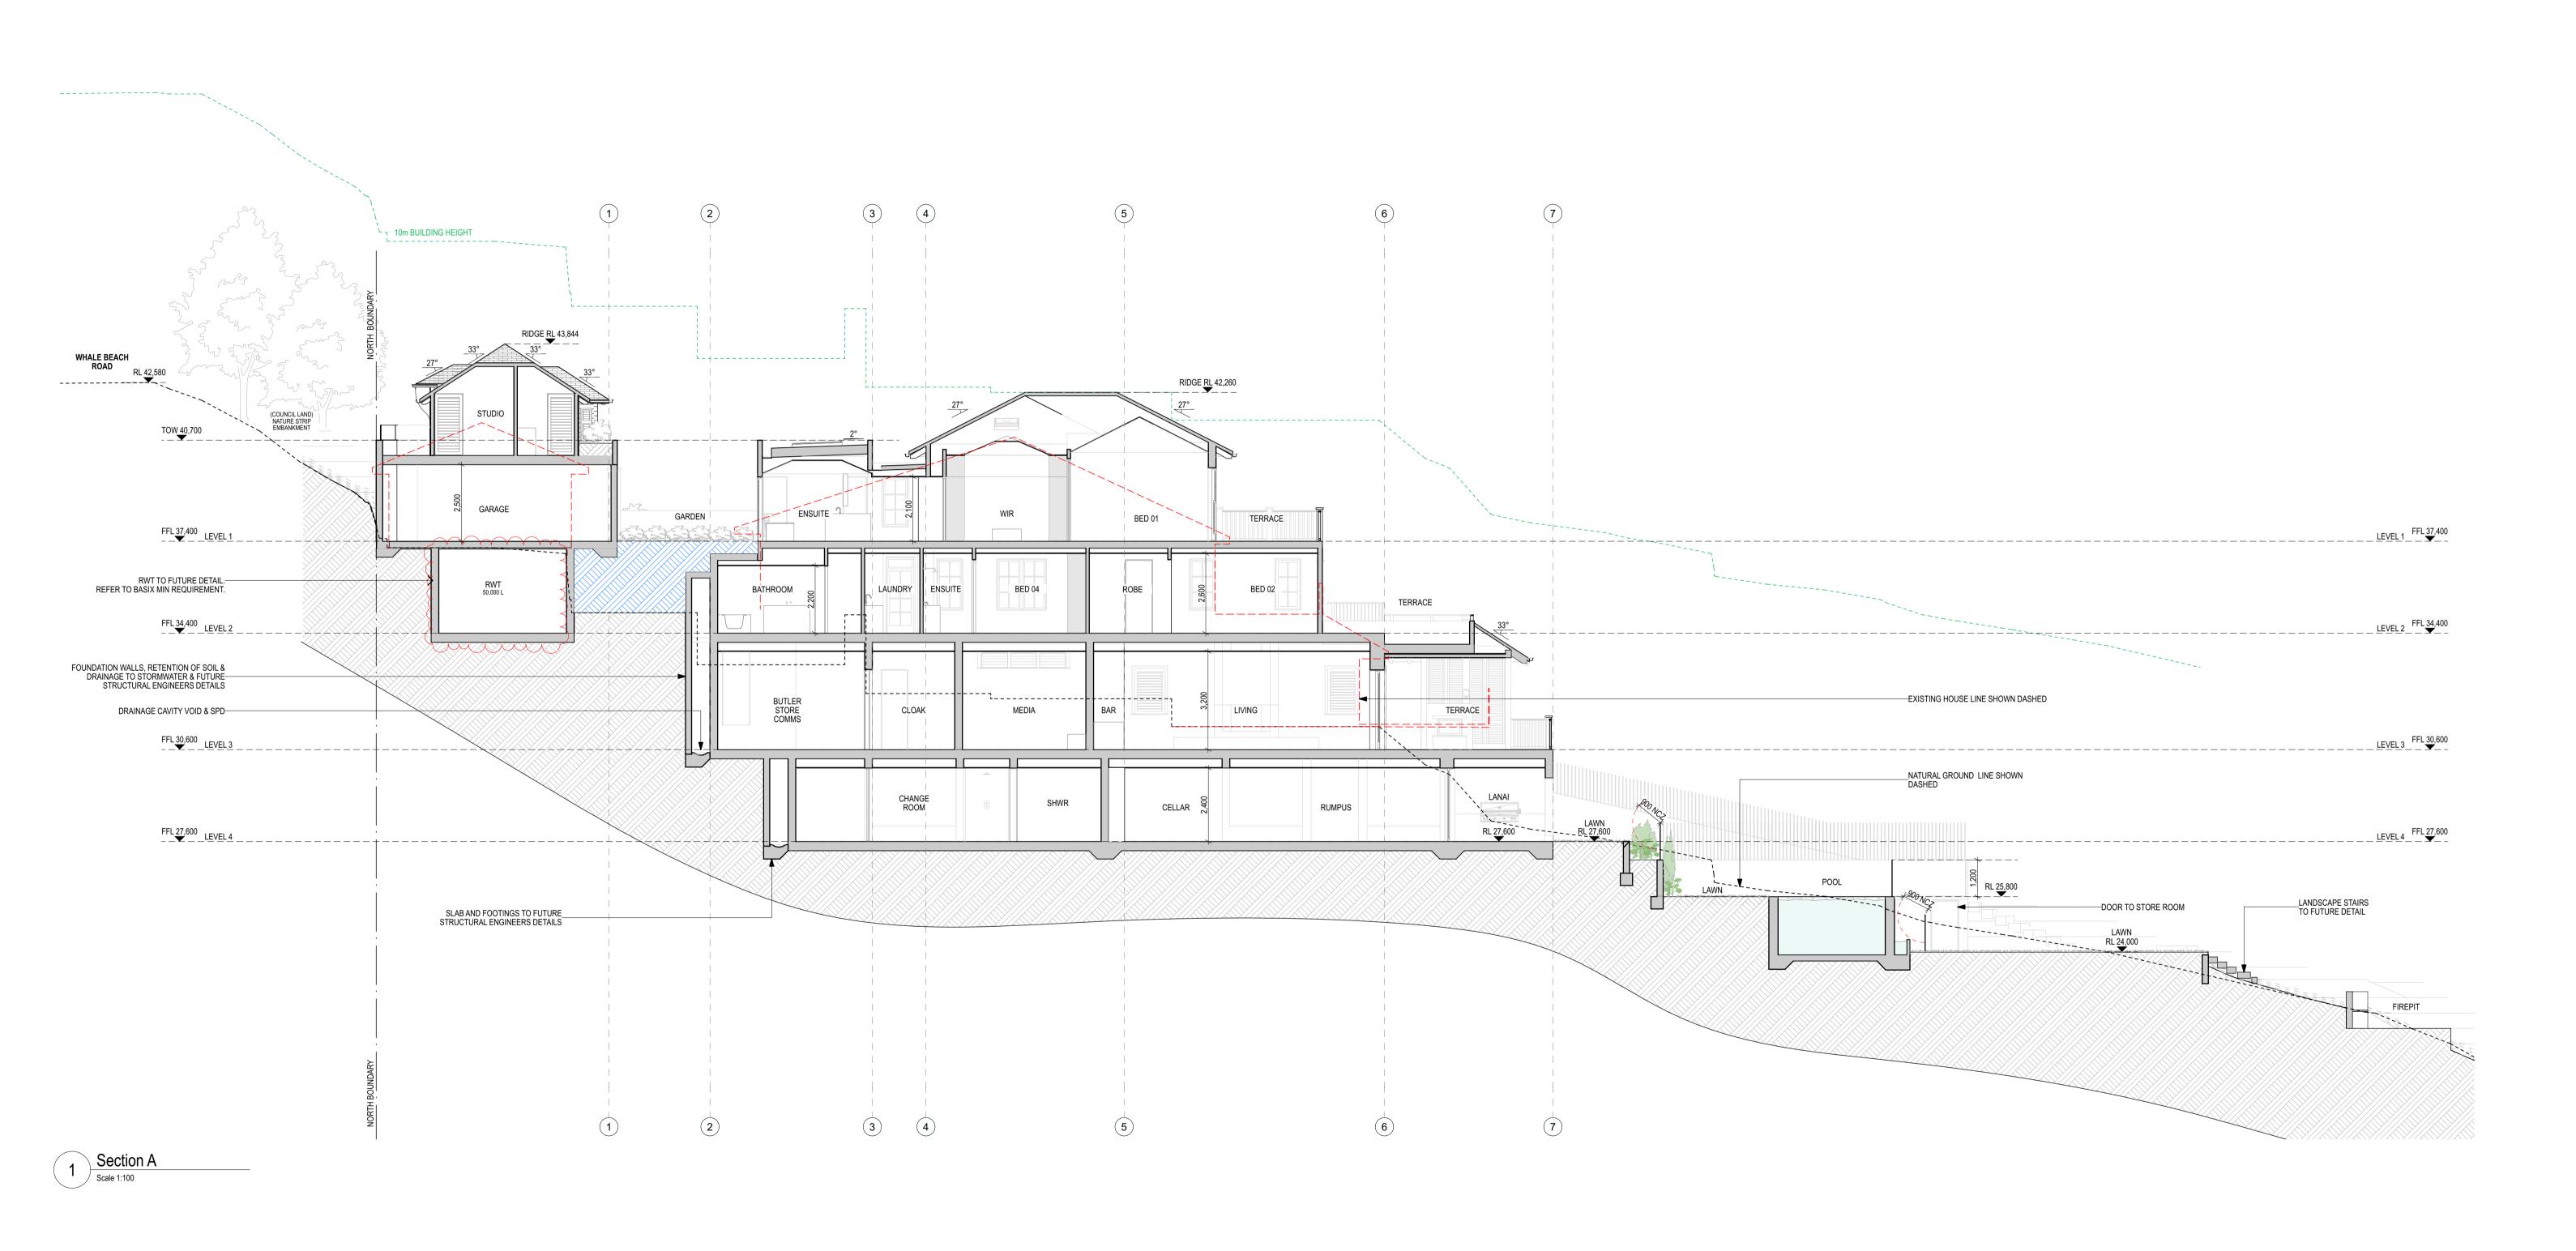
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Rev A	Date 2/12/2024	Issue DA Submission	Project: New Residence, Pool & Associated External Works	Drawing Section
			Client: James & Anna Markham	Stage: Develo
			Address: 287 Whale Beach Road, Palm Beach NSW 2107 Lot 187 DP 15376	Scale: 1:100 @

Drawing Title:

Section A

Stage:

Development Application

Scale:

1:100 @A1

Drawn: Chkd:

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Area of non-compliance
Proposed Area of Site Fill

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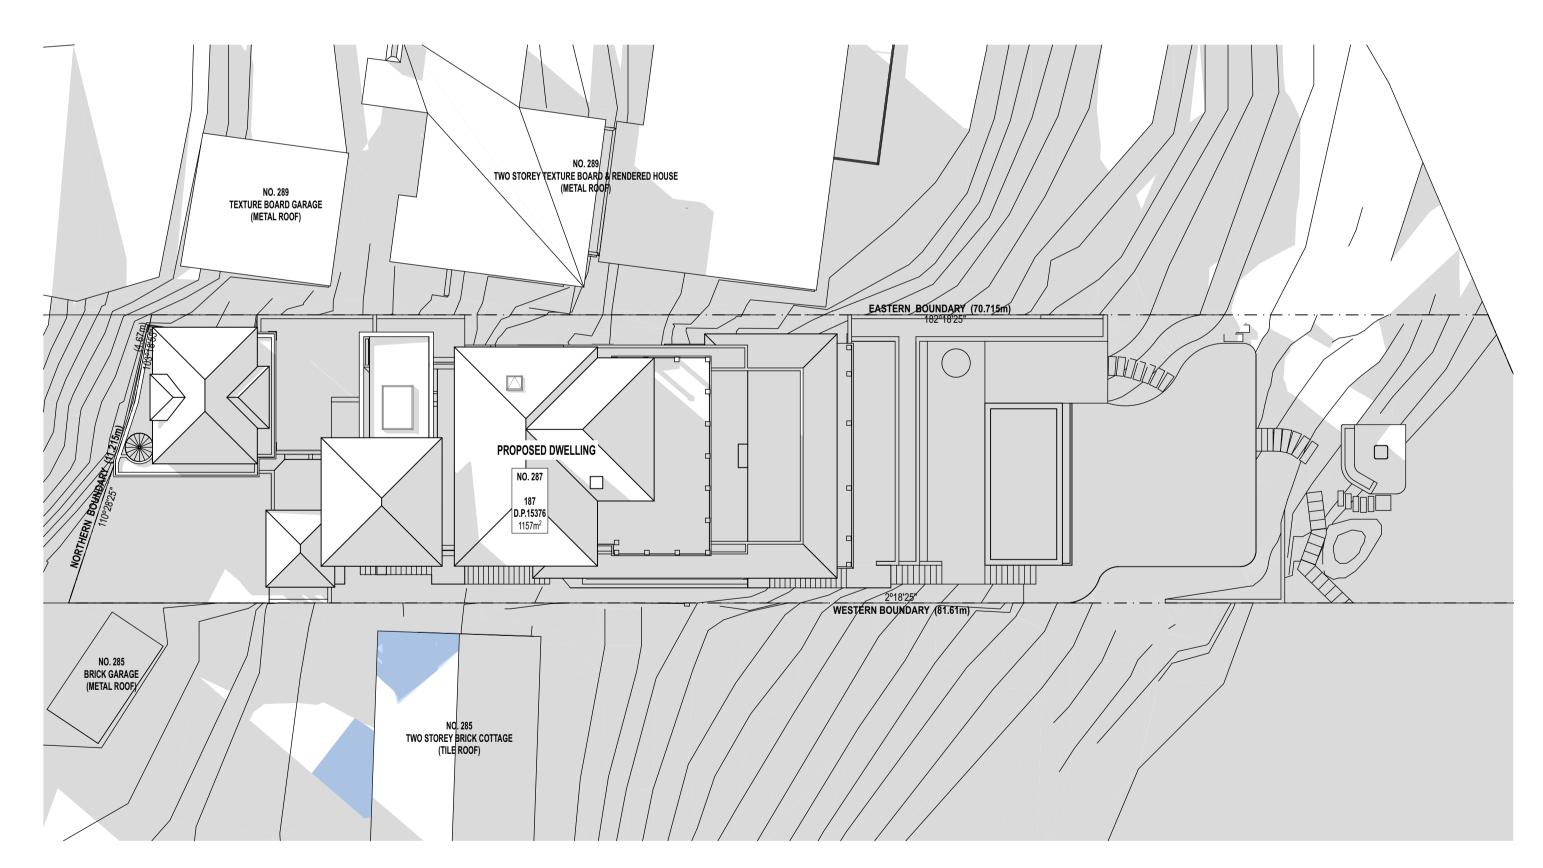
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Legend

---- Outline of Existing




Shadow Diagram 9am - Existing
Scale 1:200





Shadow Diagram 12pm - Existing
Scale 1:200

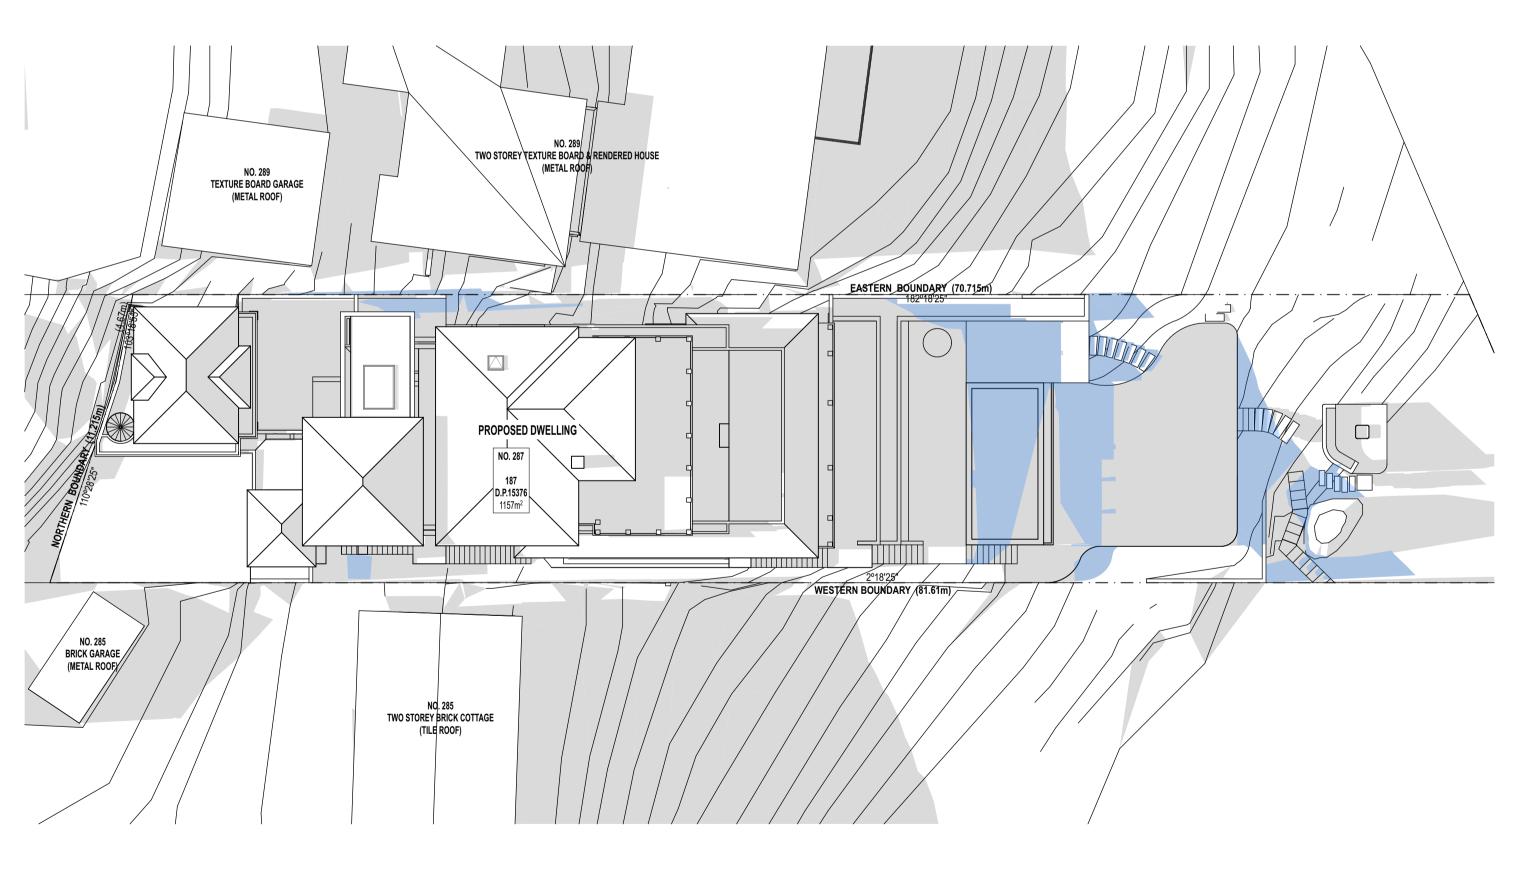

Reduced Level TOW Top of Wall Rain Head EG Eaves Gutter TOS Top of Stair BG Box Gutter FP Fireplace Copyright of design shown hereon is retained by Cadence & Co Pty Ltd and authority is required for any reproduction. This document may only be used for the express purpose for which it has been created and any unauthorised use is at the user's sole risk. Verify dimensions on site prior to commencement of work. Check existing RL's on site. Advise Cadence & Co Pty Ltd of any discrepancies before commencement.


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lev A	Date 2/12/2024	Issue DA Submission	Project: New Residence, Pool & Associated External Works	Drawing Title: Shadow Diagrams 1		I		CADENCE & CO DESIGN PTY Suite 7, 287 Mona Vale Road
			Client: James & Anna Markham	Stage: Development Application	_			Terrey Hills NSW 2084 P 02 9450 1950 E info@cadenceandco.com.au
			Address: 287 Whale Beach Road, Palm Beach NSW 2107 Lot 187 DP 15376	Scale: 1:200 @A1	Drawn: Chkd: GC NG	Sheet No: DA12	Rev:	ABN: 12 168 714 752 Nominated Architects: Michael Kilkeary NSW ARB 12302 Sam Samarghandi NSW ARB 9112 Copyright © CADENCE & CO DESIGN PTY LTD

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Shadow Diagram 3pm - Existing
Scale 1:200



Shadow Diagram 3pm - Proposed
Scale 1:200

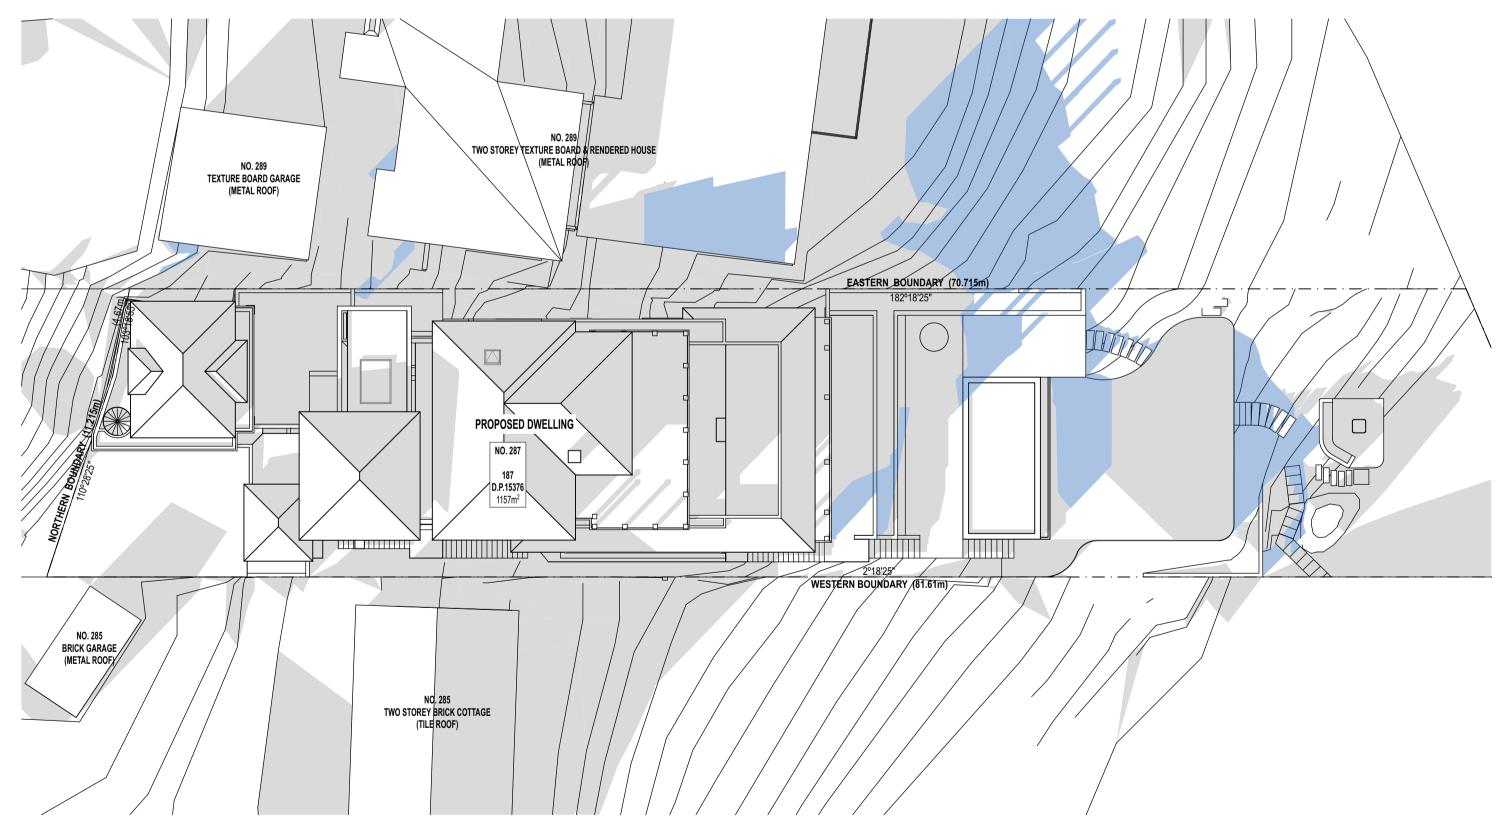


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А	2/12/2024	DA Submission	New Residence, Pool & Associated External Works	Shadow Diagrams 2	
			Client:	Stage:	
			James & Anna Markham	Development Appli	cation
			Address:	Scale:	[
			287 Whale Beach Road, Palm Beach NSW 2107 Lot 187 DP 15376	1:200 @A1	(

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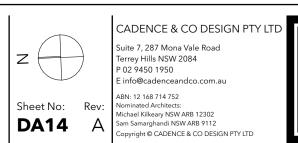







Rev	Date	Issue	Project:	Drawing ¹
A	2/12/2024	DA Submission	New Residence, Pool & Associated External Works	Excavat
			Client: James & Anna Markham	Stage: Develo
			Address: 287 Whale Beach Road, Palm Beach NSW 2107 Lot 187 DP 15376	Scale: 1:200 @
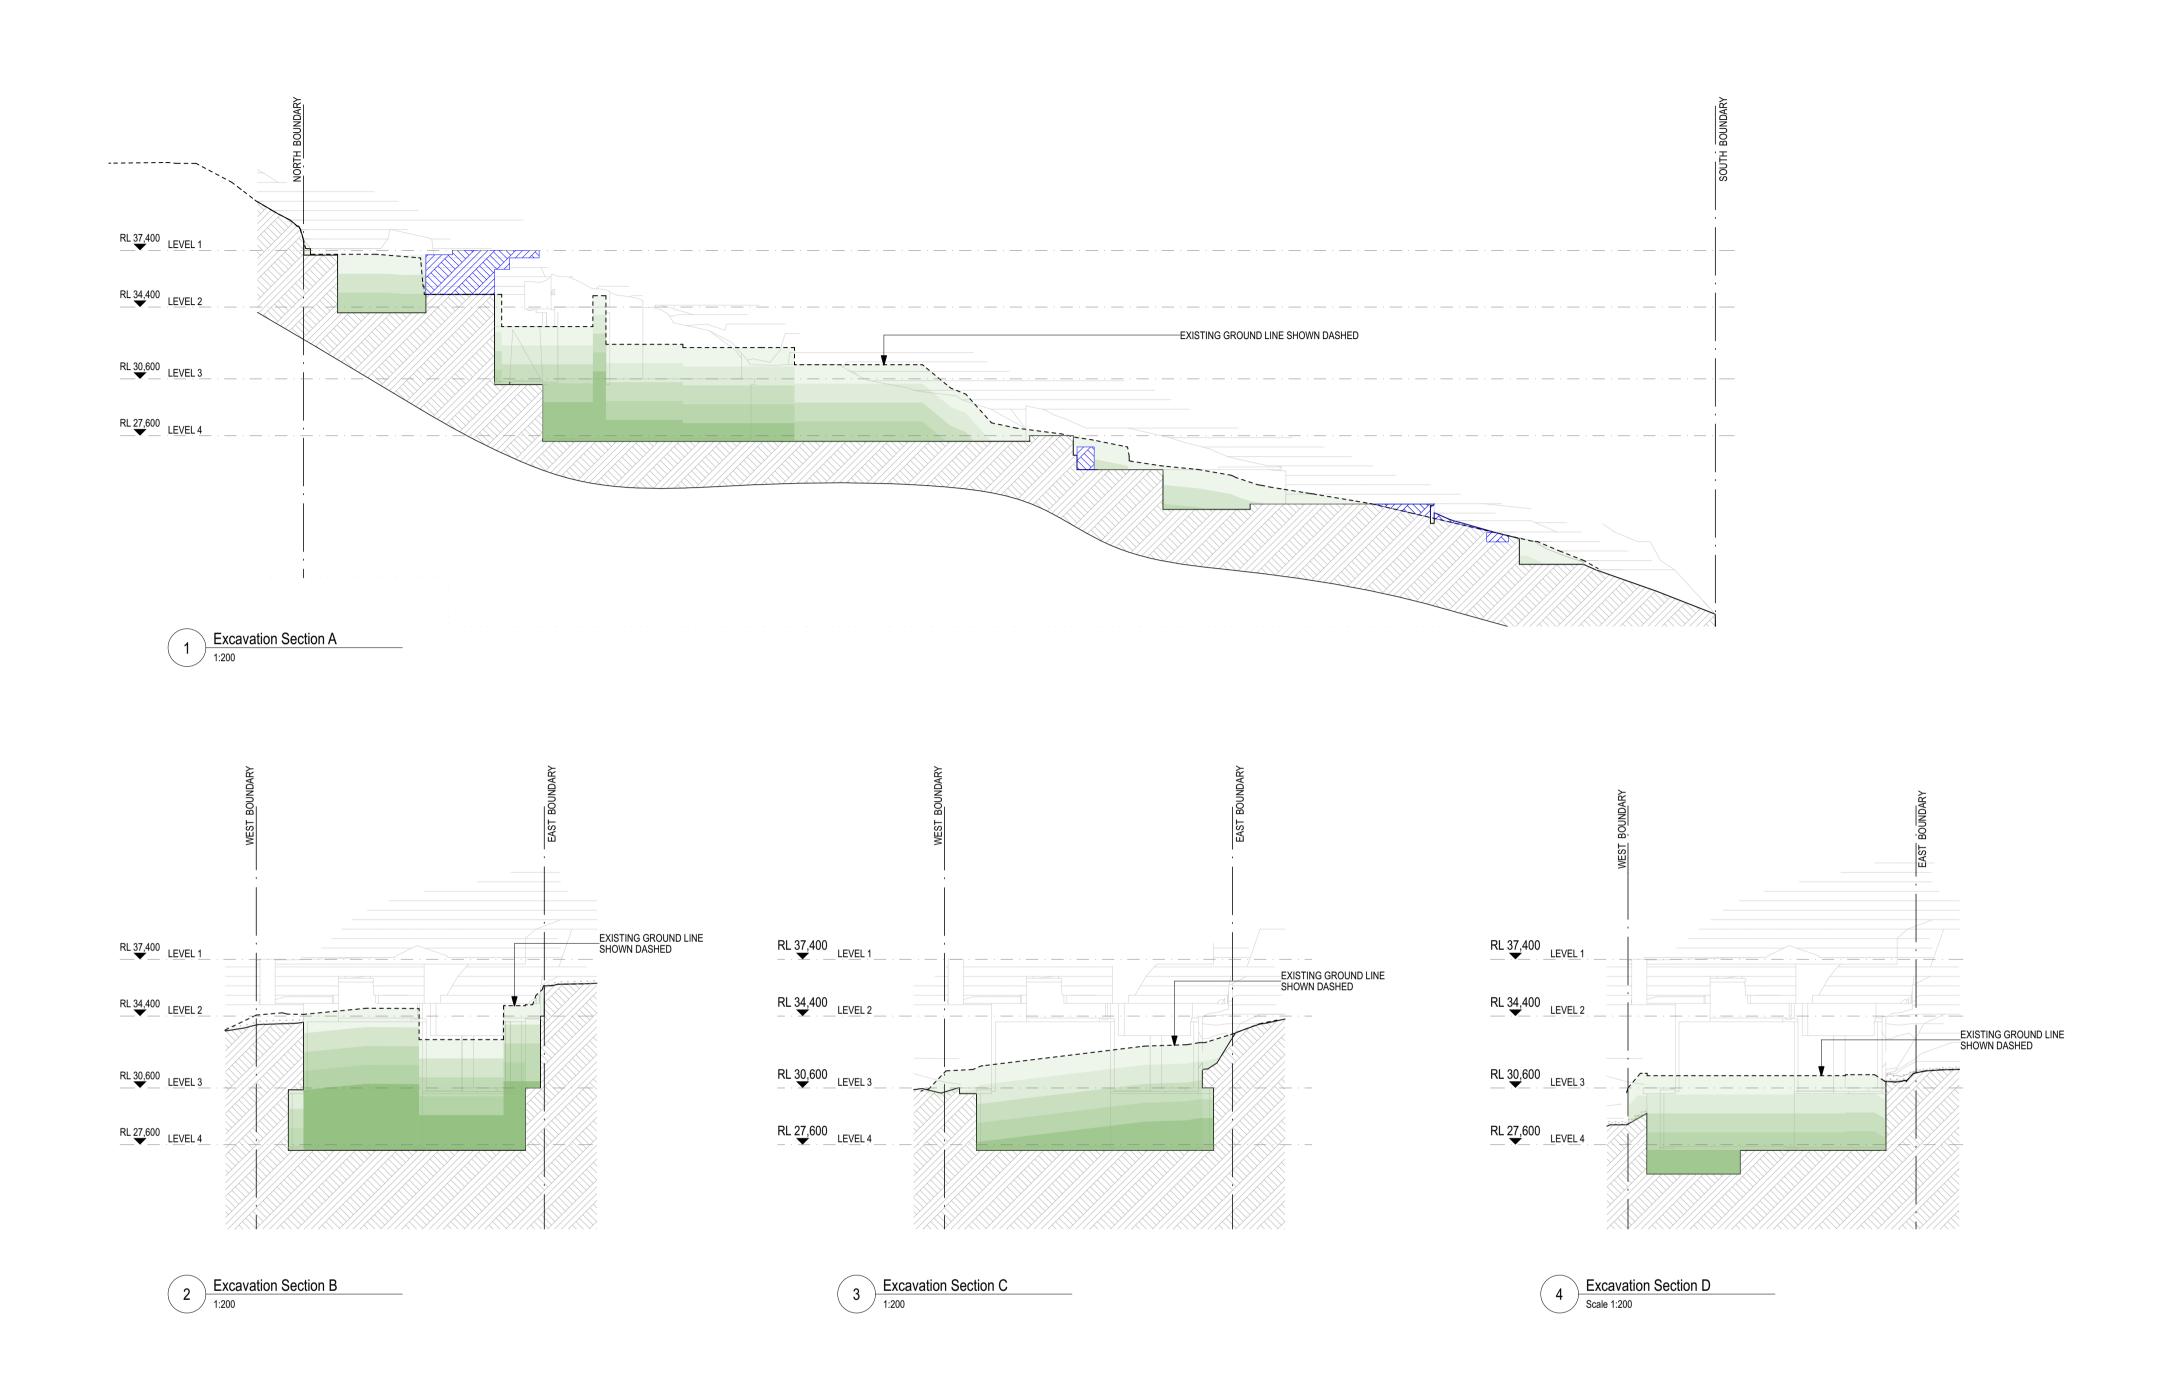
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velopment Application
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Drawn: Chkd:
O0 @A1
GC NG
DA14



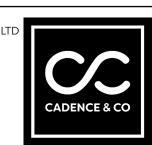











3 Southern Elevation


3D Perspectives Shown for Reference Only Landscape is Conceptual Only.


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 Date
 Issue


 A
 2/12/2024
 DA Submission
 Project:
New Residence, Pool & Associated External Works

Drawing Title:
3D Perspectives CADENCE & CO DESIGN PTY L Suite 7, 287 Mona Vale Road Terrey Hills NSW 2084 P 02 9450 1950 E info@cadenceandco.com.au Development Application James & Anna Markham Sheet No: Rev:


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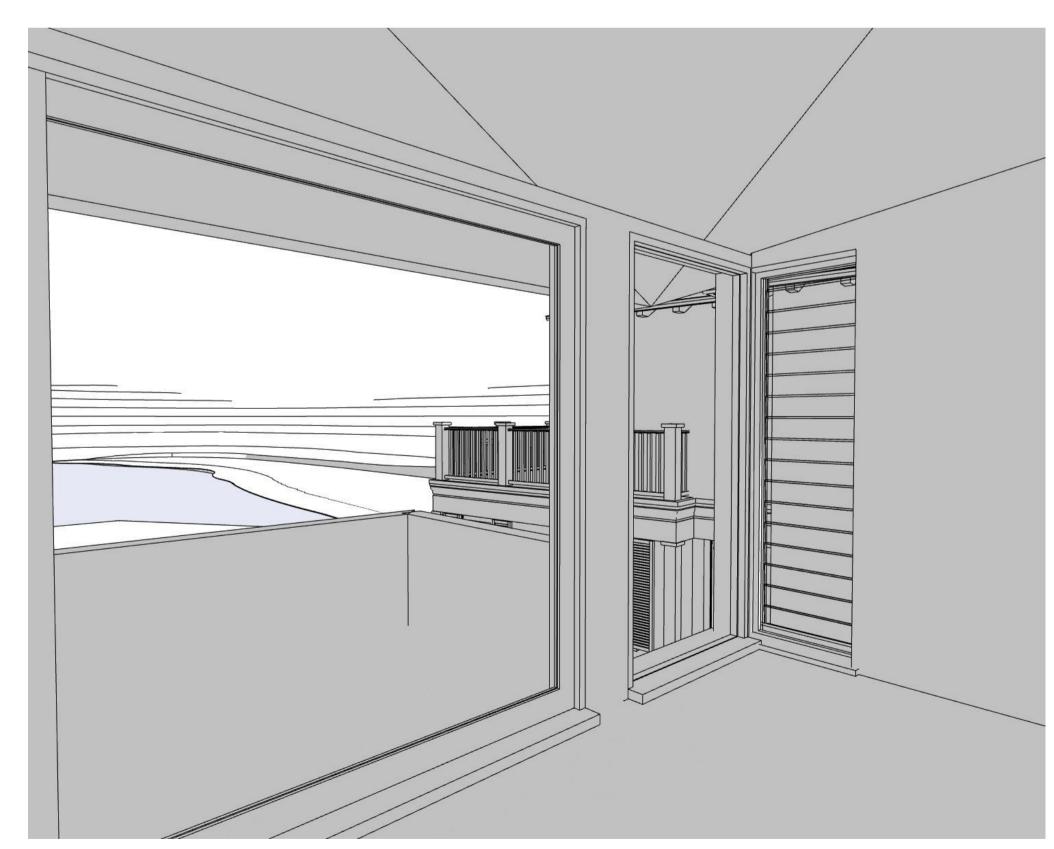


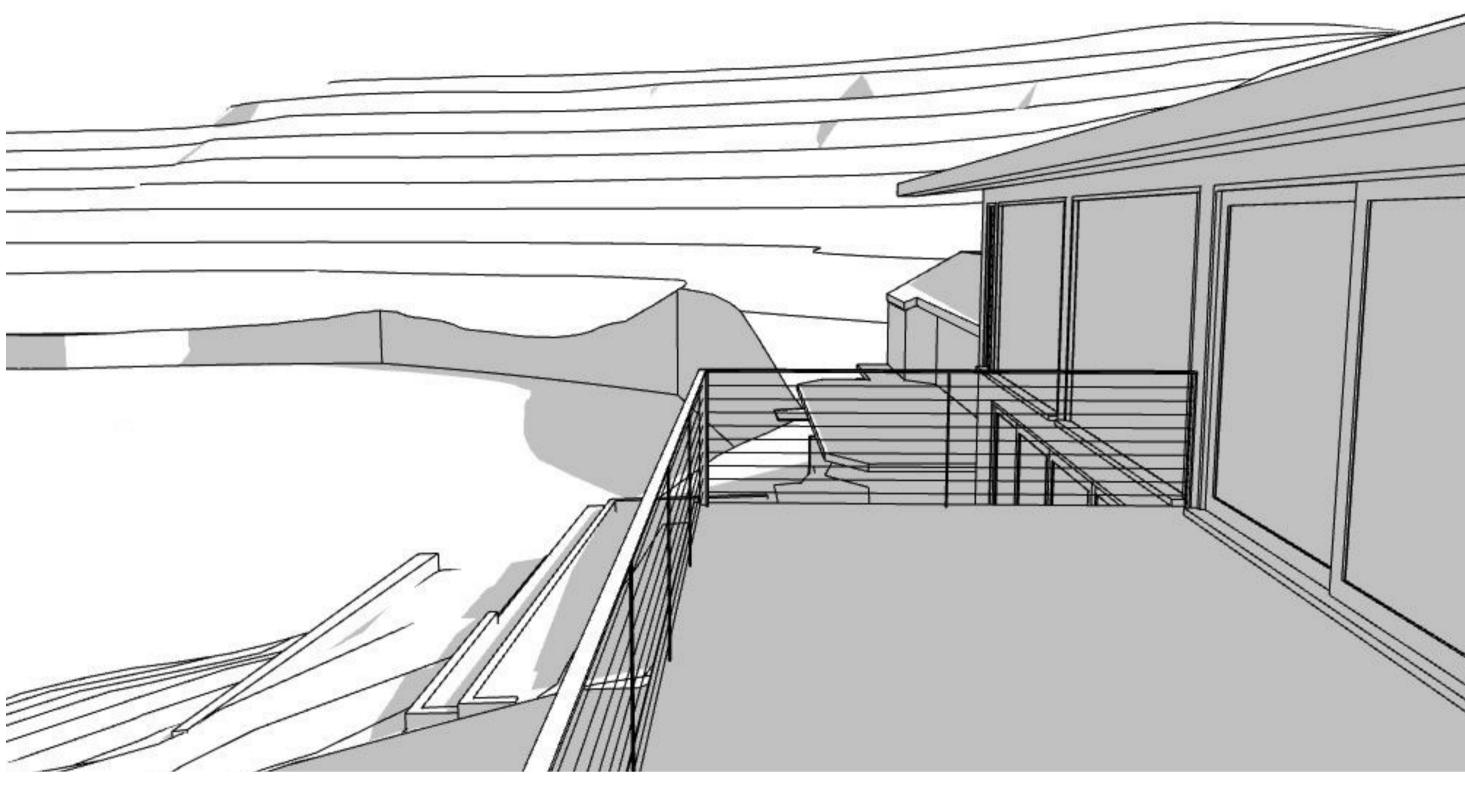

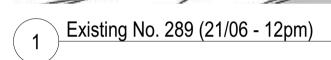3D Perspectives shown for reference only

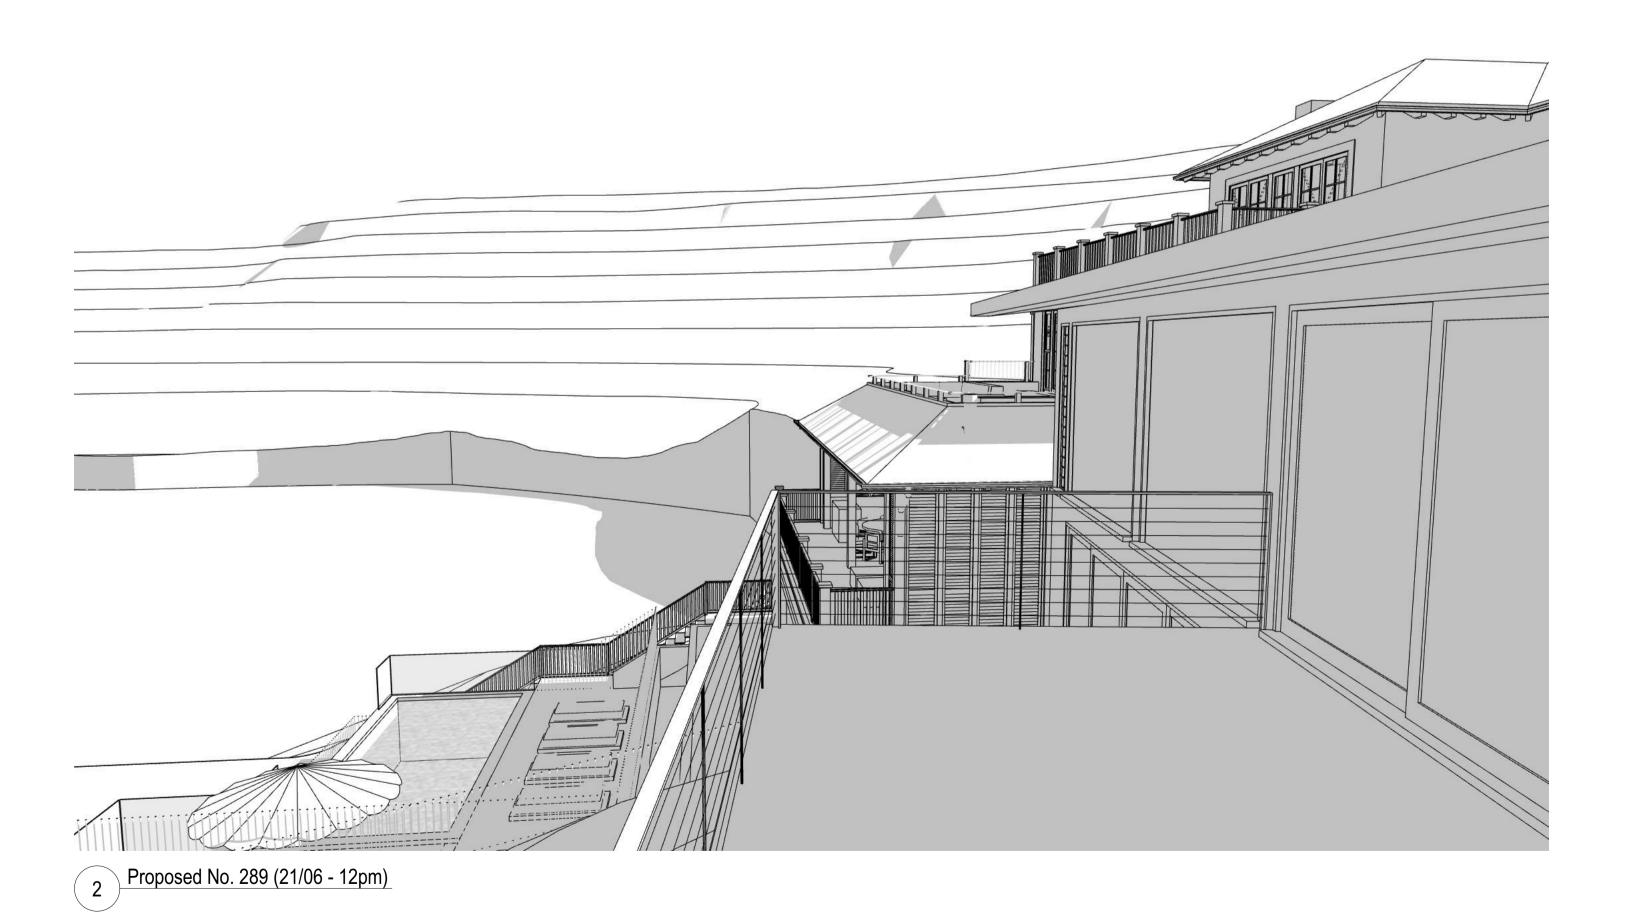

3 Existing No. 289 (21/06 - 12pm)

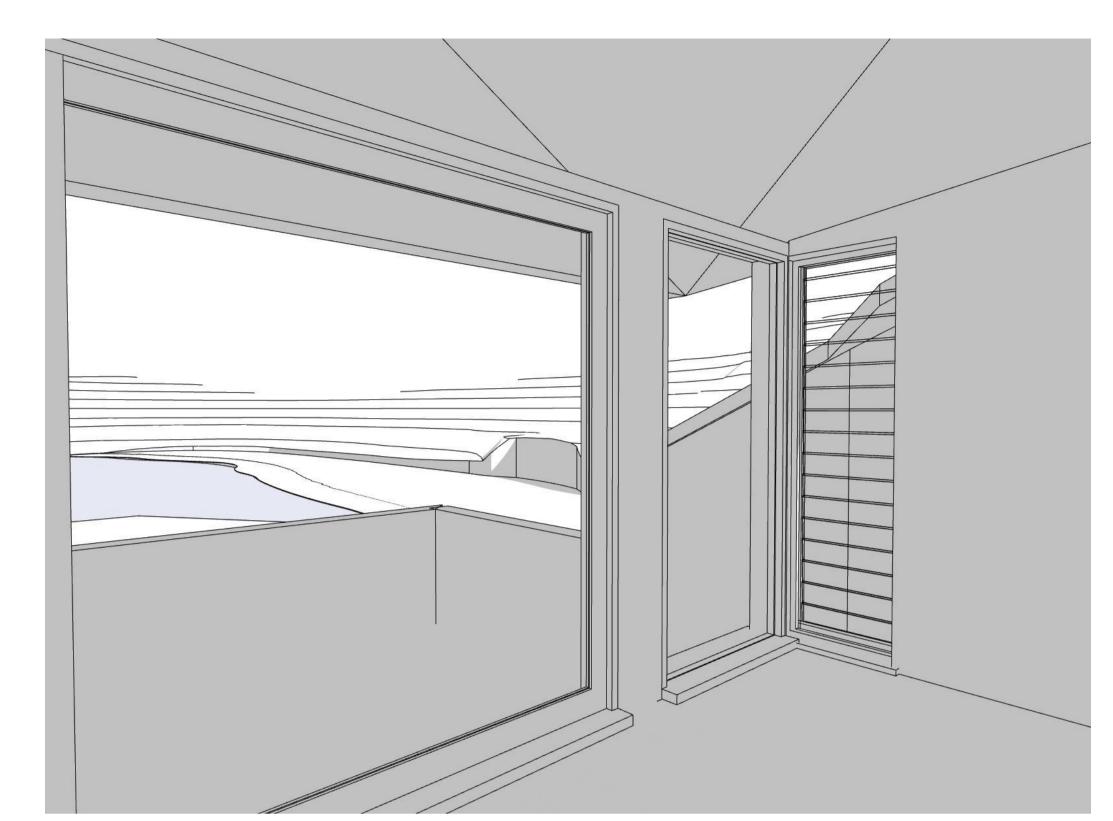

4 Proposed No. 289 (21/06 - 12pm)

egend						
WF-01	Cement Render Walls	RF-01	Roof Finish 1	DP	Down Pipe	
WF-02	Timber Cladding	RF-02	Metal Roof	RH	Rain Head	
WF-03	Stone Cladding	BAL-01	Timber Balustrade	RL	Reduced Level	
WF-04	Chimny	BAL-02	Glass Balustrade	TOW	Top Of Wall	

BAL-03 Metal Balustrade

 Rev
 Date
 Issue


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 2/12/2024
 DA Submission
 James & Anna Markham

Project:
New Residence, Pool & Associated External Works

Drawing Title:
3D Neighbours Perspectives 1 Development Application 287 Whale Beach Road, Palm Beach NSW 2107 Lot 187 | DP 15376 @A1

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1 Existing No. 285 (21/06 - 12pm)

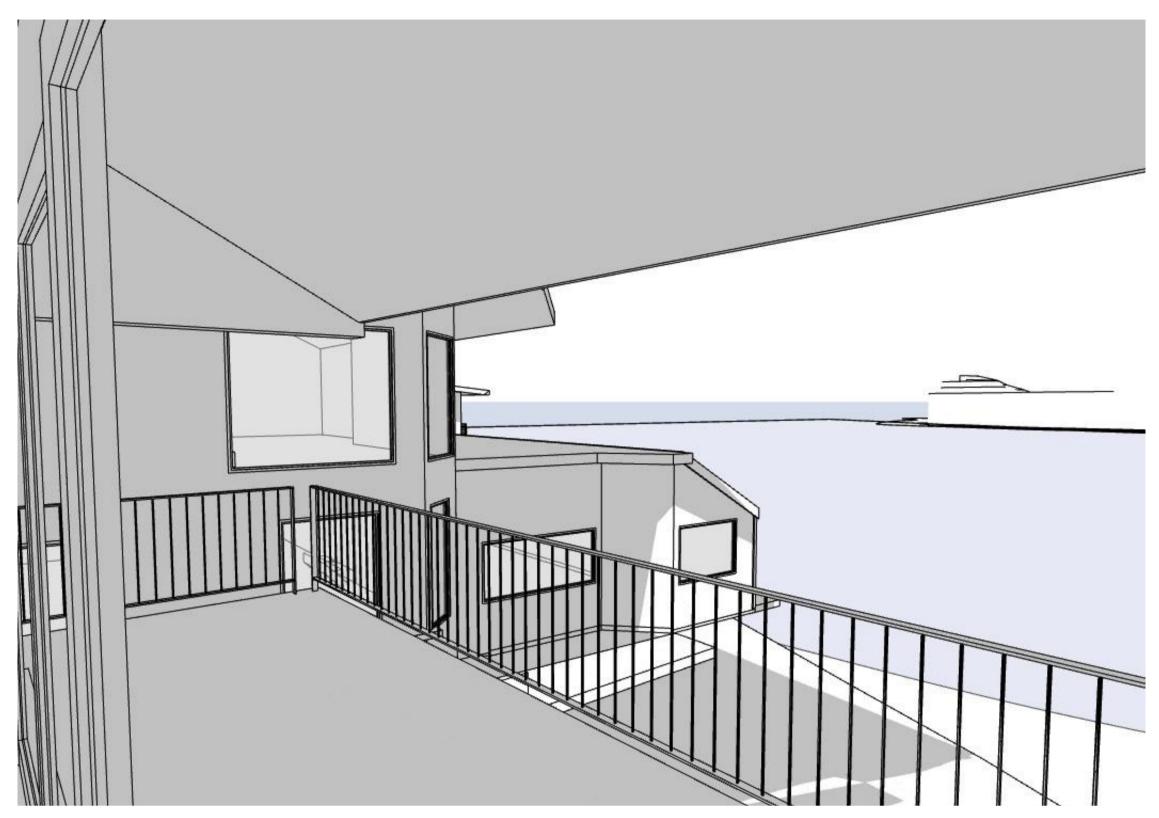

Proposed No. 285 (21/06 - 12pm)



3 Existing No. 274 (21/06 - 12pm)



4 Proposed No. 274 (21/06 - 12pm)

Legend					
•					
WF-01	Cement Render Walls	RF-01	Roof Finish 1	DP	Down Pipe
WF-02	Timber Cladding	RF-02	Metal Roof	RH	Rain Head
WF-03	Stone Cladding	BAL-01	Timber Balustrade	RL	Reduced Level
	3			TOW	Top Of Wall
M = 0.4	Chimny	DAI 02	Class Palustrada	1000	10p Oi vvaii

Perspectives shown for reference only

Rev Date Issue
A 2/12/2024 DA Submission Project:


New Residence, Pool & Associated External Works

Drawing Title:

3D Neighbours Perspectives 2 James & Anna Markham 287 Whale Beach Road, Palm Beach NSW 2107 Lot 187 | DP 15376

Development Application 1:1.25 @A1

CADENCE & CO DESIGN PTY L Suite 7, 287 Mona Vale Road Terrey Hills NSW 2084 P 02 9450 1950 E info@cadenceandco.com.au Drawn: Chkd: Sheet No: Rev: ABN: 12 168 714 752
Nominated Architects: Michael Kilkeary NSW ARB 12302
Sam Samarghandi NSW ARB 9112
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Window Schedule Studio above	Garage											
View from Reveal Side	600	600	**************************************	\$ 600 \rightarrow 600 \rightar	→ 300 → → → 300 → → → → → → → → → → → →	* 300 * * * * * * * * * * * * * * * * *	760	760	760	760	760	760
ID	W 1A.1	W 1A.2	W 1A.3	W 1A.4	W 1A.5	W 1A.6	W 1A.7	W 1A.8	W 1A.9	W 1A.10	W 1A.11	W 1A.12
Unit Dimensions (WxH)	600×650	600×650	600×1,000	600×1,000	300×1,000	300×1,000 500	760×760	760×760	760×760	760×760	760×760	760×760 3300 (from L1)
Sill/Header Value	950	950	500	500	500		3300 (from L1)	3300 (from L1)				
Location	Caretaker's Studio. North facing.	Caretaker's Studio. North facing.	Caretaker's Studio. East Facing.	Caretaker's Studio. East Facing.	Caretaker's Studio. East Facing.	Caretaker's Studio.West Facing.	Above Entry Hall. East Facing.	Above Entry Hall. East Facing.	Above Entry Hall. West Facing.	Above Entry Hall. West Facing.	Above Entry Hall. North Facing.	Above Entry Hall. North Facing.
Story Story Parformance	Roof	Roof	Roof	Roof	Roof	Roof	Roof	Roof	Roof	Roof	Roof	Roof
Glazing/BASIX Performance Frame/Material/Finish	Double Glazed. Timber Frame.	Double Glazed. Timber Frame.	Timber Louver. Timber Frame.	Timber Louver. Timber Frame.	Timber Louver. Timber Frame.	Timber Louver. Timber Frame.	Double Glazed. Timber Frame.	Double Glazed. Timber Frame.	Double Glazed. Timber Frame.	Double Glazed. Timber Frame.	Double Glazed. Timber Frame.	Double Glazed. Timber Frame.
Area of Glass + Frame	0.39	0.39	0.60	0.60	0.30	0.30	0.58	0.58	0.58	0.58	0.58	0.58
Tyne/Operation	Horizontal Pivot.	Horizontal Pivot.	Louver.	Louver.	Louver.	Louver.	Horizontal Pivot.	Horizontal Pivot.				
Type/Operation Interior Window Treatment	FIOREORIAI FIVOL	TIONZONIAI FIVOL	Louvei.	Louvei.	Louvei.	Louvei.	TIONZONIAI FIVOL	Honzontal Fivot.	TIONZONIAI FIVOL	FIOREORIAI FIVOL	FIOREORIAI FIVOL	Honzontal Fivot.
Additional Comments		1			+							
Hardware Detail												

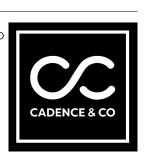Window Schedule			T												I
View from Reveal Side	2,700	860	860	860	860	860	860	1.995	5300	860	860	1.633	880	880	860
ID (M/ II)	W 1.01	W 1.02	W 1.03	W 1.04	W 1.05	W 1.06	W 1.07	W 1.08	W 1.09	W 2.01	W 2.02	W 2.03	W 2.04	W 2.05	W 2.06
Unit Dimensions (WxH) Sill/Header Value	2,700×2,300	860×1,640 2,100	860×1,640	860×1,640	860×1,640 750	860×1,640	860×1,640	1,995×2,300	565×2,300	860×1,680 750	860×1,680 750	1,633×1,680	860×1,680 750	860×1,680 750	860×1,680 750
Location	Entry. East Facing.	Bed 01 Ensuite. North Facing.	Bed 01 Ensuite. South Facing.	Bed 01 Ensuite. East Facing.	Study. West Facing.	Study. West Facing.	Study. West Facing.	Entry. North Facing.	Entry. West Facing.	Bunks. South Facing.	Bed 04 Ensuite. East Facing.	Bed 04. East Facing.	Bed 02 Ensuite. East Facing.	Bed 02. East Facing.	Bed 02. East Facing.
Story	Level 1	Level 1	Level 1	Level 1	Level 1	Level 1	Level 1	Level 1	Level 1	Level 2	Level 2	Level 2	Level 2	Level 2	Level 2
Glazing/BASIX Performance	Double Glazed.	Double Glazed.	Double Glazed.	Double Glazed.	Double Glazed.	Double Glazed.	Double Glazed.	Double Glazed.	Double Glazed.	Double Glazed.	Double Glazed.	Double Glazed.	Double Glazed.	Double Glazed.	Double Glazed.
Frame/Material/Finish	Timber Frame.	Timber Frame.	Timber Frame.	Timber Frame.	Timber Frame.	Timber Frame.	Timber Frame.	Timber Frame.	Timber Frame.	Timber Frame.	Timber Frame.	Timber Frame.	Timber Frame.	Timber Frame.	Timber Frame.
Area of Glass + Frame	6.21	1.41	1.41	1.41	1.41	1.41	1.41	4.59	1.30	1.44	1.44	2.74	1.44	1.44	1.44
Type/Operation	Double Hung.	Awning.	Awning.	Awning.	Awning.	Awning.	Awning.	Double Hung.	Double Hung.	Awning.	Awning.	Awning.	Awning.	Awning.	Awning.
1) por o poradion															
Interior Window Treatment															
Interior Window Treatment Additional Comments Hardware Detail															


				1	The state of the s							
ew from Reveal Side	860	860	860	1640	860	1400 4 008	2,800	1,000	1,000	860	860	2,935
ID W 2.07	W 2.08	W 2.09	W 2.10	W 2.11 860×1.640	W 2.12	W 3.01	W 3.02	W 3.03	W 3.04	W 3.05	W 3.06	W 4.01
hit Dimensions (WxH) 860×1,680 Sill/Header Value 750	860×1,680	860×1,680 750	860×1,640	860×1,640 750	860×1,640	800×1,400 1,200	2,800×550 2,650	1,000×1,500	1,000×1,500 1 150	860×1,700	860×1,700	2,935×2,400
Location Bed 03. West Facing.	Bed 03. West Facing.	Bed 03 Ensuite. West Facing.	Study. West Facing.	Bed 05. West Facing.	Bed 05. West Facing.	Pantry. South Facing.	Media. East Facing.	Living. East Facing	Living. East Facing	Kitchen, West Facing.	Kitchen, West Facing,	Indoor Pool. South Facing.
Story Level 2	Level 2	Level 2	Level 2	Level 2	Level 2	Level 3	Level 3	Level 3	Level 3	Level 3	Level 3	Level 4
g/BASIX Performance Double Glazed.	Double Glazed.	Double Glazed.	Double Glazed.	Double Glazed.	Double Glazed.	Double Glazed.	Timber Louver.	Double Glazed.	Double Glazed.	Double Glazed.	Double Glazed.	Double Glazed.
ne/Material/Finish Timber Frame.	Timber Frame.	Timber Frame.	Timber Frame.	Timber Frame.	Timber Frame.	Timber Frame.	Timber Frame.	Timber Frame.	Timber Frame.	Timber Frame.	Timber Frame.	Timber Frame.
of Glass + Frame 1.44	1.44	1.44	1.41	1.41	1.41	1.12	1.54	1.50	1.50	1.46	1.46	7.04
Type/Operation Awning.	Awning.	Awning.	Awning.	Awning.	Awning.	Double Hung.	Louver.	Awning.	Awning.	Double Hung.	Double Hung.	
or Window Treatment ditional Comments Hardware Detail												Glazing to meet pool fence requirements.

Window Schedule - Skylights			
View from Reveal Side	2,290	800	8,250
ID	SL 1.01	SL 1.02	SL 2.02
Opening W x H Size	2,290×1,600	800×800	8,250×588
Location	Above Bed 01 Ensuite	Above WIR	Above Gym level 4
Story	Level 1a Studio	Level 1a Studio	Level 3
Glazing/BASIX Performance			
Frame/Material/Finish			
Shell/Roof Opening Area	3.66	0.64	4.85
Type/Operation	(Operable)		
Interior Window Treatment			
Additional Comments			
Hardware Detail			

_egend WF-01	Cement Render Walls	RF-01	Roof Finish 1	DP	Down Pipe
VVF-U I	Cement Kender Wans	KF-U I	KOOI FIIIISII I		'
WF-02	Timber Cladding	RF-02	Metal Roof	RH	Rain Head
WF-03	Stone Cladding	BAL-01	Timber Balustrade	RL	Reduced Level
WF-04	3	BAL-02	Glass Balustrade	TOW	Top Of Wall
		BAL-03	Metal Balustrade		
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Rev	Date	Issue	Project:	Drawing Titl
Α	2/12/2024	DA Submission	New Residence, Pool & Associated External Works	Window S
			Client:	Stage:
			James & Anna Markham	Developn
			Address:	Scale:
			287 Whale Beach Road, Palm Beach NSW 2107 Lot 187 DP 15376	1:1 @A1



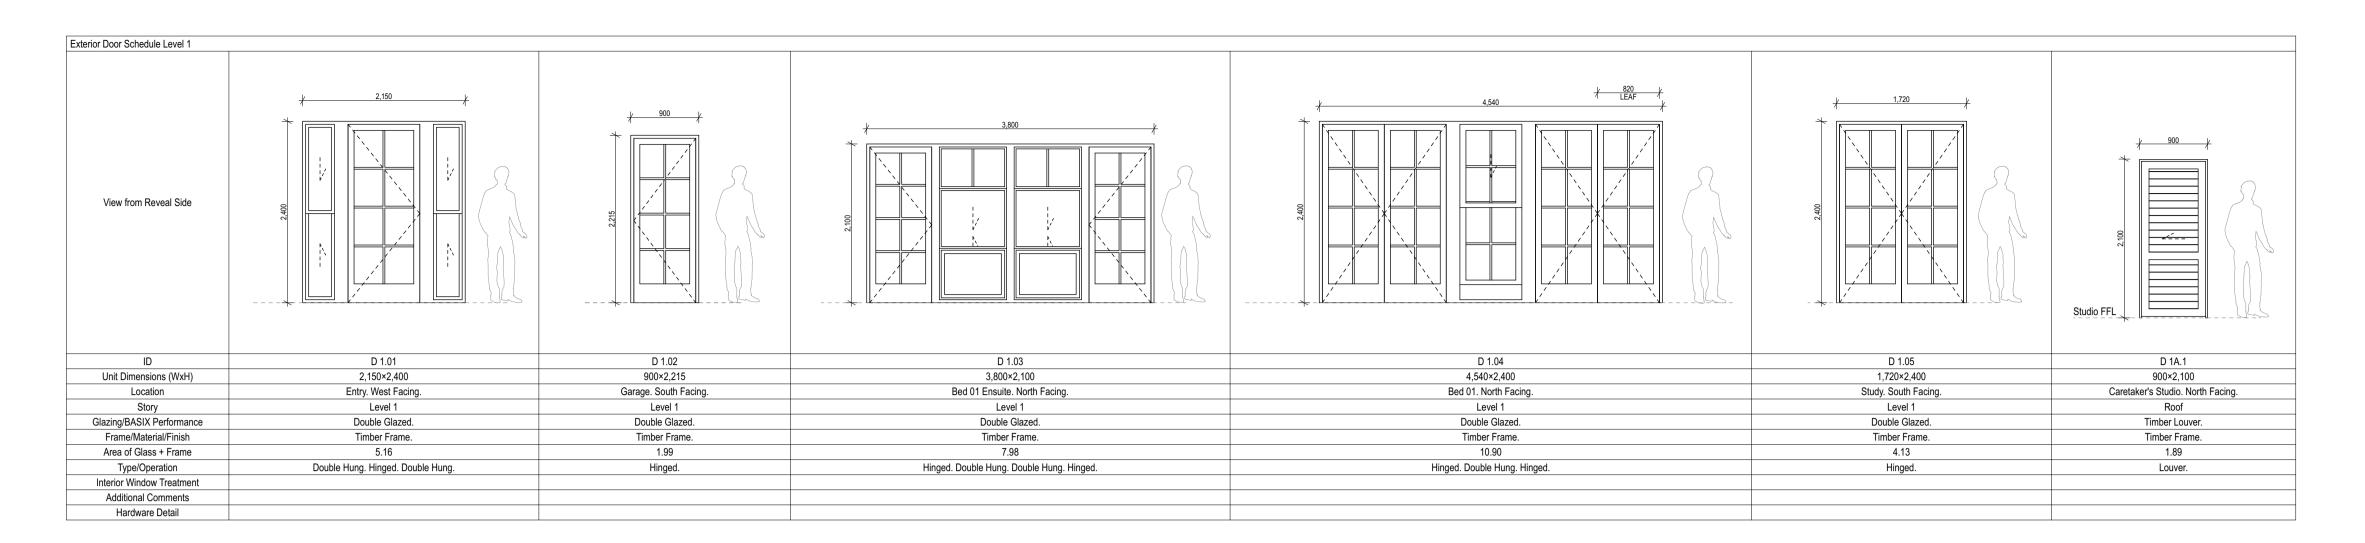

Exterior Door Schedule Level 2					
View from Reveal Side	950	950	820 LEAF 2,340	1,100	2,340
ID	D 2.01	D 2.02	D 2.03	D 2.04	D 2.05
Unit Dimensions (WxH)	950×2,550	950×2,500	2,340×2,430	1,100×2,530	2,340×2,430
Location	Entry. West Facing.	Laundry. East Facing.	Bed 02. South Facing.	Hall. South Facing.	Bed 03. South Facing.
Story	Level 2	Level 2	Level 2	Level 2	Level 2
Glazing/BASIX Performance	Double Glazed.	Double Glazed.	Double Glazed.	Double Glazed.	Double Glazed.
Frame/Material/Finish	Timber Frame.	Timber Frame.	Timber Frame.	Timber Frame.	Timber Frame.
Area of Glass + Frame	2.42	2.38	5.69	2.78	5.69
Type/Operation	Hinged.	Hinged.	Hinged. Double Hung.	Hinged.	Double Hung. Hinged.
Interior Window Treatment					
Additional Comments					
Hardware Detail					

terior Door Schedule Level 3					
View from Reveal Side	950	760	1,600	1,600	7.600
ID	D 3.01	D 3.02	D 3.03	D 3.04	D 3.05
Unit Dimensions (WxH)	950×2,600	1,600×2,600	1,600×2,600	1,600×2,600	1,600×2,600
Location	Entry. West Facing.	Living. South Facing.	Living. South Facing.	Dining. South Facing.	Kitchen. South Facing.
Story	Level 3	Level 3	Level 3	Level 3	Level 3
Glazing/BASIX Performance	Double Glazed.	Double Glazed.	Double Glazed.	Double Glazed.	Double Glazed.
Frame/Material/Finish	Timber Frame.	Timber Frame.	Timber Frame.	Timber Frame.	Timber Frame.
Area of Glass + Frame	2.47	4.16	4.16	4.16	4.16
Type/Operation	Hinged.	Sliding.	Sliding.	Sliding.	Sliding.
Interior Window Treatment					
Additional Comments					
Hardware Detail					

View from Reveal Side	5,500
ID	D 4.01
Unit Dimensions (WxH)	5,500×2,400
Location	Rumpus. South Facing.
Story	Level 4
Glazing/BASIX Performance	Double Glazed.
Frame/Material/Finish	TBC
Area of Glass + Frame	13.21
Type/Operation Interior Window Treatment	Sliding.
Additional Comments	
Additional Comments	

WF-01 Cement Render Walls RF-01 Roof Finish 1 RF-02 Metal Roof

BAL-01 Timber Balustrade RL Reduced Level WF-03 Stone Cladding TOW Top Of Wall BAL-02 Glass Balustrade WF-04 Chimny

BAL-03 Metal Balustrade Copyright of design shown hereon is retained by Cadence & Co Pty Ltd and authority is required for any reproduction. This document may only be used for the express purpose for which it has been created and any unauthorised use is at the user's sole risk. Verify dimensions on site prior to commencement of work. Check existing RL's on site. Advise Cadence & Co Pty Ltd of any discrepancies before commencement.

Comply with relevant Authorities requirements. Comply with Basix Certificate. Do not scale from drawings.

RH Rain Head

 Rev
 Date
 Issue

 A
 2/12/2024
 DA Submission
 New Residence, Pool & Associated External Works Exterior Door Schedule James & Anna Markham 287 Whale Beach Road, Palm Beach NSW 2107 Lot 187 | DP 15376

Drawing Title: CADENCE & CO DESIGN PTY LT Suite 7, 287 Mona Vale Road Terrey Hills NSW 2084 P 02 9450 1950 E info@cadenceandco.com.au Development Application Drawn: Chkd: Sheet No: Rev: Nominated Architects: Michael Kilkeary NSW ARB 12302

Sam Samarghandi NSW ARB 9112
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