

SHEET LIST

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PREPARED FOR: Katie Helmuth & Jared Gashel

DA Re-submission: Northern Beaches Council 1/4/22 (initial submission 25/8/21)


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2095

83 SYDNEY ROAD MANLY GROUND FLOOR ALTERATIONS AND SECOND STORY ADDITION DA DRAWINGS (RESUBMISSION)





Kara Jecks Bower Street Studio M. 0433 033 135 E. KJ@Bowerstreetstudio.com

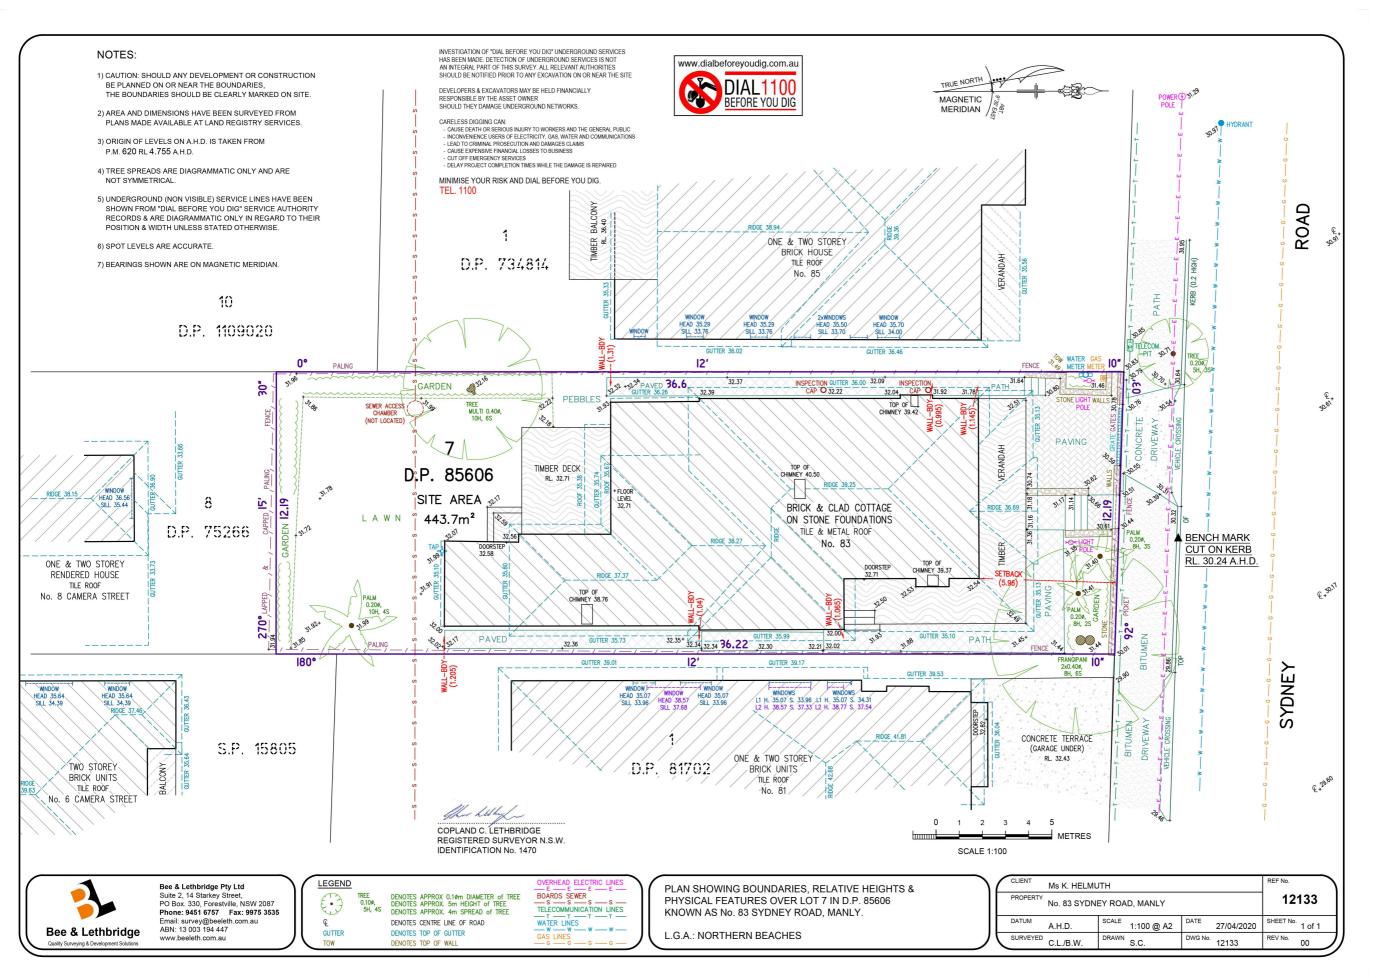CLIENT K. Helmuth & J. Gashel
Project Name Helmuth - Sydney
Project Number 20-0523
Site Area 443.7m²

83 Sydney Road, Manly

Drawn By Surveyor
Drawing Phase DA RESUB.
Current Issue B
Issue Date 1/04/22

Project type Alts & Ads

Site Survey NOT TO SCALE

Scale A Sheet No. 01





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443.7m² Site Area 83 Sydney Road, Manly

Drawn By DA RESUB. Drawing Phase В


01/04/22 Issue Date

Project type Alts & Ads Site Analysis

1:200 Scale

Sheet No. 02



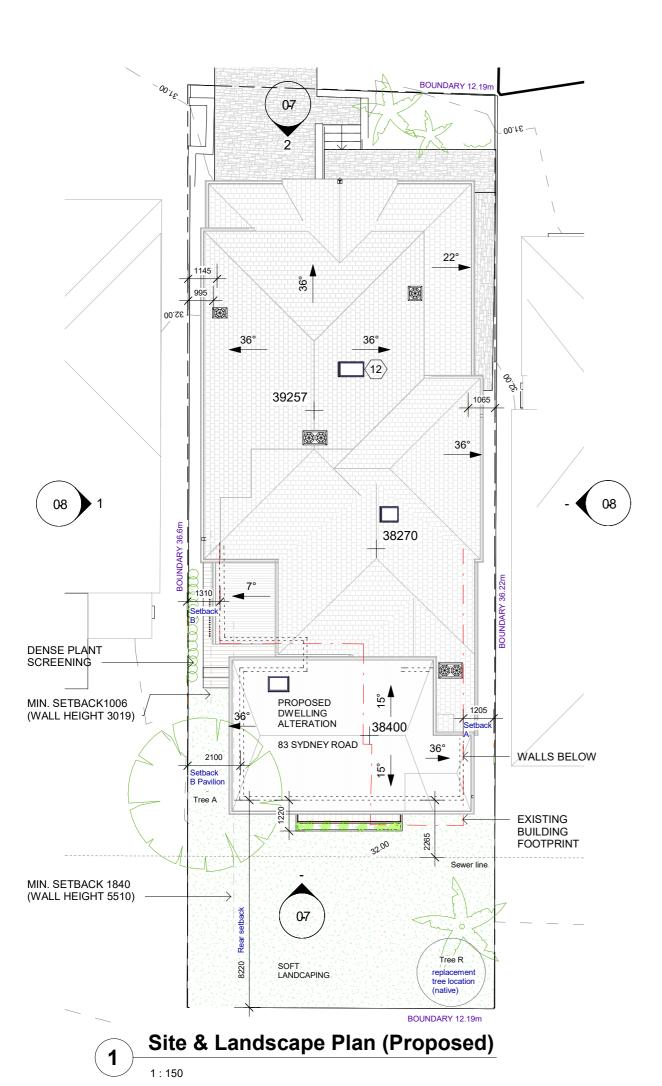


SITE CALCULATIONS & CONTROLS

Land Zoning	R1 (General Residential) 444 m²				
Site area					
	Existing	Proposed	Control	Compliant	
Ground Floor Area	162m2	182 m²		·	
Upper Floor Area	n/a	33 m²			
Total Floor Area	160m2	216 m ²			
Floor Space Ratio	0.36:1	0.49:1	0.75:1	Yes	
Total Open Space (Area OS2)	282m²/64%	270m²/61%	=/>50%	Yes	
Landscaped Area (Area OS2)		125m ² /46%	=/>30% TOS	Yes	
Private Open Space (Area OS2)		104m ²	18m ²	Yes	
Building Height (highest ridge)	7.385m	7.385m	11m	Unchanged	
Pavilion Height (highest ridge)	n/a	6.245m	11m	Yes	
Front setback	5.96m	5.96m	consistent	Unchanged	
Side setback A (E)	1.205m	1.205m	n/a	Unchanged*	
Side seback B (W)	1.31m	1.31m	1.0m	Yes**	
Side seback B Pavilion	1.205m	2.10m	1.84m*	Yes*	
Rear setback	7.27m	8.22m	8m	Yes**	

^{*}Per Manly DCP 2013 clause 4.1.7.1
** Variation sought

LANDSCAPING NOTE: Tree A is an Illawara Flame Tree, on the exempt species list. The intention is to retain this tree. In the case of disruption through building works, this tree will be replaced with a suitable native in the location specified for, "Tree R" with screening/shading plants replanted in the location of Tree A.

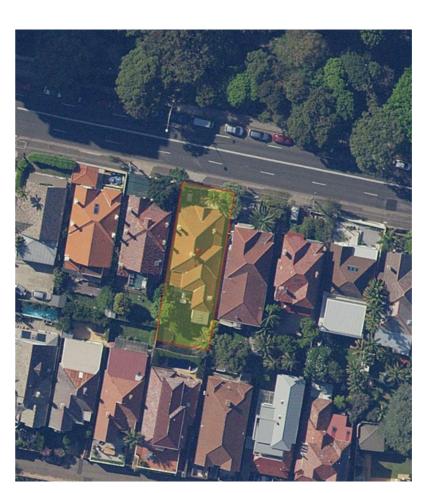



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83 Sydney Road, Manly Drawn By

DA RESUB. Drawing Phase В Current Issue 01/04/2022 Issue Date

Project type Alts & Ads Site Plan

Scale 1:150 03 Sheet No.



MAINTENANCE WORKS
(PAINTING & TIMBER
RESTORATION) TO FRONT
OF HOUSE TO UPKEEP
HERITAGE STRUCTURE.
NO CHANGE TO
STRUCTURE OR PERIOD
FEATURES

CHIMNEYS MAINTAINED.
RESURFACE & PAINT
EXISTING RENDER IN LIKE
COLOUR TO UPKEEP

DP 85606

No. 83

Single storey

weatherboard

with tiled roof

CEILINGS

EXISTING DECORATIVE CEILINGS TO FRONT OF HOUSE PRESERVED & MAINTAINED

FLOORS

EXISTING TIMBER
FLOORBOARDS REPLACED
THROUGHOUT FOR UPKEEP
AND NATURAL CONTINUITY
OF SPACE

ROOF

CHANGES TO REAR ROOF AS INDICATED TO ACCOMODATE STAIRCASE & SECOND STOREY REAR ADDITION

VEGETATION, FENCING & OTHER SITE ATTRIBUTES

ALL TREES & EXISTING
FENCES TO BE RETAINED.
INTENTION TO RETAIN
ILLAWARA FLAME TREE (IFT;
EXEMPT SPECIES LIST); IN THE
CASE OF IRREPAIRABLE
DISTURBANCE TO THE IFT, A
NEW NATIVE WILL PLANTED AT
REAR OF SITE


EXTERNAL WALLS

WHERE IN POOR CONDITION (AS INDICATED ON DEMO PLAN), REBUILD TO LIKE TO ENSURE ONGOING INTEGRITY

EXISTING DECK & COVER DEMOLISHED

DEMOLITION OF PREVIOUS INTERNAL ALTERATION INCLUDING CEILINGS AND PORTION OF ROOF ABOVE, RETAIN CHIMNEY (NOT VISIBLE TO STREET FRONT)

DEMOLISH PREVIOUS
ADDITION INCLUDING LEANTO ROOF

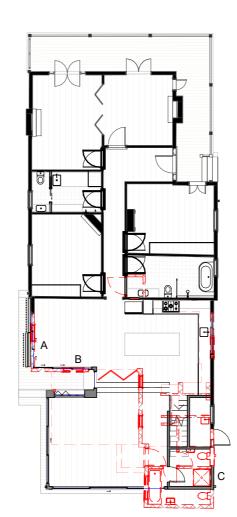

EXTENT OF INTERNAL DEMOLITON

WALLS A, B & C IN POOR CONDITION; REBUILD TO SAME FINISH TO ENSURE ONGOING INTEGRITY




HATCHED AREA INDICATES EXTENT OF ROOF DEMOLITION FOR ALTERATION





NORTH ELEVATION/ STREET VIEW

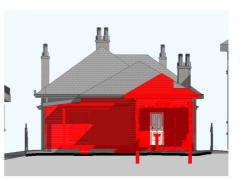

SOUTH ELEVATION/ REAR



WEST ELEVATION/ SIDE



EAST ELEVATION/ SIDE





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Site Area 443.7m²

Drawn By KJ


83 Sydney Road, Manly

Drawing Phase DA RESUB.
Current Issue B

Issue Date 01/04/2022

Project type Alts & Ads Demolition Plan

Scale As indicated A3
Sheet No. 04

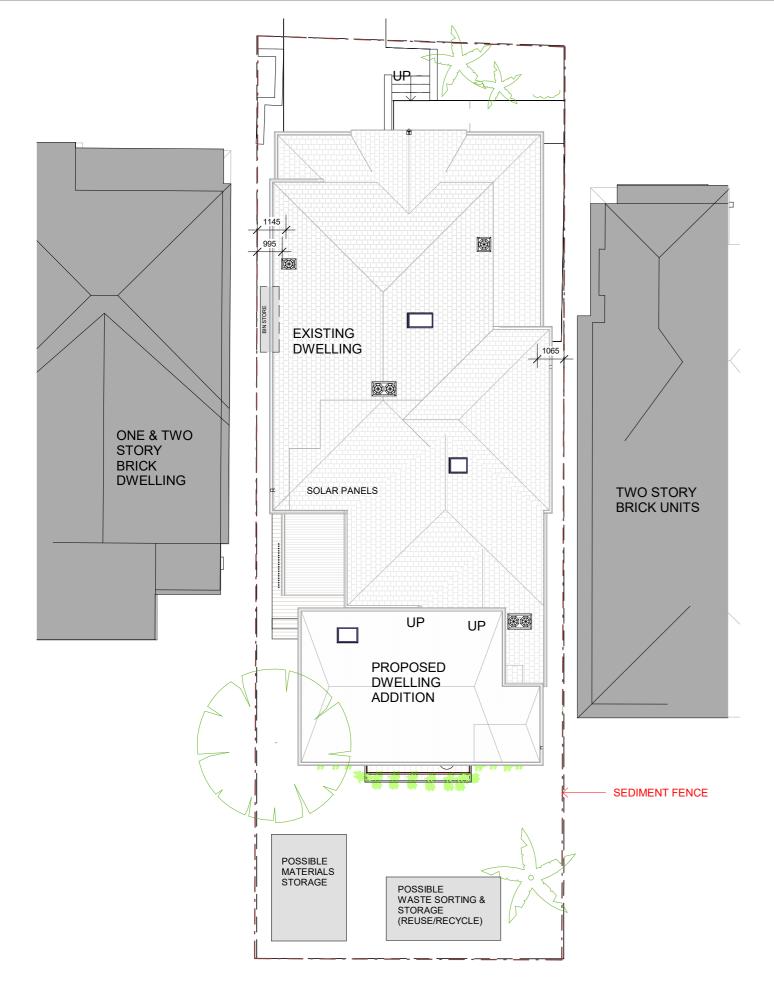

Sediment Control & Waste Management Plan

1:150

Notes Regarding Waste & Sediment

- A. Site works will not start until the erosion and sediment control works outlined in these notes are installed and functional.
- B. Sediment fences and parrier fences wil be installed as shown on plan.
- C. All stockpiles will be placed in the location shown on the plan and at least 2m clear of all areas of possible concentrated water flow, including driveways.
- Lands on the footpath will not be disturbed during works except where essential.
 Stockpiles will not be placed on these lands and they will not be used as vehicle parking areas
- E. Approved bins for building waste, paints, acid wasings and litter will be provided and arrangements made for regular collection and disposal.
- F. Guttering will be connected to the stormwater system or rainwater tank as soon as practicable.
- G. Topsoil will be respread and all disturbed areas will be stabilised within 20 working days of the completion of works.
- H. All erosion and sediment controls will be checked at least weekly and after rain, to ensure they are maintained in a fully functional condition.


Pollution Management on site

The following measures to be taken to prevent pollution on site

- Restrict access to one stable entry and exit point
- Install and maintain adequate sendement and erosion controls, with sediment fences erected as shown
- Preserve grassed area and existing vegitation by minimising the amount of land disturbed
- Ennsure stockpiles of sand, gravel, soil and similar materials are located so the material does not spill onto the road or pavement, wash into drainage lines, watercourses or depressions
- Minimise on-site vehicle activity during wet weather
- Do not pump or allow unclean water to enter the stormater system from the excess materials or cleaning tools

EROSION AND SEDIMENT MANAGEMENT WORKS SHALL COMPLY WITH THE REQUIREMENTS FOR EROSION AND SEDIMENT MANAGEMENT PLANS CONTAINED WITHIN THE MANLY DCP, 2013 AND MANLY COUNCIL'S GUIDELINES FOR SEDIMENT AND EROSION CONTROLS ON BUILDING SITES

Sediment Fence Detail

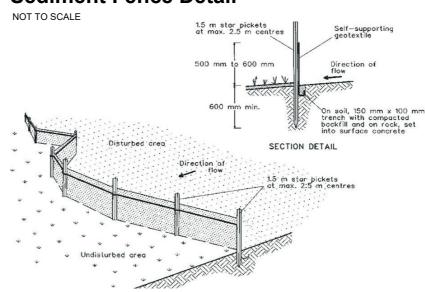

Sediment Fence Construction Notes

- Construct sediment fence as close to possible to parallel to the contours of the site, but with small returns as shown in drawing to limit the catchment area of any one section.
- Dig a 150mm deep trench along the upslope line of the fence for the bottom of the fabric to be entrenched.
- Drive 1.5 metre long star pickets into ground at 2.5metre intervals (max), at the downslope edge of the trenge. Fit star pickets with safety caps.
- Fix self-supporting geotextile to the upslope side of the posts, ensuring it goes to the base of the trench. Fix the geotextile with wire ties or as recommended by the manufacturer.
- 5. Join sections of fabric at support posts with a 150mm overlap.
- 6. Backfill the trench over the base of the fabric and compact it thoroughly over the geotextile.



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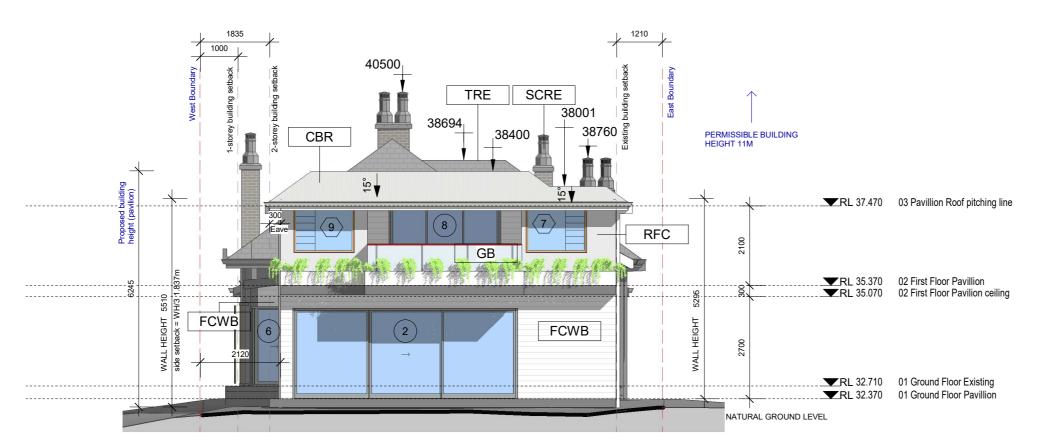
Current Issue B
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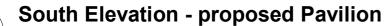
Project type Alts & Ads


Sediment & Waste

Scale 1:150 A3
Sheet No. 05







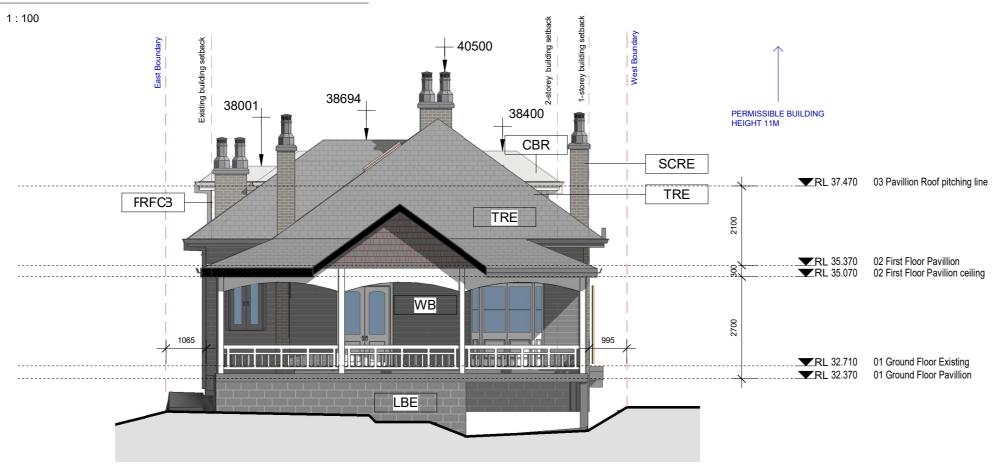

North Elevation - proposed Pavilion

1:100

8

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Project Number

Site Area

20-0523

443.7m²

Drawn By Drawing Phase Current Issue Issue Date KJ DA RESUB. A 01/04/2022 Project type Alts & Ads

Elevations - North & South

Scale 1:100 A Sheet No. 07


LEGEND

CBR Colorbond matt roof (Shale Grey)
FCWB FC weatherboard (e.g Scyon Linea)
GB Glazed balustrade 1m high
LBE Limestone blockwork (existing)


LBE Limestone blockwork (existing RFC Render-look FC cladding

CRE Stuccoed chimney - refurbish existing finish

TRE Terracotta tiled roof (existing)
VB Weatherboard (existing)

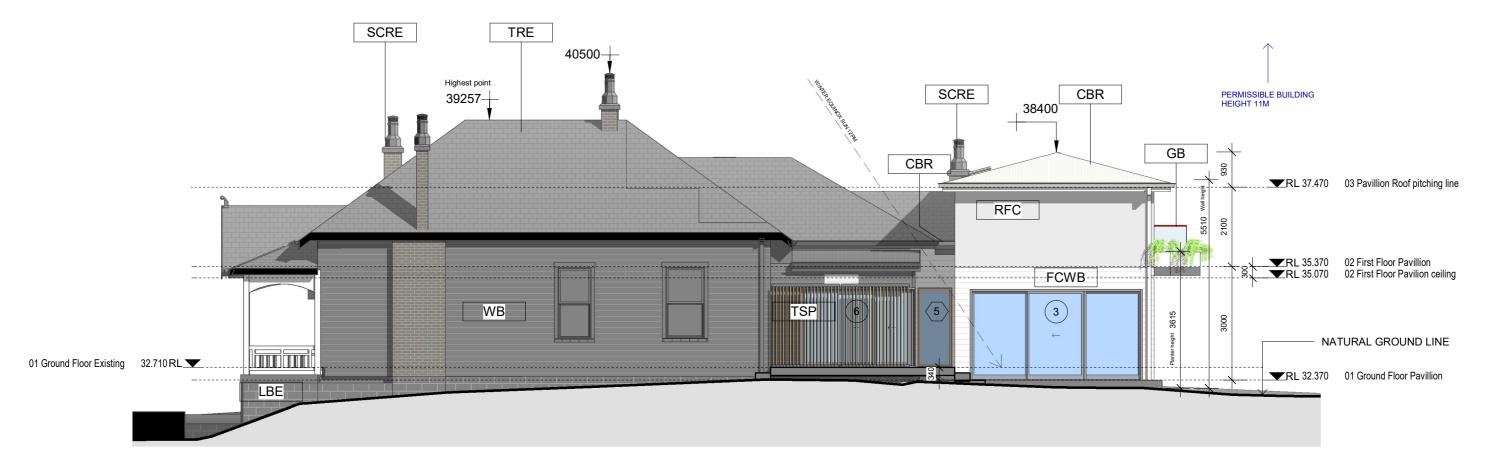

West Elevation - proposed

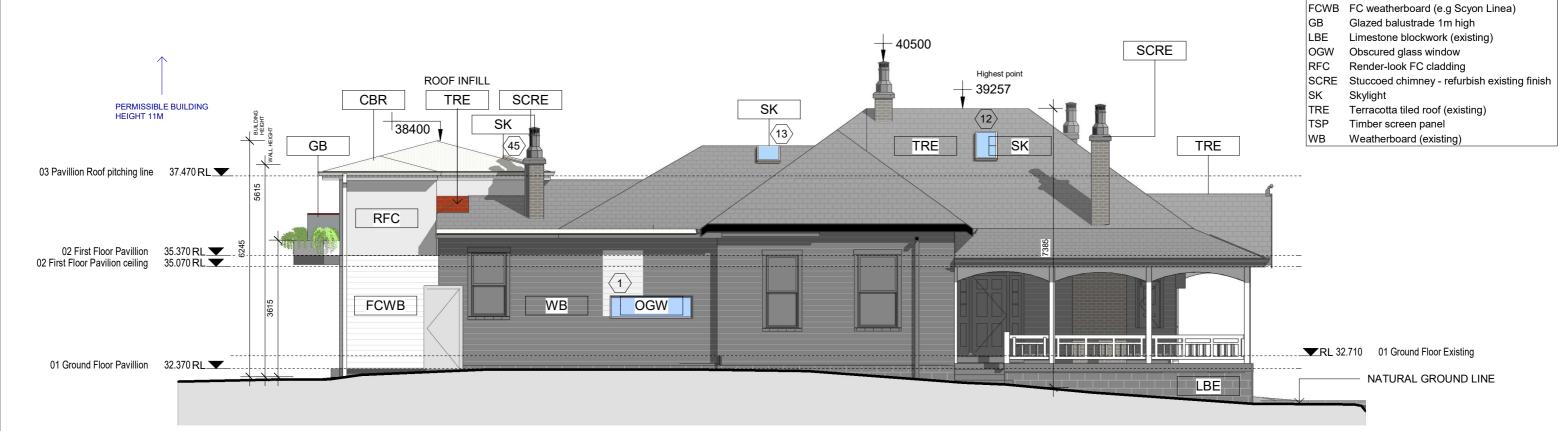

East Elevation - proposed 2

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Site Area 443.7m²

Drawn By Drawing Phase Current Issue Issue Date

KJ DA RESUB. В 01/04/2022

Project type Alts & Ads


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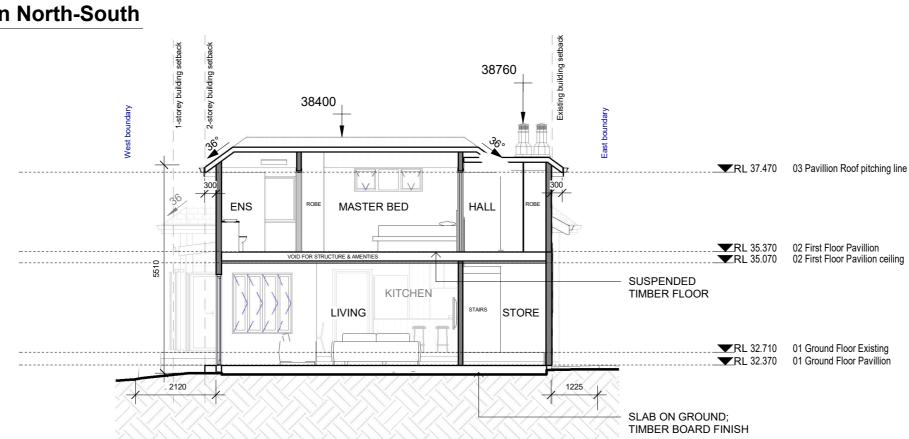
Elevations - East & West 1:100

IMPORTANT NOTE: Designs contained in these drawings are the property of Bower Streef Studio and are subject to copywright laws. Drawings are for design intent only. All dimensions to be verified on site before commencing construction. Drawings are not to be scaled. Changes to the design, specification, finishes, construction method and construction must be in consultation with designers before implementation on site. Contractors to ensure all work is carried out in accordance with relevant Building codes and Australian Standards. Design subject to approval by relevant authorities.

LEGEND

Colorbond matt roof (Shale Grey)



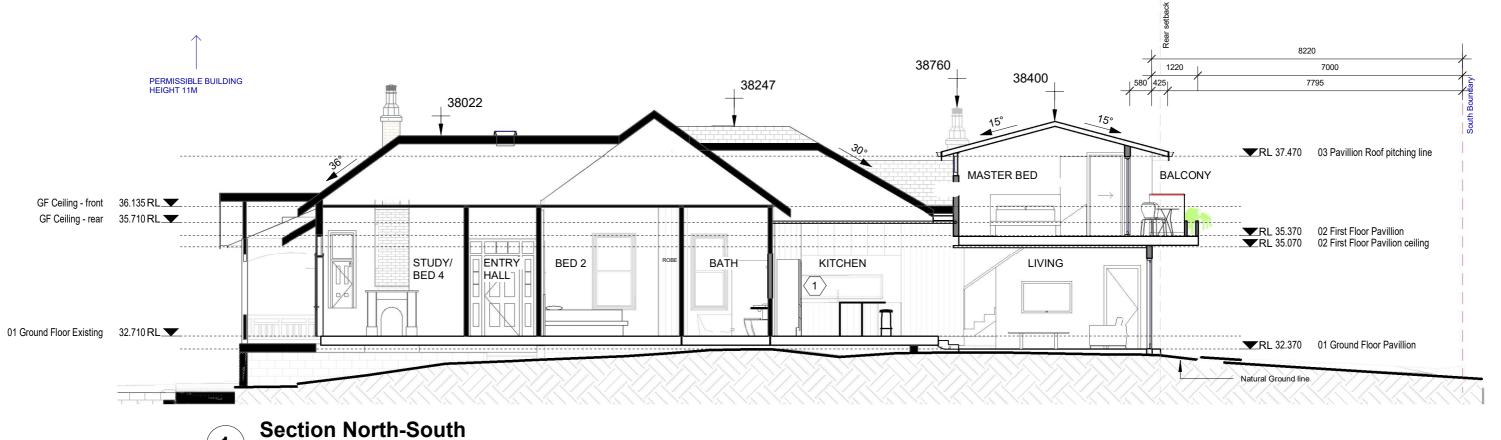





Project Number


Site Area

1:100

443.7m^t


09

Sheet No.

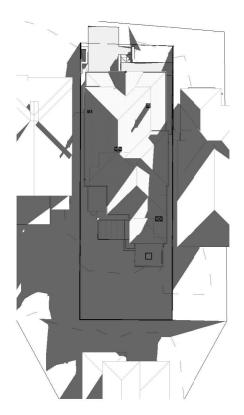


Current shadow 900 21 June

1 : 50

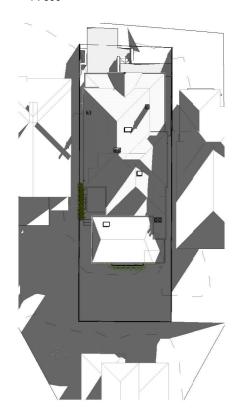


Proposed shadow 900 21 June

: 500

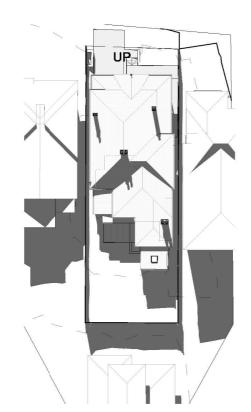


Current shadow 1200 21 June

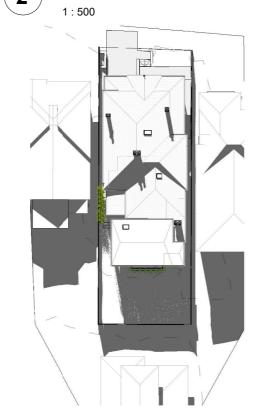

Proposed shadow 1200 21 June

Current shadow 1500 21 June

3 ti 5

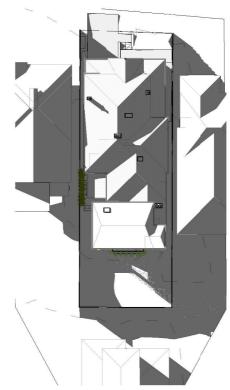

Proposed shadow 1500 21 June

1:500



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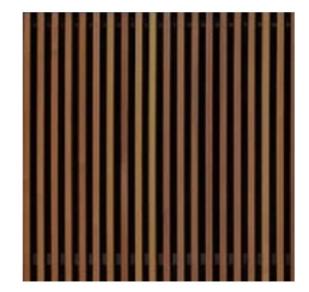
Drawn By Drawing Phase Current Issue Issue Date KJ DA RESUB. B 01/04/2022 Project type Alts & Ads

Shadows diagram


Scale 1:500 A3

Sheet No. 10

TIMBER BATTEN PRIVACY SCREENS



RENDER-LOOK CLADDING TO UPPER LEVEL PROVIDING TEXTURAL CONTRAST. PAINTED LIGHT/NEUTRAL/WHITE.

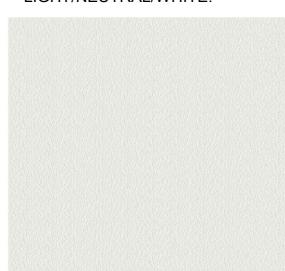

LIGHT COLOURED MATT ROOF E.G SHALE GREY. COLORBOND CUSTOM ORB PROFILE. GUTTERS & FASCIA TO MATCH.



CLASSIC WEATHERBOARD - TO MATCH EXISTING WEATHERBOARD ON GROUND FLOOR. PAINTED LIGHT NEUTRAL/WHITE









Street context 1



Street context 2 **2**







Site Area 443.7m²

Α3