# **DEVELOPMENT APPLICATION | REVISION A** 74 ELANORA ROAD ELANORA HEIGHTS NSW 2101

#### LOCATION (NTS)



#### **BASIX SPECIFICATION**

BASIX Certificate	Project address			
Building Sustainability Index www.basix.nsw.gov.au	Project name	Elanora 2		
Alterations and Additions	Street address	74 ELANDRA Road ELANORA HEIGHTS 2		
Alterations and Additions	Local Government Area	Northern Beaches Council		
ertificate number: \$1771798	Plan type and number	A GLANDRA Back CARON HIDD'     Known March Caroli     Degrater Pan DP12453     T     T     Desting house (decoded)     Degrater Pan DP12453     T     T     Desting house (decoded)     Degrater Pan DP12453     T     S     Desting house (decoded)     Degrater Pan DP12453     S     Desting house (decoded)     Degrater Pan DP12453     Desting house (decoded)     Degrater Pan     Degrater P		
	Lot number	75		
	Section number	•		
his certificate confirms that the proposed development will meet the NSW memory servicements for sustainability if it is huilt in accordance with the	Project type			
ommitments set out below. Terms used in this certificate, or in the commitments,	Dwelling type	Dwelling house (detached)		
is conflictus confirms that the proposed development will meet the NSW warmen's explainments for scalandably. It is built in accordance with the warmen's sequences of the scalandably is a scalandably with the two the management of the scalandably is a scalandable of the document of the scalandable of the scalandable of the the basic congress.	Type of alteration and addition	The estimated development cost for my renovation work is \$50,000 or more, and do not include a pool (and/or spa).		
	NA	NA		
Nechtary Iste of issue: Wednesday, 05 November 2024 o be valid, this certificate must be lodged within 3 months of the date of issue.	Certificate Prepared by	ease complete before submitting to Council or PCA)		
	Name / Company Name: STUDIO FRIEND PTY LTD			
	ABN (f applicable): 83645555639			
NSW				





Glazing requirements	Show on DA Plans	Show on CC/CDC Plans & specs	Certifier Check
Windows and glazed doors			
The applicant must install the windows, glazed doors and shading devices, in accordance with the specifications lated in the table below. Relevant overshadowing specifications must be satisfied for each window and glazed door.	~	×	~
The following requirements must also be satisfied in relation to each window and glazed door:		~	~
Each window or glazed door with standard aluminium or limber frames and single clear or loned glazes may either match the description, or, have a U-value and a Solar Healt Calin Coefficient (2HCC) no greater than that labed in the table balow. Total system U-values and SMCG must be calculated in accordance with National "resensition Restang Council (HMC); conditions.		~	~
For projections described in milimetres, the leading edge of each eave, pergola, verandah, balcony or avening must be no more than 500 mm above the head of the window or glazed door and no more than 2400 mm above the sill.	~	~	~
Pergolas with polycarbonate roof or similar translucent material must have a shading coefficient of less than 0.35.		~	~
Perpolas with fixed batters must have bettens parallel to the window or glazed door above which they are situated, unless the pergola also shades a perpendicular window. The spacing between batters must not be more than 50 mm.		~	~
Overshadowing buildings or vegetation must be of the height and datance from the centre and the base of the window and glazed door, as specified in the overshadowing column in the table below.	~	~	~

#### DRAWINGS LIST

DRAWING LIST			
DRAWING No.	DESCRIPTION	REV	DATE ISSUED
DA 00	COVER PAGE	А	29.10.24
DA 01	SITE ANALYSIS	А	29.10.24
DA 02	GROUND FLOOR DEMO PLAN	А	29.10.24
DA 03	FIRST FLOOR DEMO PLAN	А	29.10.24
DA 04	ROOF DEMO PLAN	А	29.10.24
DA 10	SITE PLAN	А	29.10.24
DA 11	GROUND FLOOR PLAN	А	29.10.24
DA 12	FIRST FLOOR PLAN	А	29.10.24
DA 13	ROOF PLAN	А	29.10.24
DA 20	NORTH ELEVATION + FINISHES SCHE	А	29.10.24
DA 20	SOUTH ELEVATION	А	29.10.24
DA 22	EAST ELEVATION	А	29.10.24
DA 22	WEST ELEVATION	А	29.10.24
DA 30	SECTION AA + BB	А	29.10.24
DA 40	SHADOW DIAGRAM - 9AM 21 JUNE	А	29.10.24
DA 41	SHADOW DIAGRAM - 12PM 21 JUNE	А	29.10.24
DA 42	SHADOW DIAGRAM - 3PM 21 JUNE	А	29.10.24
DA 50	LANDSCAPE CALCULATIONS	А	29.10.24
DA 51	GFA CALCULATIONS	А	29.10.24
DA 60	LANDSCAPE PLAN	А	05.10.24

#### CONSULTANTS

SURVEYOR **Detailed Surveys** 02 9913 9525 jsurveyor@live.com.au

BUSHFIRE CONSULTANT Matthew Willis Bushfire Planning Services Pty Limited 0428408577 www.bushfireconsultants.com.au matt@bfire.com.au

HYDRAULIC ENGINEER Cam Jones NB Consulting Suite 207, 30 fisher road, Dee Why NSW 2099 (02) 9984 7000 cameronjones@nbconsulting.com.au

#### ABREVIATIONS

BALC - BALCONY	CT - CERAMIC TILE	FFL - FINISHED FLOOR LEVEL	PAV - PAVING	RR - ROOF RIDGE	SST - SAND STONE	TPIT - TELSTRA PIT
BL - BLOCKWORK	DEM - DEMOLISHED	G - GLASS	PF - PAINT FINISH	RT - ROOF TILE	ST - STONE	TSF - TIMBER STRIP FLOOR
BW - BRICKWORK	DP - DOWN PIPE	GM - GAS METER	PP - POWER POLE	SD - STEEL DOOR	STR - STAIR	T - TIMBER
CPT - CARPET	EO - ELETRICITY LINE OVERHEAD	MR - METAL ROOF	RF - ROOF	SK - SKYLIGHT	TD - TREAD	TW - TOP OF WALL
CR - CEMENT RENDER	EX - EXISTING STRUCTURE	OF - OVER FLOW	RL - RELATIVE LEVEL	SP - STEEL PLATE	TG - TOP OF GUTTER	WM - WATER METER



#### GEOTECHNICAL ENGINEER

Troy Crozier Crozier Geotechnical Engineering Unit 12/ 42-46 Wattle Road Brookvale NSW 2100 02 9939 1882 info@croziergeotech.com.au

PLANNING CONSULTANT

Vaughan Milligan Vaughan Milligan Development Consulting Pty Ltd PO Box 49 Newport Beach NSW 2106 P: 9999 4922 planning@vmdc.com.au


#### LANDSCAPE DESIGNER

Sam Horspool Studio Friend 0423 721 075 sam@studiofriend.com.au

ORING

#### **PRELIMINARY - NOT FOR** CONSTRUCTION

REVISION Α DRAWING NO: **DA 00** 

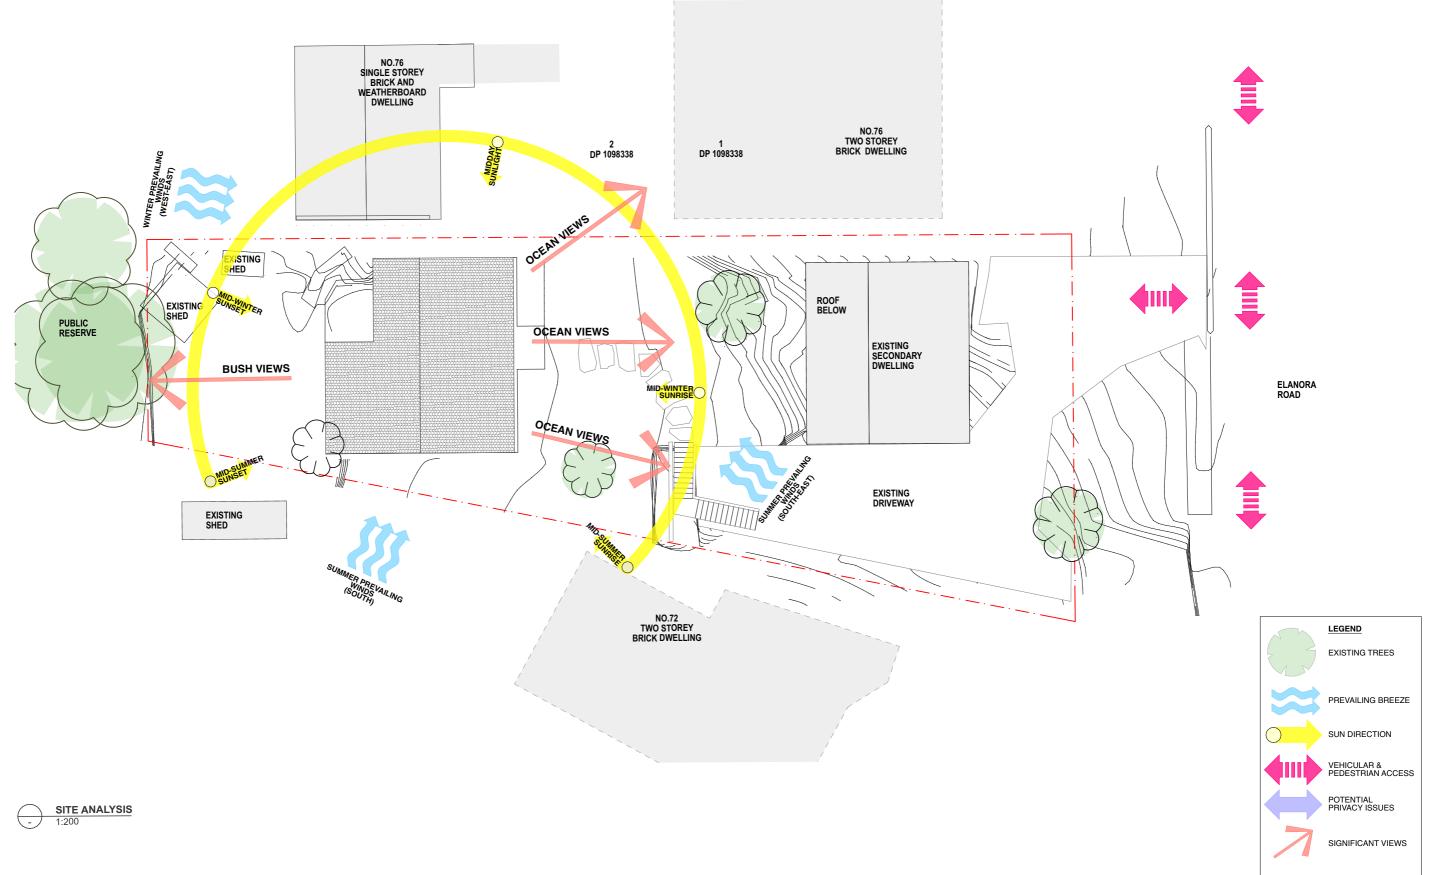









ELANORA HEIGHTS ADDRESS: 74 ELANORA ROAD ELANORA HEIGHTS NSW 2101 CLIENT: JAMES HORTON AND ANNALIESE PEDAVOLI

LEGEND
DEMOLISH STRUCTURE
BOUNDARY
EXTENT OF APPROVED DA
EXISTING CUT


TIMBER SECTION GLASS SECTION CONCRETE SECTION STEELMETAL SECTIO







REVISION Α DRAWING NO: DA 01

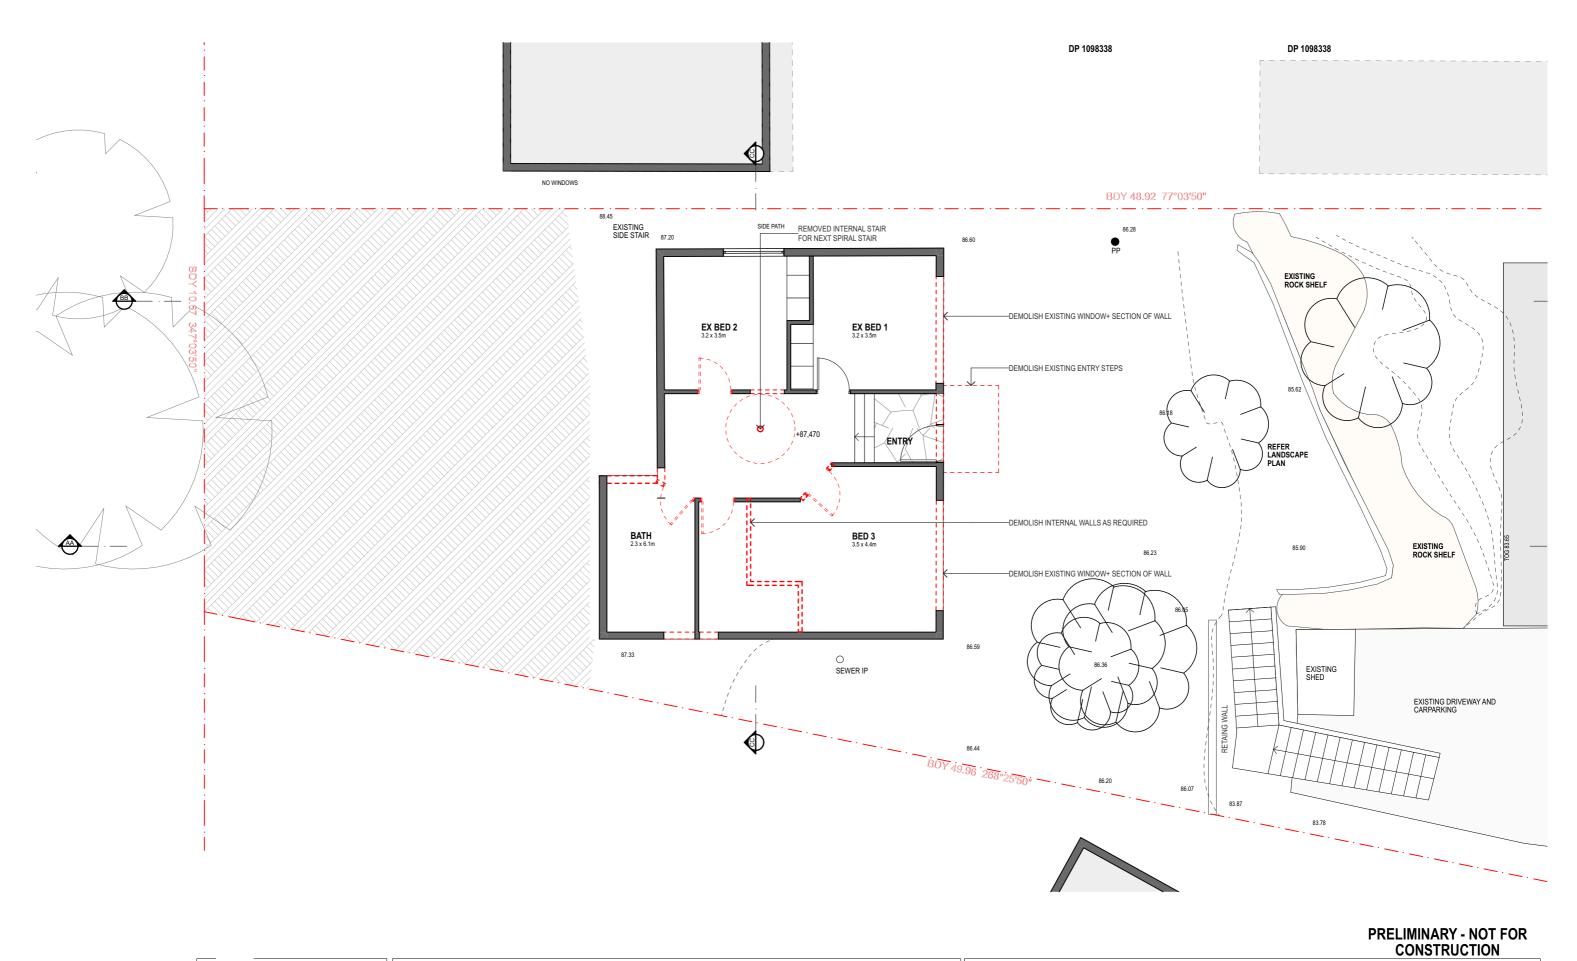


DRAWING NO:


DA 02

REVISION

Α

S T	FR	STUDIO FRIEND PTY LTD		LEGEND		USE FIGURED DIMENSIONS IN PREFERENCE TO SCALE. ALL DIMENSIONS TO BE VERIFIED ON SITE PRIOR TO FABRICATION	SETOUT OR CONSTRUCTION	REFER ANY DISCREPANCIES TO THE PROJECT ARCHITECT. IF IN DOUBT ASK.
	· · · ·	ALL RIGHTS RESERVED. NO PART OF THIS DESIGN &	ELANORA REIGHTS	DEMOLISH STRUCTURE	MASONRY SECTION	SCALE: @ A3	N	DRAWING NAME:
		DOCUMENTATION OR ALL WORKS EXECUTED FROM THIS	ADDRESS:	BOUNDARY	TIMBER SECTION		1 Å	DIVANINO NAME.
	16	DESIGN MAY BE REPRODUCED OR TRANSMITTED IN ANY FORM OR BY ANY MEANS WITHOUT WRITTEN PERMISSION	74 ELANORA ROAD ELANORA HEIGHTS NSW 2101	EXTENT OF APPROVED DA	GLASS SECTION	PROJECT NO: 2408	$ A\rangle$	GROUND FLOOR DEMO
		FROM SF ARCHITECTS. DO NOT SCALE DRAWINGS. CHECK		EXISTING CUT	CONCRETE SECTION	DATE: 17/12/24	$  \setminus \square$	
10		ALL DIMENSIONS ON SITE	CLIENT:		STEEL METAL SECTION	1//12/24		DLAN
			JAMES HORTON AND ANNALIESE PEDAVOLI					FLAN

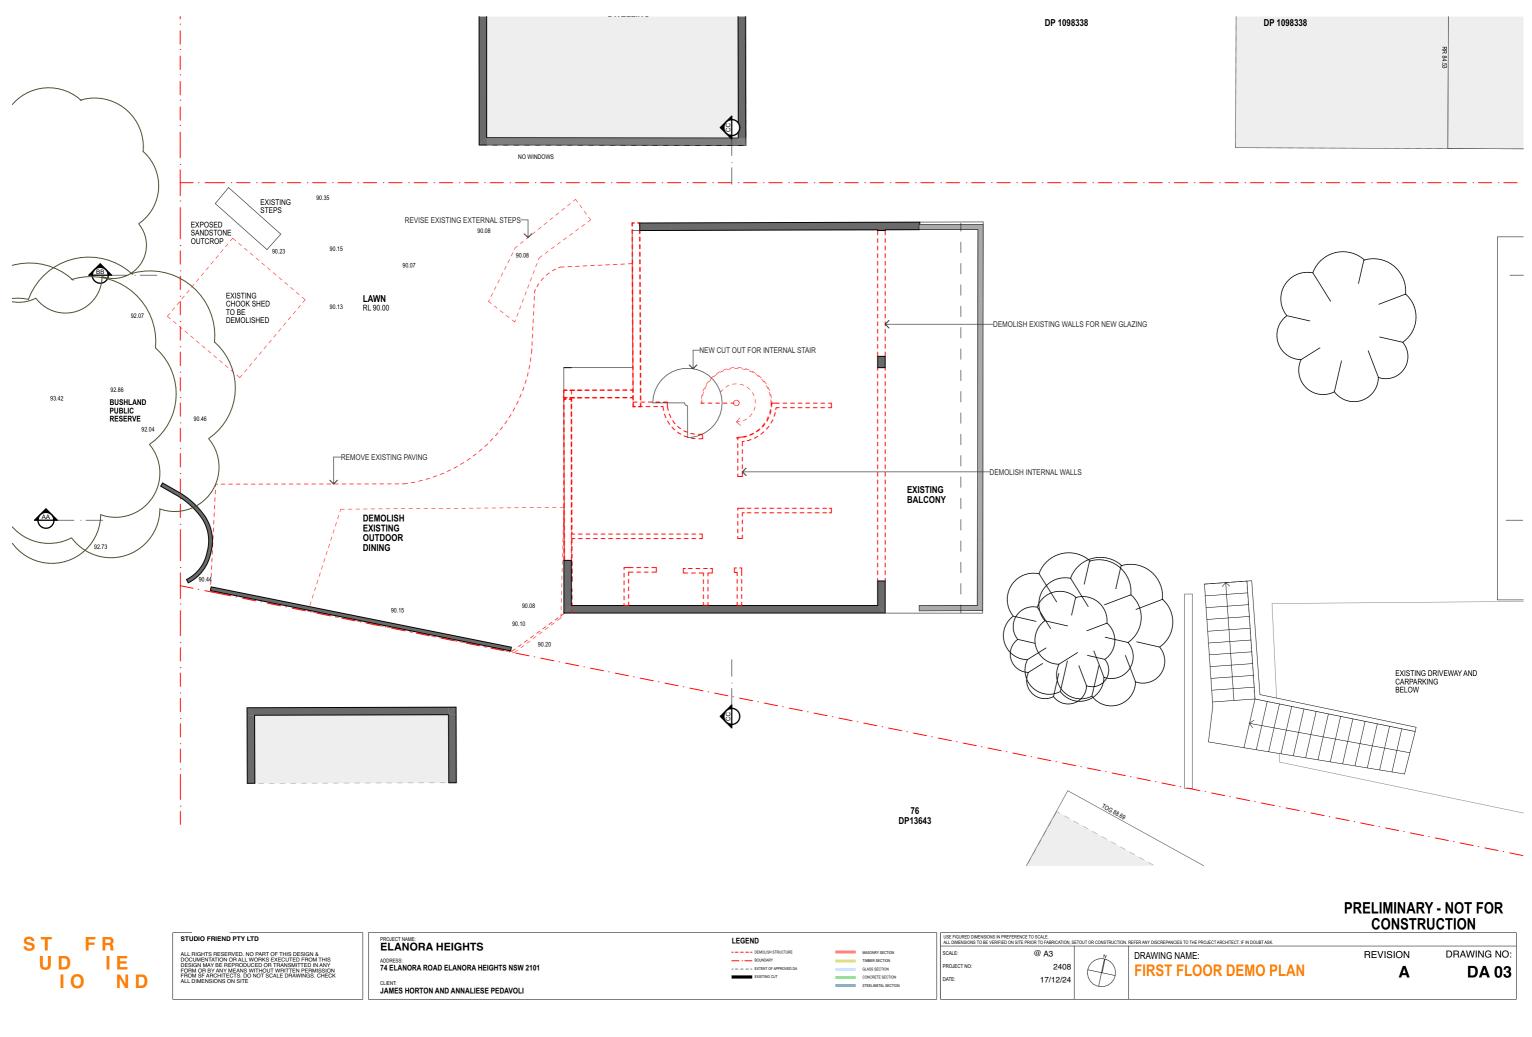

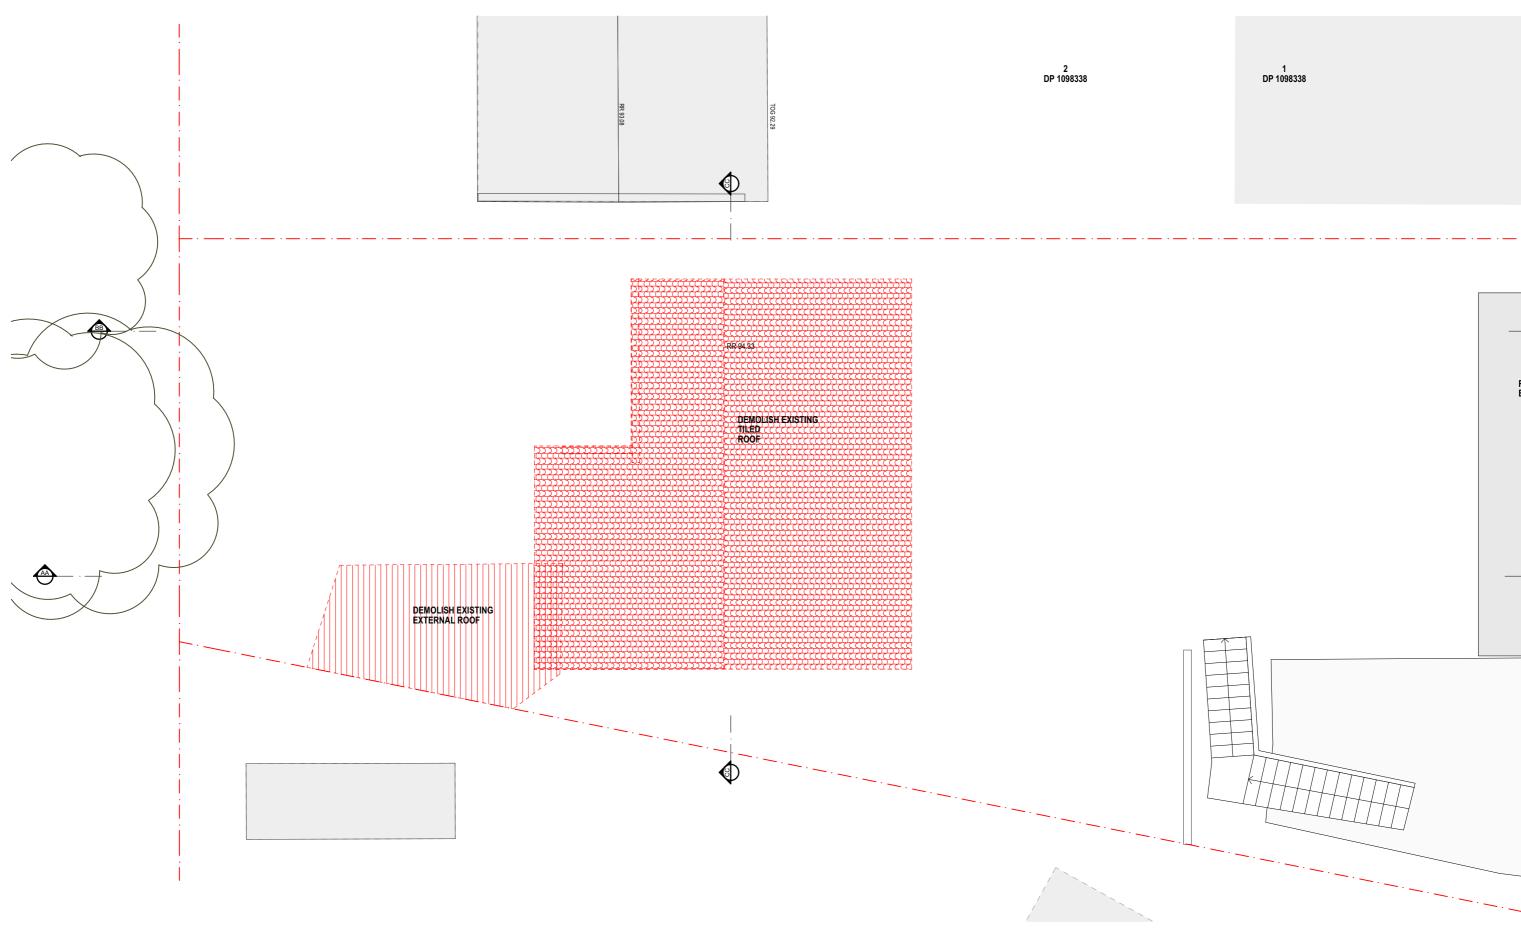

ST FR	STUDIO FRIEND PTY LTD	PROJECT NAME: ELANORA HEIGHTS
UD IE	ALL RIGHTS RESERVED. NO PART OF THIS DESIGN & DOCUMENTATION OR ALL WORKS EXECUTED FROM THIS DESIGN MAY BE REPRODUCED OR TRANSMITTED IN ANY FORM OR BY ANY MEANS WITHOUT WRITTEN PERMISSION FROM SF ARCHITECTS. DO NOT SCALE DRAWINGS. CHECK	ADDRESS: 74 ELANORA ROAD ELANORA HEIGHTS NSW 2101
IO ND	ALL DIMENSIONS ON SITE	CLIENT: JAMES HORTON AND ANNALIESE PEDAVOLI

EGEND	
DEMOLISH STRUCTURE	
BOUNDARY	
EXTENT OF APPROVED DA	
EXISTING CUT	

MASONRY SECTION
TIMBER SECTION
GLASS SECTION
CONCRETE SECTION
STEELMETAL SECTION


SCALE:

DATE:

FERENCE TO SCALE. IN SITE PRIOR TO FABRICATION, SETOUT OR CONSTRUCTION. REFER ANY DISCREPANCIES TO THE PROJECT ARCHITECT. IF IN DOUBT ASK. @ A3 PROJECT NO: 2408 +17/12/24



REVISION Α DRAWING NO: DA 04

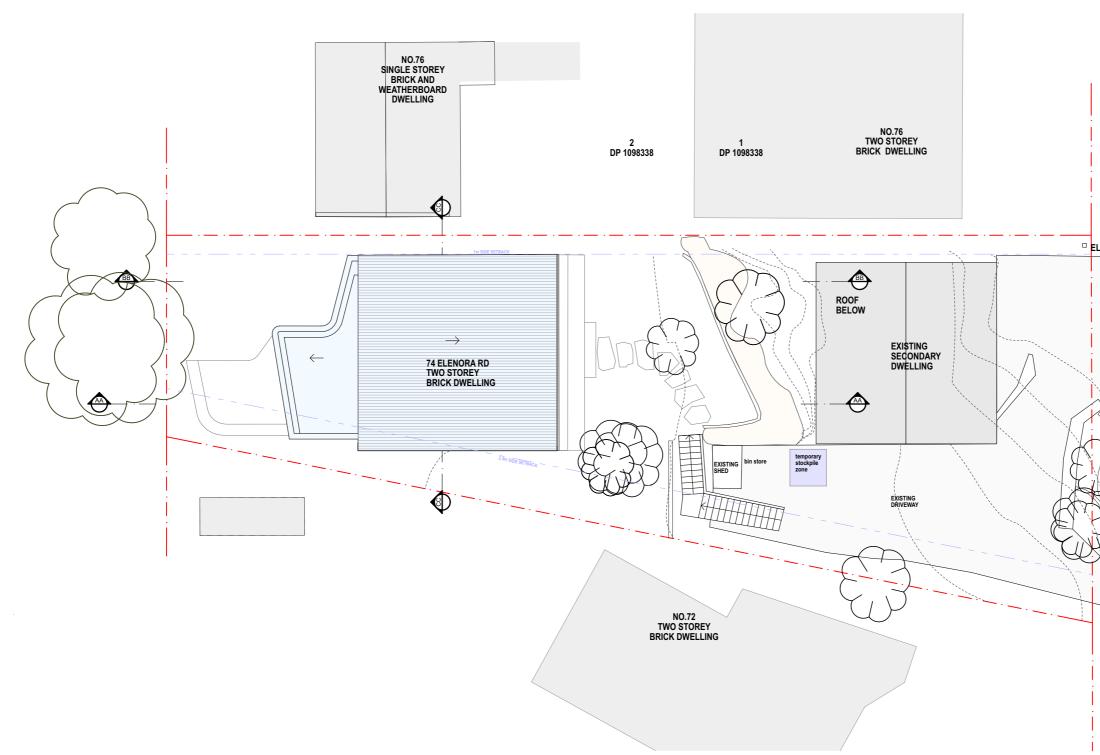


ST F	R	STUDIO FRIEND PTY LTD		LEGEND		USE FIGURED DIMENSIONS IN PREFERENCE TO SCALE. ALL DIMENSIONS TO BE VERIFIED ON SITE PRIOR TO FABRICATION	SETOUT OR CONSTRUCTION	REFER ANY DISCREPANCI
	I E N D	ALL RICHTS, RESERVED, NO PART OF THIS DESIGN & DOCUMENTITYON OF ALL WARKS EXECUTED FROM THIS DESIGN WAY BE REPRODUCED OR TRANSMITTED IN ANY FORM OR BY ANY MEANS WITHOUT WRITTER PREMISSION FROM SF ARCHITECTS. DO NOT SCALE DRAWINGS. CHECK ALL DIMENSIONS ON SITE	ELANORA HEIGHTS ADDRESS: 74 ELANORA ROAD ELANORA HEIGHTS NSW 2101 CLENT: JAMES HORTON AND ANNALIESE PEDAVOLI	DEMOLISH STRUCTURE     DEMOLISH STRUCTURE     DEMOLISH STRUCTURE     EXISTING CUT	TIMBER SECTION	SCALE: @ A3 PROJECT NO: 2406 DATE: 17/12/24		DRAWING N




REVISION


### PRELIMINARY - NOT FOR CONSTRUCTION

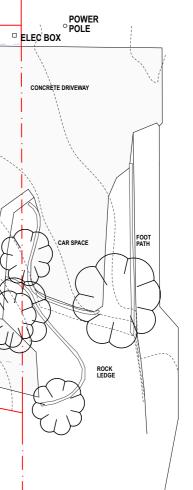


ELANORA ROAD

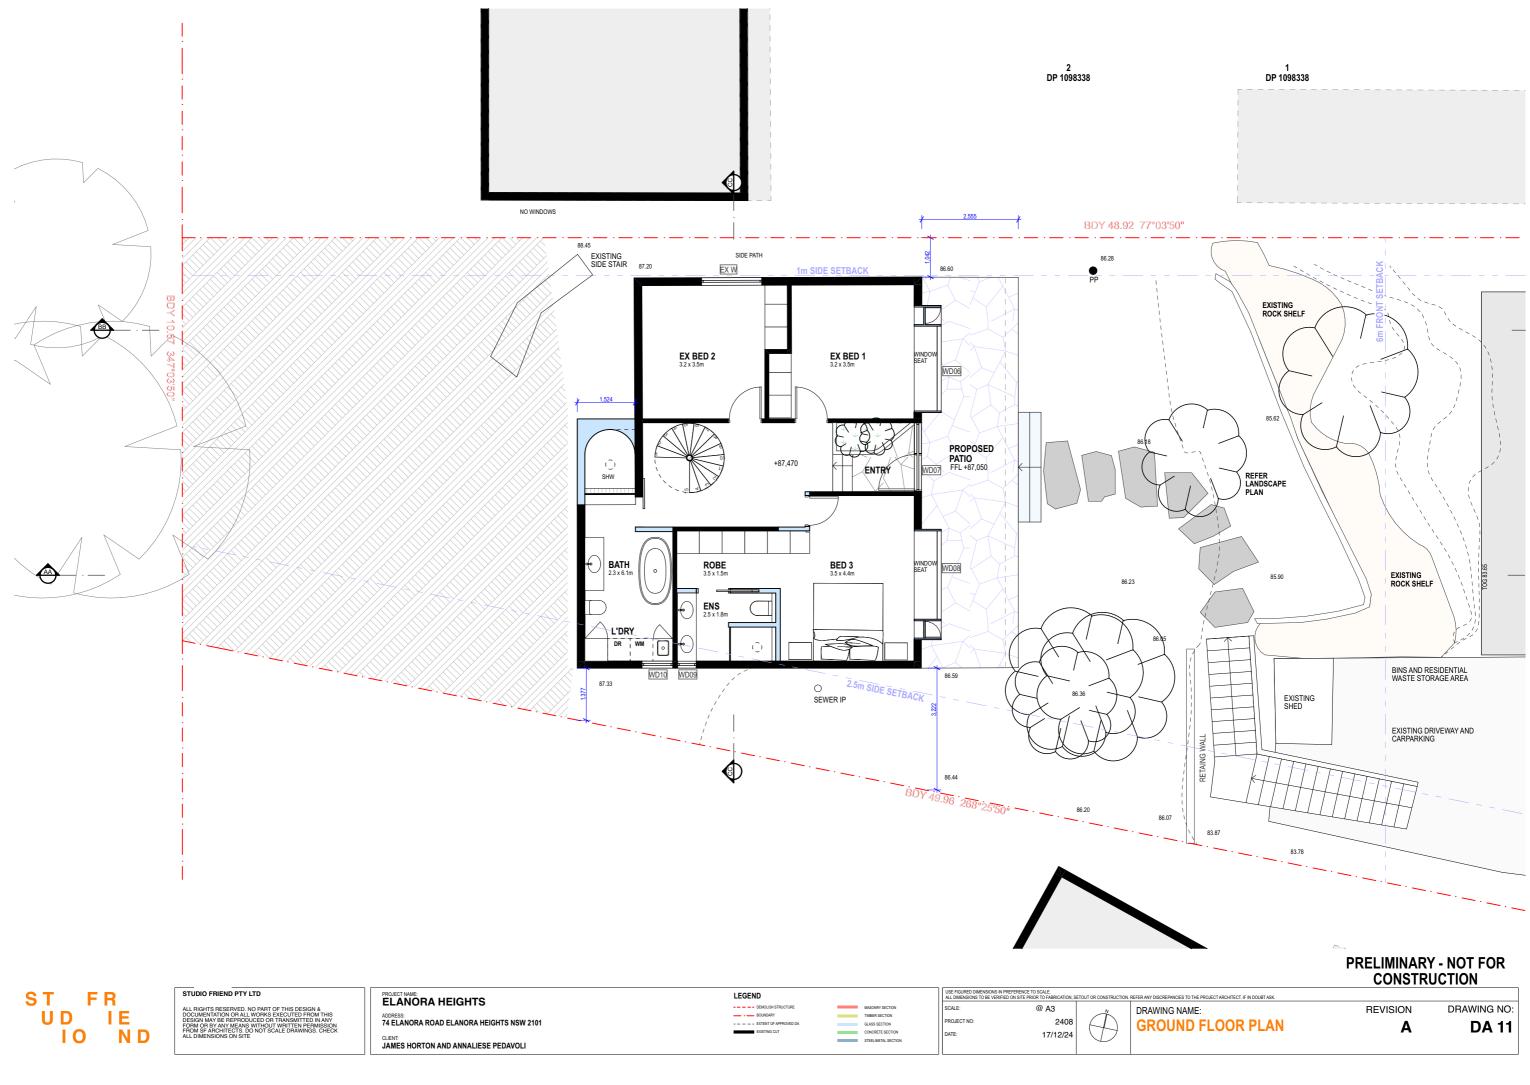


1	LEGEND
	DEMOLISH STRUCTURE
	BOUNDARY
-	EXTENT OF APPROVED DA
	EXISTING CUT

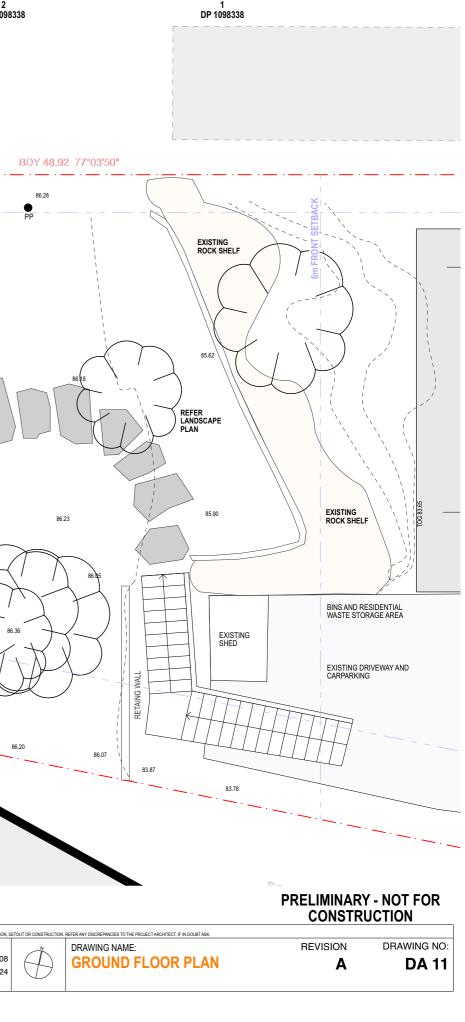


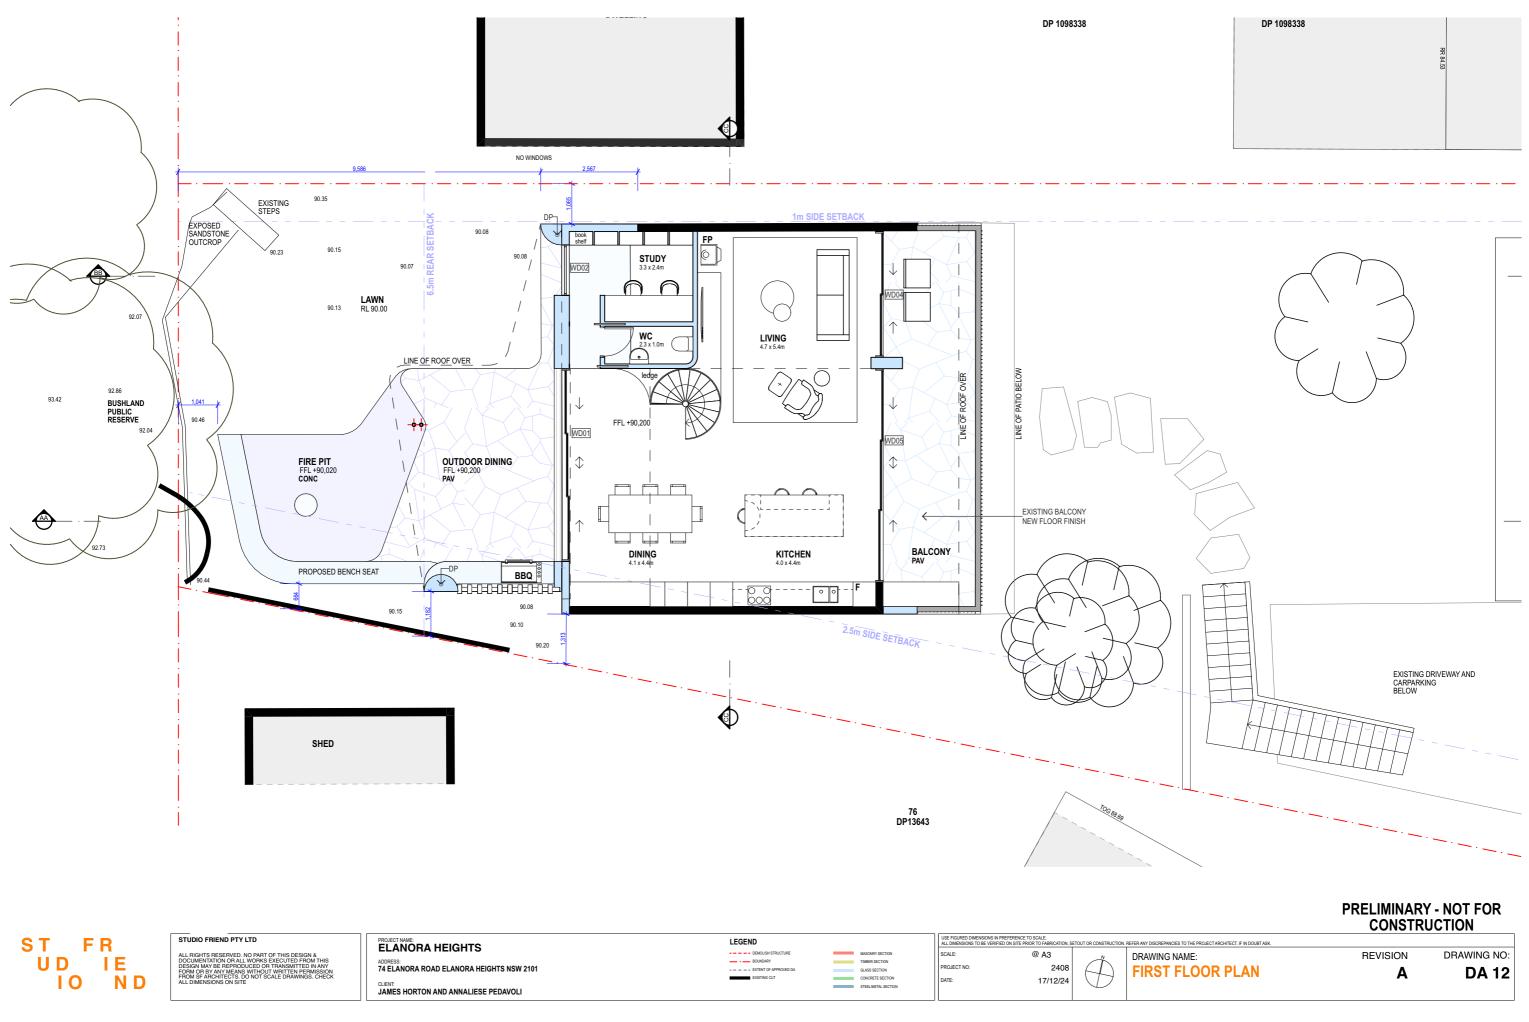

: Т	FR	STUDIO FRIEND PTY LTD		LEGEND		USE FIGURED DIMENSIONS IN PREFERENCE TO SCALE. ALL DIMENSIONS TO BE VERIFIED ON SITE PRIOR TO FABRICATIO	N, SETOUT OR CONSTRUCTIO	N. REFER ANY DISCREPANO
U D I C	IE ND	ALL RIGHTS RESERVED. NO PART OF THIS DESIGN & DOCUMENTATION OR ALL WORKS EXECUTED FROM THIS DESIGN MAY BE REPRODUCED OR TRANSMITTED IN ANY FORM OR BY ANY MEANS WITHOUT WRITTEN PERMISSION FROM SF ARCHITECTS. DO NOT SCALE DRAWINGS. CHECK ALL DIMENSIONS ON SITE	ELANORA HEIGHTS ADDRESS: 74 ELANORA ROAD ELANORA HEIGHTS NSW 2101 CLIENT: JAMES HORTON AND ANNALIESE PEDAVOLI	DEMOLISH STRUCTURE     DEMOLISH STRUCTURE     DOLINDARY     DOLINDARY     DOLINDARY     DOLINDARY     DOLINDARY     DOLINDARY     DOLINDARY	MACINEY SECTION TIMBER SECTION QLASS SECTION CONCRETE SECTION STEELINETLA SECTION	RCALE:         @ A3           PROJECT NO:         240           DATE:         17/12/2	8	DRAWING FIRST
			JAMES FORTON AND ANNALIESE FEDAVOLI					

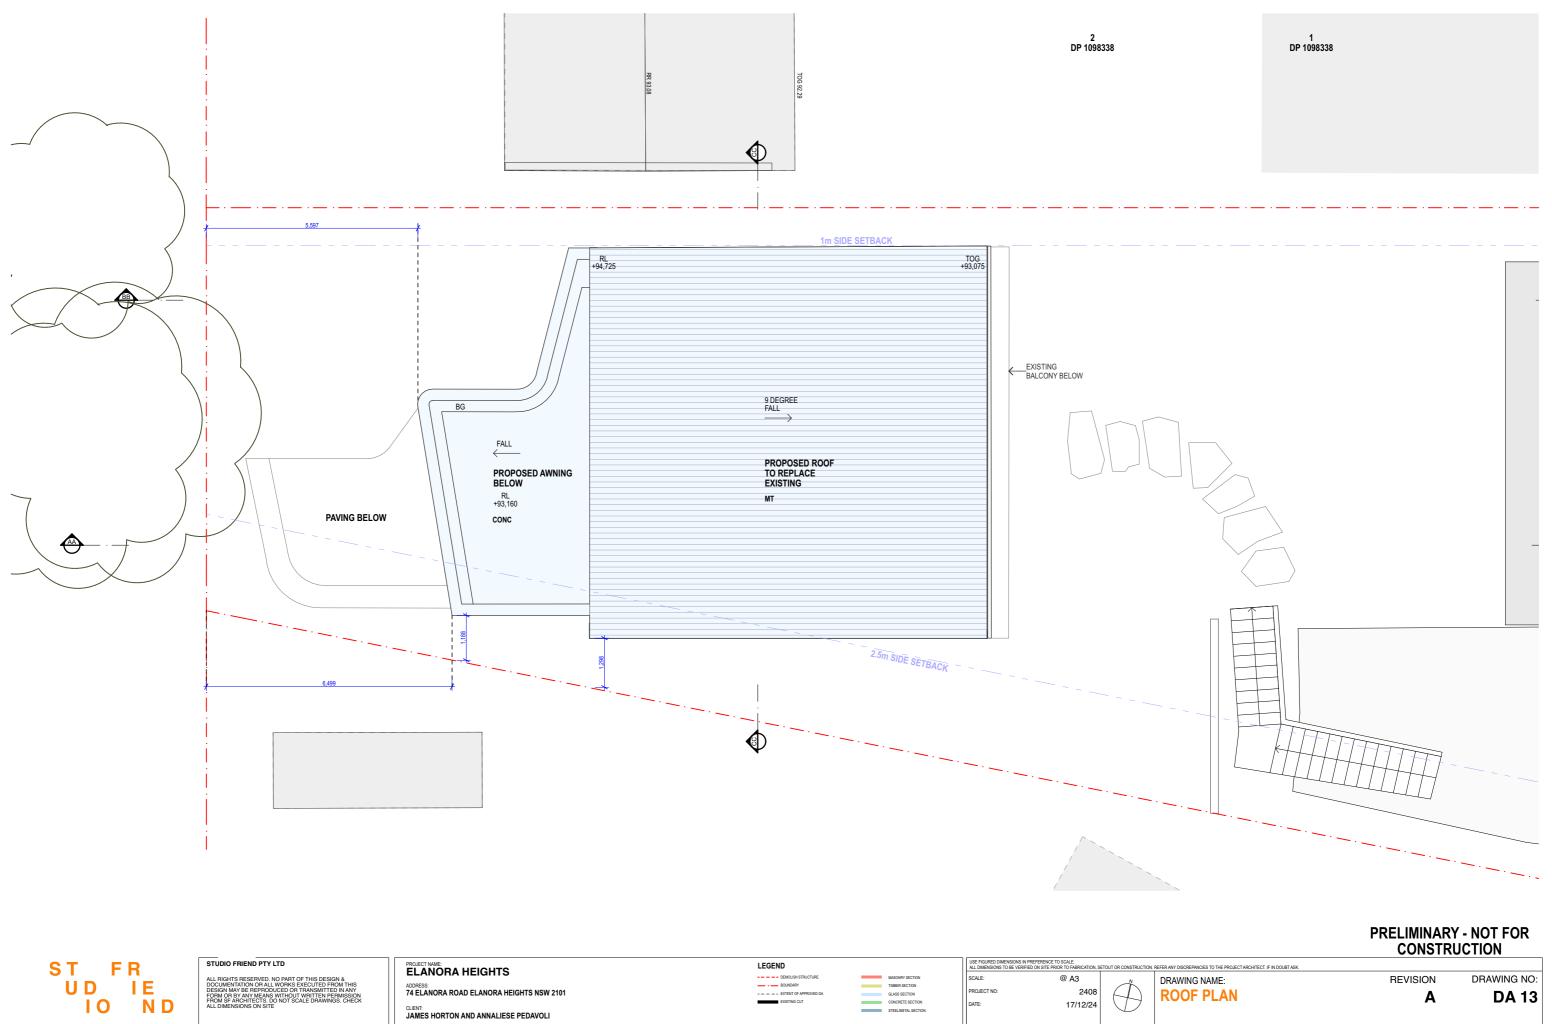


ЗТ	FR	STUDIO FRIEND PTY LTD		LEGEND		USE FIGURED DIMENSIONS IN PREFERENCE TO SCALE. ALL DIMENSIONS TO BE VERIFIED ON SITE PRIOR TO FABRICATION, SETOUT OR CONSTRUCTION. REFER ANY DISCRE		
U D 1 O		ALL RIGHTS RESERVED. NO PART OF THIS DESIGN & DOCUMENTATION OR ALL WORKS EXECUTED FROM THIS DESIGN MAY BE REPRODUCED OR TRANSMITTED IN ANY FORM OR BY ANY MEANS WITHOUT WRITTEN PERMISSION FROM SF ARCHITECTS. DO NOT SCALE DRAWINGS. CHECK ALL DIMENSIONS ON SITE	ELANORA HEIGHTS ADDRESS: 74 ELANORA ROAD ELANORA HEIGHTS NSW 2101 CLENT:	DEMOLISH STRUCTURE     BOUNDARY     EXITENT OF APPROVED DA     EXISTING CUT	MASONRY SECTION TIMBER SECTION GLASS SECTION CONCRETE SECTION STEELMETUL SECTION	SCALE: @ PROJECT NO: DATE:	© A3 2408 17/12/24	
			JAMES HORTON AND ANNALIESE PEDAVOLI					

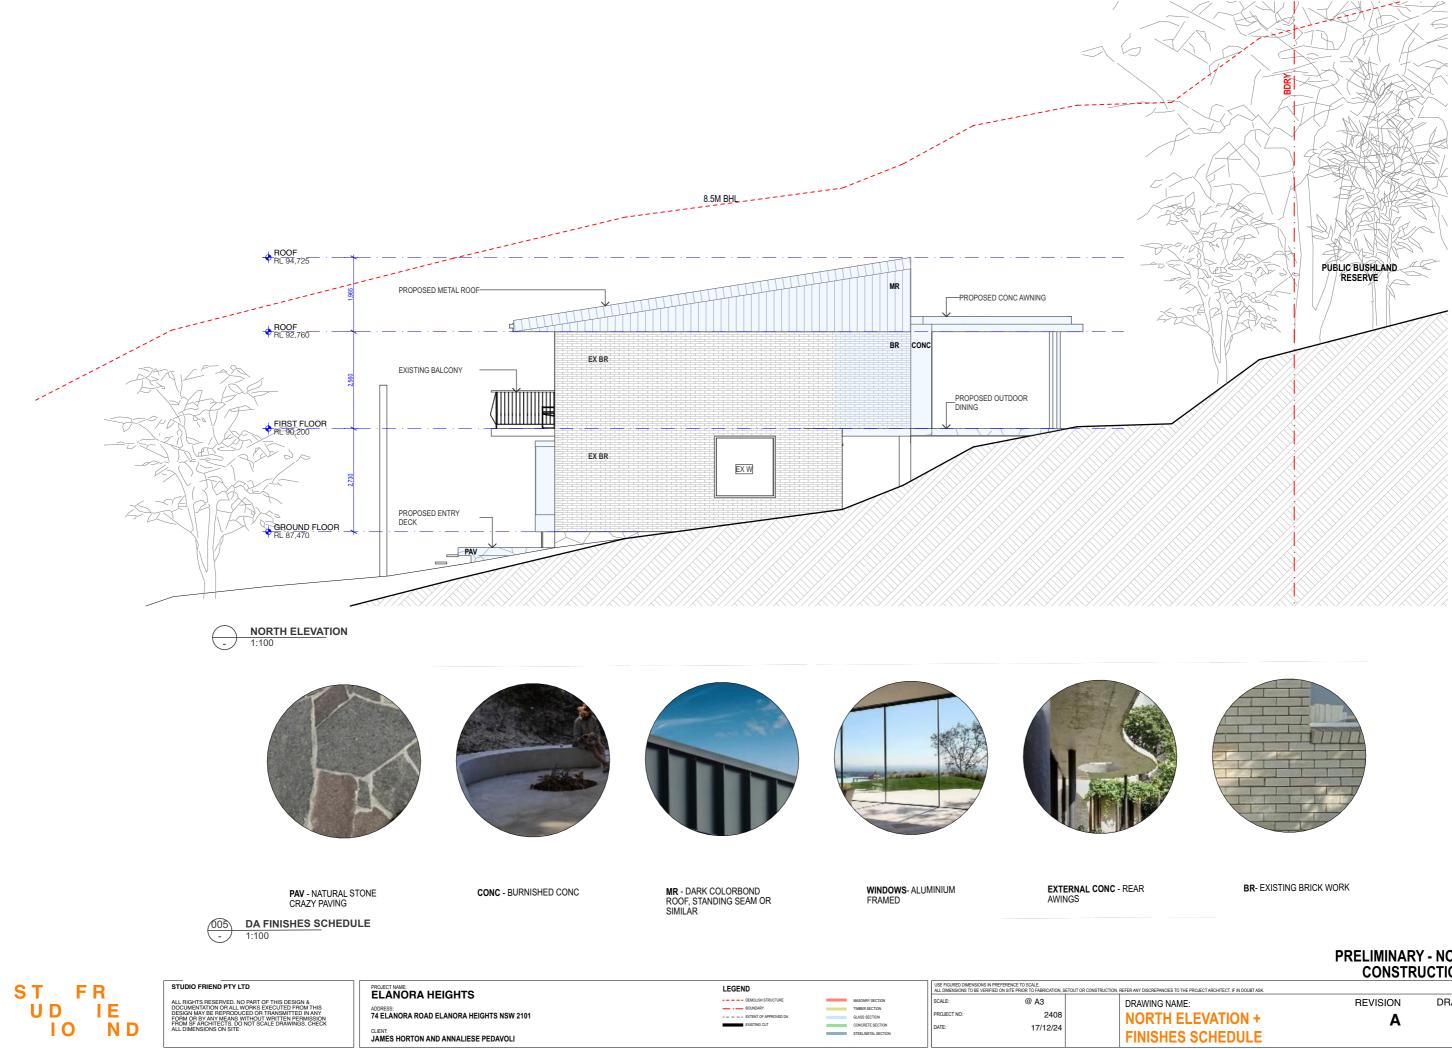

**FINISHES SCHEDULE** 


DRAWING NO: DA 20



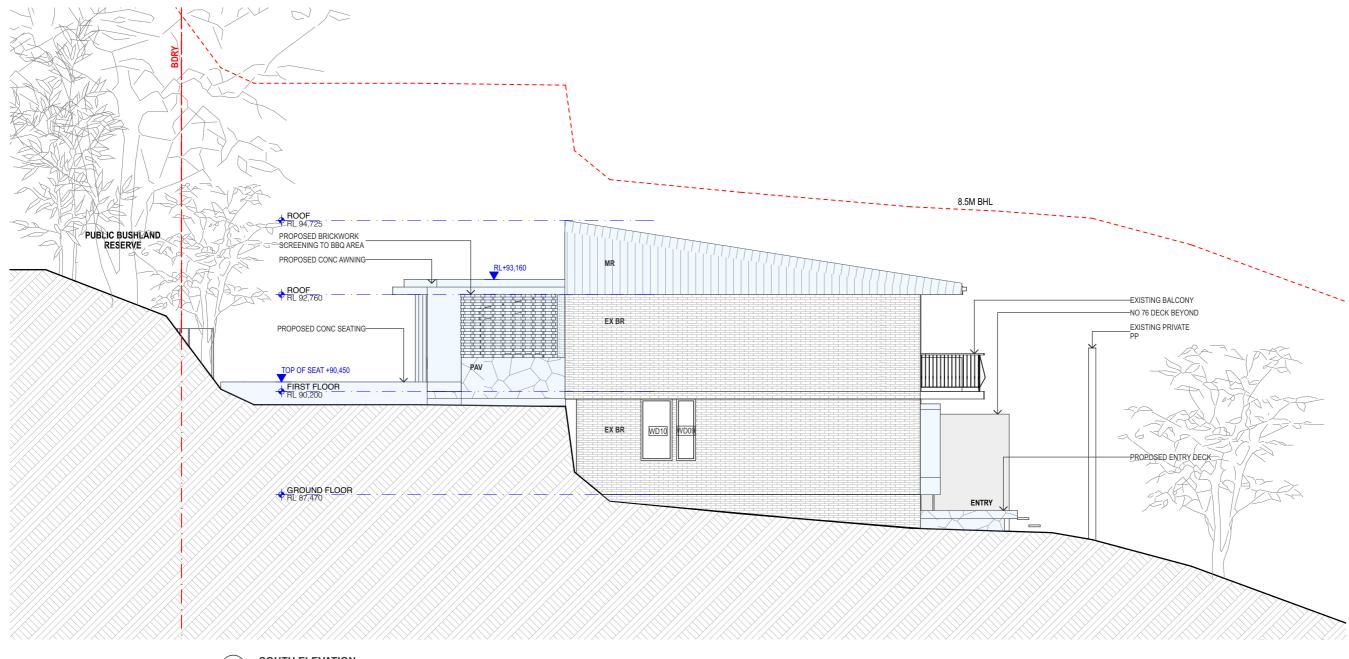

- 1:100



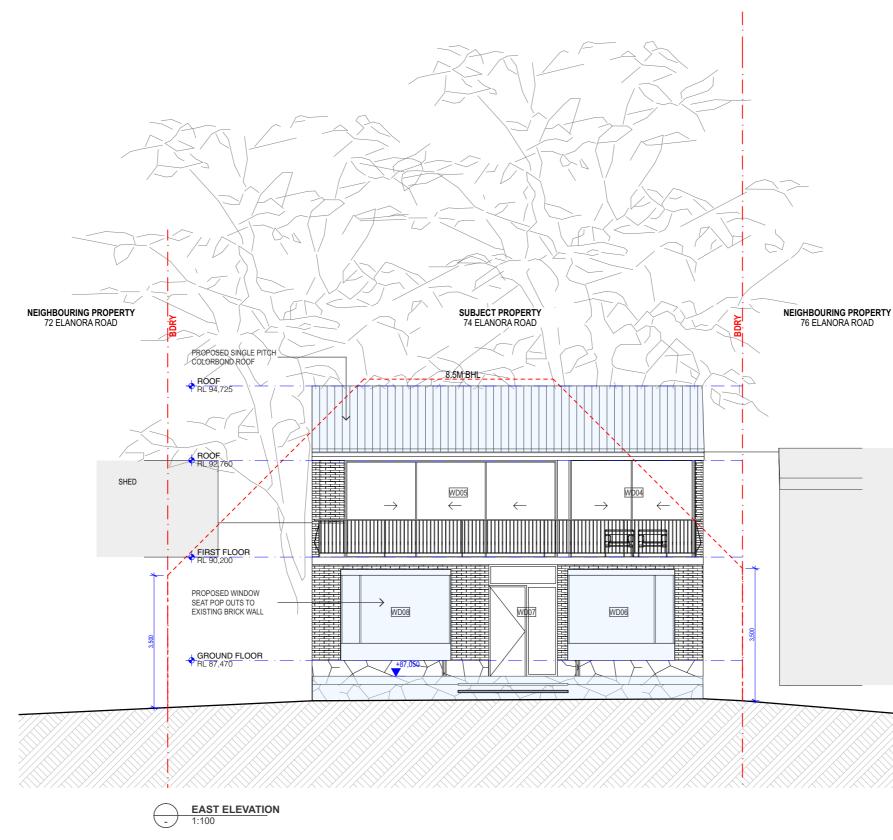



STUDIO FRIEND PTY LTD ALL RIGHTS RESERVED. NO PART OF THIS DESIGN & DOCUMENTATION OR ALL WORKS EXECUTED FROM THIS DESIGN MAY BE REPROUCED OR TRANSMITTED IN ANY FORM OR BY ANY MEANS WITHOUT WRITTEN PERMISSION ALL DIMENSIONS FOR STATE NOT SCALE DRAWINGS, OHECK ALL DIMENSIONS FOR STATE PROJECT NAME: ELANORA HEIGHTS LEGEND ---- DEMOLISH ADDRESS: 74 ELANORA ROAD ELANORA HEIGHTS NSW 2101 - - - - EVTENT 0 CLIENT: JAMES HORTON AND ANNALIESE PEDAVOLI

MASONRY SECTION TIMBER SECTION GLASS SECTION CONCRETE SECTION STEEL/METAL SECTIO SCALE: PROJECT NO: DATE:


se figu Ll dimen

TO SCALE. RIOR TO FABRICATION, SETOUT OR CONSTRUCTION. REFER ANY DISCREPANCIES TO THE PROJECT ARCHITECT. IF IN DOUBT ASK. @ A3 2408 17/12/24




REVISION Α



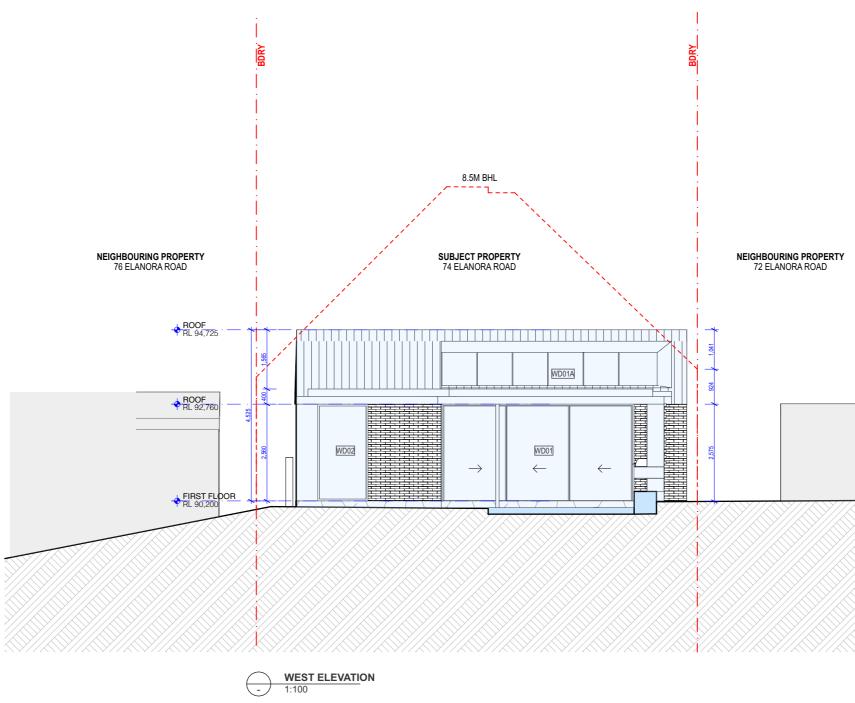






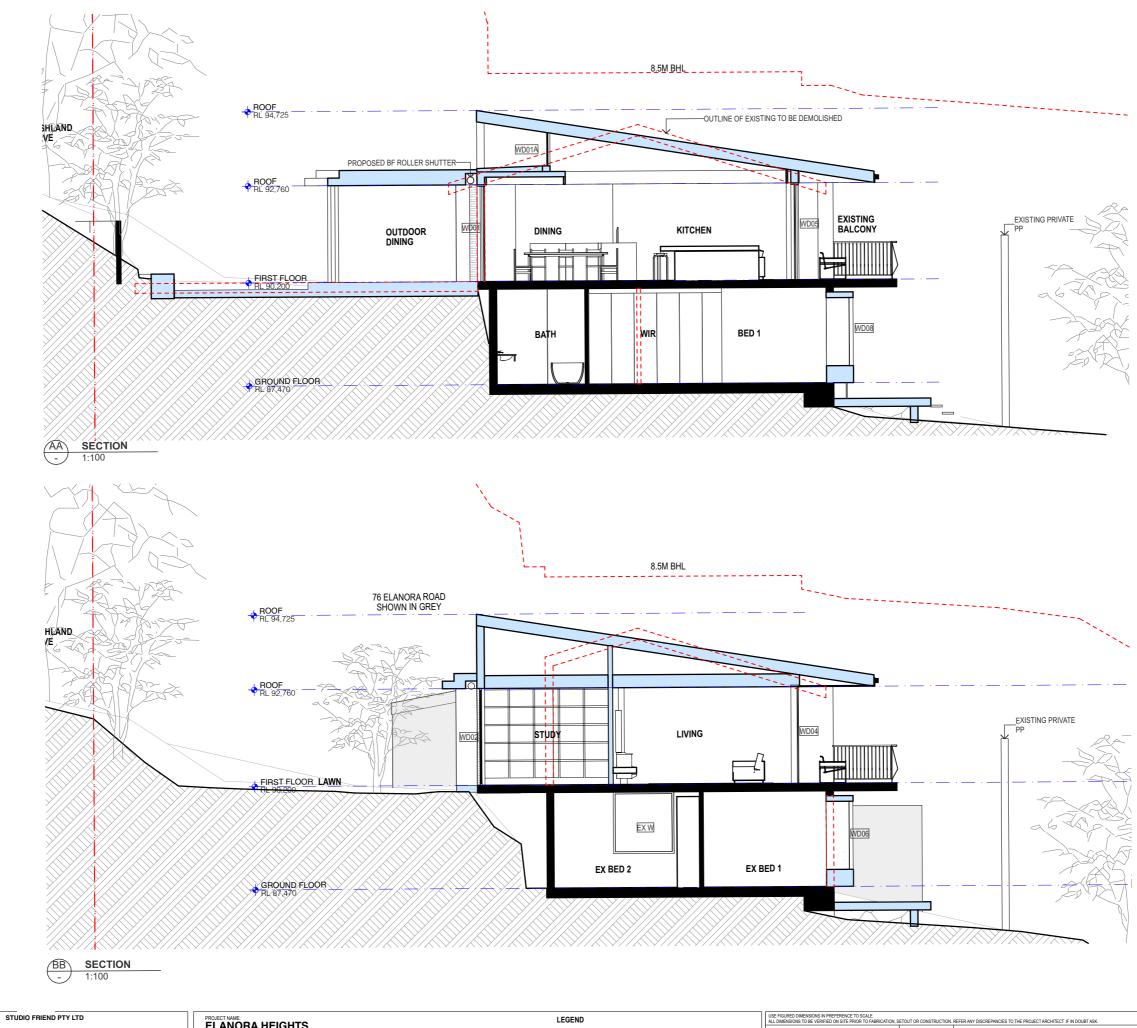

ST F R U D I E I O N D

 DRAWING NO: DA 30

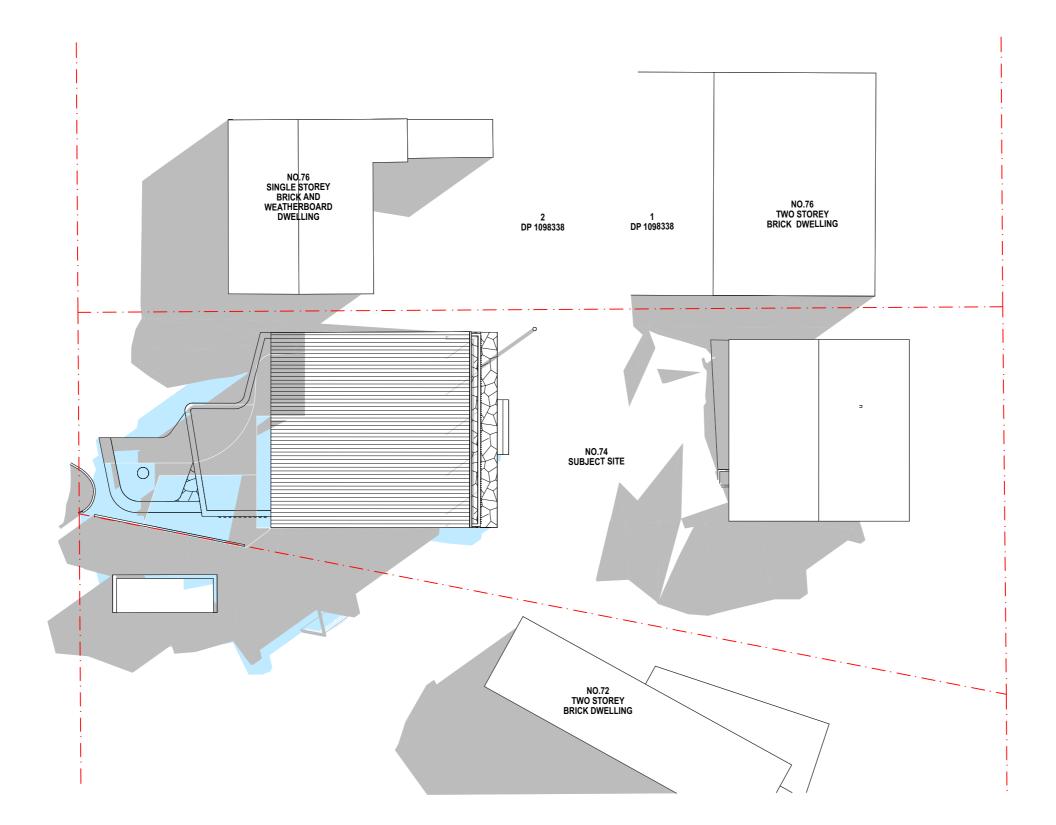

ST	FR	STUDIO FRIEND PTY LTD		LEGEND		USE FIGURED DIMENSIONS IN PREFERENCE TO SCALE. ALL DIMENSIONS TO BE VERIFIED ON SITE PRIOR TO FABRICATION	I, SETOUT OR CONSTRUCTION	REFER ANY DISCREI
Ŭ D I C	IE ND	ALL RIGHT'S RESERVED. NO PART OF THIS DESIGN & DOCUMENTATION OF ALL WORKS EXECUTED FROM THIS DESIGN MAY BE REPRODUCED OR TRANSMITTED IN ANY FORM OR BY ANY MEANS WITHOUT WRITTEN PREMISSION FROM SF ARCHITECTS. DO NOT SCALE DRAWINGS. CHECK ALL DIMENSIONS ON SITE	ADDRESS: 74 ELANORA ROAD ELANORA HEIGHTS NSW 2101 CLIENT: JAMES HORTON AND ANNALIESE PEDAVOLI	DEMOLISH STRUCTURE     BOUNDURY     EXTENT OF APPROVED DA     EXISTING CUT	MASORY SECTION THEER SECTION GLASS SECTION CONCRETE SECTION STEEL MEDAL SECTION	SCALE: 1:200 @ A3 PROJECT NO: 2408 DATE: 17/12/24		DRAWIN SHAD 21 JU

REPARCIES TO THE PROJECT ARCHITECT. IF IN DOUBT ASK. NG NAME: DOW DIAGRAM - 9AM UNE

REVISION


DRAWING NO: DA 40

### PRELIMINARY - NOT FOR CONSTRUCTION

PROPOSED ADDITIONAL SHADOWS

EXISTING SHADOWS

SHADOW DIAGRAM LEGEND

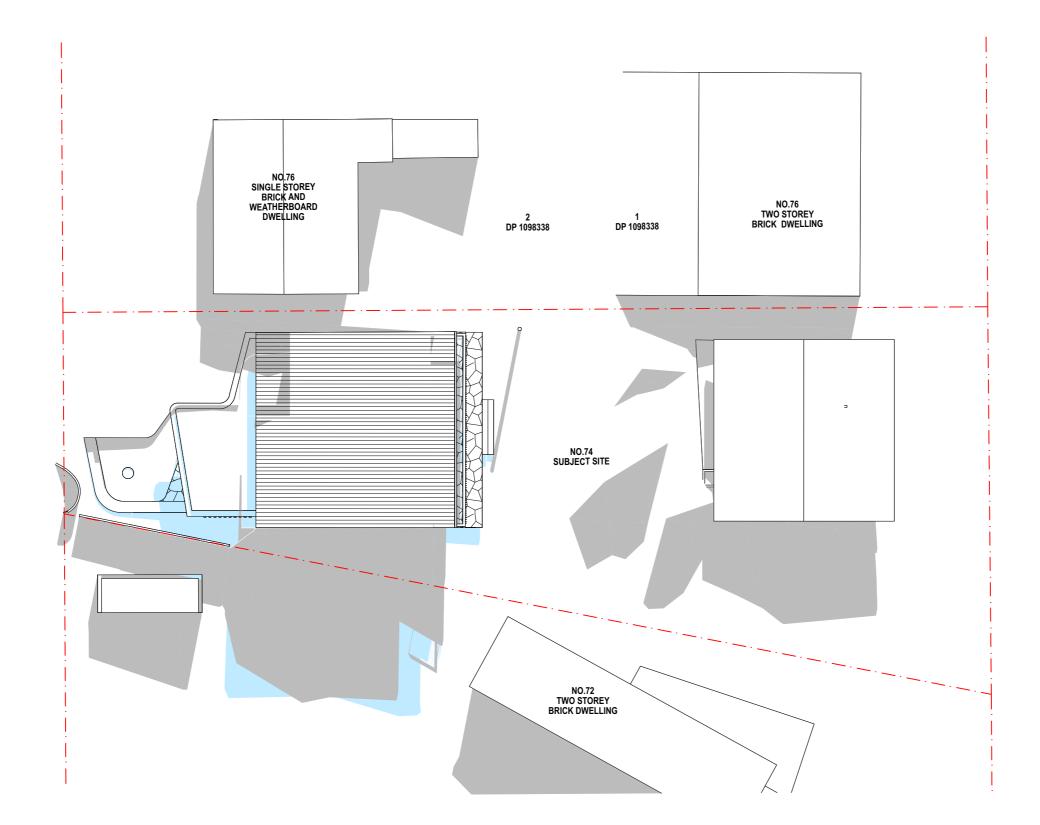

ςτ	FR	STUDIO FRIEND PTY LTD		LEGEND		USE FIGURED DIMENSIONS IN PREFERENCE TO SCALE. ALL DIMENSIONS TO BE VERIFIED ON SITE PRIOR TO FABRICATION	N, SETOUT OR CONSTRUCTION.	. REFER ANY DISCREI
Ŭ D I C	IE ND	ALL RIGHTS RESERVED. NO PART OF THIS DESIGN & DOCUMENTITY IG OF ALL WARGE SPECIFIED FROM THIS DESIGN MAY BE REPRODUCED OR TRANSMITTED IN ANY FORM OR BY ANY MEANS WITHOUT WRITTEN PERMISSION FROM SF ARCHITECTS. DO NOT SCALE DRAWINGS. CHECK ALL DIMENSIONS ON SITE	ADDRESS: 74 ELANORA ROAD ELANORA HEIGHTS NSW 2101 CLIENT: JAMES HORTON AND ANNALIESE PEDAVOLI	DEMOLISH STRUCTURE     DOUNDARY     EXTENT OF APPROVED DA     EXISTING OUT	MASONEY SECTION THREE SECTION GLASS SECTION CONCRETE SECTION STEELMETAL SECTION	SCALE: 1:200 @ A PROJECT NO: 240 DATE: 17/12/2	8	DRAWIN SHAE 21 JU


REVISION

### PRELIMINARY - NOT FOR CONSTRUCTION

PROPOSED ADDITIONAL SHADOWS

EXISTING SHADOWS

SHADOW DIAGRAM LEGEND

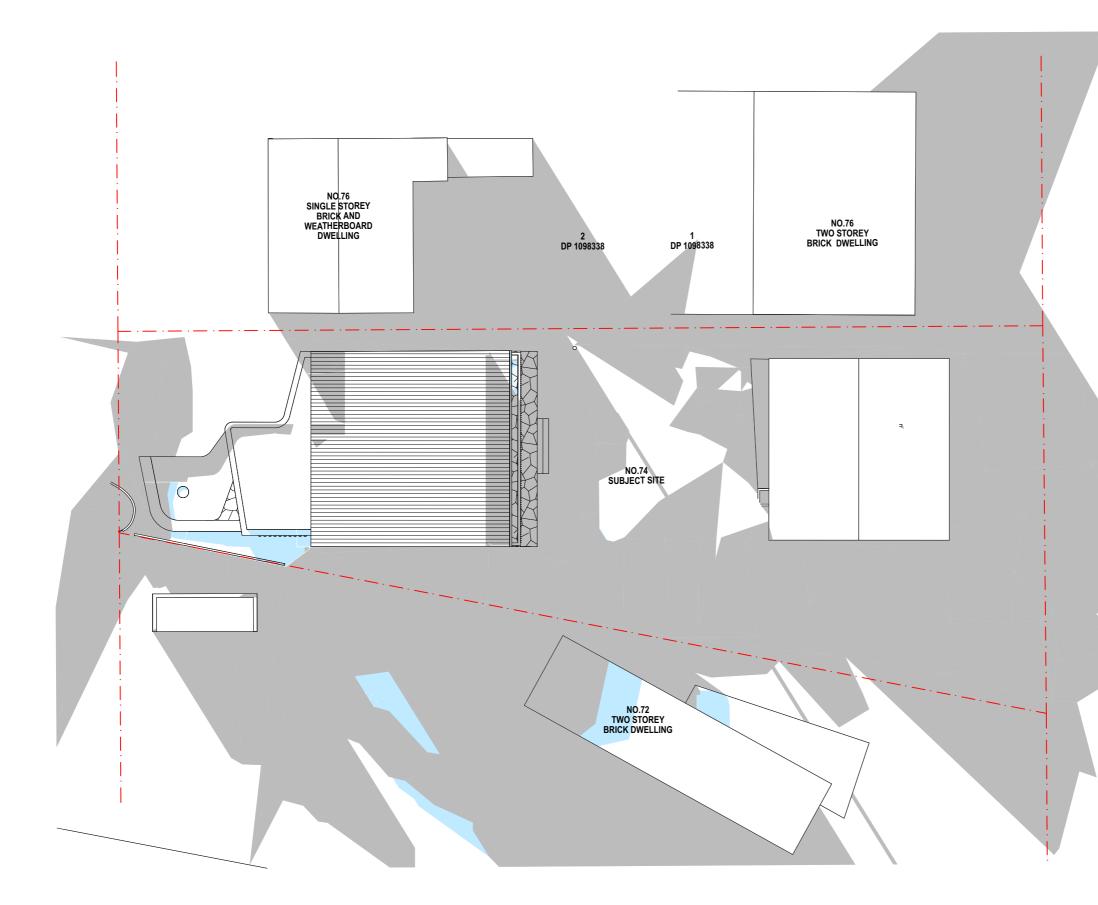

ST F	- R	STUDIO FRIEND PTY LTD		LEGEND		USE FIGURED DIMENSIONS IN PREFERENCE TO SCALE. ALL DIMENSIONS TO BE VERIFIED ON SITE PRIOR TO FABRICATION	I, SETOUT OR CONSTRUCTION.	. REFER ANY DISC
	I E N D	ALL DIRHT'S RESERVED. NO PART OF THIS DESIGN & DOCUMENTITION OF ALL WARKS EXECUTED FROM THIS DESIGN MAY BE REPRODUCED OR TRANSMITTED IN ANY FORM OR BY ANY MERAS WITHOUT WRITTER PREMISSION FROM SF ARCHITECTS. DO NOT SCALE DRAWINGS. CHECK ALL DIMENSIONS ON SITE	ADDRESS: 74 ELANORA ROAD ELANORA HEIGHTS NSW 2101 CLIENT: JAMES HORTON AND ANNALIESE PEDAVOLI	DEMOUSH STRUCTURE     DEMOUSH STRUCTURE     DURDARY     DEVIENT OF APPROVED DA     EXISTING CUT	MASONRY SECTION TIMBER SECTION GLASS SECTION CONCRETE SECTION STEELMETAL SECTION	SCALE: 1:200 @ A PROJECT NO: 2408 DATE: 17/12/24		DRAWII SHA 21 J

CREPARDES TO THE PROJECTARCHITECT. IF NDOUBTASK VING NAME: ADOW DIAGRAM - 3PM JUNE

REVISION


DRAWING NO: DA 42


### PRELIMINARY - NOT FOR CONSTRUCTION


PROPOSED ADDITIONAL SHADOWS

EXISTING SHADOWS


SHADOW DIAGRAM LEGEND

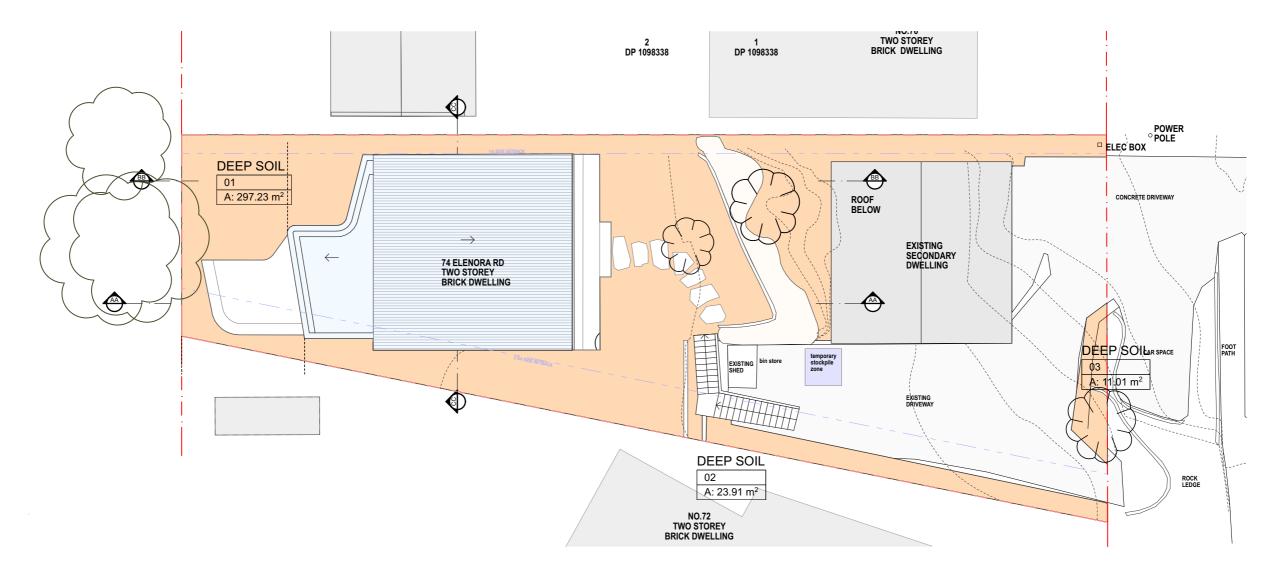


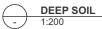

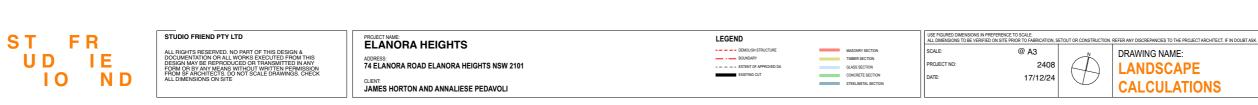

LANDSCAPE CALCS		
Zone Name	Measured Area	
DEEP SOIL	11.01	
DEEP SOIL	23.91	
DEEP SOIL	297.23	
	332.15 m <sup>2</sup>	

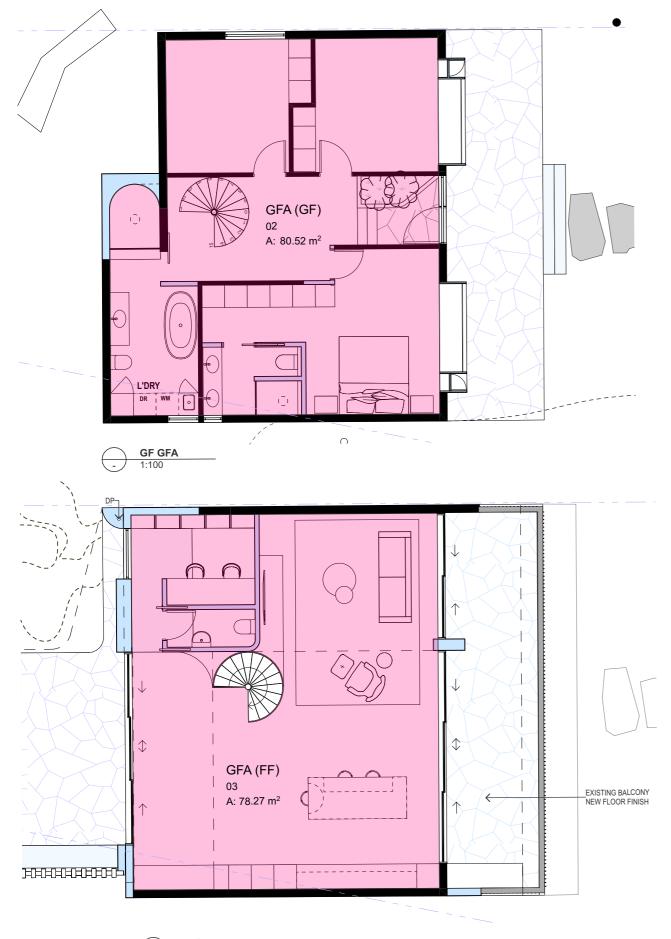

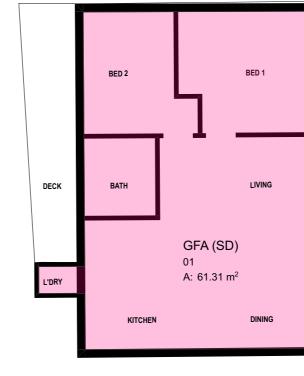

SECONDARY DWELLING GFA 1:100 (-)



ST FR UD IE ΙΟ N D



ELANORA HEIGHTS ADDRESS: 74 ELANORA ROAD ELANORA HEIGHTS NSW 2101 LEGEND DEMOLISH S - - - EXTENT OF A EXISTING C11 MASONRY SECTION TIMBER SECTION GLASS SECTION CONCRETE SECTION STEEL/METAL SECTION

SCALE:

DATE:

PROJECT NO:






#### PRELIMINARY - NOT FOR CONSTRUCTION

## SITE AREA 762m<sup>2</sup> GFA = 0.28:1

GFA CALCULATIONS	
Zone Name	Measured Area
GFA (FF)	78.27
GFA (GF)	80.52
GFA (SD)	61.31
	220.10 m <sup>2</sup>

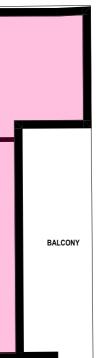



CLIENT: JAMES HORTON AND ANNALIESE PEDAVOLI

10

ND

GLASS SECTION GLASS SECTION CONCRETE SECTION STEELMETAL SECTIO PROJECT NO 2408 - EXTENT OF DATE: 17/12/24

ON NAME	NAME	SIZE	POT SIZE	INDICATIVE QUANTITIES
g Smoke Bush	Conospermum tenuifolium	0.3m	1L	9
< Lilly	Dianella congesta	Tube Stock	0.25L	6
Bush Is Bush	Ceratopetalum gummiferum Ricinocarpus pinifolius	2.5m 1m	5L 2L	4
Banksia	Banksia Eriafolia	1.5m	51	4
lba	Correa Alba	1.5m	51	4
iba	Conea Alba		JL	3
PLANTING / GR	OUND COVER BED			
ON NAME	NAME	SIZE	POT SIZE	INDICATIVE QUANTITIES
lba	Correa Alba	1m	5L	5
is	Poa affinis	Tube Stock	0.25L	8
1	Carpobrotus edulis	Tube Stock	0.5L	16
< Lilly	Dianella congesta	Tube Stock	1L	3
HFIRE RESISTIN	G PLANTING			
ON NAME	NAME	SIZE	POT SIZE	INDICATIVE QUANTITIES
g Smoke Bush	Conospermum tenuifolium	.3m	1L	8
Lilly	Dianella congesta	Tube Stock	1L	10
Bush	Hakea gibbosa	3m	2L	9
der Flower	Grevillea buxfolia	2.5m	3L	6

#### **PRELIMINARY - NOT FOR** CONSTRUCTION

## LANDSCAPE PLAN

DRAWING NO: **DA 60**