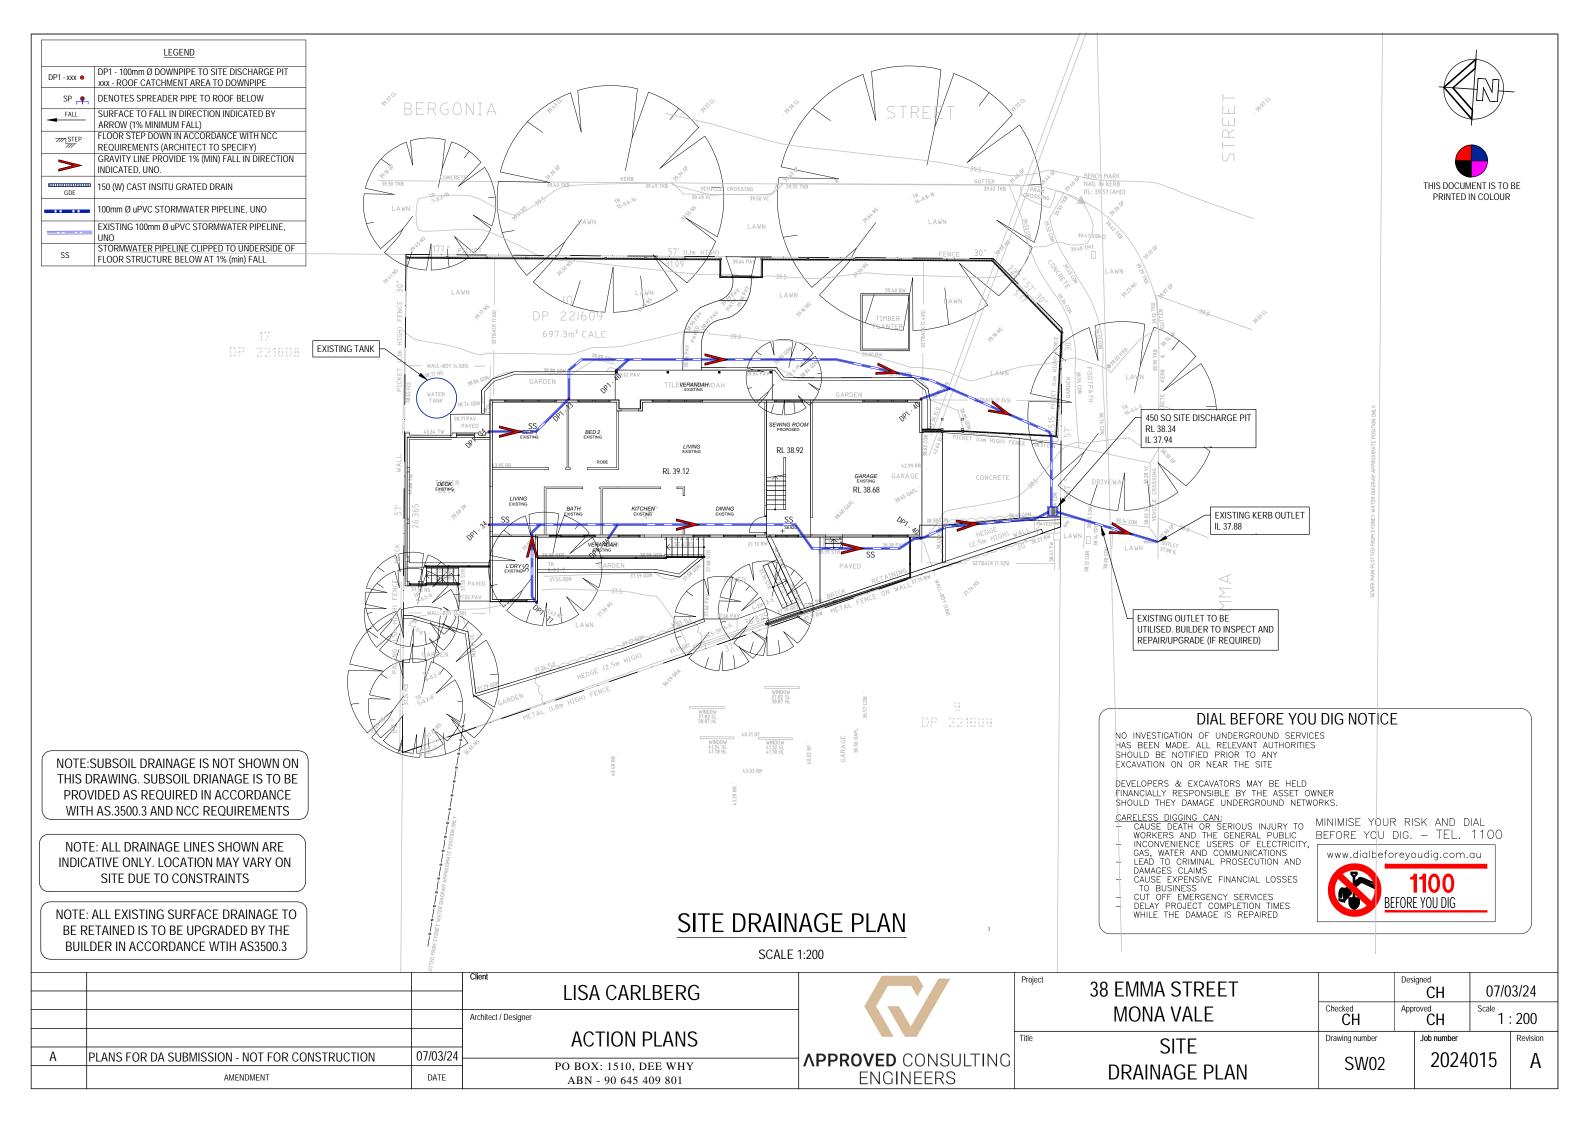
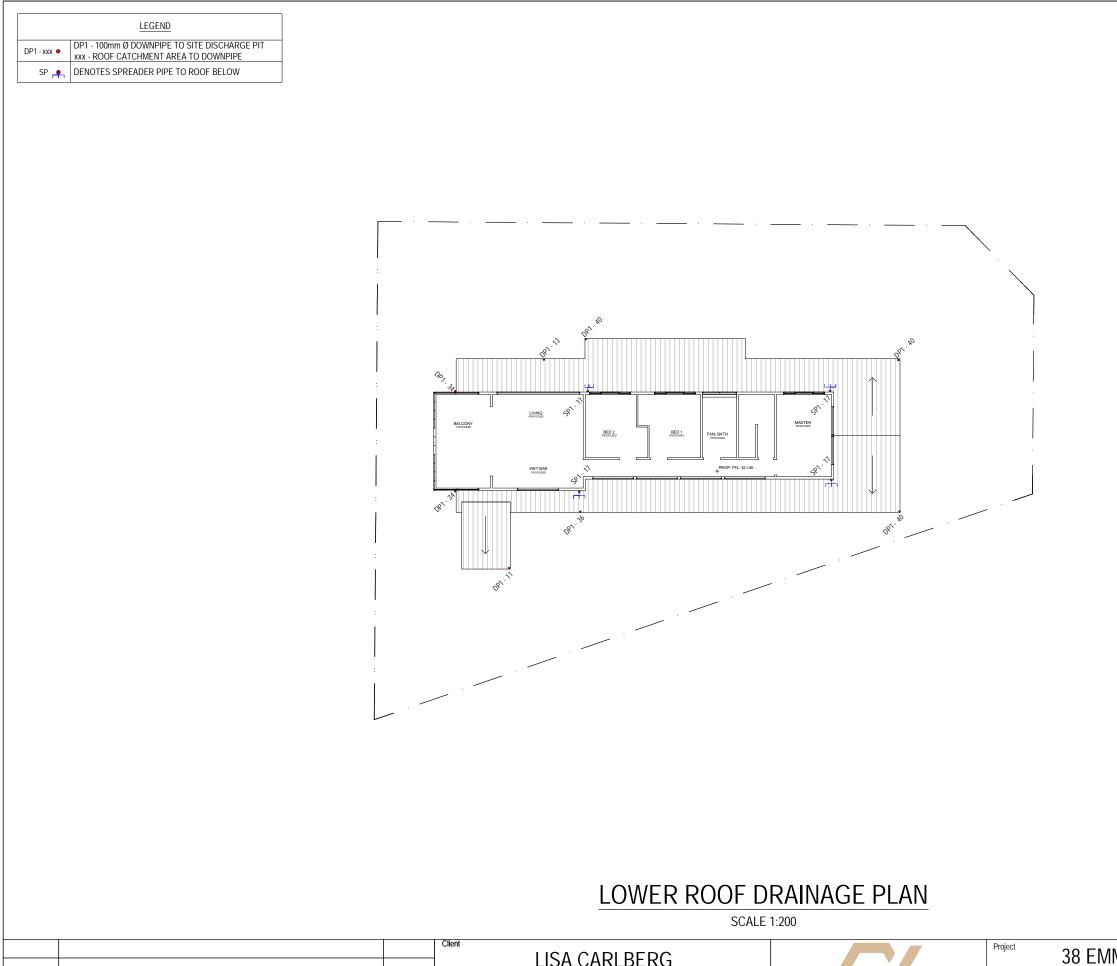
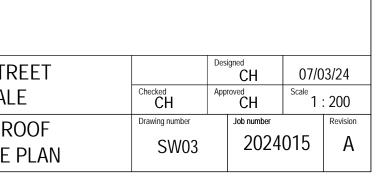
STORMWATER DRAINAGE NOTES:	RAINWATER STORAGE / REUSE	NOTES:	SITE INFORM	ATION SUMMARY
			COUNCIL	NORTHERN BEACHES (REGION 1)
 ALL PIPES TO BE 100mm Ø uPVC, LAID AT 1% MINIMUM GRADE TO AS1254.2002 U.N.O. ALL PIPES SHALL BE LAID ON A 75mm SAND BED, COMPACTED TO 100% S.M.D.D BELOW PAVEMENTS. (NO COMPACTION IS REQUIRED BELOW LANDSCAPING). COVER TO SURFACE FROM TOP OF PIPE TO BE 300mm MINIMUM. BACKFILL TO BE ADEQUATELY CONSOLIDATED AROUND PIPES BY METHOD OF RAMMING AND WATERING IN. TRENCHES TO BE FILLED WITH GRANULAR MATERIAL AS SPECIFIED. DOWNPIPE LOCATIONS ARE INDICATIVE ONLY. LOCATIONS TO BE CONFIRMED WITH ARCHTECT PROR TO COMMENCEMENT OF WORK. PROVIDE CLEANING EYES AND LEAF CATCHERS TO ALL DOWNPIPES. ALL WORK TO BE IN ACCORDANCE WITH LOCAL COUNCIL STANDARDS AND SPECIFICATIONS. ALL LEVELS SHOWN ARE TO AHD. ENSURE THAT ALL PITS AND STORMWATER PIPES ARE LOCATED CLEAR FROM TREE ROOT SYSTEMS. ALL EXISTING EARTHENWARE PIPES TO BE UPGRADED TO uPVC. ALL WORKS TO BE IN ACCORDANCE WITH AS3500.3.2003 NATIONAL PLUMBING AND DRAINAGE CODE PART 3 - STORMWATER DRAINAGE. SUBSOIL DRAINS ARE TO BE INSTALLED IN ACCORDANCE WITH AS3500.3 ALONGSIDE WALLS THAT IMPEDE THE NATURAL FLOW OF GROUNDWATER. THIS MAY ALSO INVOLVE TRENCHING INTO THE CLAY OR ROCK SUBGRADE TO DIRECT GROUNDWATER AWAY FROM STRUCTURES. EXISTING ROOF DRAINAGE AND SITE DRAINAGE SYSTEM TO BE CHECKED AND UPGRADED BUILDER TO INSPECT AND UPGRADE DRAINAGE IN ACCORDANCE WITH AS3500.3 IF REQUIRED. 	 THE RAINWATER TANK IS TO BE INSTALLED AT SYDNEY WATER AND NSW HEALTH REQUIREME ALL CONNECTIONS TO PLUMBING AND RAINW, SYDNEY WATERS 'GUIDE TO INSTALLING A RAIN WWW.SYDNEYWATER.COM.AU. PROVIDE DUAL SUPPLY SYSTEM AND BACKFL WITH 'BASIX - DESIGN GUIDE FOR SINGLE DWEI INFRASTRUCTURE, PLANNING AND NATURAL RI 201 PER 100 m2 OF ROOF CATCHMENT AREA PF INDIVIDUAL SITE ANALYSIS IS REQUIRED IN HEALARGER VOLUMES OF FIRST FLUSH RAINWATE WITH LOCAL HEALTH AUTHORITIES. SCREENED DOWNPIPE RAINWATER HEAD OR TO BE INSTALLED ON EACH DOWNPIPE. SCREE SELF-CLEANING. FIRST FLUSH DEVISED, OR APPROVED ALTER AUTOMATED DIVERSION AND DRAINAGE SYSTE DRAINAGE VALVES. REFER TYPICAL FLUSH OU' BEFORE PURCHASING MATERIALS OR PAINT 1 THE MANUFACTURER'S RECOMMENDATIONS O RAINWATER TANK SUITABILITY TO BE READ AN BUILDER/PLUMBER TO ENSURE THE INSTALLA IN ACCORDANCE WITH THE RELEVANT AUSTRA TANK DESIGN AND INSTALLATION HANDBOOK - ENGINEER. RAINWATER TANK TO BE WATERPROOFED IN ORIFICE PLATE (IF APPLICABLE) TO BE INSTALL ROOF DRAINAGE SYSTEM AND CONNECTION O TANK. 	ENTS FOR NON DRINKING USE ONLY. ATER TANKS IS TO BE IN ACCORDANCE W WATER TANK' AVAILABLE AT: OW PREVENTION SYSTEM IN ACCORDANC LINGS' BY NSW DEPARTMENT OF ESOURCES. H SYSTEM IS TO HAVE A MINIMUM SIZE OF RIOR TO ENTERING THE RAINWATER TANK WILY POLLUTED AREAS TO DETERMINE IF R ARE TO BE DIVERTED. IF IN DOUBT, CHE OTHER SUITABLE LEAF AND DEBRIS DEVION N MESH TO BE 4-6mm AND DESIGNED TO F NATIVE TO BE INSTALLED WITH AND EM, THAT IS, NO MANUAL DIVERSION AND T PIT FOR DETAILS. TO BE USED ON ROOF CATCHMENT AREAS N LABELS AND BROCHURES FOR D ADHERED TO. ATION OF THE RAINWATER TANK SYSTEM I LIAN STANDARDS AND THE RAINWATER HB 230- 2008. IF IN DOUBT CONTACT ACCORDANCE WITH HB-230-2008. LED PRIOR TO THE INSTALLATION OF THE	SITE AREA EXISTING IMPERVIOUS AREA PROPOSED IMPERVIOUS AREA REDUCTION SINCE THE INCREASE IN IMPERVIOUS NOT REQUIRED FOR THIS DEVELOPM A SA SA SA SA SA SA SA SA SA SA SA SA S	
Client	LISA CARLBERG		38 EMMA STREET	Designed CH 07/03/24
Architect / Designer	ACTION PLANS		MONA VALE	Checked CH Approved CH Scale CH 1 : 200 Drawing number Job number Revision
A PLANS FOR DA SUBMISSION - NOT FOR CONSTRUCTION 07/03/24 AMENDMENT DATE	PO BOX: 1510, DEE WHY ABN - 90 645 409 801	APPROVED CONSULTING ENGINEERS	GENERAL NOTES	SW01 2024015 A





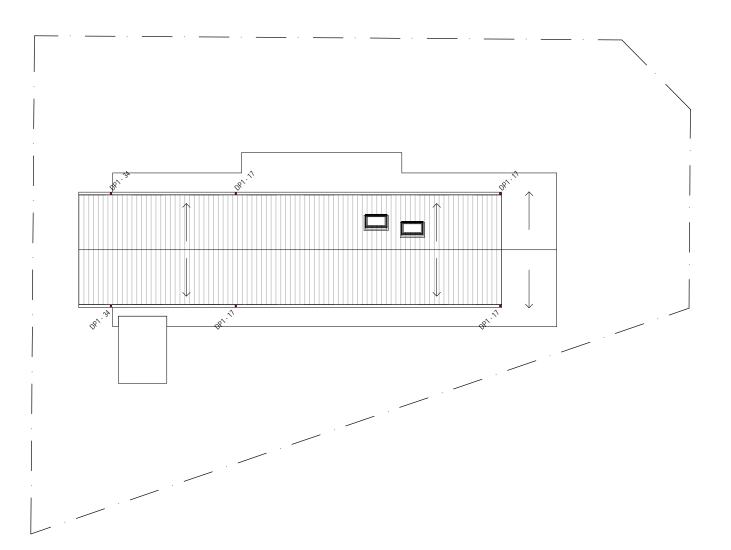
			LISA CARLBERG		Project	38 EMMA STR
			Architect / Designer			MONA VAL
			ACTION PLANS		Title	LOWER R
A	PLANS FOR DA SUBMISSION - NOT FOR CONSTRUCTION	07/03/24	PO BOX: 1510, DEE WHY	APPROVED CONSULTING		
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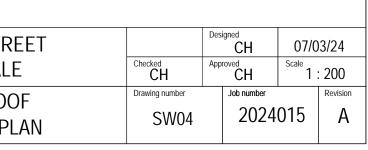


	LEGEND
DP1 - xxx 🔹	DP1 - 100mm Ø DOWNPIPE TO SITE DISCHARGE PIT xxx - ROOF CATCHMENT AREA TO DOWNPIPE
SP 📮	DENOTES SPREADER PIPE TO ROOF BELOW
-	ARROW INDICATES DIRECTION OF ROOF SLOPE. REFER ARCHITECTURAL PLANS FOR ROOF PITCH



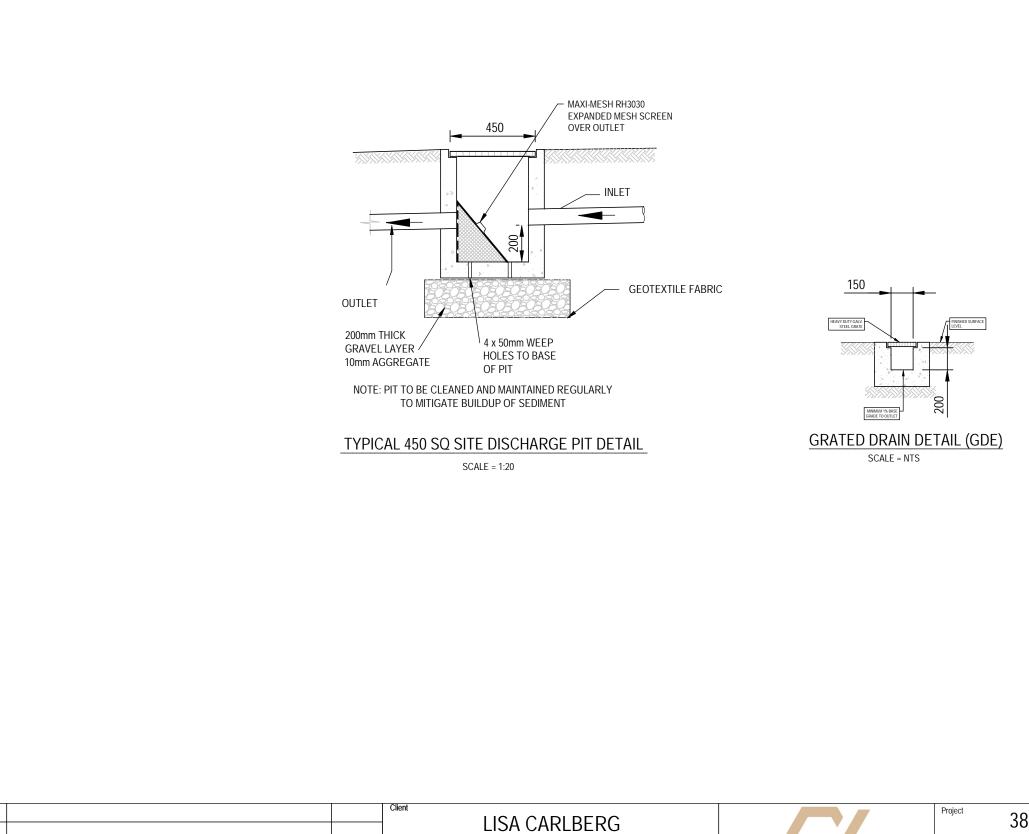
UPPER ROOF DRAINAGE PLAN

			SCA	LE 1:200		
			LISA CARLBERG		Project	38 EMMA STR
			Architect / Designer			MONA VAL
Δ	PLANS FOR DA SUBMISSION - NOT FOR CONSTRUCTION	07/03/24	ACTION PLANS		Title	UPPER ROC
	AMENDMENT	DATE	PO BOX: 1510, DEE WHY ABN - 90 645 409 801			DRAINAGE PL





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	Architect / Designer	MONA VALE	Checked CH	Approved CH	Scale 1:20	00	
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