#### **DRAWING REGISTER Drwg Scale Drwg No Drwg Name** Cover Page DA 000 1:50 Design Intent DA 001 1:250 Calculations DA 002 1:750, 1:200 DA 004 Site Analysis DA 005 Site Plan 1:100 Demolition Plan - Ground Floor & L1 1:100 1:100 DA 011 Demolition Plan - Roof 1:100 DA 099 Basement Plan Ground Floor & L1 Plan 1:100 L2 & L3 Floor Plan DA 101 1:100 DA 102 L4 & L5 Floor Plan 1:100 L6 & L7 Floor Plan 1:100 Rooftop Floor Plan DA 104 1:100 Ground Floor Plan - Extended Rear Lane 1:100 DA 110 DA 200 Elevations 1:100 DA 201 Elevations 1:100 DA 202 1:100 Elevations DA 300 Sections 01 1:100 DA 301 Sections 02 1:100 1:100 DA 302 Sections 03 DA 303 Detailed Section - Future Development 1:100 Heritage Component DA 400 1:20 Schedule of External Finishes DA 620 DA 700 June 21 9am Existing Shadow Diagram 1:200 June 21 9am Proposed Shadow Diagram 1:200 DA 701 June 21 12pm Existing Shadow Diagram DA 702 1:200 June 21 12pm Proposed Shadow Diagram DA 703 1:200 June 21 3pm Existing Shadow Diagram 1:200 DA 704 DA 705 June 21 3pm Proposed Shadow Diagram 1:200

1:100 1:100, 1:200, 1:250

## **CONSULTANT LIST**

DA 720

Solar Analysis

691 Pittwater Rd Car Stackers Detail

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# MIXED USE BOARDING HOUSE DEVELOPMENT

691 Pittwater Rd, Dee Why NSW



3D PERSPECTIVE BY BKA ARCHITECTURE



**EXISTING SITE PANORAMIC PHOTO** 

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26/11/20 ISSUE TO COUNCIL

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PROJECT# **19049** | SCALE @ A1 Mixed Use Boarding House Development AT/JG CHECKED ADDRESS 691 Pittwater Road Dee Why NSW **DA 000** Gannet Developments Cover Page







This proposal is for a mixed use, 64 room boarding house development located in the heart of Dee Why's Town Centre at 691 Pittwater Road, Dee Why. Dee Why Town Centre and Pittwater Road is characterised by a mix of commercial buildings 2-3 storeys high and newer mixed use multi-residential buildings with retail at Ground level up to 15 stories in scale. Pittwater Road is a major public transport route and has a high volume thoroughfare of cars, buses and pedestrian activity.

The site enjoys excellent access to **public transport services** including 11 bus stops within 400mm walking distance. These bus stops offer a variety of routes including the express **B-Line** bus to the City/Wynyard as well as services to Manly, Palm Beach, Elanora Heights, North Sydney and Mosman. This site is within walking distance to the Town Centre's central amenities including Northern Beaches Council, Dee Why Library, and the Village Plaza, as well as the wider town centre and Dee Why Beach. This lends the site as appropriate for convenient affordable residential accommodation for key members of the public who value ease of location and access to amenities and the beach.

The site forms part of a triangular block bound by Pittwater Road to the South-East, Fisher Road to the West, and St David Avenue to the North. Situated beside retail businesses at 693a Pittwater Road and 689 Pittwater Rd, the subject site is located in a **B4 Mixed Use Zone**. Partially adjoining the rear of the site on Fisher Road is the Salvation Army which consist of 4 buildings including a church.

The immediate context of 691 Pittwater Road looks towards higher density, a diversifying population and supports affordability. Located nearby at 701 Pittwater Road is a newly developed apartment block and highlights the current progression and transformation of the Town Centre.

The site is approximately 650m<sup>2</sup> in area and is legally known as Lot 1 in DP166322.

## HERITAGE & ARCHITECTURE

The facade of the existing building at 691 Pittwater Road is listed as an item of environmental heritage in the WLEP 2011, identified as I48 on the LEP maps. The two storey **Art Deco** style building was built in 1941 and operated as a Commonwealth Bank Branch up until 2018. Whilst extensive alterations have occurred on the interior, only minor modifications have been made to the front facade. These include an additional room on the right hand side of the facade to allow for AMT facilities, a large awning to cover the footpath, and black paint to the original red granite. The awning is a continual theme along the street frontage, however, detracts the original essence of the historical facade

The proposal seeks to restore the front facade to its original intent via removing the ATM partition walls to reveal the symmetrical nature of the Art Deco style. The awning is also proposed to be removed and replaced with a small glass awning limited to above the new proposed accessible entryway.

The addition of the boarding house development not only respects the historical significance of the building, but further adds to the gentrifying streetscape. Typical of **Art Deco characteristics**, and similar to the retained heritage facade, the proposal offers an overall composition inclusive of a strong vertical emphasis, geometric forms, smooth wall surfaces and a stepped outline.

The plan consists of an 'E' built form with a front, middle and rear bock with an internal courtyard. Both front and rear facades portray the same characteristics of the typical Art Deco style. The rear block includes a rooftop urban farm whilst the top storey of the front facade is further recessed from the street and changes materiality.

The middle block is situated within the internal courtyard void and is separated from its neighbouring boundary by 6m. This assists on a range of essential factors including additional solar access and natural ventilation, increased visual dynamics and increased privacy throughout each level. Similarly to the front and rear facade, the middle block continues the motifs of floor to ceiling windows, angular walls and geometric forms.

#### SELF CLOSING LOUVRES ON ACTIVATION WITH DRENCHES MIN 5% OF ROOM AREA TO BCA TILT AND TURN FIRE DOOR AND SAFETY **CORRIDOR** DOUBLE ROOM **WINDOWS** SCREEN DOOR FOR ADDED 3,000 PICAL ROOM **VENTILATION** 100 **SPANDREI COURTYARD** CROSS VENTILATION **OUTSIDE** REFER TO BASIX, SECTION J & NOISE IMPACT RÉPORTS

Typical Room Sectional Study

## FSR & USES

The development consists of retail and office spaces as well as 63 boarding rooms over 7 storeys plus a manager's room. Due to the site being in an Accessible Area (land within 400m walking distance of a bus stop used by a regular bus service), the affordable housing component is suitable and encouraged.

"Boarding houses serve an important role in providing low cost accommodation for people who value affordability and location over space, and who prefer simple, flexible and tenure arrangements.

- NSW Government planning - AHSEPP Review 2010

Bird's Eye View

Not only do these arrangements provide housing opportunities for low and moderate income earners, it also encourages cultural and economic diversity, assists local businesses to attract and retain employees, and promotes "live near work" housing which helps alleviate traffic congestion and the environmental impacts associated with long commutes.

The proposed development achieves an FSR lower than the maximum allowed. The site has an allowable FSR of 4:1 and the proposal for the boarding house achieves and FSR of 3.64:1.

It comprises a New Generation Boarding House where each room consists of a private bathroom, kitchenette and a combination washer dryer to allow for independence and flexibility. The proposal includes four accessible rooms as required by the BCA.

The site currently provides zero landscaped or deep soils areas. The proposed development greatly improves the status quo by providing 147m<sup>2</sup> of **deep soil planting** (>22% of the site) and rooftop urban farm. The ground floor street frontage is traditionally used as retail and is being retained. An accessible entry to the rest of the development is provided through the western thoroughfare via a ramp. This leads up to a communal courtyard area which includes 127 bicycle spaces (in lieu of zero carparking), retail facilities, and communal waste rooms. In addition, three levels of podium towards Pittwater Road retains as commercial; consistent with the existing and future character of the area.

A communal living, kitchen and dining are located on the top floor of the front block and benefits from the northern orientation as well as ocean views of Dee Why Beach to the South-East. It also directly connects to oversized communal outdoor areas. The communal area to the North takes advantage of passive solar design as they receive a minimum of 3 hours of sunlight between 9am and 3pm in mid winter. The proposed urban farm also promotes communal activity and socialisation. It encourages a healthy lifestyle and living opportunities within the Boarding House.

The proposal looks towards the near future and **advocates for sustainability** and carbon neutrality. The following sustainable strategies have been implemented: - A large solar power arrangement efficiently orientated on the rooftop, plus rainwater catchment system to further boost the project's green credentials. - The 'E' shaped formation makes the best use of solar access, views and

protection from strong and gusty winds. - Solar access and cross ventilation achievements including ceiling fans and no air

- The innovation of bicycle parking as a substitute for car parking not only promotes healthy lifestyles, but further reduces the environmental impact of traffic congestion and pollution.

The proposal also caters for the **future laneway** envisioned by Council, running through the rear 6m setback provided within the site. Waste collection, services and the possibility of up to three car parking spaces were strategically located towards this area for this purpose.

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## **QUALITY OF MATERIALS**

Due to the importance to retain the original heritage facade; a mix of materials consisting of precast concrete and lightweight metal cladding, provide a sense of tradition and durability. Reflective of the Art Deco style of smooth facades and vertical compositions, the precast concrete respects the traditional material of its surroundings.

The **natural palette** has been accentuated by earthy paint tones which highlights a different shade on each floor level. As well as this, a sense of delicacy and refinement is portrayed via black metal balustrades, awnings and window accents.

There is also an opportunity for an extensive artwork/mural to be provided along the courtvard wall which will further enhance the communal ground floor areas.

The architectural style and quality of materials proposed for 691 Pittwater Road embraces a contemporary addition to the fast changing and growing neighbourhood. It is because of this that the proposal is an opportunity for creative endeavour, which results in a unique design with ties that link the past to the



View From Corner of Pittwater Rd & St David Ave

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PROJECT# Mixed Use Boarding House Development AT/JG CHECKED 691 Pittwater Road Dee Why NSW DATE 27/11/20 DRAWING No. Gannet Developments Design Intent

19049 | SCALE @ A1

**DA 001** 

### **DA Calculations**

Project Number: 19049 Project Address: 691 Pittwater Rd, Dee Why Date: November 2020

| GFA and FSR Controls | Control | LEP  | Proposed | Compliance |
|----------------------|---------|------|----------|------------|
|                      |         |      |          |            |
| Site Area (sqm):     |         | 650  |          |            |
|                      |         |      |          | <b>~</b>   |
| FSR:                 |         | 4:1  | 3.64:1   |            |
| Max GFA (sqm):       |         | 2600 | 2418.4   | <b>✓</b>   |
| ADLL CEDD Donus *.   | NI/A    |      |          |            |

\*26 (1) (c) if the development is on land within a zone in which residential flat buildings are permitted and the land does not contain a heritage item that is identified in an environmental planning instrument or an interim heritage order or on the State Heritage Register —the existing maximum floor space ratio for any form of residential accommodation permitted on the land, plus:

(i) 0.5:1, if the existing maximum floor space ratio is 2.5:1 or less, or

(ii) 20% of the existing maximum floor space ratio, if the existing maximum floor space ratio is greater than 2.5:1.

| Net GFA (sqm) |              |        | _           |            |
|---------------|--------------|--------|-------------|------------|
| Level         | Commercial / | Office | Residential | Communal / |
|               | Retail       |        |             | Service    |
| Ground Floor  | 63.90        |        |             | 175.55     |
| Level 1       |              | 130.71 | 150.25      | 58.02      |
| Level 2       |              | 56.07  | 150.25      | 58.02      |
| Level 3       |              |        | 268.38      | 60.81      |
| Level 4       |              |        | 268.38      | 60.81      |
| Level 5       |              |        | 272.71      | 60.81      |
| Level 6       |              |        | 272.71      | 60.81      |
| Level 7       |              |        | 139.53      | 110.68     |
| Total:        | 63.9         | 186.78 | 1522.21     | 645.51     |
| TOTAL GFA     | 2418.4       |        |             | -          |

| Required DCP/SEPF<br>Average 33% **<br>per unit = 22   | Proposed 2 x Car Share +  | Compliance   |
|--|---|--|
| <u> </u>   | 2 v Car Share +   |  |
| spaces   | 9 Standard +<br>1 Manager's =   | ×  |
|  | <b>12</b> Automatic   |  |
| 1 / 16.4 sqm = 3.8 spaces  | 0   | ×  |
| 1 / 40sqm = 4.7<br>spaces  | 0   | ×  |
| 31   | 12 (post-<br>laneway  | ×  |
| 13   | 13 (post-laneway  | V  |
| Units 1x5 = 12.8  Office Employees 1/200m2 + Visitors 1/750 m2 = 1  Retail 1/200m2 +  Visitors 1/600m2=1 | 45 (first stage) -<br>15 (post<br>laneway<br>construction)  |  |
|  | spaces  1 / 40sqm = 4.7 spaces  31  Units 1x5 = 12.8  Office Employees 1/200m2 + Visitors 1/750 m2 = 1  Retail 1/200m2 + Visitors | 12 Automatic  1 / 16.4 sqm = 3.8 spaces  0  1 / 40sqm = 4.7 spaces  0  12 (post- laneway  13 (post-laneway  Units 1x5 = 12.8  Office Employees 1/200m2 + Visitors 1/750 m2 = 1 Retail 1/200m2 + Visitors 1/600m2=1 |

| Existing Car Parking Requirements.  Bank Branch  | Required DCP               | Current | Compliance     |
|--|----------------------------|---------|----------------|
| Customer Service = 587.63 sqm.<br>(Ground Floor) | 1 / 16.4sqm = 36<br>spaces | 0       | ×              |
| Office = 368.82 sqm<br>(Level 1)                 | 1 / 40sqm = 9<br>spaces    | 0       | ×              |
| TOTAL Existing Car Parking required:             | 45                         | 0       | <b>×</b> (-45) |


Research Paper


NOTE: Proposed development reduces current deficit of car

| Setback Controls DCP                          | Compliance |                                      |
|---|------------|--------------------------------------|
| Front Setback 5m from kerb first 4th Levels   | <b>~</b>   | NOTE: Heritage item setback prevails |
| Front Setback 9m from kerb above<br>4th Level | <b>~</b>   |                                      |
| Height Controls LEP                           |            |                                      |
| Current LEP Height Limit 27m                  | V          |                                      |


| Single | Double      | Accessible ***   | Manage  |
|--------|-------------|--|---|
| Rooms  | Rooms       | Accessible   | Mariago   |
|        |             |  |   |
|        | 5           | 1  |   |
|        | 5           | 1  |   |
|        | 10          | 1  |   |
|        | 10          | 1  |   |
| 2      | 10          |  |   |
| 2      | 10          |  |   |
|        | 5           |  | 1   |
| 4      | 55          | 4  | 1   |
| 64     |             |  |   |
|        | 2<br>2<br>2 | Rooms         Rooms           5         5           10         10           2         10           2         10           5         5           4         55 | Rooms         Rooms           5         1           5         1           10         1           2         10           2         10           2         5           4         55 |

|                                     | ^^^ Min Req B | CA: 61 to 80 | Units = 4 Accessible          |
|-------------------------------------|---------------|--------------|-------------------------------|
| Communal Living and Open Space      |               |              |                               |
| Level                               | Required      | Room         | Proposed Area (sqm)           |
| Communal Living Space (sqm)         | size not      | Communal     | 52.60                         |
|                                     | specified     | Lounge       |                               |
| Communal Open Space (sqm)           | 20 (ARH       | Roof         | 40.35 + 34.55 = 74.9 <b>V</b> |
| Boarding House                      | SEPP)         | Terraces     | (+54.9 sqm)                   |
| Landscaped Area (sqm) DCP           | 20% of Site   | Groud        | 11.27= 11.27sqm               |
| means a part of a site used for     | Area DCP =    | Floor        |                               |
| growing plants, grasses and trees,  | 130sqm        | Level 1      | 27.71+16.92=                  |
| but does not include any hard paved |               |              | 44.63 sqm                     |
| area                                |               | Level 2      | 5.25 sqm                      |
|                                     |               | Level 3 &    | 2 x (6.68 + 2.21)=            |
|                                     |               | 4            | 17.78sqm                      |
|                                     |               | Level 5 &    | 2 x (2.21 + 2.21)=            |
|                                     |               | 6            | 8.84sqm                       |
|                                     |               | Level 7 &    | 20.74 + 25.06 + 1.34          |
|                                     |               | Roof Top     | +1.34 + 2.24 = 50.72sqm       |
|                                     |               | TOTAL        | 138.49 sqm 🔽                  |
|                                     |               |              |                               |

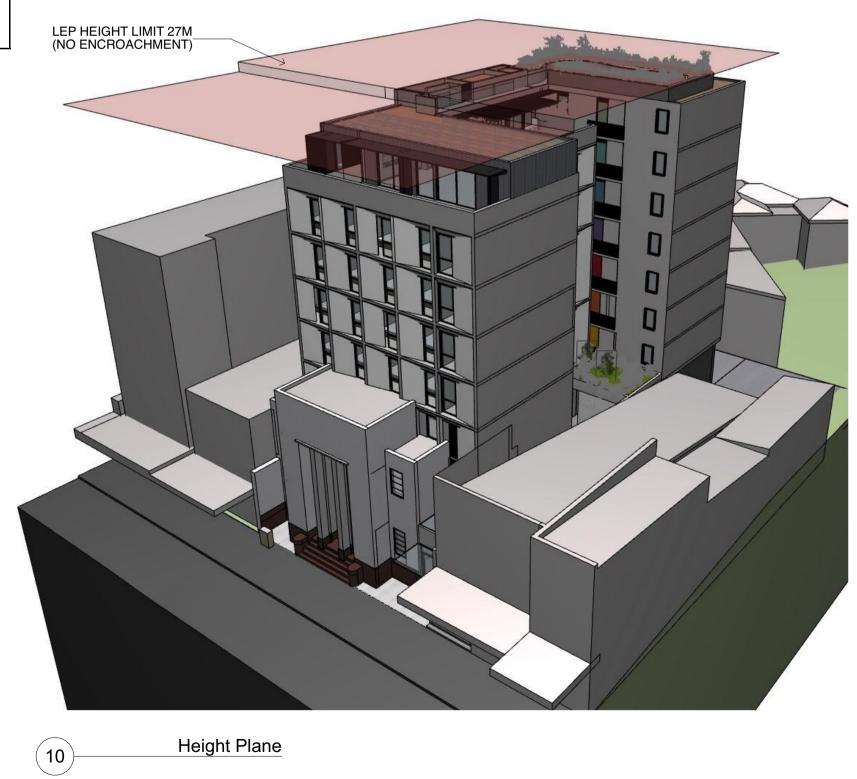


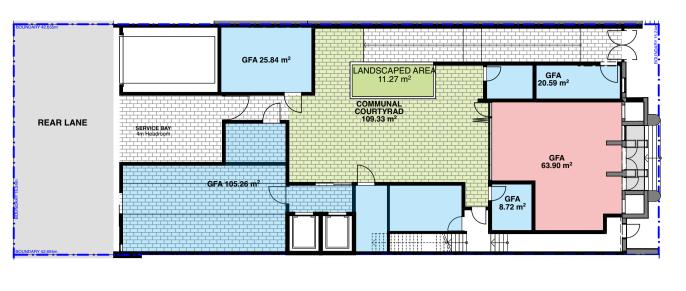




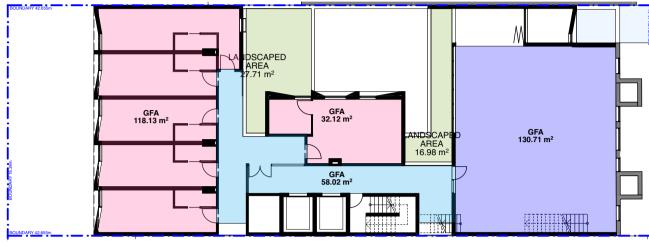

Level 1 GFA 1:250

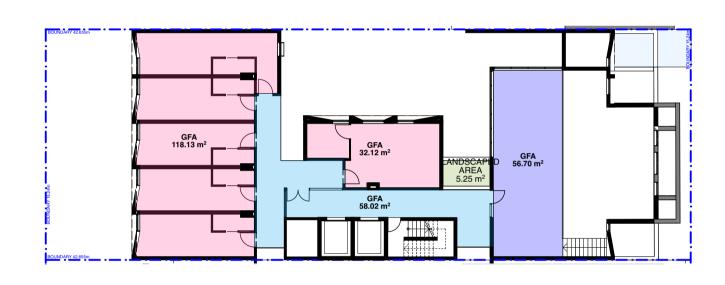


Level 2 GFA 1:250

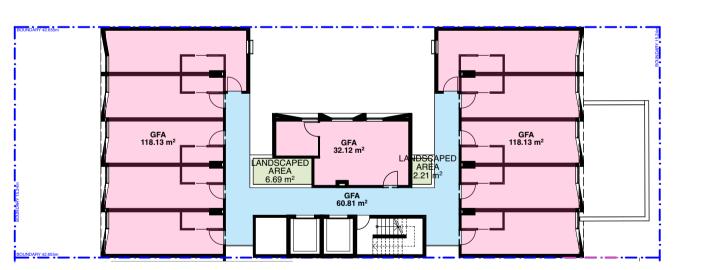


Level 3 GFA 1:250

RESIDENTIAL GFA




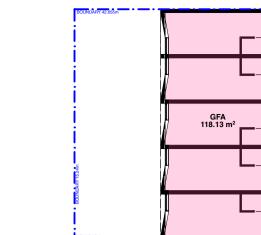


Level 4 GFA

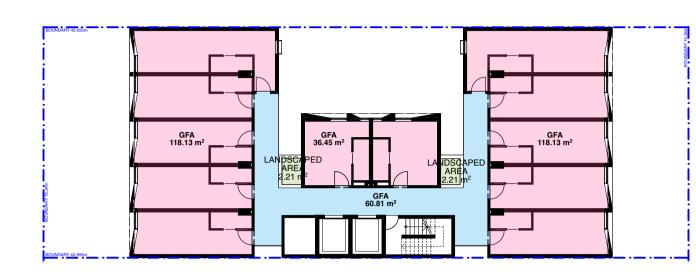


Level 5 GFA

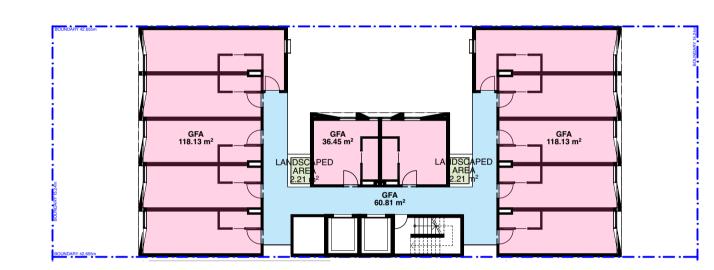

Level 6 GFA 1:250

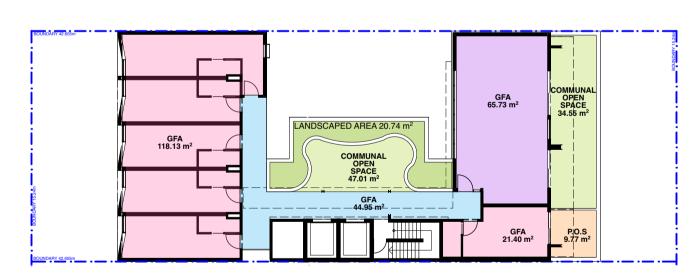

Level 7 GFA 1:250

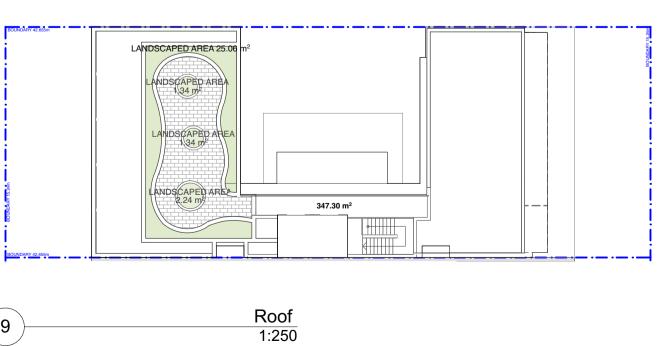

| 9 | Ro  |
|---|-----|
| 3 | 1:2 |
|   |     |


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|                                      |          |          | 5                             |             |
|--------------------------------------|----------|----------|-------------------------------|-------------|
| PROJECT Mixed Use Boarding House Dev | elonment | PROJECT# | 19049                         | SCALE @ A1  |
| ADDRESS                              | еюритент | DRAWN    | AT/JG                         | CHECKED     |
| 691 Pittwater Road Dee Why NS        | SW       | DATE     | 27/11/20                      | DRAWING No. |
| CLIENT Gannet Developments           |          | NORTH    | $\sim$                        | DA (        |
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| Calculations                         |          |          |                               | DEV/        |









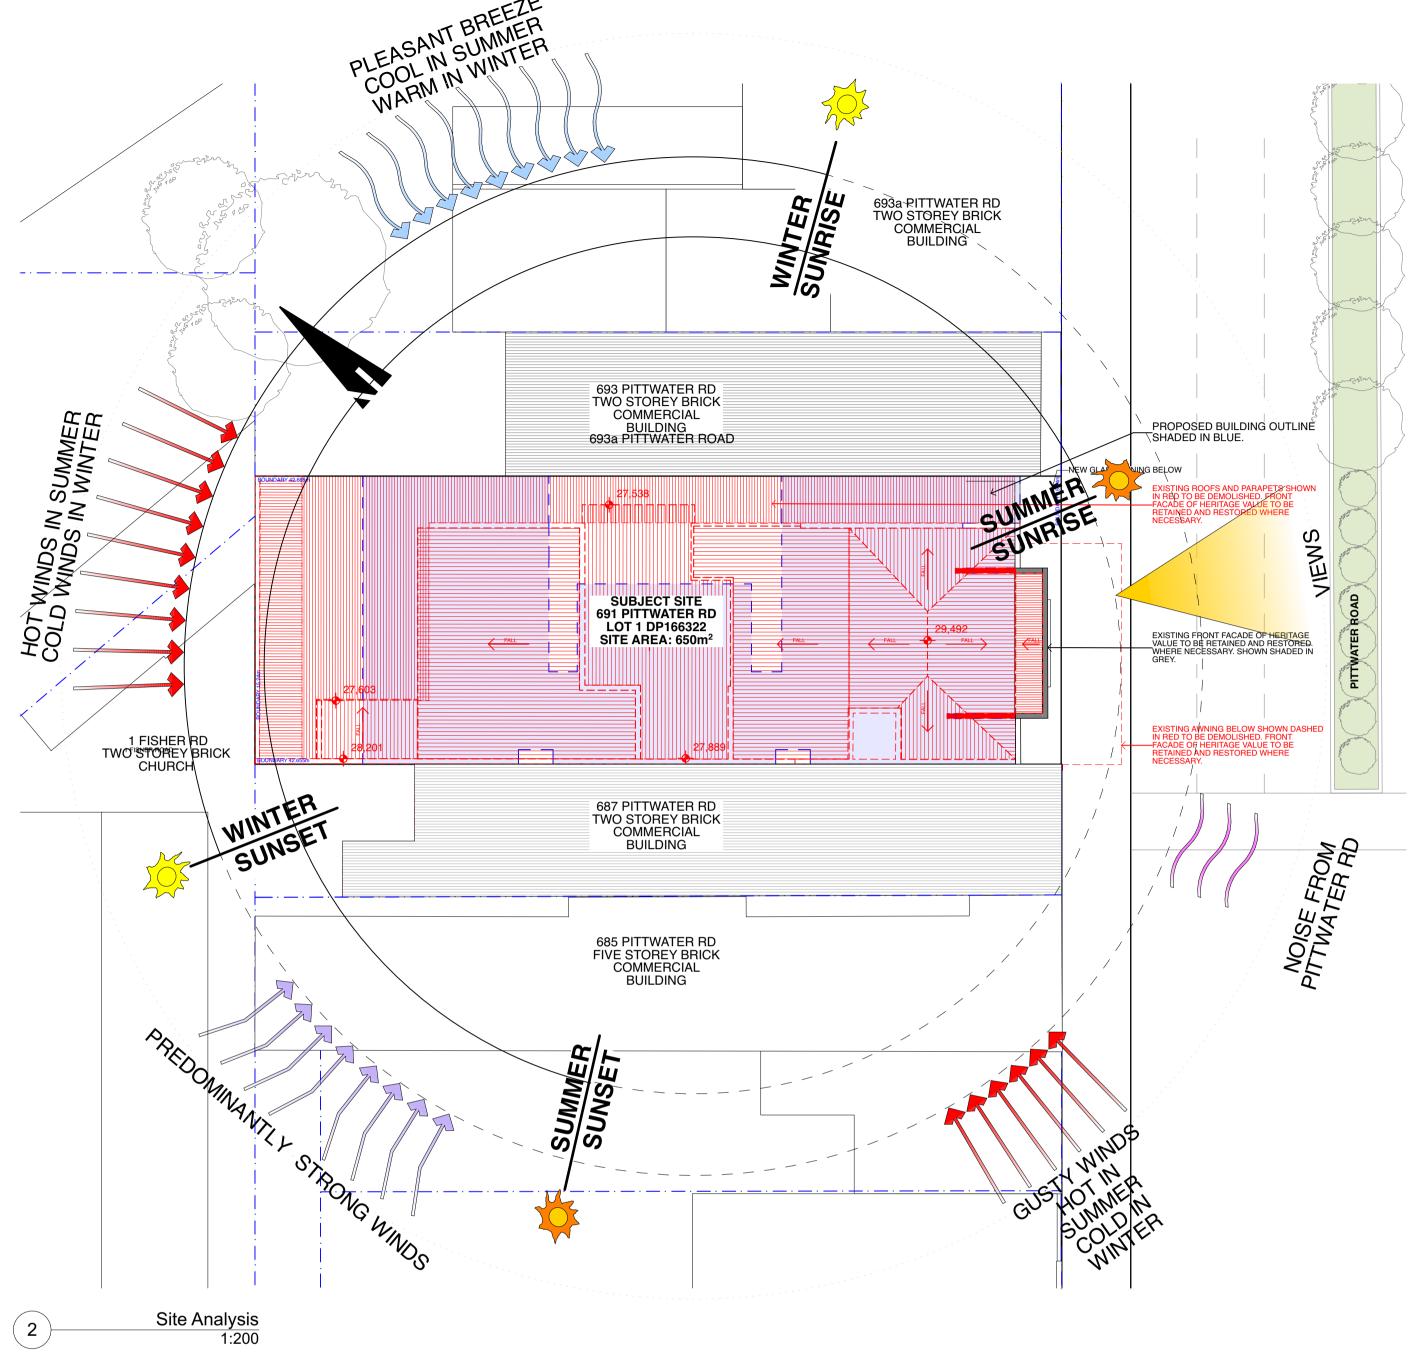

FOR DA PURPOSES

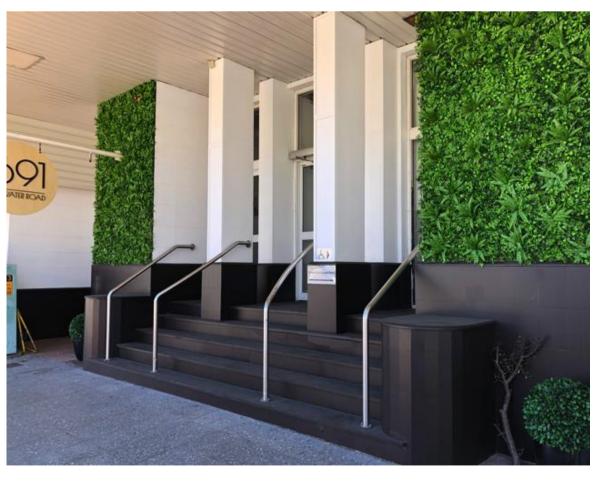

Entrance to site. Original red granite plinth painted in black to be restored.

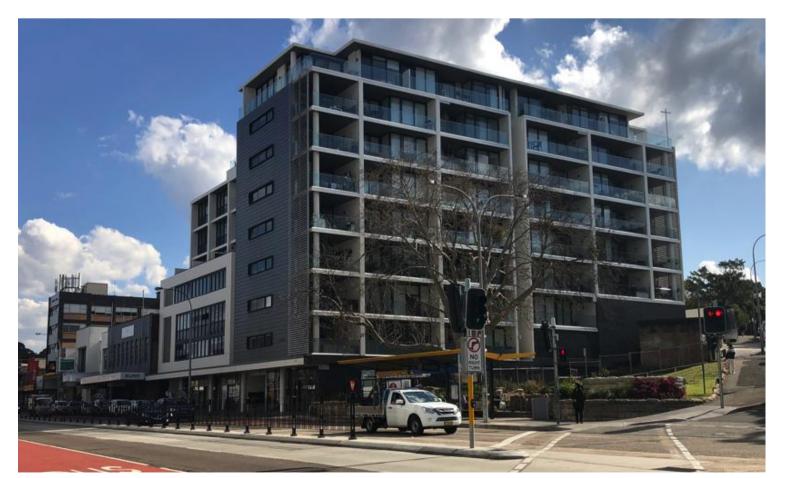

View of subject site and neighbouring properties from Pittwater Rd intersection at Howard Avenue. Newly constructed apartment building at 701 Pittwater Road.



View from subject site to other side of Pittwater Rd. Nearby traffic lights and intersection as well as a 7 storey apartment block and commercial buildings.

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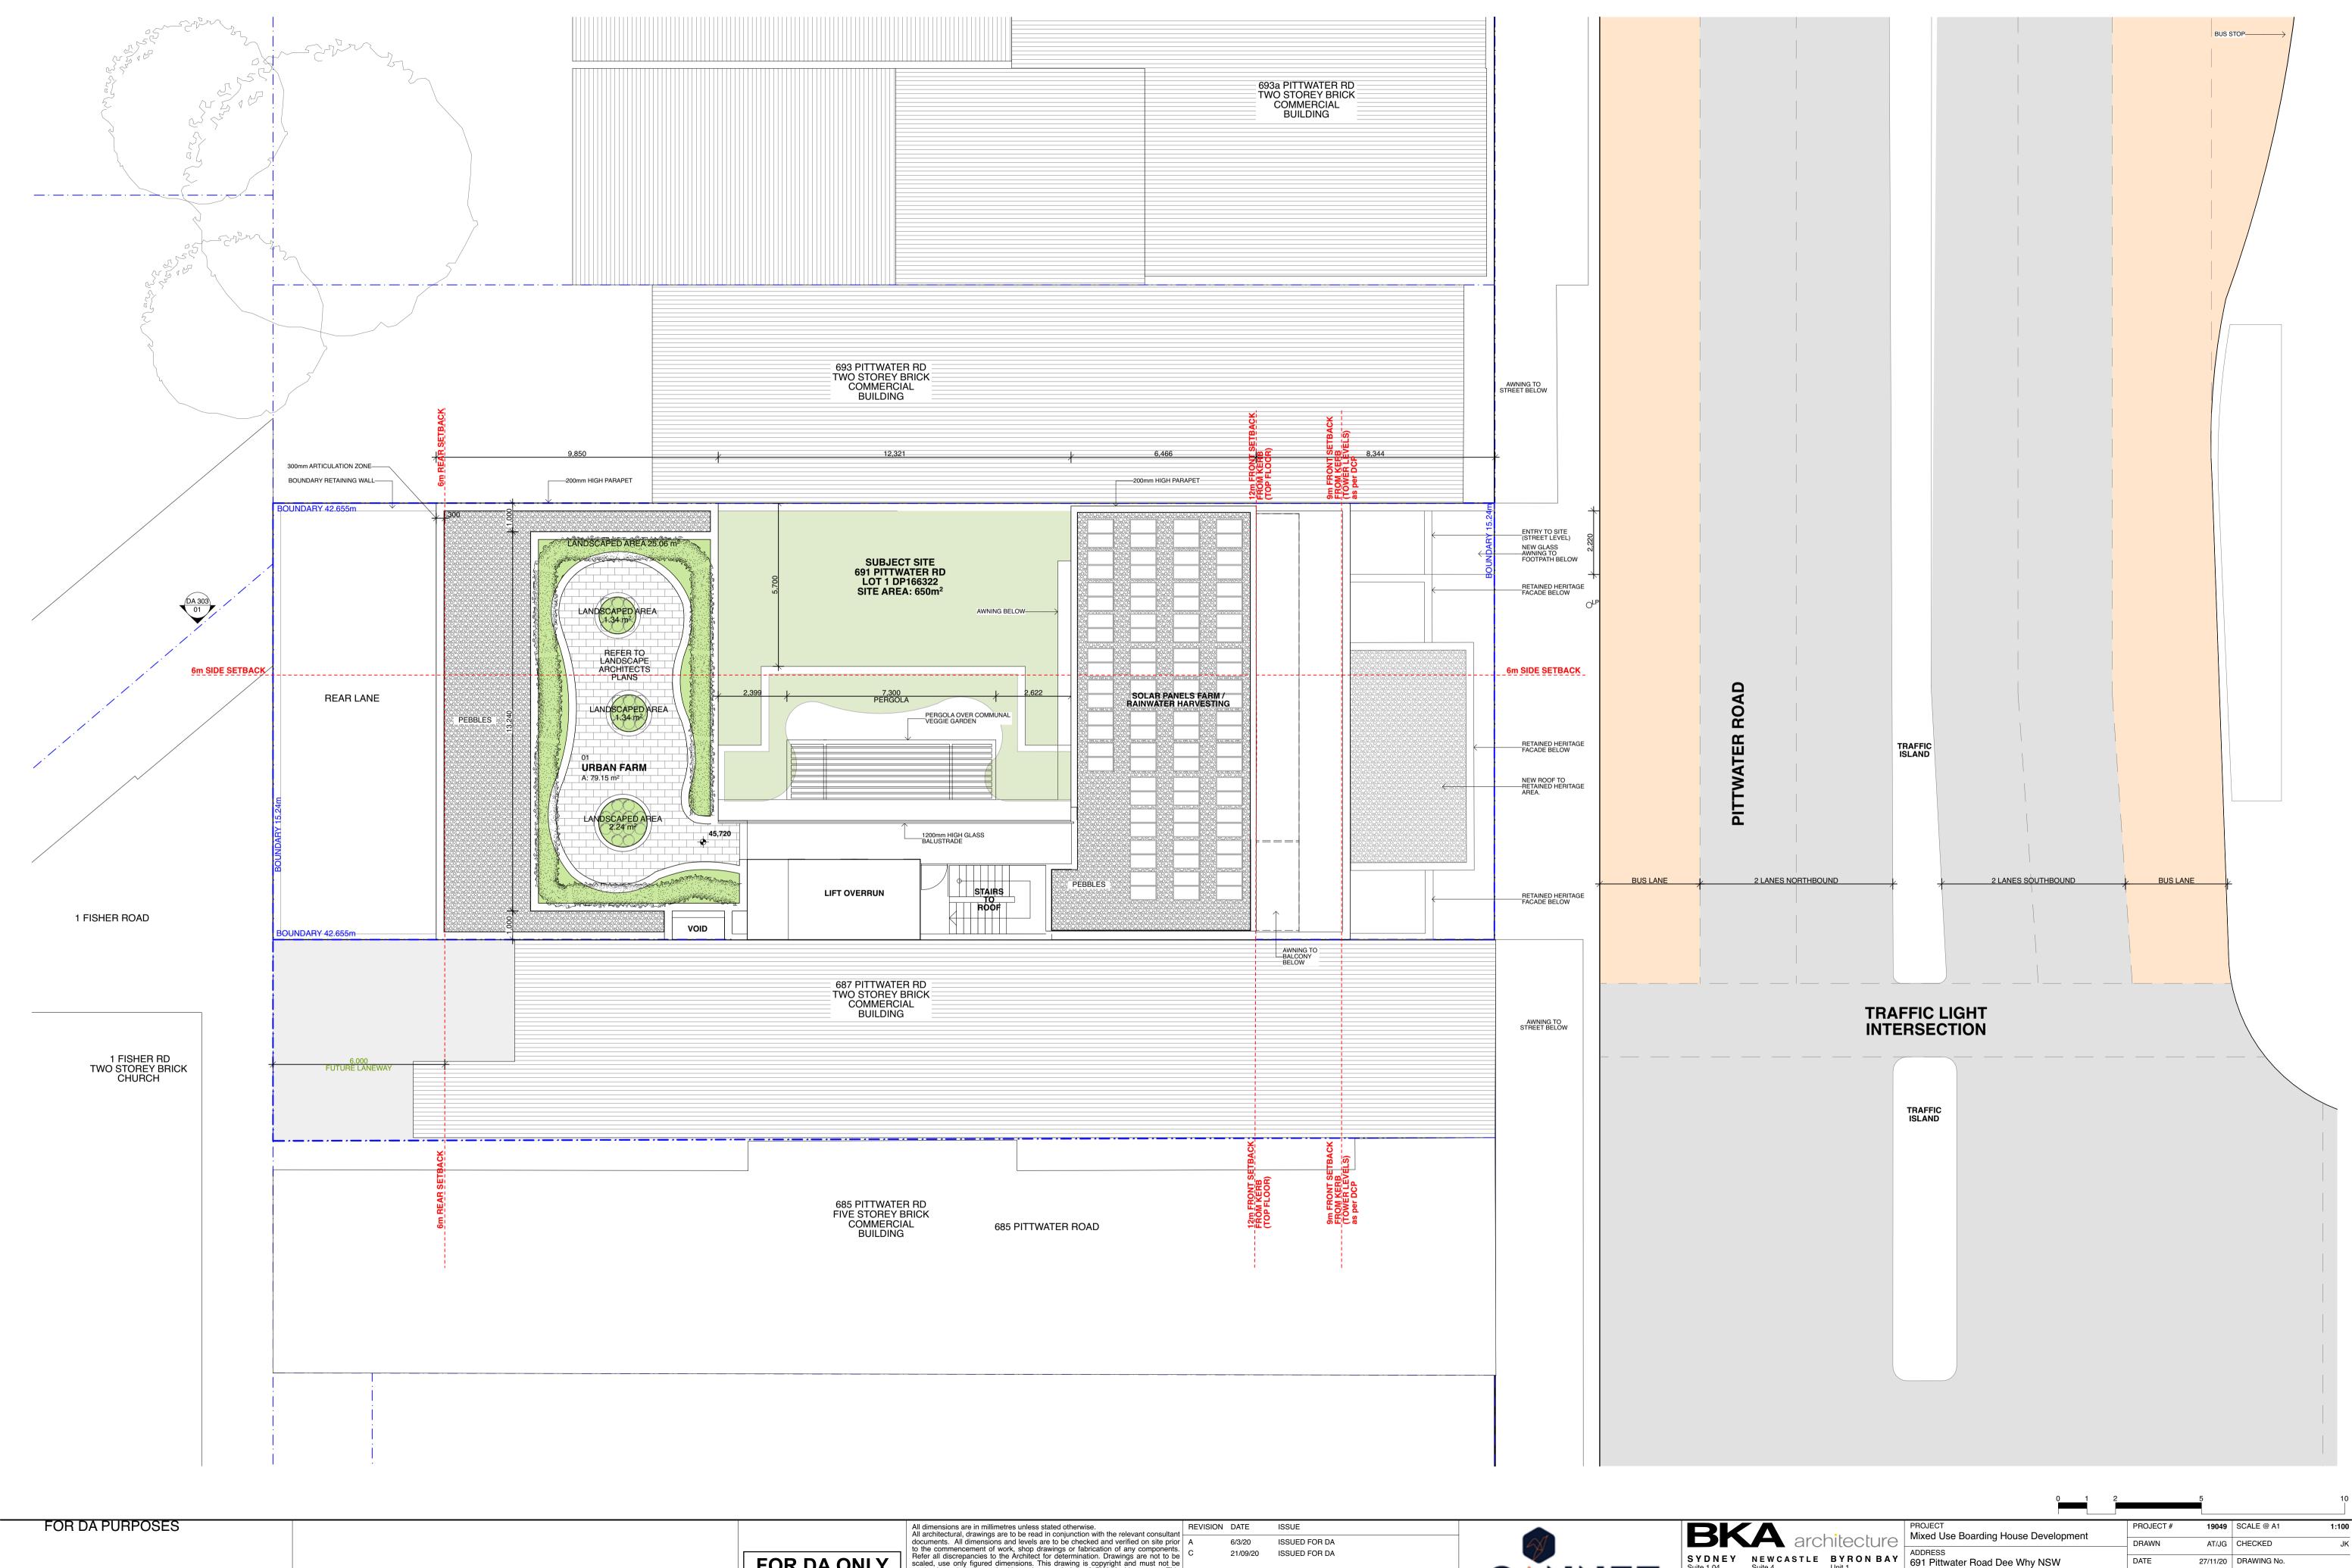
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|   |  |          | 5                 |             |
|---|--|----------|-------------------|-------------|
|   | PROJECT Mixed Use Boarding House Development | PROJECT# | 19049             | SCALE @ A1  |
| ) | ADDRESS                                      | DRAWN    | AT/JG             | CHECKED     |
| Y | 691 Pittwater Road Dee Why NSW               | DATE     | 27/11/20          | DRAWING No. |
|   | CLIENT Gannet Developments                   | NORTH    | $\langle \rangle$ | <b>DA 0</b> |
|   | DRAWING<br>Site Analysis                     | -        |                   | REV         |

ISSUED FOR DA 6/3/20 21/09/20 ISSUED FOR DA




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77 Dunning Ave, 19 Bolton St, 10 Station St, Rosebery NSW 2018

NEWCASTLE BYRON BAY
Unit 1
10 Station St, Bangalow
NSW 2479 FOR DA ONLY NOT FOR CONSTRUCTION CLIENT NORTH Gannet Developments **T**: +61 2 4926 5563 T: +61 2 9318 9200 T: +61 2 4926 5563 E: bka@bka.com.au DRAWING Site Plan



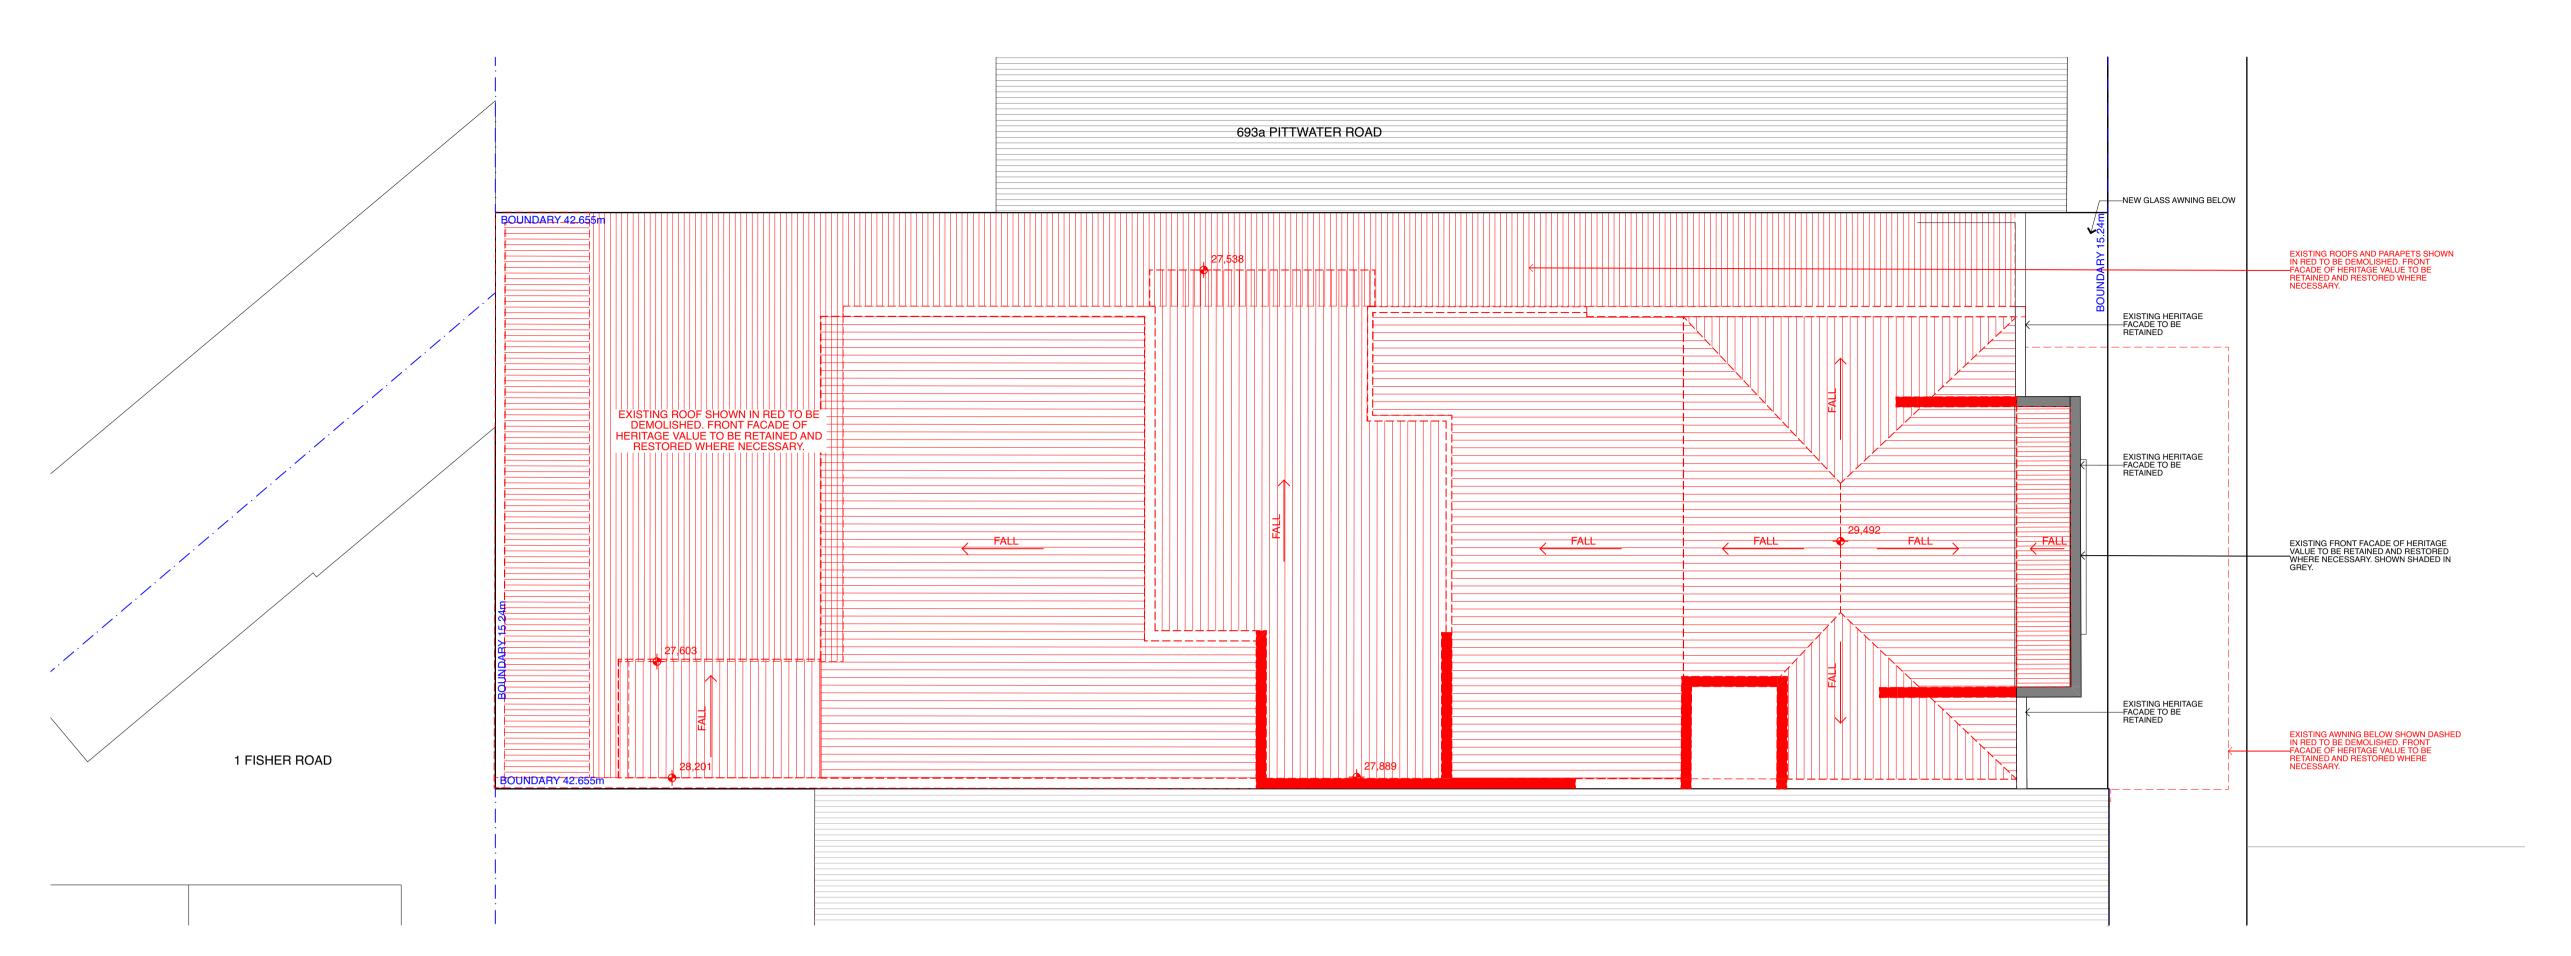

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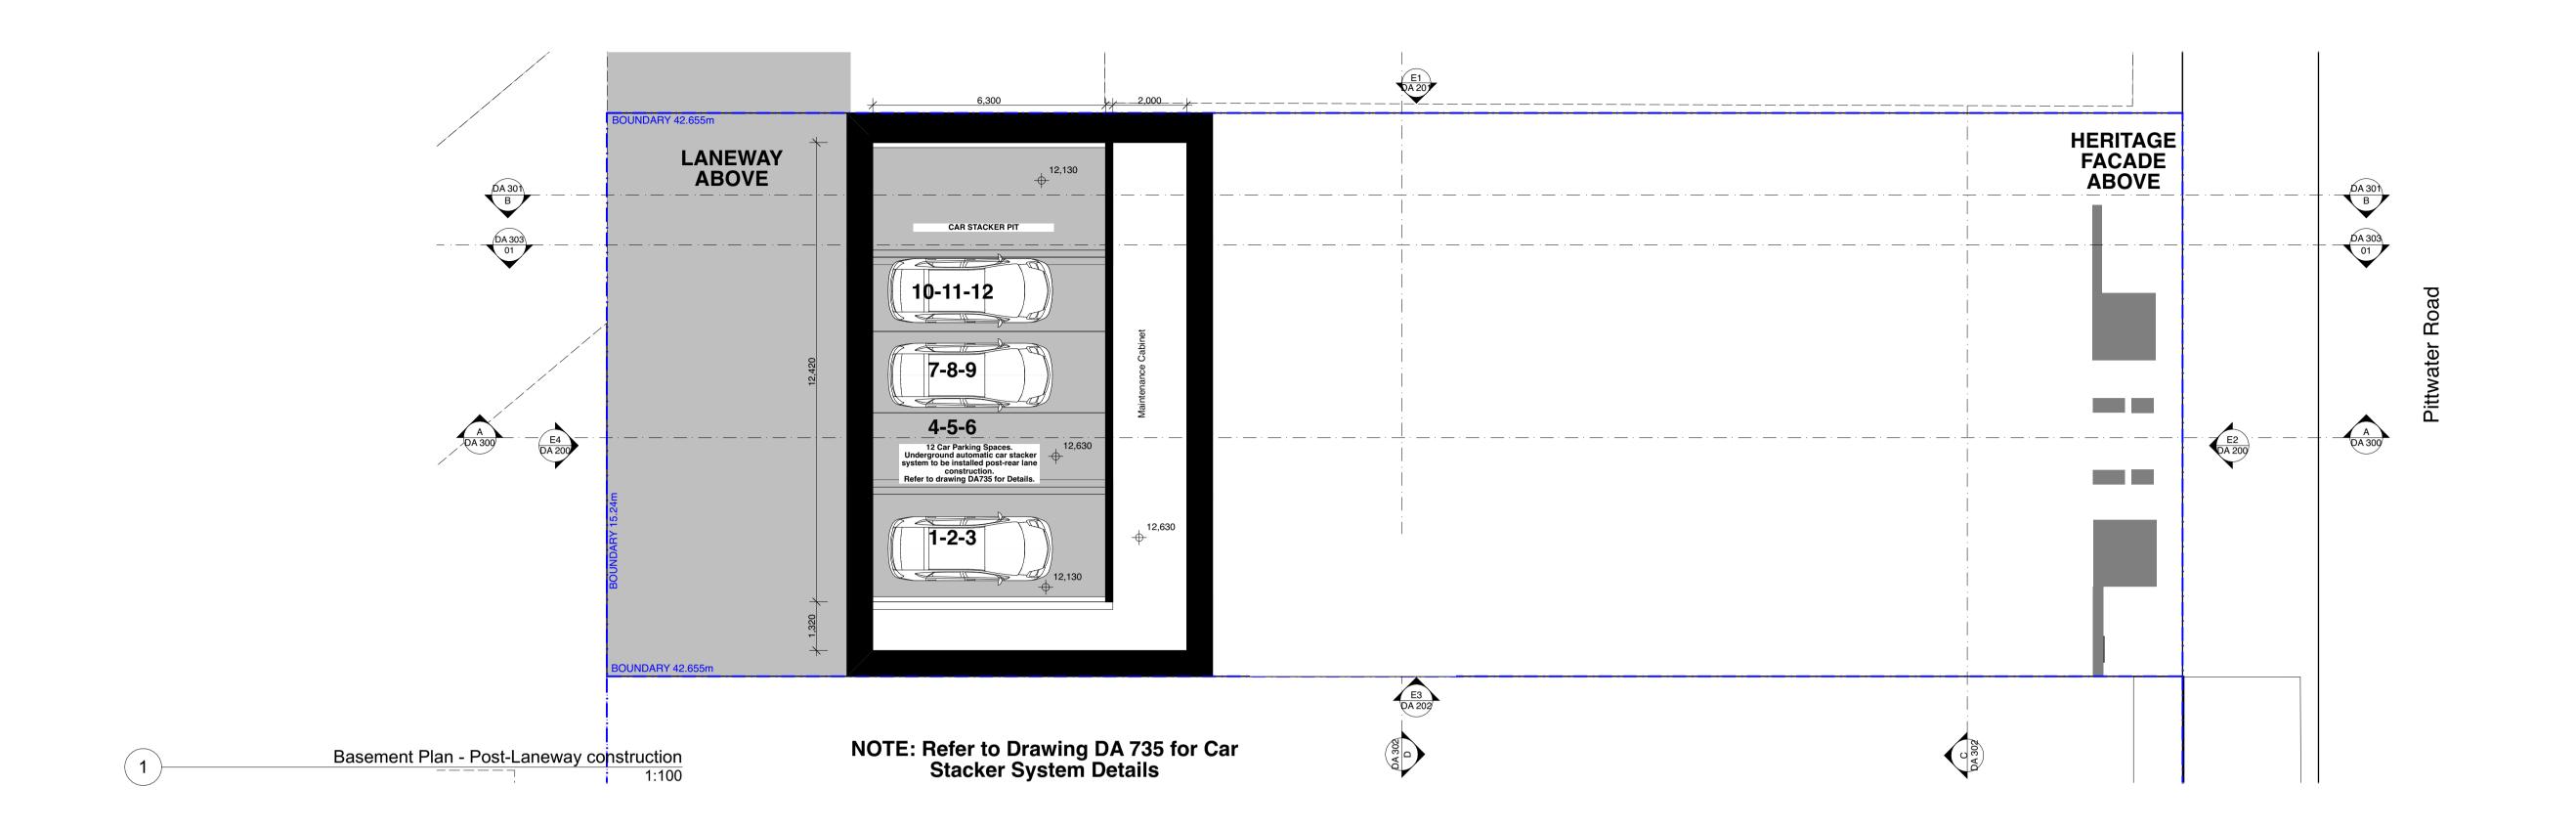
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| PROJECT Mixed Use Boarding House Development | PROJECT# | 19049    | SCALE @ A1    | 1:100 |
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| ADDRESS<br>691 Pittwater Road Dee Why NSW    | DATE     | 27/11/20 | DRAWING No.   |       |
| CLIENT Gannet Developments                   | NORTH    |          | <b>DA 011</b> |       |
| DRAWING<br>Demolition Plan - Roof            |          |          | REV           | (     |




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Unit 1
10 Station St, Bangalow
NSW 2479 DATE 27/11/20 DRAWING No. GANNET NORTH Gannet Developments T: +61 2 9318 9200 T: +61 2 4926 5563 T: +61 2 4926 5563 E: bka@bka.com.au W: www.bka.com.au DRAWING Basement Plan








Level 3 Floor Plan 1:100 All dimensions are in millimetres unless stated otherwise.
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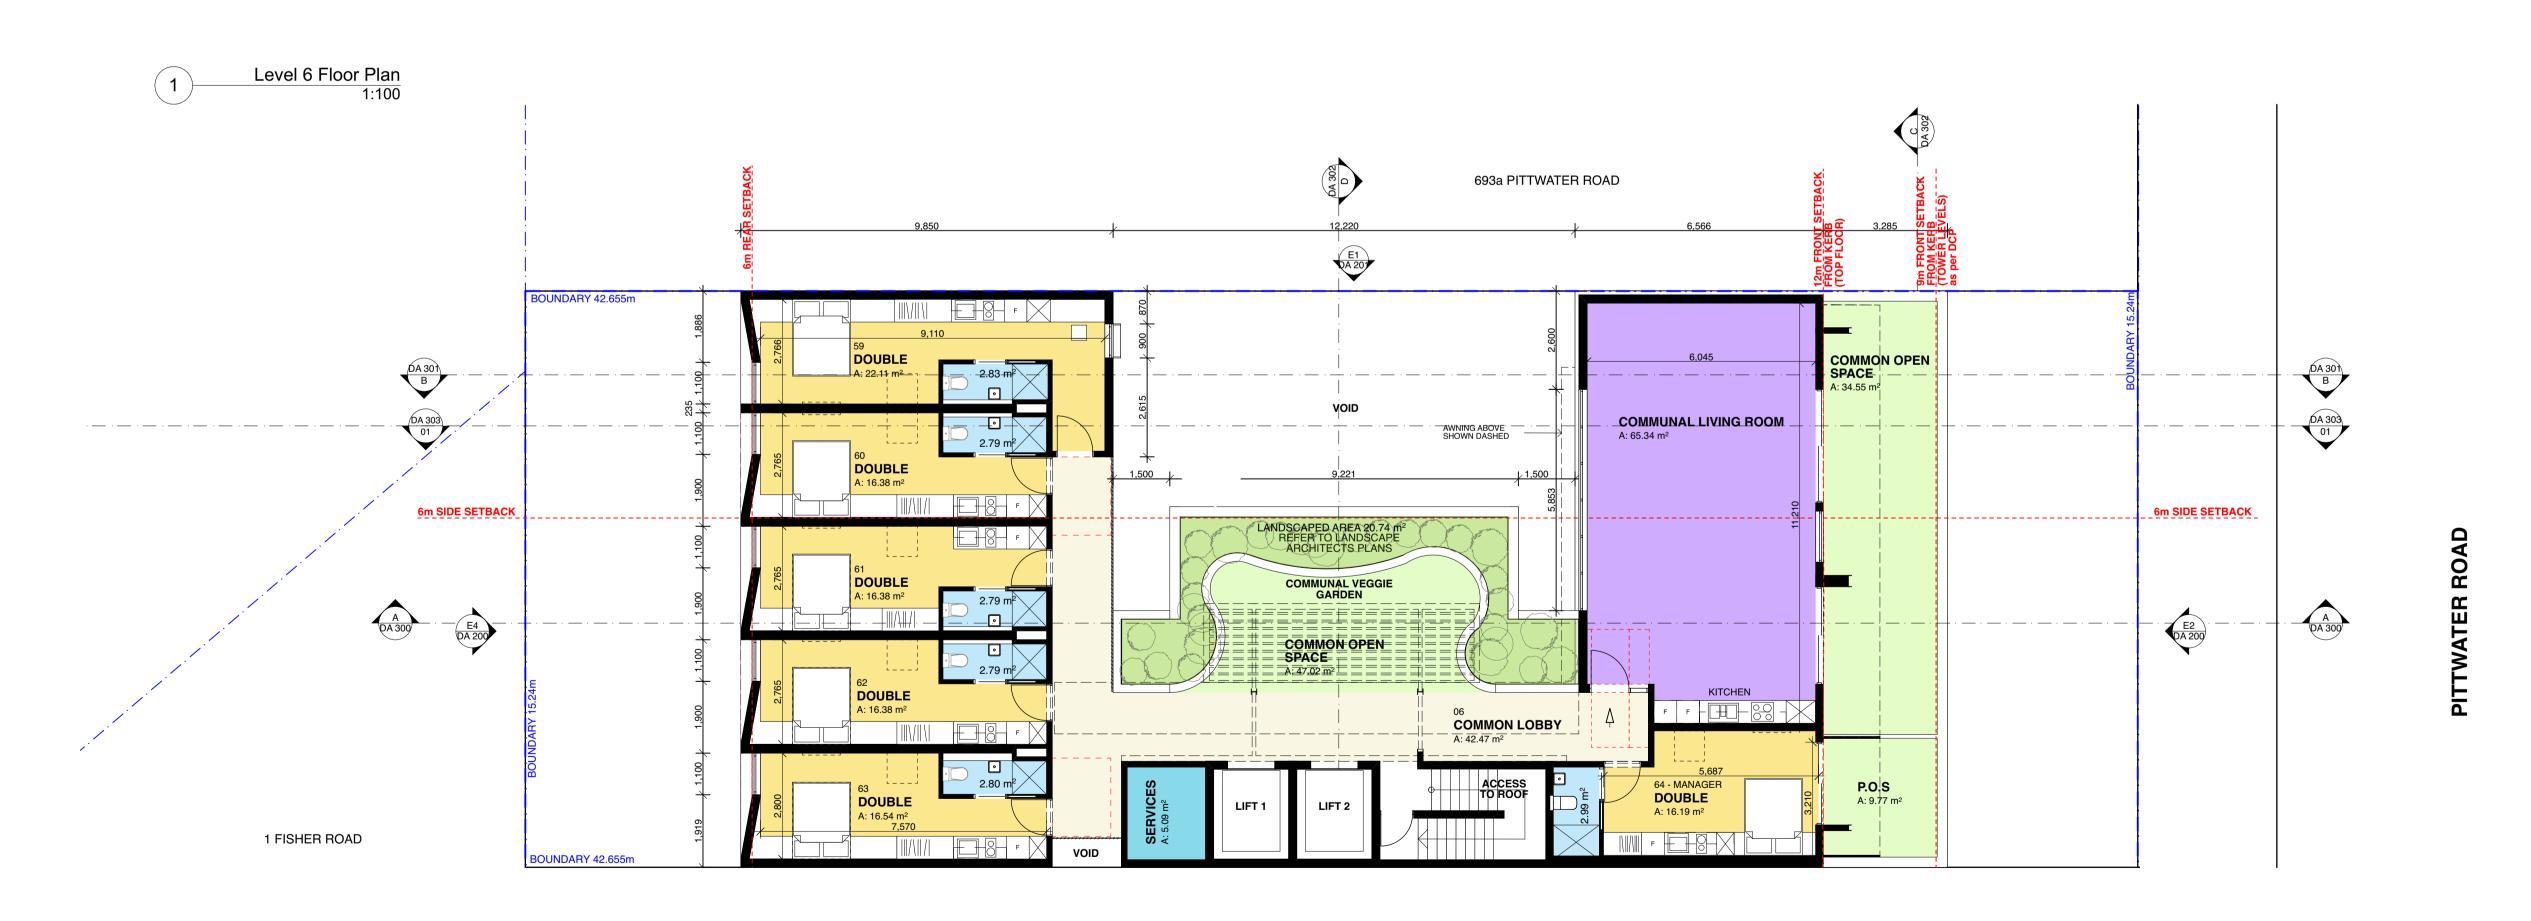
SYDNEY NEWCASTLE BYRON BAY
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Bangalow
NSW 2479 **FOR DA ONLY** DATE 27/11/20 DRAWING No. **GANNET** NORTH NOT FOR CONSTRUCTION Gannet Developments T: +61 2 9318 9200 T: +61 2 4926 5563 E: bka@bka.com.au T: +61 2 4926 5563 DRAWING L2 & L3 Floor Plan

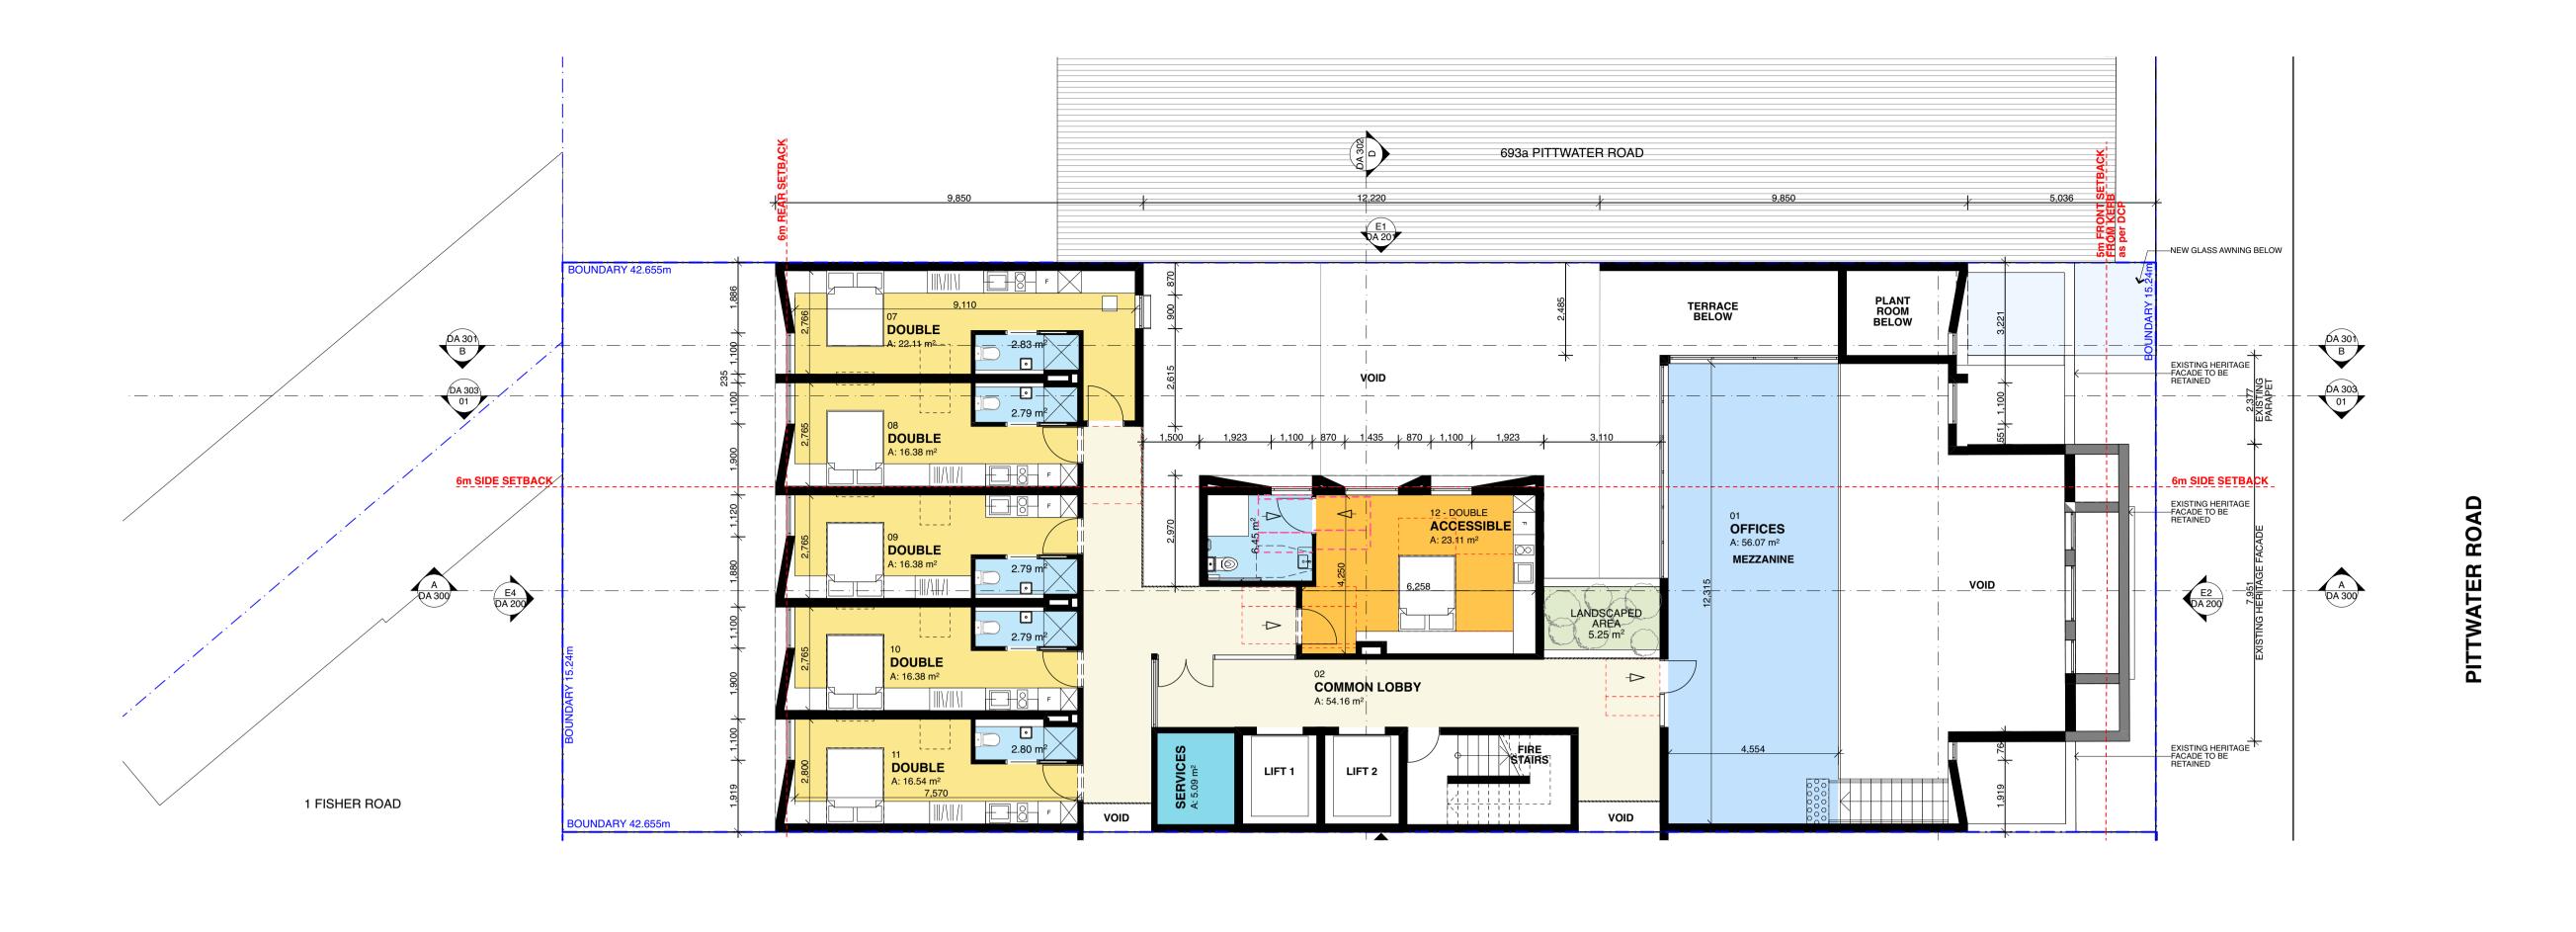









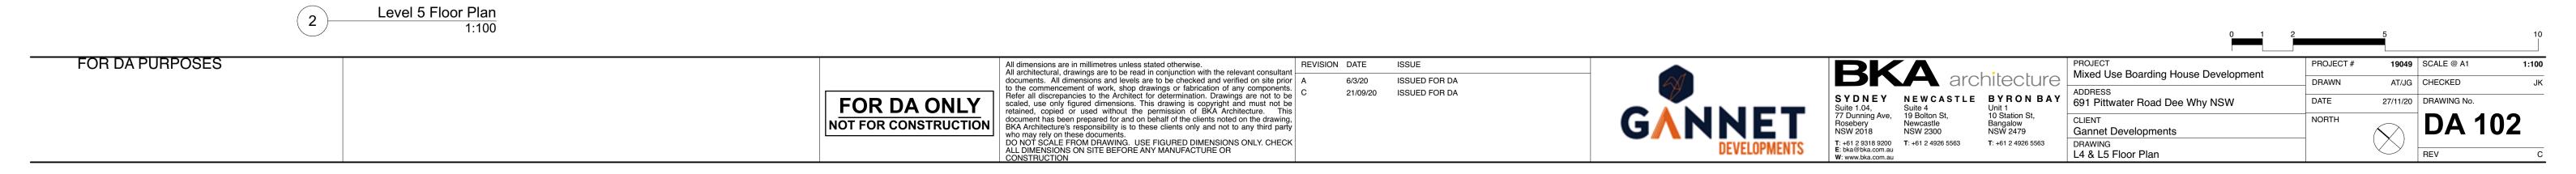

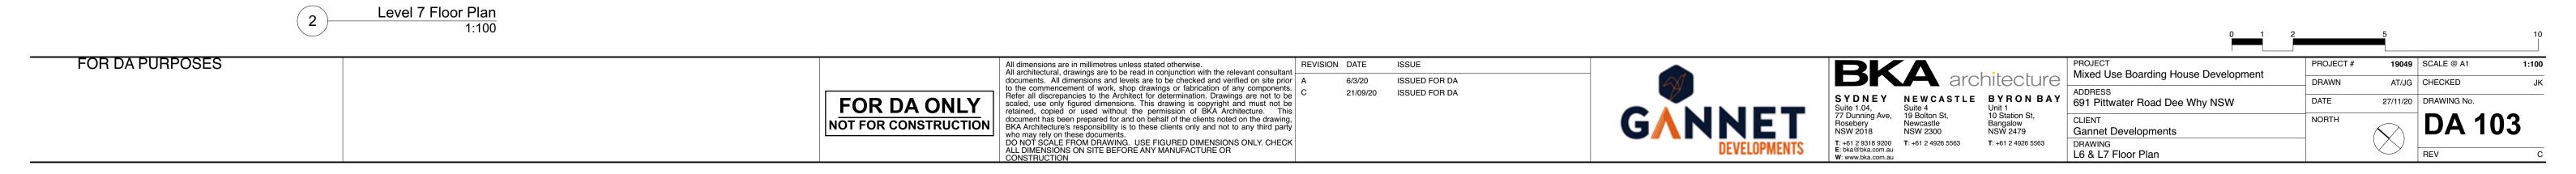

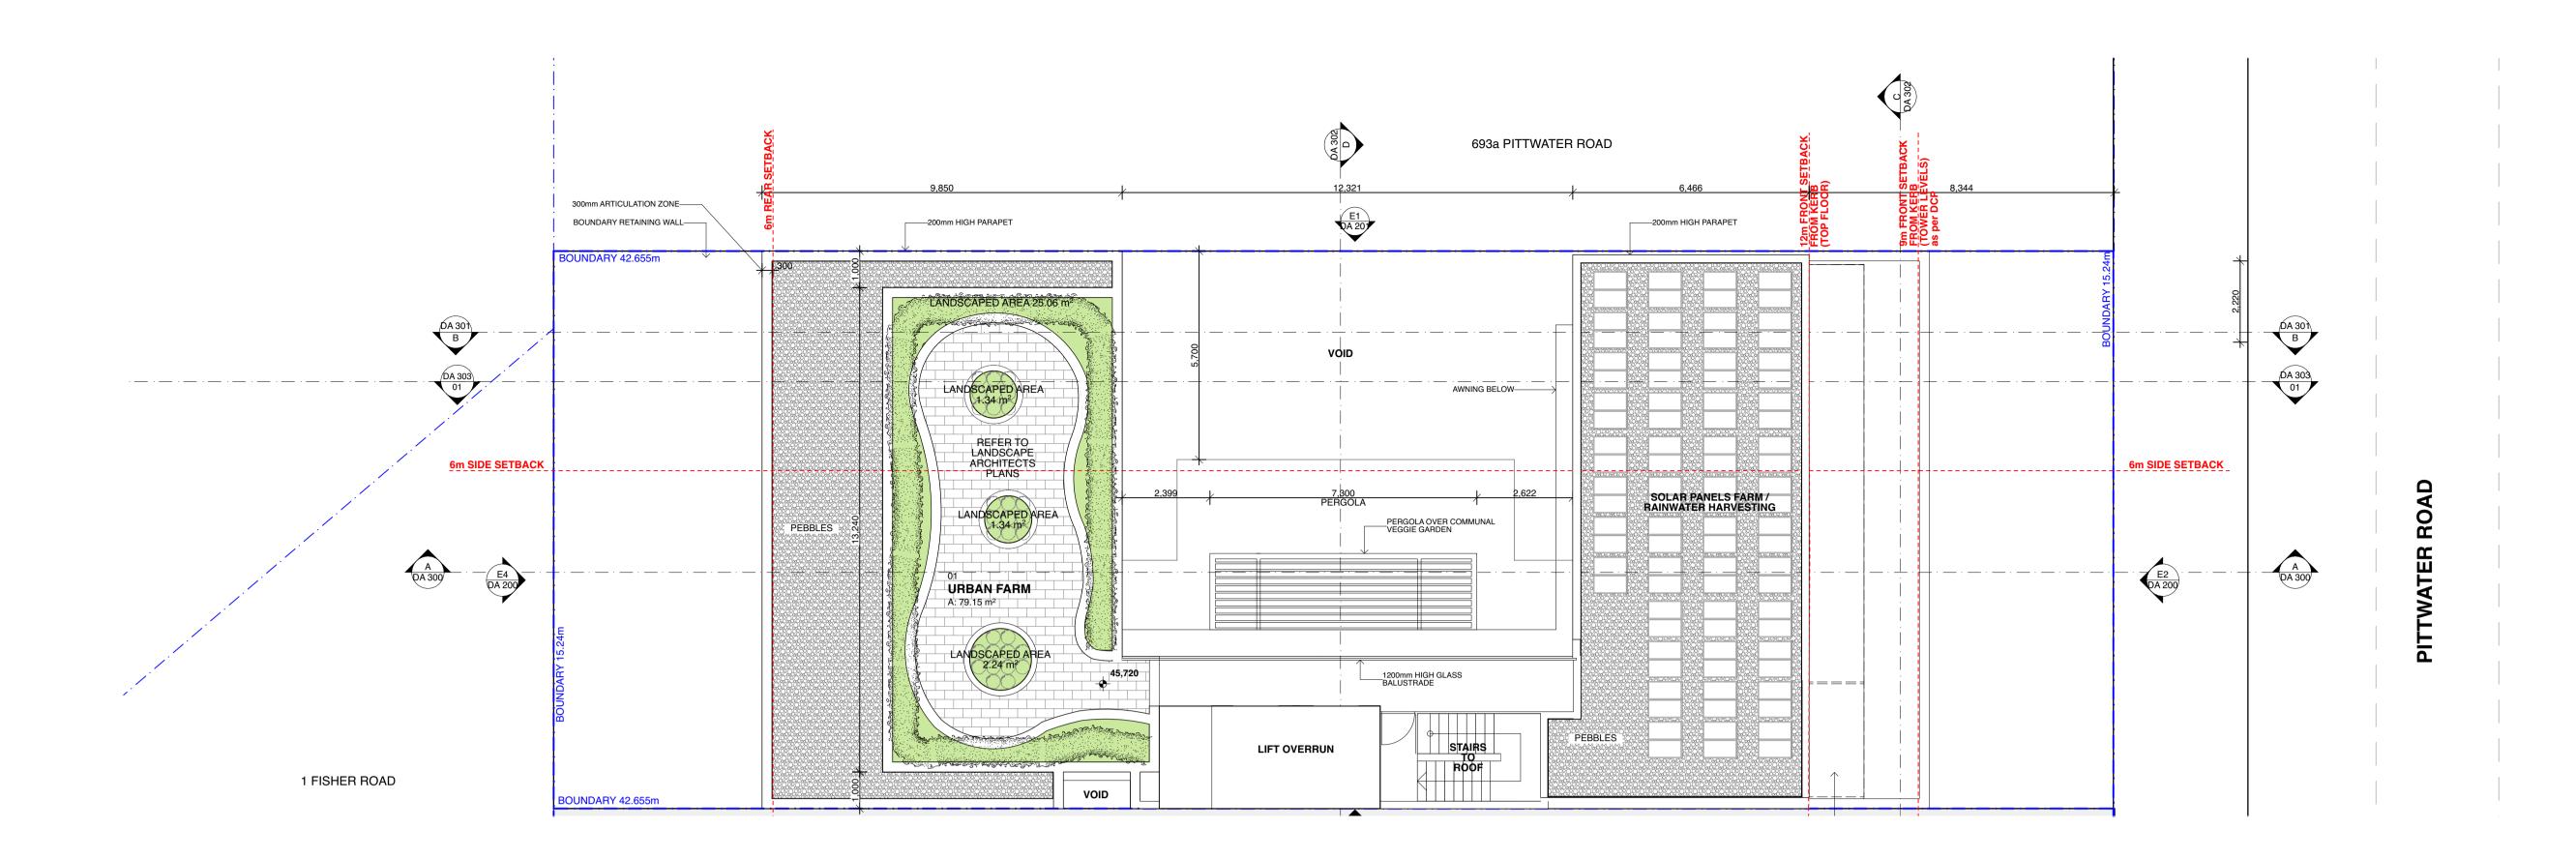

1 Rooftop Floor Plan 1:100

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NSW 2479 DATE 27/11/20 DRAWING No. GANNET NORTH Gannet Developments T: +61 2 9318 9200 T: +61 2 4926 5563 T: +61 2 4926 5563 E: bka@bka.com.au W: www.bka.com.au DRAWING Rooftop Floor Plan





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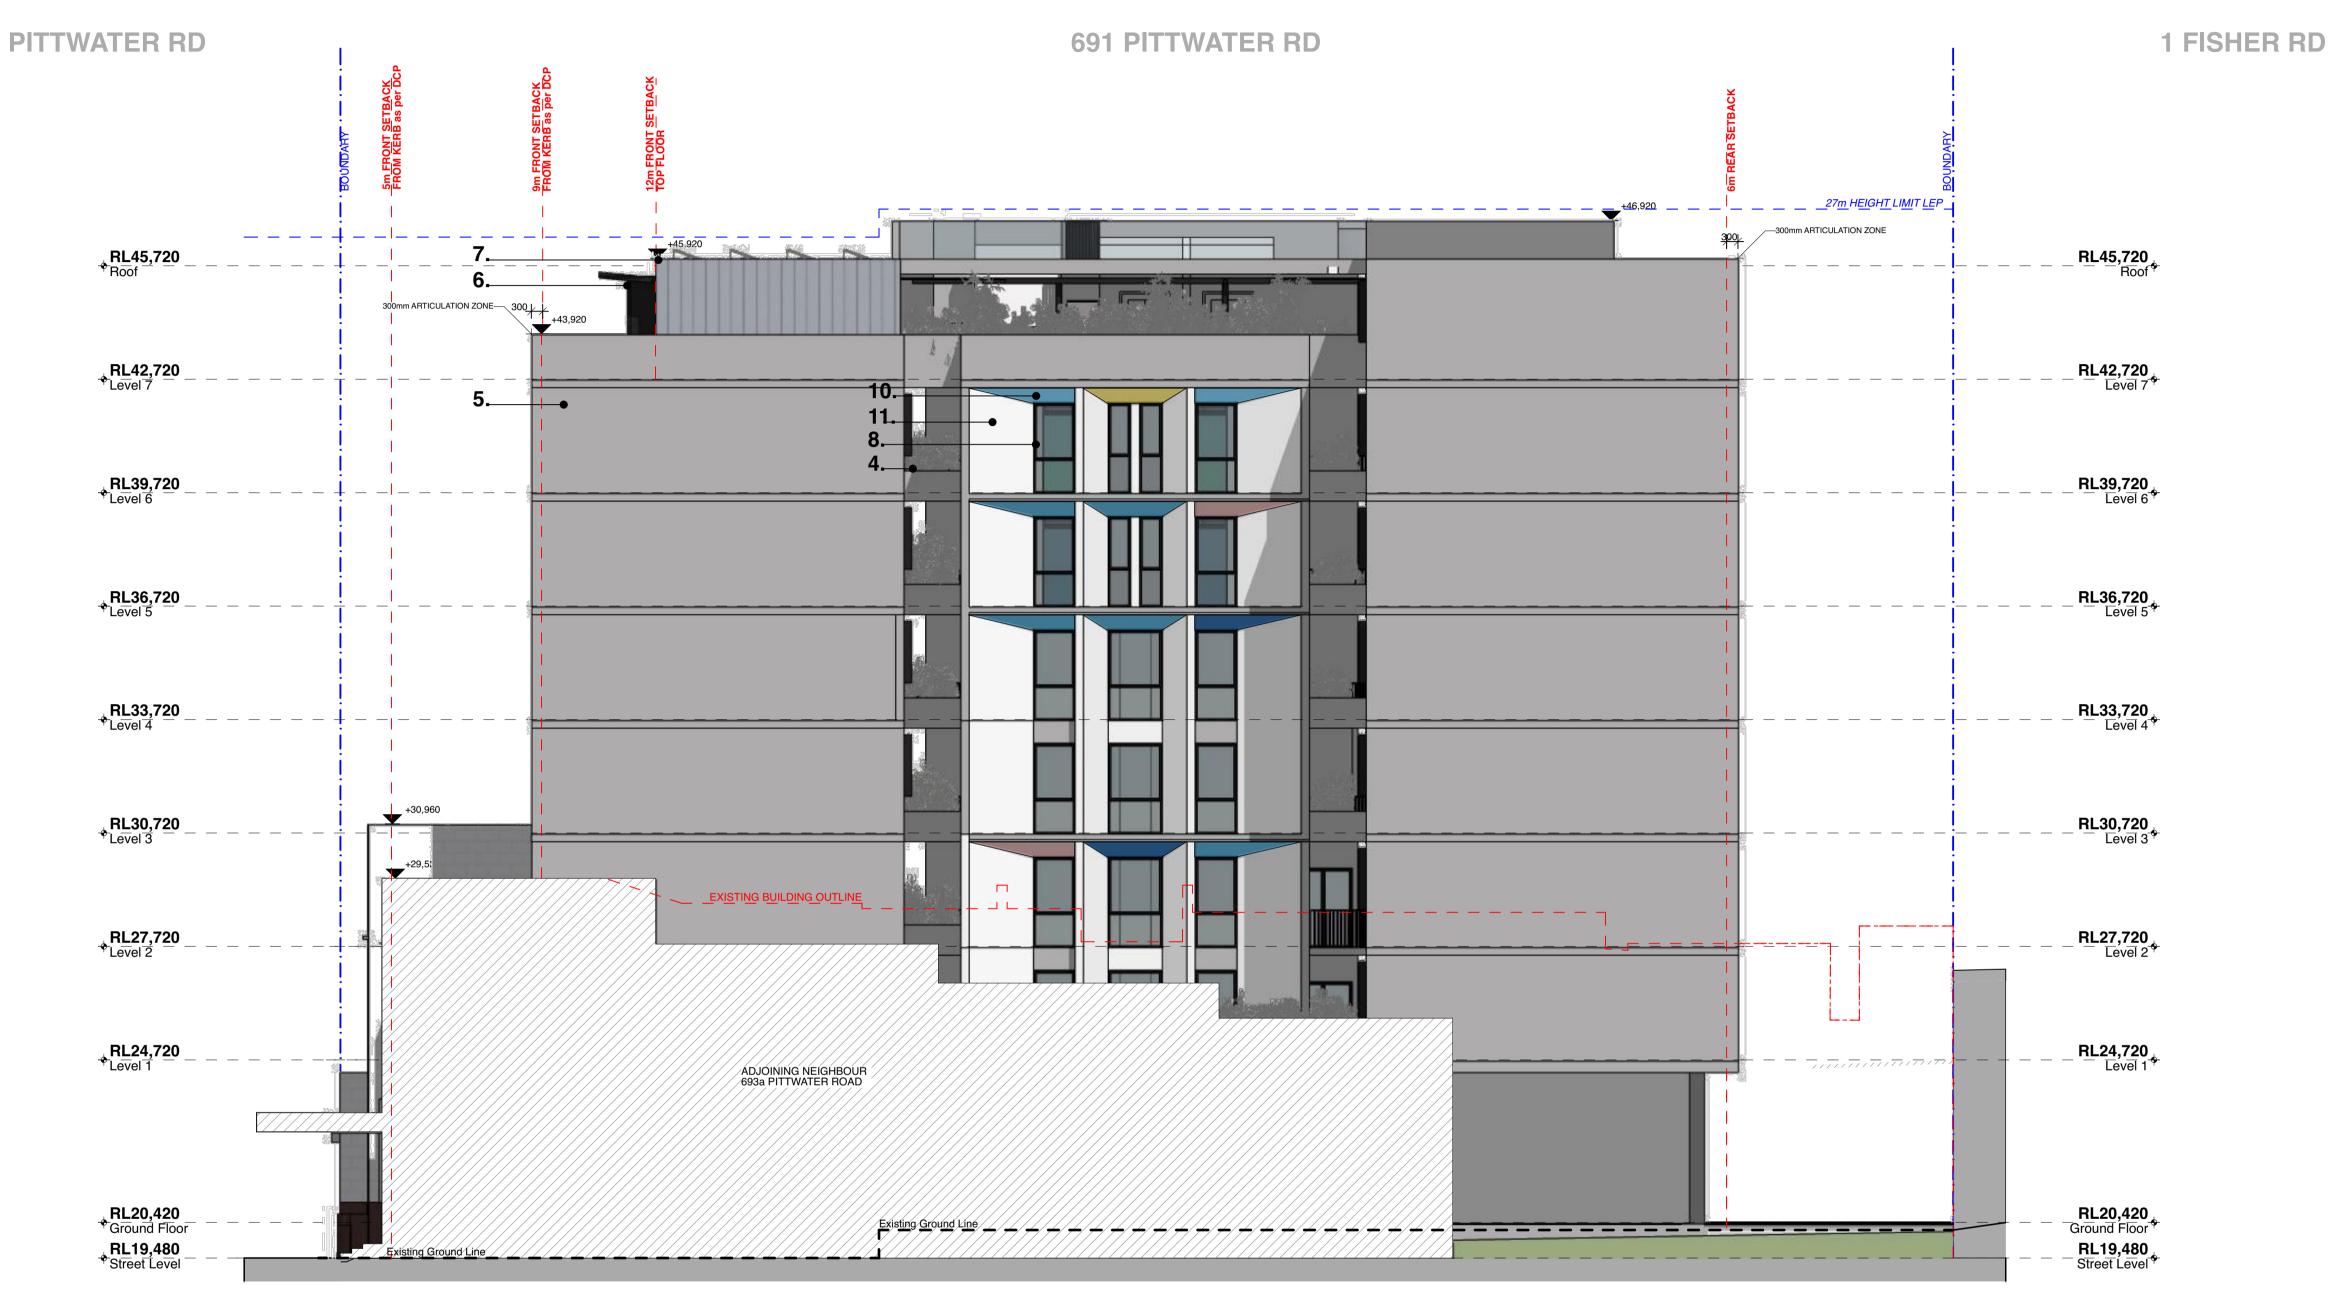
CONSTRUCTION FOR DA PURPOSES ISSUE PROJECT# **19049** | SCALE @ A1 Mixed Use Boarding House Development 6/3/20 ISSUED FOR DA AT/JG CHECKED ADDRESS 691 Pittwater Road Dee Why NSW ISSUED FOR DA 21/09/20 
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 **FOR DA ONLY** DATE 27/11/20 DRAWING No. AMENDED ISSUE FOR DRP 02/11/20 AMENDED ISSUE FOR DRP **DA 200** 03/11/20 NOT FOR CONSTRUCTION AMENDED ISSUE FOR DRP 18/11/20 Gannet Developments AMENDED ISSUE FOR DRP 24/11/20 T: +61 2 9318 9200 T: +61 2 4926 5563 E: bka@bka.com.au T: +61 2 4926 5563 Elevations



Northeast Elevation

#### **Schedule of External Finishes**



1. Existing Concrete Block Wall Colour: White

FOR DA PURPOSES



2. Existing Granite Cladding Awning Colour: Red Colour: Clear





4. Metal Balustrade 5. Precast Colour: Black Concrete P **Concrete Panels** 



**6. EasyLap Panel Cladding** Colour: Dark grey




7. Steel Window **Shades** Colour: Monument or similar



8. Aluminium Window and Door Frames Colour: Black
 9. Timber Looking Lift Lobby a. Dulux Satorini (S33H3) b. Dulux Copacabana (S33H7) c. Dulux Rosetta (S07D5) d. Dulux Buzz (S15H7)



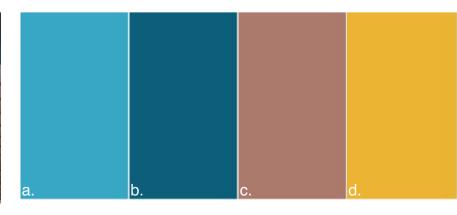



**11. FC Cladding** Colour: Mid grey

Granite

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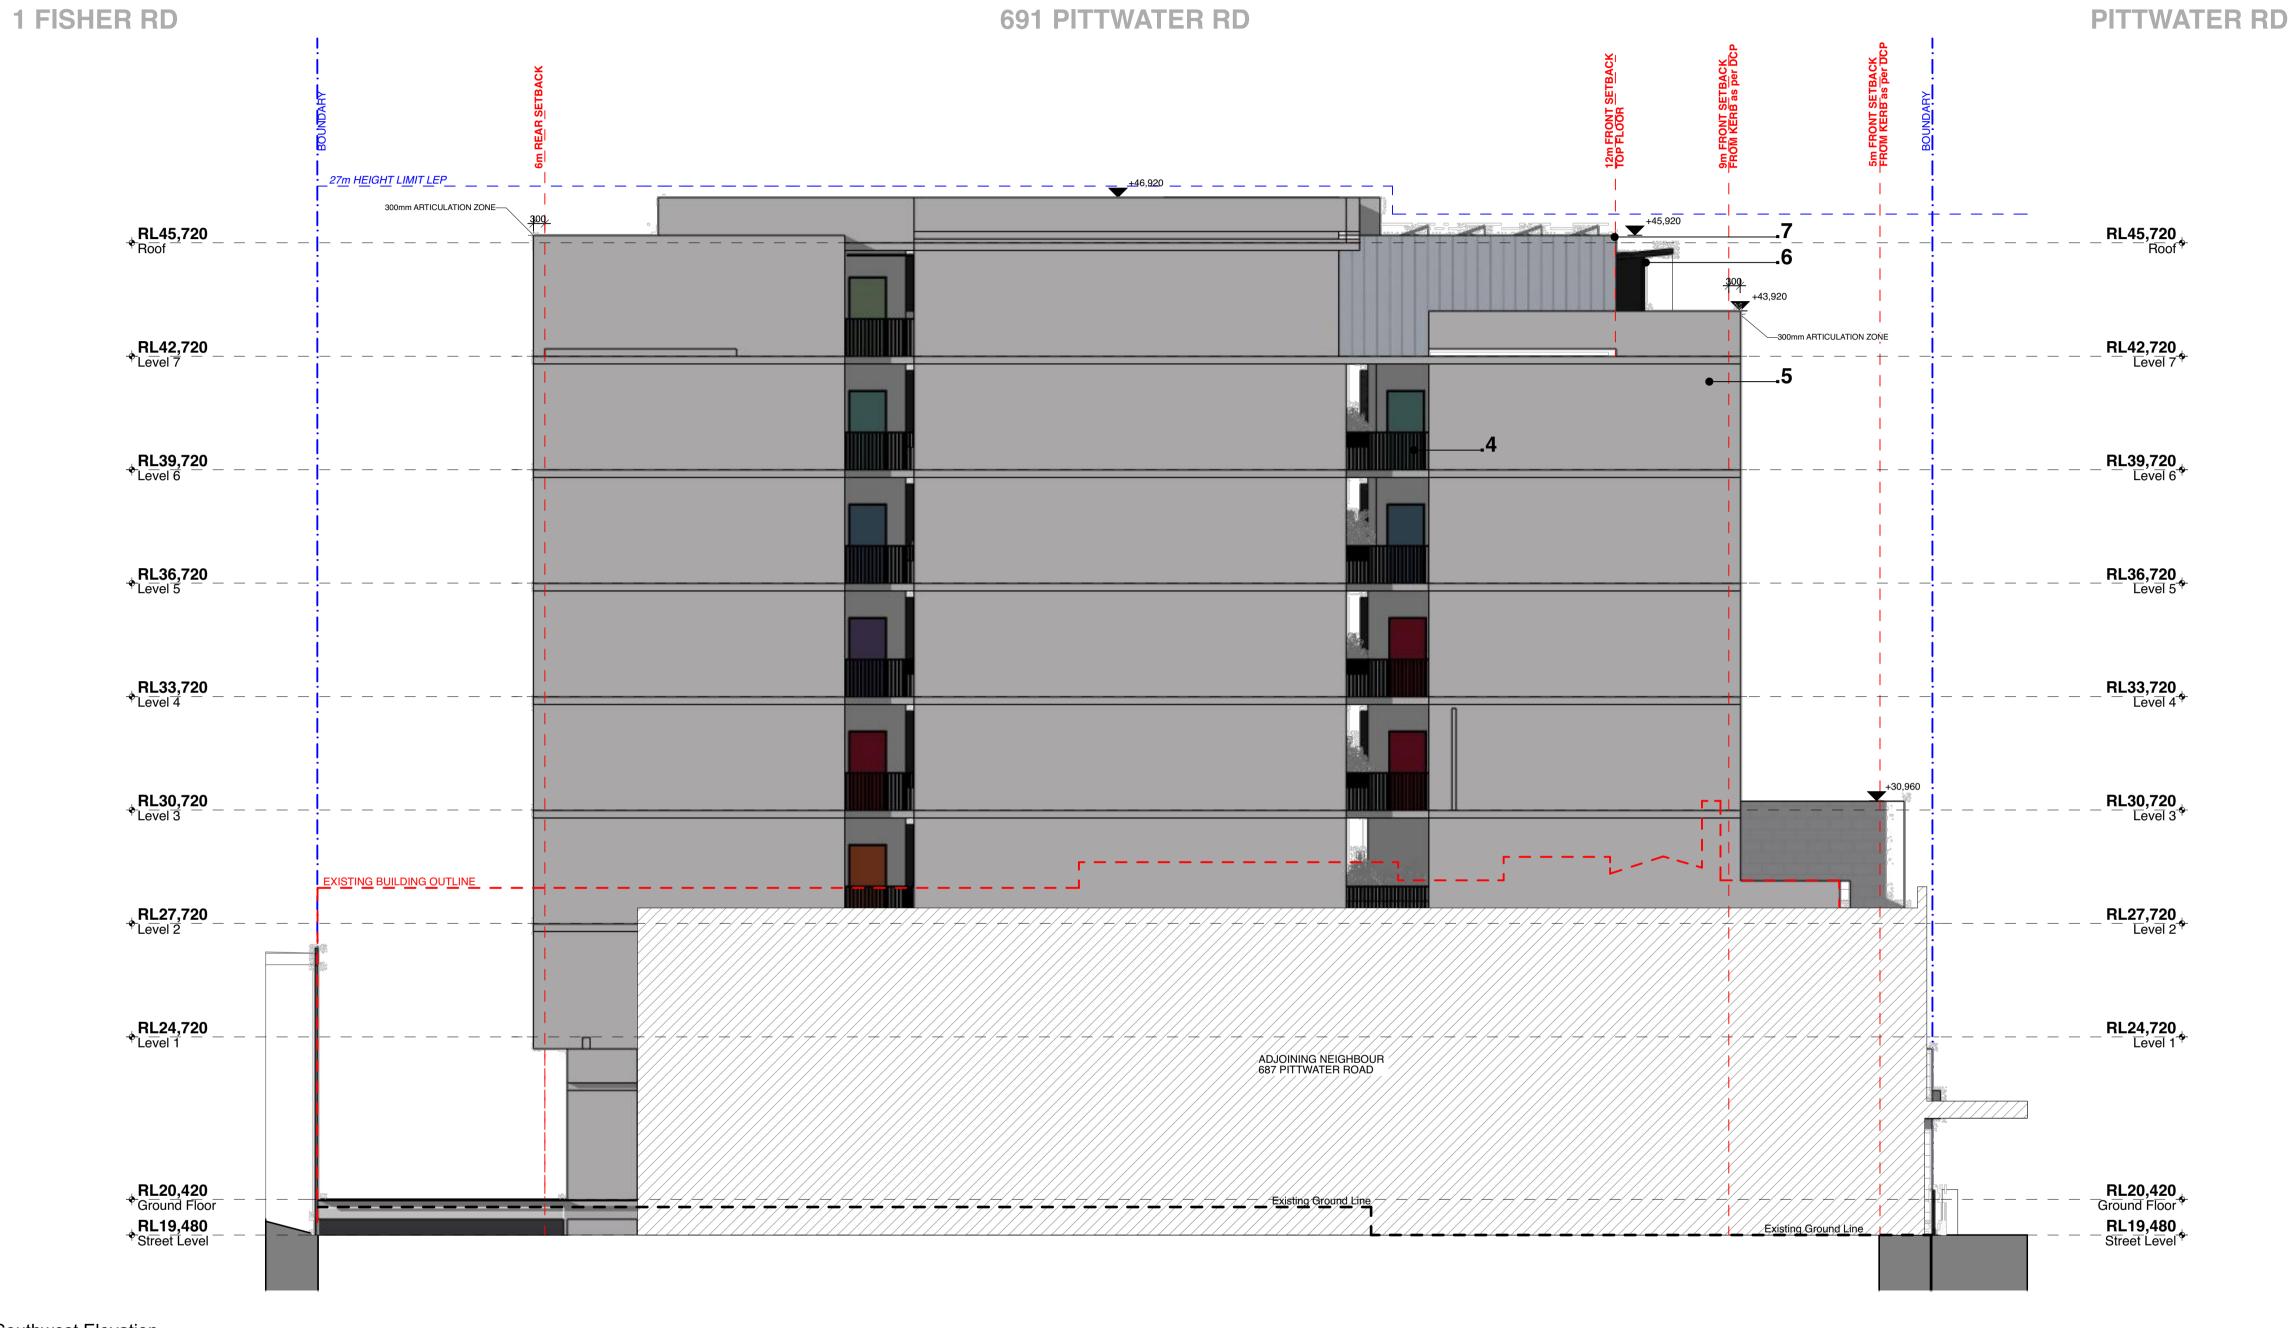
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| <b>S Y D N E Y</b><br>Suite 1.04,       | NEWCASTLE<br>Suite 4                   | BYRON BAY<br>Unit 1                    | ADDRESS<br>691 Pitty |
| 77 Dunning Ave,<br>Rosebery<br>NSW 2018 | 19 Bolton St,<br>Newcastle<br>NSW 2300 | 10 Station St,<br>Bangalow<br>NSW 2479 | CLIENT<br>Gannet     |
| T: +61 2 9318 9200<br>E: bka@bka.com.au | <b>T</b> : +61 2 4926 5563             | <b>T</b> : +61 2 4926 5563             | DRAWING              |

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| NG<br>tions                          |      |          |          | REV          | С     |





#### **Schedule of External Finishes**



1. Existing Concrete Block



2. Existing Granite Cladding Awning Colour: Red Colour: Clear Granite






4. Metal Balustrade 5. Precast Colour: Black Concrete Panels



**6. EasyLap Panel Cladding** Colour: Dark grey

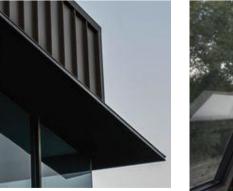

7. Steel Window **Shades** Colour: Monument or similar




8. Aluminium
Window and Door
Frames
Colour: Black

9. Timber Looking
Lift Lobby
Screening

9. Timber Looking
Lift Lobby
Screening
Colour: Black

10. Accent Paint Colours
a. Dulux Satorini (S33H3)
b. Dulux Copacabana (S33H7)
c. Dulux Rosetta (S07D5)
d. Dulux Buzz (S15H7)



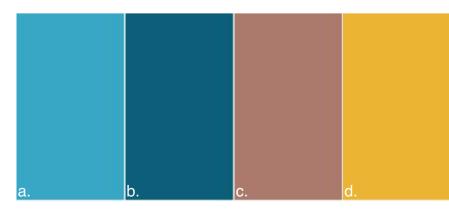



**11. FC Cladding** Colour: Mid grey

Wall Colour: White

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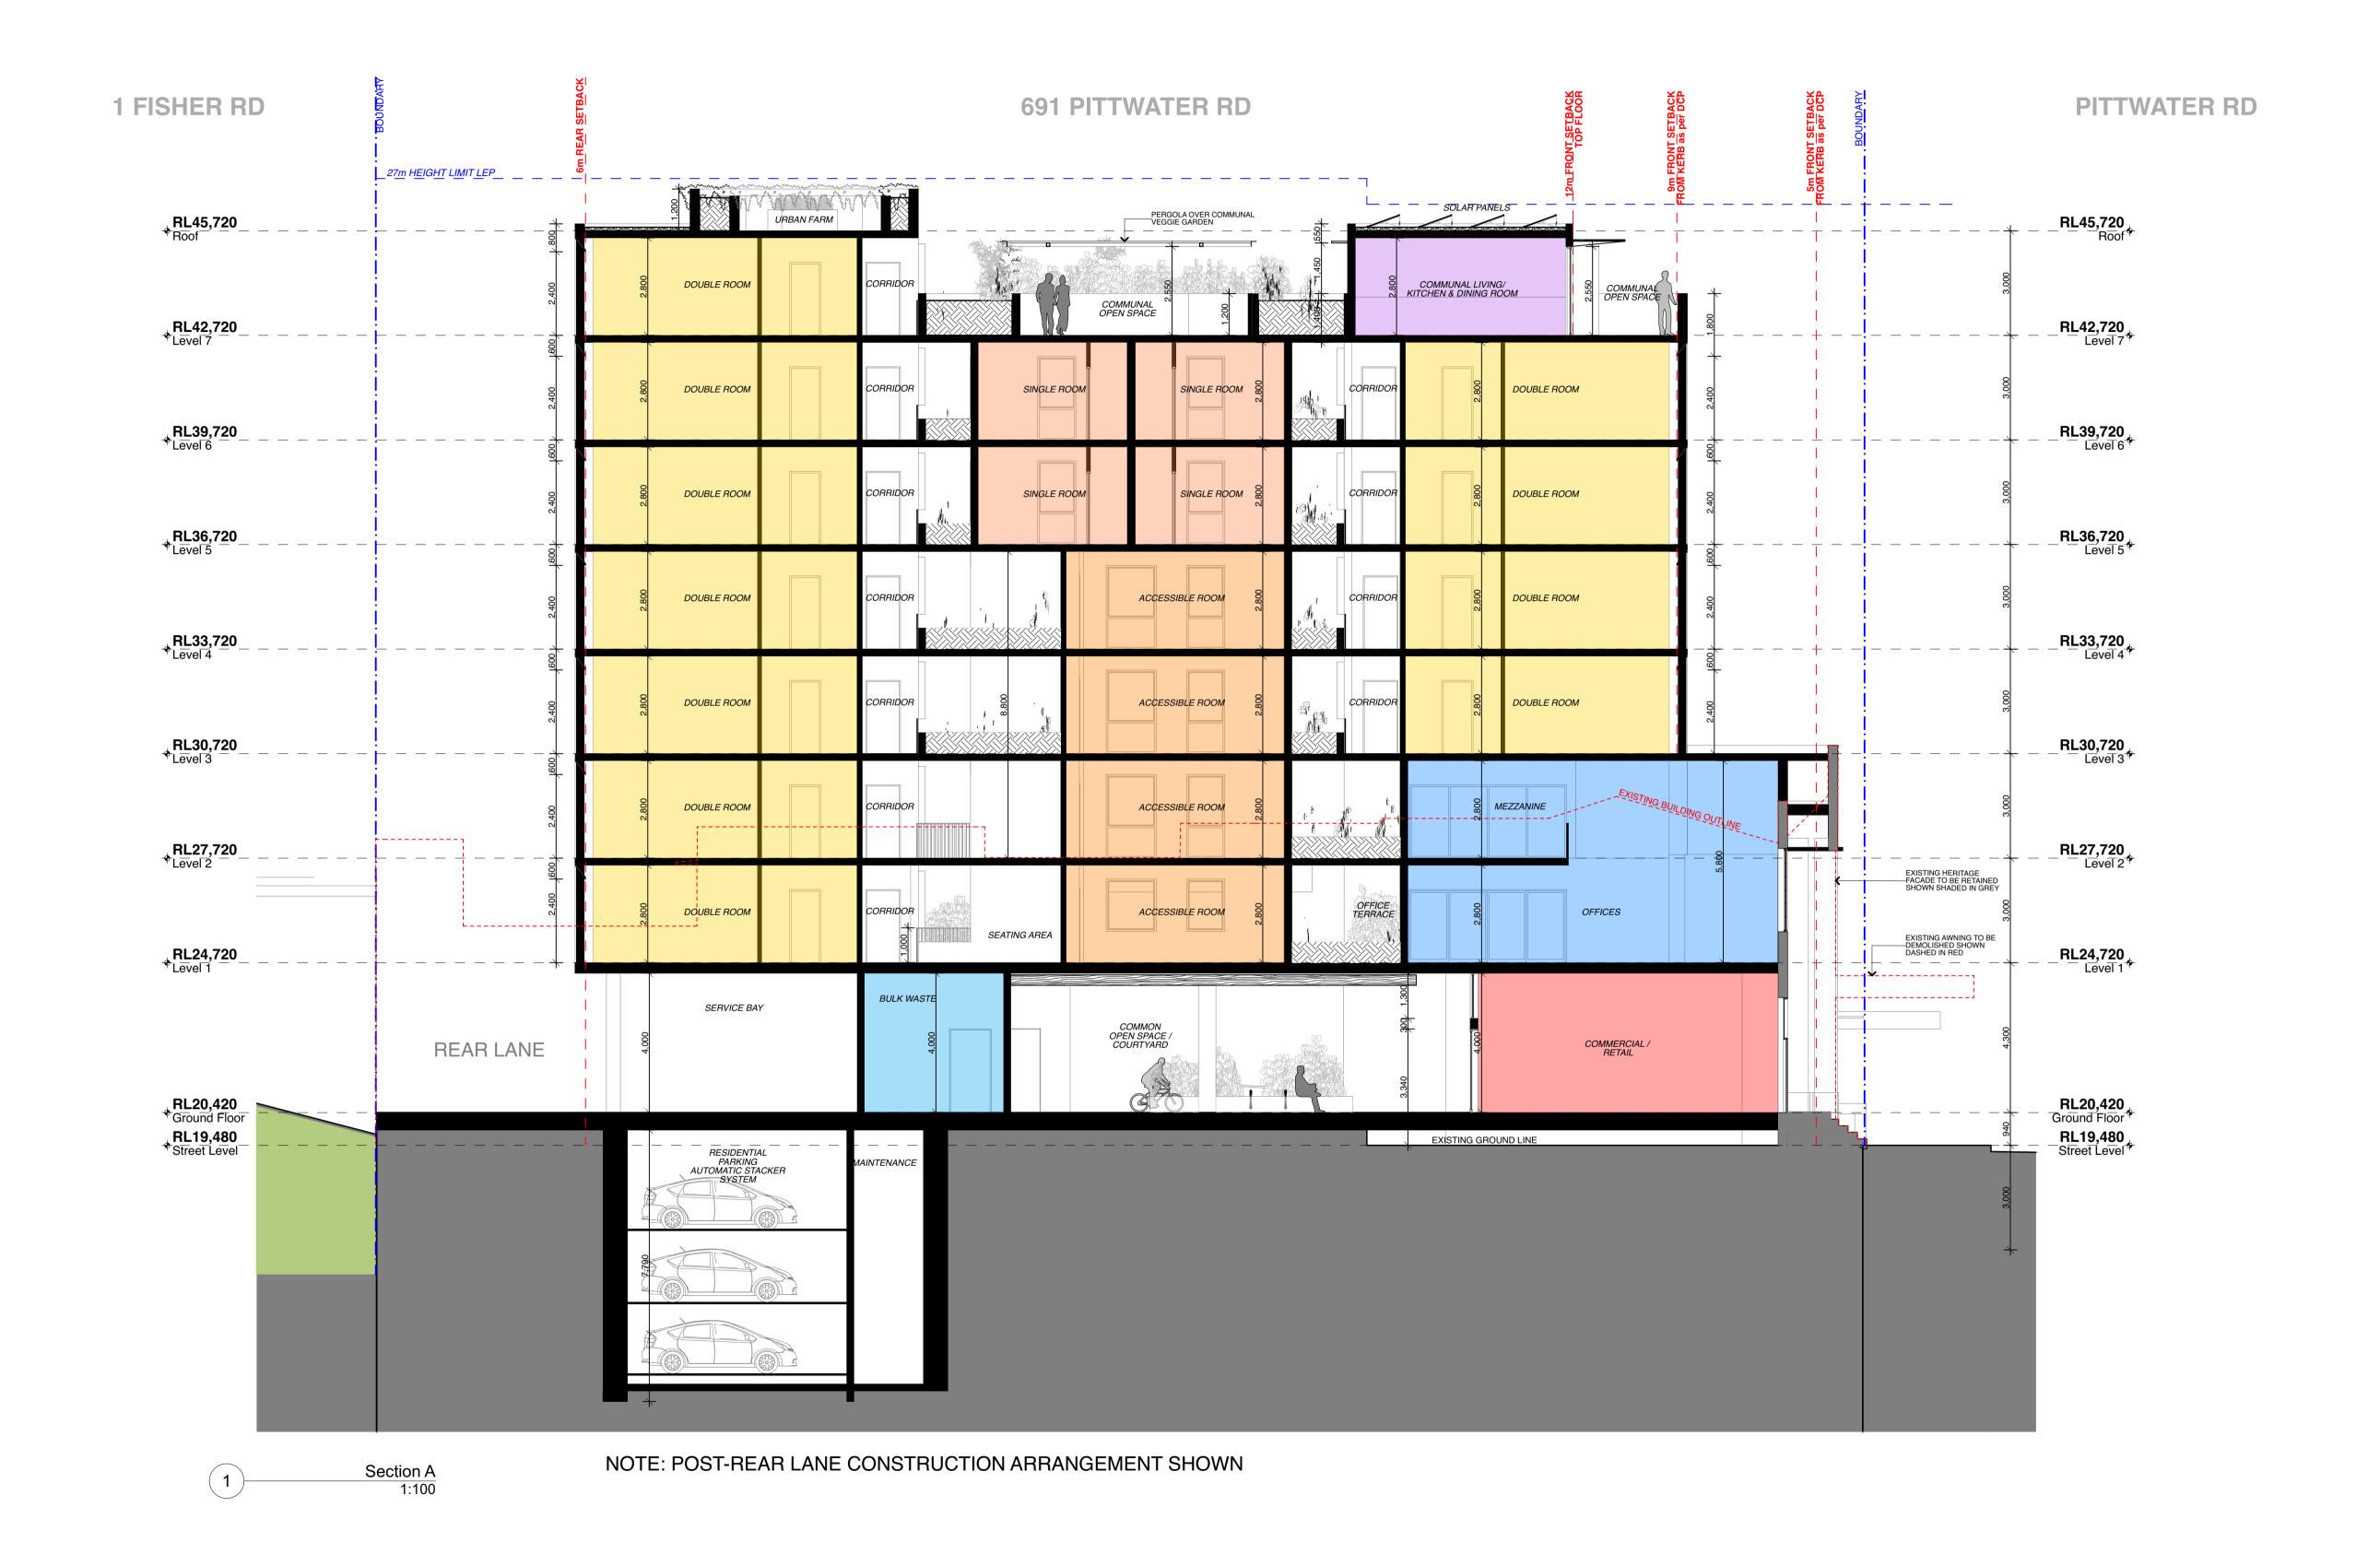
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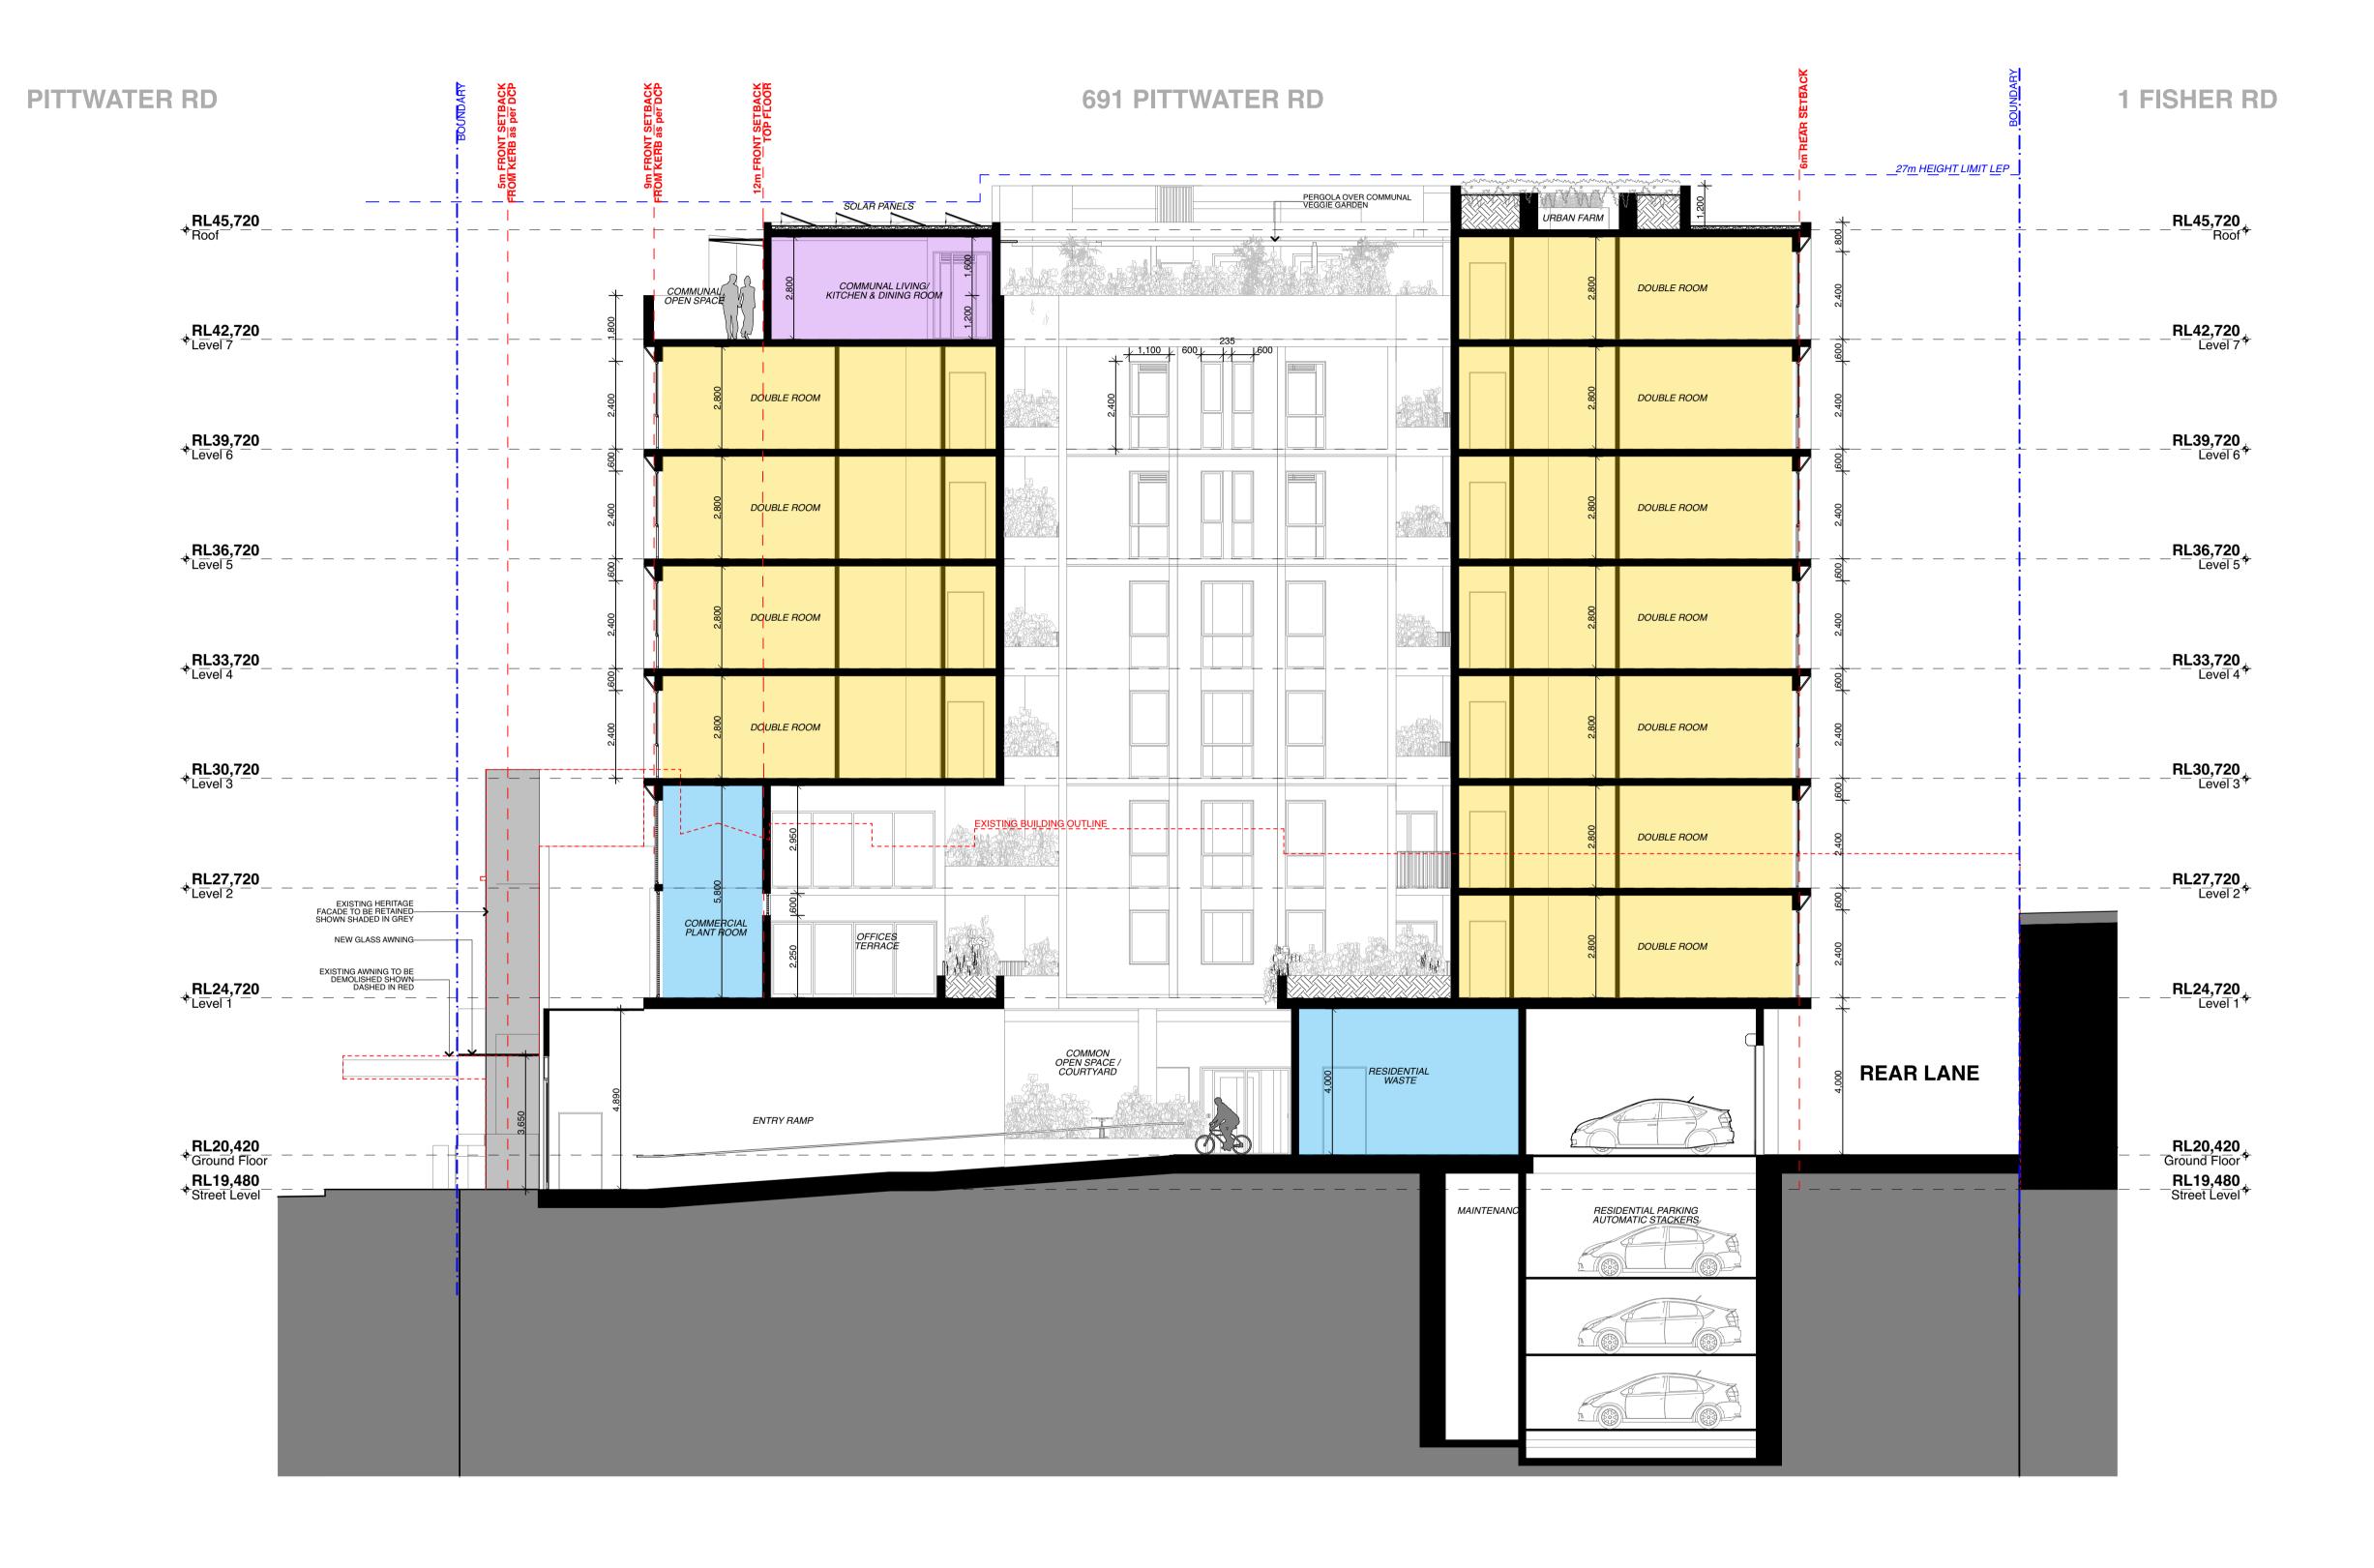
| PROJECT Mixed Use Boarding House Development | PROJECT# | 19049    | SCALE @ A1  |
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| 691 Pittwater Road Dee Why NSW               | DATE     | 27/11/20 | DRAWING No. |
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| Elevations                                   |          |          | REV         |



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Section B 1:100


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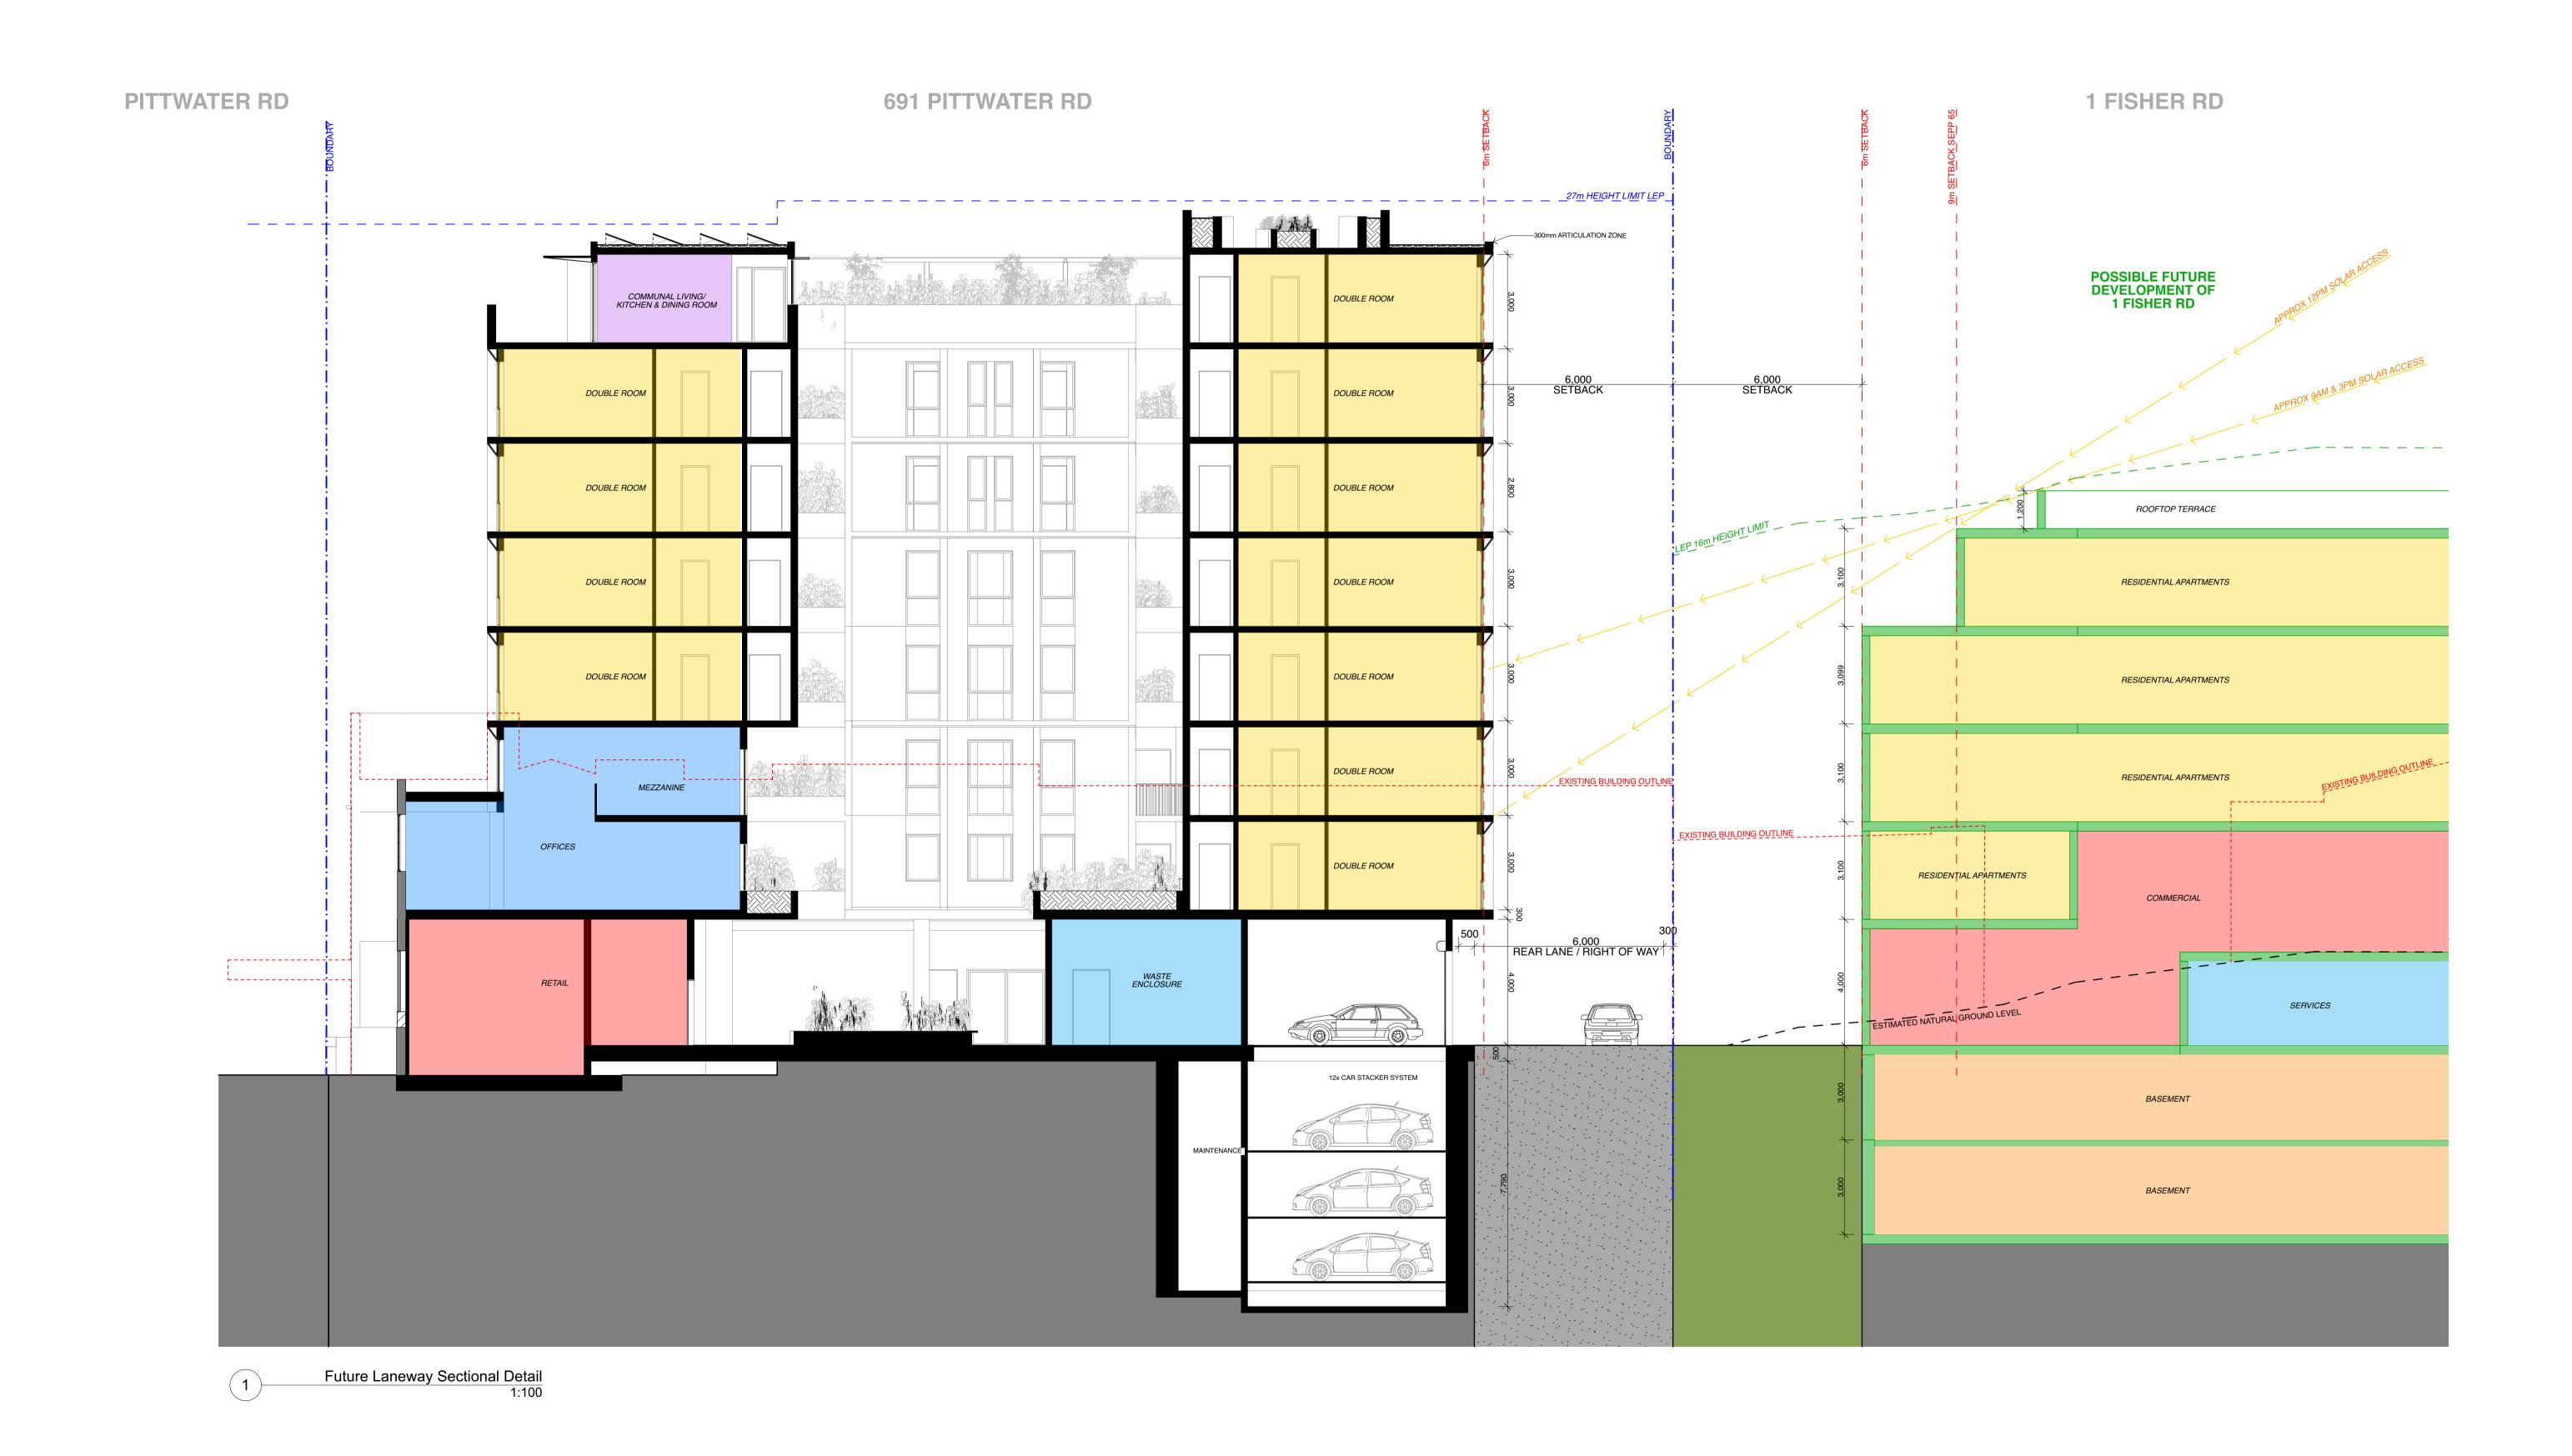


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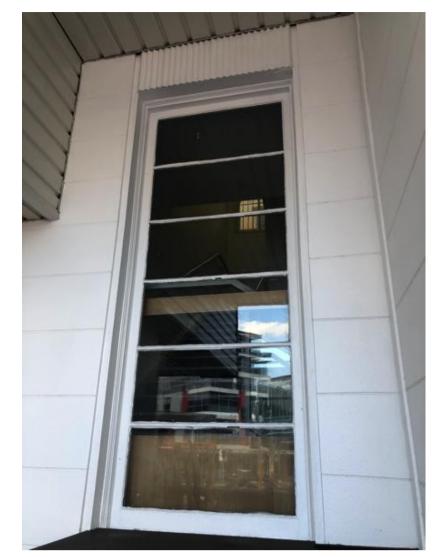
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 NSW 2300
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Detailed Section - Future Development

## HERITAGE COMPONENT



**Window 1:** Existing heritage window viewed from street, with staircase behind. Head detail to be matched in other restored window.

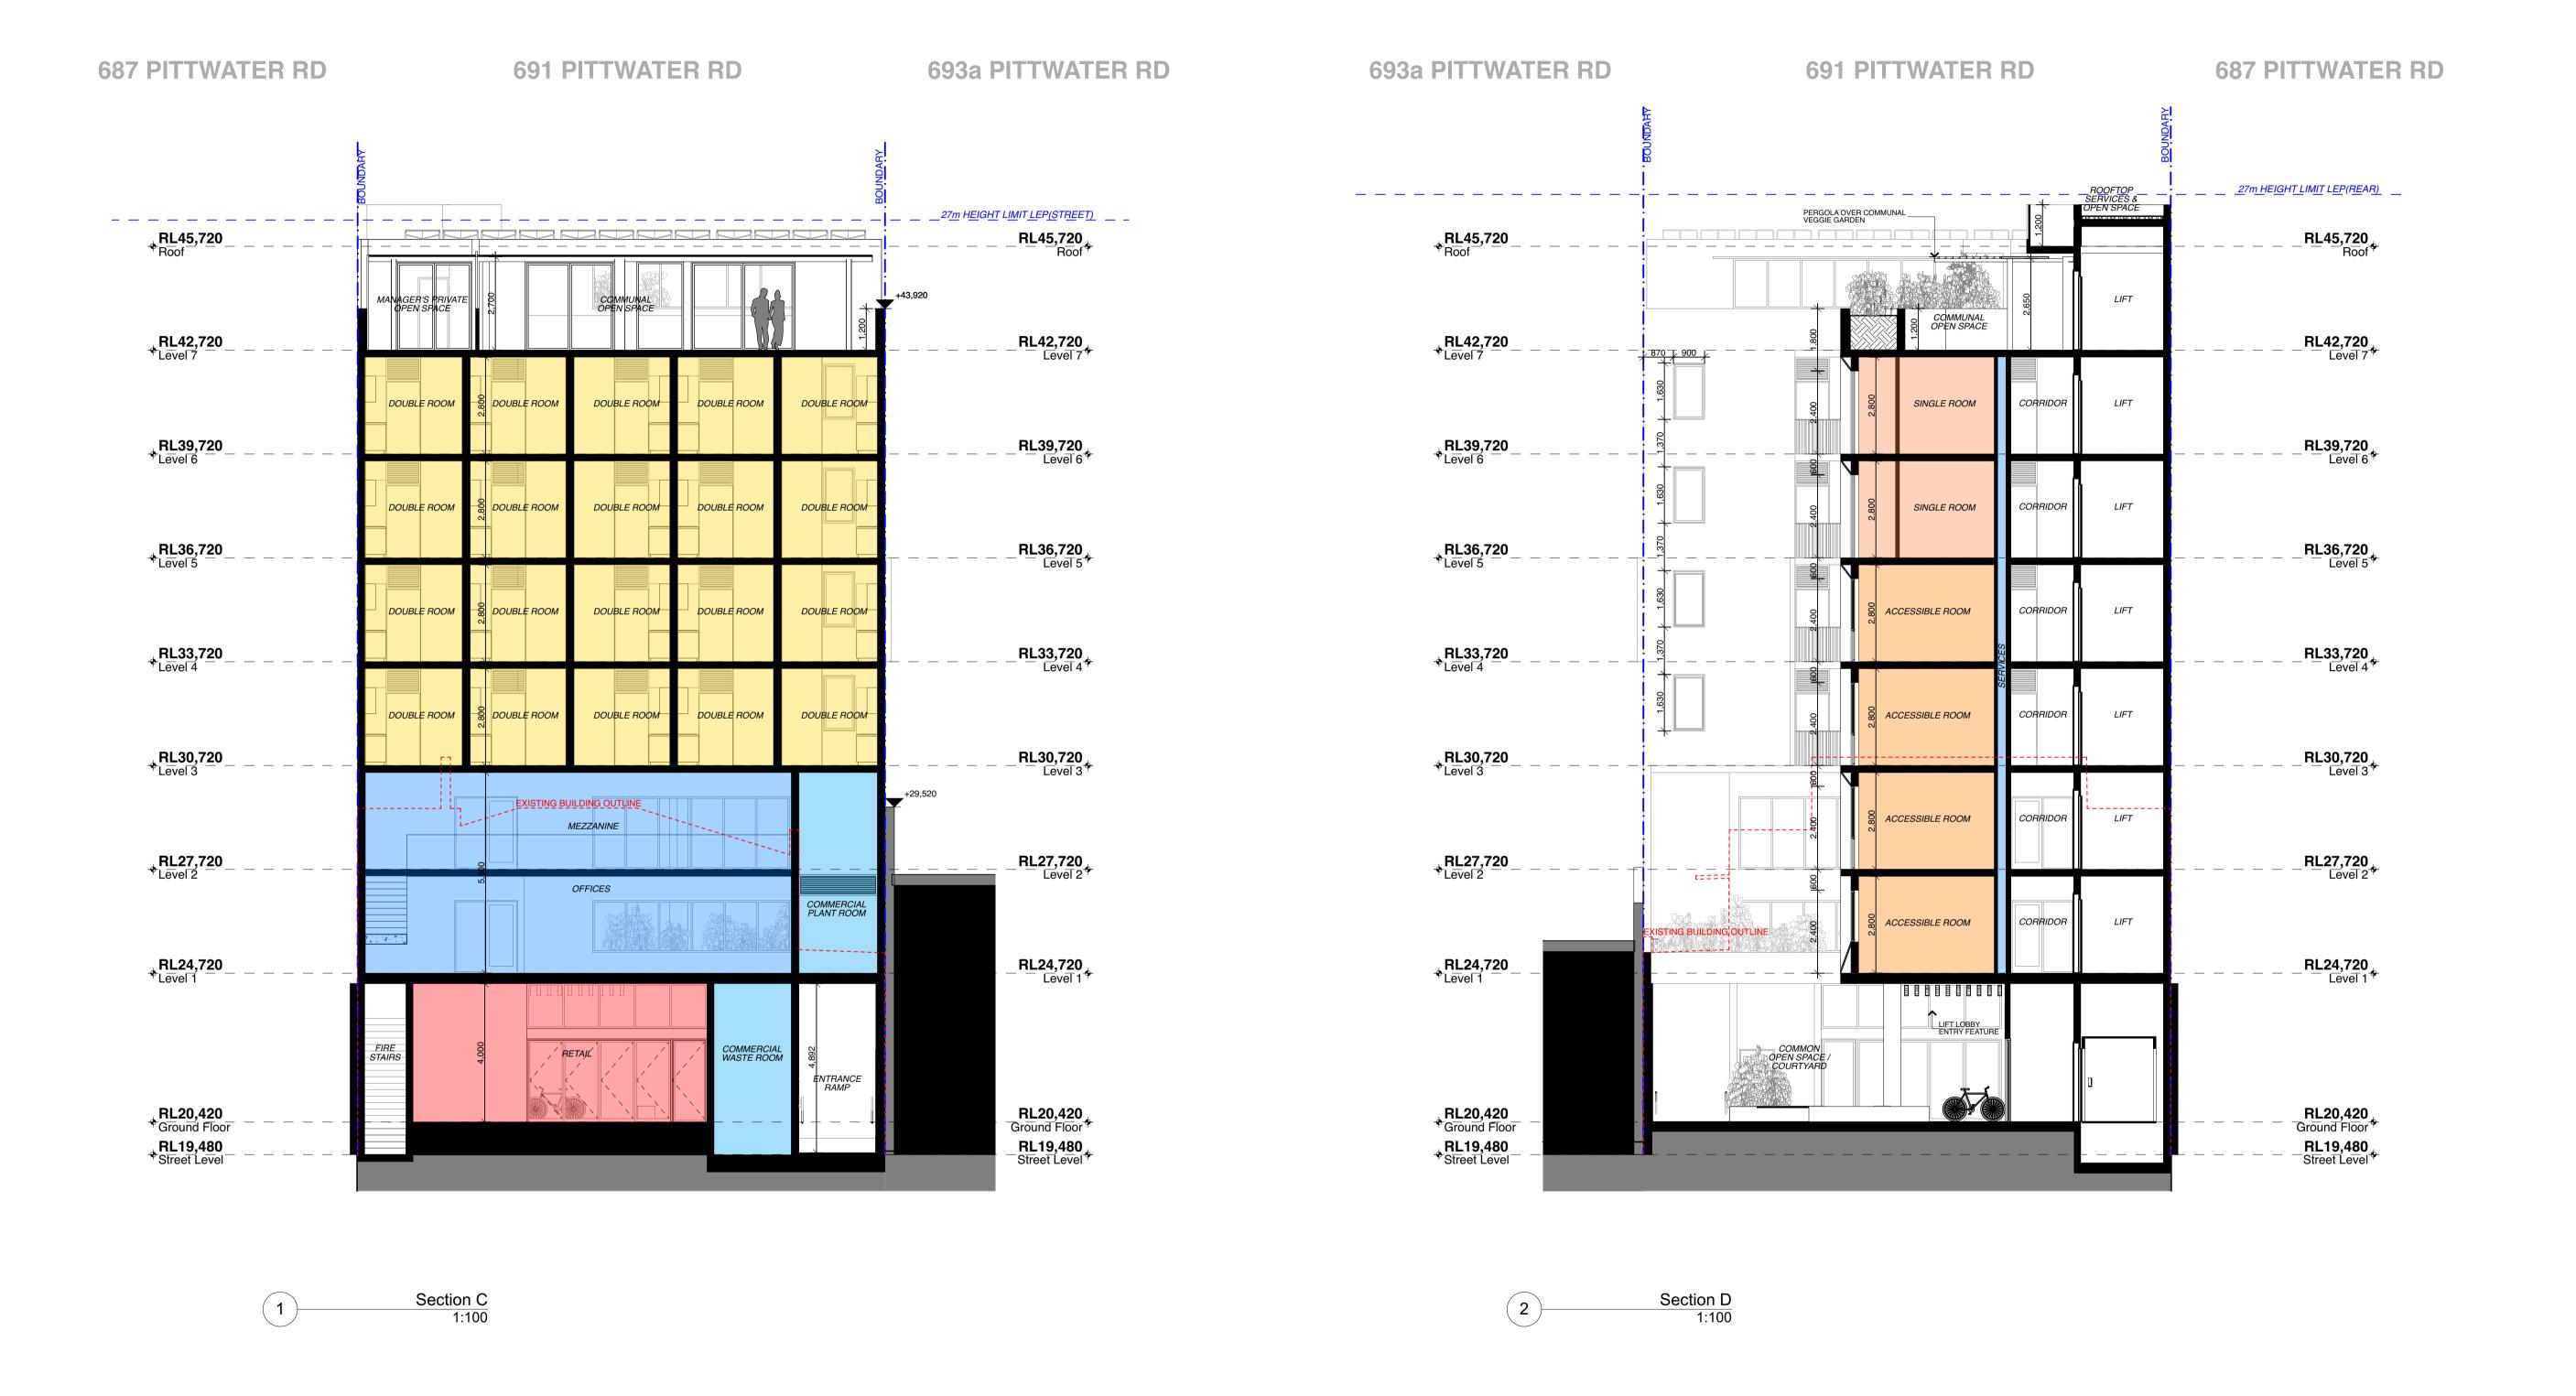
EXISTING SECURITY BARS TO BE REMOVED AND SECURITY LOCK - INSTALLED.

EXISTING IMITATION GREEN WALLS TO BE REMOVED AND MADE GOOD WHERE-NECESSARY.

PROPOSED EMERGENCY EXIT DOOR. HERITAGE WINDOW TO BE RESTORED-TO DETAIL. (WINDOW 1)

EXISTING GRANITE PLINTH. BLACK PAINT TO BE STRIPPED TO SHOW ORIGINAL RED STONE.

RMS PILLAR—

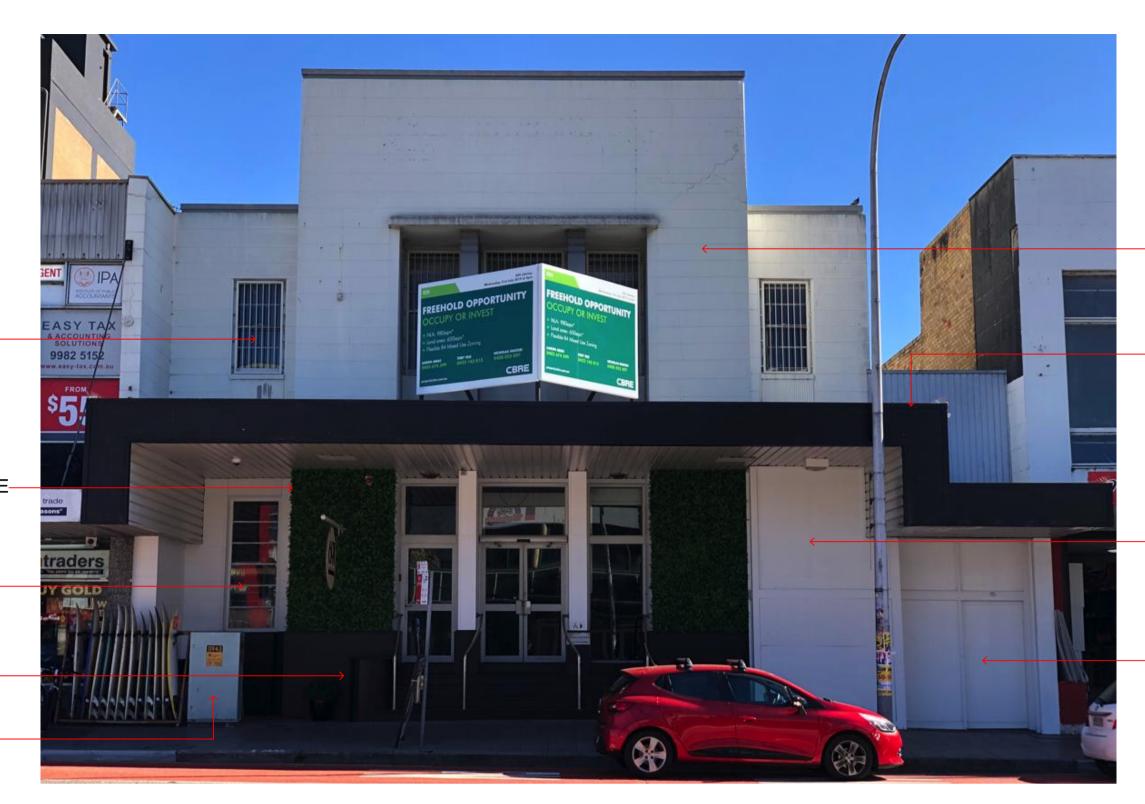

HERITAGE FACADE TO BE RETAINED AND RESTORED WHERE NECESSARY.

EXISTING AWNING TO BE REPLACED
WITH LIGHTWEIGHT GLASS AWNING
OVER ACCESSIBLE ENTRY ONLY.

EXISTING ATM FACILITIES TO BE REMOVED FOR HERITAGE WINDOW BEHIND TO BE SHOWN.

(WINDOW 2)

EXISTING ACCESSIBLE ENTRY TO BE REMOVED AND REPLACED WITH GLASS DOORS AND A COMPLIANT, ACCESSIBLE ENTRY RAMP. GLAZED ENTRY TO BE RECESSED FROM BOUNDARY, FLUSH WITH HERITAGE FACADE.




**Window 2:** Existing heritage window in poor condition. Currently covered by ATM services on the outside. View shown from inside existing building.

WINDOW 2 DETAIL

#### **GENERAL**

Proposal for the heritage facade of 691 Pittwater Rd, Dee Why, to be retained and restored.

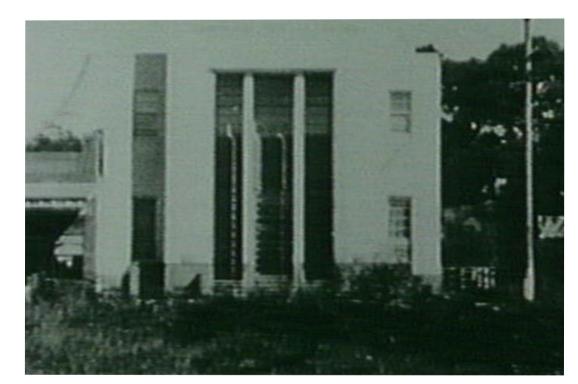


691 Pittwater Road as the Commonwealth Bank in the 1940's. (Source: Warringah Image Library, http://www.photosau.com.au/warringah/scripts/home.asp).


The proposal includes the following items:

- ATM service walls and partitions to be removed
- Black paint to be stripped from granite plinthGranite plinth to be restored to its original intent
- Granite plinth to be restored to its original inte
   Remove existing metal street awning
- Existing bars off upper level windows to be removed

As recommended by Council's Heritage Consultant in the Prelodgement Advice Document, it is preferred "that there be no awning placed on the building due to it interrupting the strong vertical lines as indicated through the aligned columns and windows". Also, "Heritage could consider a small awning above the pedestrian entryway on the northern side". As a result, a glass awning has been proposed to cover the accessible entry to the building on the northern side with minimal impact on the existing heritage facade.

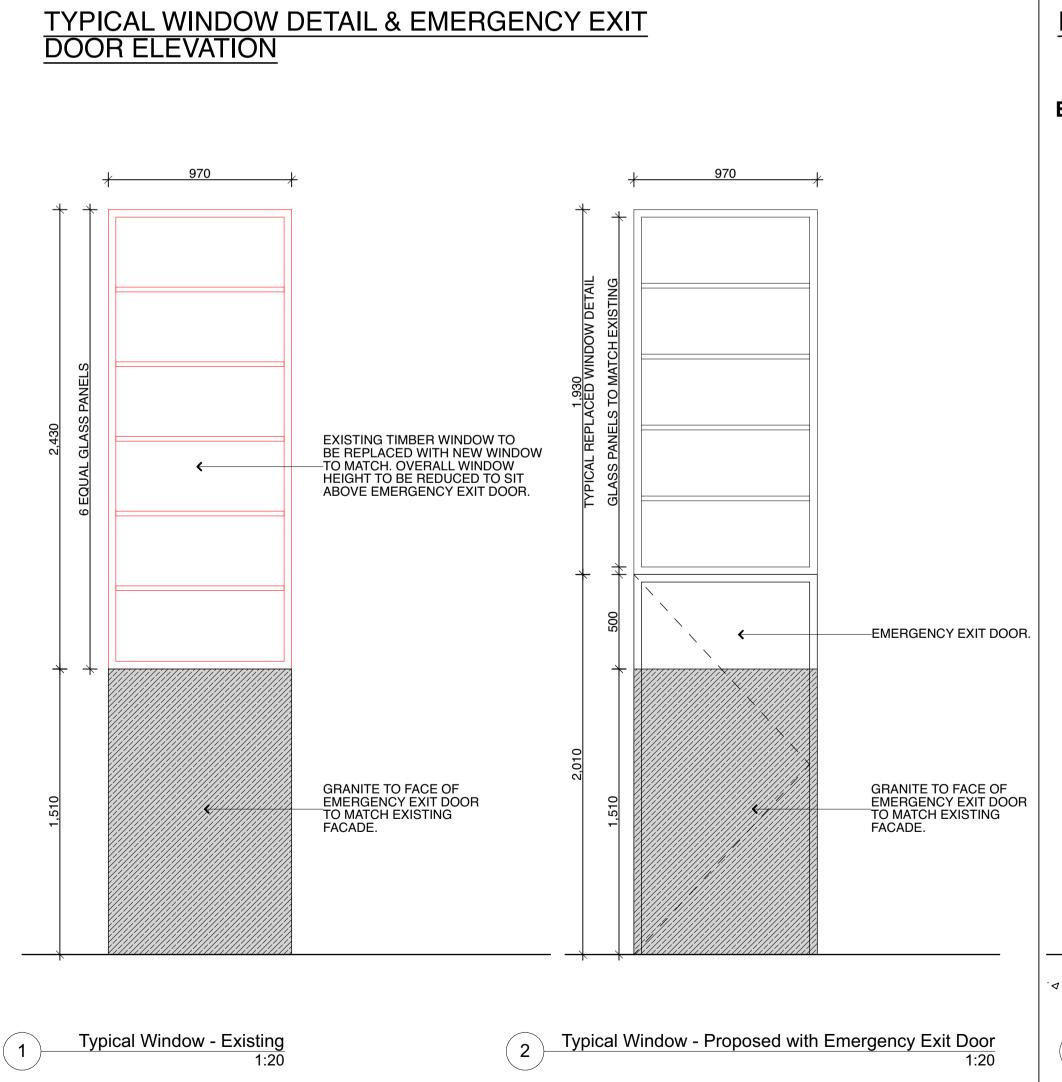

# **EMERGENCY EXIT DOOR & WINDOW 1 EMERGENCY** PITTWATER ROAD **EXIT** WINDOW HEAD DETAIL TO BE RETAINED. FIRE RATED WALL BEHIND. EXISTING TIMBER WINDOW TO BE REPLACED WITH NEW WINDOW TO MATCH. OVERALL WINDOW HEIGHT TO BE REDUCED TO SIT ABOVE EMERGENCY EXIT DOOR. PORTION OF WINDOW WHICH —HAS BEEN REDUCED DUE TO EMERGENCY EXIT DOOR. -EMERGENCY EXIT DOOR. GRANITE TO FACE OF EMERGENCY EXIT DOOR TO MATCH EXISTING **Emergency Exit Door**

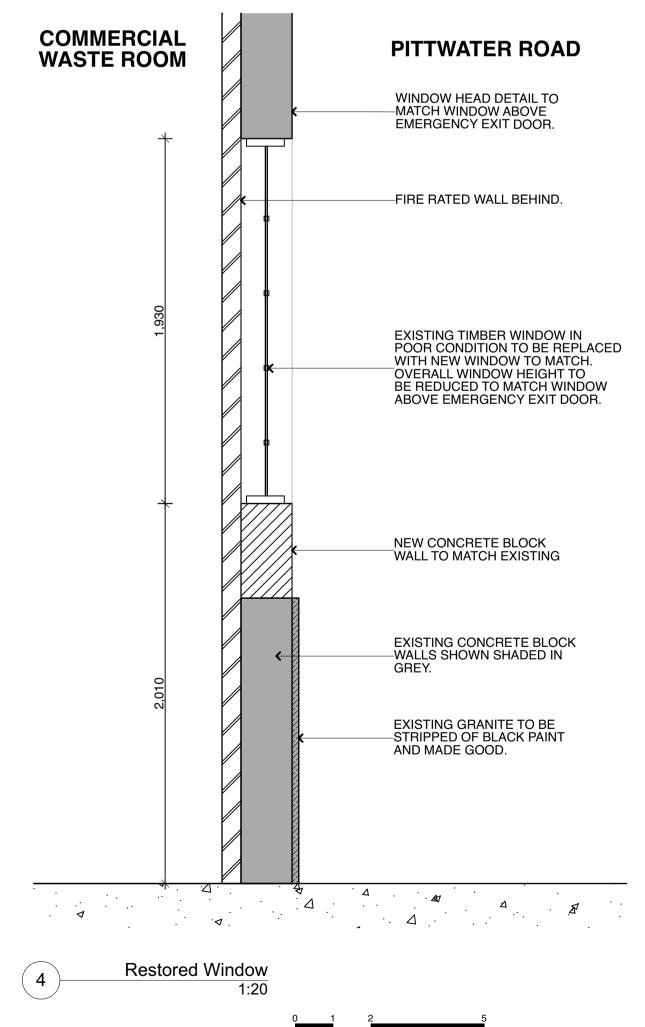

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PROJECT
Mixed Use Boarding House Development

ADDRESS
691 Pittwater Road Dee Why NSW

CLIENT
Gannet Developments

DRAWING
Heritage Component


PROJECT # 19049 SCALE @ A1

DRAWN
AT/JG
CHECKED

DATE 27/11/20 DRAWING NO

DATE


REV

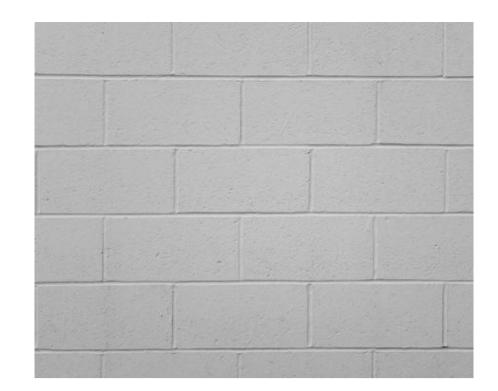


1. Existing Concrete Block Wall Colour: White




2. Existing Granite Cladding Colour: Red Granite

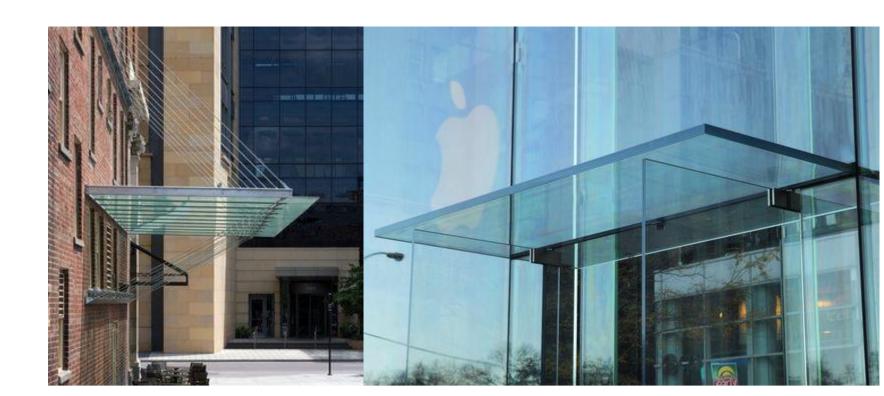

3. Glass Canopy Awning Colour: Clear

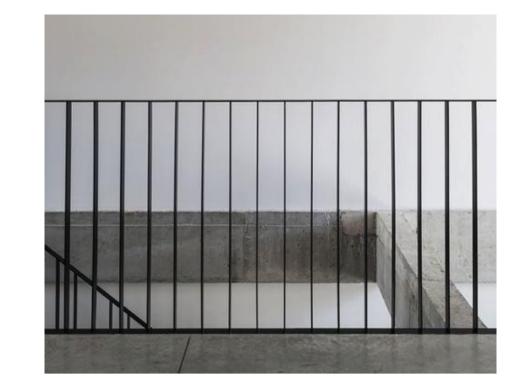


**4. Metal Balustrade** Colour: Black

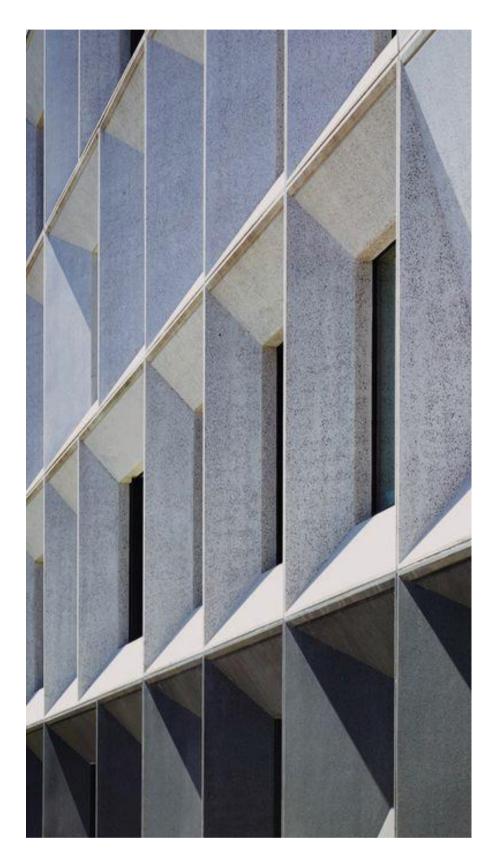

5. Precast Concrete Panels



**6. EasyLap Panel Cladding** Colour: Dark grey

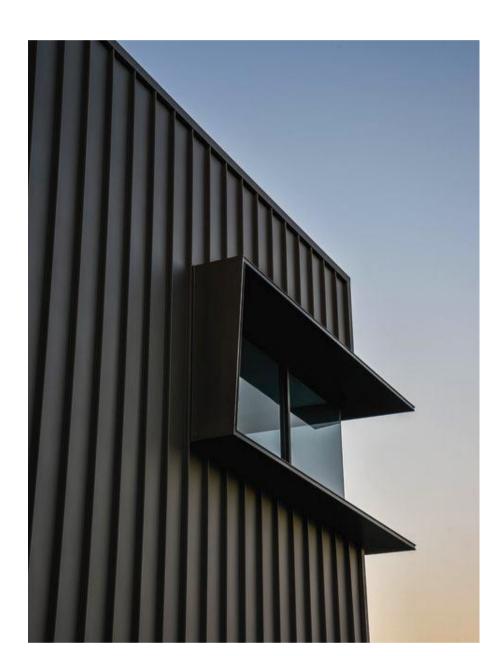


ISSUED FOR DA

21/09/20 ISSUED FOR DA


7. Steel Window Shades Colour: Monument or similar



8. Aluminium Window and Door Frames Colour: Black

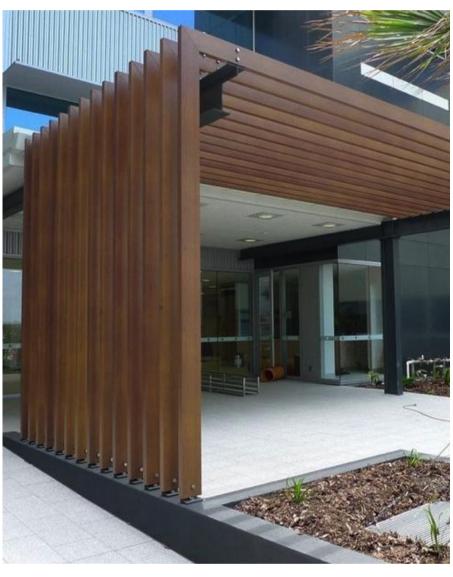



**9. Innowood** Timber Looking Lift Lobby Screening

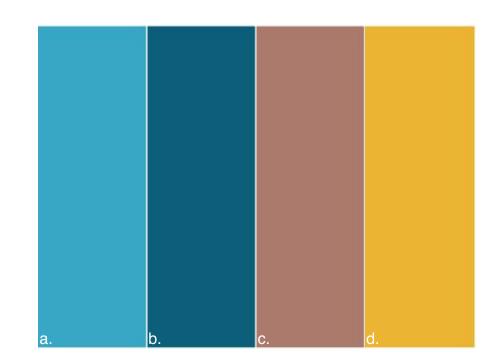



- 10. Accent Paint Colours
  a. Dulux Satorini (S33H3)
  b. Dulux Copacabana (S33H7)
  c. Dulux Rosetta (S07D5)
  d. Dulux Buzz (S15H7)




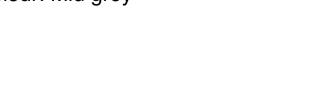


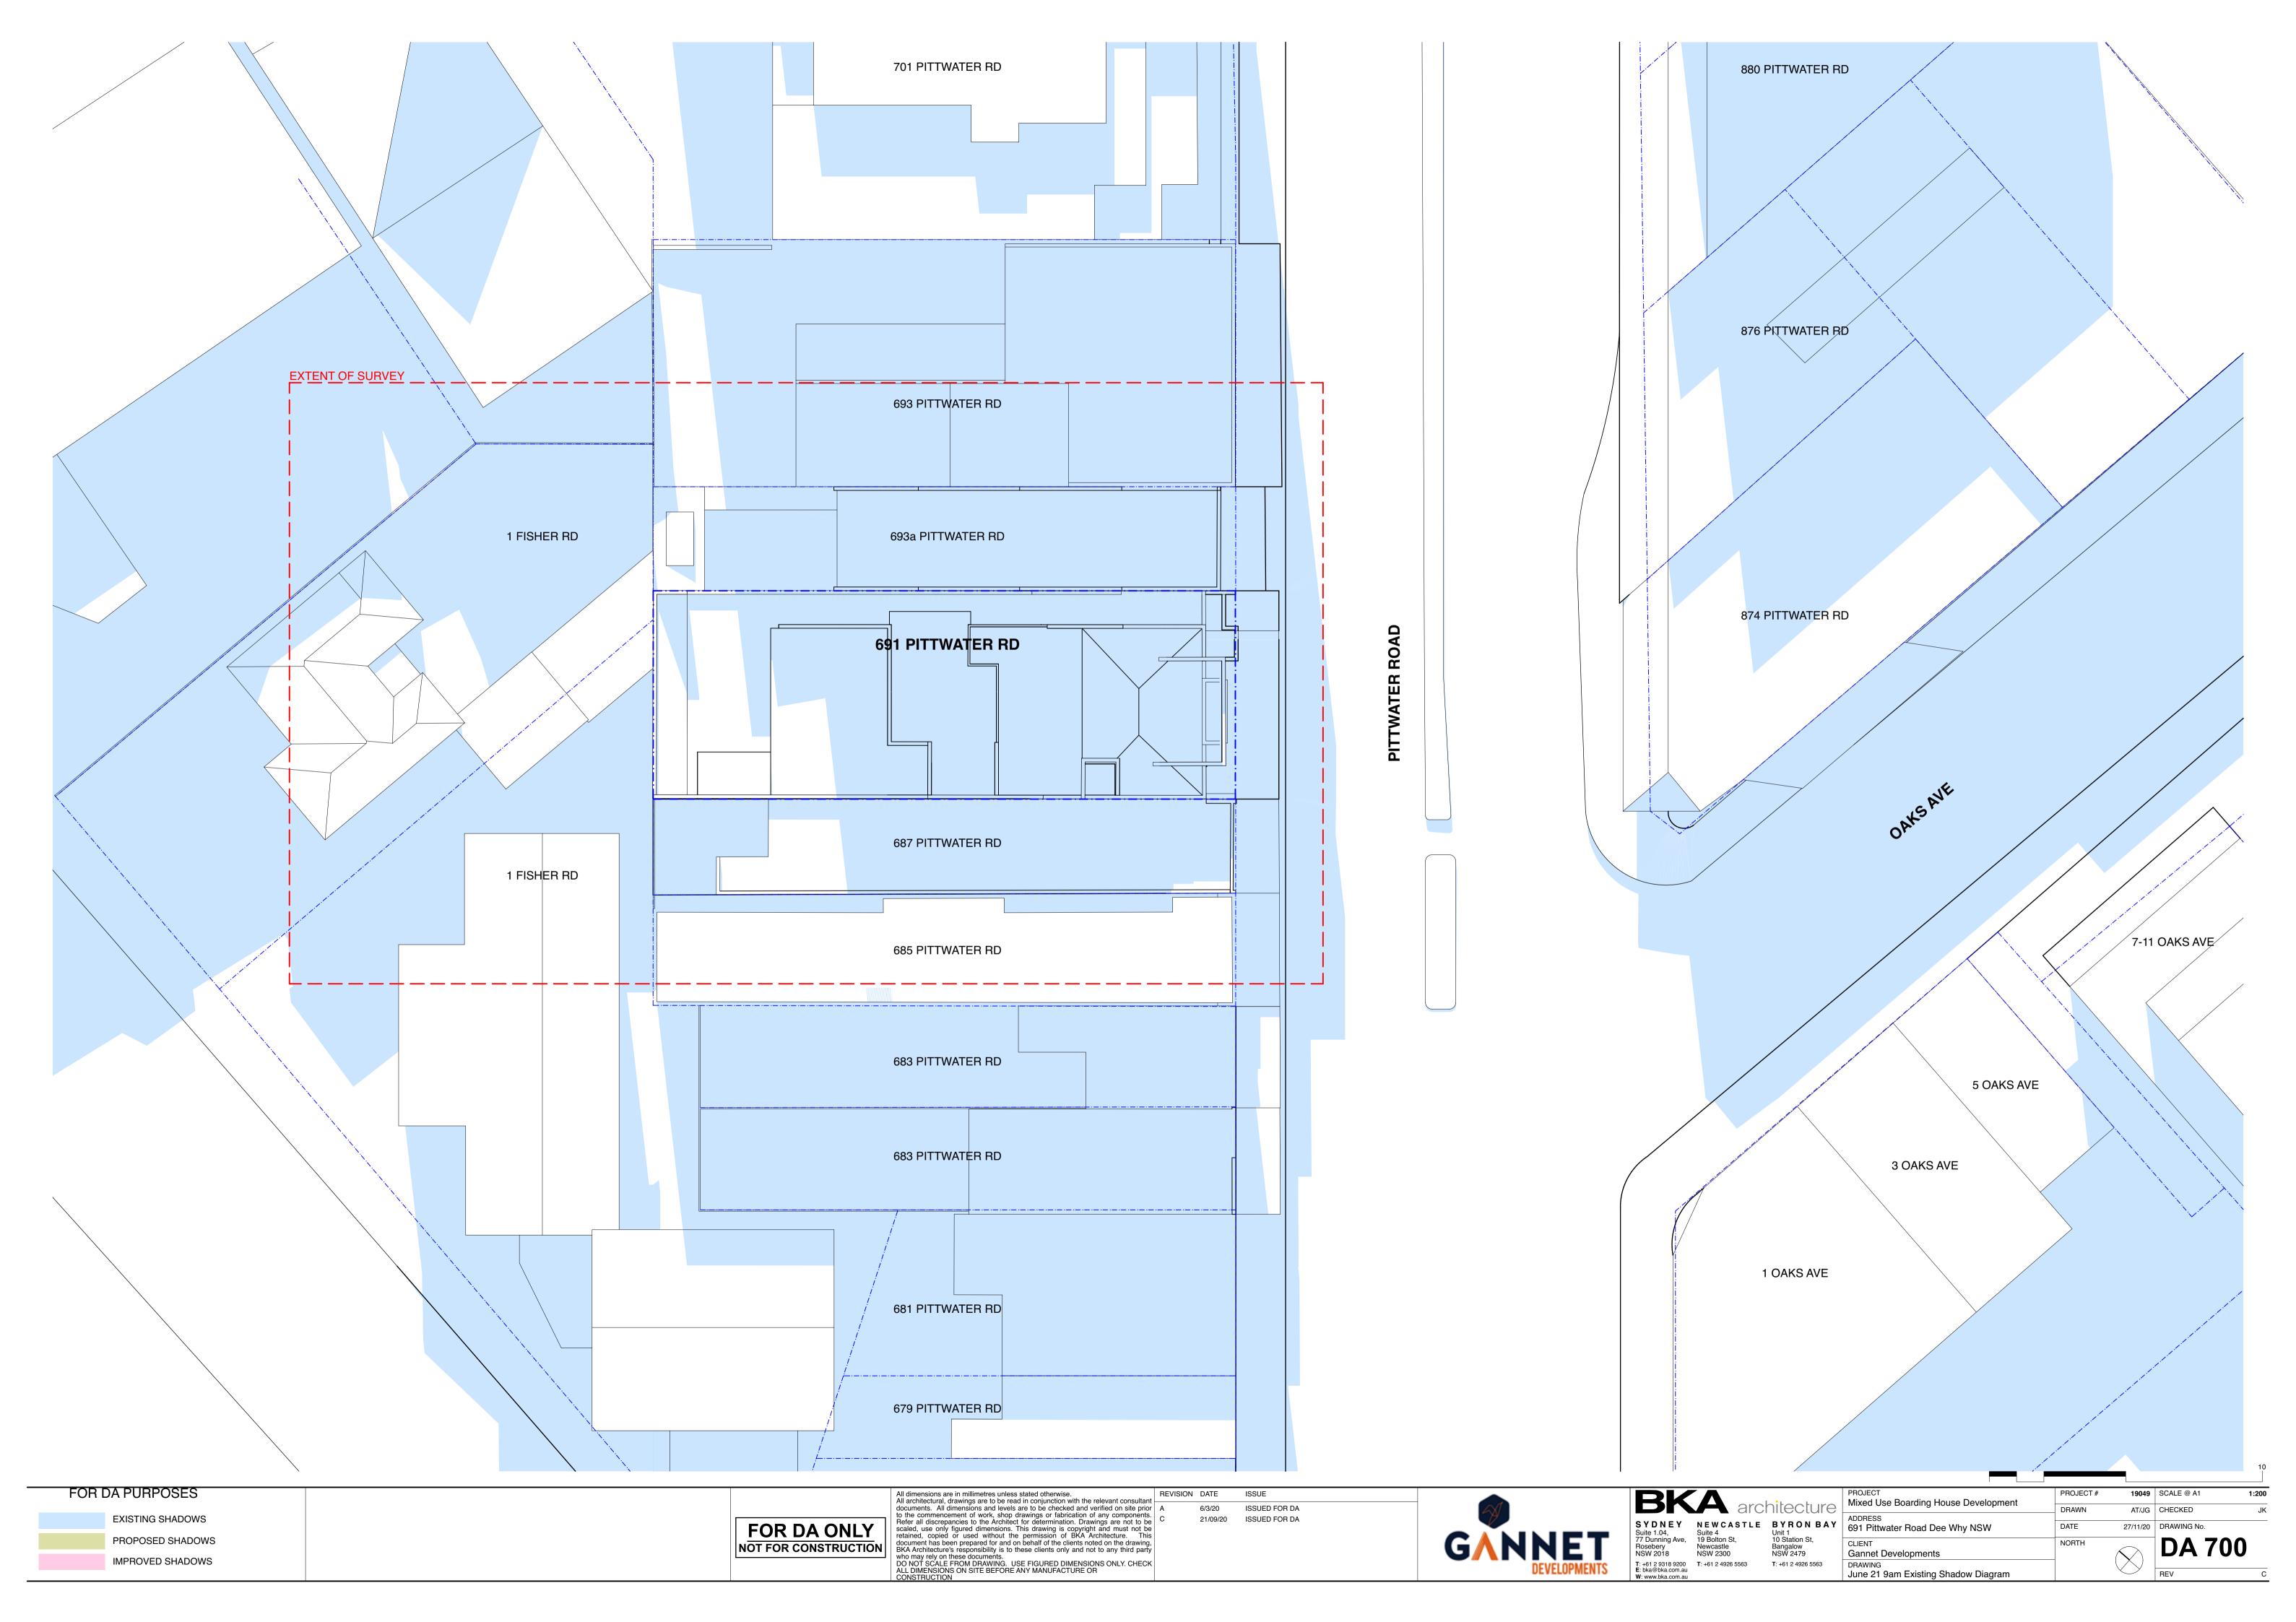


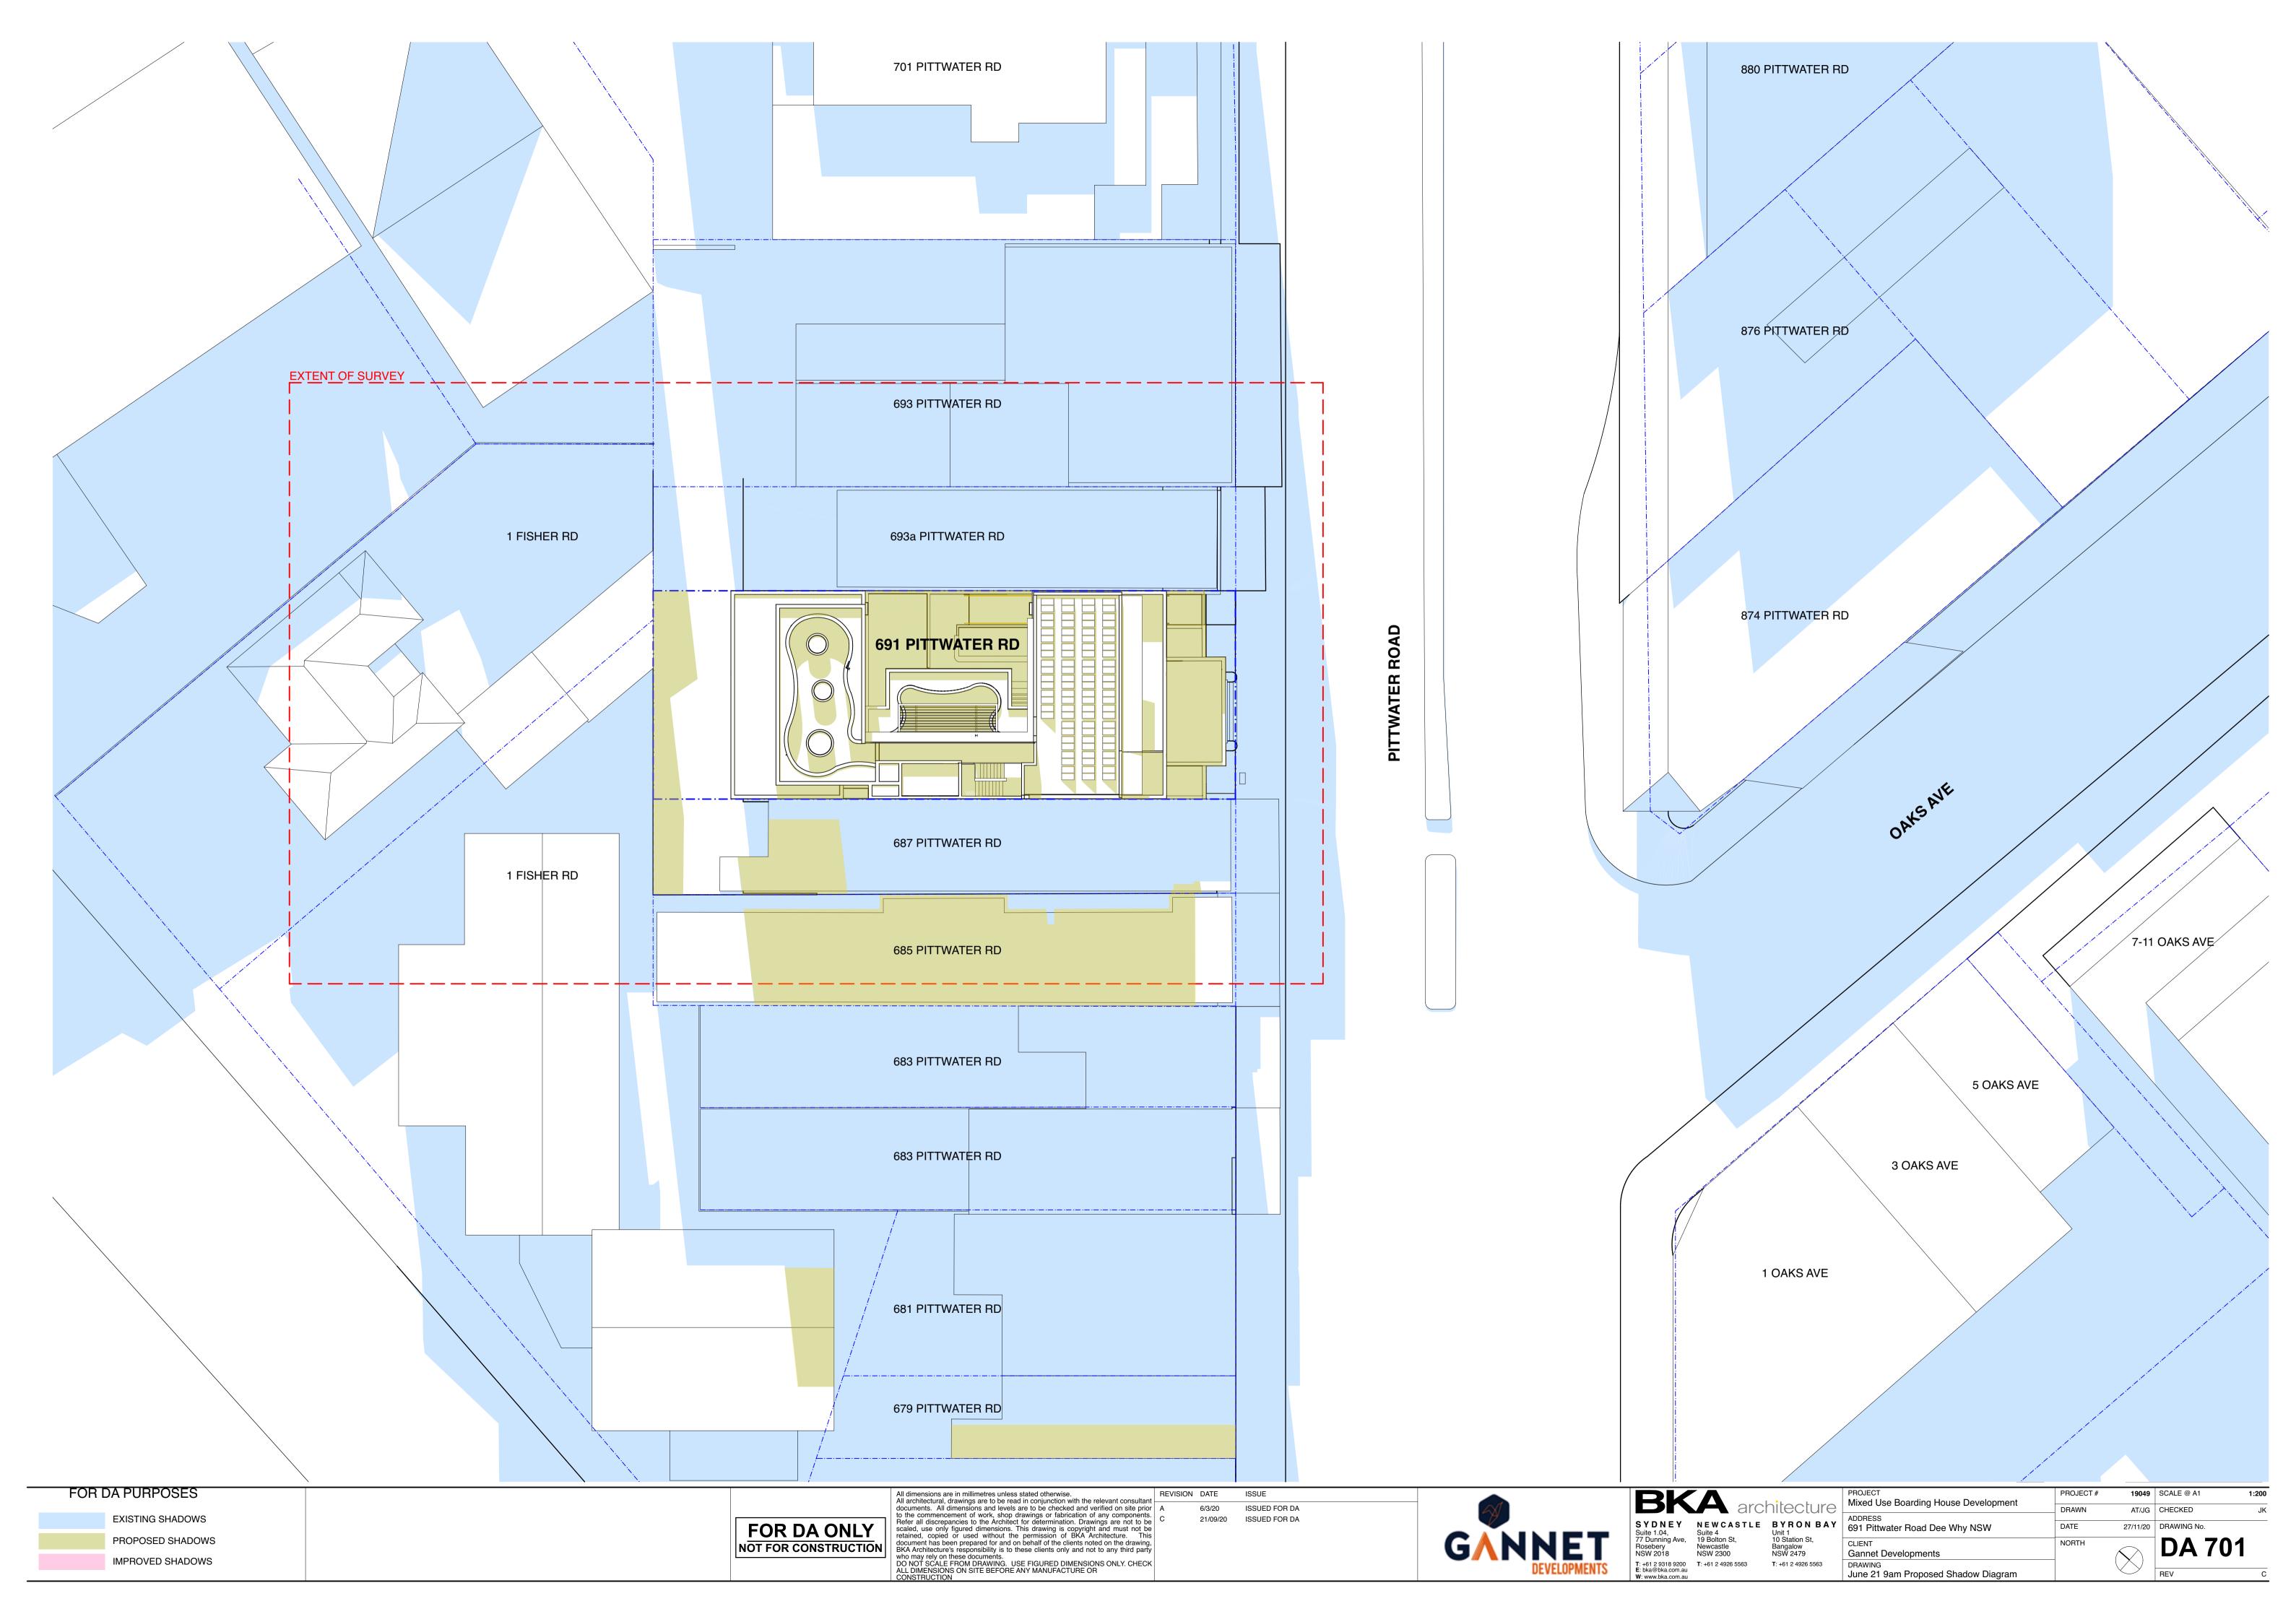

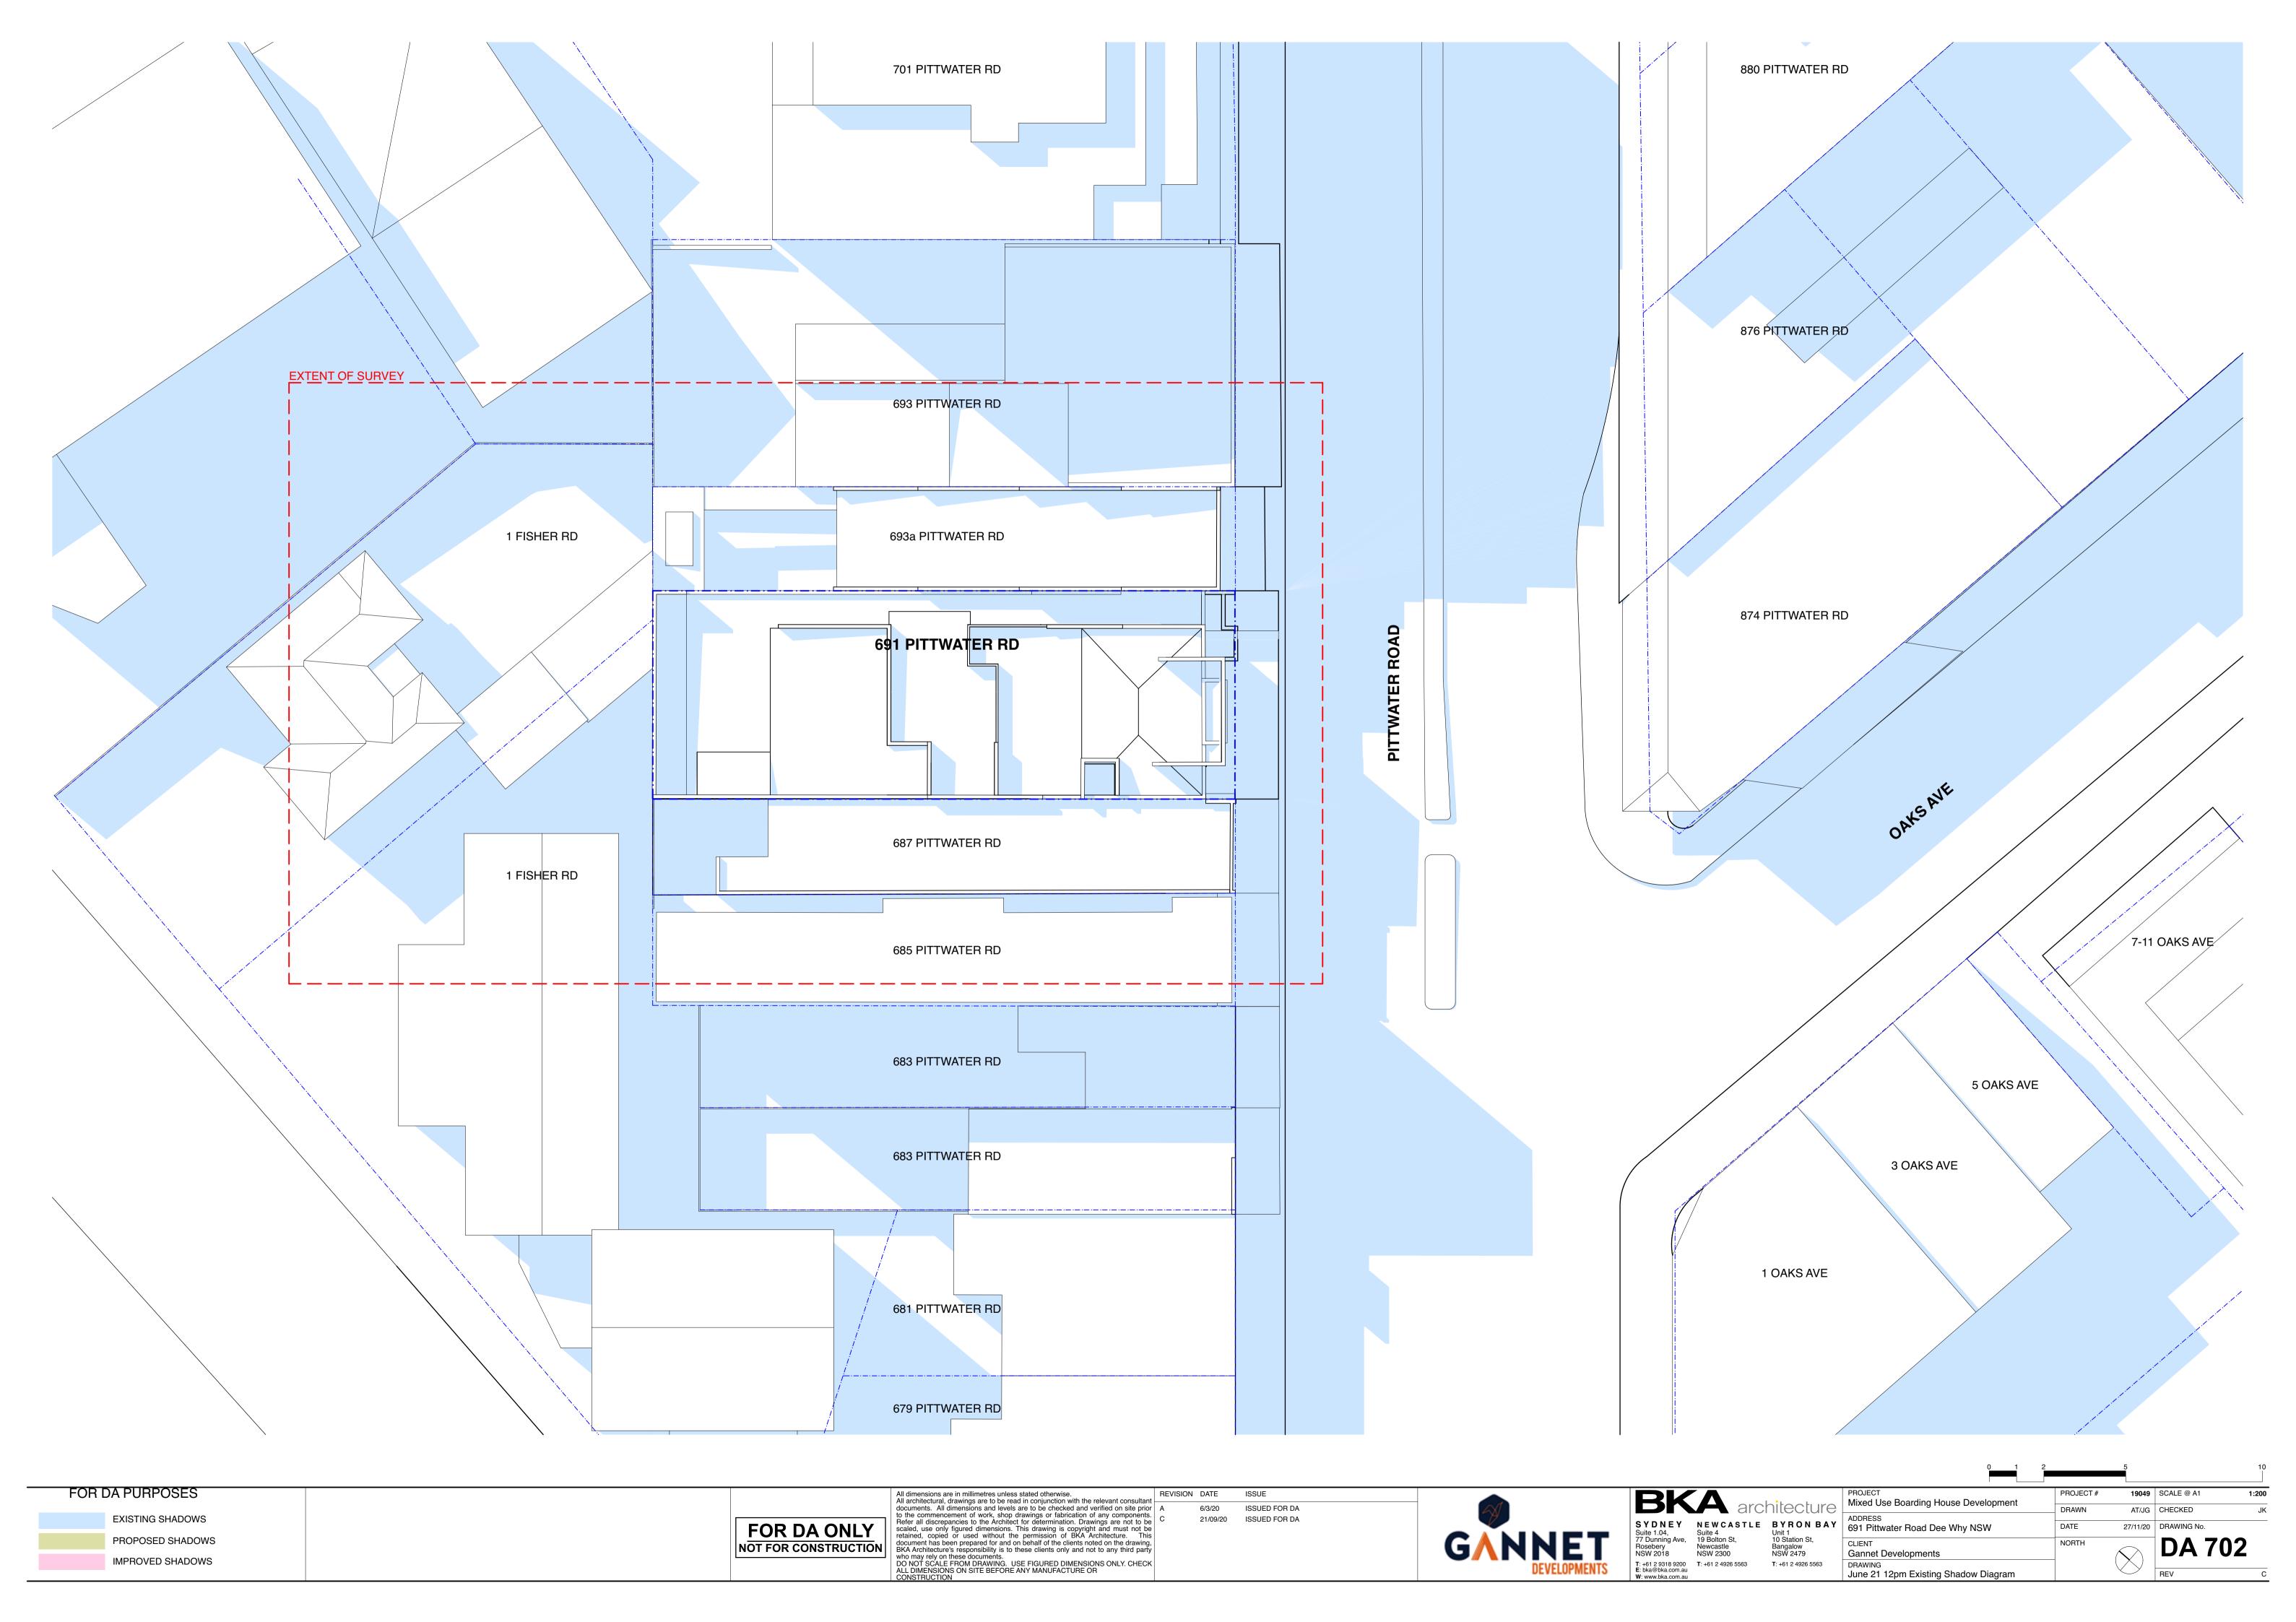


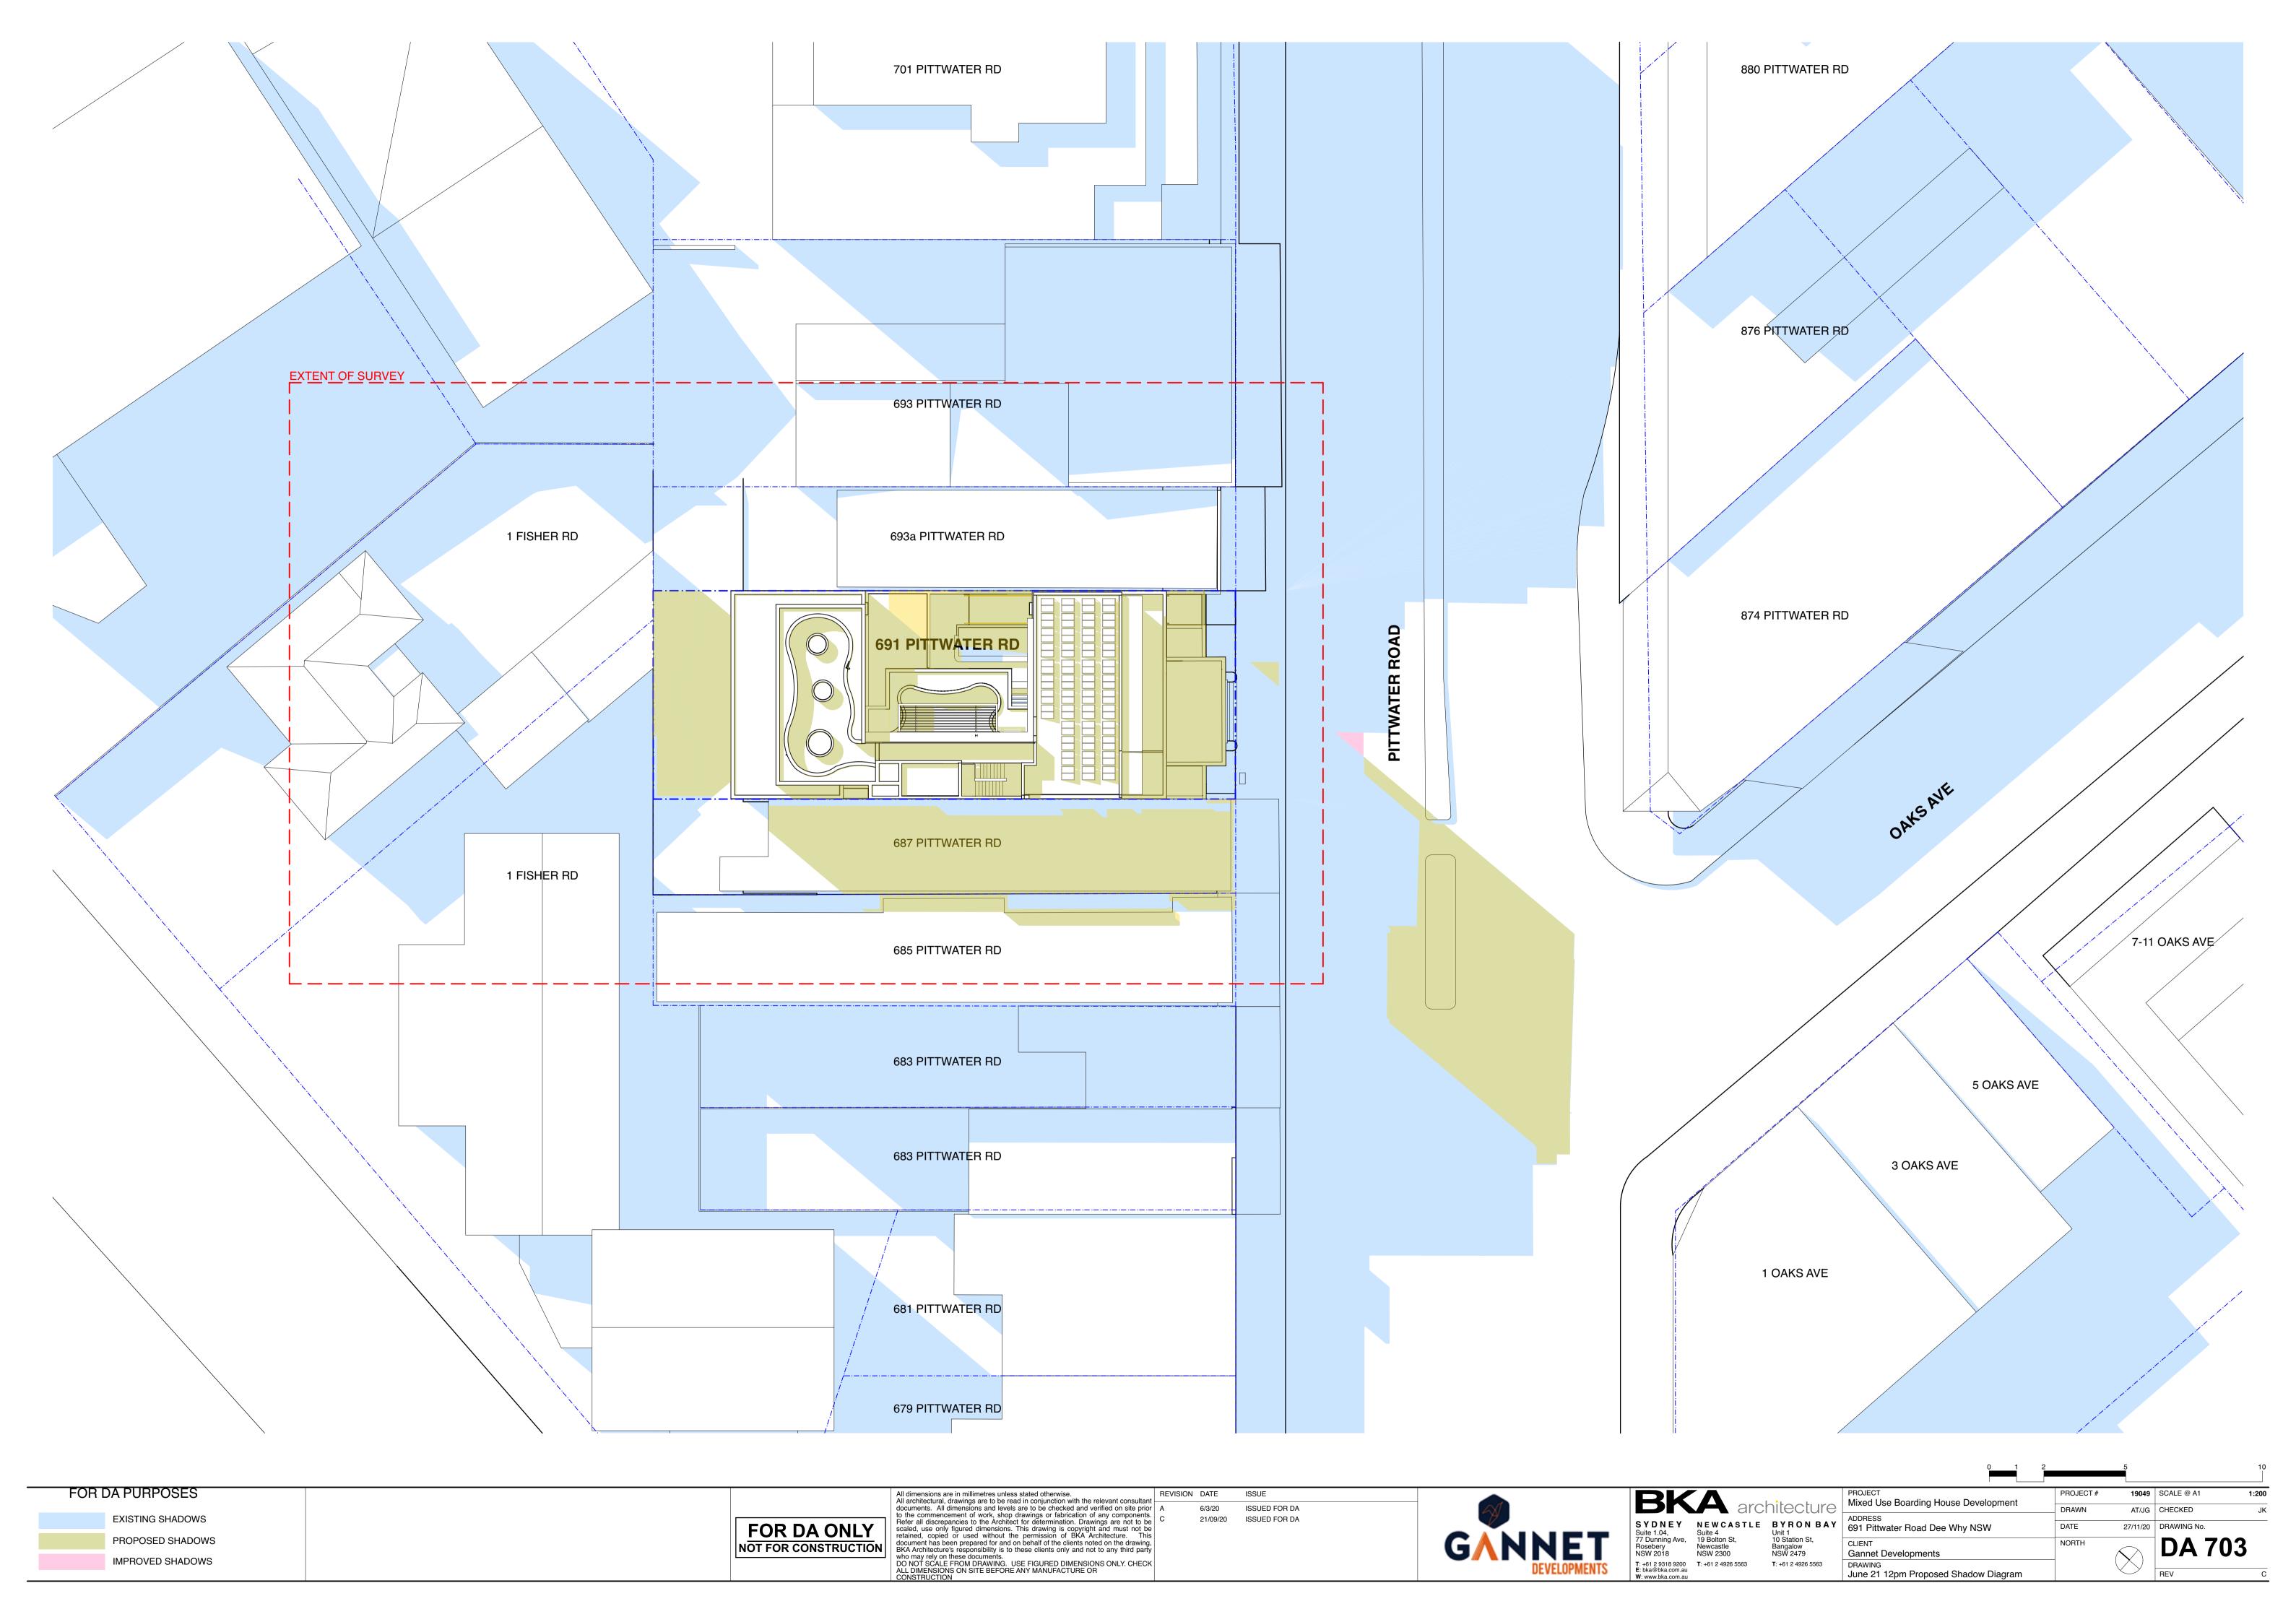


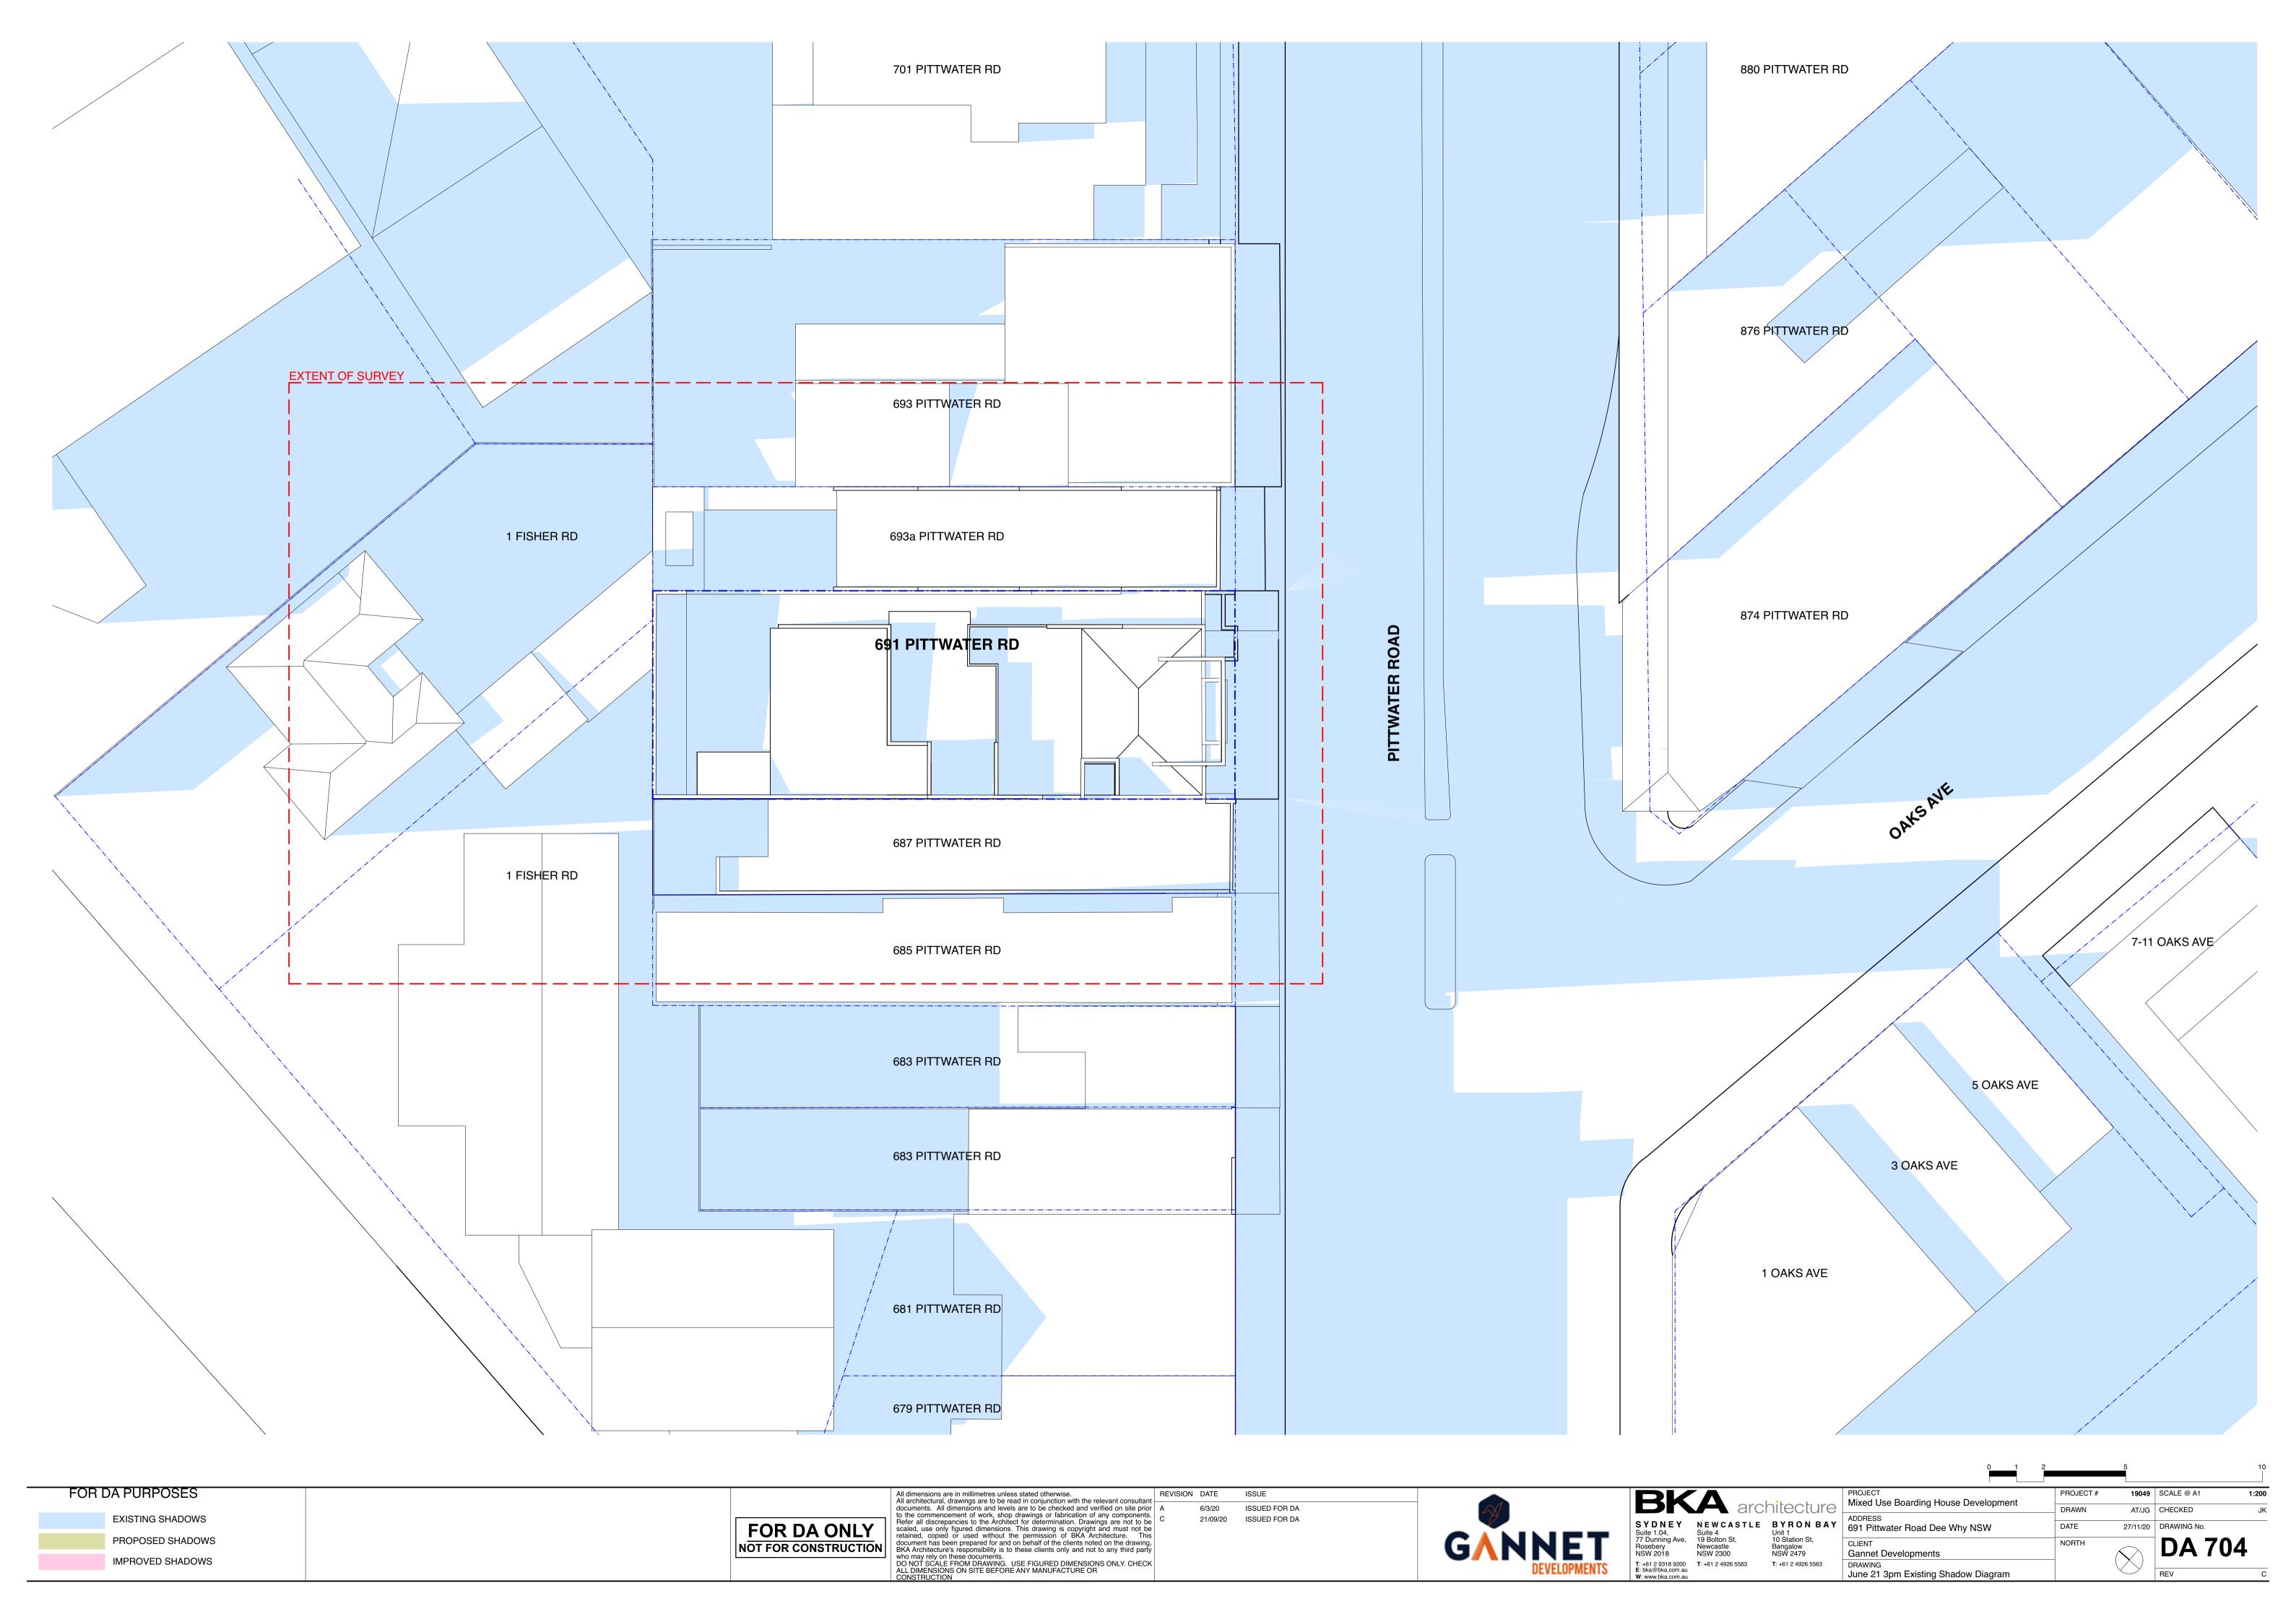


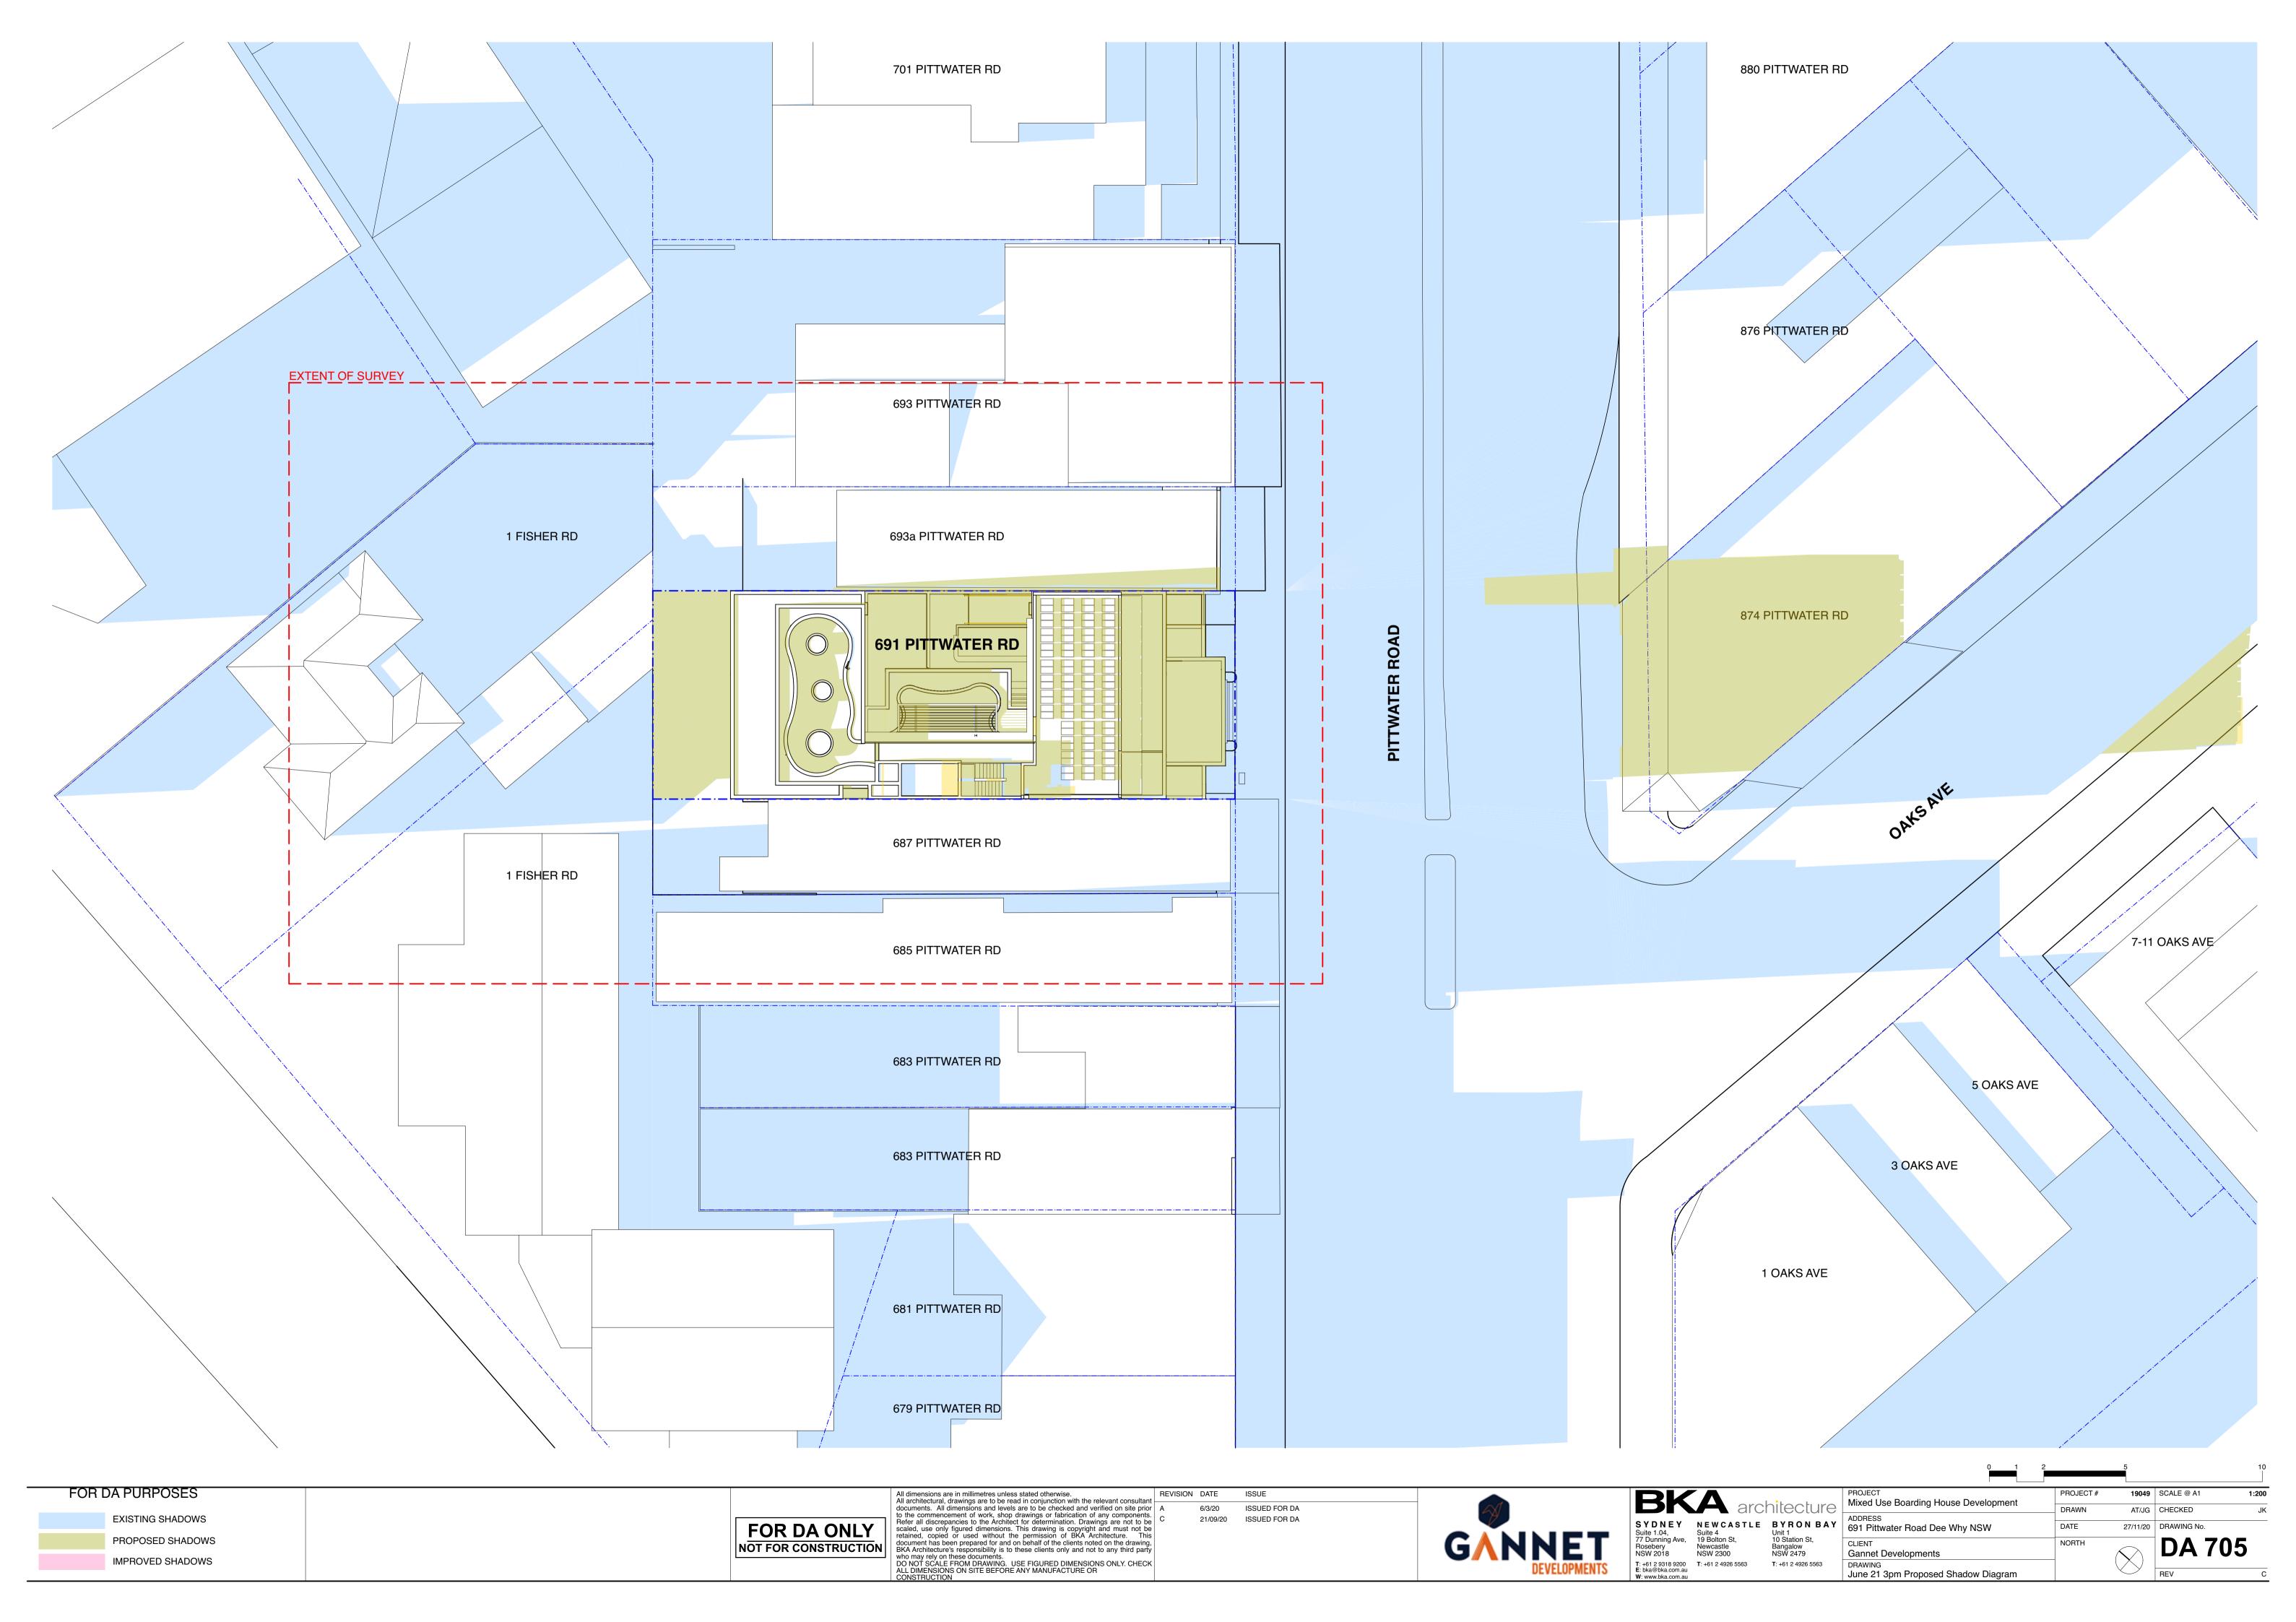

COMMUNAL LIVING ROOM AND COMMUNAL OPEN SPACE EYE OF THE SUN - SOLAR ANALYSIS

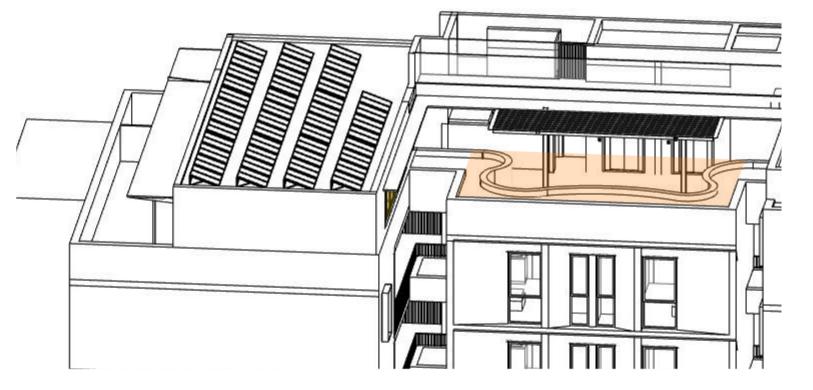

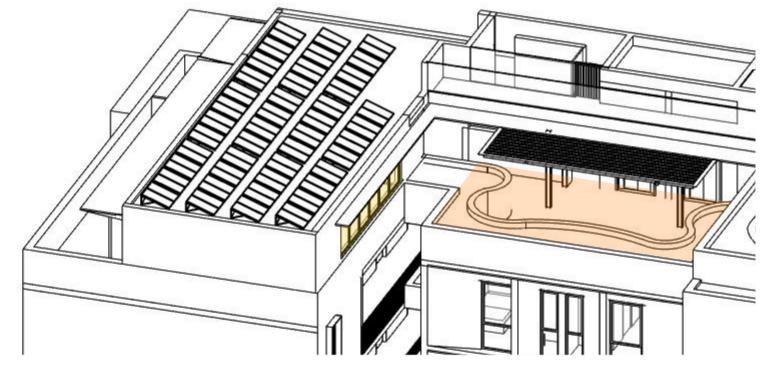


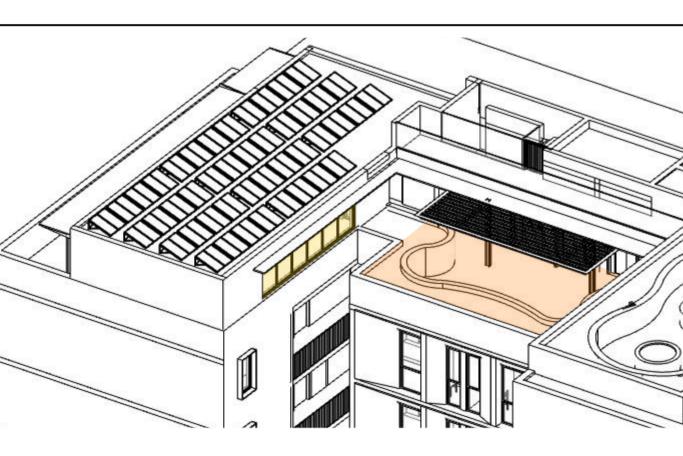


Axonometric - 9am June 21


Axonometric - 10am June 21

Axonometric - 11am June 21

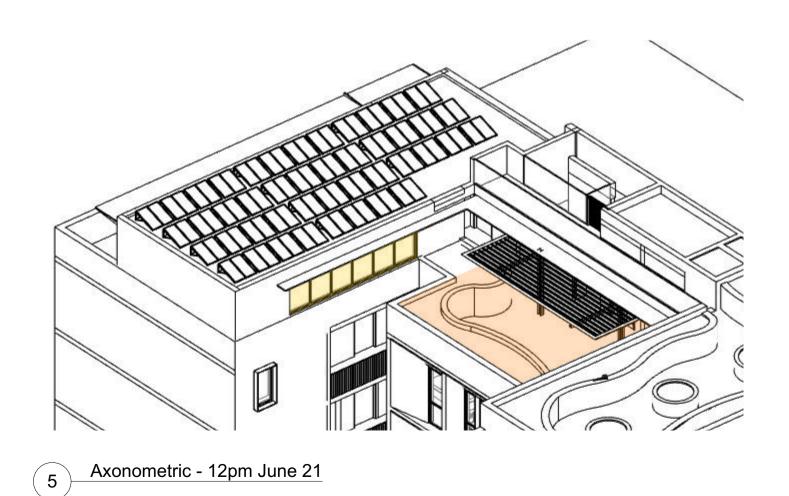

6 Axonometric - 1pm June 21

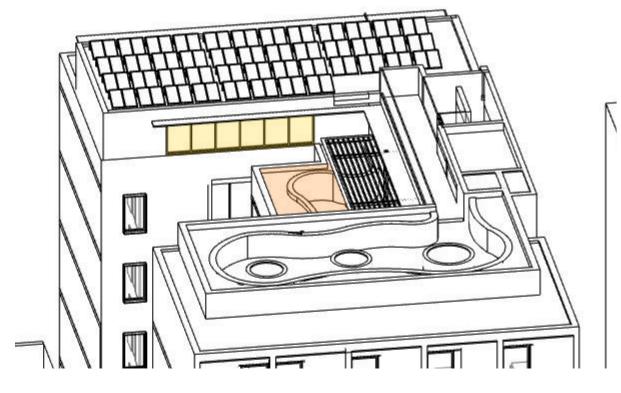

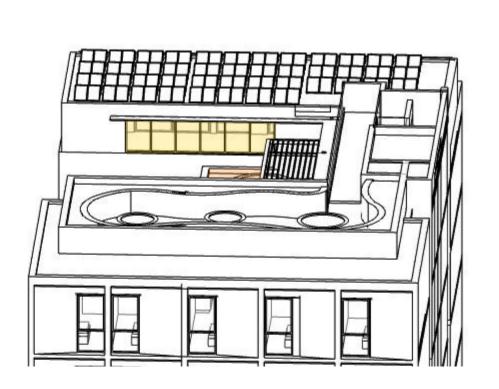

Axonometric - 2pm June 21

ISSUED FOR DA ISSUED FOR DA Axonometric - 3pm June 21


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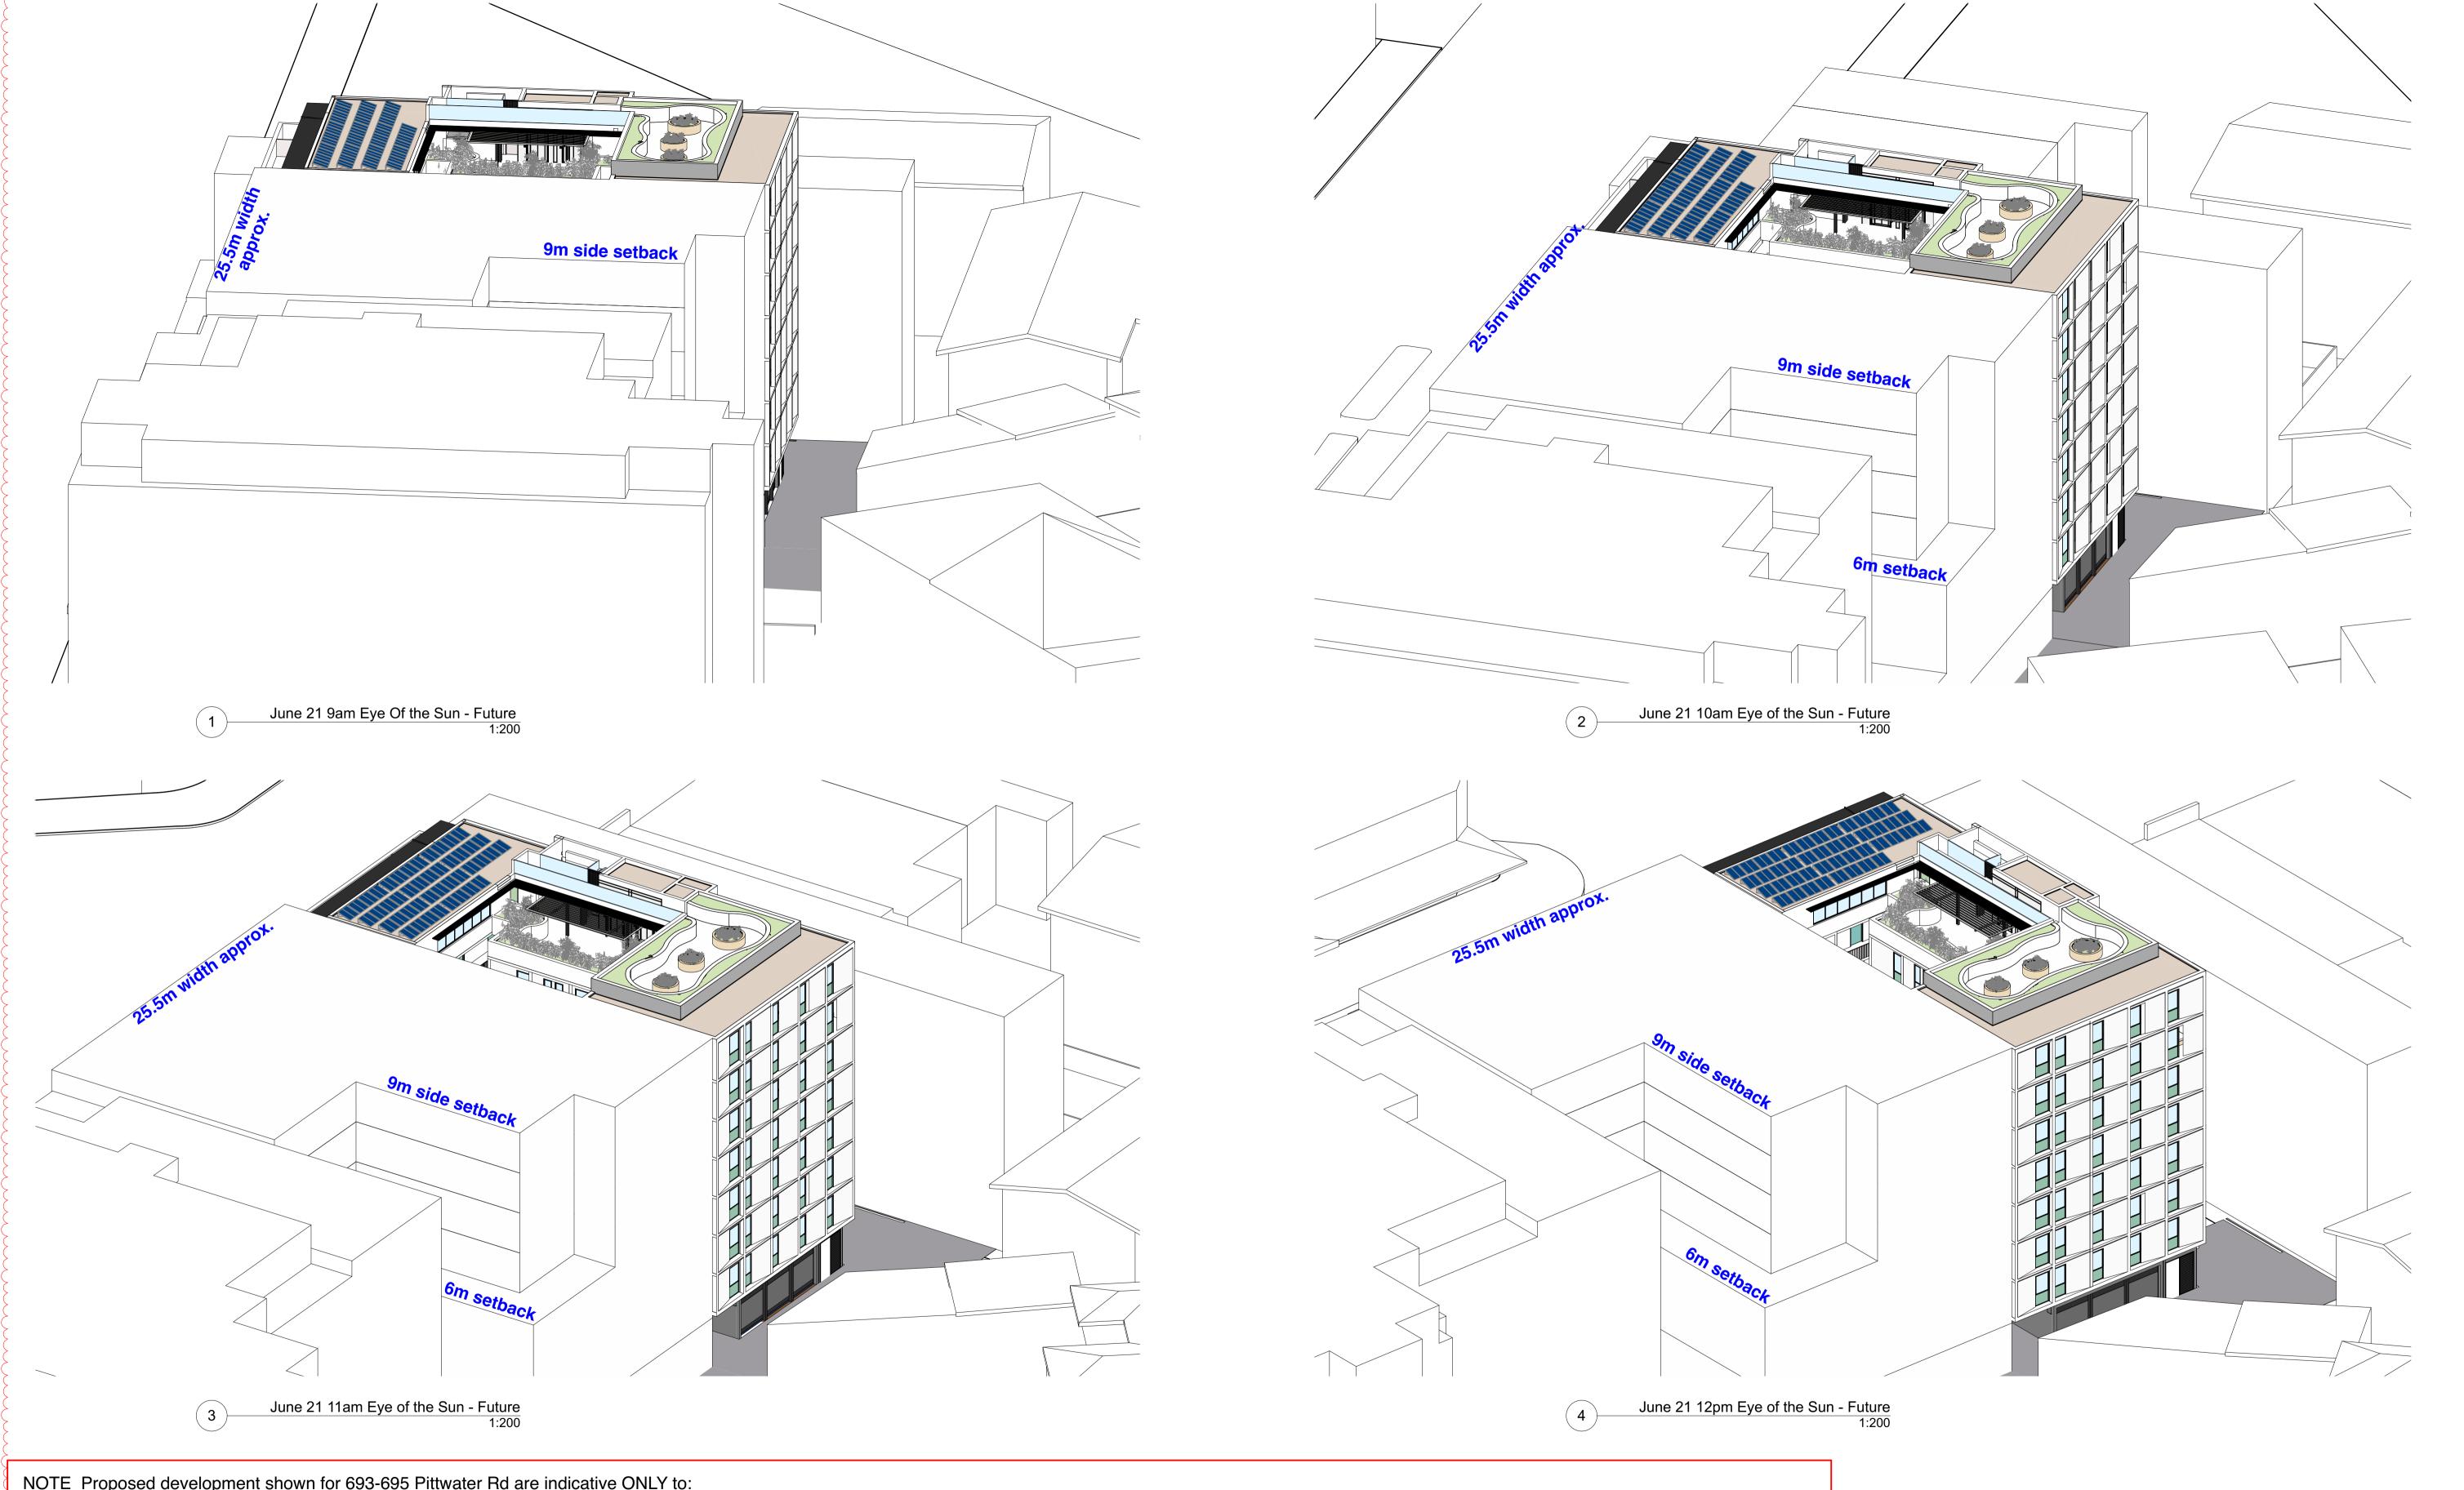
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| PROJECT Mixed Use Boarding House Development | PROJECT# | 19049    | SCALE @ A1    | 1:10 |
|--|----------|----------|---------------|------|
| winked use boarding house bevelopment        | DRAWN    | AT/JG    | CHECKED       | J    |
| ADDRESS<br>691 Pittwater Road Dee Why NSW    | DATE     | 27/11/20 | DRAWING No.   |      |
| CLIENT Gannet Developments                   | NORTH    |          | <b>DA 720</b> |      |
| DRAWING<br>Solar Analysis                    |          |          | REV           |      |





FOR DAPURPOSES

NOTE Proposed development shown for 693-695 Pittwater Rd are indicative ONLY to:
a. Demonstrate that even if future development for 693-695 Pittwater Rd constructs a blind wall towards the southern boundary, Solar Access to Communal Open Space and Communal Room is ensured for at least 3 hours between 9am and 3pm on Winter Solstice complying with AHSEPP Requirements;
b. If to be applied, Apartment Design Guidelines Figures 3F.2 and 3F.6 consider appropriate a 6m separation between a habitable room and a blank wall;
d. Eye of the Sun Diagrams show it is unlikely that future development at 693-695 Pittwater Rd will have habitable rooms towards the southern boundary due to site width (25.5m approx.), min. side setbacks and solar access requirements. Non-habitable rooms, if oriented towards southern boundary, will require between 3m and 4.5m side setbacks which would in any case improve amenity to 691 Pittwater Rd courtyard. Good design for 693-695 Pittwater Rd would take advantage of this courtyard for better amenity and cross ventilation.

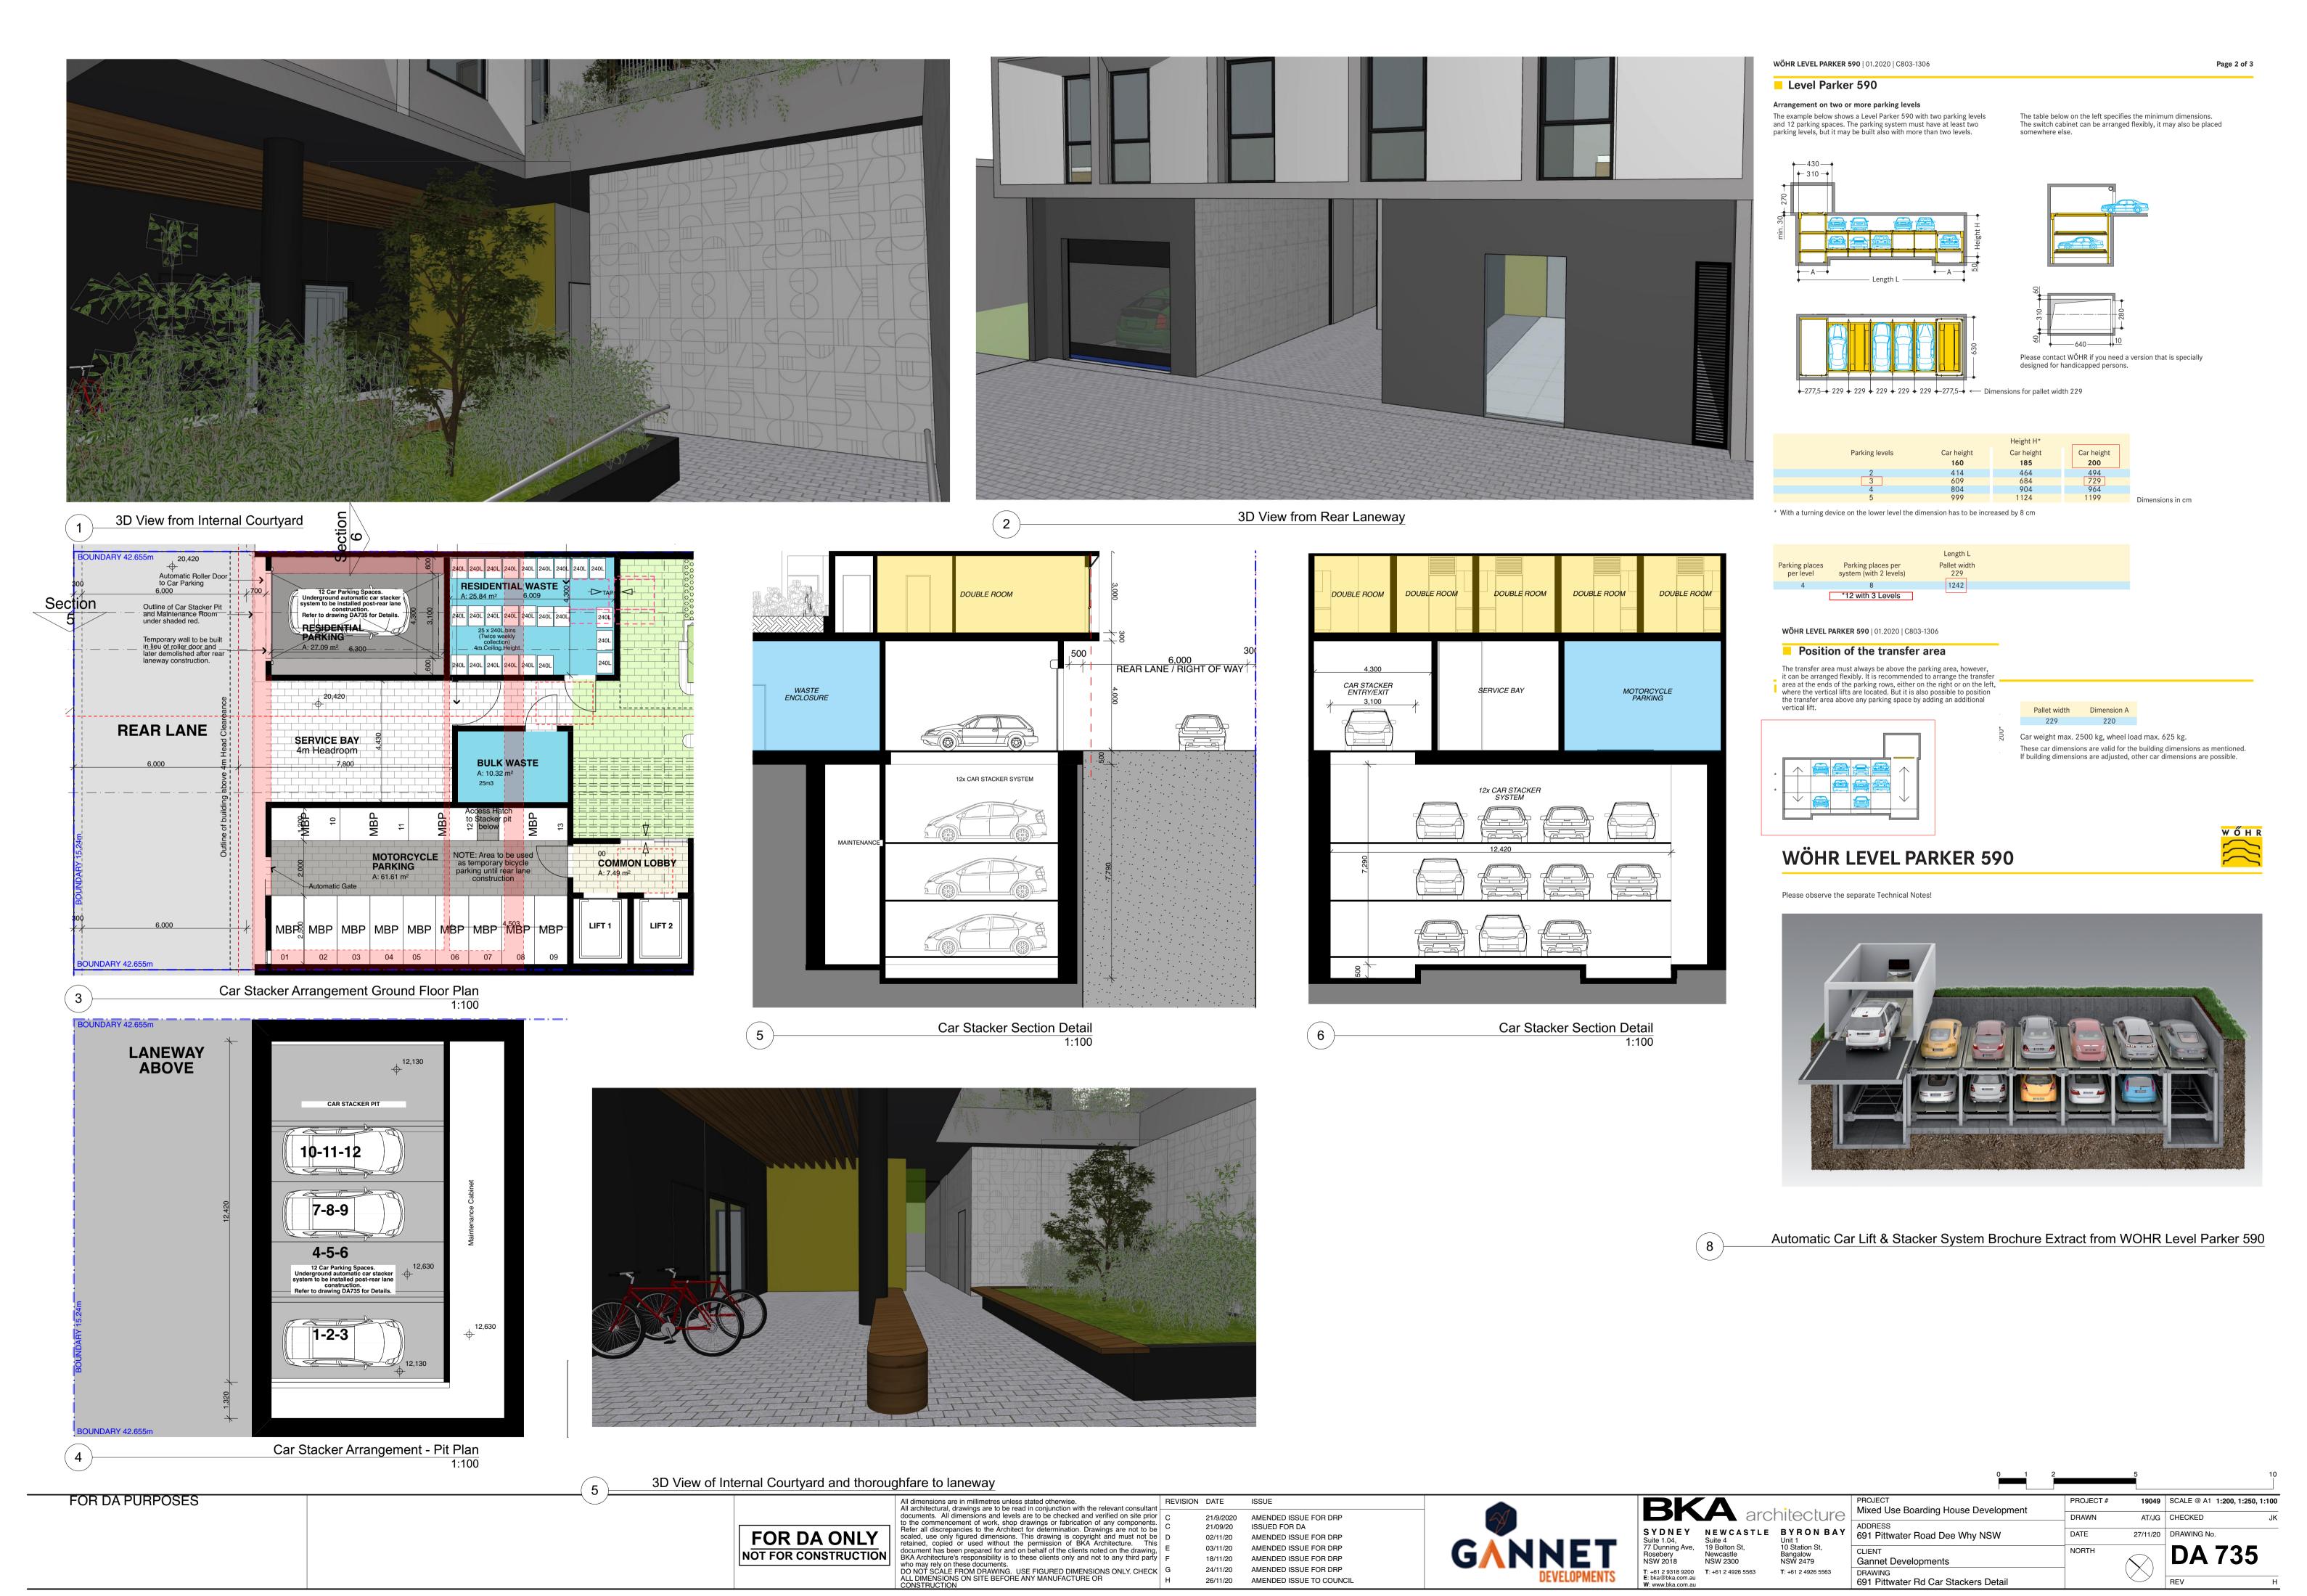NOTE development shown for 693-695 & 687 Pittwater Rd are not part of this DA

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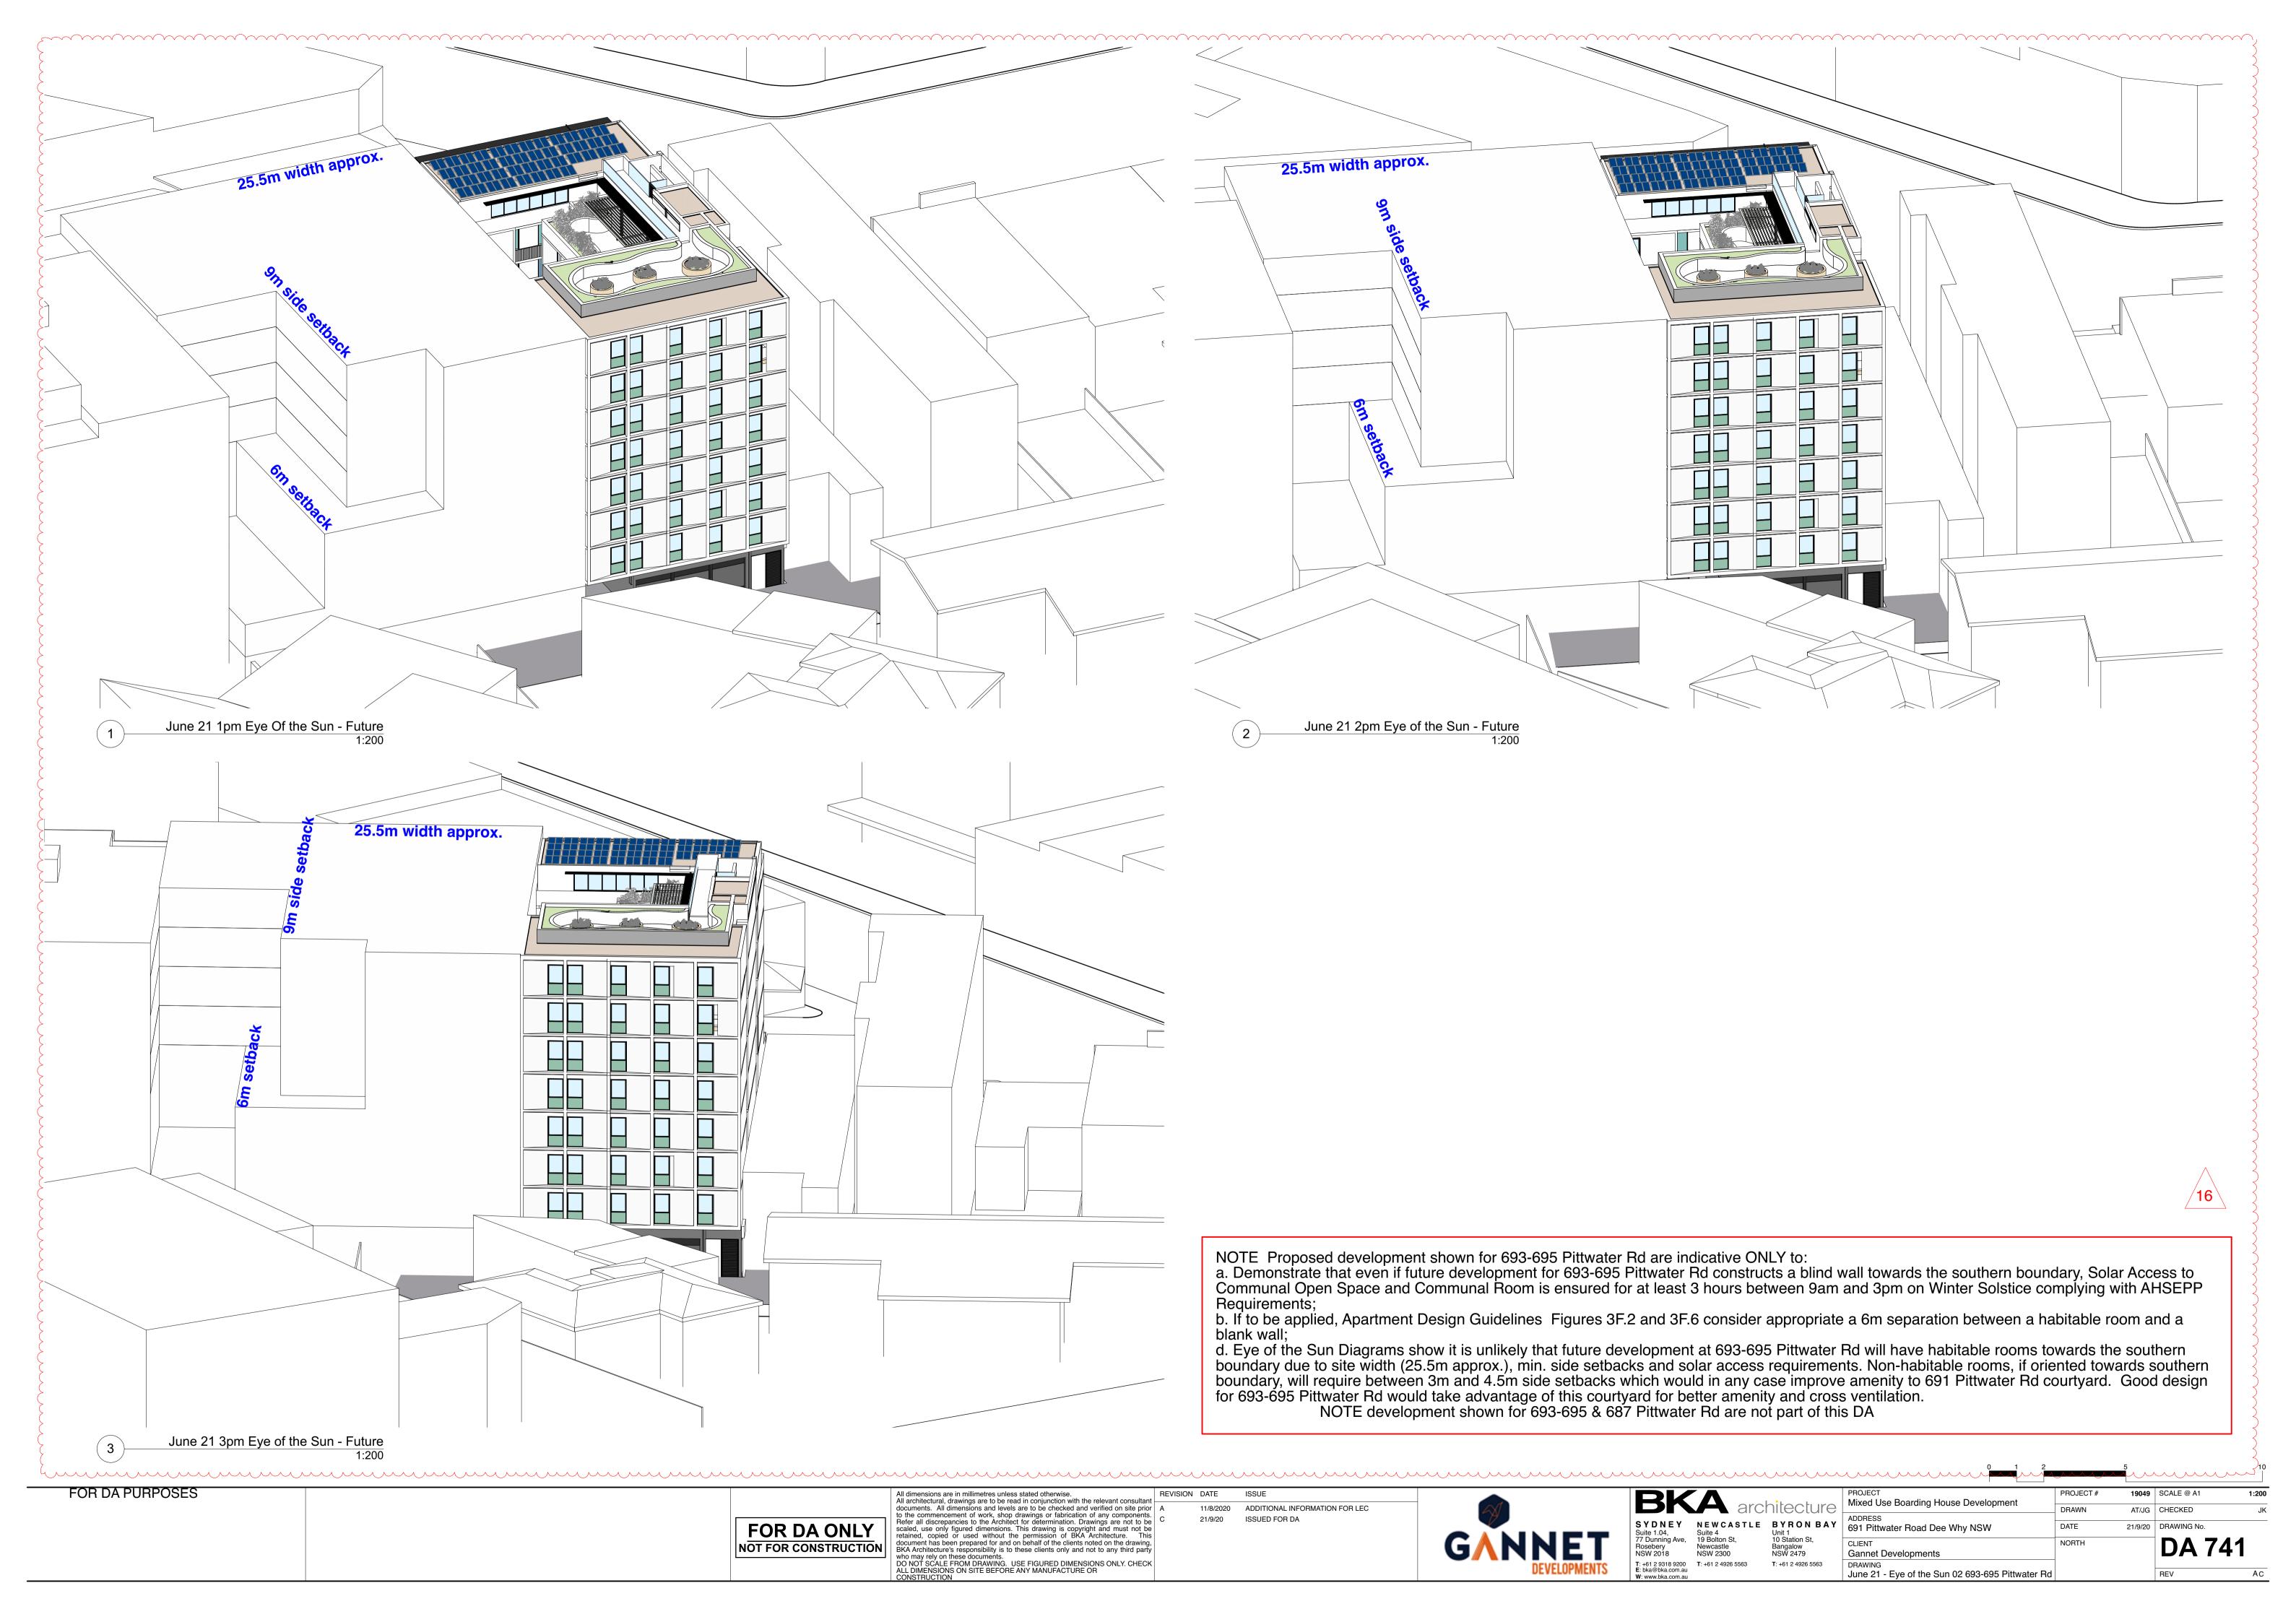
ADDITIONAL INFORMATION FOR LEC ISSUED FOR DA **GANNET** 

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Gannet Developments June 21 - Eye of the Sun 01 693-695 Pittwater Rd

PROJECT

Mixed Use Boarding House Development AT/JG CHECKED ADDRESS 691 Pittwater Road Dee Why NSW **DA 740** 



#### DA Calculations

Project Number: 19049

**Existing Car Parking Requirements.** 

Existing car parking provided

FOR DA PURPOSES

Project Address: 687 Pittwater Rd, Dee Why Date: August 2020

| GFA and FSR Controls | Control LEP | Proposed | Compliance |
|----------------------|-------------|----------|------------|
|                      |             |          |            |
| Site Area (sqm):     | 297.75      |          |            |
|                      |             |          |            |
| FSR:                 | 4:1         | 3.5      |            |
| Max GFA (sqm):       | 1191        | 1028.61  | V          |

| GFA (sqm)    |         |
|--------------|---------|
| Level        | m2      |
|              |         |
| Ground Floor | 35.89   |
| Level 1      | 196.51  |
| Level 2      | 196.68  |
| Level 3      | 138.13  |
| Level 4      | 132.82  |
| Level 5      | 124.40  |
| Level 6      | 133.05  |
| Level 7      | 71.13   |
| Total GFA:   | 1028.61 |

| Parking Controls  Control    | Required DCP  | Proposed            | Compliance | 1              |
|------------------------------|---|---------------------|------------|----------------|
| Car Parking Apartments       | $0.6 \times 1 \text{ bed } \times 5 = 3.$                   | 6 Automatic         | _          | *Except visito |
|                              | 1.4 x 3bed x 2 =<br>2.8 = TOTAL 5.8<br>1 Visitor/5= 2 Visit | Stacker in basement | *          |                |
| Car Parking Retail           | 1 / 16.4 sqm = 2.2<br>spaces                                | 0                   | ×          |                |
| Car Parking Offices          | 1 / 40sqm = 10<br>spaces                                    | 0                   | ×          |                |
| TOTAL Car Parking Required   | 20  | 6                   | ×          |                |
| Motorcycle Parking Provided: | -   | 0                   | N/A        |                |
| Bicycle Parking Provided:    | Apartments 1x8 = 8  |                     |            |                |
|                              | Office Employees<br>1/200m2 + Visitors<br>1/750 m2 = 1      | 12                  |            |                |
|                              | Retail 1/200m2 +<br>Visitors 1/600m2 =<br>1                 |                     |            |                |

Required DCP


(297.75m2 Retail -

297.75 m2 Office)

26 approx

Compliance

Current

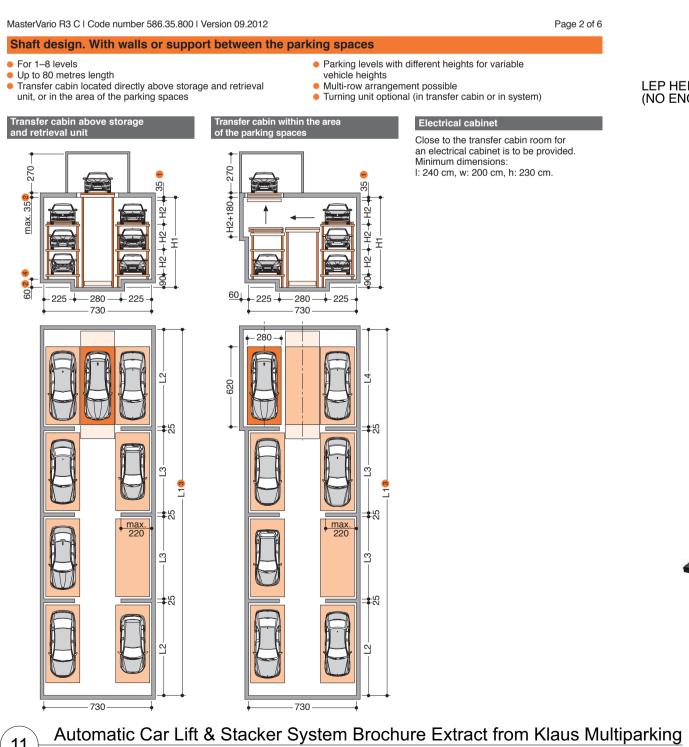

| Setback Controls DCP                          | Compliance |
|---|------------|
| Front Setback 5m from kerb first 3<br>Levels  | <b>~</b>   |
| Front Setback 9m from kerb above<br>4th Level | V          |
| Height Controls LEP                           |            |
| Current LEP Height Limit 27m                  | <b>V</b>   |

| Proposed Dwelling Mix |             |           |  |
|-----------------------|-------------|-----------|--|
| Level                 | 1 Bedroom / | 3 Bedroom |  |
|                       | Area m2     | / Area m2 |  |
| Ground Floor          |             |           |  |
| Level 1               |             |           |  |
| Level 2               |             |           |  |
| Level 3               | 1/53m2      | 1 / 124m2 |  |
| Level 4               | 1/53m2      |           |  |
| Level 5               | 1/53m2      | 1/111m2   |  |
| Level 6               | 1/53m2      |           |  |
| Level 7               | 1/53m2      |           |  |
| Total Per Type:       | 5           | 2         |  |
| TOTAL APARTMENTS:     | 7           |           |  |

| Communal Open Space |                                |          |            |
|---------------------|--------------------------------|----------|------------|
| Level               | Required                       | Proposed | Compliance |
| Communal Open Space | 25% of Site<br>ADG =<br>74.5m2 | 74.5m2   | <b>~</b>   |

| Proposed Solar Access & Cross Ventilation                              | Required<br>ADG | Proposed | Compliance |
|--|-----------------|----------|------------|
| Solar Access: Min 2Hrs from 9am to 3pm Winter Solstice (21st June)     | 70% = 4.9       | 5        | V          |
| Cross Ventilation  | 60% = 4.2       | 7        | <b>✓</b>   |
| Solar Access: Min 2Hrs from 9am to 3pm Winter Solstice (21st June) POS | 70% = 4.9       | 5        | <b>~</b>   |

#### **LEGEND**


**COMMUNAL AREA** 






1 BED

RESIDENTIAL GFA

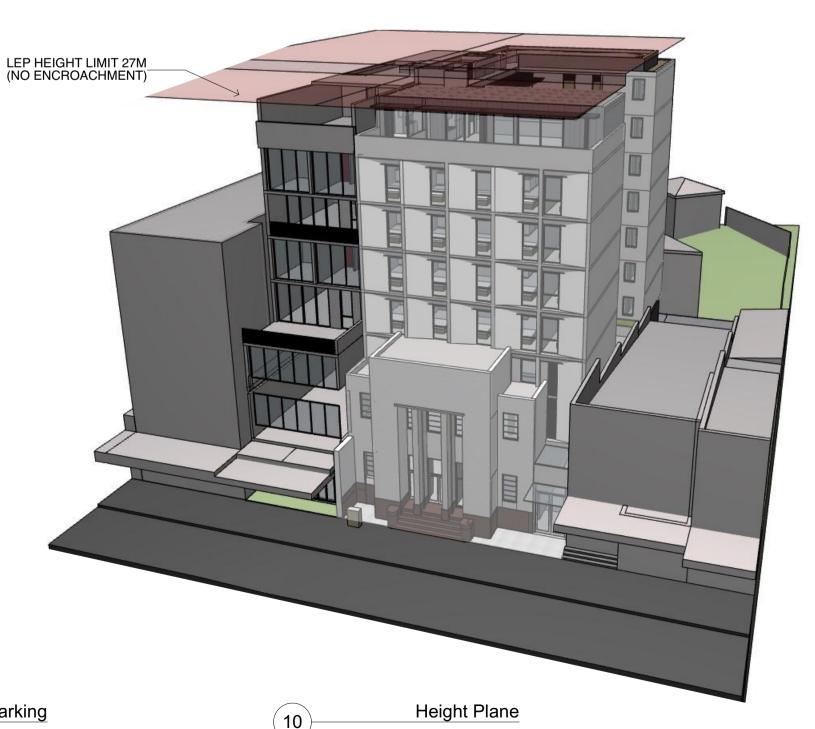

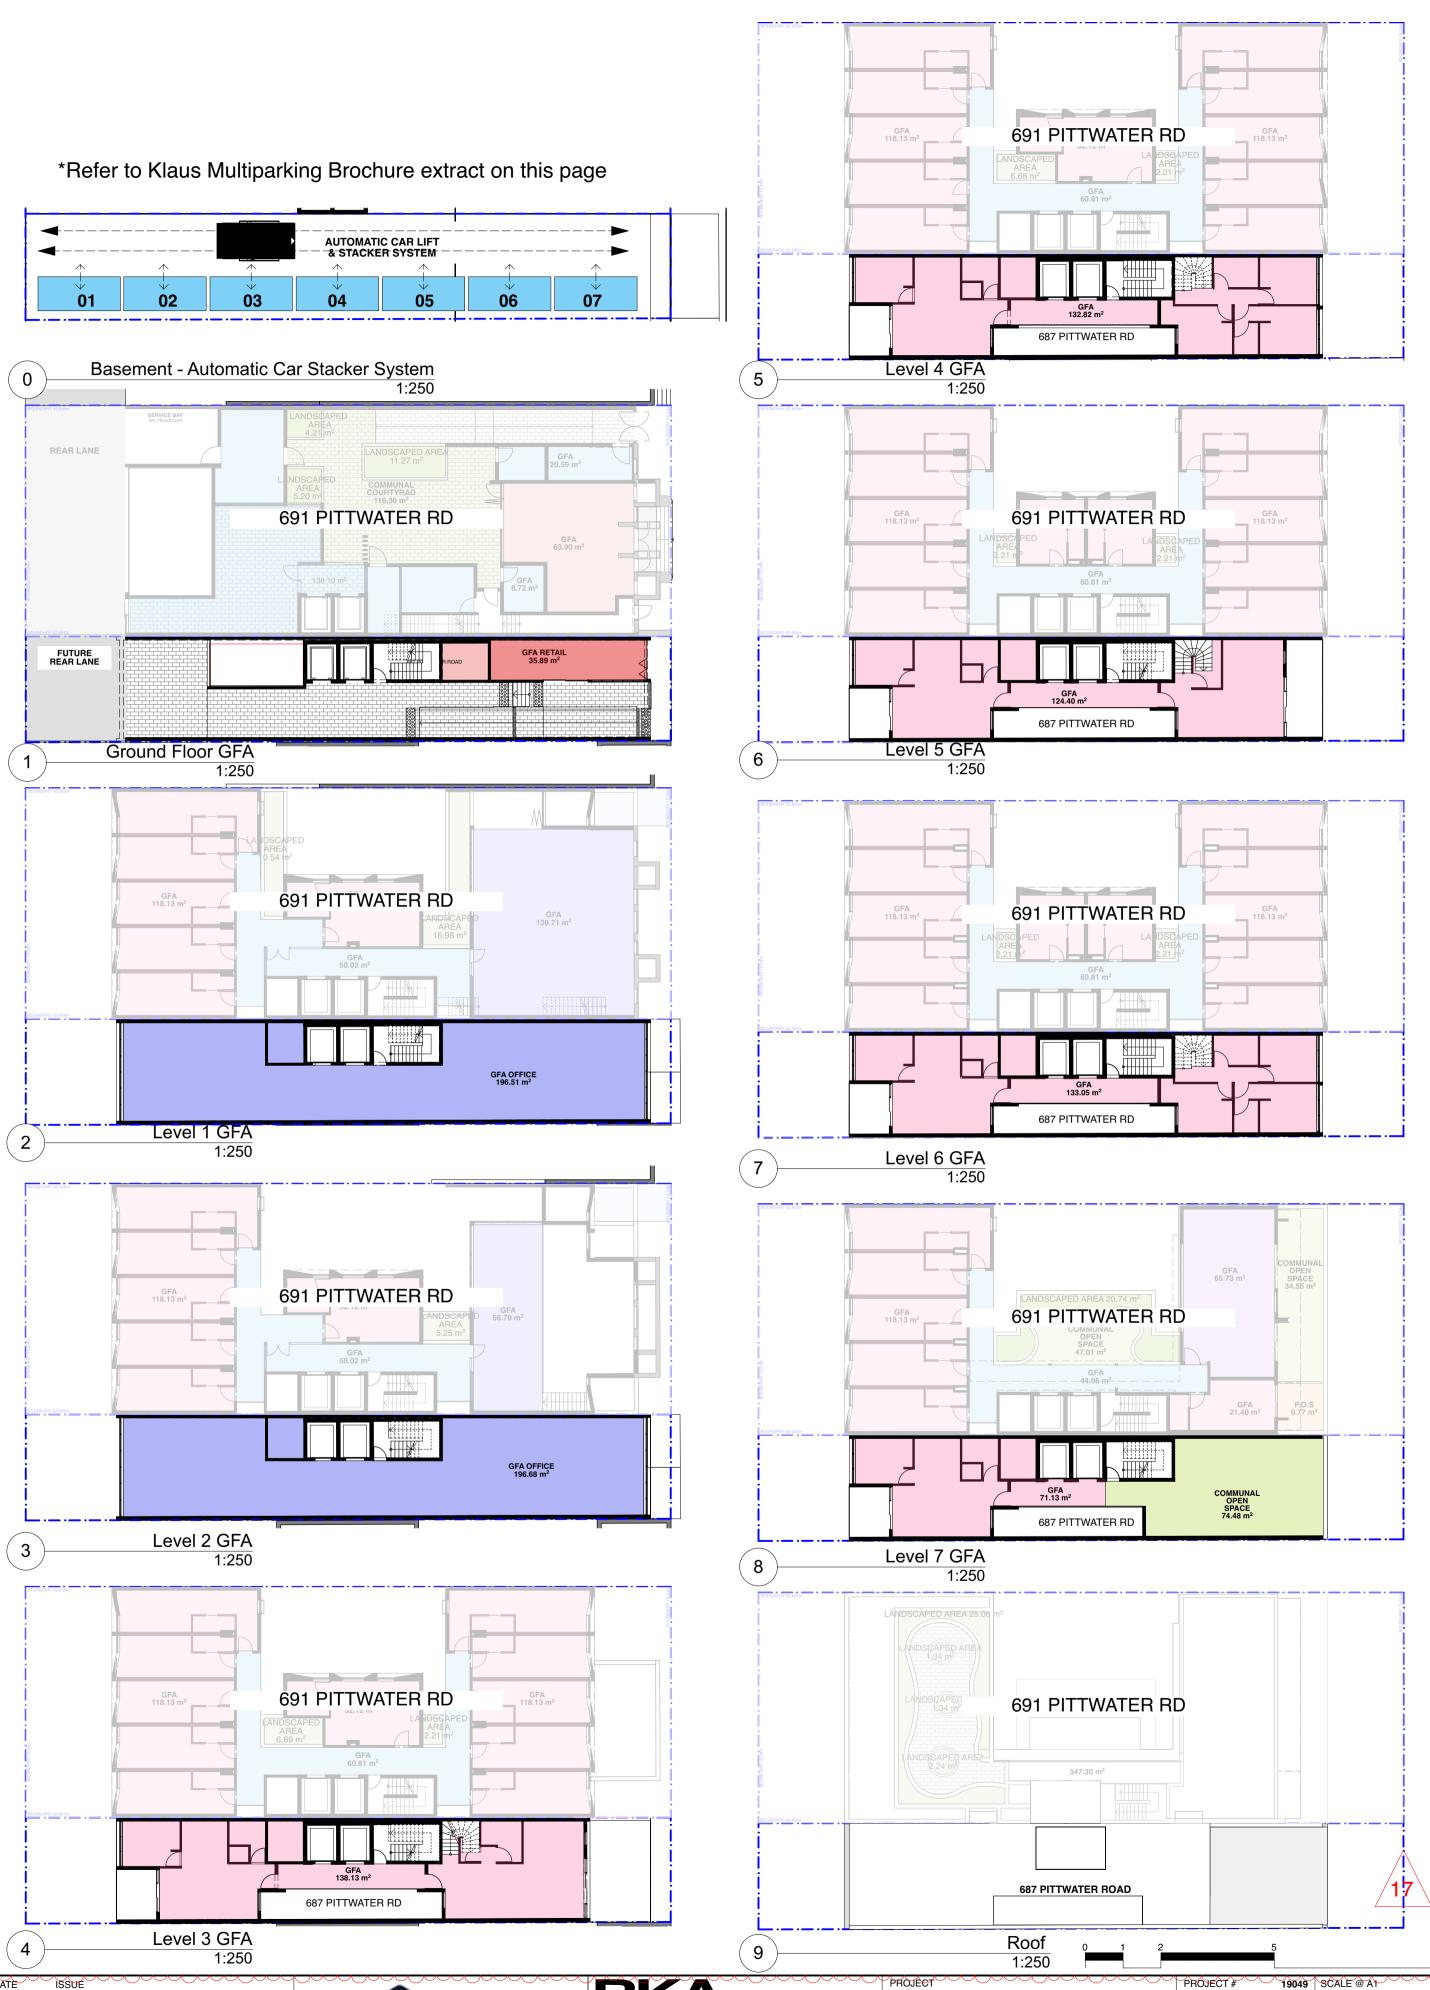

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25/8/20

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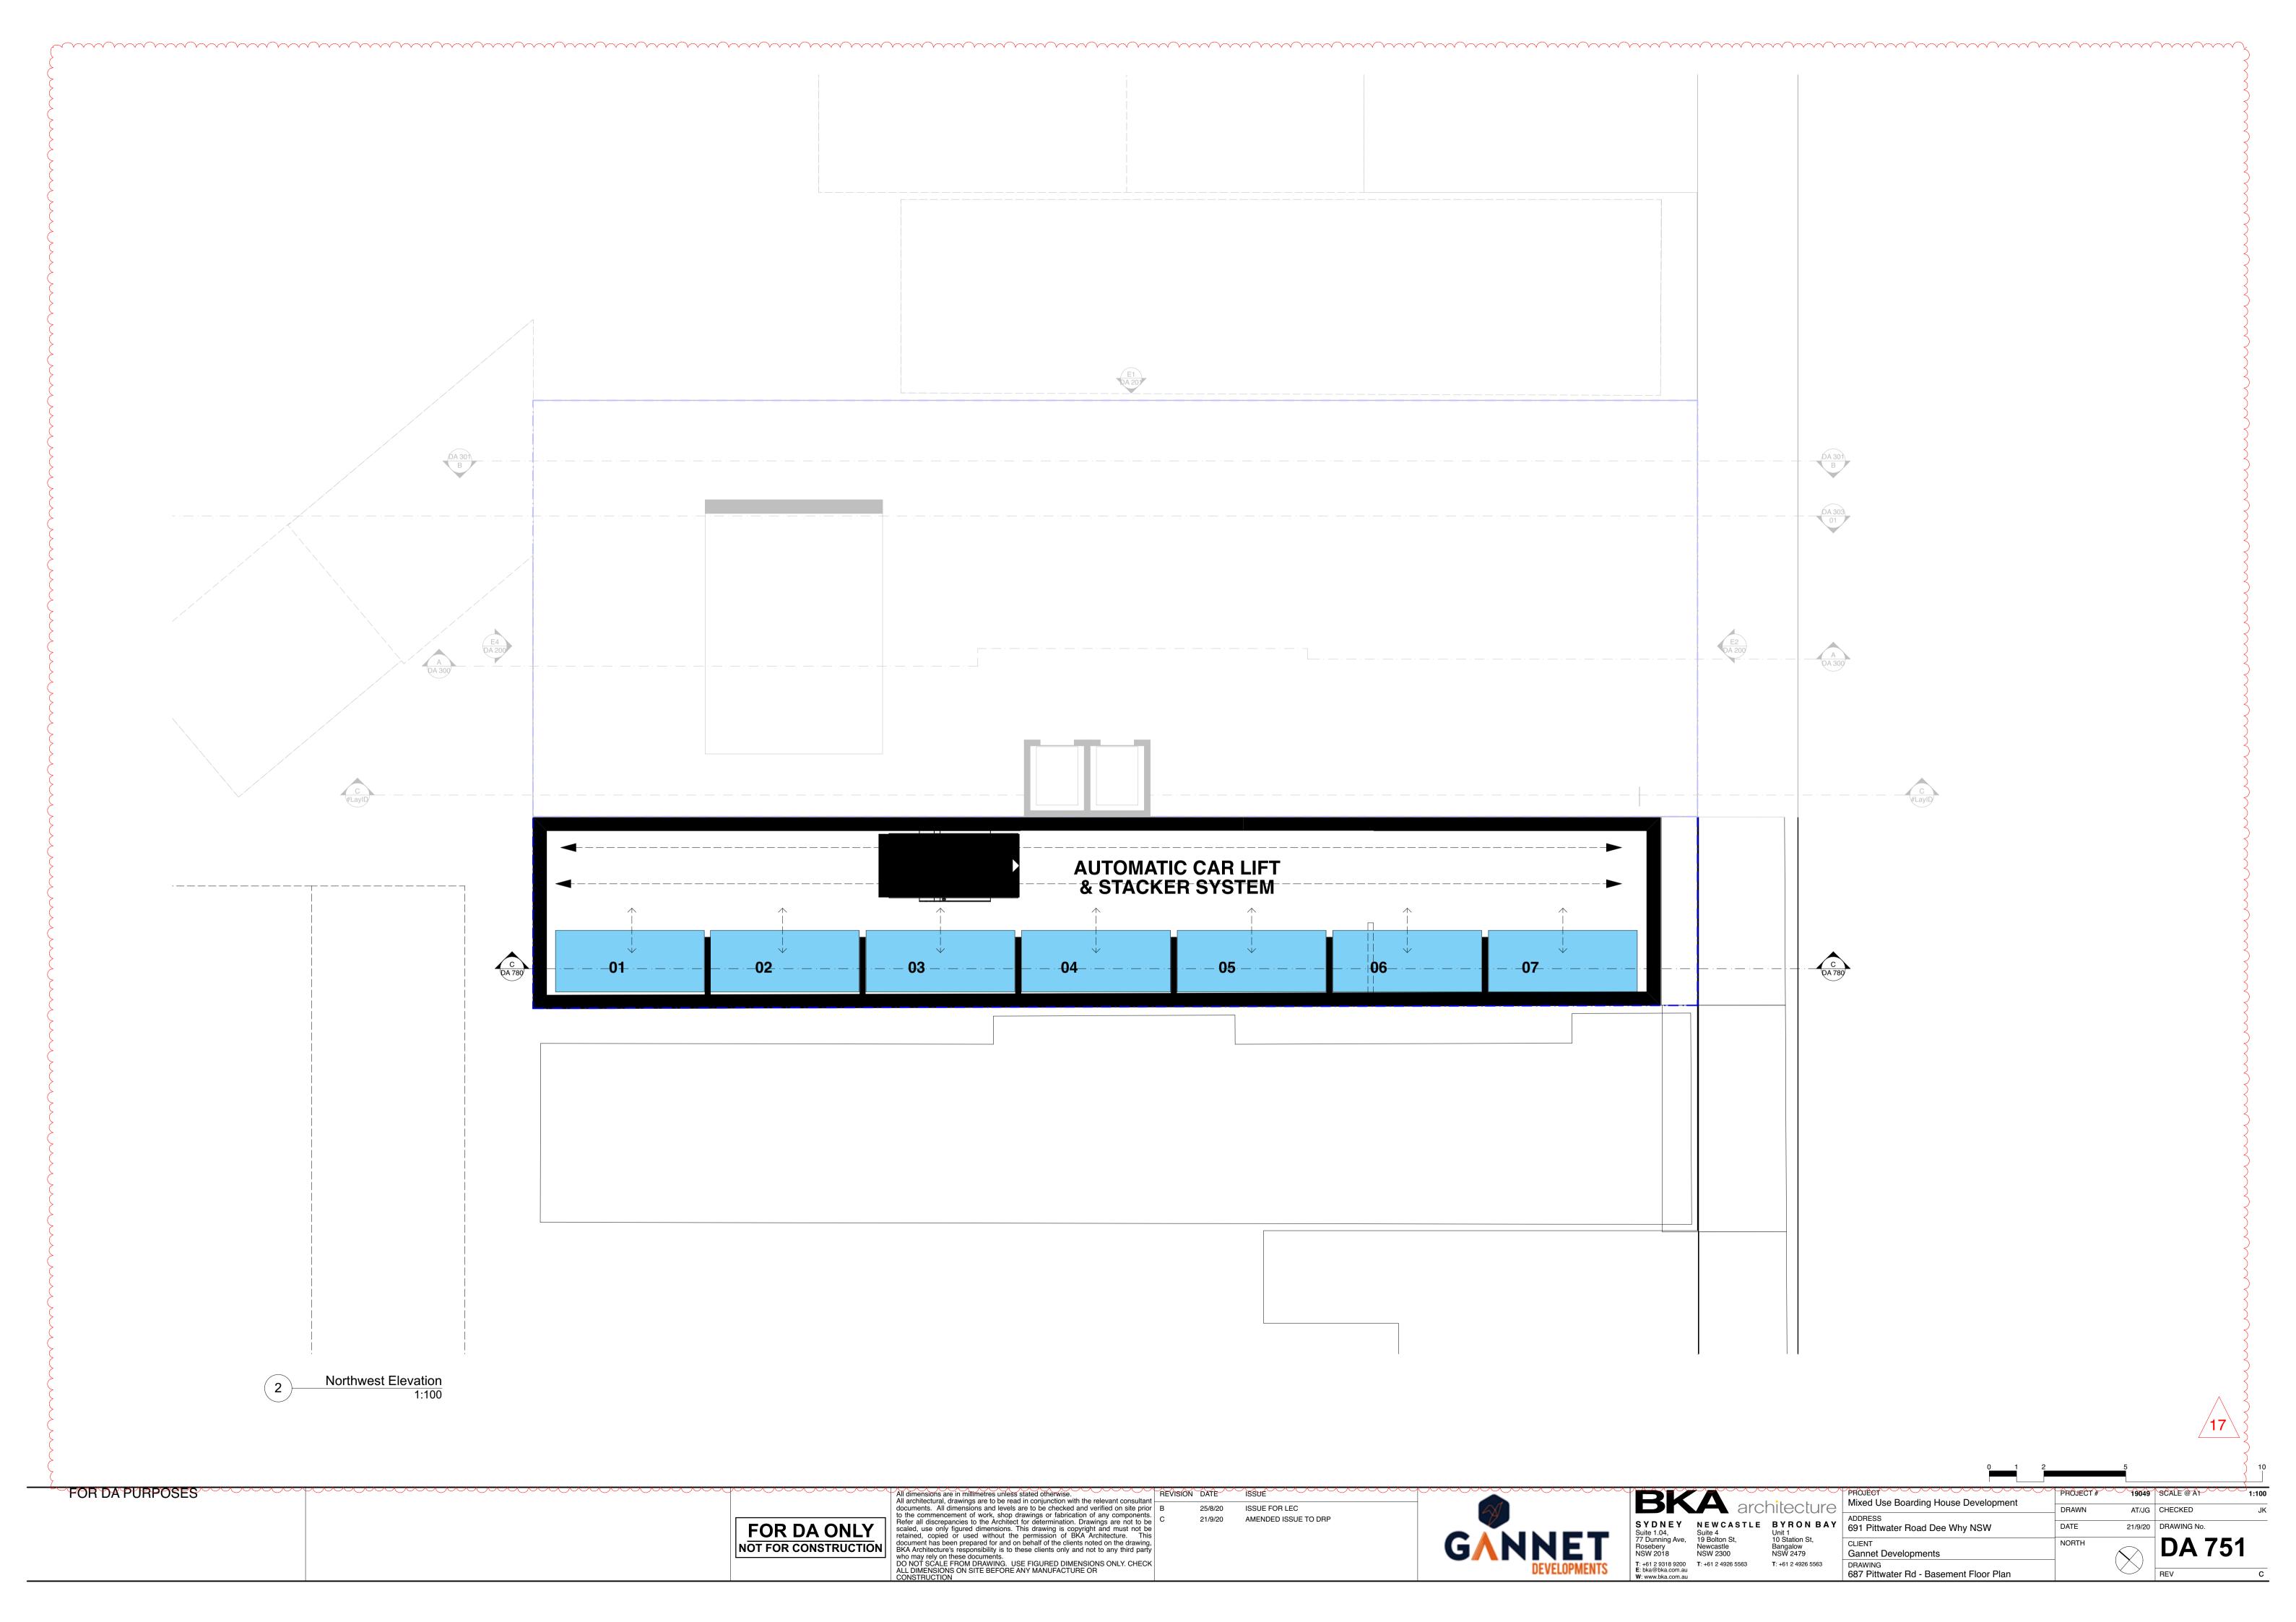
 
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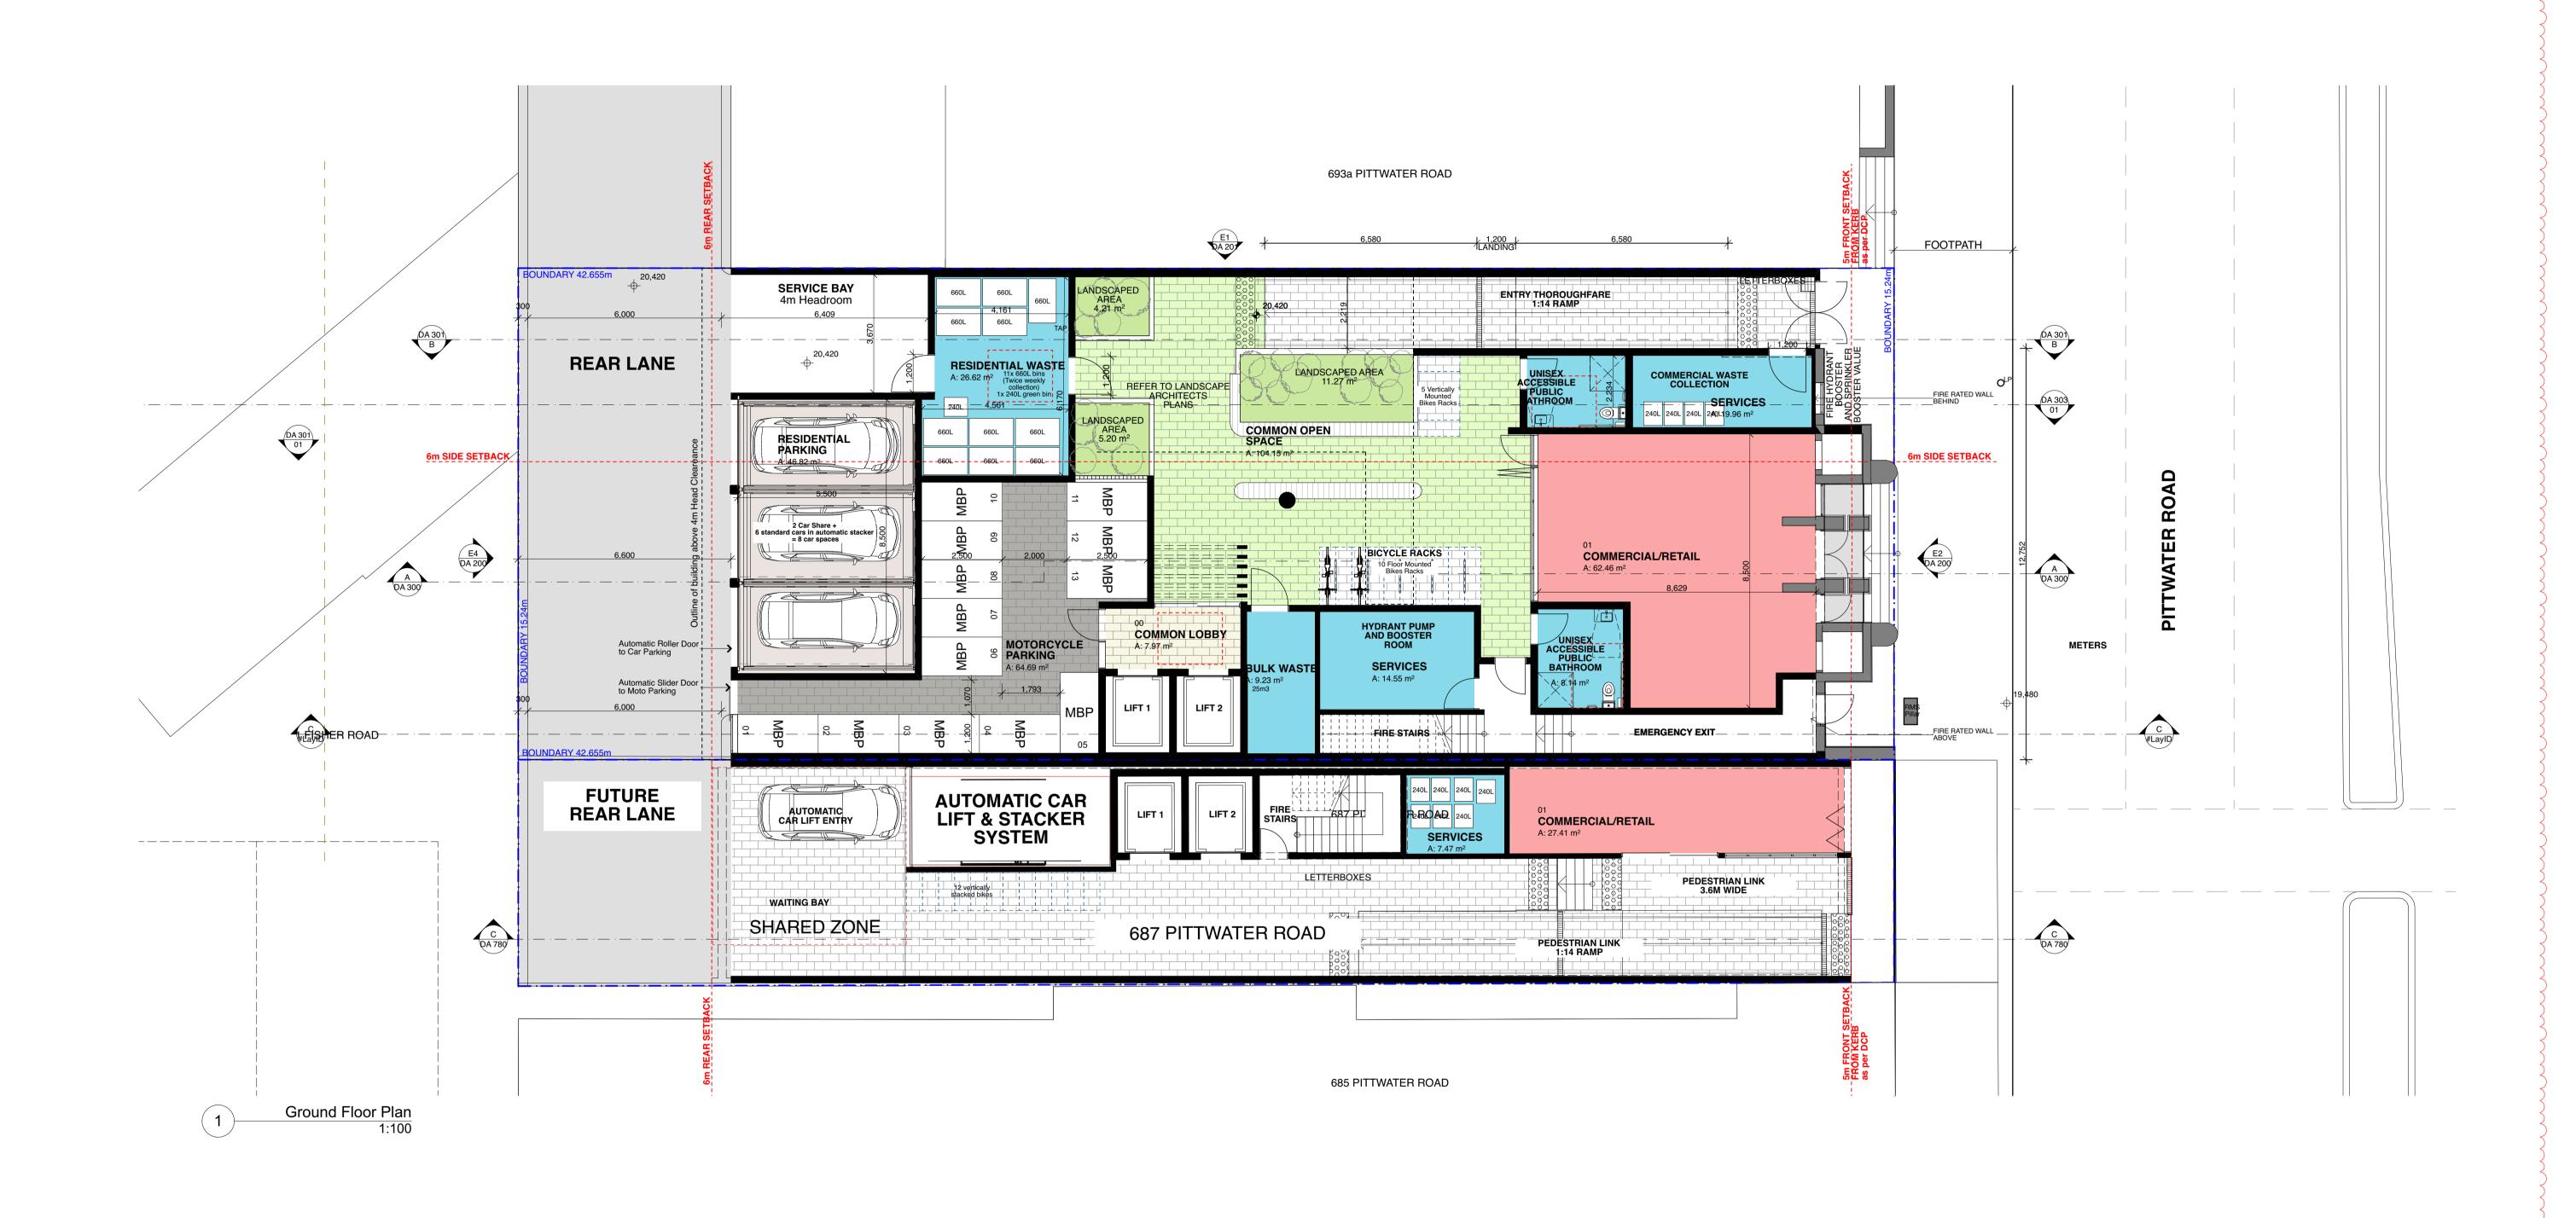
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ਸਿੰਹਾ੬ਿਵਾਂ Mixed Use Boarding House Development ADDRESS 691 Pittwater Road Dee Why NSW Gannet Developments 687 Pittwater Rd Feasibility Study

AT/JG CHECKED 21/9/20 DRAWING No.





25/8/20

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PROJECT # 19049 SCALE @ AT Mixed Use Boarding House Development

ADDRESS 691 Pittwater Road Dee Why NSW

CLIENT Gannet Developments


DRAWING 687 Pittwater Rd - Ground Floor Plan

PROJECT # 19049 SCALE @ AT DRAWING NO.

DRAWING NO.

DRAWING NO.

REV

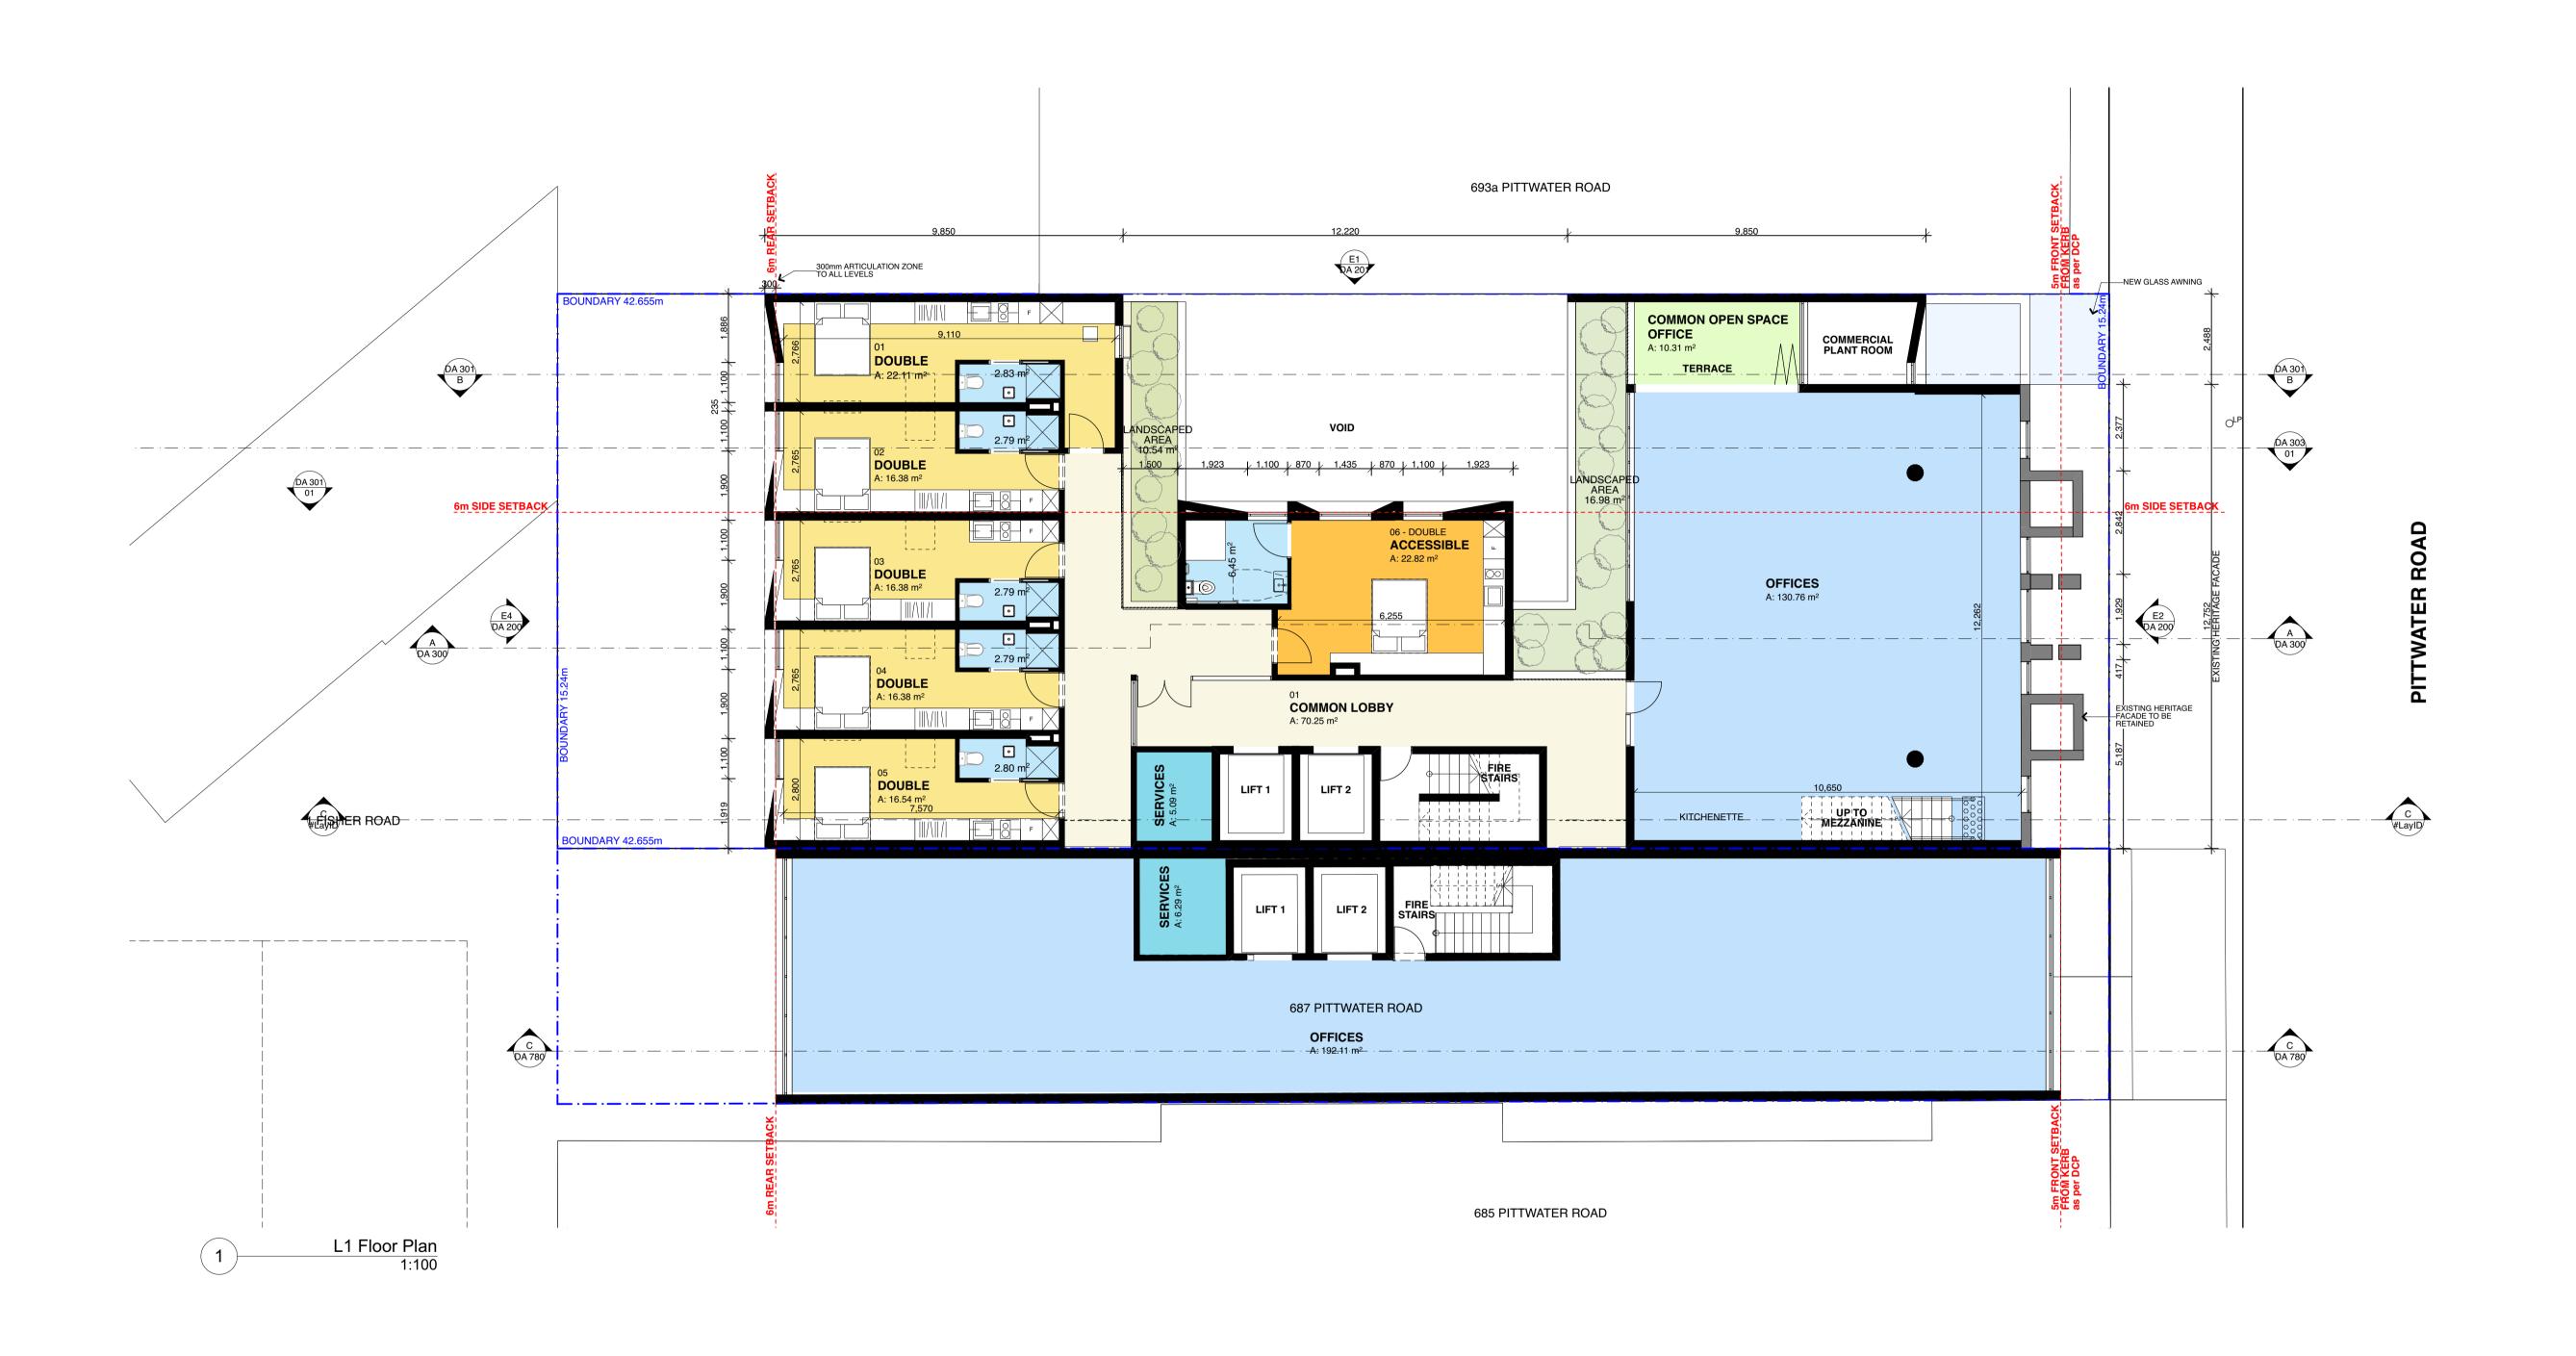

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19049 SCALE @ A1 Use Boarding House Development AT/JG CHECKED 21/9/20 DRAWING No. DATE Pittwater Road Dee Why NSW NORTH et Developments 687 Pittwater Rd - L1 Floor Plan



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19049 SCALE @ A1 Mixed Use Boarding House Development AT/JG CHECKED ADDRESS 691 Pittwater Road Dee Why NSW 21/9/20 DRAWING No. DATE CLIENT NORTH Gannet Developments DRAWING 687 Pittwater Rd - L2 Floor Plan



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19049 SCALE @ A1 Mixed Use Boarding House Development AT/JG CHECKED ADDRESS 691 Pittwater Road Dee Why NSW 21/9/20 DRAWING No. DATE CLIENT NORTH Gannet Developments DRAWING 687 Pittwater Rd - L3 Floor Plan



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10 Station St,
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NSW 2479 21/9/20 21/9/20 DRAWING No. **FOR DA ONLY** DATE GANNET CLIENT NORTH NOT FOR CONSTRUCTION Gannet Developments T: +61 2 9318 9200 T: +61 2 4926 5563 E: bka@bka.com.au T: +61 2 4926 5563 DRAWING 687 Pittwater Rd - L4 Floor Plan



17

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DO NOT SCALE FROM DRAWING. USE FIGURED DIMENSIONS ONLY. CHECK ALL DIMENSIONS ON SITE BEFORE ANY MANUFACTURE OR CONSTRUCTION FOR DAPURPOSES **BKA** architecture 19049 SCALE @ A1 Mixed Use Boarding House Development 25/8/20 ISSUE FOR LEC AT/JG CHECKED ADDRESS 691 Pittwater Road Dee Why NSW SYDNEY NEWCASTLE BYRON BAY
Suite 1.04, Suite 4
77 Dunning Ave, 19 Bolton St,
Rosebery Newcastle NSW 2300 NSW 2479

SYDNEY Unit 1
10 Station St,
Bangalow
NSW 2479 21/9/20 AMENDED ISSUE TO DRP 21/9/20 DRAWING No. **FOR DA ONLY** DATE GANNET CLIENT NORTH NOT FOR CONSTRUCTION Gannet Developments T: +61 2 9318 9200 T: +61 2 4926 5563 E: bka@bka.com.au T: +61 2 4926 5563 DRAWING 687 Pittwater Rd - L5 Floor Plan



**BKA** architecture SYDNEY NEWCASTLE BYRON BAY
Suite 1.04, Suite 4
77 Dunning Ave, 19 Bolton St,
Rosebery Newcastle NSW 2300 NSW 2479

SYDNEY Unit 1
10 Station St,
Bangalow
NSW 2479 T: +61 2 9318 9200 T: +61 2 4926 5563 E: bka@bka.com.au T: +61 2 4926 5563

Mixed Use Boarding House Development ADDRESS 691 Pittwater Road Dee Why NSW DATE CLIENT NORTH Gannet Developments DRAWING 687 Pittwater Rd - L6 Floor Plan

19049 SCALE @ A1 AT/JG CHECKED 21/9/20 DRAWING No.

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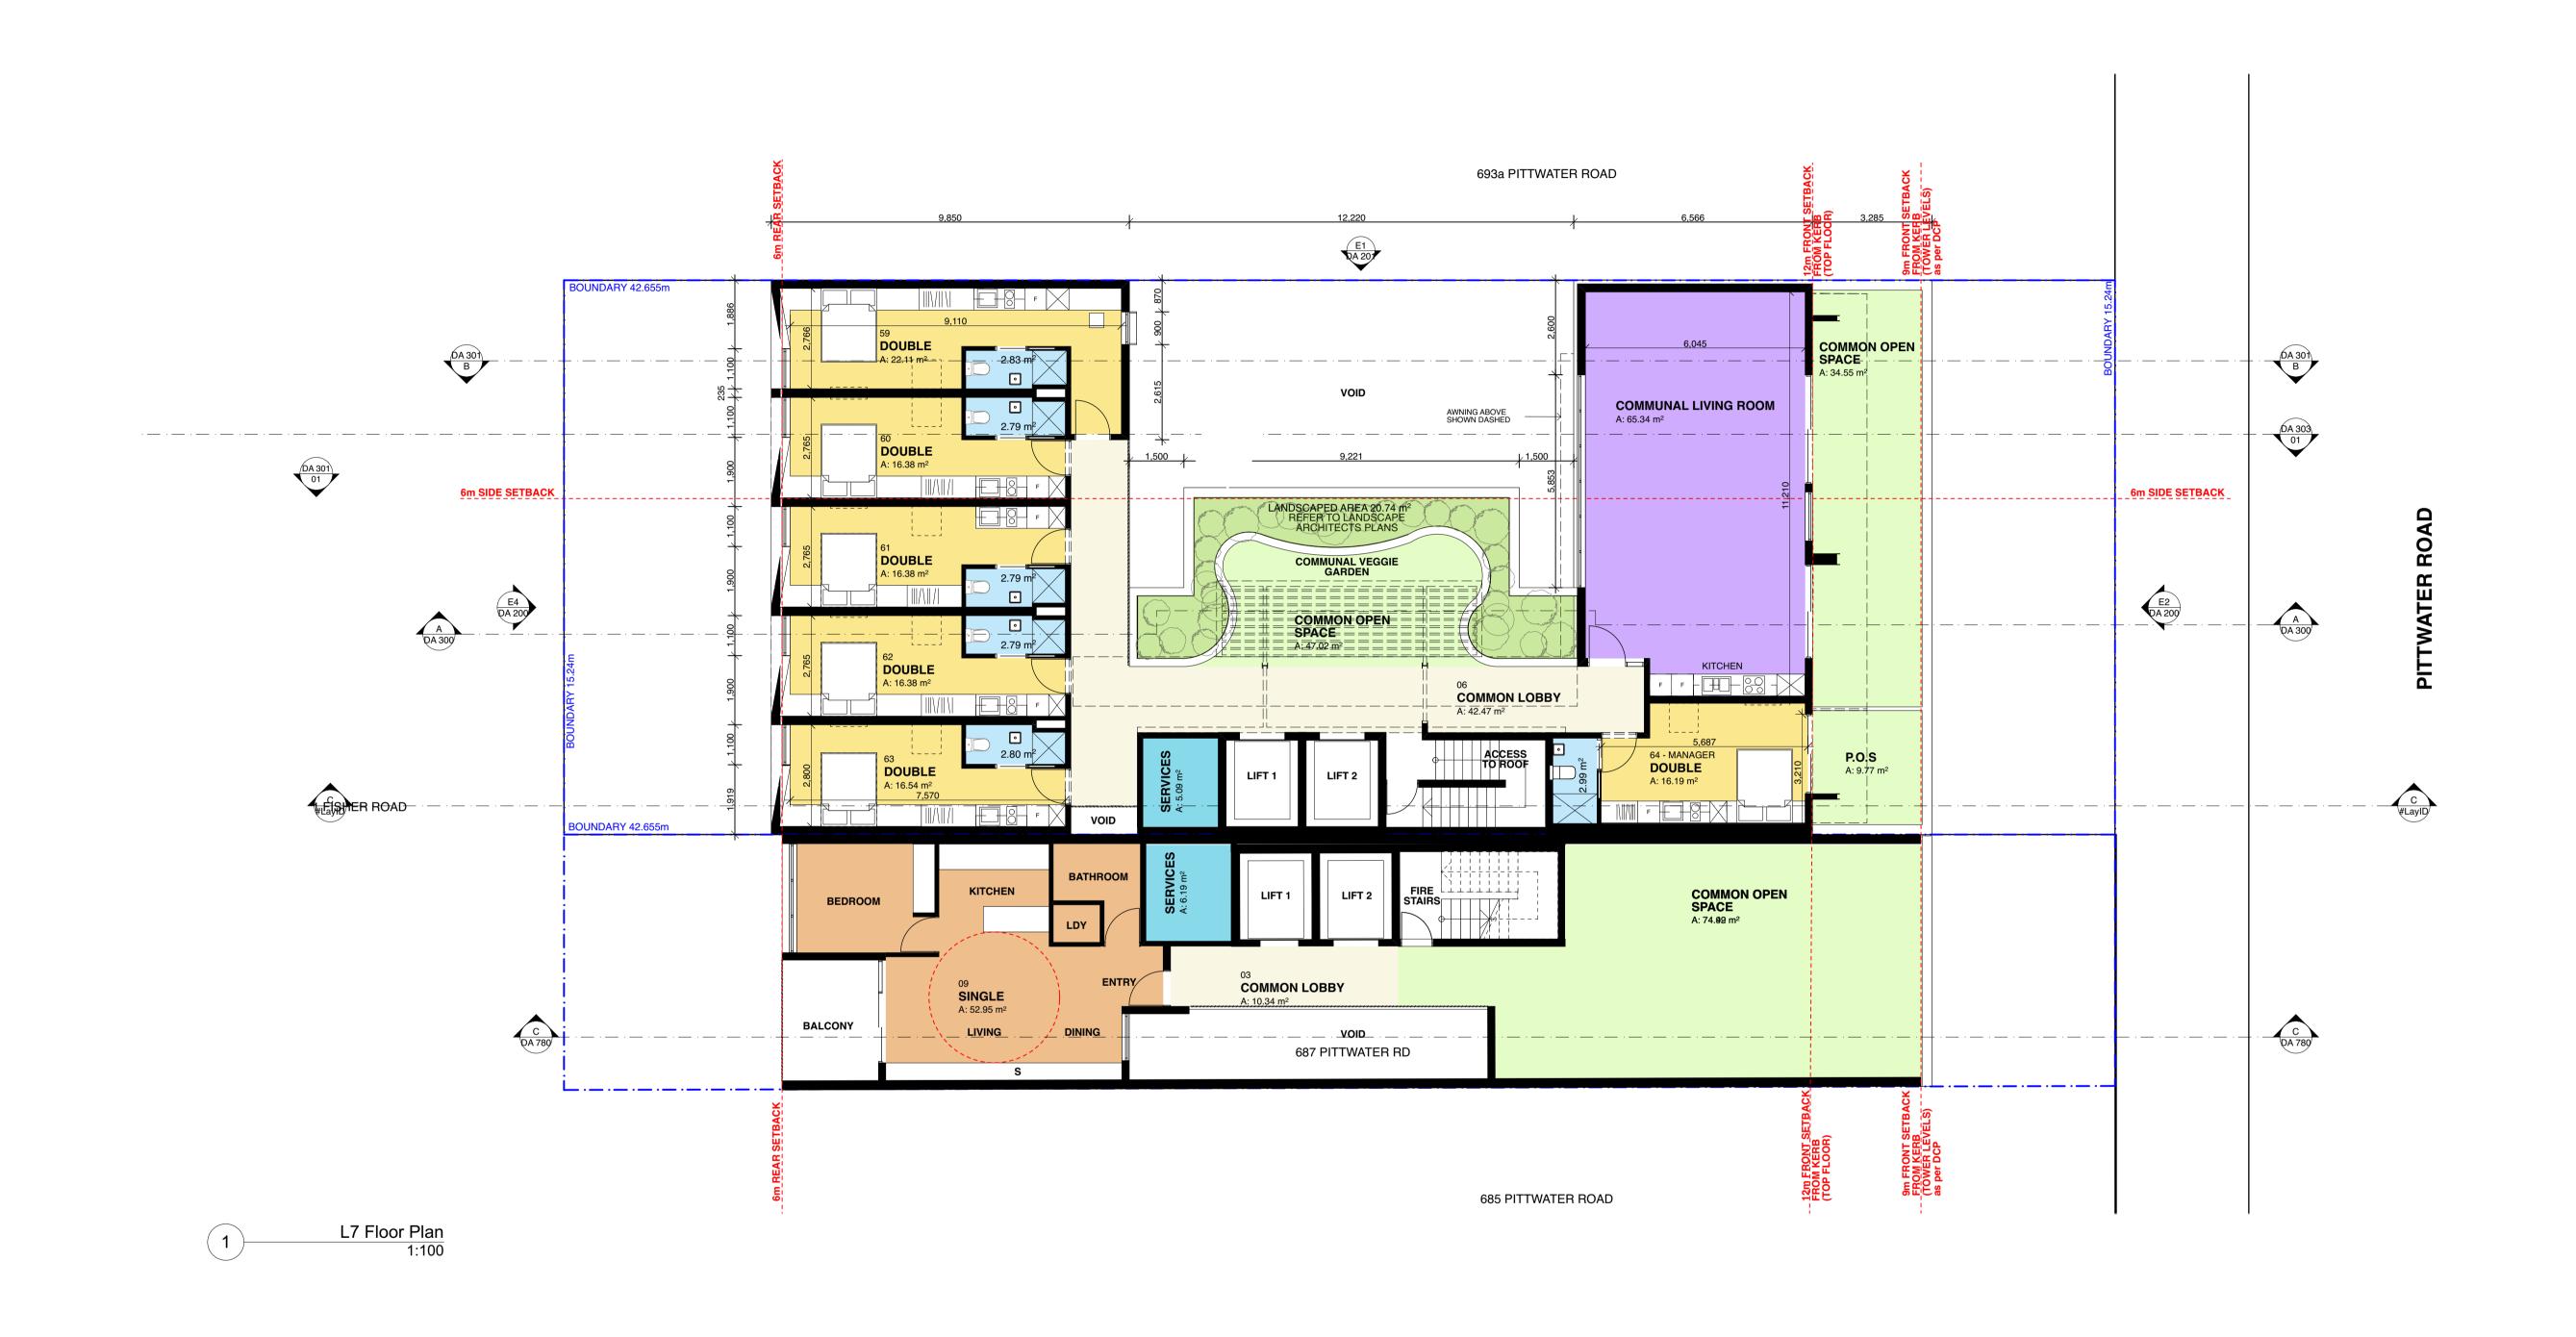
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25/8/20

21/9/20

ISSUE FOR LEC AMENDED ISSUE TO DRP GANNET



17

**BKA** architecture 19049 SCALE @ A1 PROJECT # Mixed Use Boarding House Development AT/JG CHECKED ADDRESS 691 Pittwater Road Dee Why NSW SYDNEY NEWCASTLE BYRON BAY
Suite 1.04, Suite 4
77 Dunning Ave, 19 Bolton St,
Rosebery Newcastle NSW 2300 NSW 2479

SYDNEY Unit 1
10 Station St,
Bangalow
NSW 2479 21/9/20 DRAWING No. DATE GANNET CLIENT NORTH Gannet Developments T: +61 2 9318 9200 T: +61 2 4926 5563 E: bka@bka.com.au T: +61 2 4926 5563 DRAWING 687 Pittwater Rd - L7 Floor Plan

FOR DA PURPOSES

FOR DA PURPOSES

FOR DA ONLY


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25/8/20 ISSUE FOR LEC 21/9/20 AMENDED ISSUE TO DRP



17

19049 SCALE @ A1

21/9/20 DRAWING No.

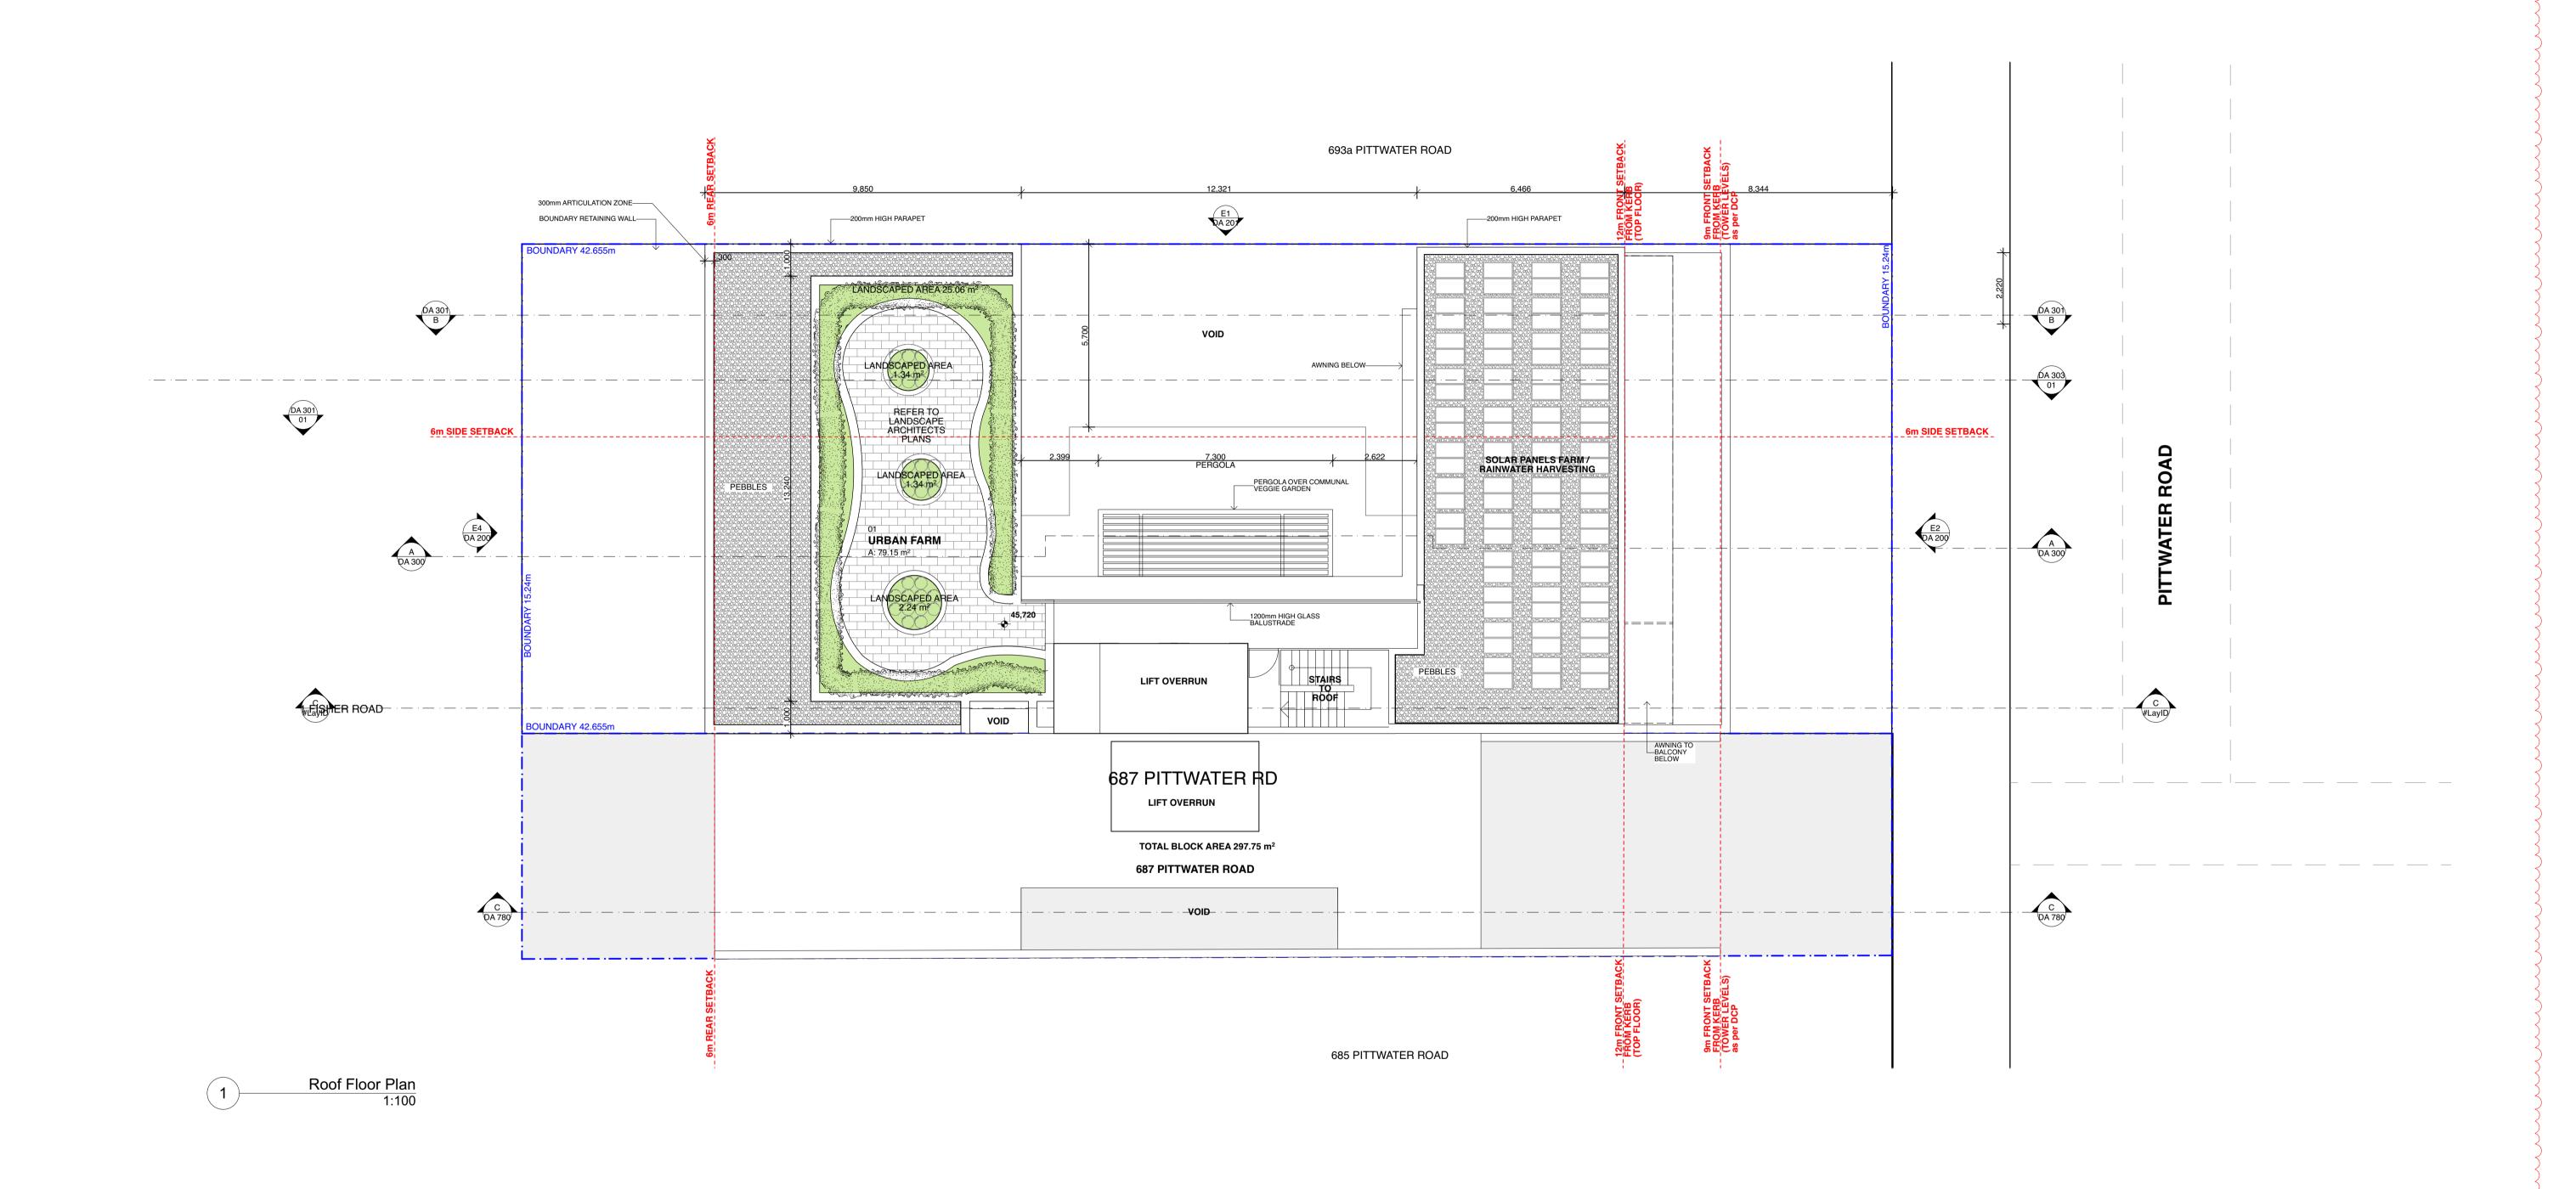AT/JG CHECKED

DATE

NORTH

Mixed Use Boarding House Development

ADDRESS 691 Pittwater Road Dee Why NSW

Gannet Developments

DRAWING 687 Pittwater Rd - Roof Plan

CLIENT

**BKA** architecture

SYDNEY NEWCASTLE BYRON BAY
Suite 1.04, Suite 4
77 Dunning Ave, 19 Bolton St, 10 Station St, Rosebery NSW 2018

NEWCASTLE BYRON BAY
Unit 1
10 Station St, Bangalow
NSW 2479

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ISSUE

AMENDED ISSUE FOR LEC


C 21/9/20

AMENDED ISSUE TO DRP

G AMENDED ISSUE TO DRP

DEVELOPMENTS

FOR DAPURPOSES

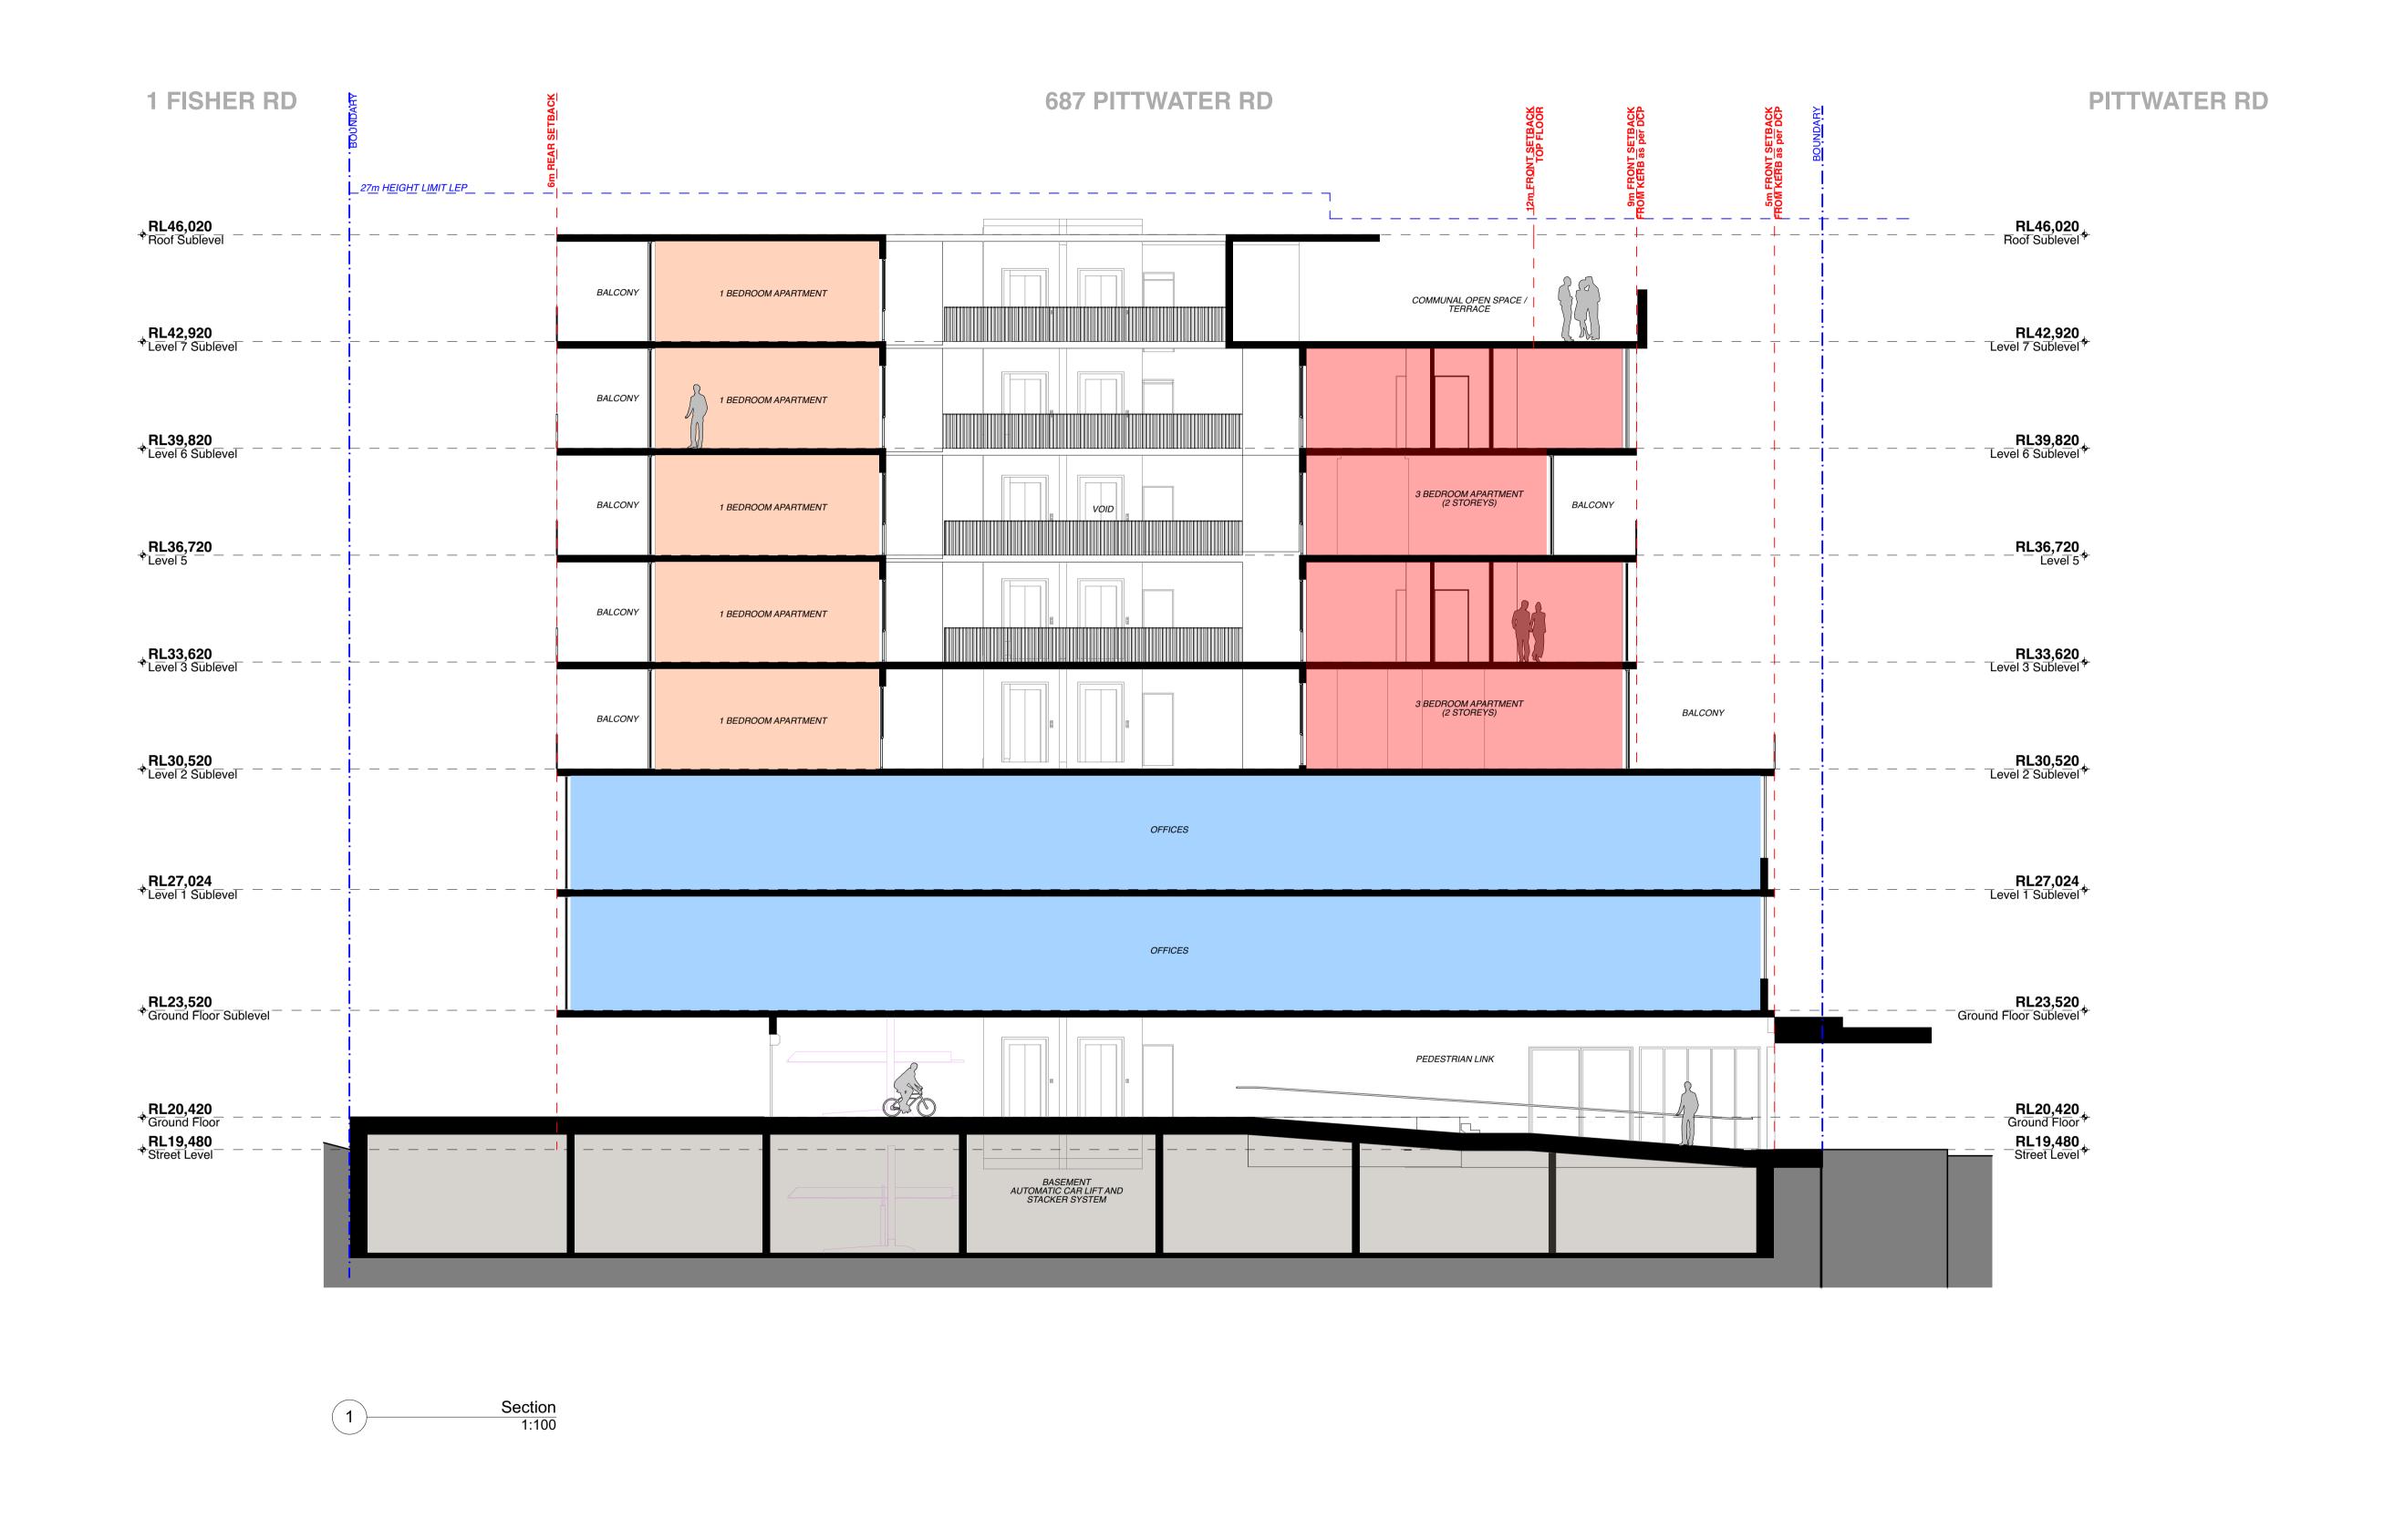

17

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BEVISION DATE ISSUE

BEVISION DATE

ISSUE

AMENDED ISSUE FOR LEC

C 21/9/20

AMENDED ISSUE TO DRP

G AMENDED ISSUE TO DRP

DEVELOPMENTS

FOR DAPURPOSES

SYDNEY NEWCASTLE BYRON BAY
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77 Dunning Ave, Rosebery NSW 2018 NSW 2300 NSW 2479
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T: +61 2 4926 5563

T: +61 2 4926 5563

Mixed Use Boarding House Development

ADDRESS
691 Pittwater Road Dee Why NSW

CLIENT
Gannet Developments

DRAWING
687 Pittwater Rd - Section











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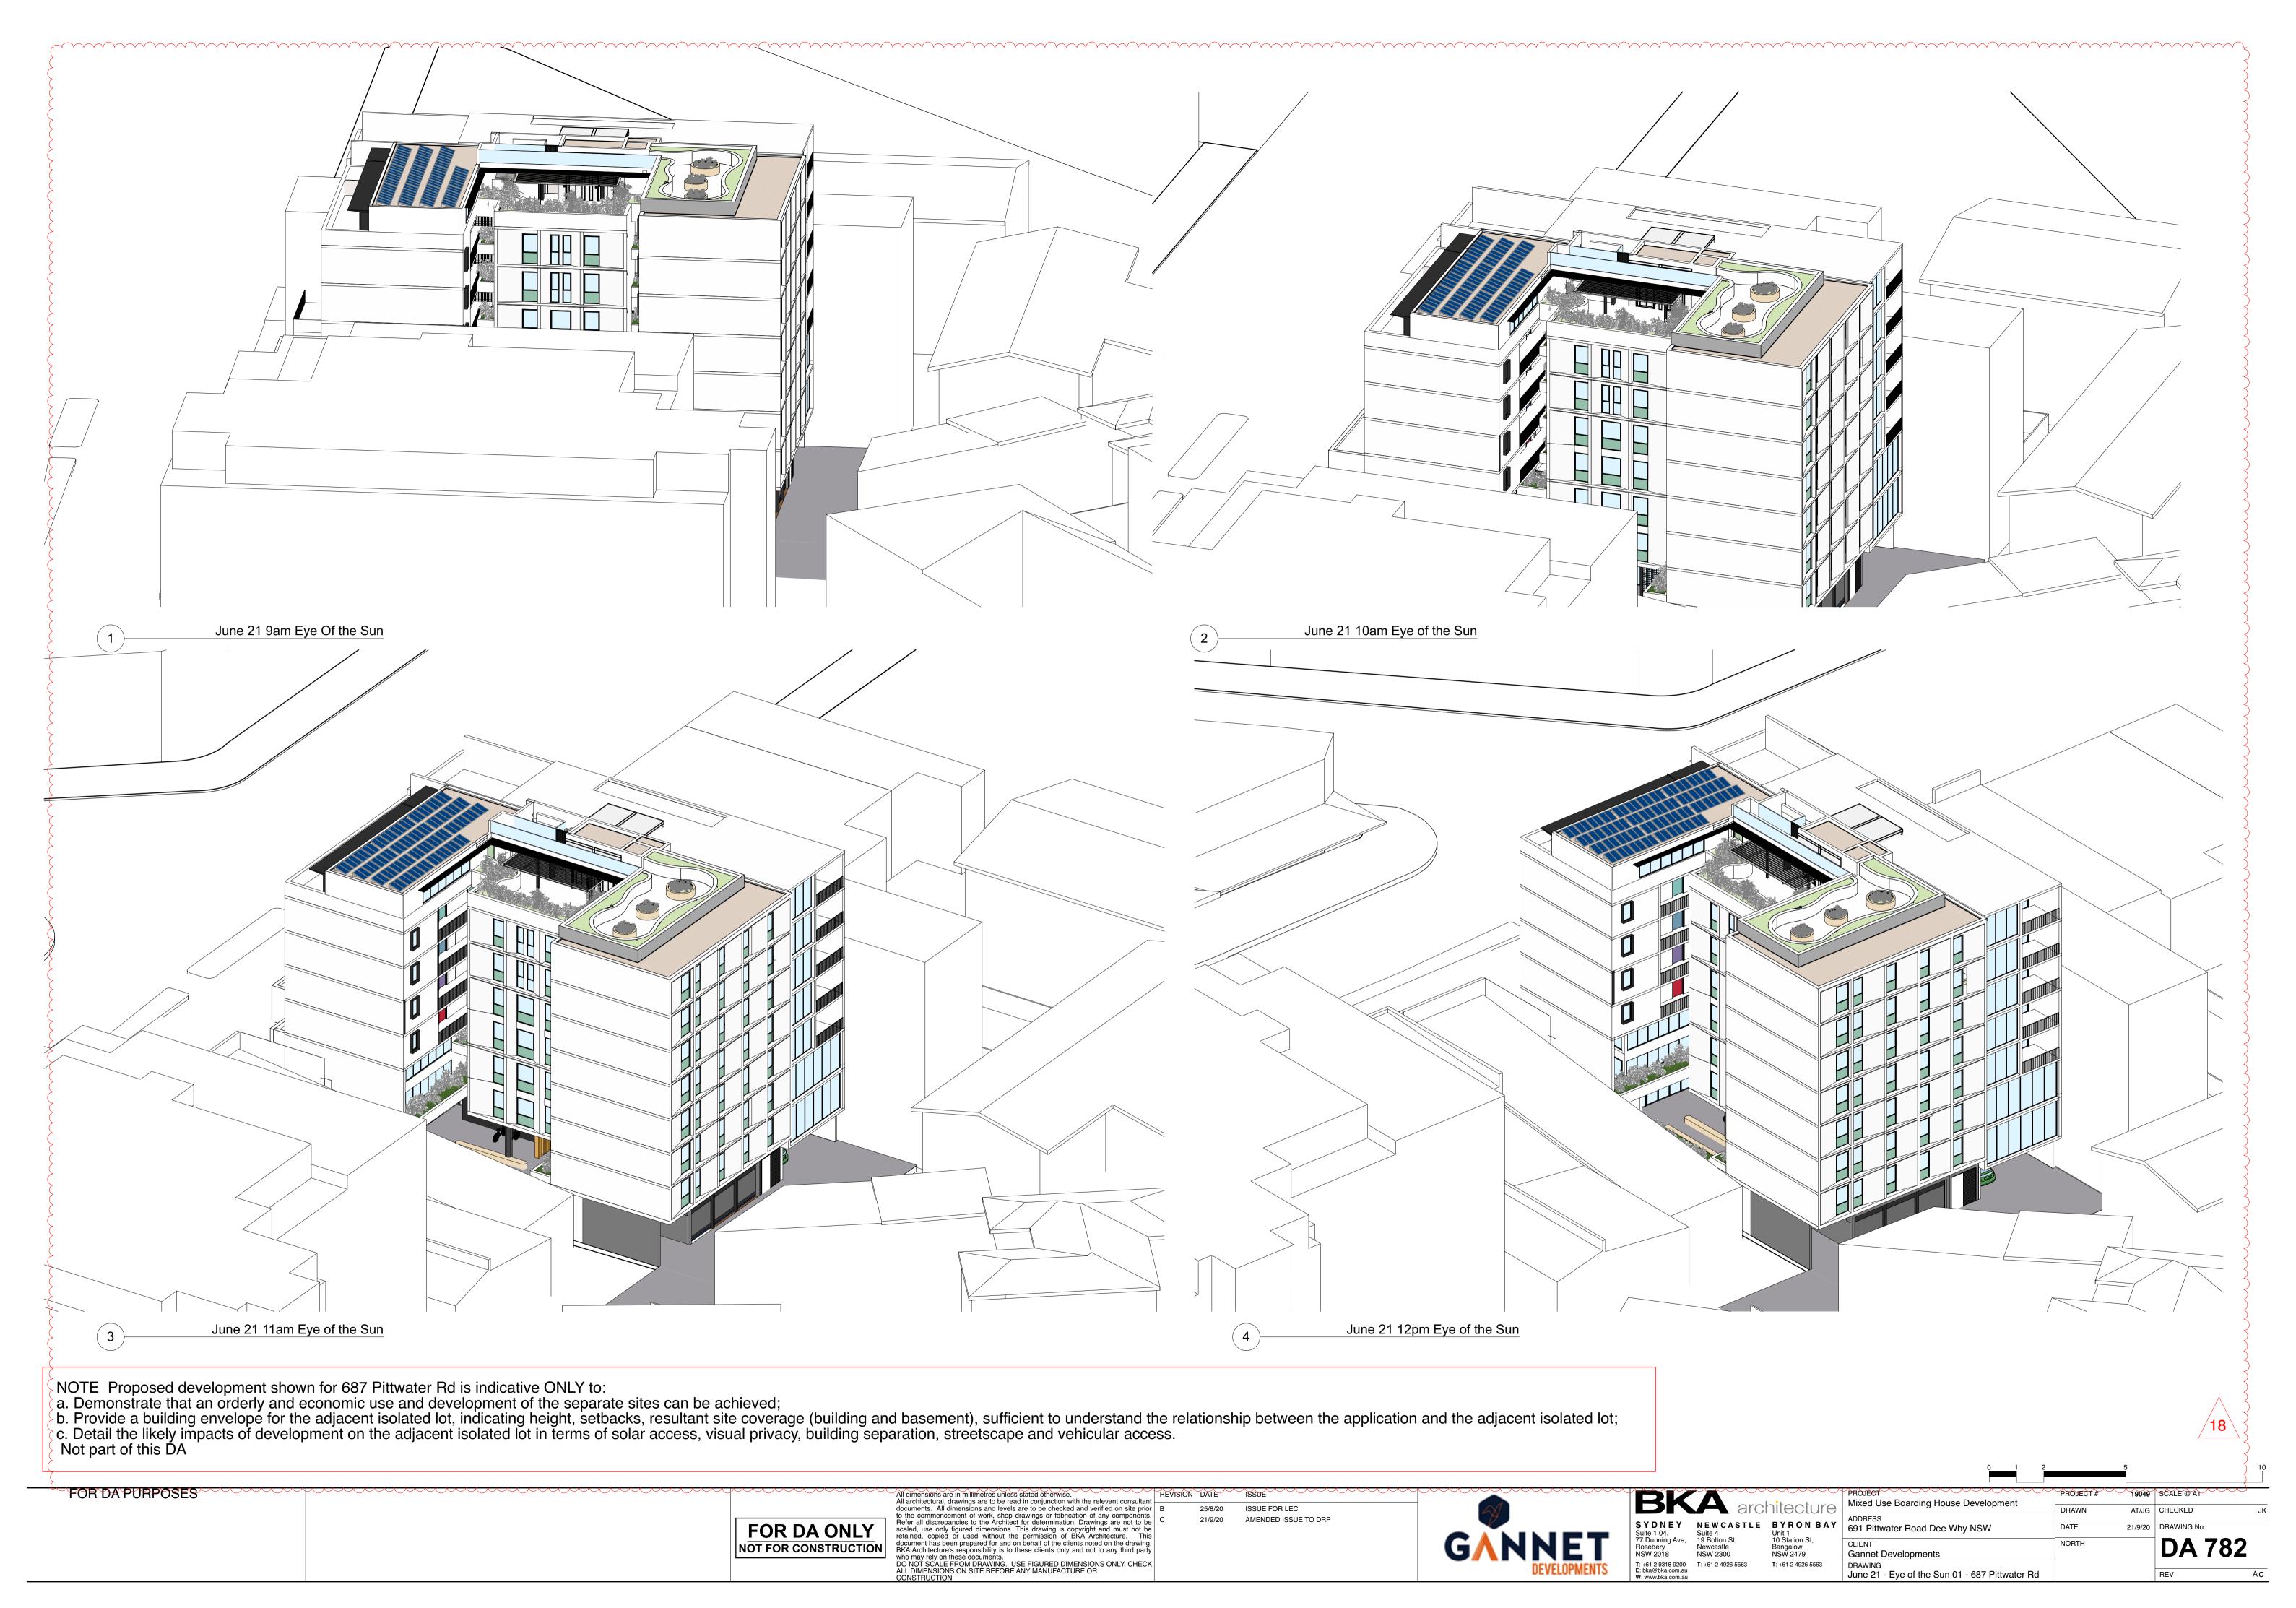
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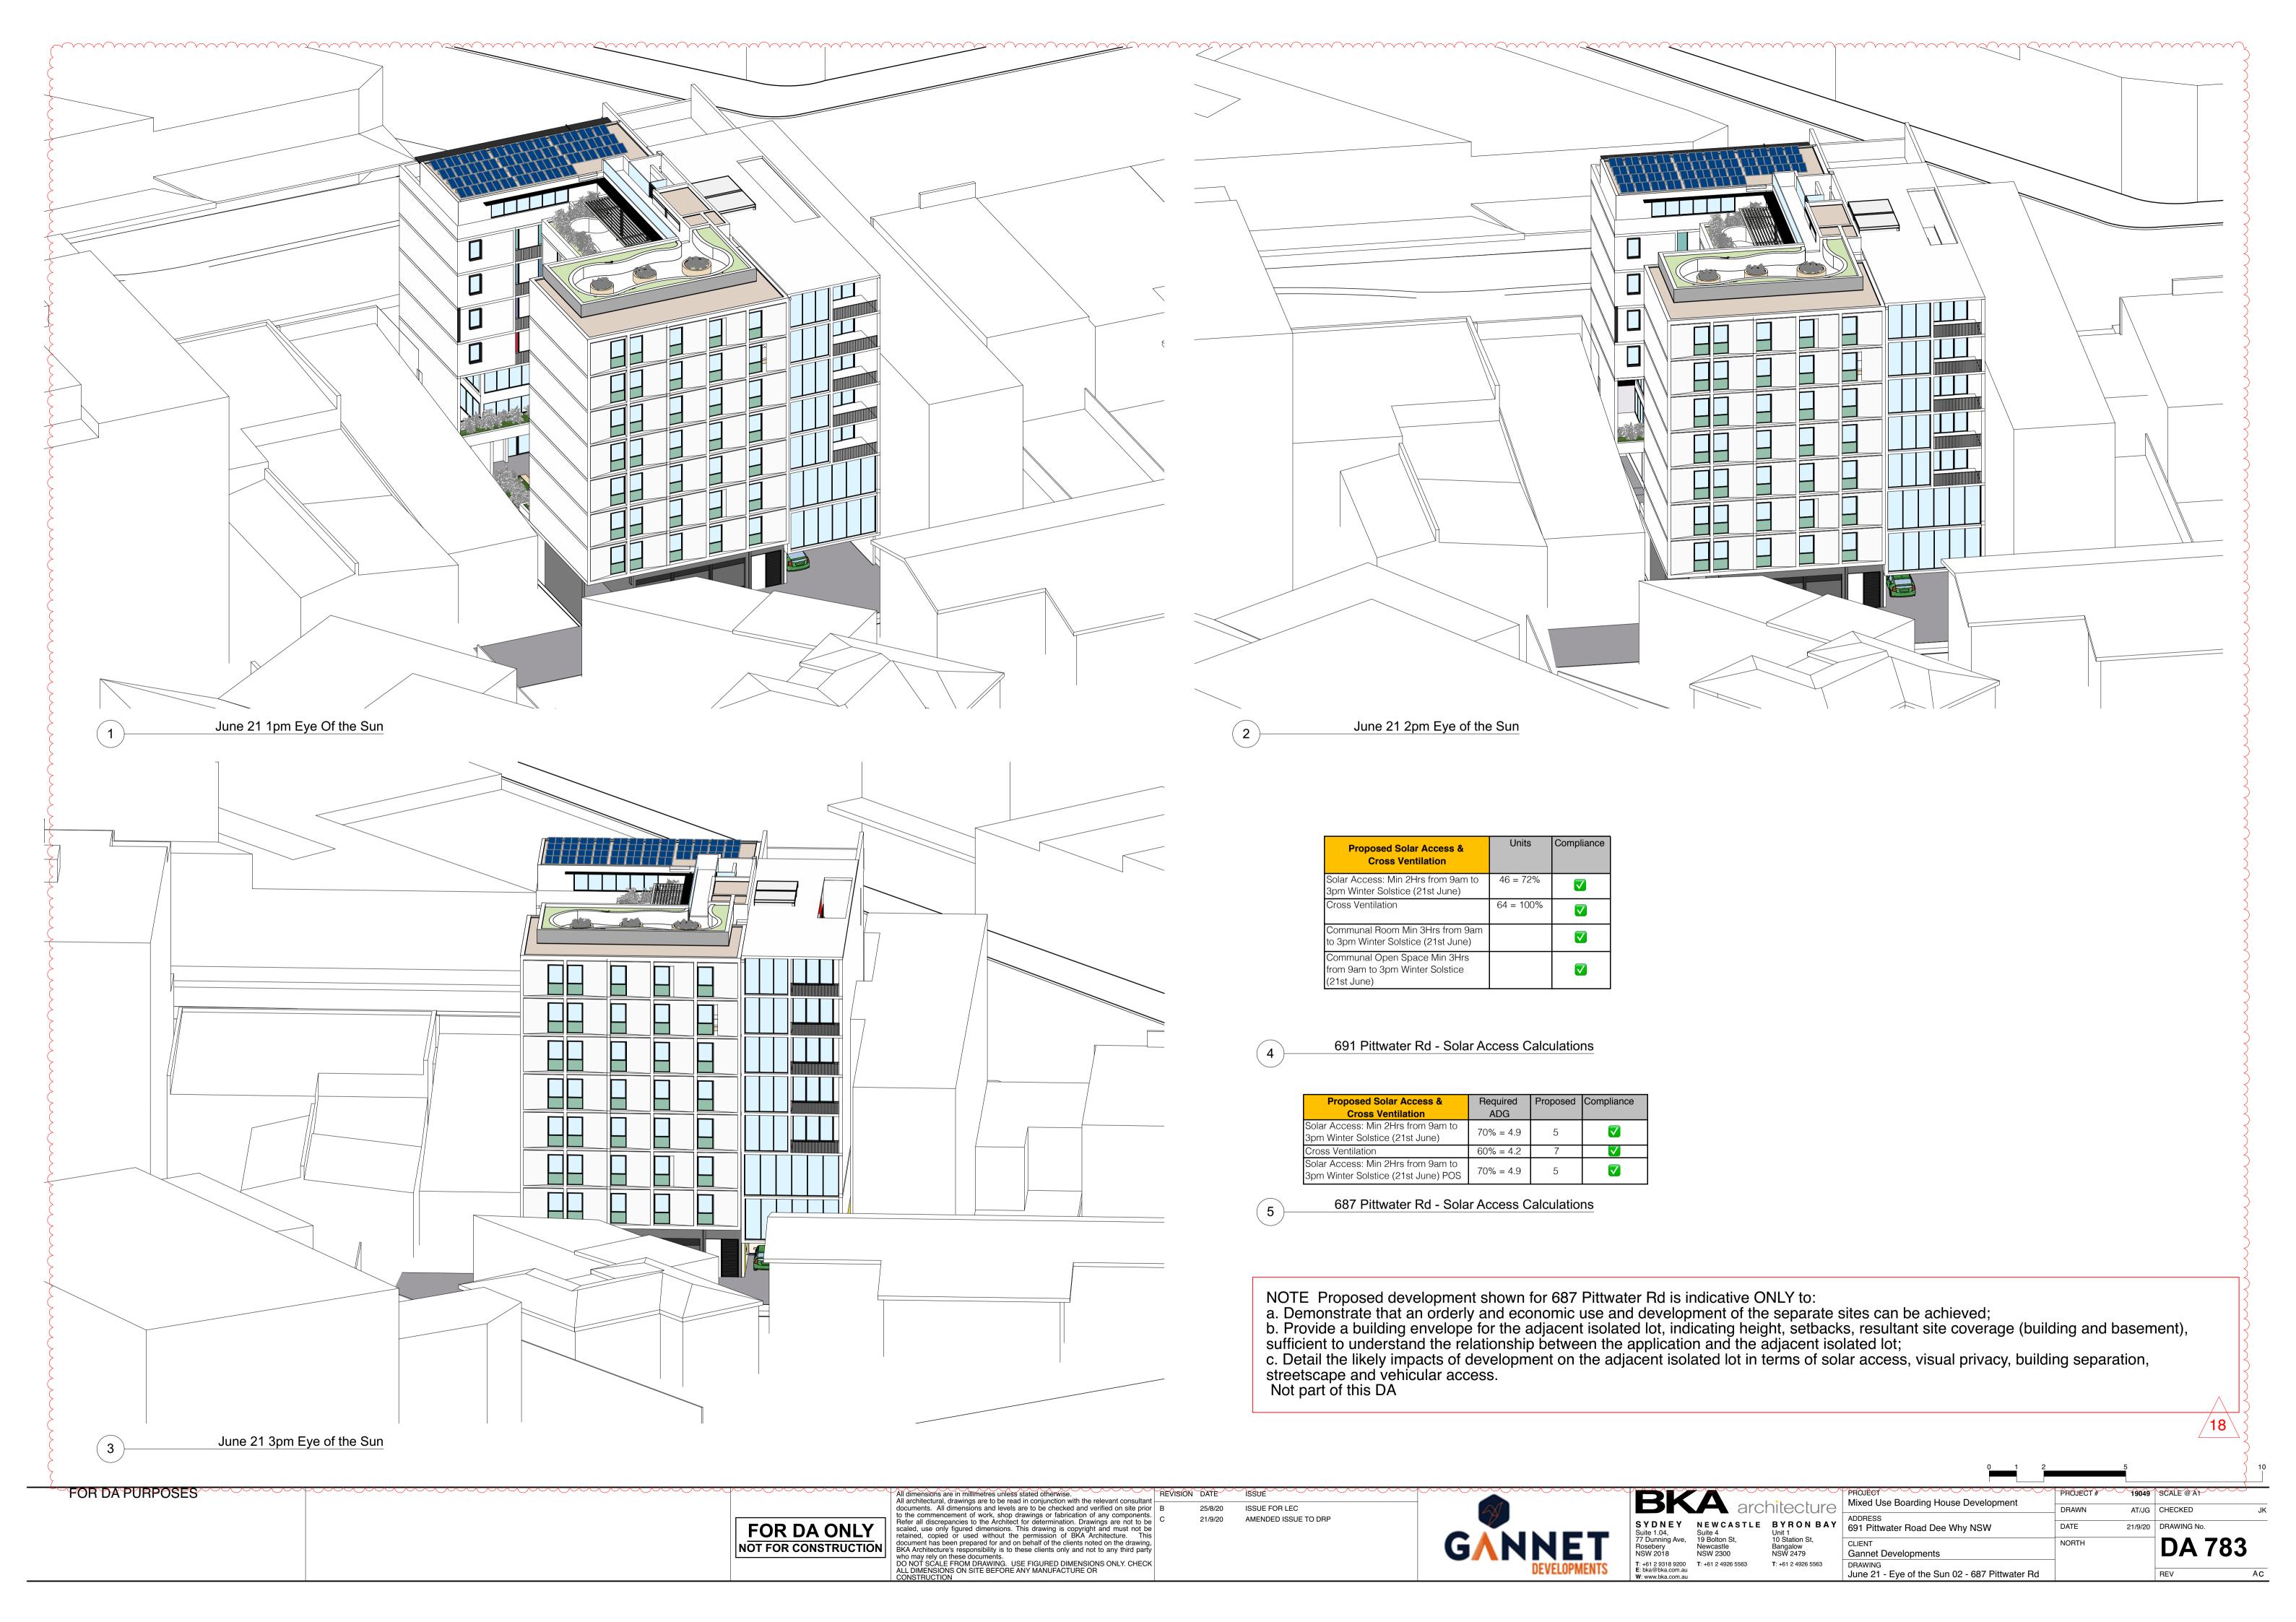
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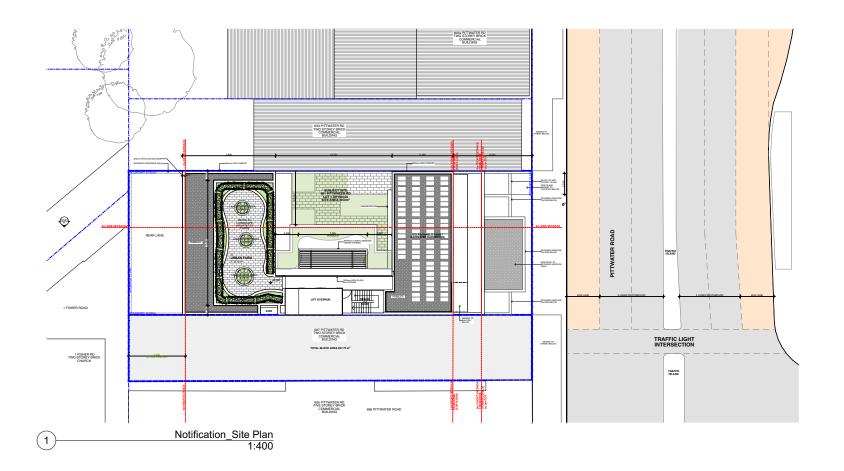
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| BK                                      | <b>A</b> arcl                          | hitecture                              | PRC<br>Mix |
|---|--|--|------------|
| S Y D N E Y<br>Suite 1.04,              | NEWCASTLE<br>Suite 4                   | BYRON BAY<br>Unit 1                    | ADD<br>691 |
| 77 Dunning Ave,<br>Rosebery<br>NSW 2018 | 19 Bolton St,<br>Newcastle<br>NSW 2300 | 10 Station St,<br>Bangalow<br>NSW 2479 | CLIE       |
| T: +61 2 9318 9200<br>E: bka@bka.com.au | <b>T</b> : +61 2 4926 5563             | <b>T</b> : +61 2 4926 5563             | DRA        |

| 人      | PROJECT  Mixed Use Boarding House Development | PROJECT# | 19049     | SCALE @ A1 |
|--------|---|----------|-----------|------------|
| h<br>7 | ADDRESS                                       | DRAWN    | AT/JG     | CHECKED    |
| ,      | 691 Pittwater Road Dee Why NSW                | DATE     | 21/9/20   | DRAWING No |
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|        | DRAWING                                       |          | $\times$  |            |
|        | 687 Pittwater Rd - Perspectives               |          |           | REV        |







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|-----------------|----------------------|--|----------|---------|---------------|------------|-------|
|                 |                      | documents. All dimensions and levels are to be checked and verified on site prior  |          | 6/3/20  | ISSUED FOR DA | (20)       |       |
|                 |                      | to the commencement of work, shop drawings or fabrication of any components.<br>Refer all discrepancies to the Architect for determination. Drawings are not to be         | C        | 21/9/20 | ISSUED FOR DA |            | ,     |
|                 | I FOR DA ONLY I      | scaled, use only figured dimensions. This drawing is copyright and must not be   |          |         |               |            |       |
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| 3KA architecture                            |                    |   | PROJECT Mixed Use Boarding House Development | PROJECT#   |              | SCALE @ A1 | 1:400 | Ī |
|---|--------------------|---|--|------------|--------------|------------|-------|---|
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| DNEY   NEW CASTLE   BYROP                   |                    | ADDRESS<br>691 Pittwater Road Dee Why NSW | DATE   | 21/9/20    | DRAWING No.  |            |       |   |
|   | Bangalow           | CLIENT<br>Gannet Developments             | NORTH  | $\Diamond$ | <b>DA 80</b> | 0          |       |   |
| 2 9318 9200<br>ePbka.com.au<br>rwbka.com.au | T: +61 2 4926 5563 | T: +61 2 4926 5563                        | DRAWING<br>Notification Plan 01              |            | igotimes     | REV        | С.    |   |



### **LEGEND & SCHEDULE**

1. ALL FINAL PLANT QUANTITIES INDICATED ON PLANS SHALL BE CHECKED AND

VERIFIED BY SUCCESSFUL LANDSCAPE CONTRACTOR.

2. ANY PLANT SUBSTITUTES REQUIRED DUE TO UNAVAILABILITY SHALL BE RECOMMENDED BY THE LANDSCAPE CONTRACTOR TO BEST MATCH SUBSTITUTED PLANTS AND APPROVED PRIOR TO PURCHASING BY THE LANDSCAPE ARCHITECT.

3. WORKS CERTIFIED FOR FINAL OCCUPANCY CERTIFICATE ARE TO MATCH

APPROVED LANDSCAPE PLANS. 4. LANDSCAPE CONTRACTOR SHALL LOCATE AND AVOID SITE STORM WATER & DRAINAGE SERVICES. LOCATE TREES A MINIMUM 1.25M FROM PITS

5. ALL PLANTING AROUND EXISTING TREES SHALL BE ADJUSTED TO AVOID DAMAGE AND CLASHING WITH SURFACE ROOTS.

6. THE NATURE STRIP (STREET FRONTAGE) FOR THE SITE IS PUBLIC LAND, AND ONLY AUTHORIZED WORKS MAY OCCUR HERE. EXISTING CONDITIONS SUCH AS STREET TREES, COUNCIL PLANTING ETC SHALL BE RETAINED AND PROTECTED DURING CONSTRUCTION, UNLESS SPECIFIC APPROVAL HAS BEEN GRANTED FOR

### **TREES**



Botanical Name: Acer palmatum 'Ariadne' Common Name: Japanese maple (Exotic) Pot size: 75Lt Mature H x S: 3m x 3m Qty Required:

300mm

300mm

300mm

300mm

0.3m x 0.6m

140mm

140mm

Qty Required: 4/m2 (14.3m2 total)

OTHER LANDSCAPE ITEMS

Timber seating fixed on retaining wall

4/m2 (22.9m2 total)

1m x 1.25m

6m x 4.5m



Botanical Name: Cupaniopsis anacardioides Common Name: Tuckeroo (Native) Mature H x S: 8-10m x 3-5m Otv Required:

SHRUBS AND HEDGES

Botanical Name: Syzygium 'Cascade' Common Name: Cascade Lilly Pilly (Native) Mature H x S: 2.5m x 1.8m Qty Required: 8

**ACCENT PLANTS** 

**Botanical Name:** Cordyline australis Common Name: Cabbage tree (Native) Mature H x S: 1.5-2.5m x 1-2.5m Qtv Required:

Botanical Name: Strelitzia nicolai

Common Name: Giant Bird of Paradise (Exotic) Pot size: Mature H x S: Qty Required:

Botanical Name: Zamia furfuracea Common Name: Cardboard Palm (Exotic) Pot size: Mature H x S: Qty Required:

Botanical Name: Alcantarea imperialis 'Rubra' Common Name: Ruby Imperial Bromeliad (Exotic) Mature H x S: 0.8m x 0.9m

Qty Required:

Mature H x S:


Myoporum 'Yareena

Turf - refer detail


Mature H x S: < .8m

**GRASSES / GROUNDCOVERS** Botanical Name: Trachelospermum Jasminoides Common Name: Star Jasmine (Exotic)



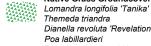



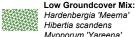












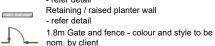





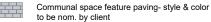

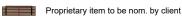








SITE AREA: PROPOSED DEEP SOIL AREA: 147.11m² (22.63%) LANDSCAPE AREA INCLUDE IN CALCULATION:

**DEEP SOIL CALCULATIONS** 

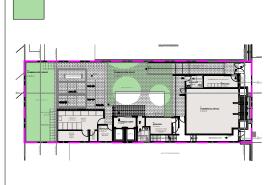

### LANDSCAPE PLAN NOTES

This plan should be read in conjunction with the architectural and hydraulics plans. Work specific to these plans should be prepared in accordance to these plans, including specification and details prior to the installation of landscaping, and should not be altered or compromised during landscape construction. Elements such as drainage swales may be incorporated in garden bed areas (using non-floatable mulch) without compromising the capacity or form.

This plan has been prepared for Development Application approval

This plan has been prepared with reference to **Northern Beaches** Councils Landscaping Guidelines & requirements. Planting proposed using mainly indigenous, commercially available plant species selected from local planting lists and the BASIX local plant list and from Sydney Waters "Plant Selector"web site one-drip rated native plants (acceptable for Basix planting).


The Design & location of new letter boxes shall be in accordance with Australia Post's "Requirements for Delivery of Mail to Residential Premises" published Feb '97. All noxious weeds listed in Councils weed lists & located on the site shall be continually removed & suppressed. Reinstate all boundary fencing in poor condition with Council approved 1.8m fencing to rear of building line, rake to 1m forward of BL. Pollution, sediment & erosion control devices as specified shall be in place, and maintained for the duration of the construction period. Proposed excavation near existing established trees to be supervised by arborist.

D.A approved landscape plan's are required to be constructed as approved to obtain occupancy certificate. Permeable areas may be indicated to achieve site coverage restrictions & should be constructed as drawn on this plan.

General Notes:

© (ABN: 75 623 405 630)

## Planting in deep soil to include: - 1 A 'Ariadne' Planting in deep soil to include: - 1 C. australis - 3 C. anacardioides - 3 A. 'Rubra' Planting in deep soil to include: - 8 S. 'Cascade' - 15.1m2Native Grass Groundcover Mix - 1 A. 'Ariadne' - 2 S. nicolai - 6 Z. furfuracea - 1 A. 'Rubra' Wire mesh attached to wall with - 7.8m2 Native Grass Groundcover Mix - 14.3m2 Low Groundcover Mix planting in the garden bed: - 4.7m2 T. Jasminoides TOW 20.870 SERVICES COMMERCIAL/RETAIL **SERVICE** EMERGENCY EXIT LANDSCAPE PLAN-GROUND FLOOR 687 PITTWATER ROAD Feature plant in pot to include: Stormwater detention tank & pits refer to - 1 A. 'Rubra' engineer's detail OMMON OPEN SPACE 0 6m SETBACK ACCESSIBL OFFICES OFFICE DOUBLE COMMON LOBBY 0 DOUBLE 687 PITTWATER ROAD

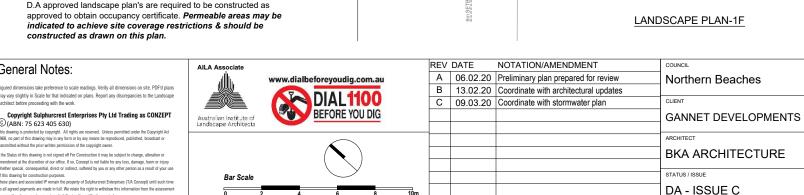

LANDSCAPE PLAN Lamdscape Architects

Suite 101, 506 Miller S

CAMMERAY NSW 2062

enquiries@conzept.net.au Mob: 0413 861 351

www.conzept.net.au

Phone: 9922 5312

Fax: 8209 4982

PROPOSED APARTMENT **DEVELOPMENT** 

> **691 PITTWATER ROAD DEE WHY**

LPDA 20 - 152 / 1 1:200 @ A3 FEB 2020 R.F R.H/K.Z

### **LEGEND & SCHEDULE**

1. ALL FINAL PLANT QUANTITIES INDICATED ON PLANS SHALL BE CHECKED AND VERIFIED BY SUCCESSFUL LANDSCAPE CONTRACTOR.

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4 LANDSCAPE CONTRACTOR SHALL LOCATE AND AVOID SITE STORM WATER & DRAINAGE SERVICES. LOCATE TREES A MINIMUM 1.25M FROM PITS

5. ALL PLANTING AROUND EXISTING TREES SHALL BE ADJUSTED TO AVOID DAMAGE AND CLASHING WITH SURFACE ROOTS.

6. THE NATURE STRIP (STREET FRONTAGE) FOR THE SITE IS PUBLIC LAND, AND ONLY AUTHORIZED WORKS MAY OCCUR HERE. EXISTING CONDITIONS SUCH AS STREET TREES, COUNCIL PLANTING ETC SHALL BE RETAINED AND PROTECTED DURING CONSTRUCTION, UNLESS SPECIFIC APPROVAL HAS BEEN GRANTED FOR NEW WORK IN THIS AREA.

### **SHRUBS AND HEDGES**



Pot size: Mature H x S: Qty Required:

Botanical Name: Metrosideros 'Fiji Fire' Common Name: NZ Christmas Bush (Exotic) 300mm 2m x 1.8m

300mm

1.5-2.5m x 1-2.5m

300mm

200mm

300mm

300mm

0.8m x 0.9m

1m x 1.25m

Botanical Name: Banksia ericifolia 'Little Eric' Common Name: Heath Banksia (Native) Pot size: Mature H x S: 1.4m x 1.4m

Qty Required: **ACCENT PLANTS** 

Botanical Name: Cordyline australis Pot size:

Common Name: Cabbage tree (Native) Mature H x S: Otv Required: Botanical Name: Strelitzia nicolai

Common Name: Giant Bird of Paradise (Exotic) Pot size: Mature H x S: Qty Required:

Botanical Name: Zamia furfuracea Common Name: Cardboard Palm (Exotic) Pot size: Mature H x S: Qty Required:

Botanical Name: Alcantarea imperialis 'Rubra' Common Name: Ruby Imperial Bromeliad (Exotic) Mature H x S:

Qty Required: Botanical Name: Alpinia caerulea 'Red Back' Common Name: Red Back Native Ginger (Exotic) Pot size: Mature H x S:

Qty Required: Botanical Name: Liriope muscari 'Evergreen Giant' Common Name: Giant Lily Turf (Exotic) Pot size:

Mature H x S: Qty Required:

150mm 0.7m x 0.65m

This plan has been prepared for Development Application approval only, not for construction.

This plan should be read in conjunction with the architectural and

the installation of landscaping, and should not be altered or

compromised during landscape construction. Elements such as

non-floatable mulch) without compromising the capacity or form.

drainage swales may be incorporated in garden bed areas (using

hydraulics plans. Work specific to these plans should be prepared in

accordance to these plans, including specification and details prior to

LANDSCAPE PLAN NOTES

This plan has been prepared with reference to Northern Beaches Councils Landscaping Guidelines & requirements. Planting proposed using mainly indigenous, commercially available plant species selected from local planting lists and the BASIX local plant list and from Sydney Waters "Plant Selector"web site one-drip rated native plants (acceptable for Basix planting).

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D.A approved landscape plan's are required to be constructed as approved to obtain occupancy certificate. Permeable areas may be indicated to achieve site coverage restrictions & should be constructed as drawn on this plan.









Cordyline australis













OTHER LANDSCAPE ITEMS Retaining / raised planter wall - refer detail



1.8m Gate and fence - colour and style to be nom. by client




Communal space feature paving- style & color to be nom. by client

### **General Notes:**

vary slightly in Scale for that indicated on plans. Report any discrepancies to the Landscap

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## LANDSCAPE PLAN PROPOSED APARTMENT **DEVELOPMENT**


Landscape Architects Suite 101, 506 Miller St

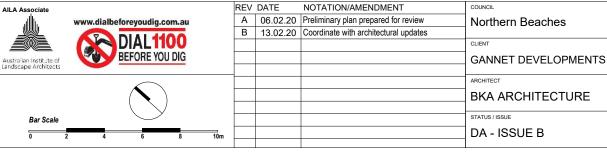www.conzept.net.au Fax: 8209 4982 enquiries@conzept.net.au Mob: 0413 861 351

Phone: 9922 5312


**691 PITTWATER ROAD DEE WHY** 

LPDA 20 - 152 / 2 1:200 @ A3 FEB 2020 CHECKED: R.H/K.Z

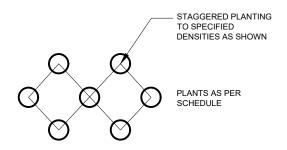


## MASS PLANTING SETOUT

N.T.S

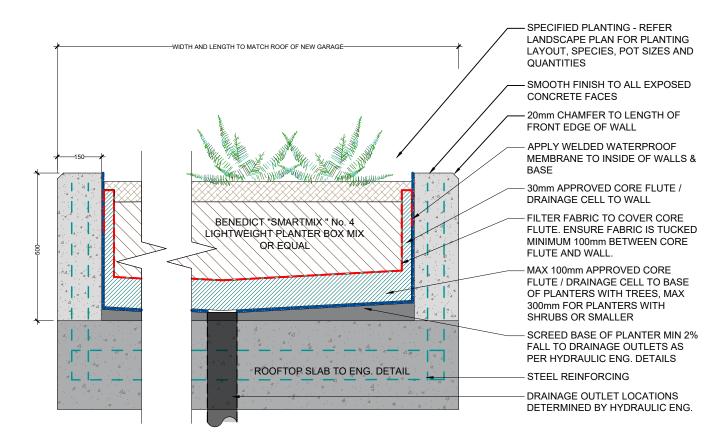

## SECTION: VEGE GARDEN ON SLAB DETAIL

**SCALE 1:10** 

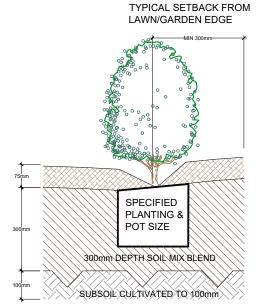

### NOTE

THIS DETAIL IS ONLY APPLICABLE
FOR PLANTING AREA OUTSIDE TREE
PROTECTION ZONE OF TREES TO BE
RETAINED.
NO CHANGES ARE TO OCCUR TO

EXISTING LEVELS, INCLUDING
RIPPING/CULTIVATING OF THE SOIL
WITHIN THE TPZ OF TREES TO BE
RETAINED ON SITE


75mm DEPTH "FOREST BLEND" MULCH OR EQUIVALENT

### SOIL MIX:

50% OF STOCKPILED SITE TOPSOIL FREE FROM ALL BUILDER'S RUBBISH AND DELETERIOUS MATERIALS. TOPSOIL TO BE MIXED WITH MINIMUM 50% IMPORTED GARDEN MIX OR SOIL CONDITIONER/ COMPOSTED ORGANIC MATTER - SEE SPEC. USE 100% IMPORTED SOIL MIX WHEN SITE TOPSOIL RUNS OUT.


## TYPICAL GARDEN PREPARATION DETAIL


**SCALE 1:10** 

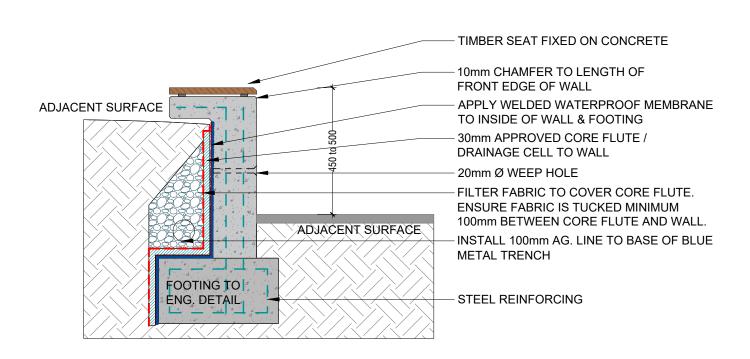

## TYPICAL IN SITU RETAINING WALL WITH SEAT


SCALE 1:20

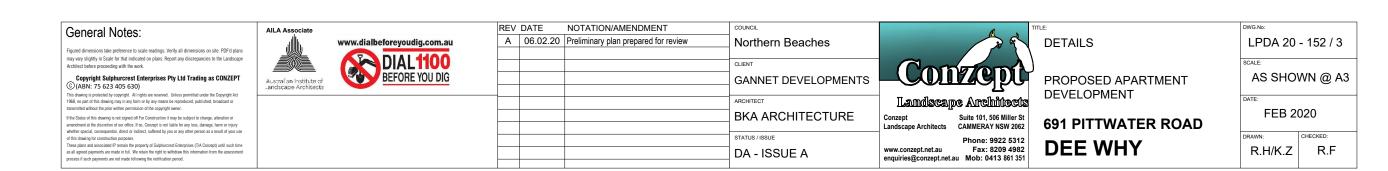

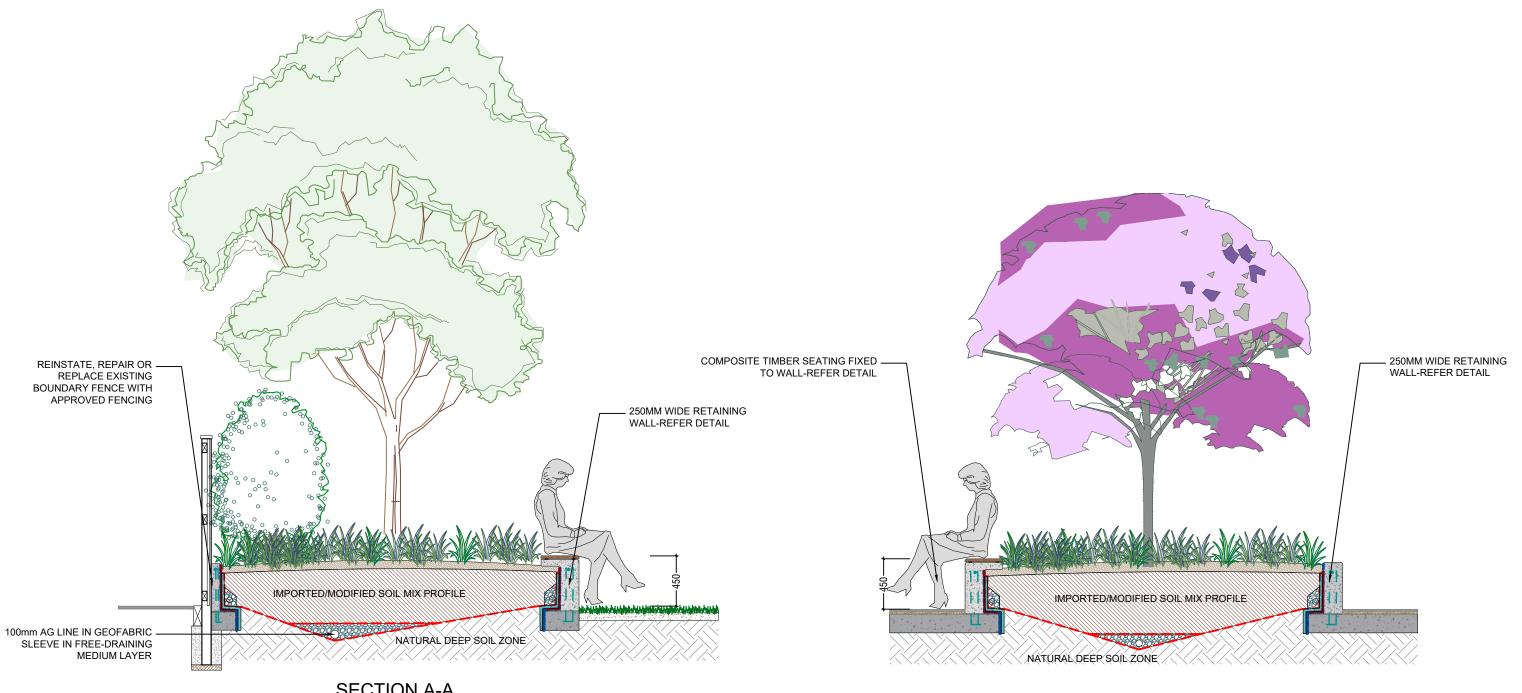

SECTION A-A SCALE 1:20

SECTION B-B SCALE 1:20

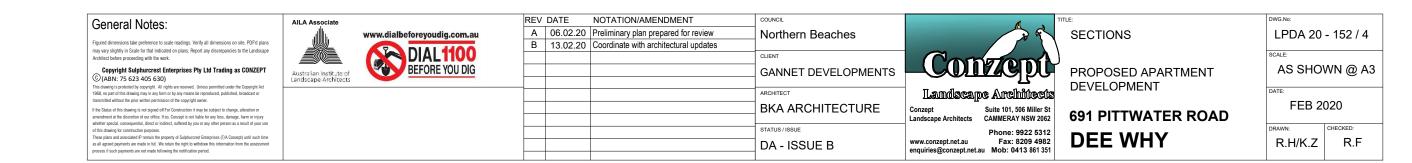

### LANDSCAPE WORK SPECIFICATION

### **PRELIMINARIES**

### 1.01 GENERAL

The following general conditions should be considered prior to the commencement of landscape works:

- The landscape plans should be read in conjunction with the architectural plans, hydraulic plans, service plans and survey prepared for the proposed development.
- All services including existing drainage should be accurately located prior to the commencement of landscape installation. Any proposed tree planting which falls close to services will be relocated on site under the instruction of the landscape architect.
- Installation of conduit for required irrigation, electrical and other services shall be completed prior to the commencement of hardscape
- All outdoor lighting specified by architect or client to be installed by qualified electrician
- Anomalies that occur in these plans should be brought to our immediate attentio
- · Where an Australian Standard applies for any landscape material testing or installation technique, that standard shall be followed.

### 1.02 PROTECTION OF ADJACENT FINISHES

The Contractor shall take all precautions to prevent damage to all or any adjacent finishes by providing adequate protection to these areas / surfaces prior to the commencement of the Works

### 1.03 PROTECTION OF EXISTING TREES

Existing trees identified to be retained shall be done so in accordance with AS 4970-2009 Protection of trees on development sites as well as in accordance with the tree protection measures prepared by project arborist.

Where general works are occurring around such trees, or pruning is required, a qualified Arborist shall be engaged to oversee such works and

Existing trees designated on the drawing for retention shall be protected at all times during the construction period. Any soil within the drip-line of existing trees shall be excavated and removed by hand only. No stockpiling shall occur within the root zone of existing trees to be retained.

Any roots larger in diameter than 50mm shall only be severed under instruction by a qualified arborist. Roots smaller than 50mm diameter

Temporary fencing shall be installed around the base of all trees to be retained prior to the commencement of landscape works. Where ble this fencing will be located around the drip line of these trees, or a minimum of 3m from the trunk. The fencing shall be maintained for the full construction period.

### 1.04 EROSION & POLLUTION CONTROL

The Contractor shall take all proper precautions to prevent the erosion of soil from the subject site. The contractor shall install erosion & sediment control barriers and as required by council, and maintain these barriers throughout the construction period. Note that the sediment control measures adopted should reflect the soil type and erosion characteristics of the site.

Erosion & pollution control measures shall incorporate the following:

- Construction of a sediment trap at the vehicle access point to the subject site.
- Sediment fencing using a geotextile filter fabric in the location indicated on the erosion control plan or as instructed on site by the andscape architect.
- Earth banks to prevent scour of stockpiles
- Sandbag kerb sediment traps
- Straw bale & geotextile sediment filter.
- Exposed banks shall be pegged with an approved Jute matting in preparation for mass planting

Refer to 'Guidelines for Erosion and Sediment Control on Building Sites' by DLWC (2000) for construction techniques

### SOIL WORKS

### 2.01 MATERIALS

### Specified Soil Conditioner (Generally to improve site soil)

The specified soil conditioner for site top-soil improvement shall be an organic mix complies with AS 4454-2012 Composts, soil conditioners and mulches. Note that for sites where soil testing indicates toxins or extremes in pH, or soils that are extremely poor, allow to excavate and supply 300mm of imported soil mix.

### New gardens & proposed Planting

arden and planting areas shall consist of a 50/50 mix of clean site soil (refer d) below) and imported soil. All mixes are to comply with AS4419-2003 Soils for Landscaping and garden use, & AS 4454 Composts, Soil conditioners & mulches.

The specified soil mix for all turf areas shall be a min 75mm layer of imported soil mix consisting of 80% washed river sand (reasonably coarse), and 20% composted organic matter equivalent to mushroom compost or soil conditioner, or other approved lawn top dress.

Site topsoil is to be clean and free of unwanted matter such as gravel, clay lumps, grass, weeds, tree roots, sticks, rubbish and plastics, and any deleterious materials and materials toxic to plants. The topsoil must have a pH of between 5.5 and 7. Use 100% imported soil mix when

### 2.02 INSTALLATION

Note: No level changes (Cut or Fill), soil ripping within the Tree Protection Zones of trees to be retained

a) Testing

All testing is to be conducted in accordance with AS4419-2003 Soils for Landscaping and garden use Methods for testing soils for engineering

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Note that a soil test conducted by the Sydney Environmental & Soil Laboratory or approved equal shall be prepared for all commercial, industrial and multi-unit residential sites. The successful landscape contractor shall implement the recommendations of this test.

### Set Out of Individual Trees & Mass Planting Areas

All individual tree planting positions and areas designated for mass planting shall be set out with stakes or another form of marking, ready for

c) Establishing Subgrade Levels
Subgrade levels are defined as the finished base levels prior to the placement of the specified material (i.e. soil conditioner). The following subgrade levels shall apply: Mass Planting Beds - 300mm below existing levels with specified imported soil mix

### Turf areas - 100mm below finished surface leve

Note that all subgrades shall consist of a relatively free draining natural material, consisting of site topsoil placed previously by the Civil

Cultivate all subgrades to a minimum depth of 100mm in all planting beds and all turf areas, ensuring a thorough breakup of the subgrade into a reasonably coarse tilth. Grade subgrades to provide falls to surface and subsurface drains, prior to the placement of the final specified soil

Install surface and subsurface drainage where required and as detailed on the drawing. Drain subsurface drains to outlets provided, with a minimum fall of 1:100 to outlets and / or service pits.

- Placement and Preparation of Specified Soil Conditioner & Mixes.

  Trees in turf & beds Holes shall be twice as wide as root ball and minimum 100mm deeper backfill hole with 50/50 mix of clean site soil and imported "Organic Garden Mix" as supplied by ANL or approved equal.
- Mass Planting Beds Install specified soil conditioner to a compacted depth of 100mm

Place the specified soil conditioner to the required compacted depth and use a rotary hoe to thoroughly mix the conditioner into the top 300mm of garden bed soil. Ensure thorough mixing and the preparation of a reasonably fine tilth and good growing medium in preparation for planting.

• Turf Areas - Install specified soil mix to a minimum compacted depth of 75mm.

Place the specified soil mix to the required compacted depth and grade to required finished soil levels, in preparation for planting and turfing.

### PLANTING

### Quality and Size of Plant Material

All trees supplied above a 25L container size must be grown and planted in accordance with AS 2303:2019 Tree stock for landscape use. Certification that trees have been grown to AS2303:2018 guidelines is to be provided upon request of Council's Tree Management

### Above - Ground Assessment:

The following plant quality assessment criteria should be followed: Plant true to type, Good vigour and health, free from pest & disease, free from injury, self-supporting, good stem taper, has been pruned correctly, is apically dominant, has even crown symmetry, free from included bark & stem junctions, even trunk position in pot, good stem

### Below - Ground Assessment:

Good root division & direction, rootball occupancy, rootball depth, height of crown, non-suckering For further explanation and description of these assessment criteria, refer to AS2303:2019.

All Plant material shall be to the type and size specified. No substitutions of plant material shall be permitted without written prior approval by the Landscape Architect. No plant shall be accepted which does not conform to the standards listed above

### Stakes and Ties

Provide min. 3 No. Stakes and ties to all plants identified as trees in the plant schedule. Stakes shall be sound, unpainted, straight hardwood, free of knots and pointed at one end. They shall be 2200mm x 50mm x 50mm Hardwood, or approved alternative. Ties shall be 50mm wide

c) Fertilisers
Fertilisers shall be approved slow release fertilisers suitable for the proposed planting types. Note that for native plants, specifically Proteaceae

Mulch shall be an approved equal to "Forest Blend" as supplied by ANL. Mulch shall be completely free from any soil, weeds, rubbish or other

Turf shall be soft leaf Buffalo or equivalent (unless stated otherwise), free from any weeds and other grasses, and be in a healthy growing

### 3.02 INSTALLATION

All planting set out shall be in strict accordance with the drawings, or as directed. Note that proposed tree planting located near services should be adjusted at this stage. Notify Landscape Architect for inspection for approval prior to planting.

All plant material shall be planted as soon after delivery as possible. Planting holes for trees shall be excavated as detailed and specified. Plant containers shall be removed and discarded, and the outer roots gently teased from the soil mass. Immediately set plant in hole and backfill with specified soil mix, incorporating the approved quantity of fertiliser for each plant type. Ensure that plants are set plumb vertically and root balls set to the consolidated finished grades detailed on the drawings. Compact the backfilled soil and saturate by hand watering to expel any remaining

Staking and tying shall be in strict accordance with the drawings and shall occur immediately following plant placement and soil backfilling. All plants identified as "Trees" on the planting schedule shall be staked with a min. 3 stakes.

Mulch for general planter bed shall be an approved equal to "Forest Blend" as supplied by ANL. Mulch shall be completely free from any soil, weeds, rubbish or other debris. Mulch for bio-retention/rain garden area where is required shall be non-floatable materials that could include crushed rock, gravel, coarse river sand, scoria or river pebbles, 4-7mm screenings or similar,

Moisten soil prior to the turf being laid. Turf shall be neatly butt jointed and true to grade to finish flush with adjacent surfaces. Incorporate a lawn fertilizer and thoroughly water in. Keep turf moist until roots have taken and sods/rolls cannot be lifted. Keep all traffic off turf until this has occurred. Allow for top dressing of all turf areas. All turf shall be rolled immediately following installation.

The nature strip (street frontage) for the site is public land, and only authorized works may occur here.

REV DATE

Existing Conditions such as street trees, council planting etc shall be retained and protected during construction, unless specific approval has been granted for new work in this area. Where council policy specifies a particular unit paver, material finish, pattern or treatment, it shall be the contractors responsibility to check and verify that this material & treatment is correct and current prior to undertaking construction works'

### HARDSCAPE WORKS

### 4.01 GENERAL

The Contractor shall undertake the installation of all hardscape works as detailed on the drawing, or where not detailed, by manufacturers

NOTATION/AMENDMENT

Paying - refer to typical details provided, and applicable Australian Standards. Permeable paying may be used as a suitable means of satisfying Council permeable surface requirements, while providing a useable, hardwearing, practical surface. In most instances, the client shall nominate the appropriate paving material to be used.

Australian Standards shall be adhered to in relation to all concrete, masonry & metal work. Some details are typical and may vary on site. All hardscape works shall be setout as per the drawings, and inspected and approved by the Landscape Architect prior to installation. All workmanship shall be of the highest standard. Any queries or problems that arise from hardscape variations should be bought to the attention of the Landscape Architect

Your attention is directed to any obligations or responsibilities under the Dividing Fences Act, 1991 in respect of adjoining property owner/s which may arise from this application. Any enquiries in this regard may be made to the Crown Lands on 1300 886 235.

### 5.01 GENERAL (PERFORMANCE SPECIFICATION)

This is a general Irrigation Performance Specification only, as a guide for projects requiring irrigation systems as part of consent requirements or An automated irrigation system is recommended for the effective establishment of new gardens, and to assist with the success of planting areas

on terraces, over slabs and in Communal Open Spaces

The inclusion of this general specification is no guarantee that an irrigation system forms part of the landscape scope of works, which will be determined by the building contract.

virrigation systems to planting areas shall be a Commercial Grade Irrigation System conforming to all relevant Australian standards, including AS 3500 & the Gas and Electricity (Consumer Safety) Act 2017, Workplace Health & Safety Act 2011, & the latest Sydney Water Code An automated drip-irrigation system is to be installed to all gardens, planters and lawn areas in accordance with the approved Irrigation Design.

This system shall be designed and installed by a qualified and licensed irrigation specialist, to the highest industry standards and to maximise the The Installer is required to obtain all approvals necessary for the completion of works in accordance with the Laws of Australia. Laws of the State

of NSW. Northern Beaches Council By-Laws and Ordinances.

<u>Drawings:</u>
- The Landscape Contractor nominated Licensed Irrigation Specialist shall provide irrigation drawings for approval upon engagement.

Design Requirements:

The irrigation system shall be installed prior to all planting works. It shall incorporate a commercially available irrigation system, with

It shall incorporate a suitable back flow prevention device for the scale of works, an in-line filter, check valves, and suitable high and low density poly hose fittings and PVC piping to achieve flow rates suitable for specified planting.

The irrigation application rate shall not exceed the infiltration rate of the soil or creates run-off.

The landscape contractor shall check the existing pressure available from the ring mains and size irrigation piping to suit. Supply shall be

All piping and fittings shall be buried 50mm below the finished soil levels in garden and lawn areas, and secured in position at 500mm

### Size of pipes shall be selected to ensure the working pressure at the end of the line does not decrease by more than 5%

### Services Co-ordination:

Co-ordination required by Landscape Contractor or Project Manager to provide required conduit, pipe work and penetration through slabs and planter walls for water and power provision

The Landscape Contractor shall be engaged with the Irrigation Specialist to co-ordinate with the Project Manager to identify the preferred

Project Manager and Landscape Contractor to establish area suitable for irrigation control system with required area, power provision and

Testing & Defects:
Upon completion of installation, the system shall be tested, including

- Main Line Pressure Test: The main line is pressurised to test for leaks. All valves are shut and the pressure is taken over a determined
- Dripper Pressure Test: Measurement at flushing valves are taken and the pressure gauged to make sure it conforms to the manufacturer recommendations. The inlet pressure is then tested under the same conditions to check it does not exceed 300Kpa.
- All components are to be satisfactorily functional and operational prior to approval. Should any defect develop, or the capacity or efficiency of the system decline during the agreed maintenance system, then these faults shall be immediately rectified.

6.01 GENERAL

Warranty:
- A full 12 month warranty shall be included to cover labour and all parts.

Further Documentation:
- On request, a detailed irrigation performance specification report can be issued.

### CONSOLIDATION AND MAINTENANCE

The consolidation and maintenance period shall be 12 months beginning from the approved completion of the specified construction work (Practical Completion). A qualified landscape maintenance contractor shall undertake the required landscape maintenance works. Consolidation and maintenance shall mean the care and maintenance of Contracted works by accepted landscaping or horticultural practices, ensuring that all plants are in optimum growing conditions and appearance at all times, as well as rectifying any defects that become apparent in the contra

This shall include, but not be limited to, the following items where and as required:

- Watering all planting and lawn areas / irrigation maintenance.
- Clearing litter and other debris from landscaped areas.
- Removing weeds, pruning and general plant maintenance. Replacement of damaged, stolen or unhealthy plants.
- Make good areas of soil subsidence or erosion
- Topping up of mulched areas Spray / treatment for Insect and disease control.
- Fertilizing with approved fertilizers at correct rates.

  Mowing lawns & trimming edges each 14 days in summer or 18 days in winter
- Adjusting ties to Stakes
- Maintenance of all paving, retaining and hardscape eler

On the completion of the maintenance period, the landscape works shall be inspected and at the satisfaction of the superintendent or landscape

# General Notes:

ay vary slightly in Scale for that indicated on plans. Report any discrepancies to the Landscap Copyright Sulphurcrest Enterprises Pty Ltd Trading as CONZEPT (ABN: 75 623 405 630)

amendment at the discretion of our office. If so, Concept is not liable for any loss, damage, alteration or whether special, consequential, direct or indirect, suffered by you or any other person as a result of your us of this drawing for construction purposes. as all agreed payments are made in full. We retain the right to withdraw this information from the asse





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A 06.02.20 Preliminary plan prepared for review Northern Beaches **GANNET DEVELOPMENTS** ARCHITECT **BKA ARCHITECTURE** STATUS / ISSUE DA - ISSUE A

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PROPOSED APARTMENT DEVELOPMENT

**SPECIFICATIONS** 

**691 PITTWATER ROAD DEE WHY** 

LPDA 20 - 152 / 5 AS SHOWN @ A3 FEB 2020 K.Z R.F