


SYMBOLS	
F.F.L.	FINISHED FLOOR LEVEL
F.G.L.	FINISHED GARAGE LEVEL
T.K.	TOP OF KERB
* 11.0	FINISHED LEVEL
+ 11.0	EXISTING LEVEL
S.L.	SURFACE LEVEL
I.L.	INVERT LEVEL
20 R	ROOF CATCHMENT AREA (m2)
201	IMPERVIOUS CATCHMENT AREA (m2)
20 L	LANDSCAPED CATCHMENT AREA (m2)
• DP	Ø100 DOWN PIPE OR EQUIVALENT
• SP	SPREADER
• VD	VERTICAL DROP
• VR	VERTICAL RISER
🖵 OF	SAFETY OVERFLOW
	RAIN WATER HEAD & DOWN PIPE
\otimes	CLEAN OUT POINT
⊜ SUMP	Ø150 SUMP
	CONCRETE COVER JUNCTION PIT
	GRATED INLET PIT 450x450
	200Wx100D GRATED DRAIN WITH 2% BTM SLOPE
	STORMWATER PIPE
	SUSPENDED STORMWATER PIPE
	STORMWATER PIPE TO RWT
	PUMP LINE
	Ø100 SUBSOIL PIPE
<u> </u>	SILT FENCE
$\overline{\Box}$	OVERLAND FLOW
←───	FALLS

- 1. ALL EROSION AND SILTATION CONTROL DEVICES ARE TO BE PLACED PRIOR TO THE COMMENCEMENT OF ANY CONSTRUCTION WORKS, AND ALL SILT TRAPS ARE TO HAVE DEPOSITED SILT REMOVED REGULARLY DURING CONSTRUCTION.
- 2. ALL TREES ARE TO BE PRESERVED UNLESS INDICATED OTHERWISE ON THE ARCHITECT'S OR LANDSCAPE ARCHITECT'S DRAWINGS. EXISTING GRASS COVER SHALL BE MAINTAINED EXCEPT IN AREAS CLEARED FOR BUILDINGS, PAVEMENTS ETC.
- 3. INSTALL TEMPORARY SEDIMENT BARRIERS TO ALL INLET PITS LIKELY TO COLLECT SILT LADDEN WATER, TO COUNCIL'S STANDARDS
- 4. NOT WITHSTANDING DETAILS SHOWN IT IS THE CONTRACTORS SOLE RESPONSIBILITY TO ENSURE THAT ALL SITE ACTIVITIES COMPLY WITH THE REQUIREMENTS OF THE CLEAN
- WATERS ACT. 5. ALL TOPSOIL TO BE CONSERVED FOR RE-USE ON SITE
- NOTES
- ALL LINES ARE TO BE Ø100 U.P.V.C @ MIN 1.0% GRADE UNLESS NOTED OTHERWISE. CHARGED LINES TO BE SEWER GRADE & SEALED.
- 2. IT IS THE CONTRACTORS RESPONSIBILITY TO LOCATE & LEVEL ALL EXISTING SERVICES PRIOR TO THE COMMENCEMENT OF ANY EARTHWORKS.
- 3. ALL PIPES TO HAVE MIN 150mm COVER IF LOCATED WITHIN PROPERTY. 4. ALL PITS IN DRIVEWAYS TO BE 450x450 CONCRETE AND ALL PITS IN LANDSCAPED AREAS TO BE 450x450 PLASTIC.
- PITS LESS THAN 600 DEEP MAY BE BRICK, PRECAST OR CONCRETE. 5. 6. PITS DEEPER THAN 900 MUST BE 900x900 AND HAVE STEP RUNGS AT 300 CENTRES.
- 7. ALL BALCONIES AND ROOFS TO BE DRAINED AND TO HAVE SAFETY OVERFLOWS IN
- ACCORDANCE WITH RELEVANT AUSTRALIAN STANDARDS. 8. ALL EXTERNAL SLABS TO BE WATERPROOFED.
- 9. ALL GRATES TO HAVE CHILD PROOF LOCKS.
- 10. ALL DRAINAGE WORKS TO AVOID TREE ROOTS. 11. ALL DP'S TO HAVE LEAF GUARDS
- 12. ALL EXISTING LEVELS TO BE CONFIRMED BY BUILDER PRIOR TO CONSTRUCTION.
- 13. ALL WORK WITHIN COUNCIL RESERVE TO BE INSPECTED BY COUNCIL PRIOR TO CONSTRUCTION.
- 14. COUNCIL'S ISSUED FOOTWAY DESIGN LEVELS TO BE INCORPORATED INTO THE FINISHED LEVELS ONCE ISSUED BY COUNCIL.
- 15. ALL WORK SHALL BE IN ACCORDANCE WITH B.C.A. AND A.S.3500.3. 16. EXISTING STORMWATER PIPE LOCATIONS HAVE BEEN ASSUMED. PLUMBER TO INSPECT

PRIOR TO WORKS AND UPGRADE PIPES AS NECESSARY.

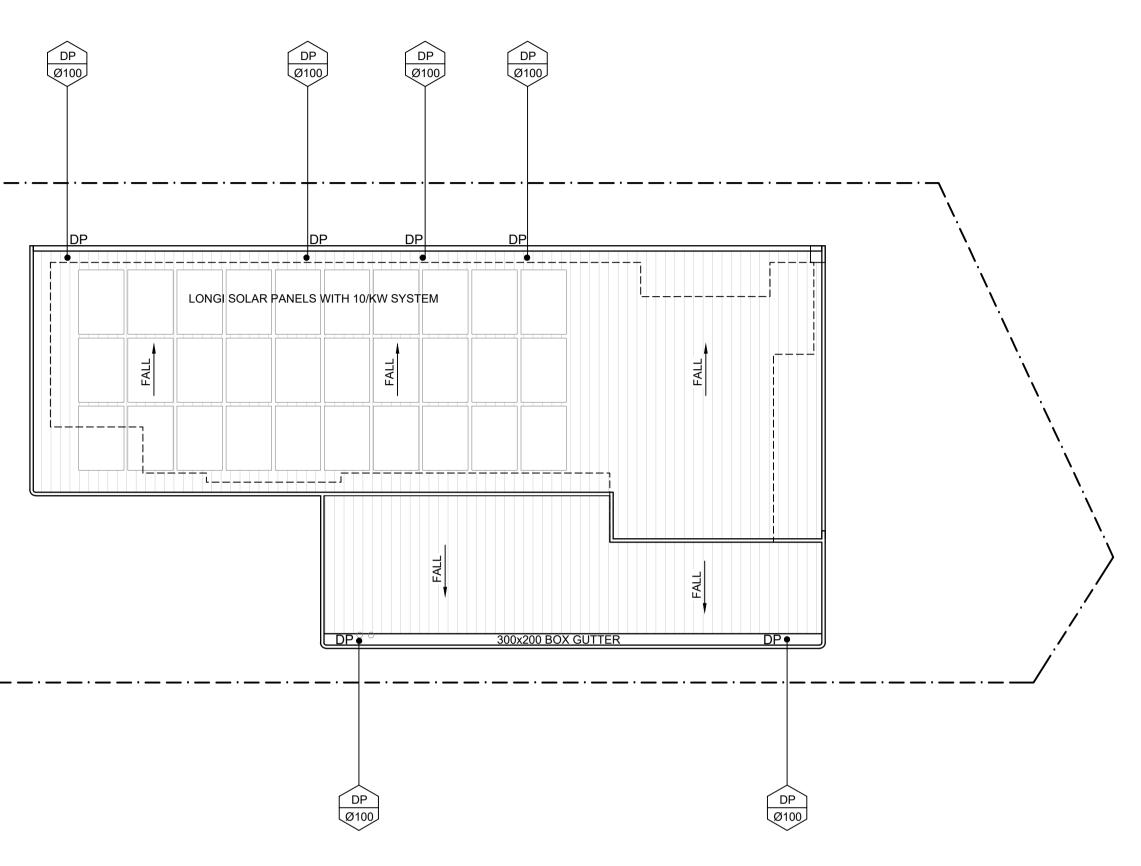

ROOF DRAINAGE PLAN


SCALE 1:100 NOTE:

- 1. MINIMUM ROOF FALL 1% TO OUTLETS
- WATERPROOF ALL CONCRETE ROOFS
 PROVIDE SAFETY OVERFLOW TO ALL ROOFS
- 4. ALL DOWNPIPES CHARGED TO THE RAINWATER TANK ARE TO BE SEALED UP TO GUTTER LEVEL & BE PRESSURE TESTED AND CERTIFIED. 5. ALL DOWNPIPES TO BE CONSTRUCTED OF ONE MATERIAL FOR AESTHETICS REASONS
- AND PAINTED TO PROTECT THEM AGAINST ULTRA-VIOLET LIGHT DAMAGE.

REFER TO DRAWING No. SW04 & SW05 FOR ALL DRAINAGE DETAILS

Revision Rev Date Description A 05.12.2024 ISSUE FOR DA B 02.05.2025 ISSUE FOR DA (SW REDESIGN) C 15.05.2025 ISSUE FOR DA (AMENDED ARCH) PROJECT: PROPOSED NEW RESIDENCE 2 PRINCE EDWARD ROAD, SEAFORTH COUNCIL: NORTHERN BEACHES CLIENT: SOPHIA & STUART NAYLOR BUILDER: - - - ARCHITECT: NEW PARADIGM DESIGN PTY LTD DRAWING TITLE: ROOF DRAINAGE PLAN Image: Structure of the structure of	18	SSU	ΕF	OR	DA	ON	ILY	
A 05.12.2024 ISSUE FOR DA B 02.05.2025 ISSUE FOR DA (SW REDESIGN) C 15.05.2025 ISSUE FOR DA (AMENDED ARCH) PROJECT: PROPOSED NEW RESIDENCE 2 PRINCE EDWARD ROAD, SEAFORTH COUNCIL: NORTHERN BEACHES CLIENT: SOPHIA & STUART NAYLOR BUILDER: - ARCHITECT: NEW PARADIGM DESIGN PTY LTD DRAWING TITLE: ROOF DRAINAGE PLAN STUDENTION CONSULTANTS PTY LTD 3/10 Childs Road, Chipping Norton, NSW 2170 e: info@neconsultants.com.au ABN:97 672 220 345	Re	vision						
B 02.05.2025 ISSUE FOR DA (SW REDESIGN) C 15.05.2025 ISSUE FOR DA (AMENDED ARCH) PROJECT: PROPOSED NEW RESIDENCE 2 PRINCE EDWARD ROAD, SEAFORTH COUNCIL: NORTHERN BEACHES CLIENT: SOPHIA & STUART NAYLOR BUILDER: - ARCHITECT: NEW PARADIGM DESIGN PTY LTD DRAWING TITLE: ROOF DRAINAGE PLAN NOF DRAINAGE PLAN 3/10 Childs Road, Chipping Norton, NSW 2170 e: info@neonsultants pty LtD 3/10 Childs Road, Chipping Norton, NSW 2170 e: info@neonsultants com.au ABN:97 672 826 345	Rev	Date		Descrip	tion			
C 15.05.2025 ISSUE FOR DA (AMENDED ARCH) PROJECT: PROPOSED NEW RESIDENCE 2 PRINCE EDWARD ROAD, SEAFORTH COUNCIL: NORTHERN BEACHES CLIENT: SOPHIA & STUART NAYLOR BUILDER: ARCHITECT: NEW PARADIGM DESIGN PTY LTD DRAWING TITLE: ROOF DRAINAGE PLAN NUMBER CONSULTANTS PTY LTD 3/10 Childs Road, Chipping Norton, NSW 2170 e: info@neonsultations.com.au ABN:97 672 826 345	A	05.12.2	024	ISSUE I	FOR DA	1		
PROJECT: PROPOSED NEW RESIDENCE 2 PRINCE EDWARD ROAD, SEAFORTH COUNCIL: NORTHERN BEACHES CLIENT: SOPHIA & STUART NAYLOR BUILDER: - ARCHITECT: NEW PARADIGM DESIGN PTY LTD DRAWING TITLE: ROOF DRAINAGE PLAN NOF DRAINAGE PLAN STUDIAL ENGINEERING CONSULTANTS PTY LTD 3/10 Childs Road, Chipping Norton, NSW 2170 e: info@neconsultat.com.au ABN:97 672 826 345	_					· ·	,	
PROPOSED NEW RESIDENCE 2 PRINCE EDWARD ROAD, SEAFORTH COUNCIL: NORTHERN BEACHES CLIENT: SOPHIA & STUART NAYLOR BUILDER: - ARCHITECT: NEW PARADIGM DESIGN PTY LTD DRAWING TITLE: ROOF DRAINAGE PLAN NO CONSULTANTS PTY LTD 3/10 Childs Road, Chipping Norton, NSW 2170 e: info@neconsultants.com.au ABN:97 672 826 345	С	15.05.2	025	ISSUE I	FOR DA	(AMEN	DED ARCH)	
PROPOSED NEW RESIDENCE 2 PRINCE EDWARD ROAD, SEAFORTH COUNCIL: NORTHERN BEACHES CLIENT: SOPHIA & STUART NAYLOR BUILDER: - ARCHITECT: NEW PARADIGM DESIGN PTY LTD DRAWING TITLE: ROOF DRAINAGE PLAN NO CONSULTANTS PTY LTD 3/10 Childs Road, Chipping Norton, NSW 2170 e: info@neconsultants.com.au ABN:97 672 826 345								
PROPOSED NEW RESIDENCE 2 PRINCE EDWARD ROAD, SEAFORTH COUNCIL: NORTHERN BEACHES CLIENT: SOPHIA & STUART NAYLOR BUILDER: - ARCHITECT: NEW PARADIGM DESIGN PTY LTD DRAWING TITLE: ROOF DRAINAGE PLAN NO CONSULTANTS PTY LTD 3/10 Childs Road, Chipping Norton, NSW 2170 e: info@neconsultants.com.au ABN:97 672 826 345								
PROPOSED NEW RESIDENCE 2 PRINCE EDWARD ROAD, SEAFORTH COUNCIL: NORTHERN BEACHES CLIENT: SOPHIA & STUART NAYLOR BUILDER: - ARCHITECT: NEW PARADIGM DESIGN PTY LTD DRAWING TITLE: ROOF DRAINAGE PLAN NO CONSULTANTS PTY LTD 3/10 Childs Road, Chipping Norton, NSW 2170 e: info@neconsultants.com.au ABN:97 672 826 345								
NORTHERN BEACHES CLIENT: SOPHIA & STUART NAYLOR BUILDER: - ARCHITECT: NEW PARADIGM DESIGN PTY LTD DRAWING TITLE: ROOF DRAINAGE PLAN NUMBERING CONSULTANTS PTY LTD 3/10 Childs Road, Chipping Norton, NSW 2170 e: info@neconsultants.com.au ABN:97 672 826 345	PRC 2 PR	POSE	E <mark>d Ne</mark> Edwaf			ENCE		
SOPHIA & STUART NAYLOR BUILDER: - ARCHITECT: NEW PARADIGM DESIGN PTY LTD DRAWING TITLE: ROOF DRAINAGE PLAN NI LICK CONSULTANTS PTY LTD 3/10 Childs Road, Chipping Norton, NSW 2170 e: info@neconsultants.com.au ABN:97 672 826 345		-		EACH	ES			
- ARCHITECT: NEW PARADIGM DESIGN PTY LTD DRAWING TITLE: ROOF DRAINAGE PLAN NOTIONAL ENGINEERING CONSULTANTS PTY LTD 3/10 Childs Road, Chipping Norton, NSW 2170 e: info@neconsultants.com.au ABN:97 672 826 345			STU	ART	NAYL	OR		
NEW PARADIGM DESIGN PTY LTD DRAWING TITLE: ROOF DRAINAGE PLAN INTERVIEW OF DRAINAGE PLAN INTERVIEW OF DRAINAGE PLAN INTERVIEW OF DRAINAGE PLAN INTERVIEW OF DRAINAGE PLAN	BUIL -	DER:						
ROOF DRAINAGE PLAN								
3/10 Childs Road, Chipping Norton, NSW 2170 e: info@neconsultants.com.au ABN:97 672 826 345								
Chipping Norton, NSW 2170 e: info@neconsultants.com.au ABN:97 672 826 345	NATIONAL ENGINEERING CONSULTANTS PTY LTD							
	Chipping Norton, NSW 2170 e: info@neconsultants.com.au ABN:97 672 826 345 ACN: 672 826 345							
NORTH: DESIGNED: DRAWN: CHECKED: J.T. V.S. J.T.	NORTH:	\geq	J.	Т.	V		J.T.	
APPROVED: JOSEPH SAAD TANNOUS SIZE: BEng (Hons), MIEAust, CPEng A1	F	N		JOSEPH BEng (Hons),	MIEAust, CPEn	g	A1	
JOB NO: 24-1086 C DRAWING NO: SW01				086	REVISION:	C		



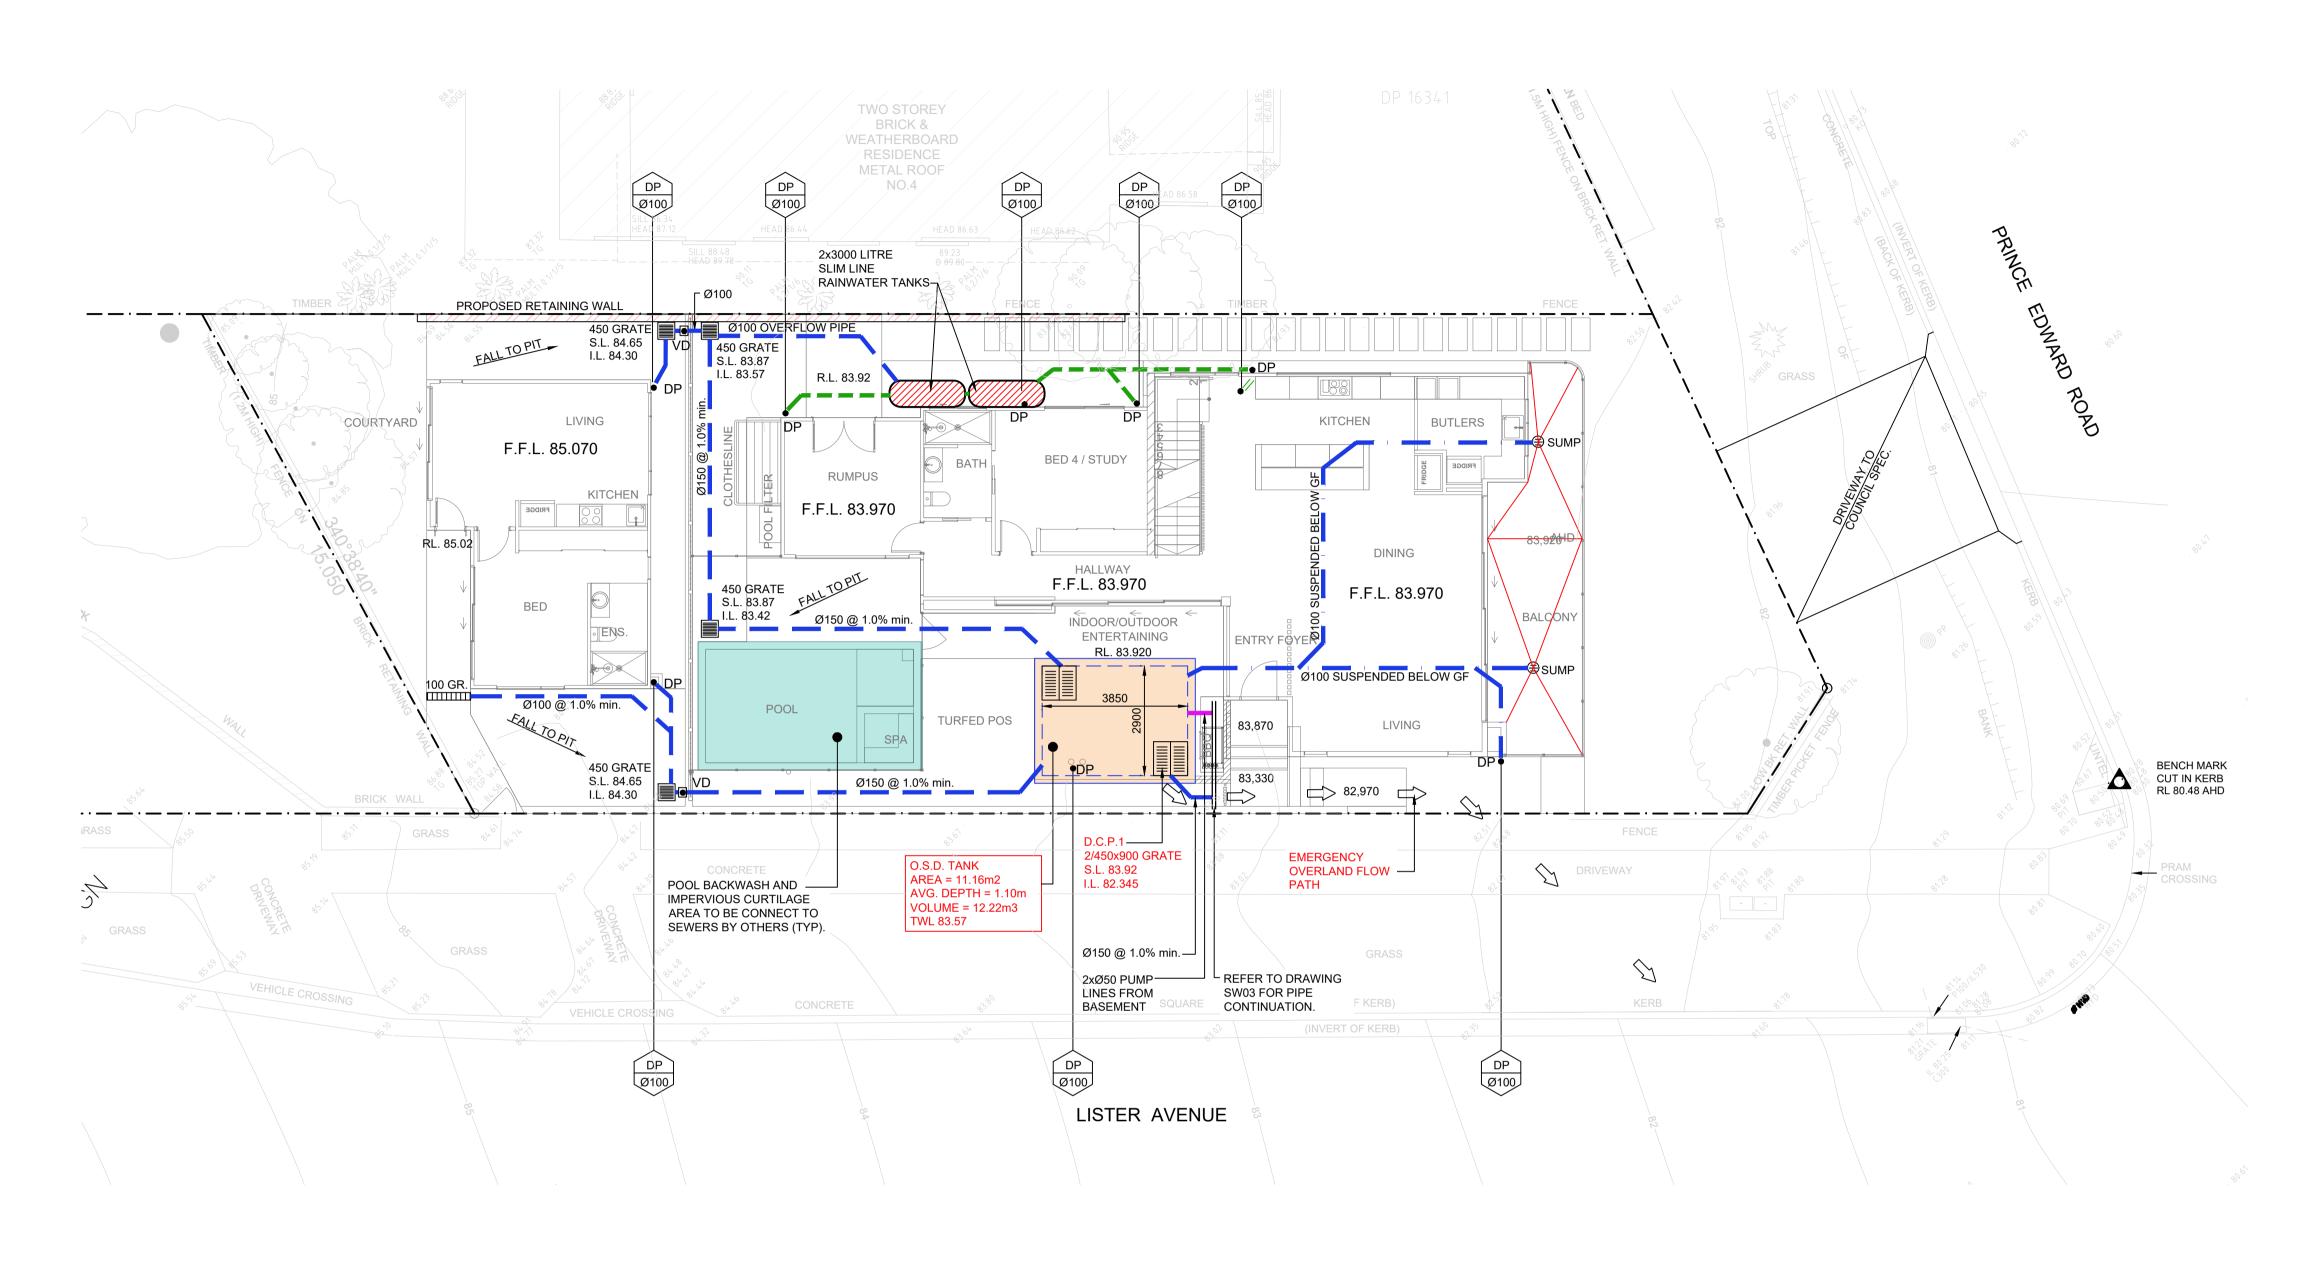

SYMBOLS	5
F.F.L.	FINISHED FLOOR LEVEL
F.G.L.	FINISHED GARAGE LEVEL
T.K.	TOP OF KERB
* 11.0	FINISHED LEVEL
+ 11.0	EXISTING LEVEL
S.L.	SURFACE LEVEL
I.L.	INVERT LEVEL
20 R	ROOF CATCHMENT AREA (m2)
20	IMPERVIOUS CATCHMENT AREA (m2)
20 L	LANDSCAPED CATCHMENT AREA (m2)
● DP	Ø100 DOWN PIPE OR EQUIVALENT
SP	SPREADER
• VD	VERTICAL DROP
• VR	VERTICAL RISER
🖵 OF	SAFETY OVERFLOW
	RAIN WATER HEAD & DOWN PIPE
\otimes	CLEAN OUT POINT
⊜ SUMP	Ø150 SUMP
	CONCRETE COVER JUNCTION PIT
	GRATED INLET PIT 450x450
	200Wx100D GRATED DRAIN WITH 2% BTM SLOPE
	STORMWATER PIPE
	SUSPENDED STORMWATER PIPE
	STORMWATER PIPE TO RWT
	PUMP LINE

FALLS

SILT FENCE

Ø100 SUBSOIL PIPE

OVERLAND FLOW

- 1. ALL EROSION AND SILTATION CONTROL DEVICES ARE TO BE PLACED PRIOR TO THE COMMENCEMENT OF ANY CONSTRUCTION WORKS, AND ALL SILT TRAPS ARE TO HAVE DEPOSITED SILT REMOVED REGULARLY DURING CONSTRUCTION.
- 2. ALL TREES ARE TO BE PRESERVED UNLESS INDICATED OTHERWISE ON THE ARCHITECT'S OR LANDSCAPE ARCHITECT'S DRAWINGS. EXISTING GRASS COVER SHALL BE MAINTAINED EXCEPT IN AREAS CLEARED FOR BUILDINGS, PAVEMENTS ETC.
- 3. INSTALL TEMPORARY SEDIMENT BARRIERS TO ALL INLET PITS LIKELY TO COLLECT SILT LADDEN WATER, TO COUNCIL'S STANDARDS
- NOT WITHSTANDING DETAILS SHOWN IT IS THE CONTRACTORS SOLE RESPONSIBILITY TO ENSURE THAT ALL SITE ACTIVITIES COMPLY WITH THE REQUIREMENTS OF THE CLEAN WATERS ACT.
- WATERS ACT. 5. ALL TOPSOIL TO BE CONSERVED FOR RE-USE ON SITE

NOTES

_____ · · · _____

 \leftarrow

 \leq

- 1. ALL LINES ARE TO BE Ø100 U.P.V.C @ MIN 1.0% GRADE UNLESS NOTED OTHERWISE. CHARGED LINES TO BE SEWER GRADE & SEALED.
- 2. IT IS THE CONTRACTORS RESPONSIBILITY TO LOCATE & LEVEL ALL EXISTING SERVICES PRIOR TO THE COMMENCEMENT OF ANY EARTHWORKS.
- ALL PIPES TO HAVE MIN 150mm COVER IF LOCATED WITHIN PROPERTY.
 ALL PITS IN DRIVEWAYS TO BE 450x450 CONCRETE AND ALL PITS IN LANDSCAPED AREAS TO BE 450x450 PLASTIC.
- PITS LESS THAN 600 DEEP MAY BE BRICK, PRECAST OR CONCRETE.
 PITS DEEPER THAN 900 MUST BE 900x900 AND HAVE STEP RUNGS AT 300 CENTRES.
- ALL BALCONIES AND ROOFS TO BE DRAINED AND TO HAVE SAFETY OVERFLOWS IN
- ACCORDANCE WITH RELEVANT AUSTRALIAN STANDARDS.8. ALL EXTERNAL SLABS TO BE WATERPROOFED.
- 9. ALL GRATES TO HAVE CHILD PROOF LOCKS.
- ALL DRAINAGE WORKS TO AVOID TREE ROOTS.
 ALL DP'S TO HAVE LEAF GUARDS
- 12. ALL EXISTING LEVELS TO BE CONFIRMED BY BUILDER PRIOR TO CONSTRUCTION.
- 13. ALL WORK WITHIN COUNCIL RESERVE TO BE INSPECTED BY COUNCIL PRIOR TO
- CONSTRUCTION. 14. COUNCIL'S ISSUED FOOTWAY DESIGN LEVELS TO BE INCORPORATED INTO THE FINISHED LEVELS ONCE ISSUED BY COUNCIL.
- 15. ALL WORK SHALL BE IN ACCORDANCE WITH B.C.A. AND A.S.3500.3.
- 16. EXISTING STORMWATER PIPE LOCATIONS HAVE BEEN ASSUMED. PLUMBER TO INSPECT PRIOR TO WORKS AND UPGRADE PIPES AS NECESSARY.

GROUND FLOOR DRAINAGE PLAN

SCALE 1:100 NOTE:

- MINIMUM ROOF FALL 1% TO OUTLETS
 WATERPROOF ALL CONCRETE ROOFS
- WATERPROOF ALL CONCRETE ROOFS
 PROVIDE SAFETY OVERFLOW TO ALL ROOFS
- ALL BALCONIES TO HAVE FLOOR WASTE AND 1% FALL WITH SAFETY OVERFLOW
 ALL DOWNPIPES CHARGED TO THE RAINWATER TANK ARE TO BE SEALED UP TO GUTTER
- LEVEL & BE PRESSURE TESTED AND CERTIFIED.
- 6. ALL DOWNPIPES TO BE CONSTRUCTED OF ONE MATERIAL FOR AESTHETICS REASONS AND PAINTED TO PROTECT THEM AGAINST ULTRA-VIOLET LIGHT DAMAGE.

REFER TO DRAWING No. SW04 & SW05 FOR ALL DRAINAGE DETAILS

ISSUE FOR DA ONLY

Revision Rev Date Description A 05.12.2024 ISSUE FOR DA B 02.05.2025 ISSUE FOR DA (SW REDESIGN) C 15.05.2025 ISSUE FOR DA (AMENDED ARCH)

PROJECT:

PROPOSED NEW RESIDENCE 2 PRINCE EDWARD ROAD, SEAFORTH

COUNCIL: NORTHERN BEACHES

CLIENT: SOPHIA & STUART NAYLOR

BUILDER:


ARCHITECT: NEW PARADIGM DESIGN PTY LTD

DRAWING TITLE: GROUND FLOOR DRAINAGE PLAN



3/10 Childs Road,					
Chipping Norton, NSW 2170					
e: info@neconsultants.com.au					
ABN:97 672 826 345					
ACN: 672 826 34	-5				
NORTH:	DESIGNED:	DRAWN:	CHECKED:		
\frown	J.T.	V.S.	J.T.		
A	APPROVED: JOSEPH	SIZE:			
$\left(\overline{7}_{1} \right)$		A1			
$\langle / / \rangle \rangle$	JOB No:	REVISION:	DRAWING No:		
V	24-1086	С	SW02		
	APPROVED: JOSEPH BEng (Hons),	I SAAD TANNOUS MIEAust, CPEng	SIZE: A1 DRAWING No:		



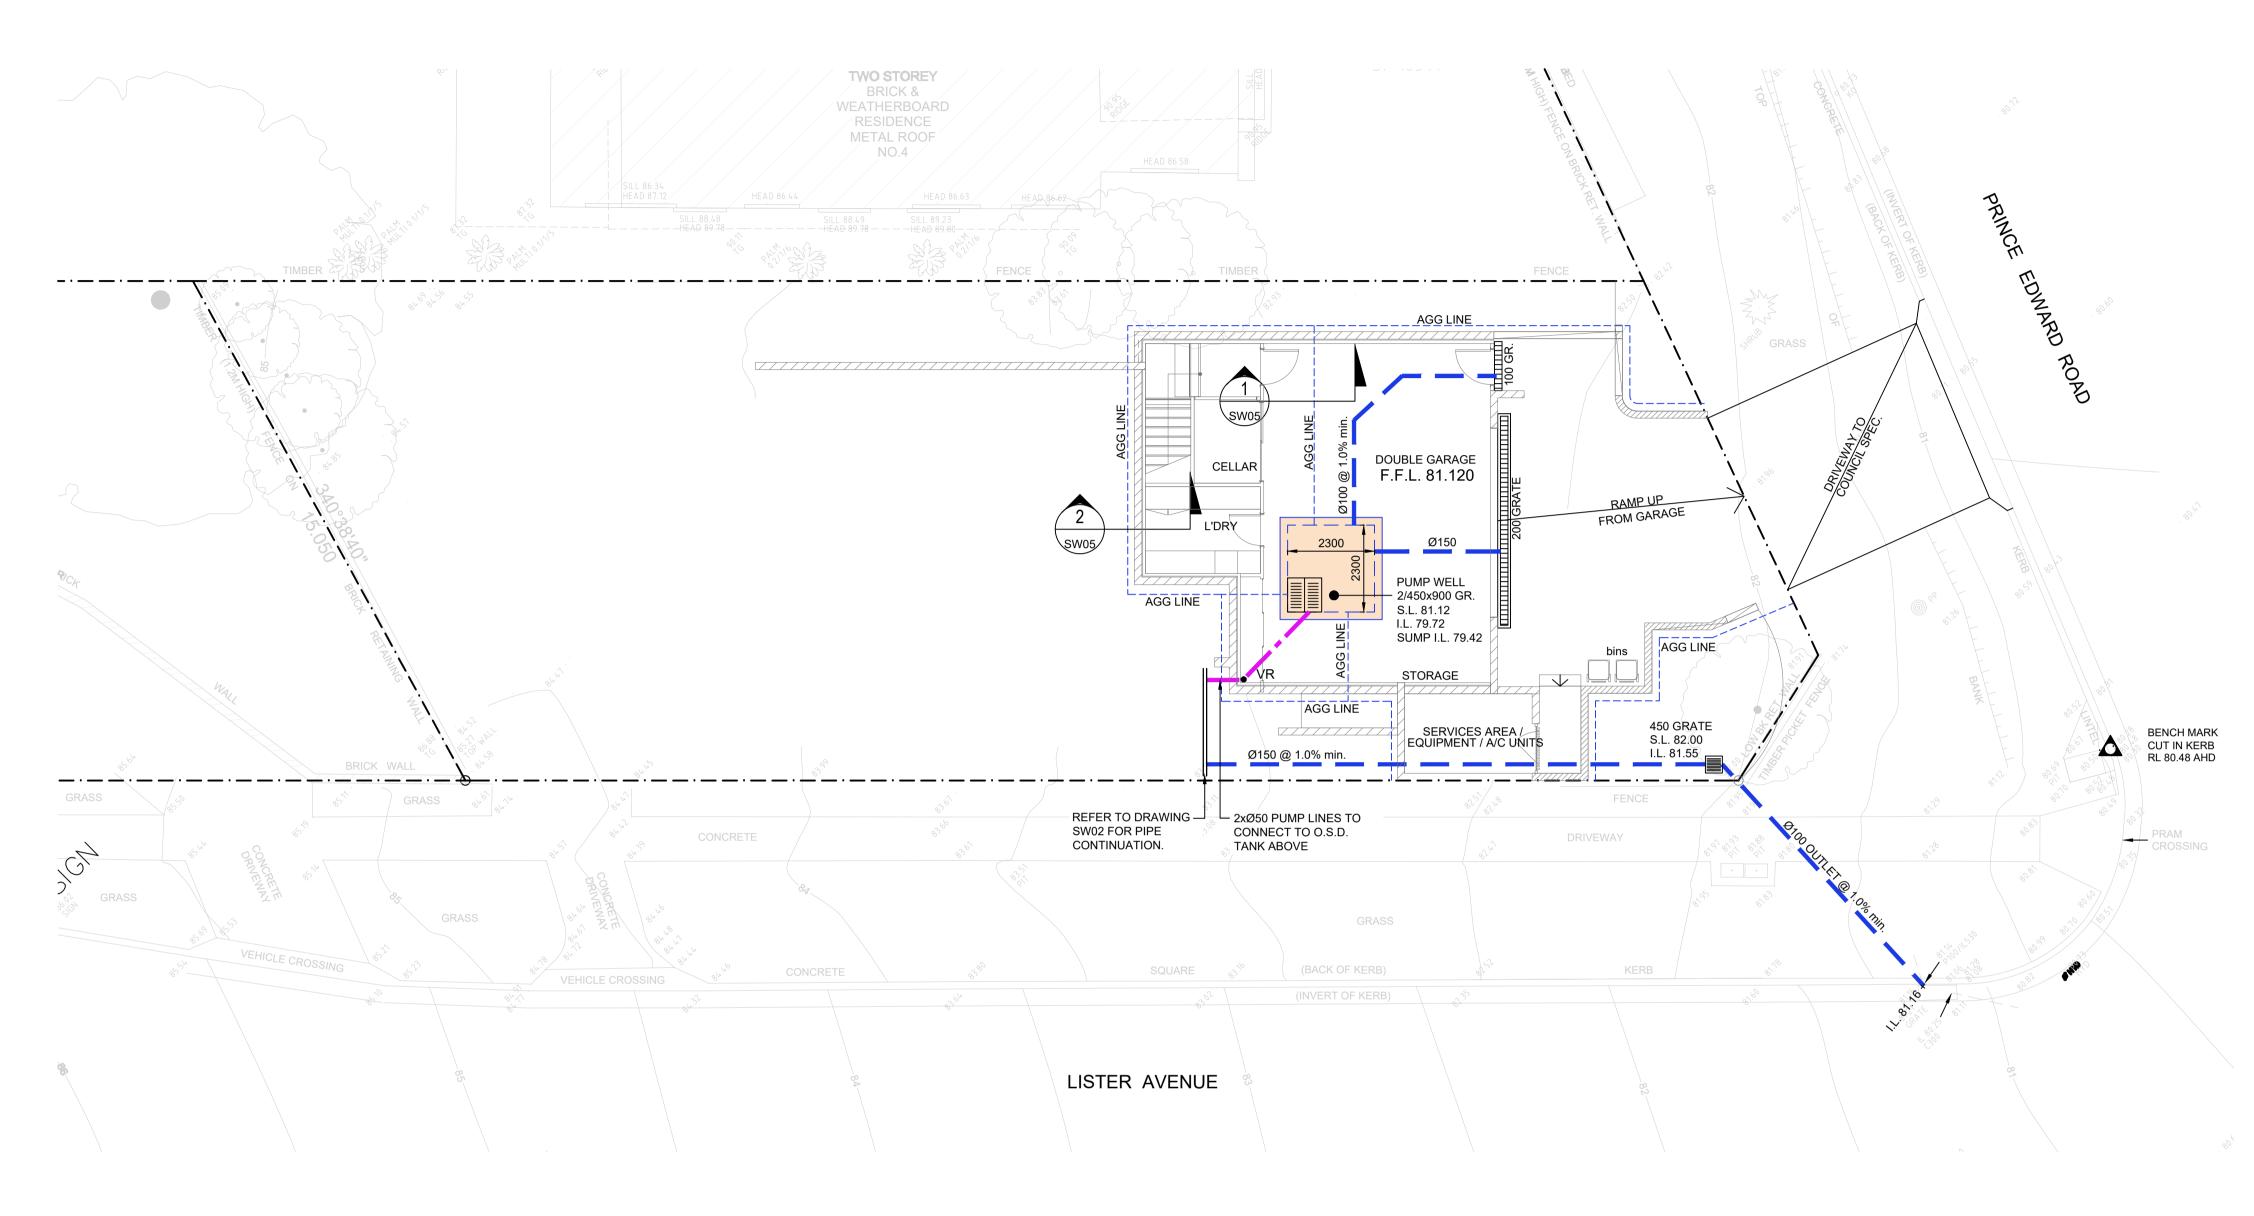

SYMBOLS	
F.F.L.	FINISHED FLOOR LEVEL
F.G.L.	FINISHED GARAGE LEVEL
Т.К.	TOP OF KERB
* 11.0	FINISHED LEVEL
+ 11.0	EXISTING LEVEL
S.L.	SURFACE LEVEL
I.L.	INVERT LEVEL
20 R	ROOF CATCHMENT AREA (m2)
201	IMPERVIOUS CATCHMENT AREA (m2)
20 L	LANDSCAPED CATCHMENT AREA (m2)
• DP	Ø100 DOWN PIPE OR EQUIVALENT
• SP	SPREADER
• VD	VERTICAL DROP
• VR	VERTICAL RISER
- OF	SAFETY OVERFLOW
	RAIN WATER HEAD & DOWN PIPE
\otimes	CLEAN OUT POINT
⊜ SUMP	Ø150 SUMP
	CONCRETE COVER JUNCTION PIT
	GRATED INLET PIT 450x450
	200Wx100D GRATED DRAIN WITH 2% BTM SLOPE
	STORMWATER PIPE
	SUSPENDED STORMWATER PIPE
	STORMWATER PIPE TO RWT
	PUMP LINE
	Ø100 SUBSOIL PIPE
<u> </u>	SILT FENCE
$\langle \Box$	OVERLAND FLOW
<u> </u>	FALLS

- 1. ALL EROSION AND SILTATION CONTROL DEVICES ARE TO BE PLACED PRIOR TO THE COMMENCEMENT OF ANY CONSTRUCTION WORKS, AND ALL SILT TRAPS ARE TO HAVE DEPOSITED SILT REMOVED REGULARLY DURING CONSTRUCTION.
- 2. ALL TREES ARE TO BE PRESERVED UNLESS INDICATED OTHERWISE ON THE ARCHITECT'S OR LANDSCAPE ARCHITECT'S DRAWINGS. EXISTING GRASS COVER SHALL BE MAINTAINED EXCEPT IN AREAS CLEARED FOR BUILDINGS, PAVEMENTS ETC.
- 3. INSTALL TEMPORARY SEDIMENT BARRIERS TO ALL INLET PITS LIKELY TO COLLECT SILT LADDEN WATER, TO COUNCIL'S STANDARDS
- NOT WITHSTANDING DETAILS SHOWN IT IS THE CONTRACTORS SOLE RESPONSIBILITY TO ENSURE THAT ALL SITE ACTIVITIES COMPLY WITH THE REQUIREMENTS OF THE CLEAN WATERS ACT.
- WATERS ACT.ALL TOPSOIL TO BE CONSERVED FOR RE-USE ON SITE

NOTES

- 1. ALL LINES ARE TO BE Ø100 U.P.V.C @ MIN 1.0% GRADE UNLESS NOTED OTHERWISE. CHARGED LINES TO BE SEWER GRADE & SEALED.
- 2. IT IS THE CONTRACTORS RESPONSIBILITY TO LOCATE & LEVEL ALL EXISTING SERVICES PRIOR TO THE COMMENCEMENT OF ANY EARTHWORKS.
- ALL PIPES TO HAVE MIN 150mm COVER IF LOCATED WITHIN PROPERTY.
 ALL PITS IN DRIVEWAYS TO BE 450x450 CONCRETE AND ALL PITS IN LANDSCAPED AREAS TO BE 450x450 PLASTIC.
- PITS LESS THAN 600 DEEP MAY BE BRICK, PRECAST OR CONCRETE.
 PITS DEEPER THAN 900 MUST BE 900x900 AND HAVE STEP RUNGS AT 300 CENTRES.
- ALL BALCONIES AND ROOFS TO BE DRAINED AND TO HAVE SAFETY OVERFLOWS IN
- ACCORDANCE WITH RELEVANT AUSTRALIAN STANDARDS.8. ALL EXTERNAL SLABS TO BE WATERPROOFED.
- 9. ALL GRATES TO HAVE CHILD PROOF LOCKS.
- ALL DRAINAGE WORKS TO AVOID TREE ROOTS.
 ALL DP'S TO HAVE LEAF GUARDS
- 12. ALL EXISTING LEVELS TO BE CONFIRMED BY BUILDER PRIOR TO CONSTRUCTION.
- 13. ALL WORK WITHIN COUNCIL RESERVE TO BE INSPECTED BY COUNCIL PRIOR TO
- CONSTRUCTION. 14. COUNCIL'S ISSUED FOOTWAY DESIGN LEVELS TO BE INCORPORATED INTO THE FINISHED LEVELS ONCE ISSUED BY COUNCIL.
- 15. ALL WORK SHALL BE IN ACCORDANCE WITH B.C.A. AND A.S.3500.3.
- 16. EXISTING STORMWATER PIPE LOCATIONS HAVE BEEN ASSUMED. PLUMBER TO INSPECT PRIOR TO WORKS AND UPGRADE PIPES AS NECESSARY.

BASEMENT DRAINAGE PLAN

SCALE 1:100 NOTE:

- ENGINEER TO INSPECT D.C.P.1 DURING CONSTRUCTION
 MINIMUM ROOF FALL 1% TO OUTLETS
- 3. WATERPROOF ALL CONCRETE ROOFS
- PROVIDE SAFETY OVERFLOW TO ALL ROOFS
 ALL BALCONIES TO HAVE FLOOR WASTE AND 1% FALL WITH SAFETY OVERFLOW
- ALL DOWNPIPES CHARGED TO THE RAINWATER TANK ARE TO BE SEALED UP TO GUTTER
- LEVEL & BE PRESSURE TESTED AND CERTIFIED. 7. ALL DOWNPIPES TO BE CONSTRUCTED OF ONE MATERIAL FOR AESTHETICS REASONS
- AND PAINTED TO PROTECT THEM AGAINST ULTRA-VIOLET LIGHT DAMAGE.

REFER TO DRAWING No. SW04 & SW05 FOR ALL DRAINAGE DETAILS

ISSUE FOR DA ONLY

ISSUE FOR DA ONL I Rev Date Description A 05.12.2024 ISSUE FOR DA B 02.05.2025 ISSUE FOR DA (SW REDESIGN) C 15.05.2025 ISSUE FOR DA (AMENDED ARCH)

PROJECT:

PROPOSED NEW RESIDENCE 2 PRINCE EDWARD ROAD, SEAFORTH

COUNCIL: NORTHERN BEACHES

CLIENT: SOPHIA & STUART NAYLOR

BUILDER:

ARCHITECT: NEW PARADIGM DESIGN PTY LTD

DRAWING TITLE: BASEMENT DRAINAGE PLAN

e: info@neconsultants.com.au

ABN:97 672 826 345 ACN: 672 826 345



J.T. V.S.

APPROVED: JOSEPH SAAD TANNOUS SIZE:


BEng (Hons), MIEAust, CPEng

JOB No: 24-1086 C CHECKED:

J.T.

A1

DRAWING No:

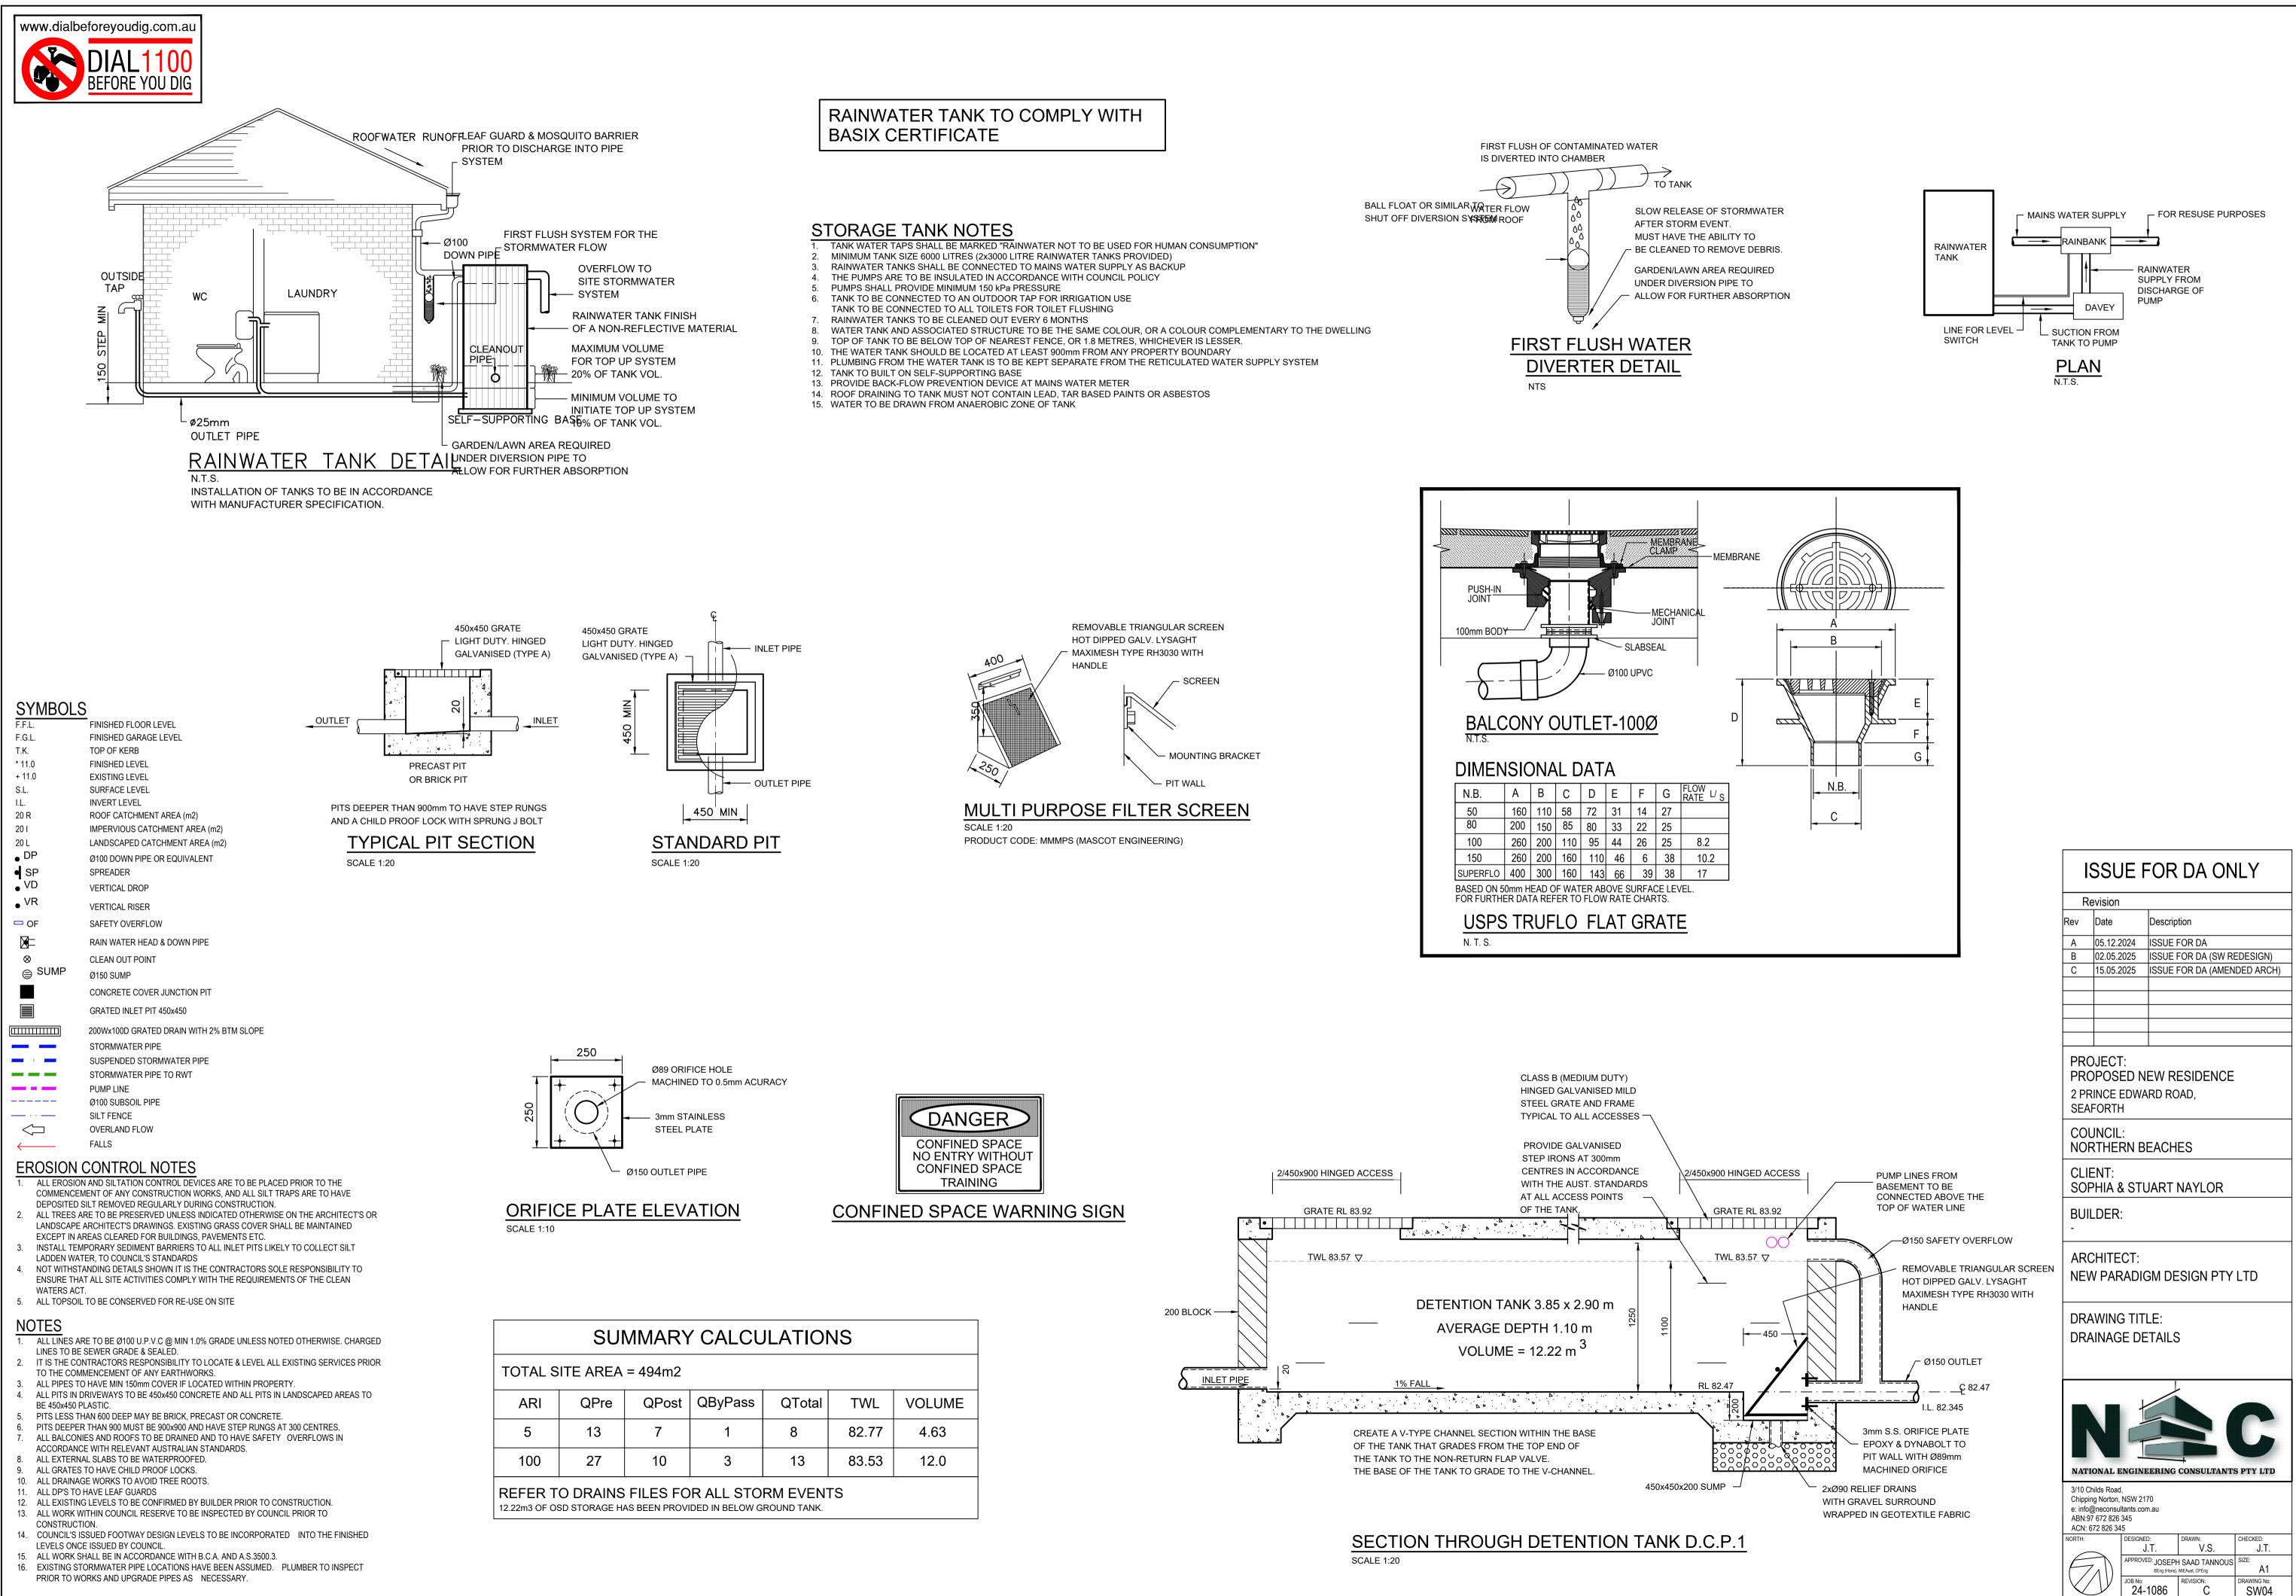


www.dialbeforeyoudig.com.au

3. 1x DUAL DOL CONTROL PANEL WITH: MAIN ISOLATING SWITCH AUTOMATIC ALTERNATION MANUAL/OFF/AUTO SWITCH FOR EACH PUMP CIRCUIT BREAKERS FOR EACH MOTOR AND CONTROL CIRCUIT.

TYPE

COMPONENTS

PUMP SPECIFICATIONS

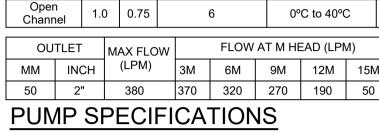

HP KW CONTINUOUS AMP OPERATING

TEMPERATURE

RATING

LIGHTS, CODED DATA OUTPUT FOR BMS CONNECTION


AUDIBLE ALARM WITH MUTE BUTTON

4. SET OF VALVES AND FITTINGS TO SUIT


POWER REQUIREMENTS:

5. INSTRUCTION AND MAINTENANCE MANUAL


240 VOLTS, 0.75 KW & 6 AMPS EACH PUMP

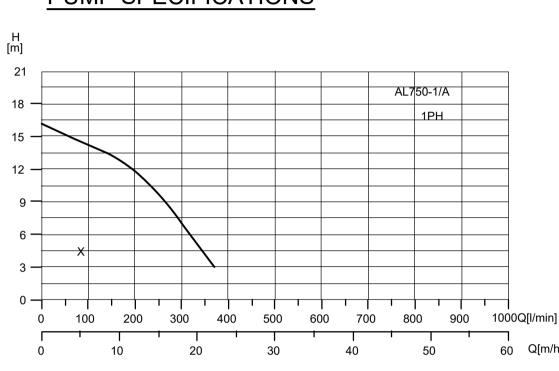

PUMP PERFORMANCE CURVE SCALE 1:20

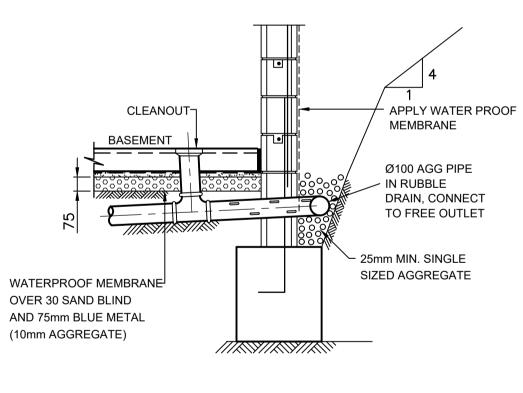



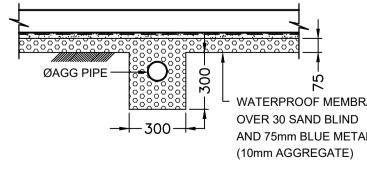



F.F.L. FINISHED FLOOR LEVEL F.G.L. FINISHED GARAGE LEVEL T.K. TOP OF KERB * 11.0 FINISHED LEVEL + 11.0 EXISTING LEVEL SURFACE LEVEL S.L. INVERT LEVEL 20 R ROOF CATCHMENT AREA (m2) 20 I IMPERVIOUS CATCHMENT AREA (m2) 20 L LANDSCAPED CATCHMENT AREA (m2) • DP Ø100 DOWN PIPE OR EQUIVALENT SP SPREADER • VD VERTICAL DROP • VR VERTICAL RISER SAFETY OVERFLOW 🗖 OF RAIN WATER HEAD & DOWN PIPE \otimes CLEAN OUT POINT 😑 SUMP Ø150 SUMP CONCRETE COVER JUNCTION PIT GRATED INLET PIT 450x450 200Wx100D GRATED DRAIN WITH 2% BTM SLOPE STORMWATER PIPE SUSPENDED STORMWATER PIPE STORMWATER PIPE TO RWT ____ PUMP LINE _____ Ø100 SUBSOIL PIPE

SYMBOLS

EROSION CONTROL NOTES

FALLS

SILT FENCE

OVERLAND FLOW

- 1. ALL EROSION AND SILTATION CONTROL DEVICES ARE TO BE PLACED PRIOR TO THE COMMENCEMENT OF ANY CONSTRUCTION WORKS, AND ALL SILT TRAPS ARE TO HAVE DEPOSITED SILT REMOVED REGULARLY DURING CONSTRUCTION.
- ALL TREES ARE TO BE PRESERVED UNLESS INDICATED OTHERWISE ON THE ARCHITECT'S OR LANDSCAPE ARCHITECT'S DRAWINGS. EXISTING GRASS COVER SHALL BE MAINTAINED EXCEPT IN AREAS CLEARED FOR BUILDINGS, PAVEMENTS ETC.
- INSTALL TEMPORARY SEDIMENT BARRIERS TO ALL INLET PITS LIKELY TO COLLECT SILT LADDEN WATER, TO COUNCIL'S STANDARDS
- NOT WITHSTANDING DETAILS SHOWN IT IS THE CONTRACTORS SOLE RESPONSIBILITY TO ENSURE THAT ALL SITE ACTIVITIES COMPLY WITH THE REQUIREMENTS OF THE CLEAN WATERS ACT.
- 5. ALL TOPSOIL TO BE CONSERVED FOR RE-USE ON SITE

NOTES

_____ · · · ____ ·

 \leq


←____

- 1. ALL LINES ARE TO BE Ø100 U.P.V.C @ MIN 1.0% GRADE UNLESS NOTED OTHERWISE. CHARGED LINES TO BE SEWER GRADE & SEALED.
- IT IS THE CONTRACTORS RESPONSIBILITY TO LOCATE & LEVEL ALL EXISTING SERVICES PRIOR TO THE COMMENCEMENT OF ANY EARTHWORKS.
- ALL PIPES TO HAVE MIN 150mm COVER IF LOCATED WITHIN PROPERTY. ALL PITS IN DRIVEWAYS TO BE 450x450 CONCRETE AND ALL PITS IN LANDSCAPED AREAS TO BE 450x450 PLASTIC.
- PITS LESS THAN 600 DEEP MAY BE BRICK, PRECAST OR CONCRETE. PITS DEEPER THAN 900 MUST BE 900x900 AND HAVE STEP RUNGS AT 300 CENTRES.
- ALL BALCONIES AND ROOFS TO BE DRAINED AND TO HAVE SAFETY OVERFLOWS IN
- ACCORDANCE WITH RELEVANT AUSTRALIAN STANDARDS. ALL EXTERNAL SLABS TO BE WATERPROOFED.
- 9. ALL GRATES TO HAVE CHILD PROOF LOCKS.
- 10. ALL DRAINAGE WORKS TO AVOID TREE ROOTS
- 11. ALL DP'S TO HAVE LEAF GUARDS
- 12. ALL EXISTING LEVELS TO BE CONFIRMED BY BUILDER PRIOR TO CONSTRUCTION.
- 13. ALL WORK WITHIN COUNCIL RESERVE TO BE INSPECTED BY COUNCIL PRIOR TO CONSTRUCTION.
- 14. COUNCIL'S ISSUED FOOTWAY DESIGN LEVELS TO BE INCORPORATED INTO THE FINISHED LEVELS ONCE ISSUED BY COUNCIL.
- 15. ALL WORK SHALL BE IN ACCORDANCE WITH B.C.A. AND A.S.3500.3.
- 16. EXISTING STORMWATER PIPE LOCATIONS HAVE BEEN ASSUMED. PLUMBER TO INSPECT PRIOR TO WORKS AND UPGRADE PIPES AS NECESSARY.

1. 2 x ALINE, MODEL AL750-1, 0.75kW, 240 VOLT SUBMERSIBLE PUMPS 2. 2x ALINE DIFFERENTIAL FLOAT SWITCHES MODEL 9006 COMPLETE WITH 20m CABLES.

6. NOTE: CONDUIT FROM PIT TO WALL SHOULD BE MINIMUM 50mm (OR 2x32 mm) WITH LONG RADIUS BENDS

	VOLTAGE		AUTO/ MANUAL	DISCHARGE (MM)	CABLE LENGTH
	240V		Manual/ Automatic	50	10M
		MAX HEAD		INSIONS	WEIGHT
_		٩D			(KG)
V	1 (M)	(M)		L X W X H (MM)	
)	13		525 x 2	250 x 280	27

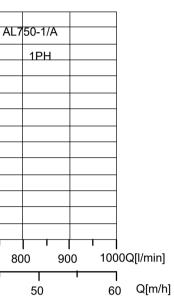

WATERPROOF MEMBRANE AND 75mm BLUE METAL

PUMP WELL DETAILS

SUMP SIZE AND PUMP SIZE BASE ON 100 YEAR 2 HOUR STORM INTENSITY IS 62.3 mm/hr, AREA DRAINING TOWARDS SUMP IS 48m2 Q=CIA/3600 =1.0x62.3x48/3600 = 0.83 l/s VOLUME REQUIRED IS 0.83x(2x60x60) = 5,976 litres STORAGE PROVIDED 2300x2300x1200 = 6,348 litres

USE DUAL AL750-1A OR SIMILAR

THEREFORE ADEQUATE STROAGE PROVIDED

TO BE INSTALLED IN SUMP AND CONNECTED TO CONTROL PANEL WHICH WILL ALLOW FOR THE PUMPS TO ACT ALTERNATIVELY AT 3.53m HEAD

STANDARD PUMP OUT DESIGN NOTES


THE PUMP SHALL BE PROGRAMMED TO WORK ALTERNATIVELY SO AS TO ALLOW BOTH PUMPS TO HAVE AN EQUAL OPERATION LOAD AND PUMP LIFE.

A LOW LEVEL FLOAT SHALL BE PROVIDED TO ENSURE THAT THE MINIMUM REQUIRED WATER LEVEL IS MAINTAINED WITHIN THE SUMP AREA OF THE BELOW GROUND TANK. IN THIS REGARD THIS FLOAT WILL FUNCTION AS AN OFF SWITCH FOR THE PUMPS.

A SECOND FLOAT SHALL BE PROVIDED AT A HIGHER LEVEL, APPROXIMATELY 300mm ABOVE THE MINIMUM WATER LEVEL, WHEREBY ONE OF THE PUMPS WILL OPERATE AND DRAIN THE TANK TO THE LEVEL OF THE LOW LEVEL FLOAT.

A THIRD FLOAT SHALL BE PROVIDED AT A HIGH LEVEL WHICH IS APPROXIMATELY THE ROOF LEVEL OF THE BELOW GROUND TANK. THIS FLOAT SHOULD START THE OTHER PUMP THAT IS NOT OPERATING AND ACTIVATE THE ALARM.


AN ALARM SYSTEM SHALL BE PROVIDED WITH A FLASHING STROBE LIGHT AN A PUMP FAILURE WARNING SIGN WHICH ARE TO BE LOCATED AT THE DRIVEWAY ENTRANCE TO THE BASEMENT LEVEL. THE ALARM SYSTEM SHALL BE PROVIDED WITH A BATTERY BACK-UP IN CASE OF POWER FAILURE.

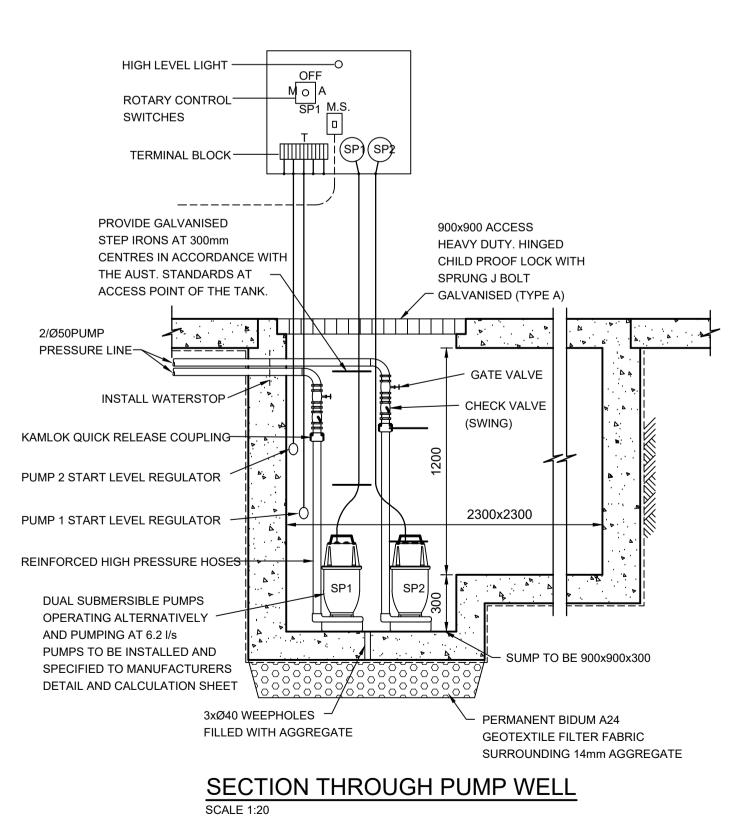

ISSUE FOR DA ONLY

	levision	
Rev	Date	Description
A	05.12.2024	ISSUE FOR DA
B	02.05.2024	ISSUE FOR DA (SW REDESIGN)
C	15.05.2025	ISSUE FOR DA (AMENDED ARCH)
<u> </u>		
PR 2 Pl		NEW RESIDENCE ARD ROAD,
	UNCIL: RTHERN E	BEACHES
-	ENT: PHIA & ST	UART NAYLOR
BU -	ILDER:	
	CHITECT: W PARADI	GM DESIGN PTY LTD
	AWING TIT AINAGE D	
DR	AINAGE D	
DR. NAT	AINAGE D	ETAILS
DR. NAT 3/10 C Chipp e: infc ABN:: ACN:	AINAGE D	ETAILS
DR. NAT 3/10 C Chipp e: infc ABN: ACN:	AINAGE D	ETAILS
DR. NAT	AINAGE D	ETAILS



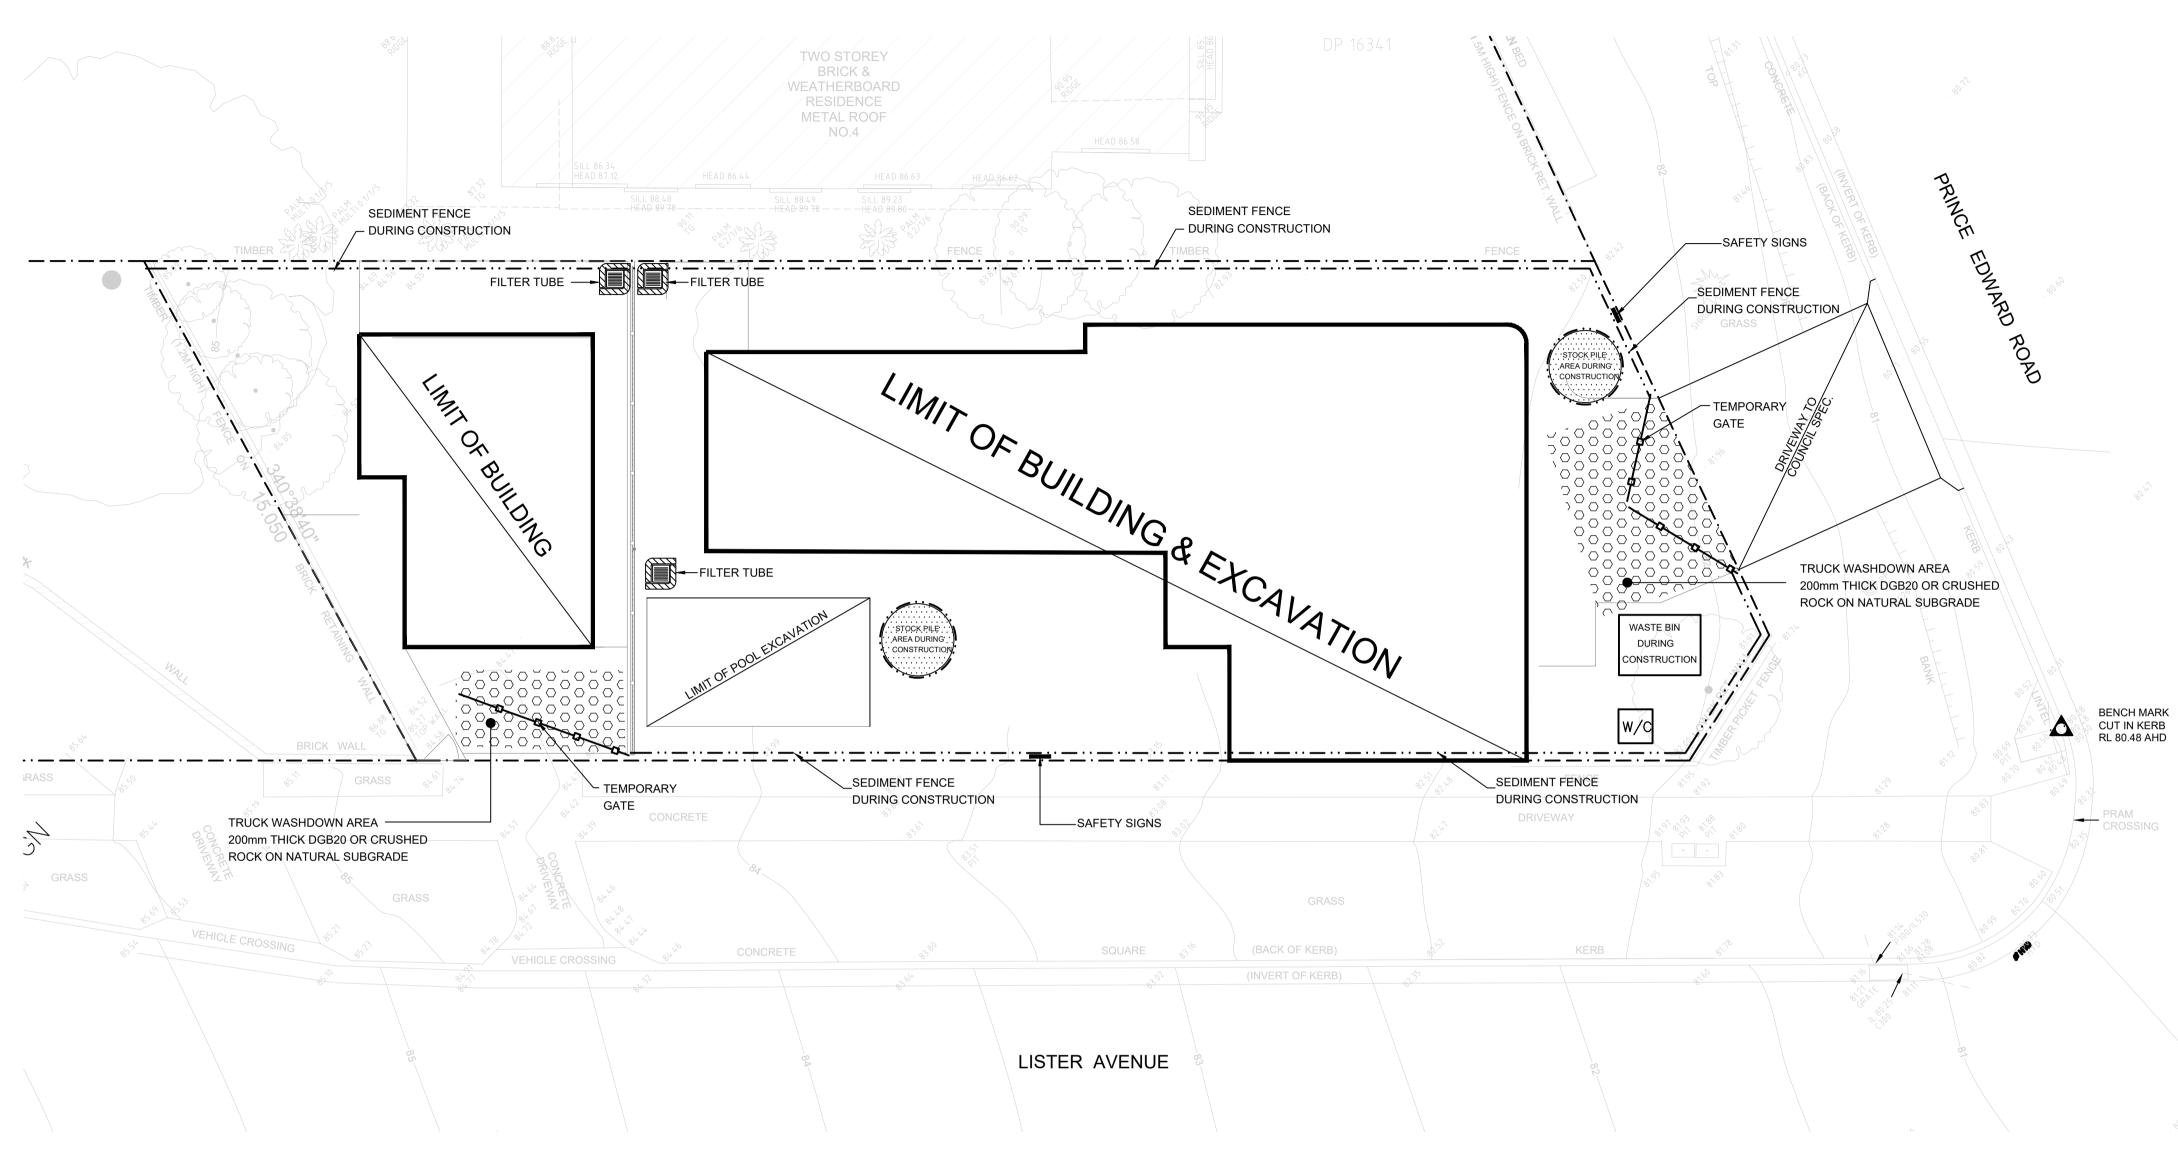


SYMBOLS	
F.F.L.	FINISHED FLOOR LEVEL
F.G.L.	FINISHED GARAGE LEVEL
Т.К.	TOP OF KERB
* 11.0	FINISHED LEVEL
+ 11.0	EXISTING LEVEL
S.L.	SURFACE LEVEL
I.L.	INVERT LEVEL
20 R	ROOF CATCHMENT AREA (m2)
20 I	IMPERVIOUS CATCHMENT AREA (m2)
20 L	LANDSCAPED CATCHMENT AREA (m2)
• DP	Ø100 DOWN PIPE OR EQUIVALENT
• SP	SPREADER
• VD	VERTICAL DROP
• VR	VERTICAL RISER
🖵 OF	SAFETY OVERFLOW
	RAIN WATER HEAD & DOWN PIPE
\otimes	CLEAN OUT POINT
⊜ SUMP	Ø150 SUMP
	CONCRETE COVER JUNCTION PIT
	GRATED INLET PIT 450x450
	200Wx100D GRATED DRAIN WITH 2% BTM SLOPE
	STORMWATER PIPE
	SUSPENDED STORMWATER PIPE
	STORMWATER PIPE TO RWT
	PUMP LINE
	Ø100 SUBSOIL PIPE
· · ·	SILT FENCE
$\langle \neg \rangle$	OVERLAND FLOW
<u> </u>	FALLS


- 1. ALL EROSION AND SILTATION CONTROL DEVICES ARE TO BE PLACED PRIOR TO THE COMMENCEMENT OF ANY CONSTRUCTION WORKS, AND ALL SILT TRAPS ARE TO HAVE DEPOSITED SILT REMOVED REGULARLY DURING CONSTRUCTION.
- ALL TREES ARE TO BE PRESERVED UNLESS INDICATED OTHERWISE ON THE ARCHITECT'S OR LANDSCAPE ARCHITECT'S DRAWINGS. EXISTING GRASS COVER SHALL BE MAINTAINED EXCEPT IN AREAS CLEARED FOR BUILDINGS, PAVEMENTS ETC.
- INSTALL TEMPORARY SEDIMENT BARRIERS TO ALL INLET PITS LIKELY TO COLLECT SILT LADDEN WATER, TO COUNCIL'S STANDARDS
- NOT WITHSTANDING DETAILS SHOWN IT IS THE CONTRACTORS SOLE RESPONSIBILITY TO ENSURE THAT ALL SITE ACTIVITIES COMPLY WITH THE REQUIREMENTS OF THE CLEAN WATERS ACT.
- 5. ALL TOPSOIL TO BE CONSERVED FOR RE-USE ON SITE

NOTES

- 1. ALL LINES ARE TO BE Ø100 U.P.V.C @ MIN 1.0% GRADE UNLESS NOTED OTHERWISE. CHARGED LINES TO BE SEWER GRADE & SEALED. IT IS THE CONTRACTORS RESPONSIBILITY TO LOCATE & LEVEL ALL EXISTING SERVICES PRIOR
- TO THE COMMENCEMENT OF ANY EARTHWORKS. ALL PIPES TO HAVE MIN 150mm COVER IF LOCATED WITHIN PROPERTY.
- 4. ALL PITS IN DRIVEWAYS TO BE 450x450 CONCRETE AND ALL PITS IN LANDSCAPED AREAS TO BE 450x450 PLASTIC. PITS LESS THAN 600 DEEP MAY BE BRICK, PRECAST OR CONCRETE.
- PITS DEEPER THAN 900 MUST BE 900x900 AND HAVE STEP RUNGS AT 300 CENTRES. ALL BALCONIES AND ROOFS TO BE DRAINED AND TO HAVE SAFETY OVERFLOWS IN
- ACCORDANCE WITH RELEVANT AUSTRALIAN STANDARDS.
- ALL EXTERNAL SLABS TO BE WATERPROOFED. 9. ALL GRATES TO HAVE CHILD PROOF LOCKS.
- 10. ALL DRAINAGE WORKS TO AVOID TREE ROOTS.
- 11. ALL DP'S TO HAVE LEAF GUARDS
- 12. ALL EXISTING LEVELS TO BE CONFIRMED BY BUILDER PRIOR TO CONSTRUCTION. 13. ALL WORK WITHIN COUNCIL RESERVE TO BE INSPECTED BY COUNCIL PRIOR TO
- CONSTRUCTION. 14. COUNCIL'S ISSUED FOOTWAY DESIGN LEVELS TO BE INCORPORATED INTO THE FINISHED
- LEVELS ONCE ISSUED BY COUNCIL. 15. ALL WORK SHALL BE IN ACCORDANCE WITH B.C.A. AND A.S.3500.3.
- 16. EXISTING STORMWATER PIPE LOCATIONS HAVE BEEN ASSUMED. PLUMBER TO INSPECT PRIOR TO WORKS AND UPGRADE PIPES AS NECESSARY.




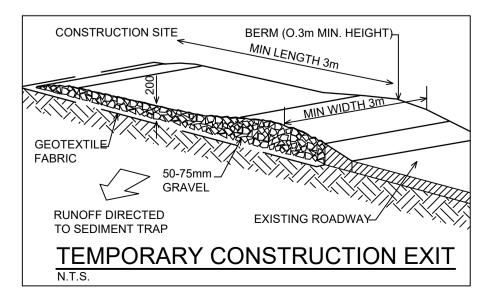


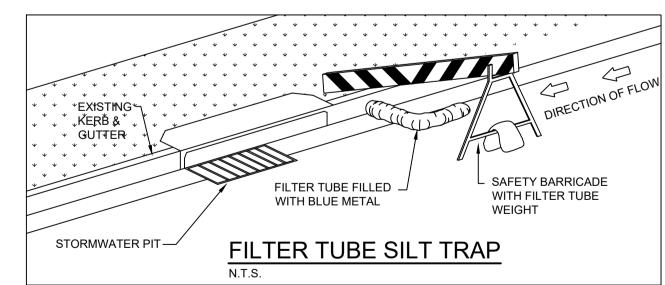

SOIL & WATER MANAGEMENT PLAN


NOTE: CONNECT DOWN PIPES AS SOON AS ROOF IS ON.

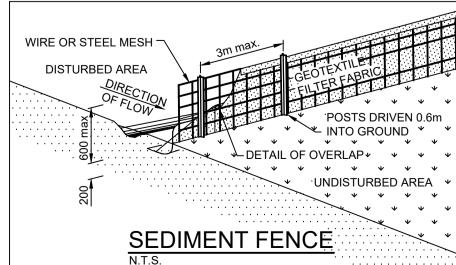

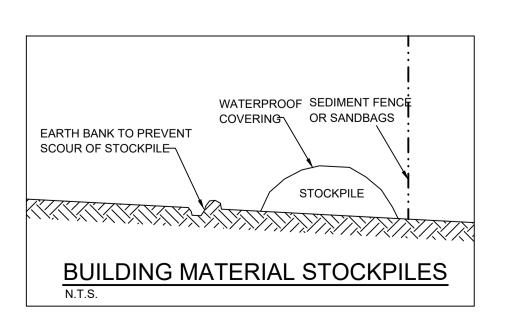

SEDIMENT CONTROL NOTES

- STANDARDS OF SOIL CONSERVATION N.S.W. 2. ALL DRAINAGE WORKS SHALL BE CONSTRUCTED AND STABILIZED AS
- EARLY AS POSSIBLE DURING DEVELOPMENT. 3.
- CONSISTING OF 300mm WIDE x 300mm DEEP TRENCH. 4. ALL SEDIMENT BASINS AND TRAPS SHALL BE CLEANED WHEN THE
- INCLUDING DURING THE MAINTENANCE PERIOD.
- 5. ALL DISTURBED AREAS SHALL BE REVEGETATED AS SOON AS THE RELEVANT WORKS ARE COMPLETED.
- FILTER SHALL BE CONSTRUCTED BY STRETCHING A FILTER FABRIC
- FABRIC SHALL BE BURIED 150 mm ALONG ITS LOWER EDGE. 8. CONTROL SURFACE WATER FLOW IN A MANNER THAT:
- A- DIVERTS RUN-OFF AROUND DISTURBED AREAS D- ENSURES DISTURBED AREAS ARE PROMPTLY REHABILITATED

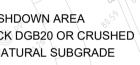

ALL EROSION AND SEDIMENTATION CONTROL MEASURES, INCLUDING REVEGETATION AND STORAGE OF SOIL, SHALL BE IMPLEMENTED TO THE

SEDIMENT TRAPS SHALL BE CONSTRUCTED AROUND ALL INLET PITS,

STRUCTURES ARE A MINIMUM OF 60% FULL OF SOIL MATERIALS,

SOIL AND STOCKPILES SHALL BE LOCATED AWAY FROM DRAINAGE LINES AND AREAS WHERE WATER MAY CONCENTRATE.

(PROPEX OR APPROVED EQUIVALENT BETWEEN POST AT 3.0M CENTERS.

B- MINIMISES SLOPE AND FLOW DISTANCE WITHIN DISTURBED AREAS C- ENSURES SURFACE RUN-OFF OCCURS AT NON-ERODABLE VELOCITIES

ISSUE FOR DA ONLY

Revision Description Date Rev A 05.12.2024 ISSUE FOR DA B 02.05.2025 ISSUE FOR DA (SW REDESIGN) 15.05.2025 ISSUE FOR DA (AMENDED ARCH) С

PROJECT:

PROPOSED NEW RESIDENCE 2 PRINCE EDWARD ROAD, SEAFORTH


COUNCIL: NORTHERN BEACHES

CLIENT: SOPHIA & STUART NAYLOR

BUILDER:

ARCHITECT: NEW PARADIGM DESIGN PTY LTD

DRAWING TITLE: SOIL & WATER MANAGEMENT PLAN

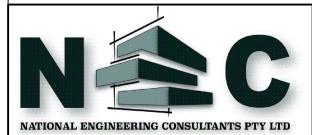

3/10 Childs Road, Chipping Norton, NSW 2170 e: info@neconsultants.com.au ABN:97 672 826 345 ACN: 672 826 345 CHECKED V.<u>S.</u> J.T. J.T. 5 APPROVED: JOSEPH SAAD TANNOUS SIZE: A1 BEng (Hons), MIEAust, CPEng REVISION: JOB No: F DRAWING No: С SW06