

Masonry walls with R2.0 insulation between garage and entry stairs

Plasterboard on studs and masonry with R2.0 insulation between shed/ store and internal house

Plasterboard on studs and masonry walls, no insulation required to the remainder areas of the

## Floor coverings

Tiles to wet areas, timber elsewhere

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Plasterboard ceiling with R5.0insulation (insulation only value) where roof above

Plasterboard ceiling with R2.0 insulation to habitable rooms ceiling where garage above

at 11 Bruce Street, Mona Vale, NSW 2103

title Lot 9 in DP 15762

Metal roof with foil

External Colour Dark (SA > 0.7)

Ceiling Penetrations



**DEVELOPMENT APPLICATION** Site Plan

FOR DEVELOPMENT

**APPLICATION** 

**PURPOSES ONLY** 

NOT FOR CONSTRUCTION

Notes: Do not scale from drawings


DP 15762

DP 15762


1:200 28/09/2020


1912 **DA-01** 


New Dwelling and Pool

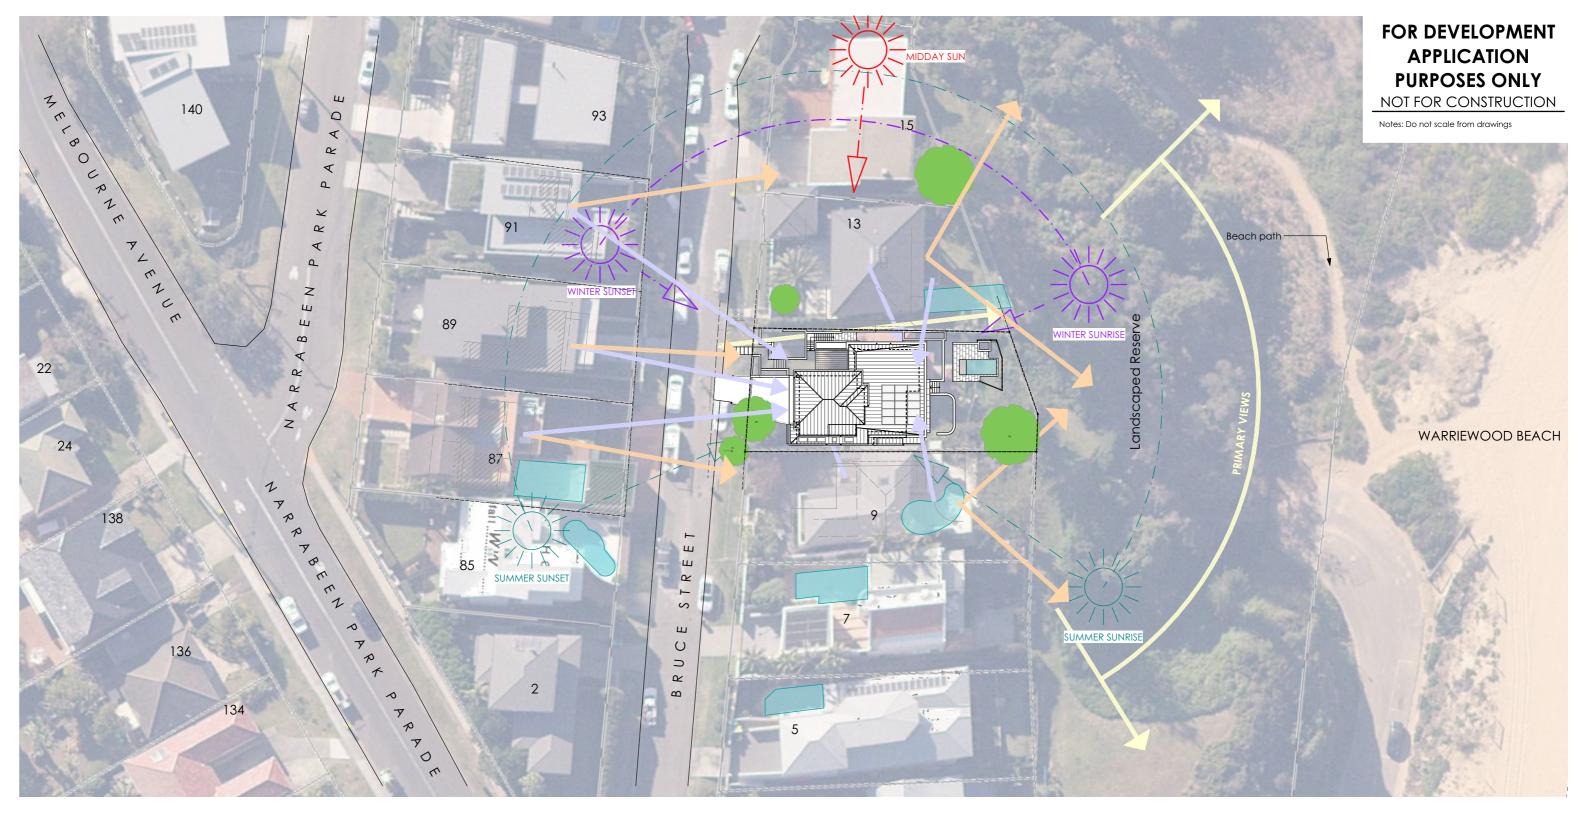



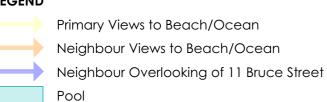

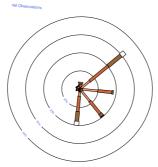

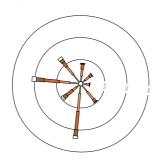

Wind Rose for July



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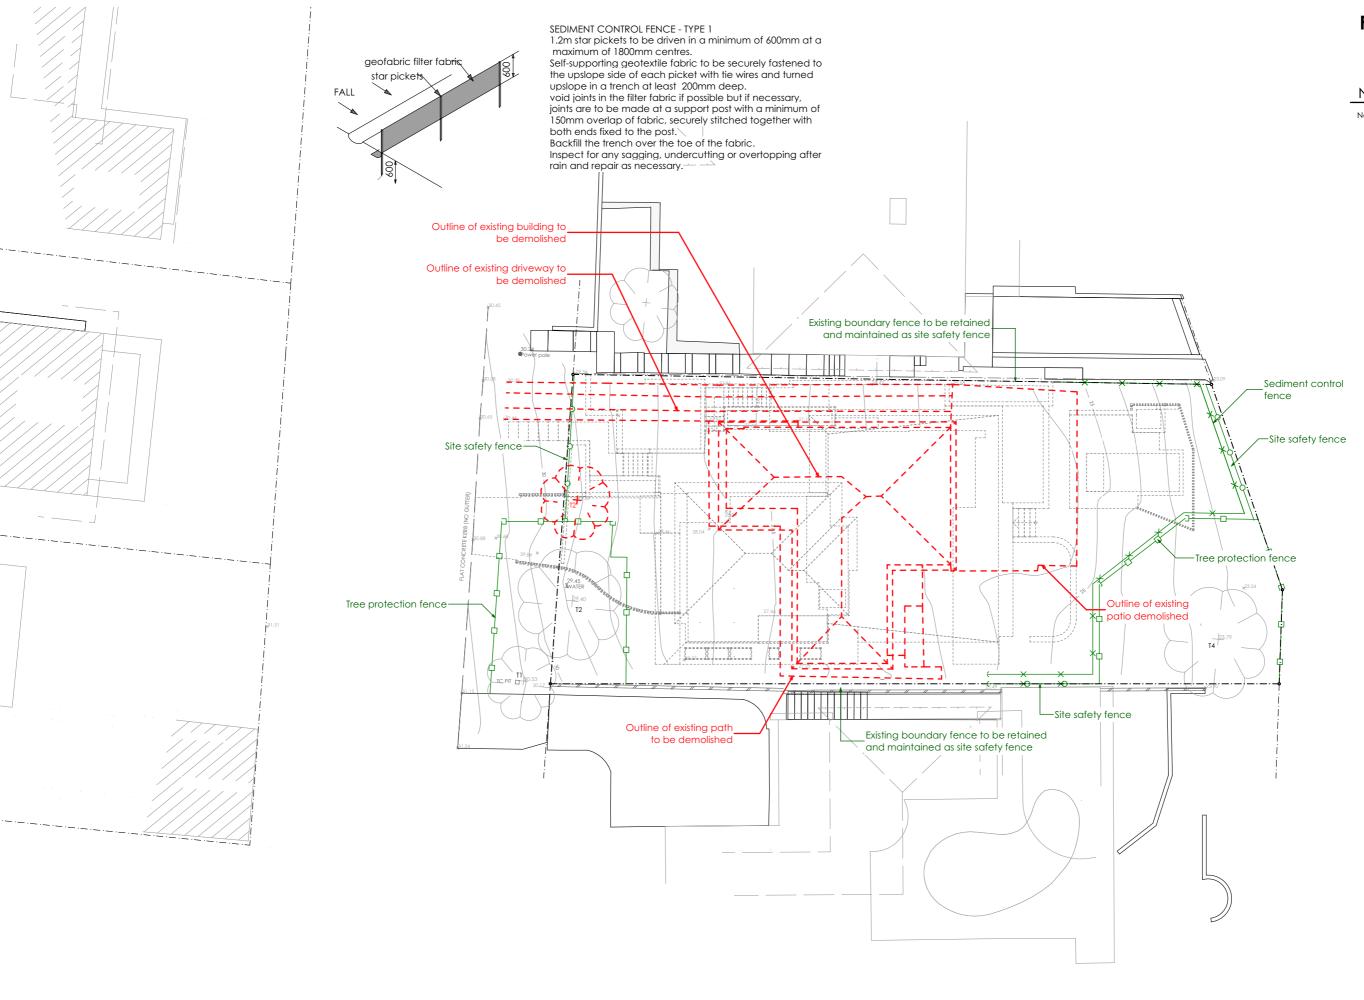


New Dwelling and Pool at 11 Bruce Street, Mona Vale, NSW 2103 title Lot 9 in DP 15762

Wind Rose for January




DEVELOPMENT APPLICATION Location Plan and Site Analysis 1:500 28/09/2020





Notes: Do not scale from drawings



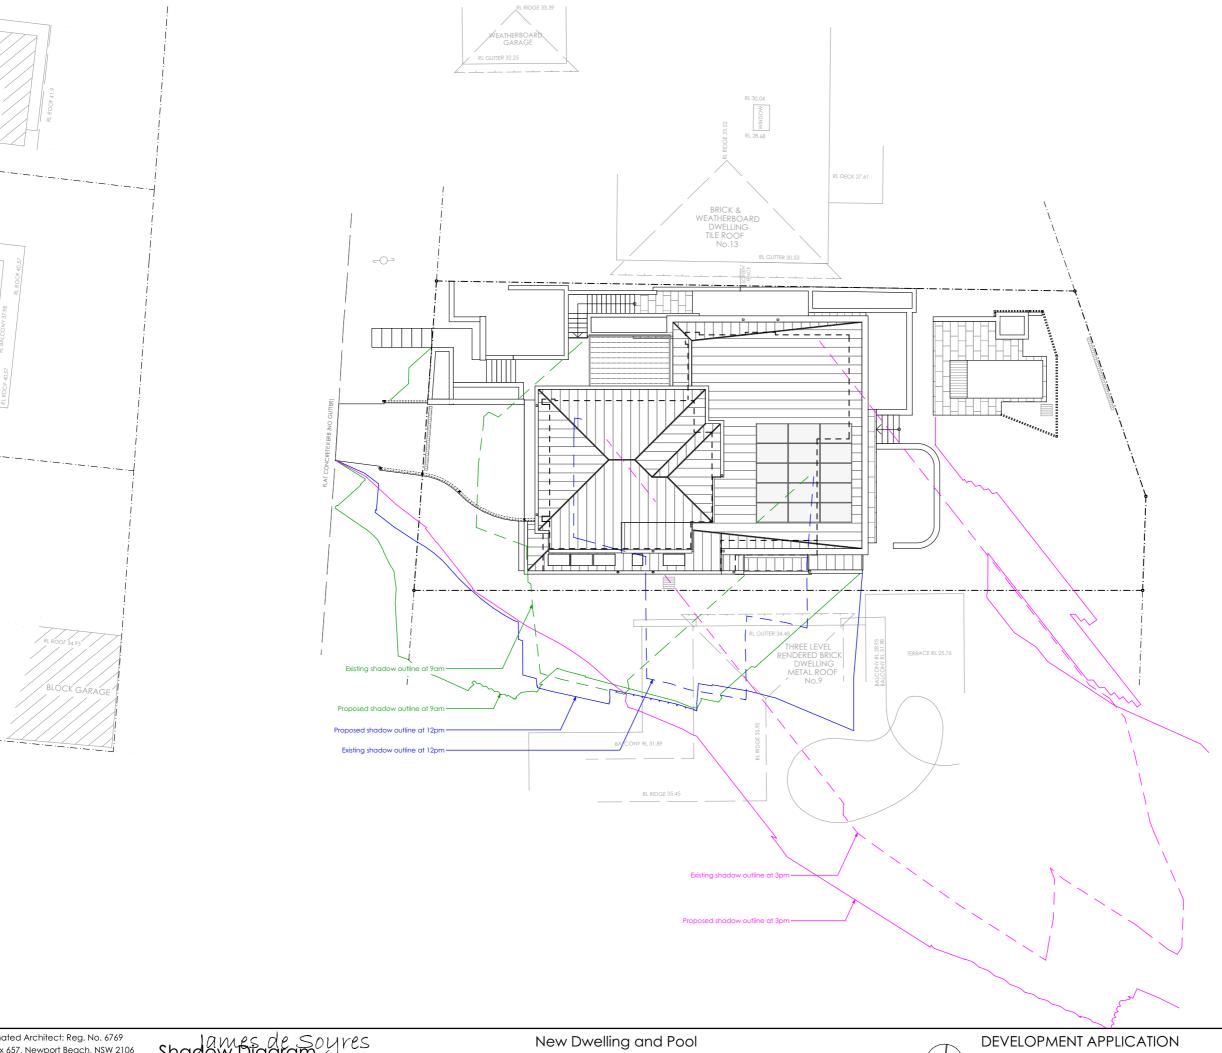


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**PLANNED** 

Site Area = 592.1m2Soft Landscaped Area

= 281.3m2

= 47.5% External Impervious Areas

= 48.8m2

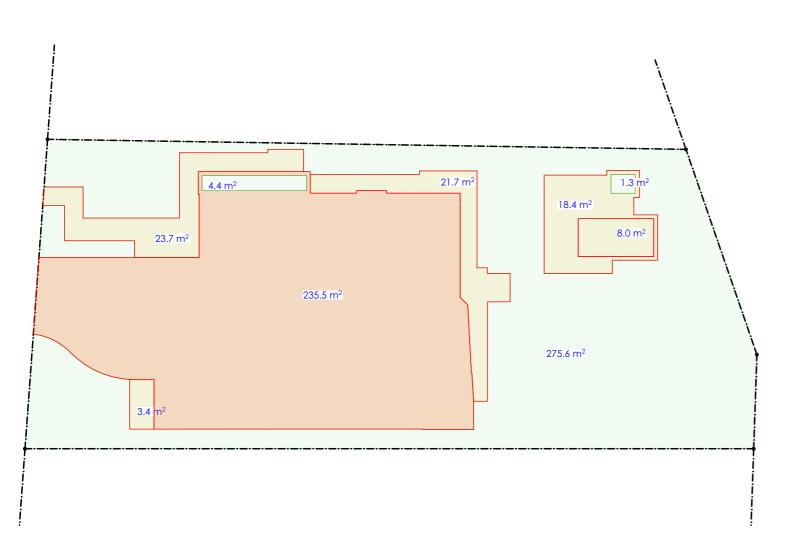= 8.2%

House and Driveway

= 235.5m2

Site Area 592.1m2

6% amenity area

40% Built upon area

60% landscaped area = 355.26m2

= 39.8%

Pool and Pool Terrace

= 26.4m2= 4.4%

Landscaped and Amenity Areas

= 356.5m2

= 60.2%

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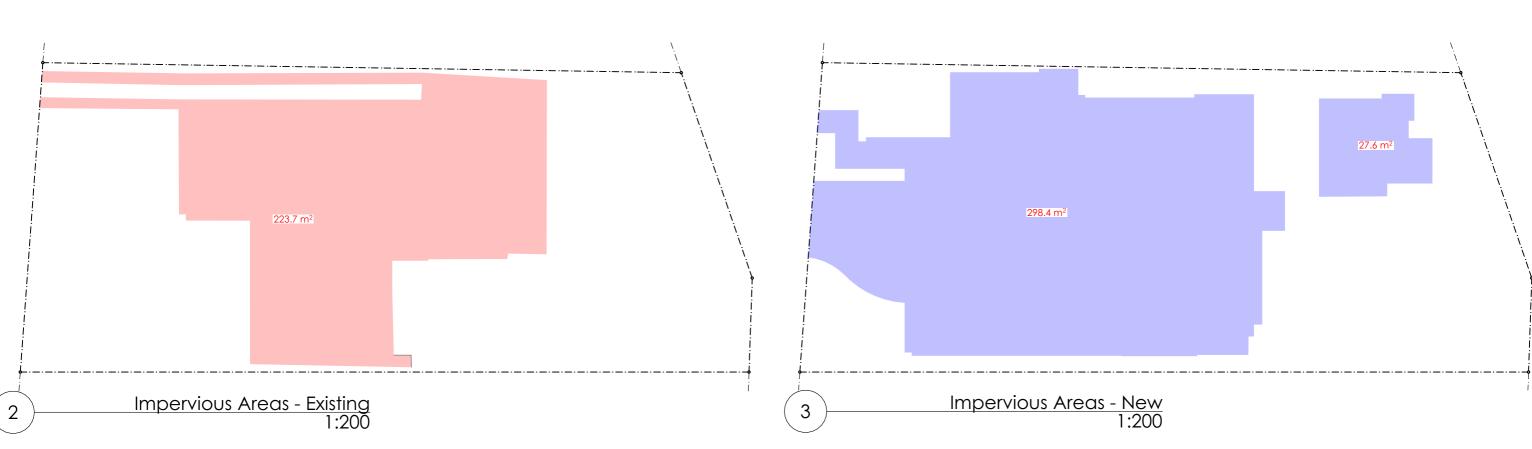
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= 35.53m2

= 236.84m2





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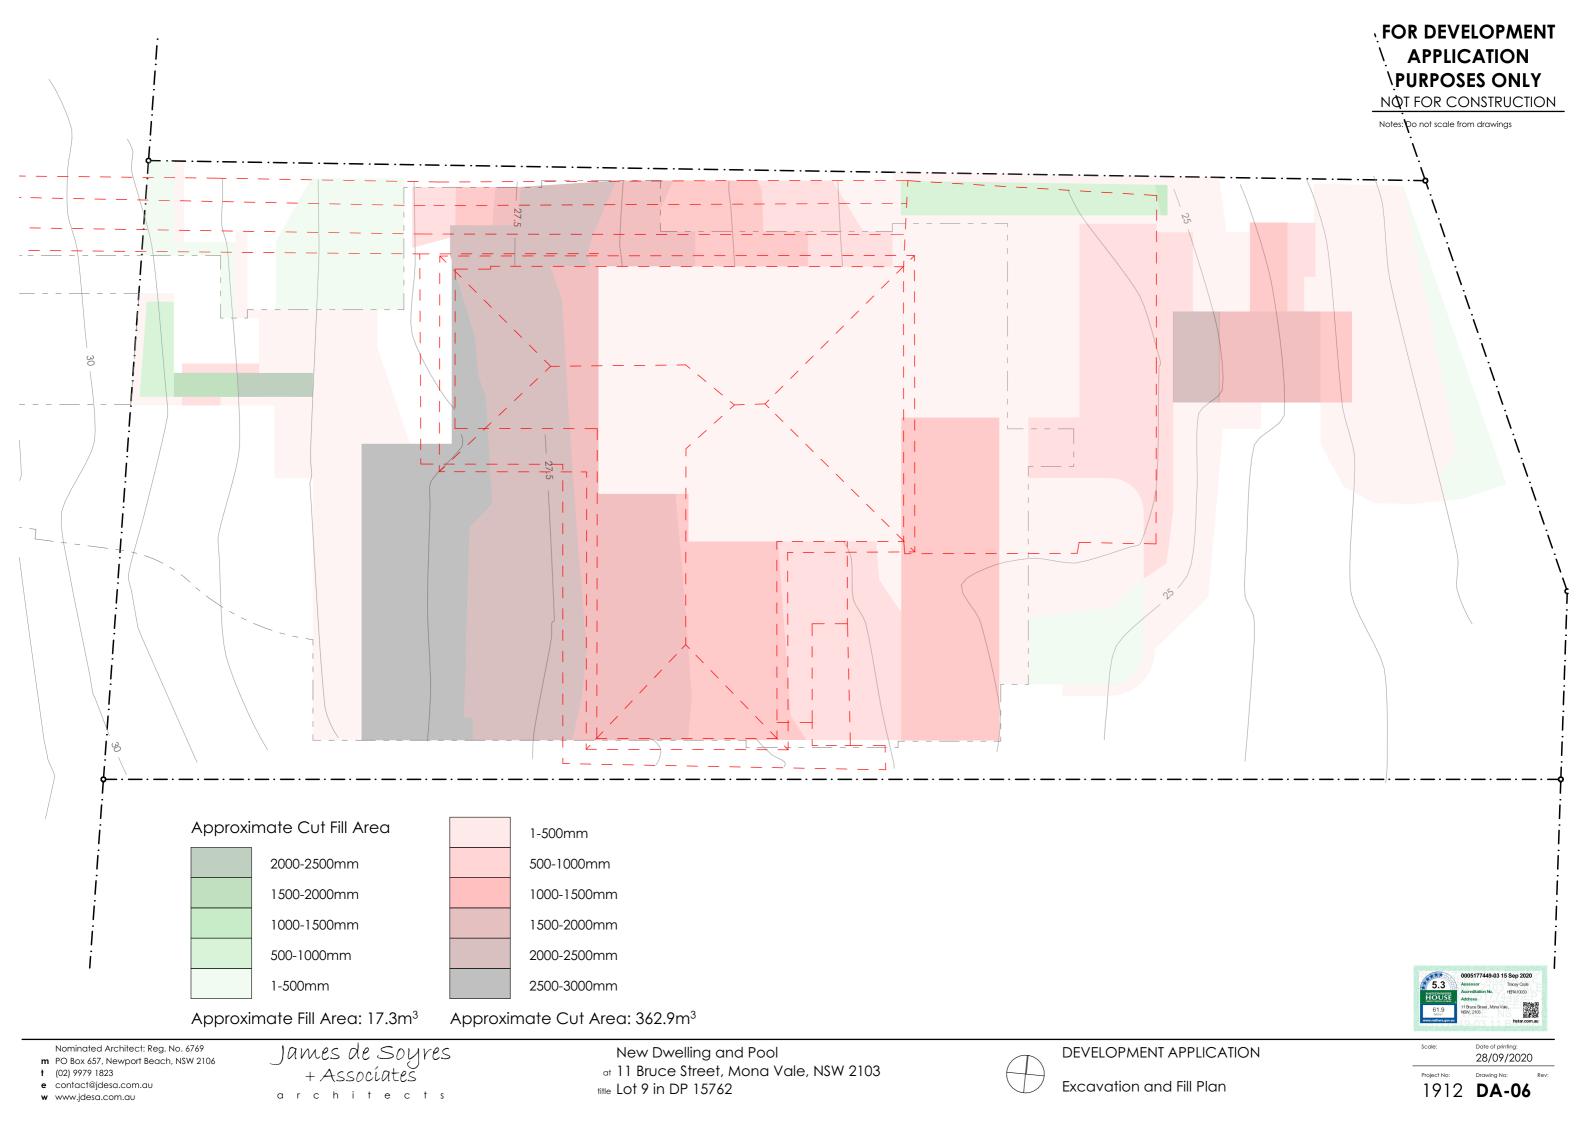
+ Associates architects

New Dwelling and Pool at 11 Bruce Street, Mona Vale, NSW 2103 title Lot 9 in DP 15762

DEVELOPMENT APPLICATION

Areas Schedule

1:200 28/09/2020



## FOR DEVELOPMENT APPLICATION PURPOSES ONLY

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Proposed View from NE



Proposed Street View



ROOF Prefa Aluminium 'Standard Quartz Grey'



WALL CLADDING
Charred timber



WALL RENDER Resene 'Half Pravda'



STONE CLADDING
Natural Stone

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James de Soyres + Associates architects New Dwelling and Pool at 11 Bruce Street, Mona Vale, NSW 2103 title Lot 9 in DP 15762 DEVELOPMENT APPLICATION

Scale: Date of printing: 10/12/2020


3D Renders and Finishes Schedule



9 Bruce Street from rear yard



9 Bruce Street from front yard

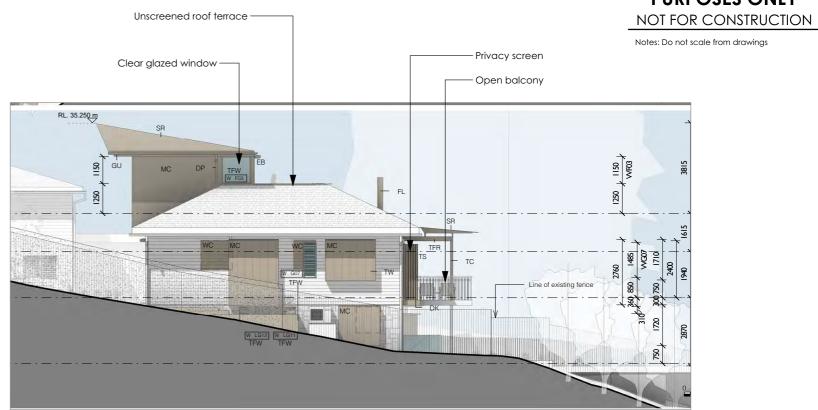

Approved additions to 13 Bruce Street




13 Bruce Street from rear yard



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## FOR DEVELOPMENT **APPLICATION PURPOSES ONLY**

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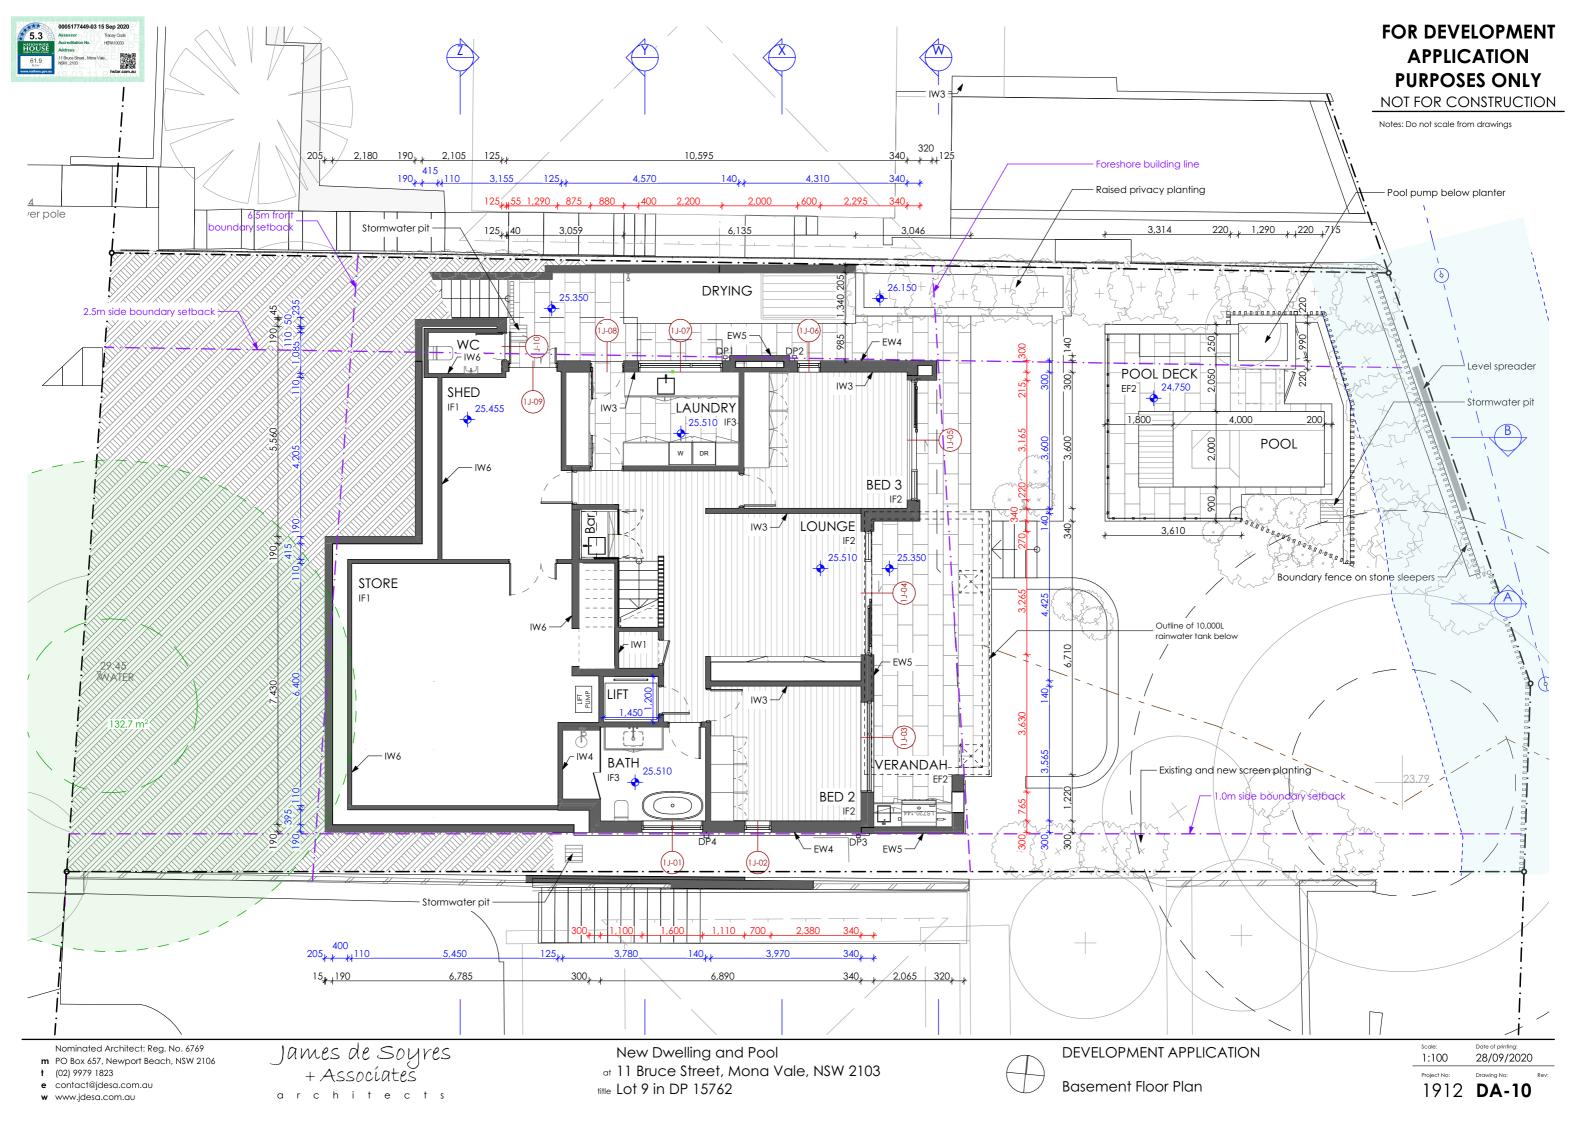
James de Soyres + Associates  $\hbox{a }\hbox{r }\hbox{c }\hbox{h }\hbox{i }\hbox{t }\hbox{e }\hbox{c }\hbox{t }\hbox{s}$ 


New Dwelling and Pool at 11 Bruce Street, Mona Vale, NSW 2103

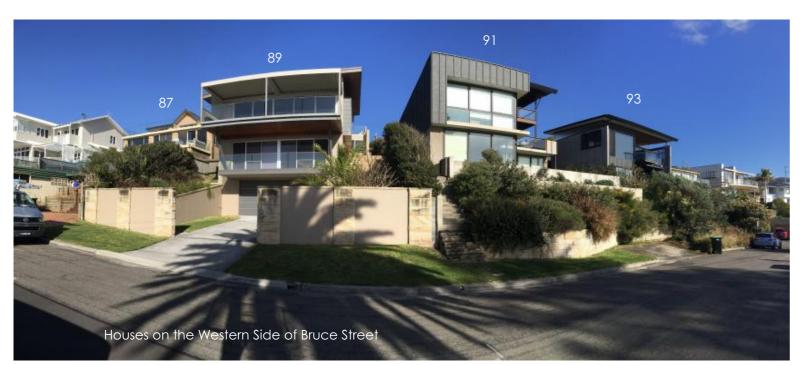
title Lot 9 in DP 15762

DEVELOPMENT APPLICATION Locality Photographs

28/09/2020



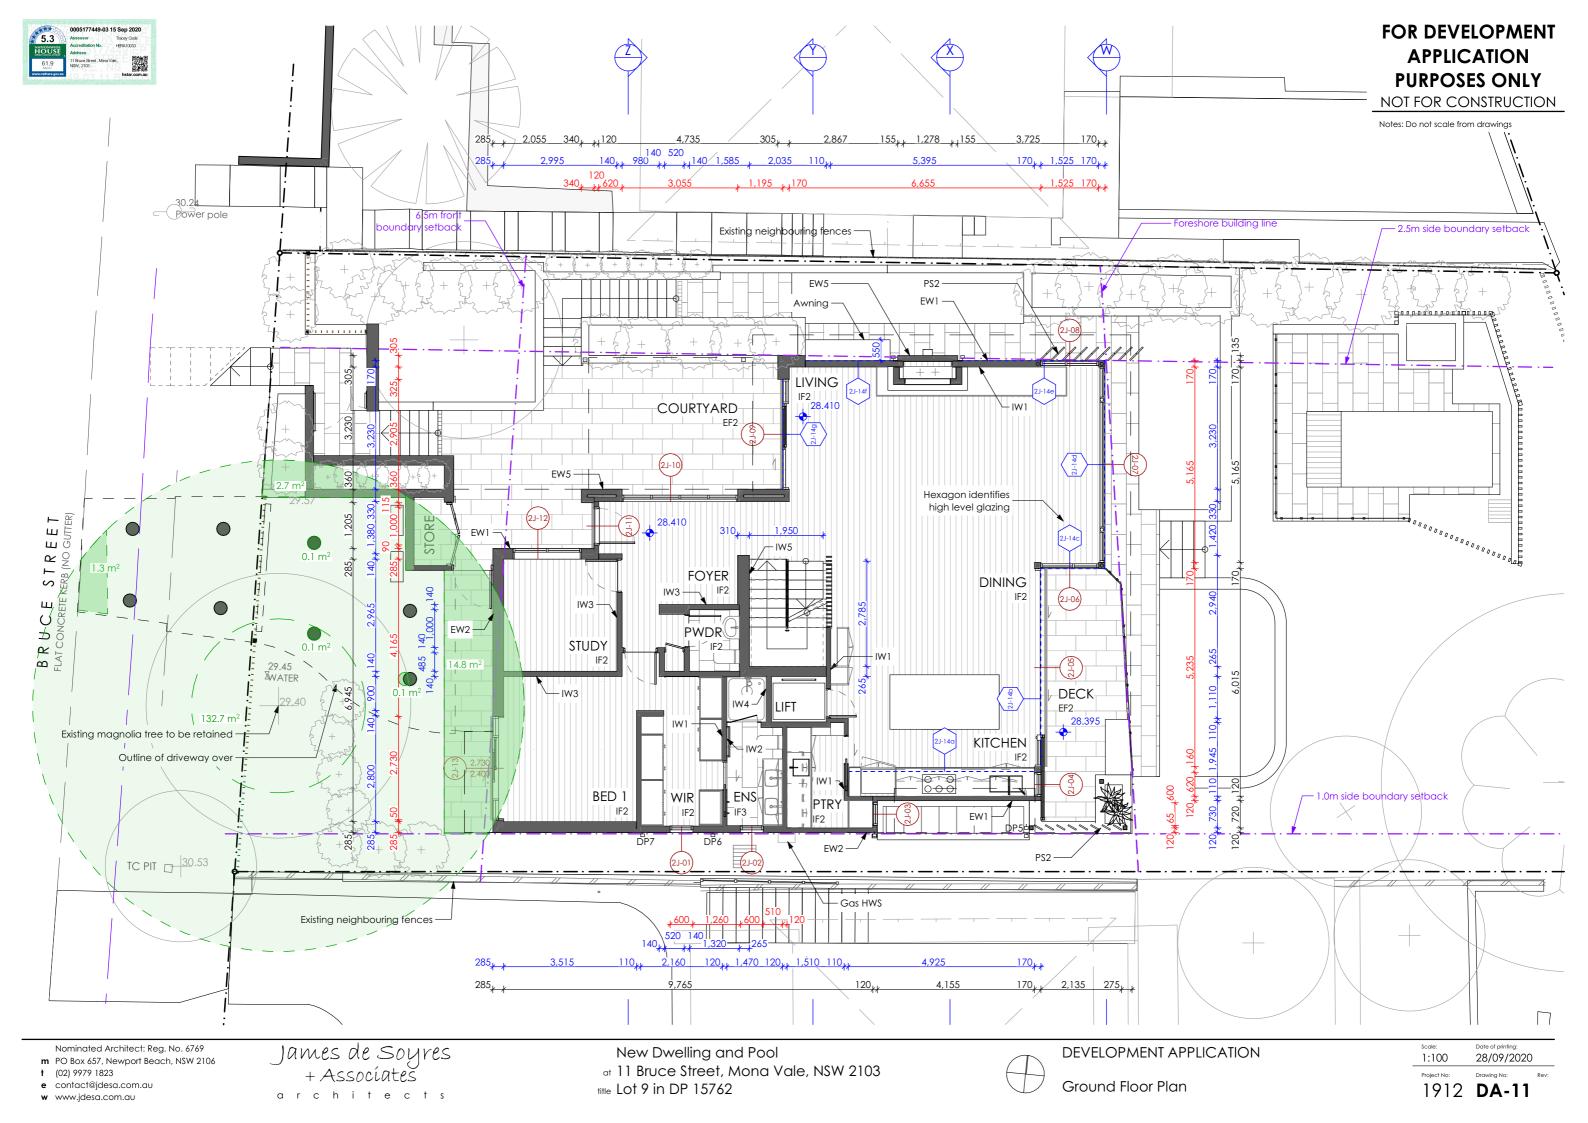

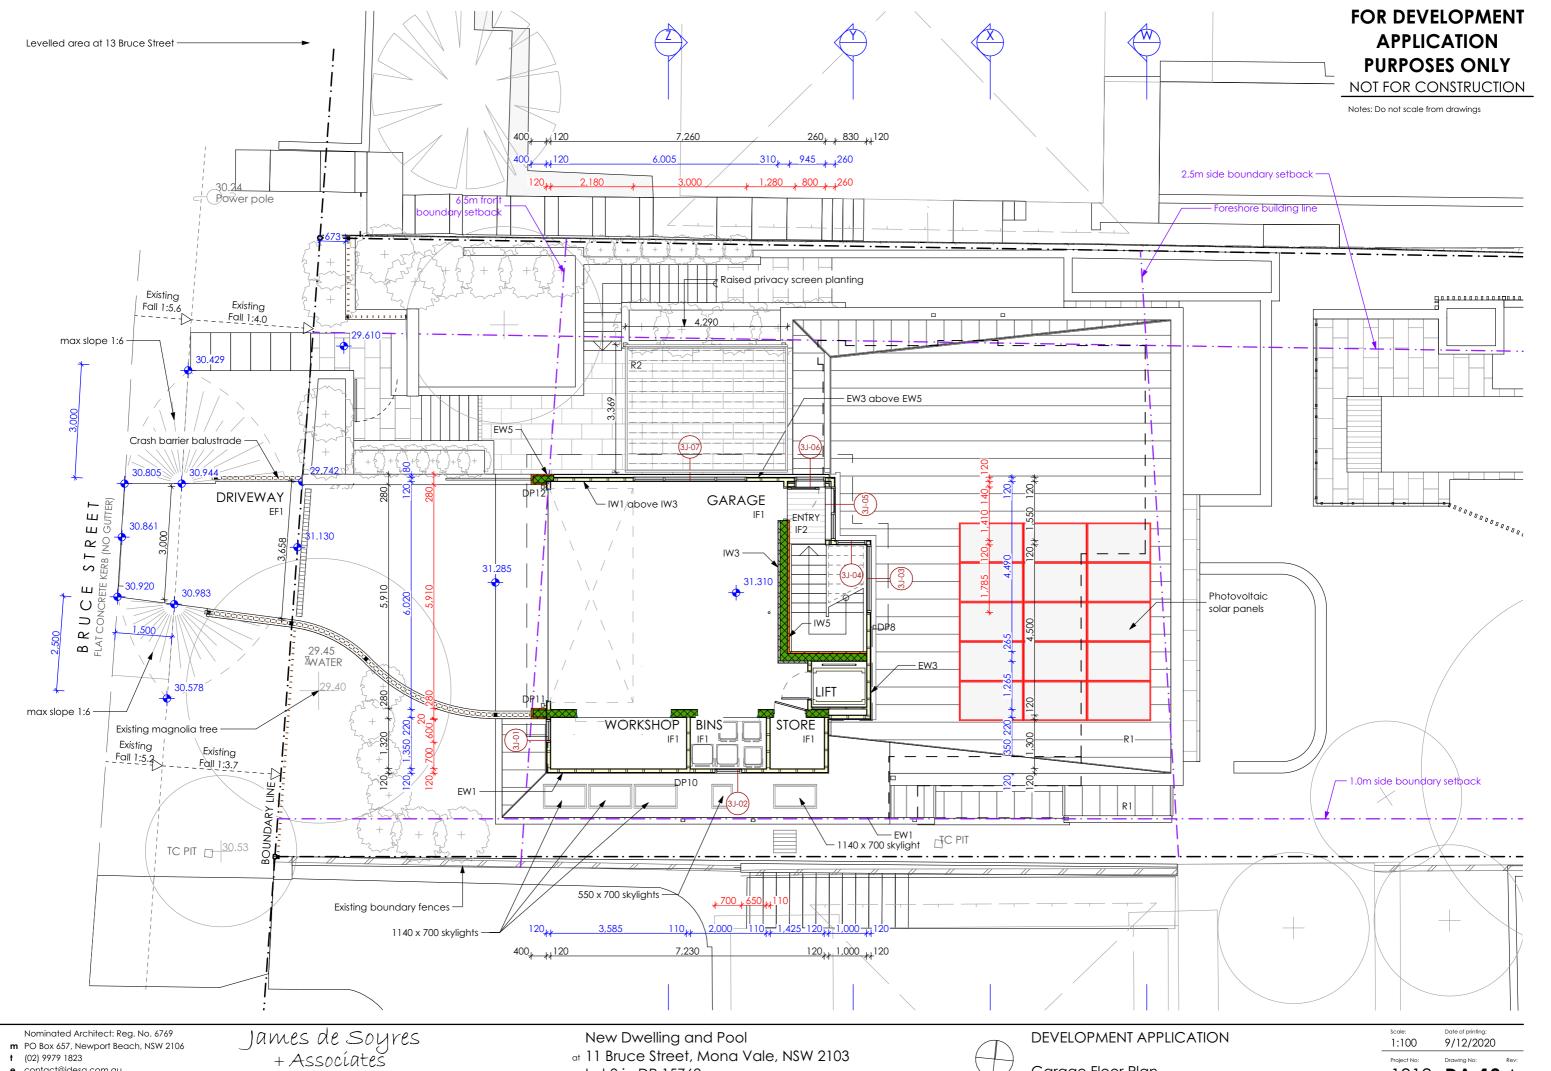



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Garage Floor Plan

1912 **DA-12** A



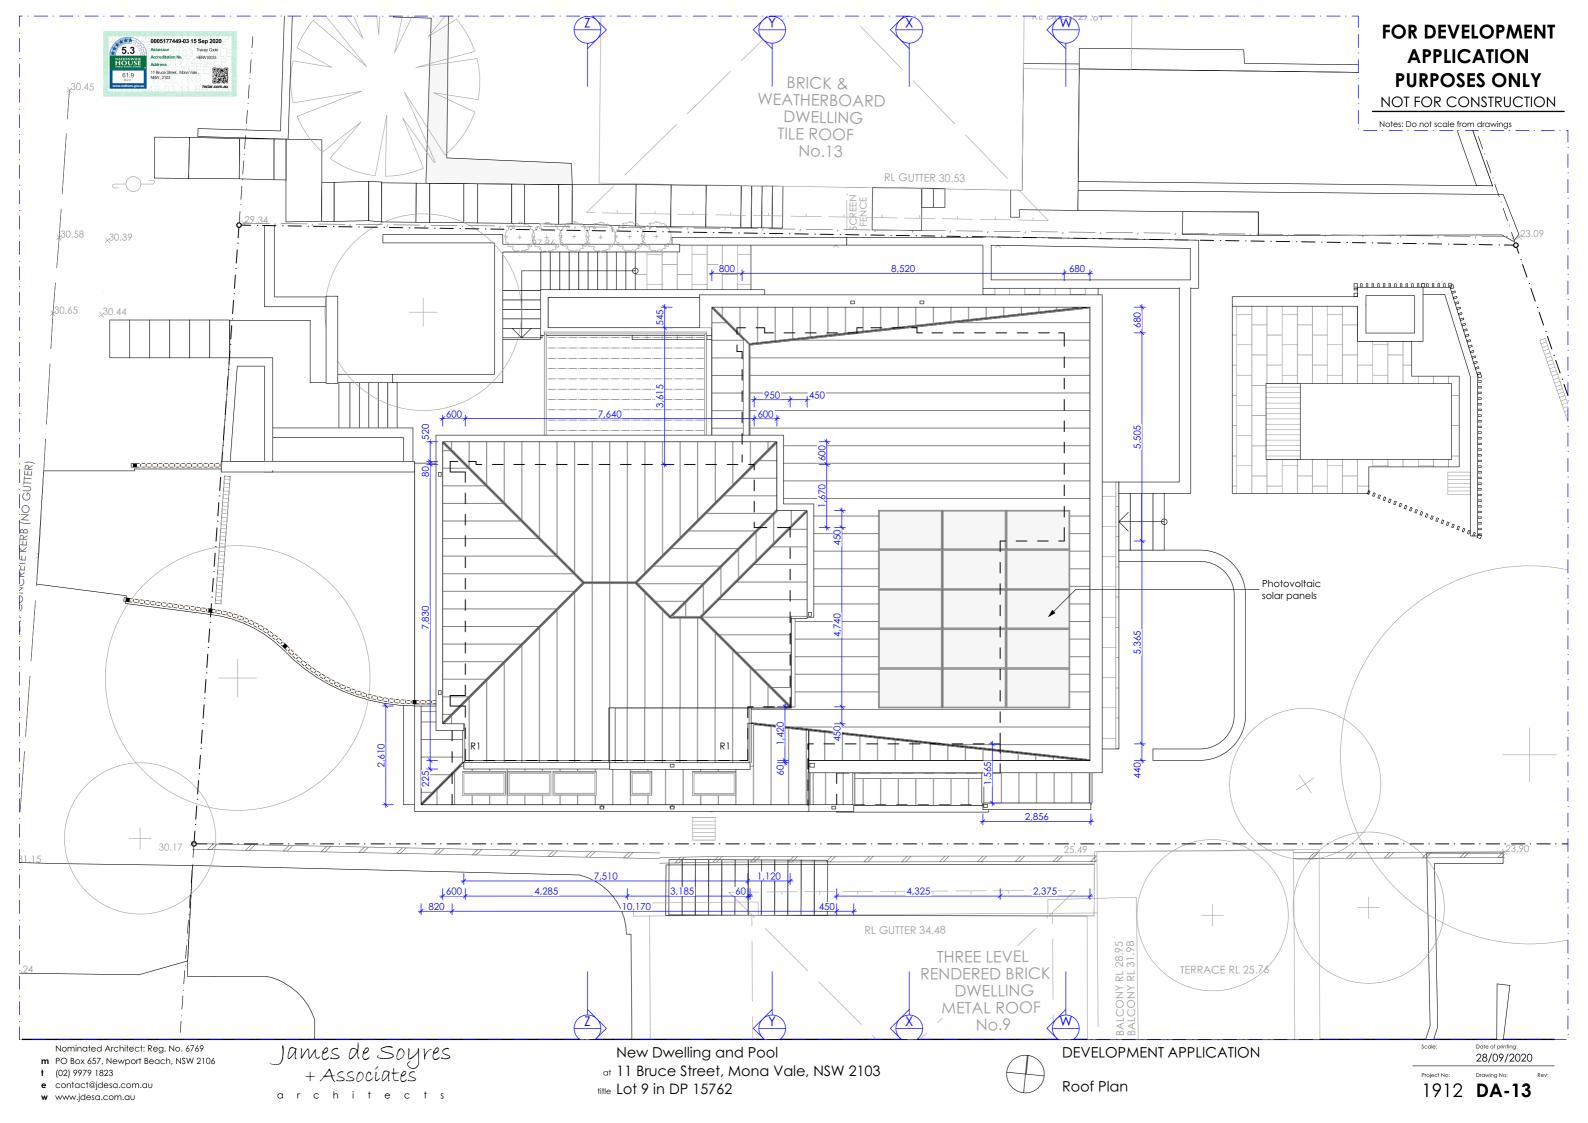

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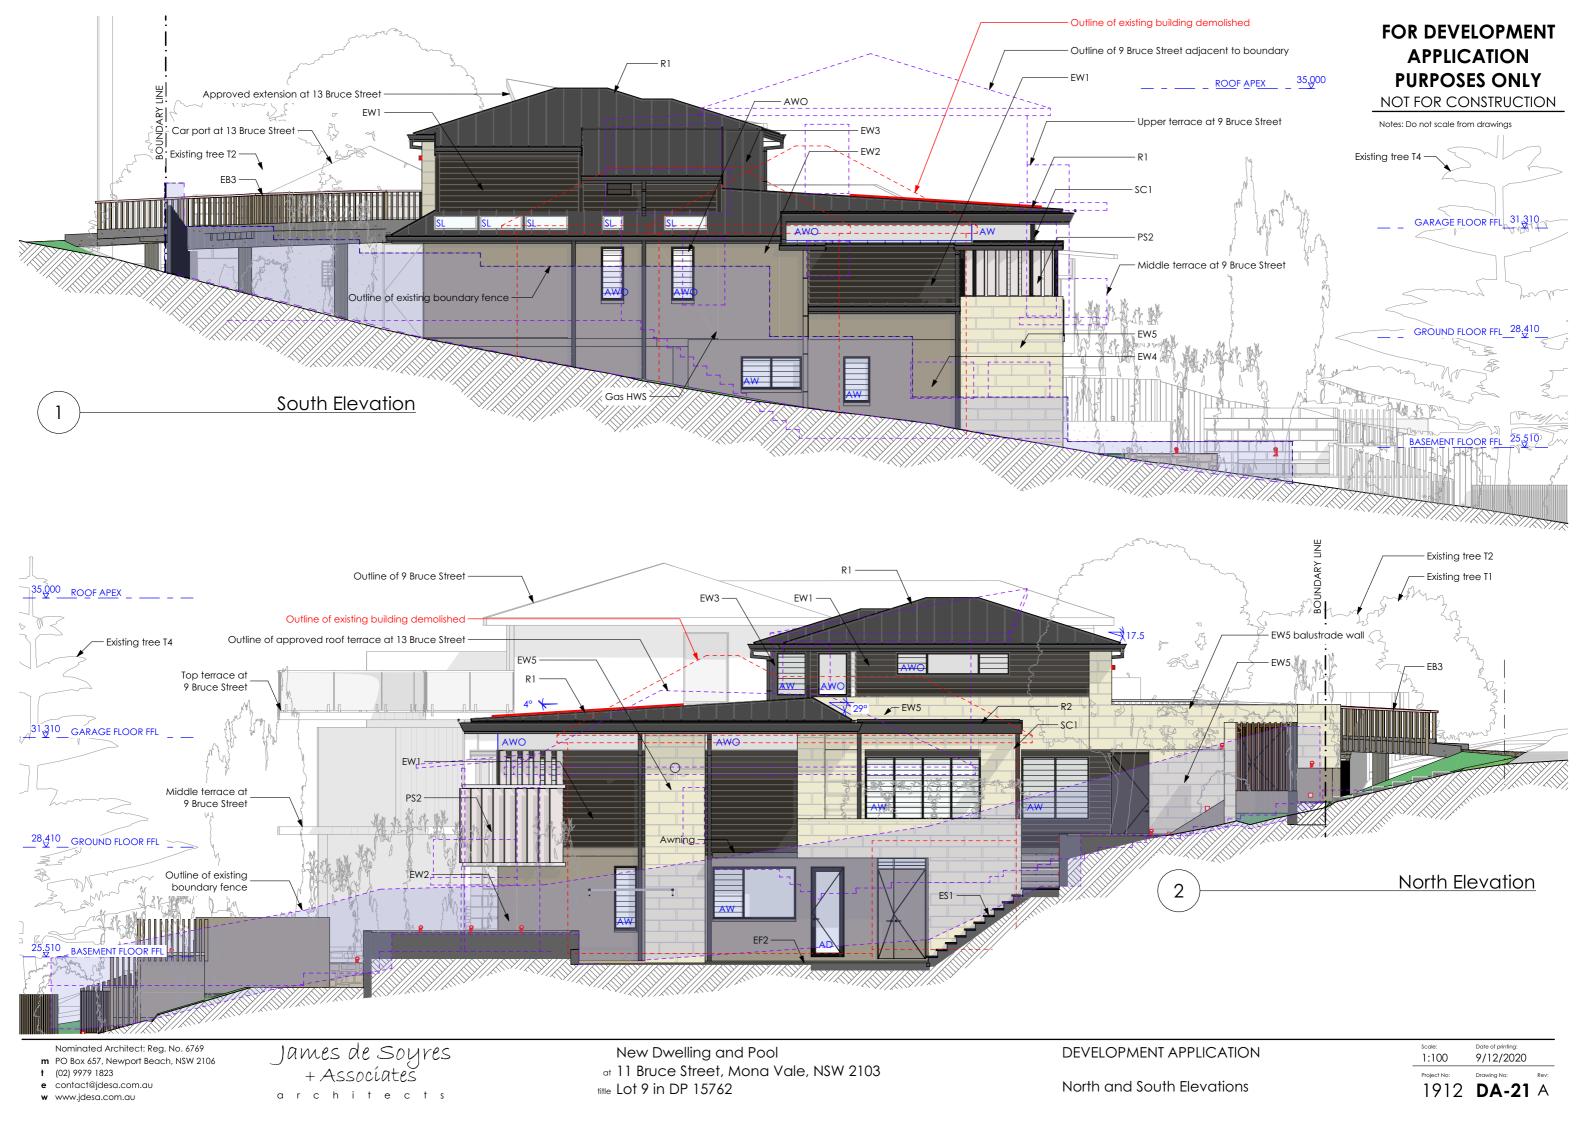
**DEVELOPMENT APPLICATION** 

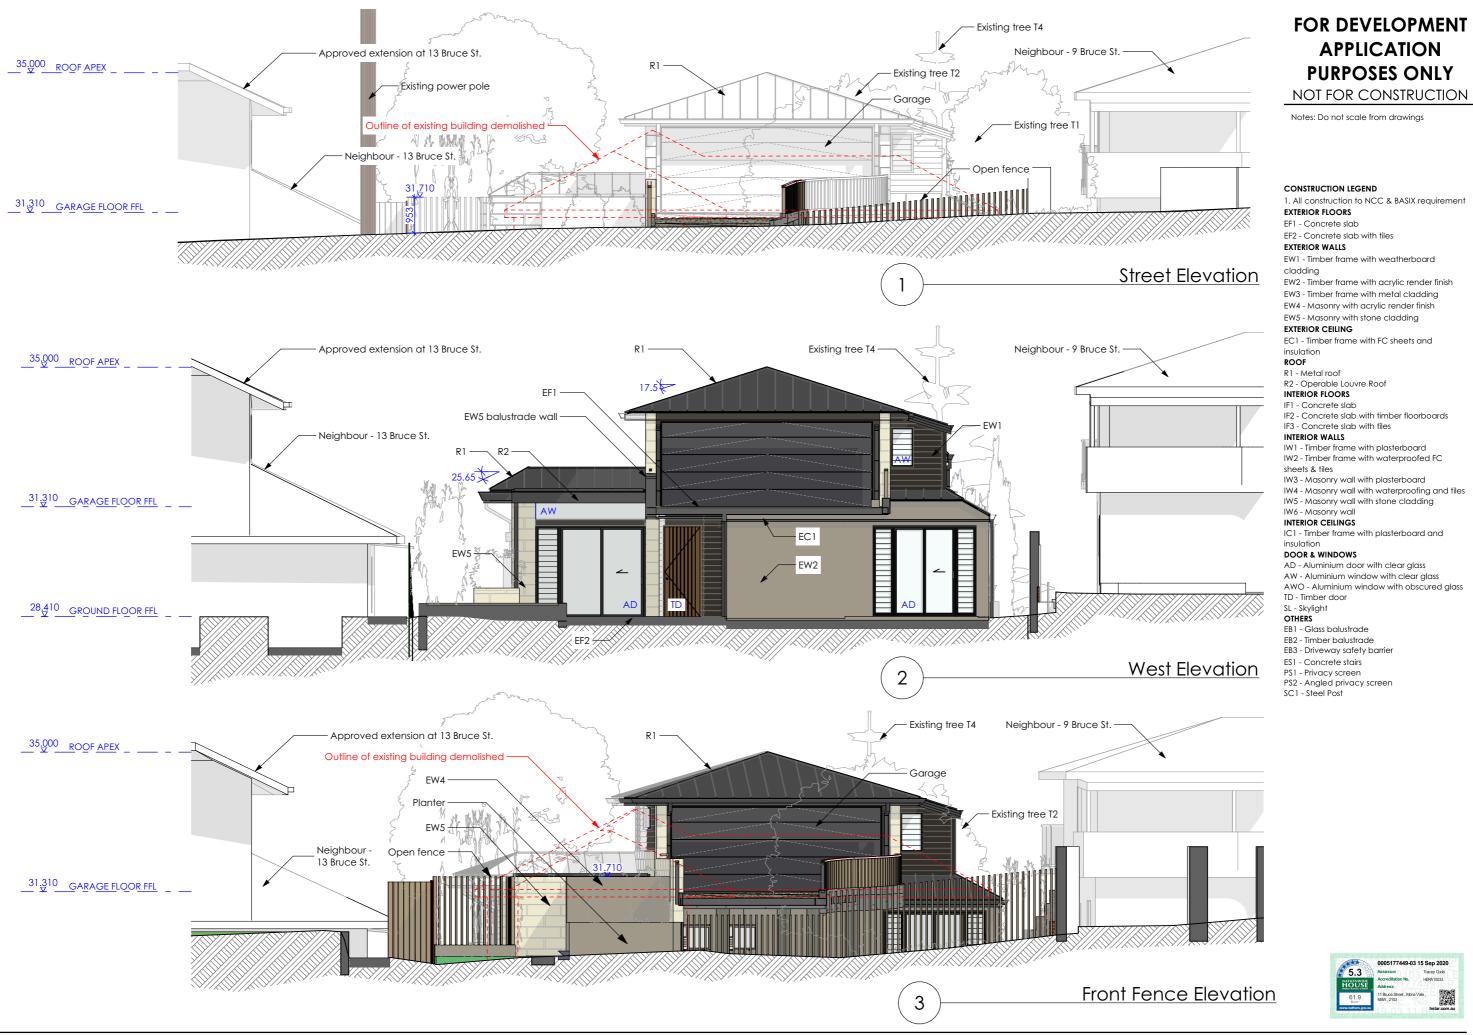1:100

28/09/2020

1912 **DA-20** 

West Elevation and Front Fence



## FOR DEVELOPMENT **APPLICATION PURPOSES ONLY**

NOT FOR CONSTRUCTION

Notes: Do not scale from drawings

### CONSTRUCTION LEGEND

1. All construction to NCC & BASIX requirement

## EXTERIOR FLOORS

EF1 - Concrete slab EF2 - Concrete slab with tiles

## EXTERIOR WALLS

EW1 - Timber frame with weatherboard cladding

EW2 - Timber frame with acrylic render finish

EW3 - Timber frame with metal cladding

EW4 - Masonry with acrylic render finish

EW5 - Masonry with stone cladding

## EXTERIOR CEILING

EC1 - Timber frame with FC sheets and insulation

ROOF R1 - Metal roof

R2 - Operable Louvre Roof
INTERIOR FLOORS

## IF1 - Concrete slab

IF2 - Concrete slab with timber floorboards IF3 - Concrete slab with tiles

## INTERIOR WALLS

IW1 - Timber frame with plasterboard IW2 - Timber frame with waterproofed FC

sheets & tiles

IW3 - Masonry wall with plasterboard IW4 - Masonry wall with waterproofing and tiles

IW5 - Masonry wall with stone cladding

IW6 - Masonry wall
INTERIOR CEILINGS

IC1 - Timber frame with plasterboard and insulation

## DOOR & WINDOWS

AD - Aluminium door with clear glass AW - Aluminium window with clear glass

AWO - Aluminium window with obscured glass TD - Timber door SL - Skylight

### OTHERS

EB1 - Glass balustrade

EB2 - Timber balustrade

EB3 - Driveway safety barrier

ES1 - Concrete stairs

PS1 - Privacy screen PS2 - Angled privacy screen





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New Dwelling and Pool


at 11 Bruce Street, Mona Vale, NSW 2103 title Lot 9 in DP 15762

**DEVELOPMENT APPLICATION** 

East Elevation

1:100

28/09/2020

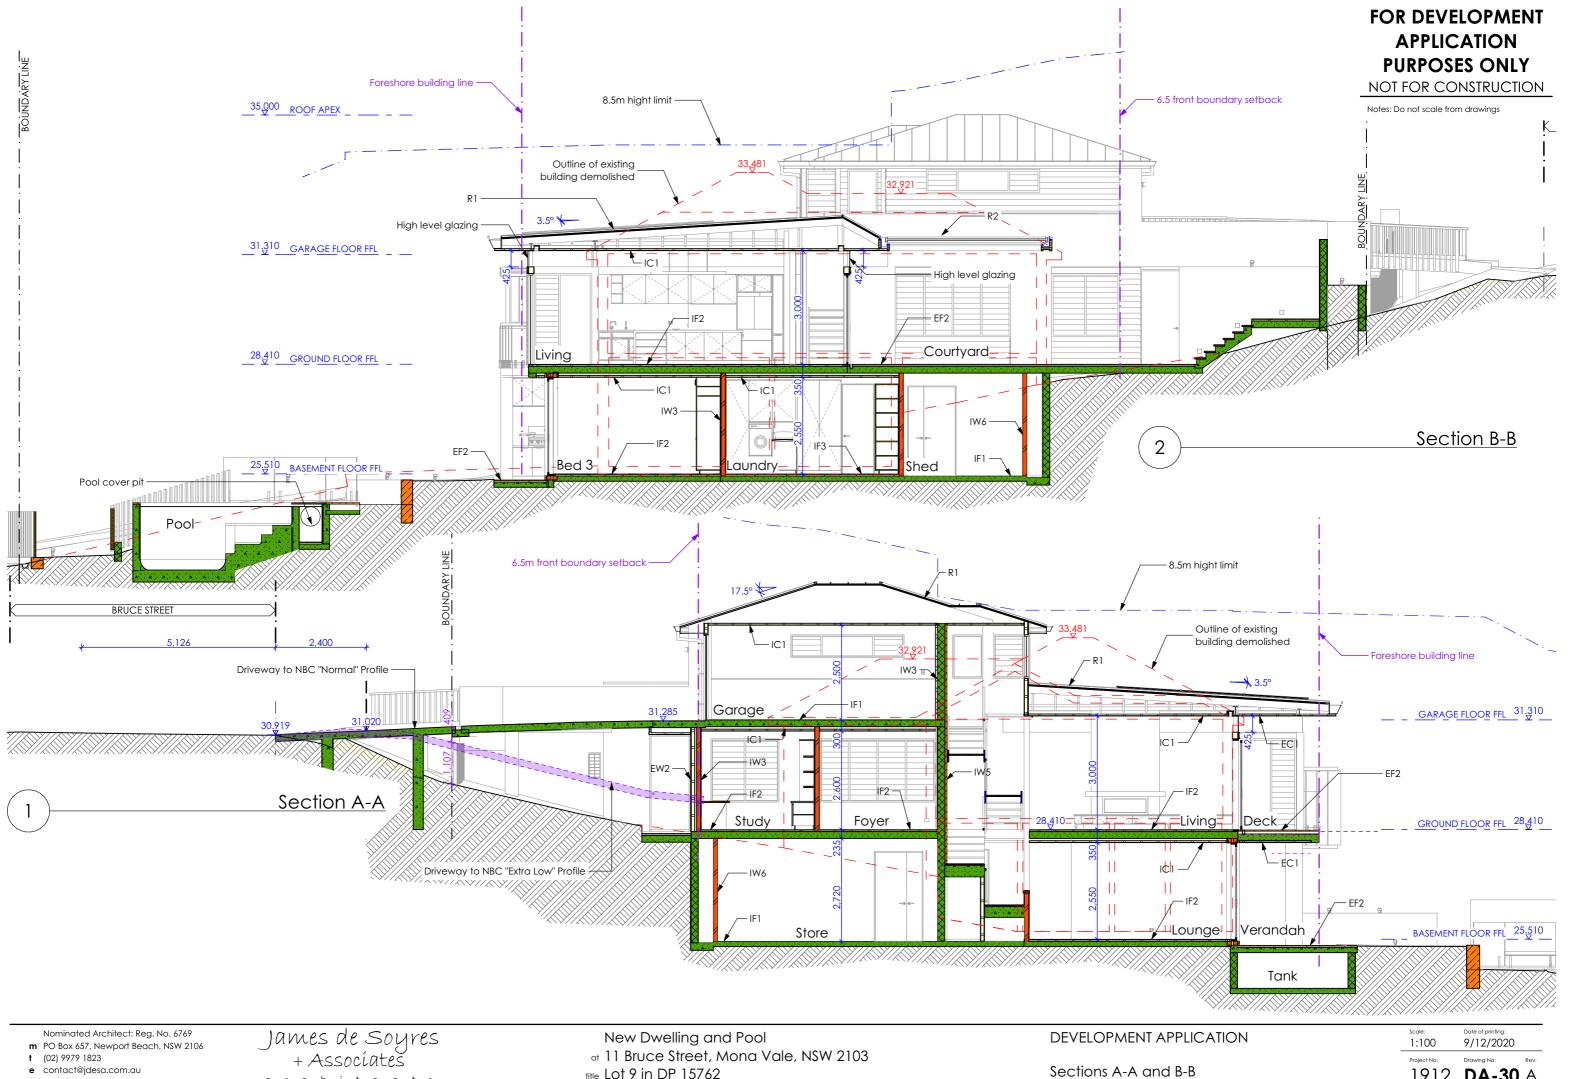


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architects

Sections A-A and B-B

1912 **DA-30** A



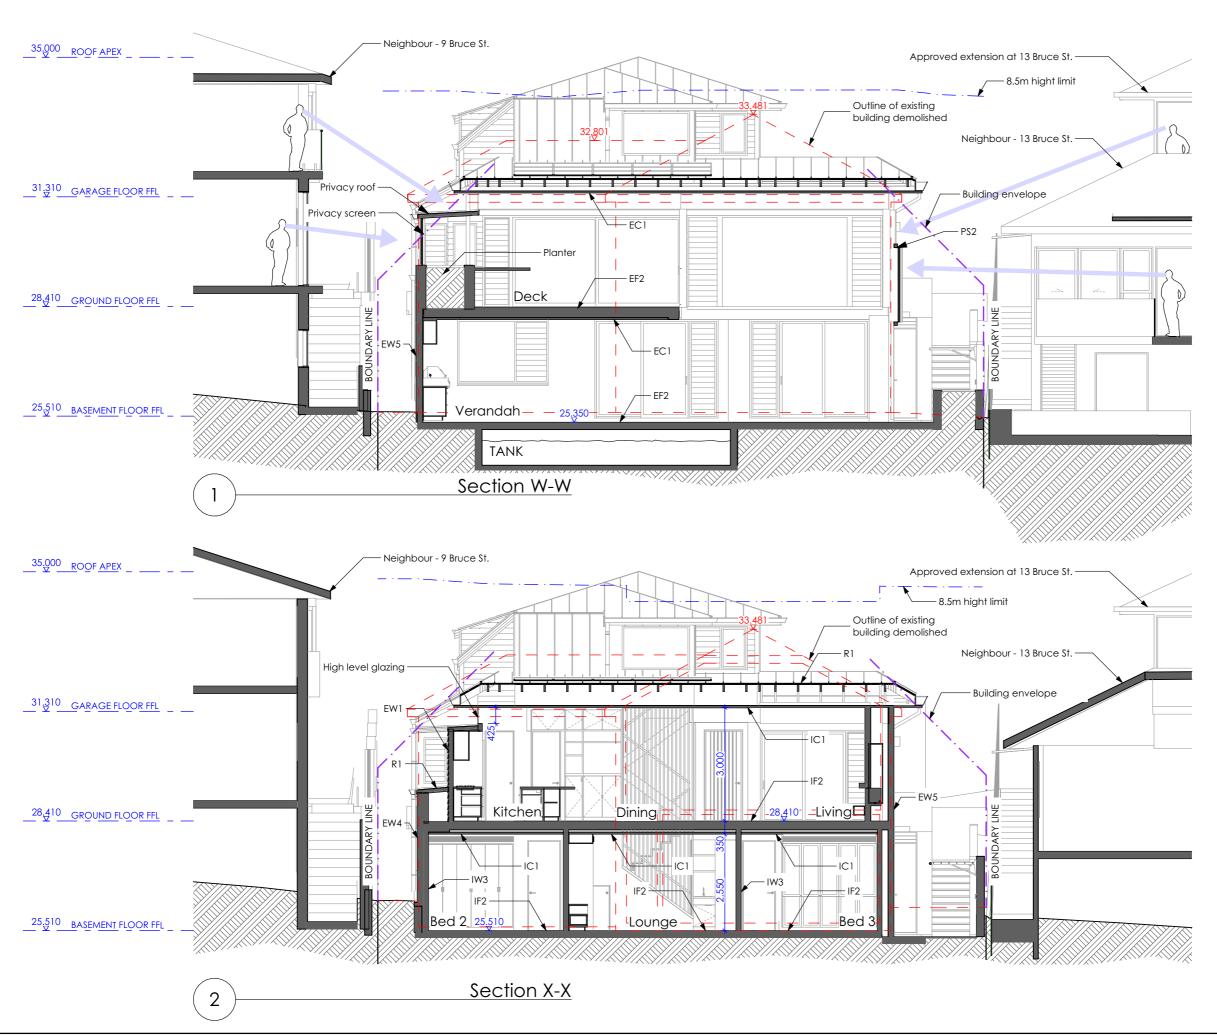

FOR DEVELOPMENT

**APPLICATION** 

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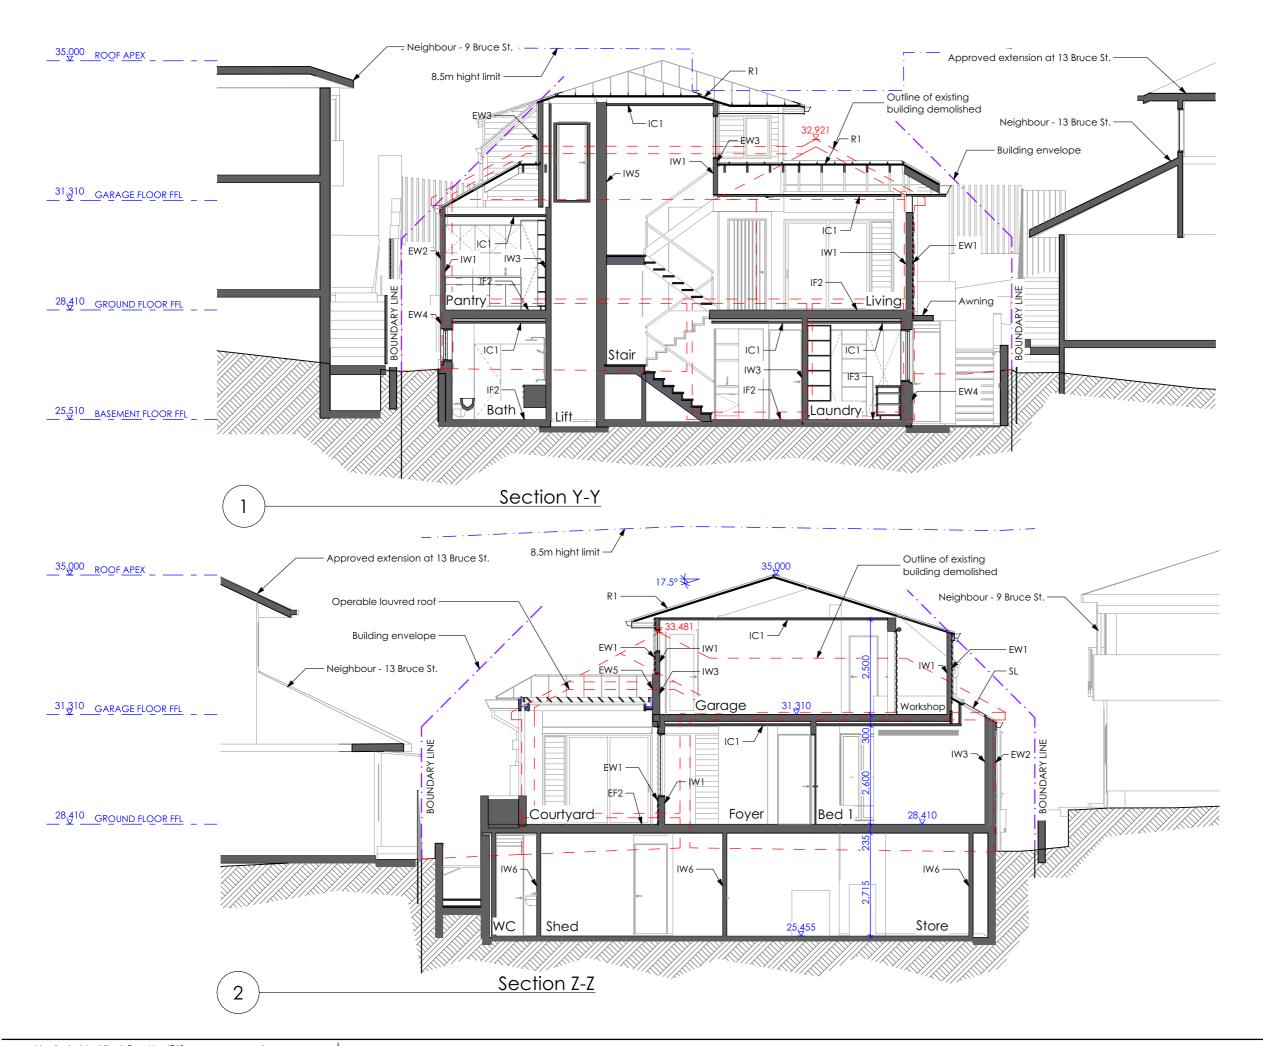
at 11 Bruce Street, Mona Vale, NSW 2103

title Lot 9 in DP 15762

DEVELOPMENT APPLICATION

Sections W-W and X-X

1:100 28/09/2020
Project No: Drawing No: 1912 **DA-31** 





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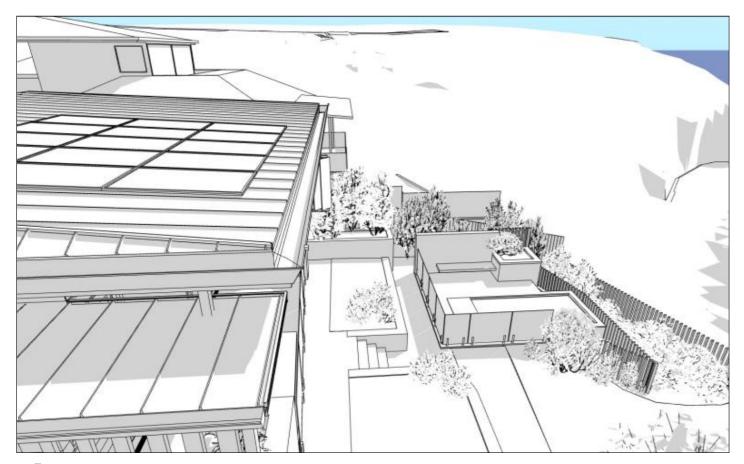
at 11 Bruce Street, Mona Vale, NSW 2103

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**DEVELOPMENT APPLICATION** 

Sections Y-Y and Z-Z

1:100 28/09/2020



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Notes: Do not scale from drawings



View from 9 Bruce St. - Top Balcony



View from 9 Bruce St. - Middle Balcony



View from 9 Bruce St. - Pool Level

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James de Soyres + Associates architects New Dwelling and Pool at 11 Bruce Street, Mona Vale, NSW 2103

file Lot 9 in DP 15762

DEVELOPMENT APPLICATION

Views from 9 Bruce St.

| Scale: | Date of printing: | 28/09/2020 | | Project No: | Drawing No: | Rev



## View from 13 Bruce St. - Balcony



View from 13 Bruce St. - Pool Level



View from 13 Bruce St. - Approved Roof Terrace

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title Lot 9 in DP 15762

DEVELOPMENT APPLICATION


Views from 13 Bruce St.

Scale: Date of printing: 28/09/2020

Project No: Drawing No: Re
1912 DA-41

FOR DEVELOPMENT
APPLICATION
PURPOSES ONLY
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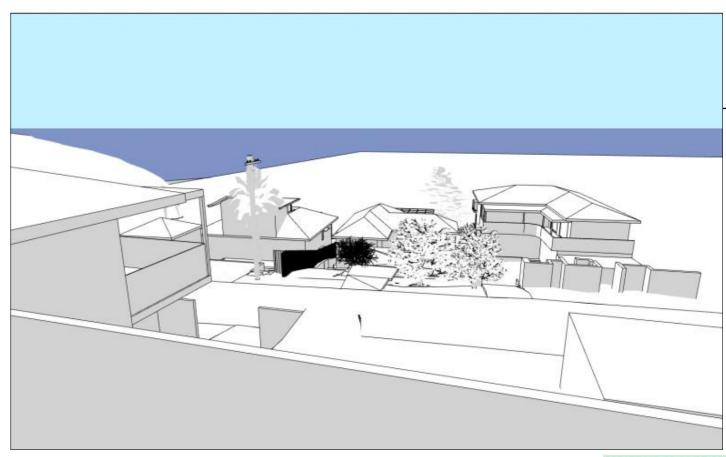
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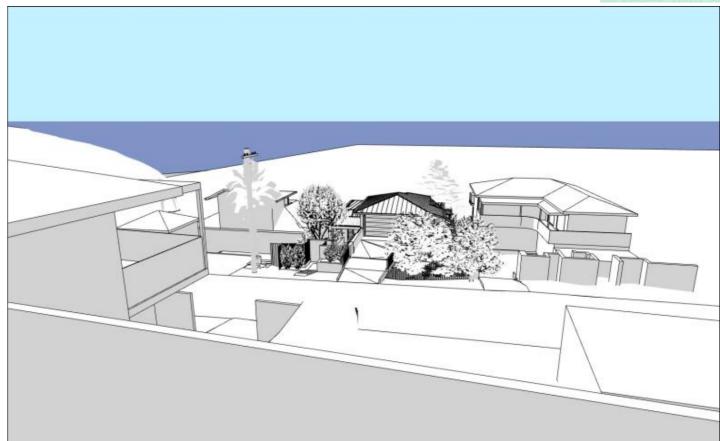


Proposed View from Neighbour 87 NPP

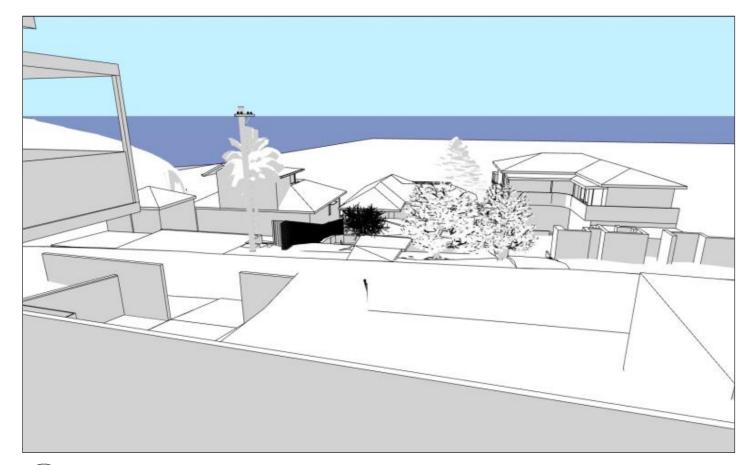

Existing View from Neighbour 87 NPP





Proposed View from Neighbour 87 NPP

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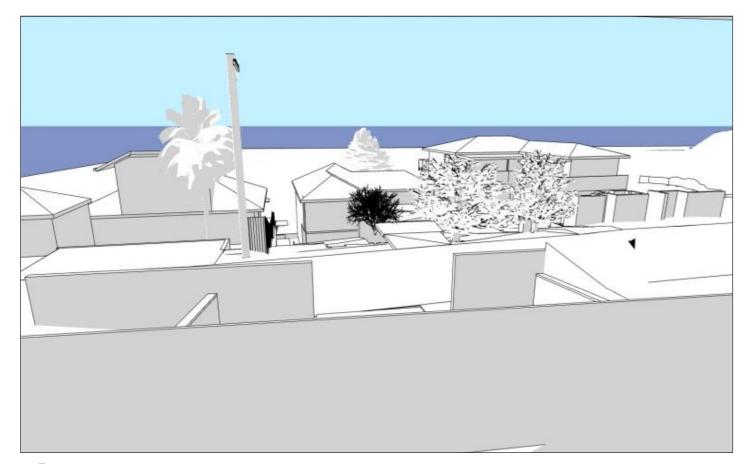
New Dwelling and Pool


at 11 Bruce Street, Mona Vale, NSW 2103 title Lot 9 in DP 15762


DEVELOPMENT APPLICATION

Views from 87 Narrabeen Park Parade


28/09/2020



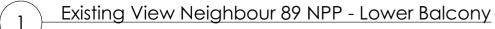

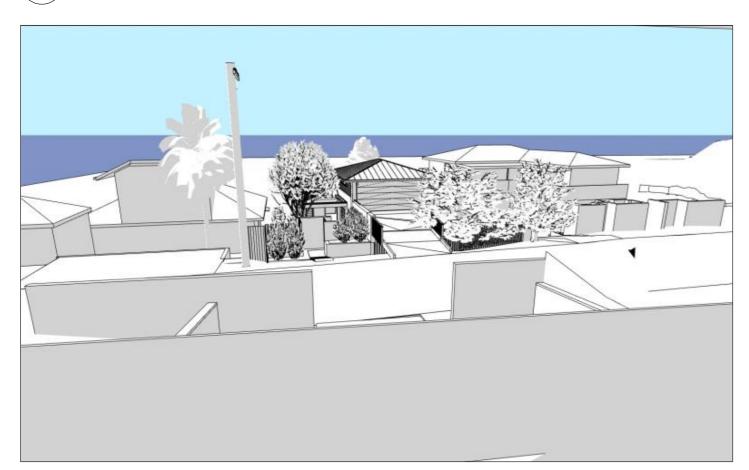

Proposed View Neighbour 89 NPP - Lower Balcony

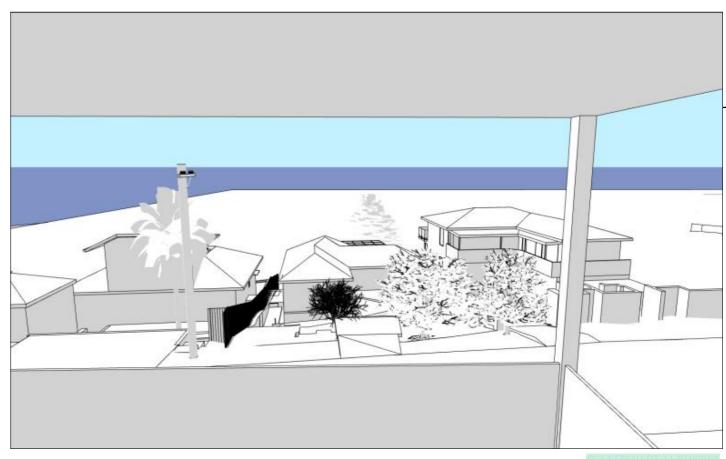

Existing View Neighbour 89 NPP - Main Terrace





Proposed View Neighbour 89 NPP - Main Terrace

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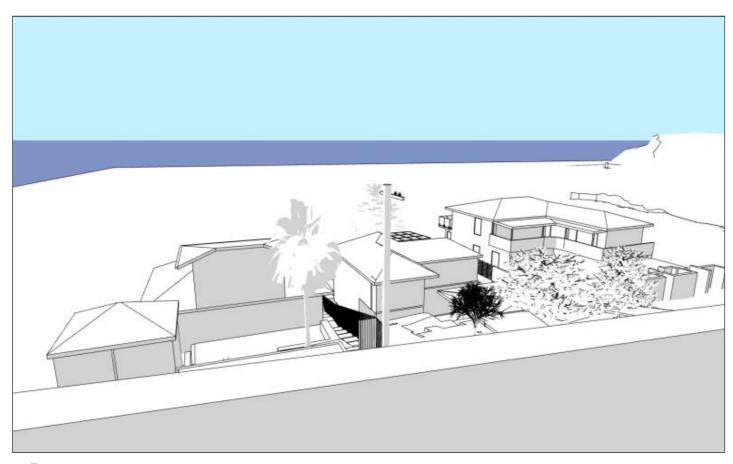
New Dwelling and Pool at 11 Bruce Street, Mona Vale, NSW 2103

title Lot 9 in DP 15762


DEVELOPMENT APPLICATION

28/09/2020


Views from 89 Narrabeen Park Parade 1912 **DA-43** 



Existing View from Neighbour 91 NPP

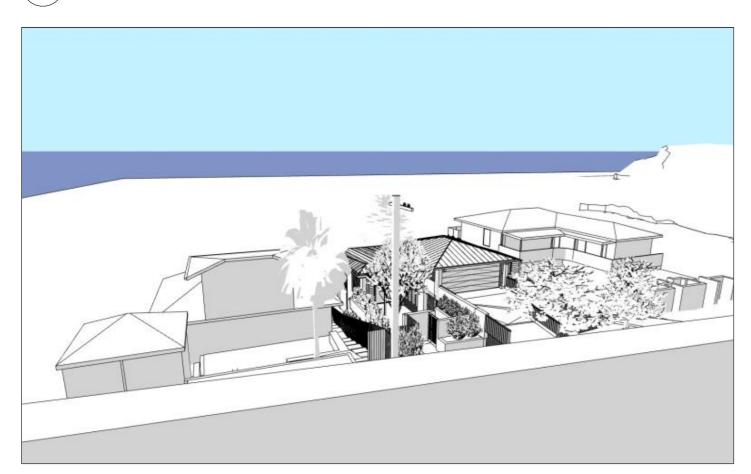


Proposed View from Neighbour 91 NPP

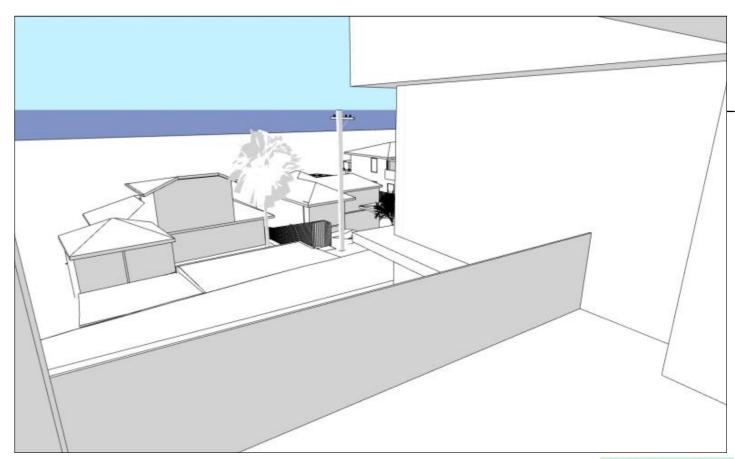

Existing View from Neighbour 91 NPP



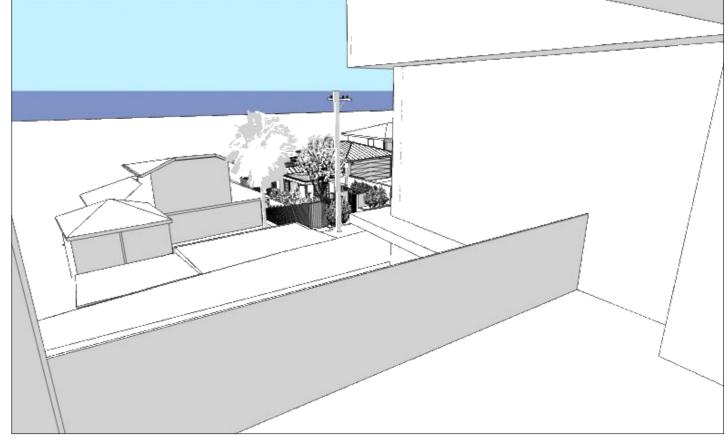

Proposed View from Neighbour 91 NPP

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New Dwelling and Pool

at 11 Bruce Street, Mona Vale, NSW 2103

title Lot 9 in DP 15762

DEVELOPMENT APPLICATION

Views from 91 Narrabeen Park Parade

28/09/2020 1912 **DA-44** 

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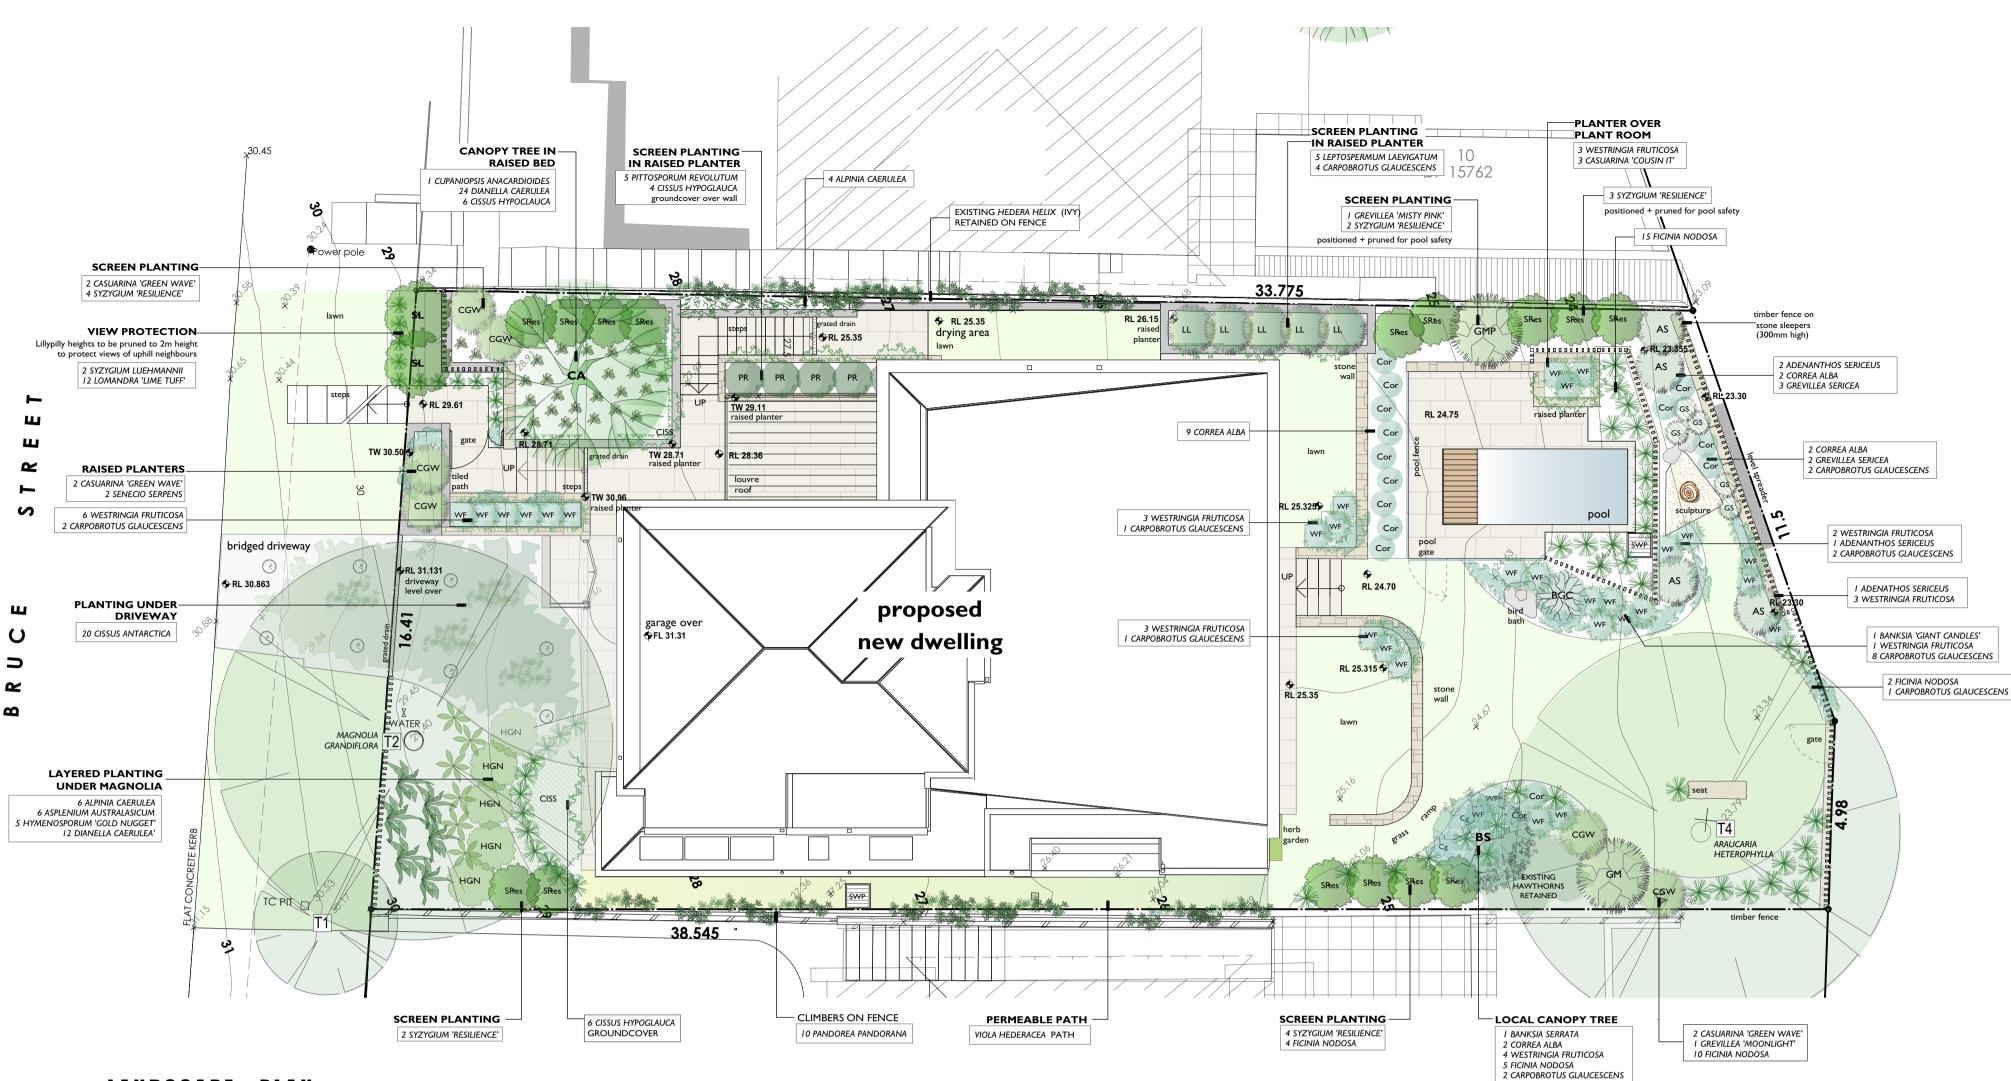


View from Proposed Living Room towards 13 Bruce St.




2 View from Proposed Deck towards 9 Bruce St





LANDSCAPE PLAN SCALE 1:100 @ A1

## LEGEND

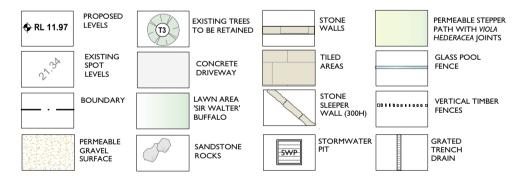

## COMPLIANCE TABLE

PITTWATER LEP 2014

7.6 BIODIVERSTIY PROTECTION The landscape design aims to enhance the foreshore vegetation + maintain terrestrial buildiversity by:
- protecting native fauna and flora
- no native flora proposed to be removed from site
- no weed species to be introduced to site

- 80% of proposed planting nominated to be local speces - any new fencing shall be wildlife passable PITTWATER 21 DCP

**B4.11 LAND ADJOINING BUSHLAND** 80% of any new planting shall be locally native vegetation to comply with control

**B4.17 LITTORAL RAINFOREST - ENDANGERED ECOLOGICAL COMMUNITY** The site does not contain any Littoral Rainforest species

**B4.22 PRESERVATION of TREES and BUSHLAND VEGETATION** No protected trees or bushland vegetation are proposed to be removed to facilitate the development

**C.I.3 VIEW SHARING** 

C.I.I LANDSCAPING The design aims to soften and complemented the built form

 The landscaping reflects the scale and form of development and screen the built form
 Pier and beam footings are proposed within the TPZ of existing tree T2 proposed for retention The development results in an increase in the number of local tree species + local tree canopy The landscape proposal enhances Pittwater's biodiversity by using locally native plant species
The landscaping enhances habitat and amenity value
The development complies with geotechnical advice to reduce risk of landslip
The landscaping results in 95% plants of low watering requirement

MINIMUM TREES REQUIRED: 2 FRONT and I REAR (Minimum 8m3 / tree)

2 FRONT and 2 REAR COMPLIES WITH DCP I MAGNOLIA GRANDIFLORA TREES PROPOSED:

I CUPANIOPSIS ANACARDIOIDES Canopy trees are to be located a minimum of 5 metres from existing and proposed built structures, or minimum of 3 metres where pier and beam footings are used. A minimum of 8m3 soil volume shall be

provided for new trees. COMPLIES (100% REQUIRED) OVERALL LOCAL SPECIES PROPOSED SCREENING OF THE BUILT FORM: 60% SCREENING COMPLIES (60% REQUIRED)

Proposed planting aims to protect the views of adjoining properties CI.17 SWIMMING POOL SAFETY Design complies with AS1926.1-2007 Swimming Pool Safety, Swimming Pools Act 1992 and Regulations

D14.13 LANDSCAPE AREA - ENVIRONMENTALLY SENSITIVE LAND

E4 ENVIRONMENTAL LIVING SITE AREA: MINIMI IM LANDSCAPE AREA DCP 21: SOFT LANDSCAPE AREA PROPOSED: VARIATION CLAIMED FOR AMENITY AREA: 35.543m<sup>2</sup> (6%) LANDSCAPE AREA PROPOSED:

316.83m² (53.5%) (refer to Architectural Plan DA05 Areas Schedule 1912-DA05 (28.9.20) for full details of area calculations) The landscape design provides for 268m2 of low water or indigenous species (95% of landscape area)

## LANDSCAPE DESIGN PRINCIPLES

TO INTEGRATE DEVELOPMENT WITH STREETSCAPE SELECTION OF EVERGREEN NATIVE (LOCAL + NON-LOCAL) SPECIES PROPOSED WITH THE AIM TO INTEGRATE THE DEVELOPMENT WITH EXISTING STREETSCAPE IN A STYLE THAT HARMONISES WITH ADJOINING PROPERTIES AND

MAINTAINS THE COASTAL CHARACTER OF THE LOCALITY. TO INTEGRATE SITE WITH ADJOINING WARRIEWOOD BEACH RESERVE A MAJORITY (80%) LOCALLY INDIGENOUS SPECIES HAVE BEEN PROPOSED TO INTEGRATE THE SITE WITH THE ADJOINING RESERVE.

TO REDUCE THE IMPACT OF THE BUILT FORM PROVISION OF TREES AND SCREEN SHRUBS WITHIN FRONT BUILDING SETBACK DESIGNED TO REDUCE THE IMPACT AND SOFTEN THE BUILT FORM, PRESENTING THE DEVELOPMENT WITHIN A VEGETATED SETTING.

A MINIMUM OF 60% OF THE BUILT FORM SHALL BE SCREENED FROM BRUCE STREET. TO PROTECT NEIGHBOUR AMENITY + MAINTAIN VIEWS BOUNDARY SCREEN PLANTING HAS BEEN PROVIDED TO PROTECT NEIGHBOUR PRIVACY.

TREE PLACEMENT IS MINDFUL OF THE DESIRE TO MAINTAIN VIEW LINES FROM SITE AND ADJOINING PROPERTIES. TO CONSERVE, PROTECT AND ENHANCE THE LOCAL ECOLOGY NO LOCAL TREE OR SHRUBS SPECIES ARE PROPOSED TO BE REMOVED FROM THE STIE. NO LITTORAL RAINFOREST SPECIES ARE CURRENTLY LOCATED ON THE SITE.

THE MAJORITY (80%) OF NEW SITE PLANTING SHALL BE SOURCED FROM LOCAL SPECIES. TO COMPENSATE FOR

VEGETATION PROPOSED TO BE REMOVED AND ENHANCE FORAGING AND HABITAT OPPORTUNITIES FOR LOCAL FAUNA AND BIRDLIFE. NEW BOUNDARY FENCING WILL REMAIN WILDLIFE PASSABLE. TO REPLENISH NEIGHBOURHOOD TREE CANOPY

IN ADDITION TO TWO (2) EXISTING TREES PROPOSED TO BE RETAINED WITHIN THE DEVELOPMENT, TWO (2) LOCAL TREES ARE PROPOSED TO BE PLANTED TO COMPLY WITH DCP REQUIREMENTS 1 × BANKSIA SERRATA (Old Man Banksia) 1 x CUPANIOPSIS ANACARDIOIDES (Tuckeroo)

all noxious and environmental weeds shall be removed from site and no weed species planted. TO FACILITATE RESPONSIBLE STORMWATER MANAGEMENT

SOFT SURFACES HAVE BEEN MAXIMISED TO PROVIDE FOR INFILTRATION OF STORMWATER

TO COMPLY WITH BASIX COMMITMENTS 268m2 OF 'LOW WATER or INDIGENOUS' SPECIES (95% OF LANDSCAPE AREA) HAVE BEEN INCLUDED TO MEET BASIX SUSTAINABILITY COMMITMENTS

## SPECIFICATIONS

TO CONTROL SPREAD OF WEEDS

NCE WITH FUTURE DETAILED SPECIFICATIONS

CARE SHALL BE TAKEN DURING ALL WORKS INCLUDING DEMOLTION TO PROTECT EXISTING TREES (INCLUDING ROOTS AND CANOPY AREA) ON SITE AND ROAD RESERVE. REFER TO ARBORIST REPORT FOR DETAILS.

AREA OF EXPOSED TREE ROOTS ON ROAD RESERVE SHALL BE PROTECTED FOR THE ENTIRE PERIOD OF THE WORKS AS SPECIFIED IN ARBORIST REPORT. PROJECT ARBORIST SHALL ATTEND SITE FOR TREE PRUNING AND DRIVEWAY PIER EXCAVATION WORKS SOIL PREPARATION

PLANTING BEDS SHALL BE PREPARED BY REMOVING ALL BUILDER'S RUBBLE. WASTE MATERIAL AND WEED MATERIAL. SPREAD PLANTING BEDS SHALL BE PREPARED BY REPOVING ALL BUILDER'S ROBBLE, WASTE PIATERIAL. AND WEED PIATERIAL. SPREAD 100mm (SERENLIFE COMPOST OVER PLANTING BEDS PRIOR TO PLANTING AND CULTIVATE INTO TOP 20mm LAYER OF SITE SOIL. DO NOT INTRODUCE ORGANIC MATTER AT DEPTHS GREATER THAN 300mm. CONTRACTOR SHALL UNDERTAKE PH TESTS AND ADJUST WHERE NECESSARY TO ACHIEVE A RANGE OF 5.5-7.5. IMPORTED SOIL WHERE REQUIRED SHALL BE 'NATIVE' SOIL MIX'. INSTALL PLANTER BOX MIX FOR NATIVES' IN ALL PLANTERS. WATERPROOFING + DRAINAGE TO ENGINEER'S SPECIFICATIONS.

ALL PLANTS SHALL BE WELL GROWN AND DISEASE FREE. TREES SHALL BE GROWN TO NATSPEC / AS2303. PLANTING SHALL BE IN ACCORDANCE WITH PLANTING SCHEDULE . LOCALLY INDIGENOUS SPECIES SHALL BE SOURCED FROM LOCAL PROVENANCE WHEREVER POSSIBLE. CARE SHALL BE TAKEN WHEN PLANTING WITHIN THE TREE PROTECTION ZONES OF TREES TO BE RETAINED. PLANTING HOLES SHALL BE RELOCATED SHOULD TREE ROOTS BE ENCOUNTERED.

LAWN AREAS SHALL BE GRADED TO PROVIDE SUB-BASE AND SURFACE FALLS TO DRAINS.

'SIR WALTER' BUFFALO SHALL BE LAID ON A MINIMUM BASE OF 100mm QUALITY TURF UNDERLAY.


STEEL LAWN EDGING SHALL BE INSTALLED WHERE REQUIRED AT ALL JUNCTIONS OF LAWN AND PLANTING BEDS.

COVER PLANTING AREAS OF SITE WITH 75mm 'FOREST FINES' MULCH OR ALTERNATIVE APPROVED MULCH MATERIAL. KEEP MULCH CLEAR OF TREE + SHRUB TRUNKS. ENSURE ALL MULCH MATERIAL IS FREE OF WEED SEED AND VEGETATIVE MATERIAL

**FENCING** REFER TO ARCHITECT'S PLAN . NEW FENCES SHALL BE WILDLIFE PASSABLE.

WEED MANAGEMENT ALL PRIORITY AND ENVIRONMENTAL WEEDS SHALL BE REMOVED FROM SITE. NO WEED SPECIES SHALL BE PLANTED ON SITE.


**STORMWATER** REFER TO STORMWATER PLAN BY MICHAL KORECKY 20076 / SWI + SW2 (24.9.20)

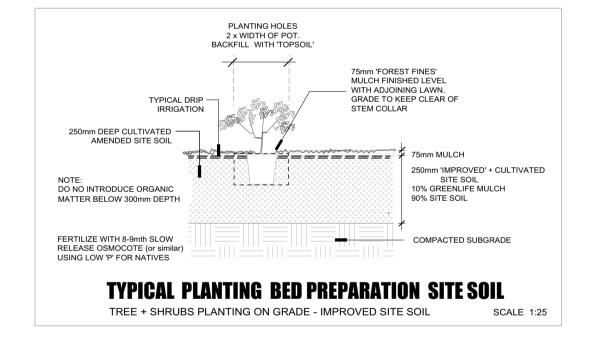



## PLANTING SCHEDULE

SPECIES HAVE BEEN SELECTED ON THE BASIS OF SUITABILITY TO SITE CONDITIONS AND LOCAL LANDSCAPE CHARACTER, WITH A MINIMUM OF 80% LOCAL SPECIES BEING SPECIFIED. WHERE AVAILABLE, SUPPLY LOCALLY INDIGENOUS SPECIES GROWN FROM LOCAL PROVENANCE STOCK. SYDNEY WATER 'PLANT SELECTOR' GENERALLY USED TO DETERMINE 'LOW' WATER REQUIREMENT

KEY	BOTANICAL NAME	COMMON NAME	HEIGHT	NO	POT SIZE	VEGETATION COMMUNITY	LOCAL	WATER	COMMENTS
TREE	ES								
BS	BANKSIA SERRATA	OLD MAN BANKSIA	6m	ı	75 litre	LOCAL SPECIES	1	LOW	LOCALLY INDIGENOUS SPECIES
CA	CUPANIOPSIS ANACARDIOIDES	TUCKEROO	6m	ı	75 litre	LITTORAL RAINFOREST SPECIES	1	LOW	LOCAL CANOPY TREE - MIN 8M3 SOIL VOLUME
SHR	UBS								
AC	ALPINIA CAERULEA	NATIVE GINGER	2m	10	200mm	LITTORAL RAINFOREST SPECIES		MOD	NATIVE SPECIES
AS	ADENANTHOS SERICEUS	ALBANY WOOLLY BUSH	2m	4	200mm			LOW	NATIVE SPECIES
ввс	BANKSIA 'BIRTHDAY CANDLES'	DWARF BANKSIA	2m	1	200mm			LOW	NATIVE SPECIES
CA	CORREA ALBA	WHITE CORREA	Im	15	200mm	LOCAL SPECIES	15	LOW	LOCALLY INDIGENOUS SPECIES
CGW	CASUARINA 'GREEN WAVE'	DWARF SHE-OAK	1.5m	6	200mm			LOW	NATIVE SEPCIES
GM	GREVILLEA 'MOONLIGHT'	CREAM GREVILLEA	2m	ı	200mm			LOW	NATIVE SEPCIES
GMP	GREVILLEA 'MISTY PINK'	PINK GREVILLEA	2m	I	200mm			LOW	NATIVE SEPCIES
GS	GREVILLEA SERICEA	PINK GREVILLEA	Im	5	200mm	LOCAL SPECIES	5	LOW	LOCALLY INDIGENOUS SPECIES
HGN	HYMENOSPORUM 'GOLD NUGGET'	DWARF NATIVE FRANGIPANI	I.2m	5	200mm			LOW	NATIVE SEPCIES
LL	LEPTOSPERMUM LAEVIGATUM	HEATH TEA TREE	3m	5	200mm	LOCAL SPECIES	5	LOW	LOCALLY INDIGENOUS SPECIES
PR	PITTOSPORUM REVOLUTUM	ROUGH FRUIT PITTOSPORUM	Im	5	200mm	LOCAL SPECIES	5	LOW	LOCALLY INDIGENOUS SPECIES
SL	SYZYGIUM LUEHMANII	SMALL LEAF LILLYPILLY	4m	2	75 litre	LITTORAL RAINFOREST SPECIES		LOW	NATIVE SPECIES- PRUNE TO 2m HIGH
SR	SYZYGIUM AUSTRALE 'RESILIENCE'	DWARF LILLYPILLY	3m	15	300mm			LOW	NATIVE SPECIES
WF	WESTRINGIA FRUTICOSA	COASTAL ROSEMARY	Im	31	200mm	LOCAL SPECIES	31	LOW	LOCALLY INDIGENOUS SPECIES
GRO	UNDCOVERS, ACCENTS, CLIM	BERS + GRASSES							
	ASPLENIUM AUSTRALASICUM	BIRDS NEST FERN	0.6m	6	200mm	LITTORAL RAINFOREST SPECIES	6	LOW	LOCALLY INDIGENOUS SPECIES
	CARPOBROTUS GLAUCESCENS	COASTAL PIGFACE	g/cover	24	I50mm	LOCAL SPECIES	24	LOW	LOCALLY INDIGENOUS SPECIES
	CASUARINA 'COUSIN IT'	DWARF SHE-OAK	g/cover	3	I50mm			LOW	NATIVE SPECIES
	CISSUS ANTARCTICA	KANGAROO VINE	g/cover	20	I50mm	LOCAL SPECIES	20	LOW	LOCALLY INDIGENOUS SPECIES
	CISSUS HYPOGLAUCA	WATER VINE	g/cover	16	I50mm	LOCAL SPECIES	16	MED	LOCALLY INDIGENOUS SPECIES
	DIANELLA CAERULEA	BLUE FLAG LILY	0.6m	36	I50mm	LOCAL SPECIES	36	LOW	LOCALLY INDIGENOUS SPECIES
	FICINIA NODOSA	KNOBBY CLUB RUSH	0.6m	36	I50mm	LOCAL SPECIES	36	LOW	LOCALLY INDIGENOUS SPECIES
	LOMANDRA 'LIME TUFF'	DWARF MAT RUSH	0.4m	12	I50mm			LOW	NATIVE SPECIES
	PANDORA PANDOREANA	WONGA WONGA VINE	climber	10	I50mm	LOCAL SPECIES	10	LOW	LOCALLY INDIGENOUS SPECIES
	SENECIO SERPENS	BLUE CHALKSTICKS	g/cover	2	I50mm			LOW	
	VIOLA HEDERACEA	NATIVE VIOLETS	g/cover	24	I50mm	LOCAL SPECIES	24	LOW	LOCALLY INDIGENOUS SPECIES
NUMBER OF LOCAL SPECIES							235		80%
	L NUMBER OF PLANTS PROPOSED			294					

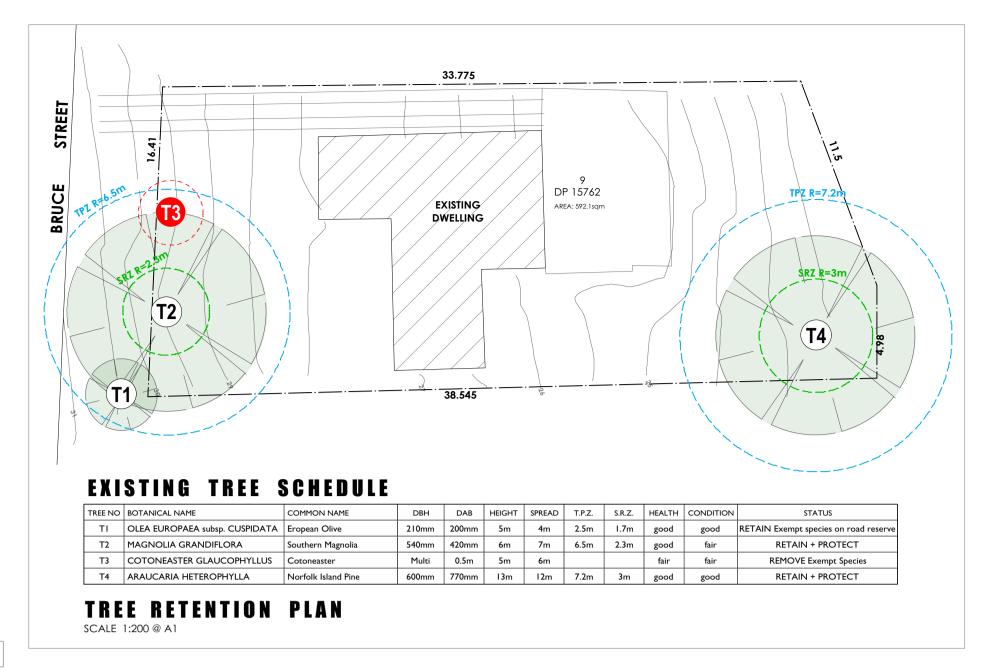

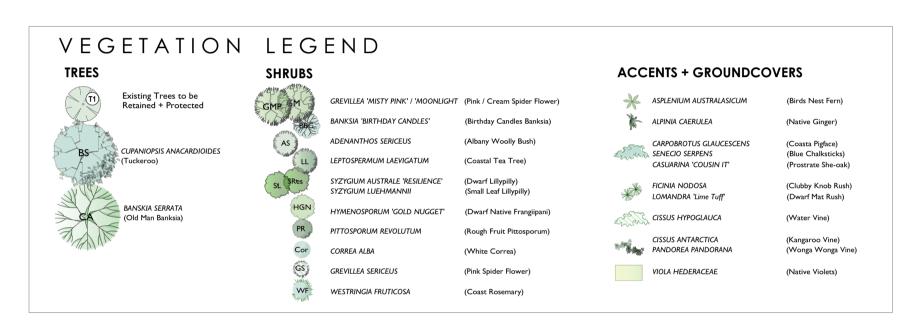

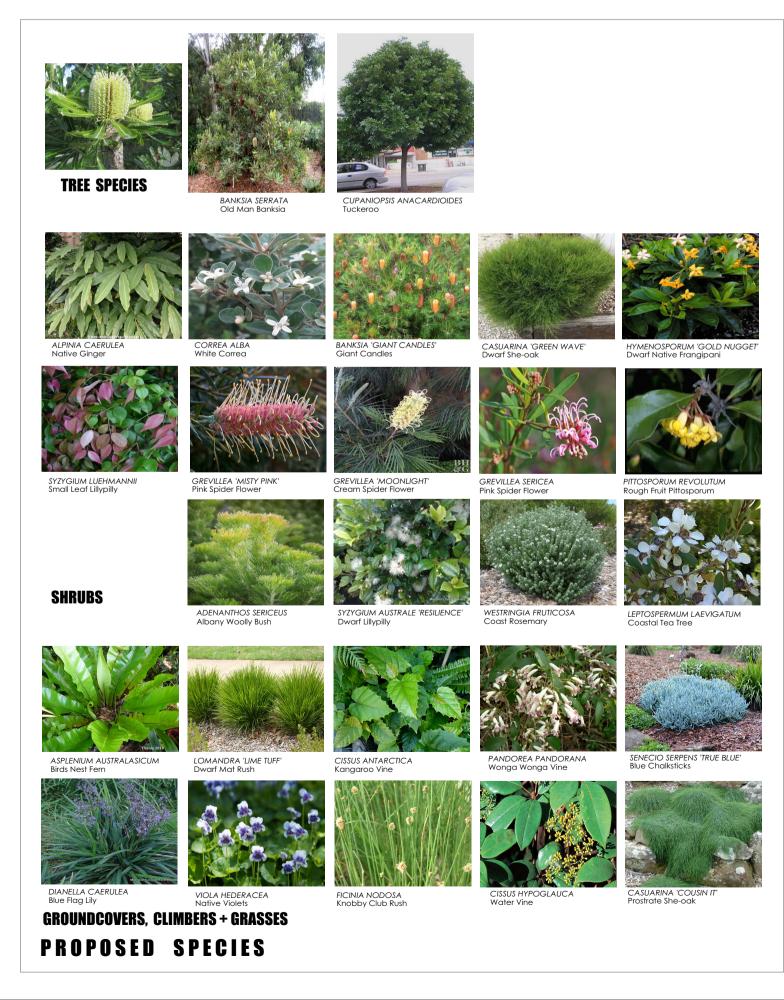



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DEVELOPMENT APPLICATION NEW DWELLING for B. HASTIE + C. HANDLEY



LANDSCAPE PLAN 1:100 @ A1 SCALE 28.9.20 DATE 2007 JOB DA ISSUE 2007/ DA-L01 DWG