## GENERAL NOTES


- 1. THE PLUMBER / DRAINER SHALL INSPECT THE SITE AND CONFIRM THE EXISTING SITE STRUCTURES, SERVICES AND CONDITIONS PRIOR TO PROCEEDING, IF ANY DISCREPANCIES FOUND, CONTACT THE ENGINEER FOR DISCUSSION.
- 2. ALL WORKS TO BE CARRIED OUT IN ACCORDANCE WITH RELEVANT AUSTRALIAN STANDARDS, BUILDING CODE OF AUSTRALIA AND LOCAL GOVERNMENT'S REQUIREMENTS. IT IS THE RESPONSIBILITY OF THE PLUMBER/ DRAINER TO OBTAIN ANY APPROVALS/ PERMITS/ LICENSES ISSUED BY THE AUTHORITIES PRIOR TO PROCEEDING WITH STORMWATER WORKS.
- 3. UNLESS NOTED AS OTHERWISE, ALL DOWNPIPES TO BE \$\phi\$100 ROUND (OR 100x75) RECTANGULAR) AND FULLY SEALED: ALL STORMWATER PIPES TO BE \$\phi\$100 SEWER GRADE AND LAID AT 1% MIN. FALL. ALL MATERIALS USED IN THE WORK SHALL BE NEW AND CONFORM WITH RELEVANT AUSTRALIAN STANDARDS AND BEAR THE REQUIRED STANDARDS MARK.
- 4. LOCATION OF STORMWATER SYSTEMS, INCLUDING DOWNPIPES, PIPES, PITS AND RAINWATER TANK ARE INDICATIVE ONLY. EXACT LOCATION SHALL BE DETERMINED ON SITE TO SUIT SITE CONDITIONS.
- 5. SUB-SOIL DRAINS FOR RETAINING WALL SHALL BE INSTALLED BY THE BUILDER AND CONNECTED TO STORMWATER LINES. ALL AGG. LINES SHALL BE 100mm DIA., UNLESS NOTED OTHERWISE.
- 6. LEVELS ARE APPROXIMATE ONLY. THE PLUMBER/ DRAINER SHALL CONFIRM THE LEVELS PRIOR TO PROCEEDING. IF ANY DISCREPANCIES FOUND. CONTACT THE ENGINEER FOR DISCUSSION.
- 7. INSPECTION AND CERTIFICATION, IF REQUIRED, SHALL BE DONE PRIOR TO BACKFILLING. ALLOW 24 HOUR NOTICE FOR THE ENGINEER TO CARRY OUT INSPECTION.
- 8. ANY DAMAGE TO SERVICES DURING CONSTRUCTION SHALL BE REPAIRED IMMEDIATELY AT THE PLUMBER / DRAINER'S OWN EXPENSE.
- 9. THESE DRAWINGS ARE TO BE READ IN CONJUNCTION WITH:
- ARCHITECTURAL PLAN BY ..., PROJECT/JOB No. ..., REVISION/ISSUE No. ..., DATED ...

## **BASIX REQUIREMENTS**

THIS DEVELOPMENT IS AN ALTERATIONS AND ADDITIONS TO AN EXISTING SINGLE DWELLING ONLY. THERE IS NO COMMITMENT TO RAINWATER REUSE UNDER BASIX CERTIFICATE.


## OSD REQUIREMENTS

THIS DEVELOPMENT IS AN ALTERATIONS AND ADDITIONS TO AN EXISTING SINGLE DWELLING ONLY. DUE TO THAT THE TOTAL IMPERVIOUS AREA NOT BEING INCREASED, OSD IS NOT REQUIRED.

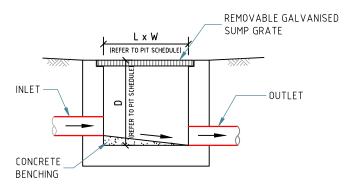

### GRATED PIT DETAILS

SCALE 1:20

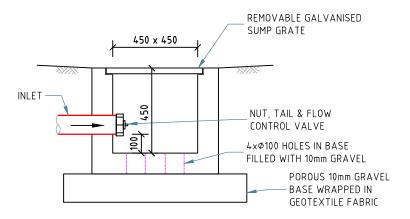


#### CLEAN-OUT/FIRST FLUSH PIT DETAILS

**SCALE 1:20** 

| MINIMUM PIPE COVER (FROM FINISHED SURFACE TO TOP OF PIPE)  |                                       |  |  |
|--|---------------------------------------|--|--|
|  | MINIMUM COVER (mm)                    |  |  |
| LOCATION   | CAST/DUCTILE IRON<br>GAL STEEL        | OTHER AUTHORISED<br>PRODUCTS (~)               |  |
| 1. NOT SUBJECT TO VEHICULAR LOADING: A. WITHOUT PAVEMENT i. FOR SINGLE DWELLING ii. OTHER THAN SINGLE DWELLING B. WITH PAVEMENT OF BRICK/UNREINFORCED CONCRETE   | 0<br>0<br>0(~~)                       | 100<br>300<br>50(~~)                           |  |
| 2. SUBJECT TO VEHICULAR LOADING: A. OTHER THAN ROAD: i. WITHOUT PAVEMENT ii. WITH PAVEMENT OF: - REIFORCED CONC. FOR HEAVY VEHICLE - BRICK/UNREINF. CONC. LIGHT VEHICLE B. ROAD i. SEALED ii. UNSEALED | 300<br>0(~~#)<br>0(~~#)<br>300<br>300 | 450<br>100(~~#)<br>75(~~#)<br>500(#)<br>500(#) |  |
| 3. SUBJECT TO CONSTRUCTION VEHICLE OR IN ENBANKMENT CONDITION  | 300                                   | 500(#)   |  |
| (~) INCLUDES OVERLAY ABOVE THE TOP OF THE PIPE OF NOT LESS THAN 50mm THICK   |                                       |  |  |

- (~~) BELOW THE UNDERSIDE OF THE PAVEMENT
- (#) SUBJECT TO COMPLIANCE WITH AS1762, AS2033, AS/NZS2566.1, AS3725 OR AS4060

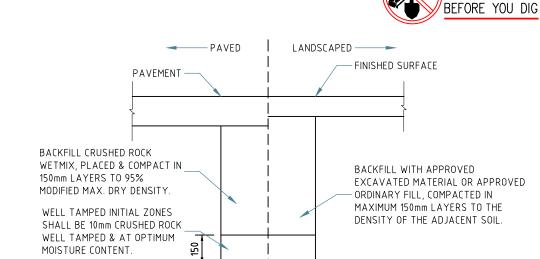


PIPE DIA X MIN "D" 100-150 75 300 75 600 75 75 225-300

BEDDING HAUNCH & OVERLAY ZONES SHALL BE 10mm CRUSHED ROCK WELL TAMPED & AT OPTIMUM MOISTURE CONTENT.

www.dialbeforeyoudig.com.au

### UPVC PIPE TRENCH BACKFILL TYP. DETAILS

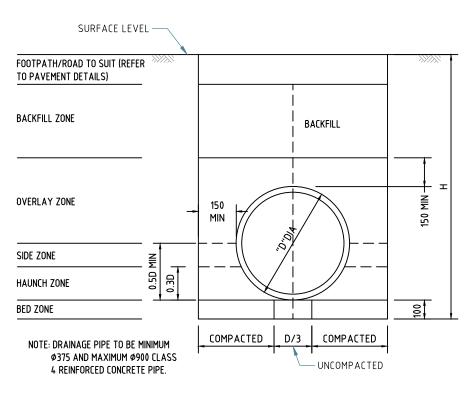

#### CONCRETE PIPE TRENCH BACKFILL TYP. DETAILS

**SCALE 1:20** 

All dimensions are in millimetres. Do not 1 scale the drawing. Use written dimensions. Dimensions must be confirmed prior to commencement. Location of services are approximate only. Dial 1100 before any

excavation or demolition.

Original issue Designed: DL,HL Checked: HL

Revisions

Approved: Quoc Huy Nguyen PhD (Eng), MIEAust, CPEng, CONSULTING © Copyright. All rights reserved. NER Reg. No. 208 2513


NITMA CONSULTING PTY LTD PO Box 43. West Rvde NSW 1685 M: 0434 284 585 E: admin@nitma.com.au W: nitma.com.au

PROJECT: PROPOSED ALTERATIONS AND ADDITIONS ADDRESS: 7 CARLTON STREET, MANLY LGA: NORTHERN BEACHES COUNCIL

#### **NOTES & STANDARD DETAILS**

Project No: 3484H Issue: B Date: 17.01.2019 Sheet No: 1 of 3



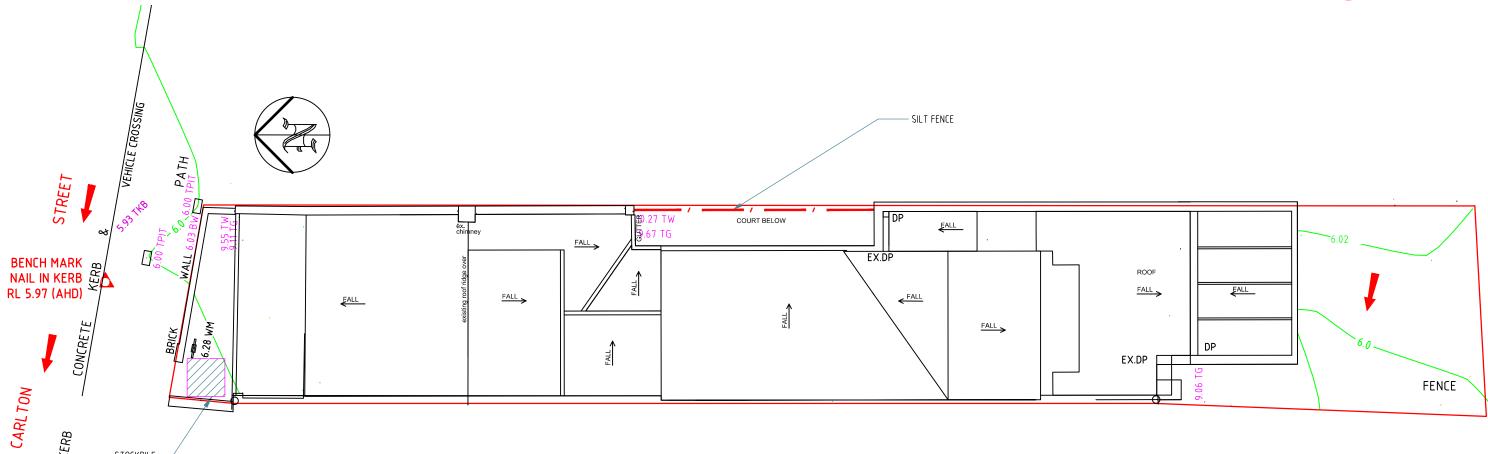

# EROSION AND SEDIMENT PLAN


SCALE 1:100

# NOTES:

- 1. ALL EROSION AND SEDIMENT CONTROL MEASURES TO BE INSPECTED AND MAINTAINED DAILY BY SITE MANAGER
- 2. MINIMISE DISTURBED AREA

STOCKPILE

- 3. ALL STOCKPILES TO BE CLEAR FROM DRAINS, GUTTERS AND FOOTPATH
- 4. DRAINAGE IS TO BE CONNECTED TO STORMWATER SYSTEM AS SOON AS POSSIBLE
- 5. ROADS AND FOOTPATH TO BE SWEPT DAILY
- 6. KERB SIDE INLET TO BE PROTECTED WITH FABRIC FILLED WITH GRAVEL

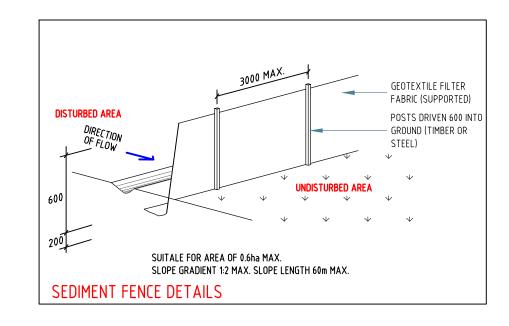

| ഗ്ര   | All dimensions are in millimetres. Do not  |
|-------|--|
| ⋖     | scale the drawing. Use written dimensions. |
| size: | Dimensions must be confirmed prior to      |
| Si    | commencement. Location of services are     |
| Ser   | approximate only. Dial 1100 before any     |
| Рар   | excavation or demolition.                  |
|       |  |

| Rev             | visions     | Approved:                                  |
|-----------------|-------------|--|
| Original issue  |             |  |
|                 |             | Quoc Huy Nguyen PhD (Eng), MIEAust, CPEng, |
| Designed: DL,HL | Checked: HL | NER Reg. No. 208 2513                      |

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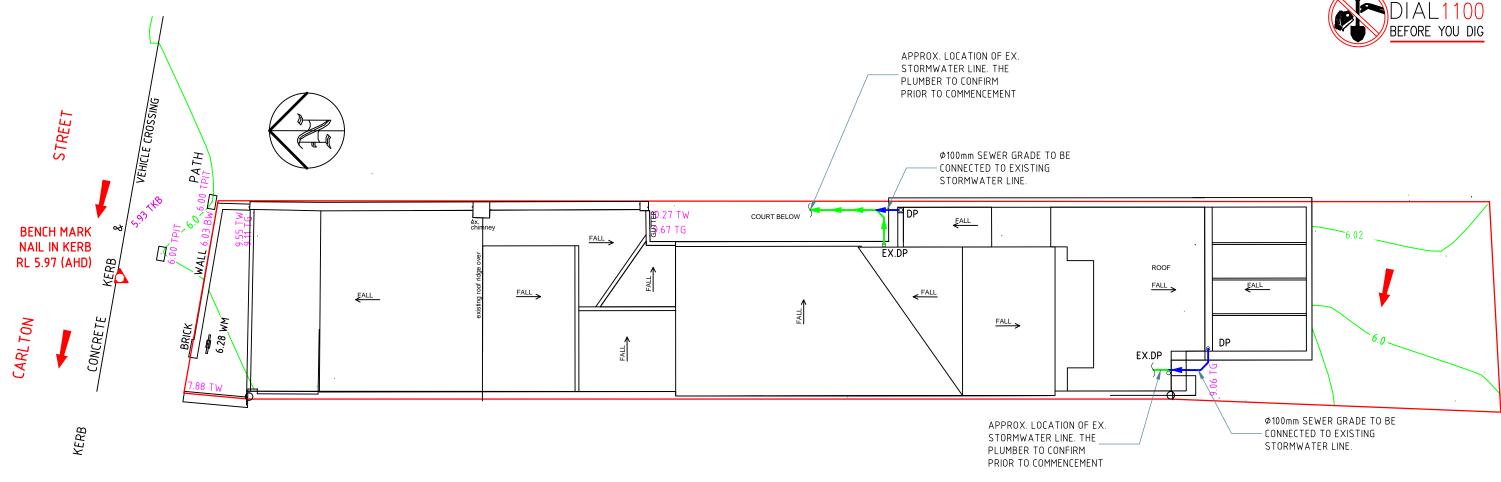
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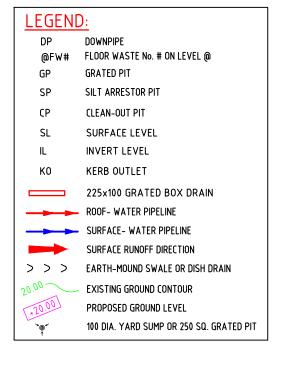
## **EROSION & SEDIMENT CONTROL PLAN**

Project No: 3484H Issue: B Date: 17.01.2019 Sheet No: 2 of 3





DRAINAGE PLAN SCALE 1:100



| 13    | All dimensions are in millimetres. Do not                        |
|-------|--|
| 4     | scale the drawing. Use written dimensions                        |
| size: | Dimensions must be confirmed prior to                            |
| .is   | commencement. Location of services are                           |
| Paper | approximate only. Dial 1100 before any                           |
| Ра    | approximate only. Dial 1100 before any excavation or demolition. |

Revisions Original issue Designed: DL,HL Checked: HL

Approved: Quoc Huy Nguyen

PhD (Eng), MIEAust, CPEng,

NER Reg. No. 208 2513

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#### **DRAINAGE PLAN**

Project No: 3484H

Issue: B Date: 17.01.2019 Sheet No: **3** of 3