

- 1. ALL EROSION AND SEDIMENTATION CONTROL MEASURES, INCLUDING REVEGETATION AND STORAGE OF SOIL AND TOPSOIL, SHALL BE IMPLEMENTED TO THE STANDARDS OF THE
- 2. ALL DRAINAGE WORKS SHALL BE CONSTRUCTED AND STABILISED AS EARLY AS POSSIBLE DURING DEVELOPMENT.
- DURING DEVELOPMENT.

  3. SEDIMENT TRAPS SHALL BE CONSTRUCTED AROUND ALL INLET PITS, CONSISTING OF
  300mm WIDE X 300mm DEEP TRENCH.


  4. ALL SEDIMENT BASINS AND TRAPS SHALL BE CLEANED WHEN THE STRUCTURES ARE A
  60% FULL OF SOIL MATERIALS, INCLUDING THE MAINTENANCE PERIOD.

  5. ALL DISTURBED AREAS SHALL BE REVEGETATED AS SOON AS THE RELEVANT WORKS ARE

- COMPLETED.

  6. SOIL AND TOPSOIL STOCKPILES SHALL BE LOCATED AWAY FROM DRAINAGE LINES AND AREA WHERE WAYER MAY CONCENTRATE.


  7. FILTER SHALL BE CONSTRUCTED BY STRETCHING A FILTER FABRIC (PROPEX OR APPROVED
- EQUIVALENT BETWEEN POST AT 3.0m CENTRES, FABRIC SHALL BE BURIED 150mm ALONG

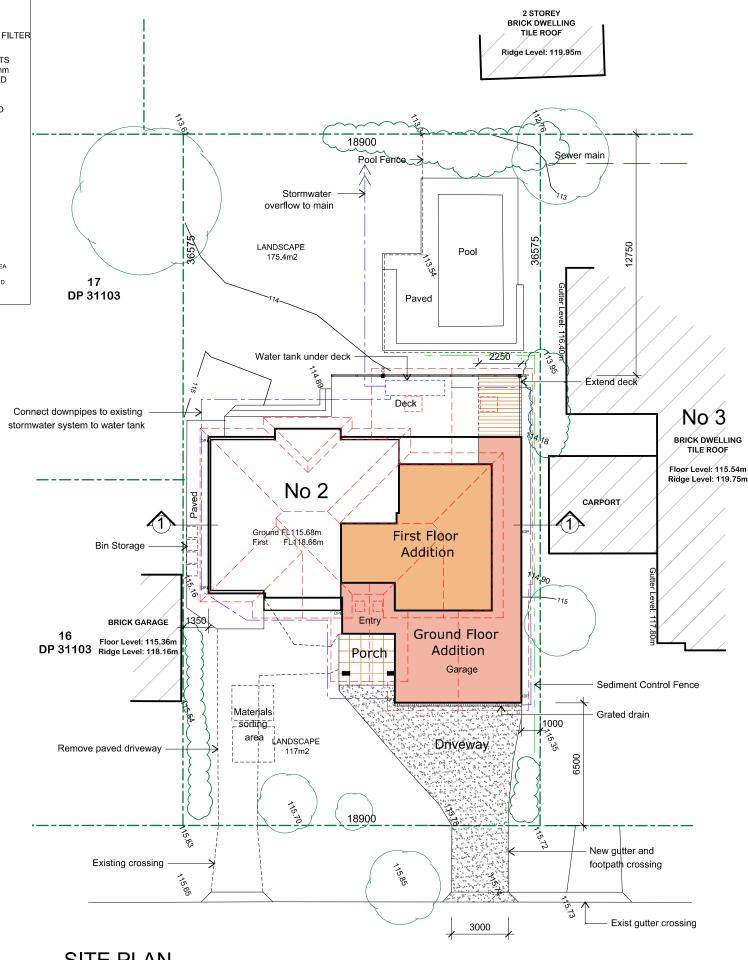



THIS PLAN IS TO BE READ IN **CONJUNCTION WITH** THE CONDITIONS OF DEVELOPMENT CONSENT

DA2021/0626

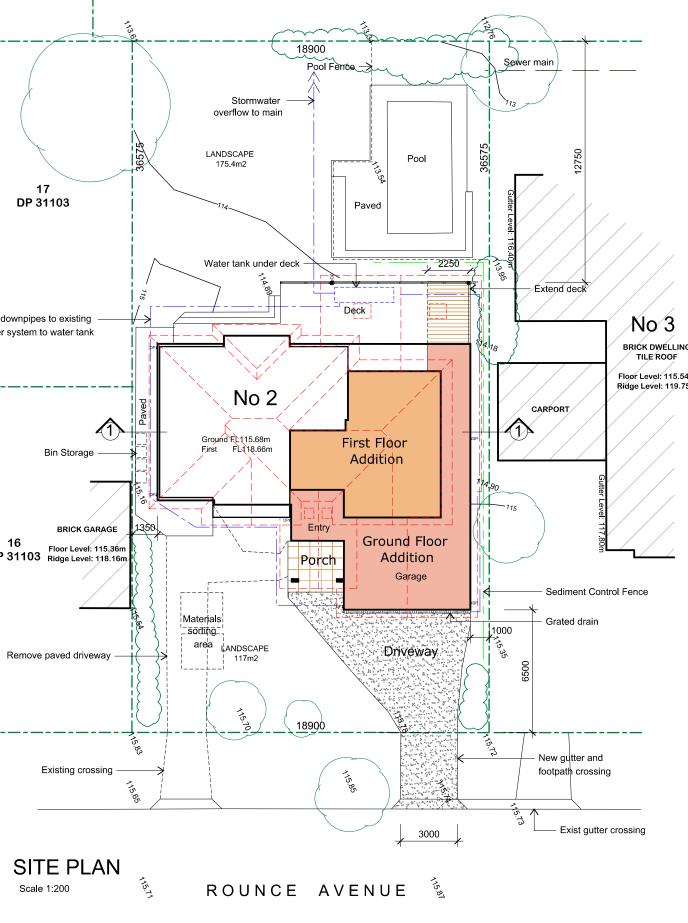

#### DRAWING NOTES

All new RWP to be connected to the Council's satisfaction

All timber sizes to comply with timber codes of Australia

All reinforced concrete slabs, footings, beams, etc to be engineers details

All building works to be in compliance with the building code of Australia. DO NOT SCALE FROM DRAWINGS - USE FIGURED DIMENSIONS

DIMENSIONS TO BE CHECKED ON SITE.

### CONSTRUCTION

Demolish walls as shown

Demolish existing steps and entry verandah to residence

Ground floor walls timber frame with sheet cladding and render finish.

First floor walls constructed of timber stud with weatherboard external cladding. Internal walls timber stud with plasterboard lining

Roof is timber framed, insulated and clad with selected tiles

Deck extension to ground floor is timber framed with timber decking boards to match existing

Floor to ground and first floor area is timber framed

Garage floor to be concrete slab

Windows are timber and aluminium

Construct new concrete driveway and gutter crossing

All sewer and stormwater lines to be connected to existing sewer and stormwater systems

Provide plumbing services to new kitchen and bathroom facilities.

Provide electrical services to all new work

### **BASIX**

As per Basix Certificate Number: A416006

<u>Lighting - minimum of 40% of new or altered light fixtures are fitted with</u> fluorescent, compact fluorescent, or light-emitting-diode (LED) lamps.

<u>Fixtures - New or altered showerheads have a flow rate no greater than 9 litres</u> per minute or a 3 star water rating.

New or altered toilets have a flow rate no greater than 4 litres per average flush or

New or altered taps have a flow rate no greater than 9 litres per minute or minimum 3 star water rating.

Insulation- for floors/walls/ceiling/roof/):

Concrete slab on ground - Nil

Suspended floor - enclosed sub floor Framed R0.7: R0.6 down (or R1.3 incl construction)

Floor above existing - Nil

External wall: Framed: R1.3 or R1.7 incl construction

Internal wall shared with Garage: Nil

Flat ceiling, Pitched roof: ceiling: R3.0 up, roof: foil sarking

Medium (solar absorptance 0.475-0.70)

Windows & Glazed Doors - Each window or glazed door with standard aluminium or timber frames and single clear glass

or have a U-value and a Solar Heat Gain Coefficient (SHGC) no greater than U-value:7.63, SHGC: 0.75

Other windows to have alternate glass options as per the glazing requirements



**AREAS** SITE AREA

689.2 m2

LANDSCAPE AREA

292.4 m2 = 42.43%

Neil Harvey - B.Arch

14 Farrer Place, Frenchs Forest NSW 2086

Ph: 0403 505 322 Email: nfharvey@bigpond.com

Alterations & Additions Mr & Mrs Clark

2 Rounce Ave Forestville NSW 2087

## SITE PLAN

SCALE:


DRAWN:

JOB No: 2057 LOT REF: Lot 15 DP 200198

DATE: 28 April 2021 DWG SIZE: A3

SHEET:

DA-1

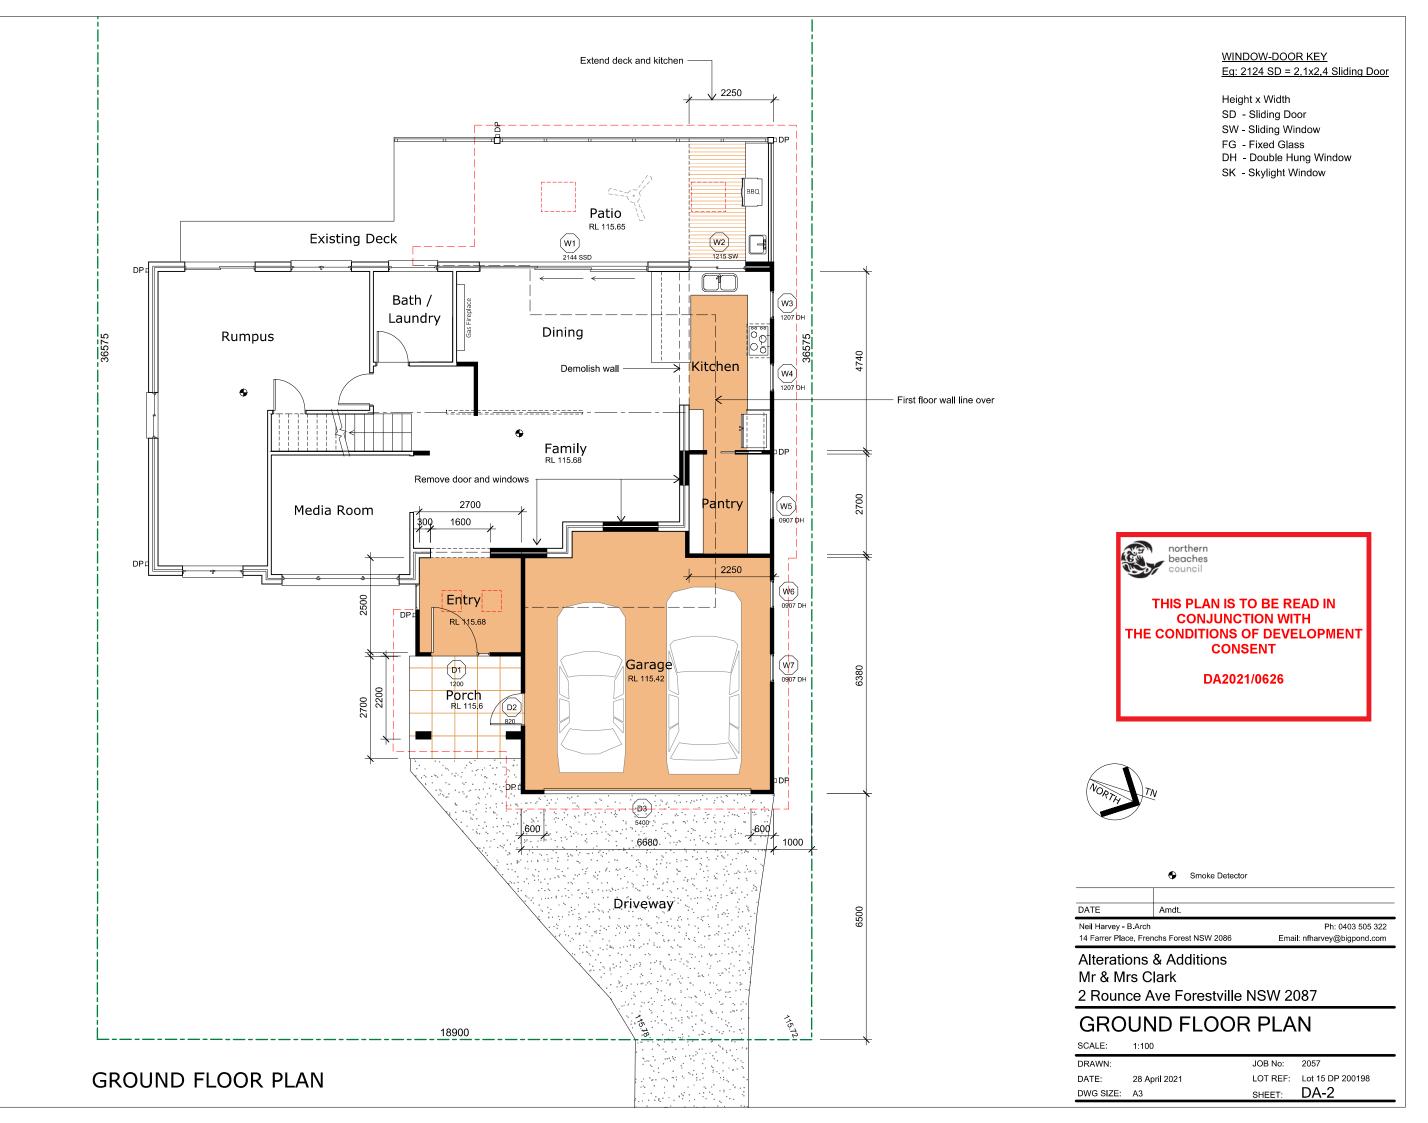



WINDOW-DOOR KEY Eg: 2124 SD = 2.1x2.4 Sliding Door

Height x Width

SD - Sliding Door

SW - Sliding Window

FG - Fixed Glass

DH - Double Hung Window SK - Skylight Window



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Smoke Detector

DATE

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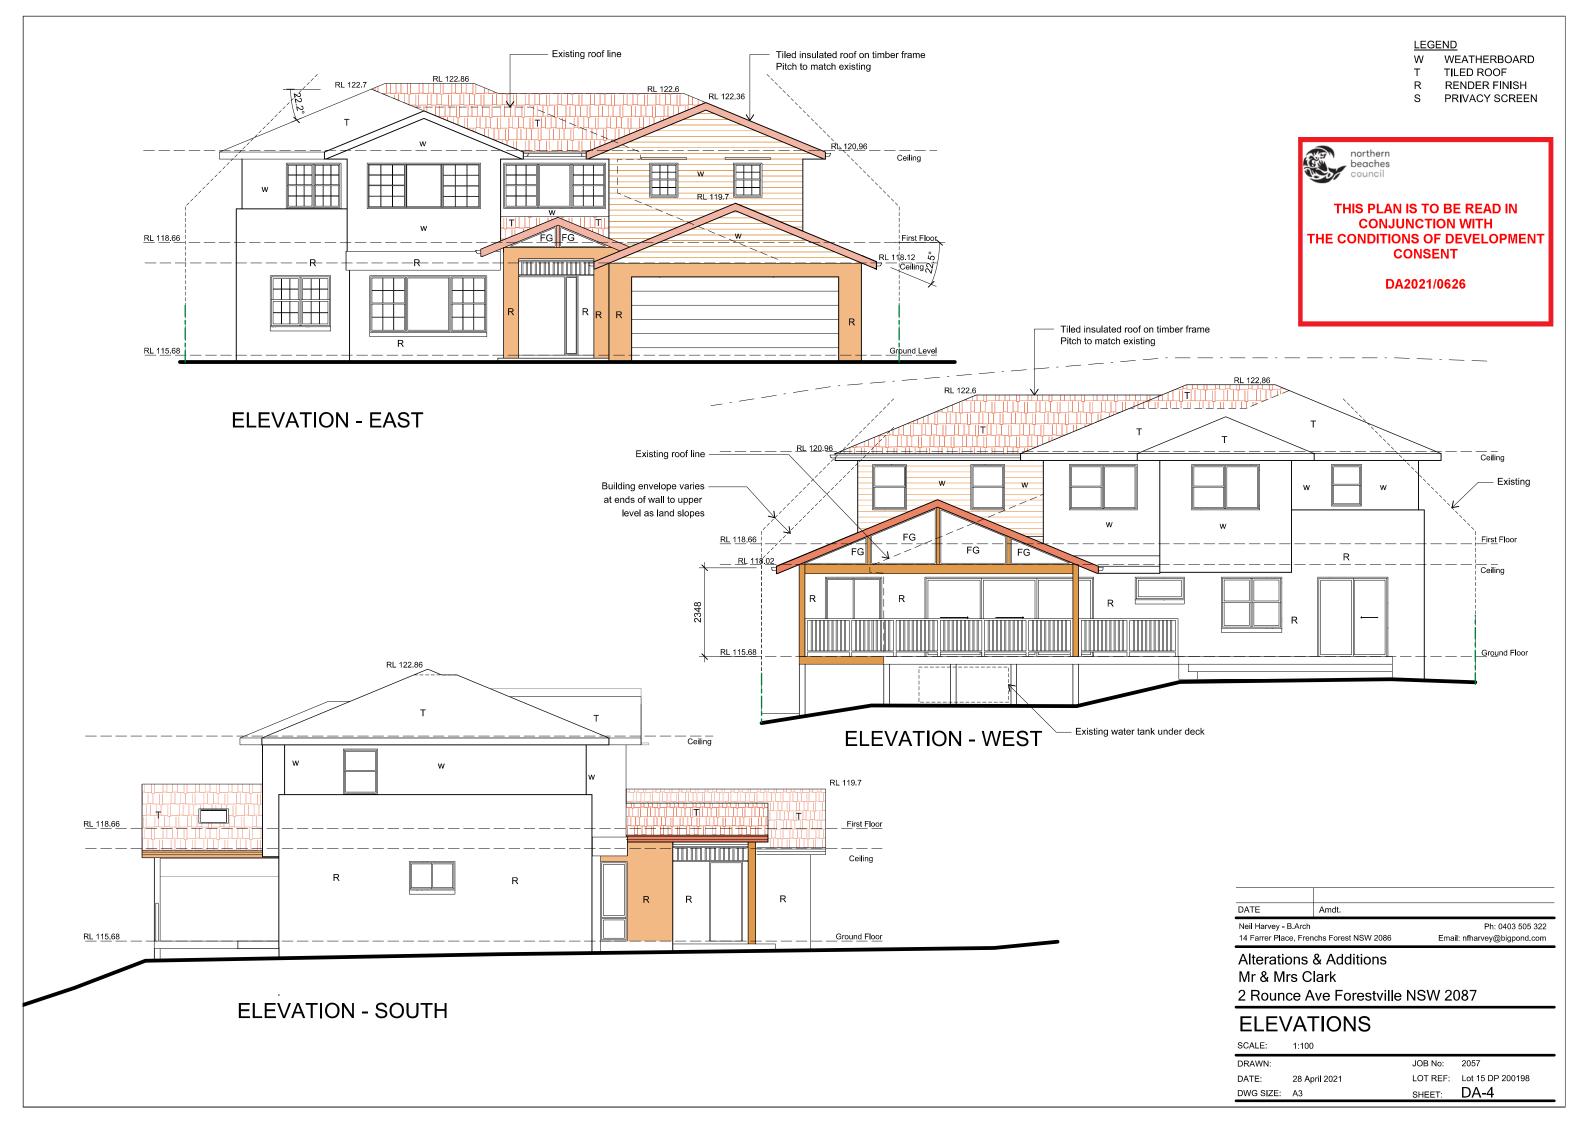
# FIRST FLOOR PLAN


SCALE:

DRAWN: LOT REF: Lot 15 DP 200198 DATE: 28 April 2021

DWG SIZE: A3

DA-3 SHEET:



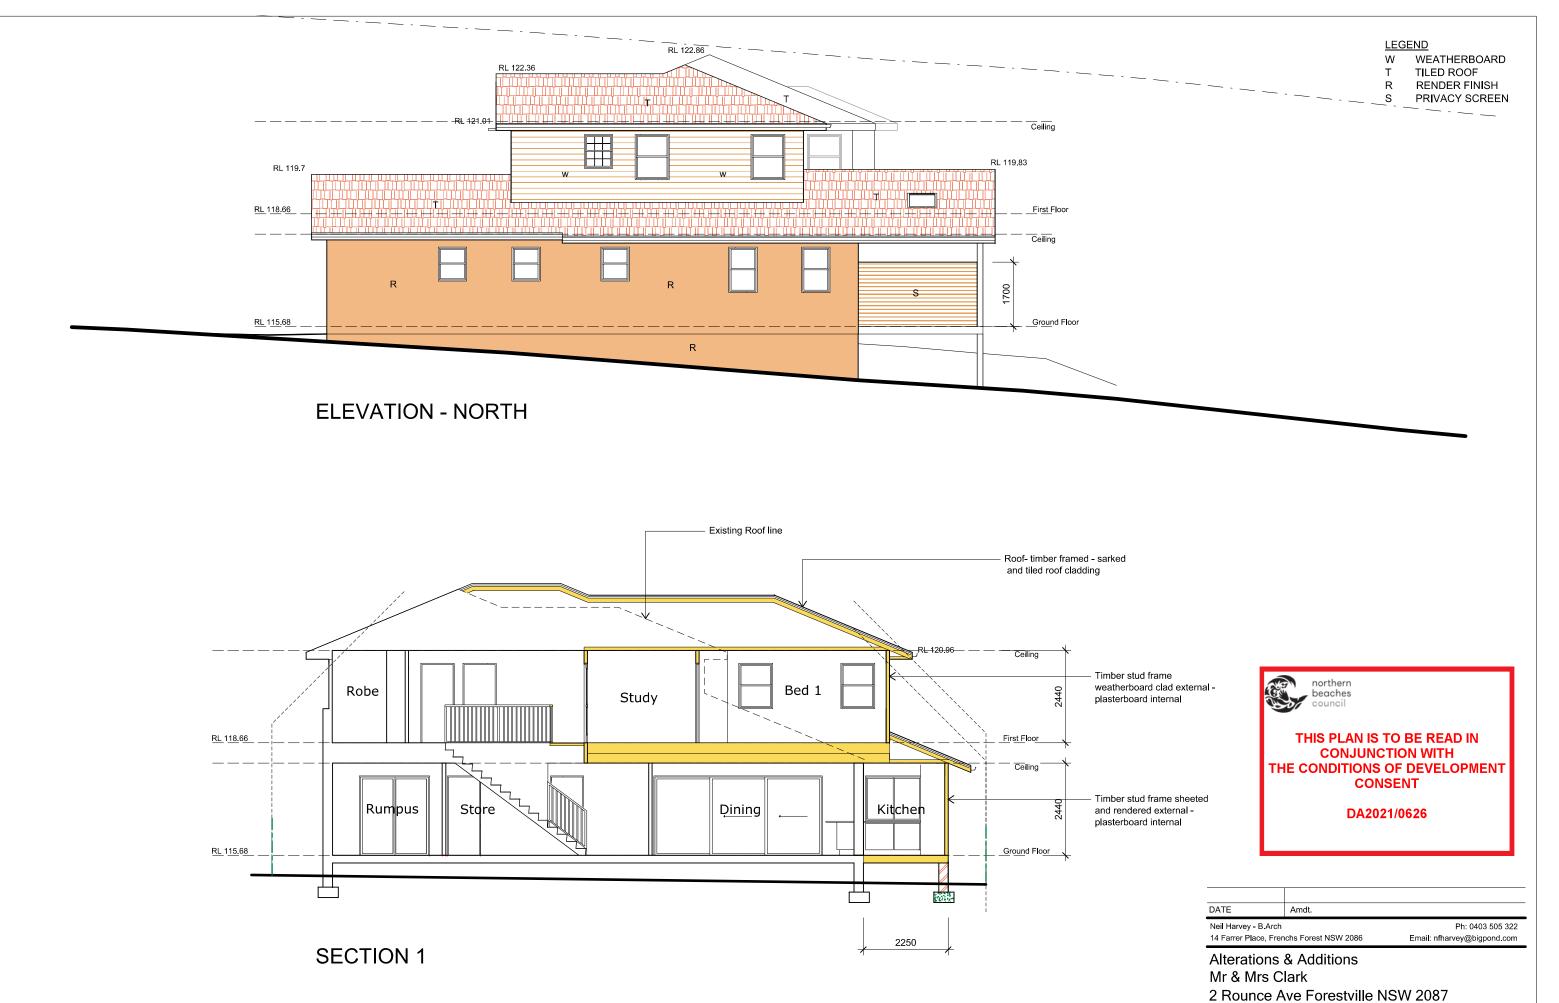

**ELEVATIONS & SECTION** 

SCALE: 1:100

DRAWN: JOB No: 2057

DATE: 28 April 2021 LOT REF: Lot 15 DP 200198

DWG SIZE: A3 SHEET: DA-5

### **COLOUR SCHEME**

Generally colour scheme indication is shown on the proposed rendered view on page 4.

Roof –Tiled Boral "Shingle" - Grey



Walls - Weatherboard & Render painted Dulux "Snowy Mountains White"



Trim - Fascia & Windows painted Dulux "Lexicon Quarter"



Gutters Colorbond - "Night Sky"



