

SITE PLAN 1:200



A.01.1

MD&	В
<b>MILEHAM</b> Design	& Build

www.mileham.com.au REGISTERED ARCHITECT 10030 CONTRACTOR LICENCE 272736C ABN 41 168 183 506 PROJECT ADDRESS

12 HORNING PARADE


MANLY VALE NSW 2093

SCALE

JACKSON DRAWING NAME SITE PLAN DRAWING NUMBER

DATE REVISION

1:200 11/06/2021

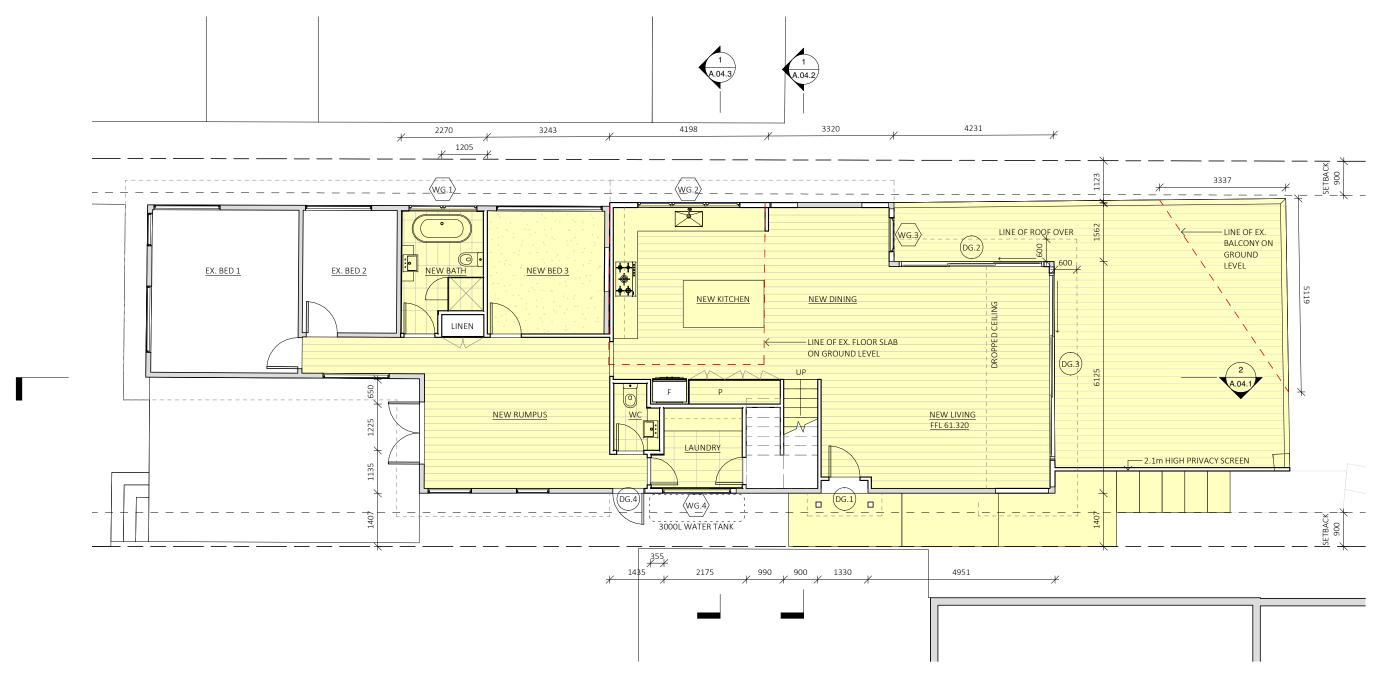


**GROUND LEVEL** 1:100





PROJECT ADDRESS	CLIENT	DRAWING NAME	DRAWING NUMBER
12 HORNING PARADE	JACKSON	GROUND LEVEL	A.02.1
MANLY VALE NSW 2093	SCALE	DATE	REVISION
	1:100	11/06/2021	E

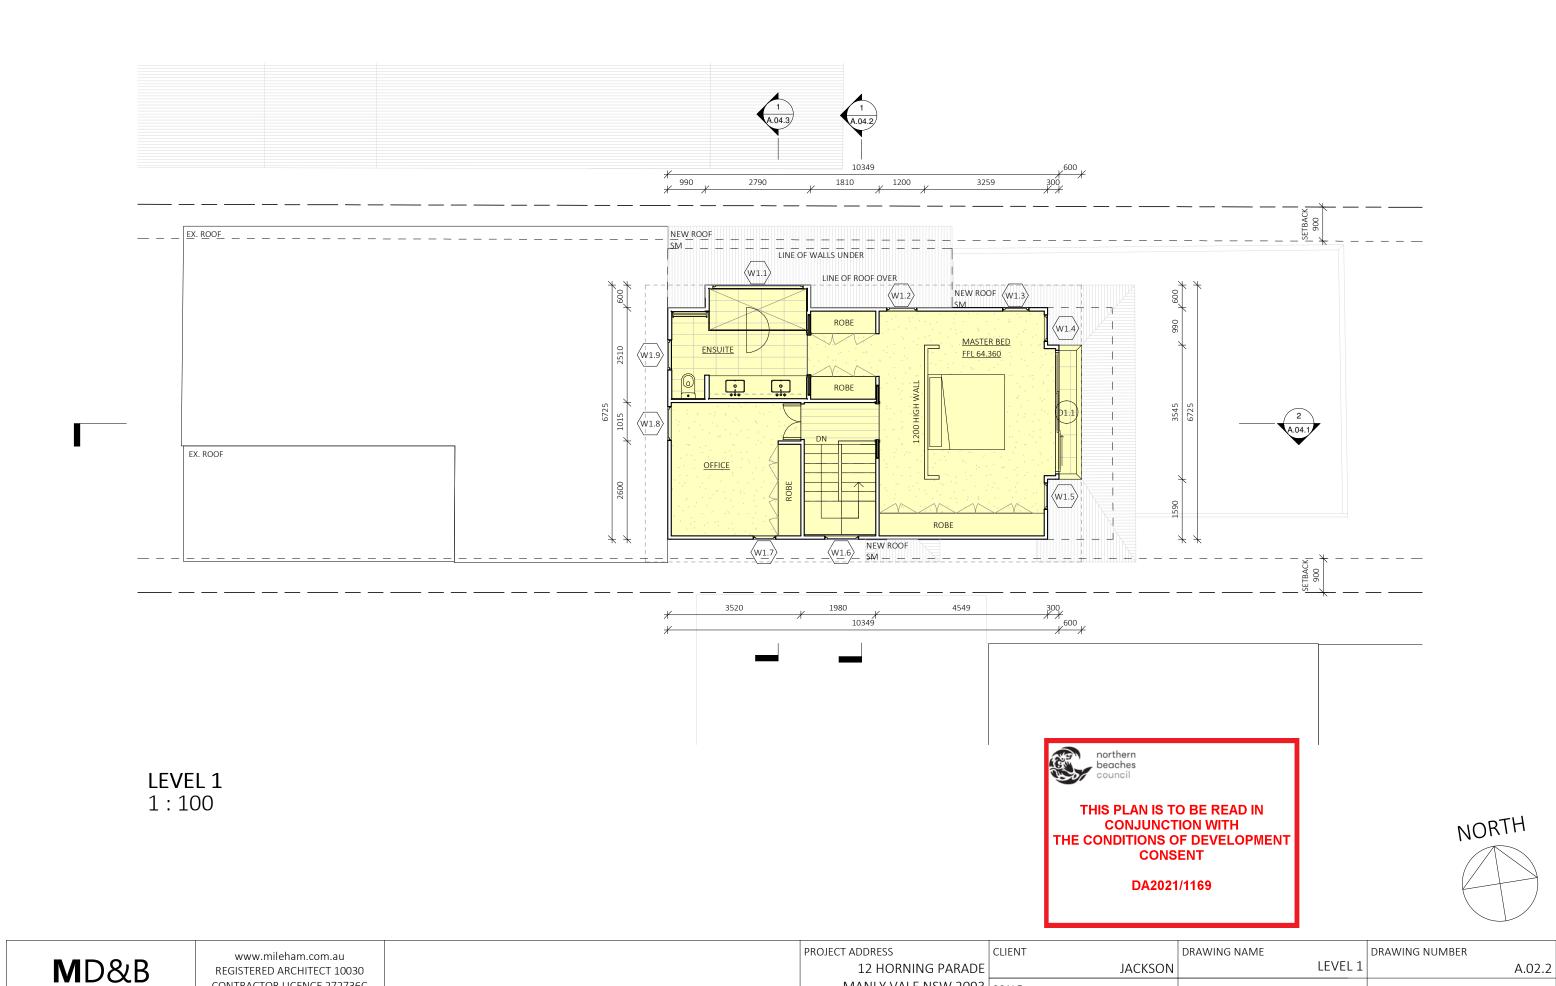

CONTRACTOR LICENCE 272736C

ABN 41 168 183 506


MILEHAM Design & Build

MANLY VALE NSW 2093 SCALE

REVISION

11/06/2021

1:100

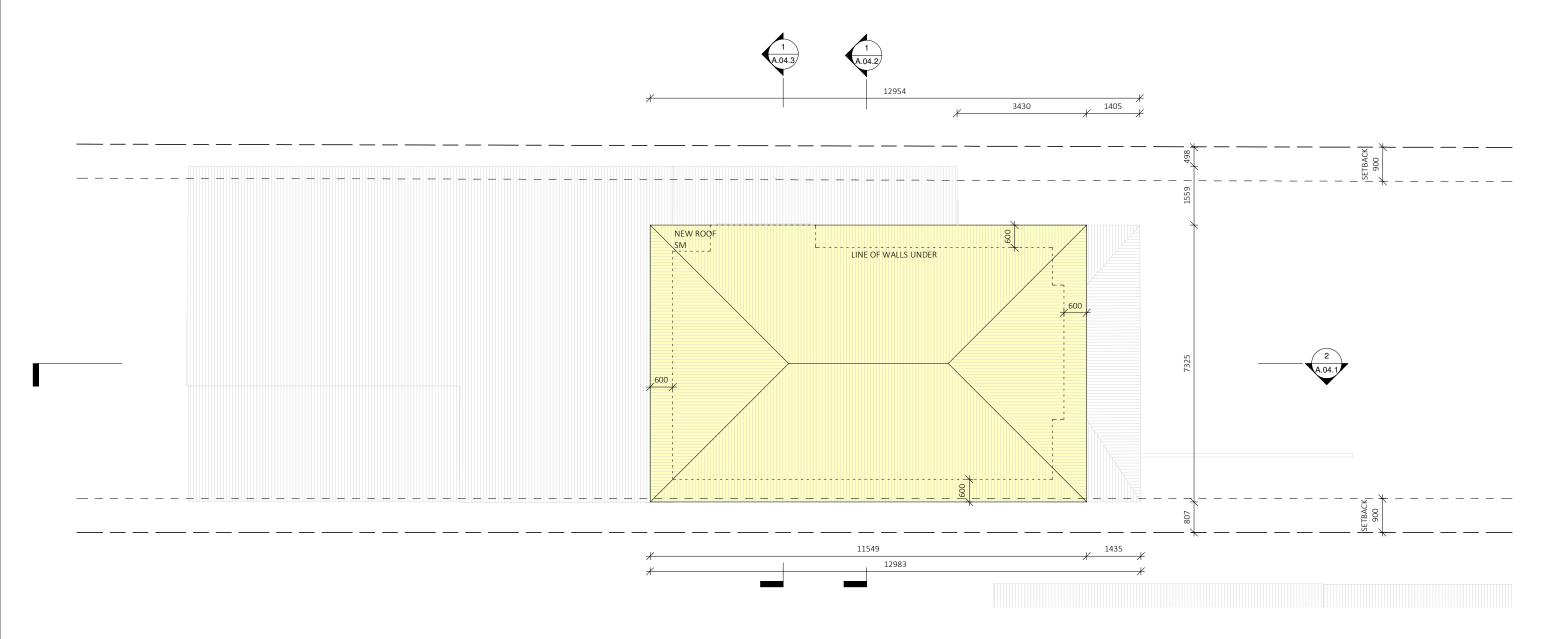





MD	&B
MILEHAM De	esign & Build

www.mileham.com.au REGISTERED ARCHITECT 10030 CONTRACTOR LICENCE 272736C ABN 41 168 183 506 PROJECT ADDRESS

12 HORNING PARADE

MANLY VALE NSW 2093

SCALE

JACKSON DRAWING NAME
ROOF

1:100 DATE


11/06/2021

DRAWING NUMBER


A.02.3

REVISION

F

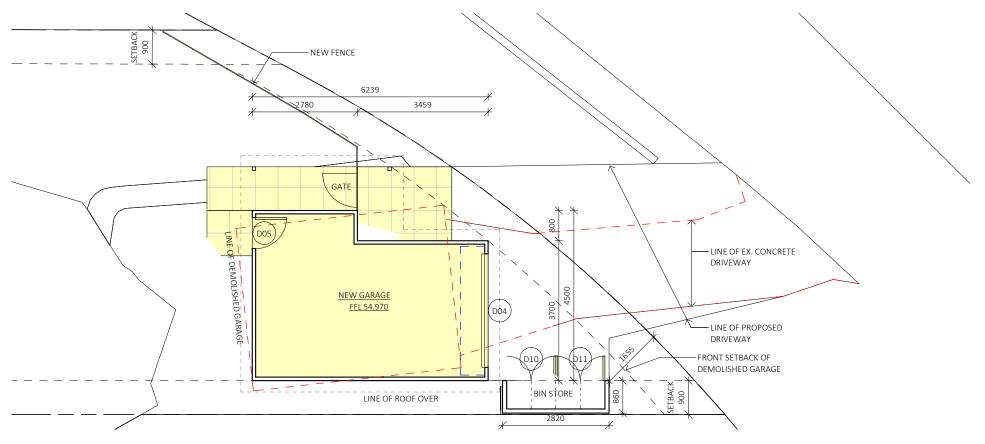

GARAGE - FLOOR PLAN 1:100

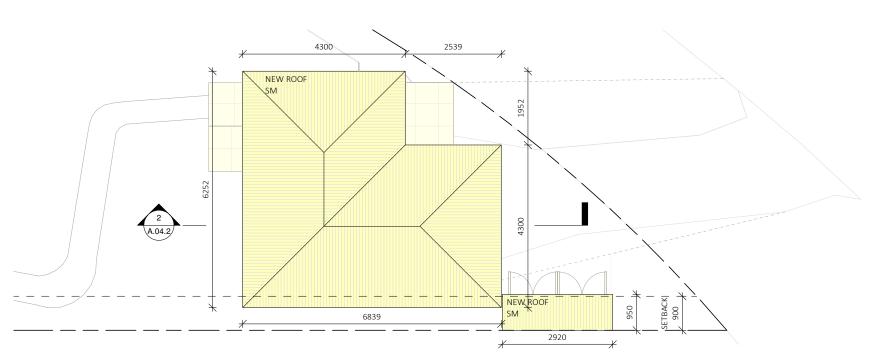

GARAGE - ROOF 1:100



THIS PLAN IS TO BE READ IN CONJUNCTION WITH THE CONDITIONS OF DEVELOPMENT CONSENT

DA2021/1169



MD&B
MILEHAM Design & Build

www.mileham.com.au
REGISTERED ARCHITECT 10030
CONTRACTOR LICENCE 272736C
ABN 41 168 183 506

PROJECT ADDRESS	CLIENT	DRAWING NAME	DRAWING NUMBER
12 HORNING PARADE	JACKSON	GARAGE	A.02.4
MANLY VALE NSW 2093	SCALE	DATE	REVISION
	1:100	11/06/2021	D





**NORTH** 1:100

WB PAINTED WEATHERBOARD SM SHEET METAL ROOFING



ROJECT ADDRESS	CLI
12 HORNING PARADE	
MANLY VALE NSW 2093	SCA

IENT	JACKSON	DRAWING NAME NORTH ELEVATION	DRAWING NUMBER A.03.1
CALE		DATE	REVISION
	1 · 100	11/06/2021	D



**SOUTH** 1:100

WB PAINTED WEATHERBOARD SM SHEET METAL ROOFING






www.mileham.com.au
REGISTERED ARCHITECT 10030
CONTRACTOR LICENCE 272736C
ABN 41 168 183 506

PROJECT ADDRESS	CLIENT		DRAWING NUMBER	
12 HORNING PARADE	JACKSON	SOUTH ELEVATION	A.03.2	
MANLY VALE NSW 2093	SCALE	DATE	REVISION	
	1:100	11/06/2021	D	



THIS PLAN IS TO BE READ IN CONJUNCTION WITH THE CONDITIONS OF DEVELOPMENT CONSENT

DA2021/1169

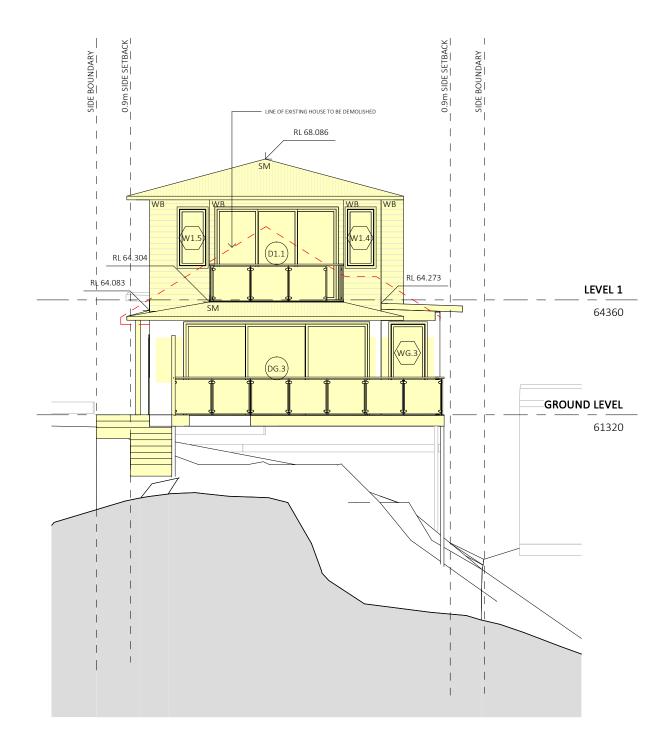

0.9m SIDE SETBACK RL 64.550 RL 64.253 RL 64.083 LEVEL 1 64360 GROUND LEVEL 61320


**EAST** 1: 100

**WEST** 1 : 100


WB PAINTED WEATHERBOARD SM SHEET METAL ROOFING

<b>M</b> D&B
MILEHAM Design & Build

ROJECT ADDRESS  12 HORNING PARADE	CLIENT JACKSON	DRAWING NAME EAST & WEST ELEVATION	DRAWING NUMBER A.03.3	
MANLY VALE NSW 2093	SCALE	DATE	REVISION	
	1:100	11/06/2021	D	

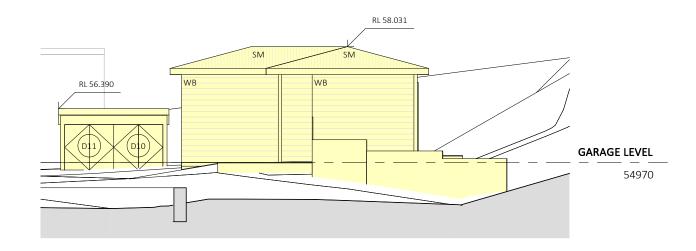


NORTH - GARAGE 1:100

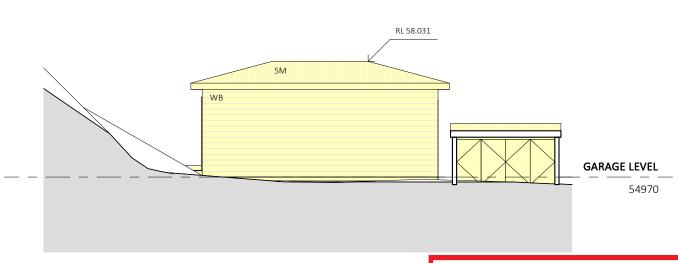


SOUTH - GARAGE 1:100



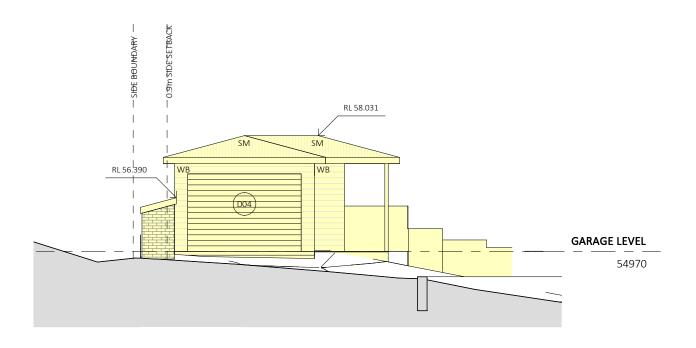

EAST - GARAGE 1:100

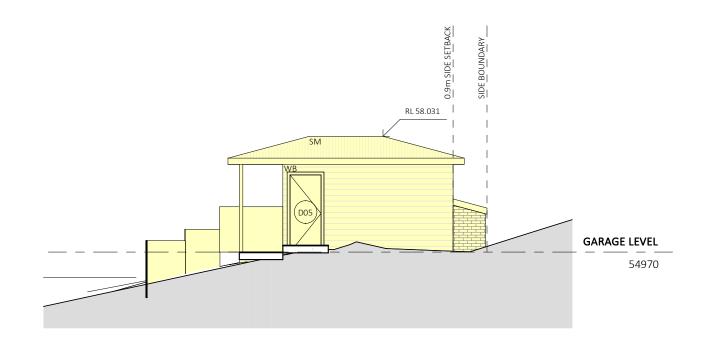


WEST- GARAGE 1: 100

WB PAINTED WEATHERBOARD SM SHEET METAL ROOFING

A.03.4



PROJECT ADDRESS	CLIENT	DRAWING NAME	DRAWING NUMBER
12 HORNING PARADE	JACKSON	ELEVATION - GARAGE	
MANLY VALE NSW 2093	SCALE	DATE	REVISION
	1:100	11/06/2021	

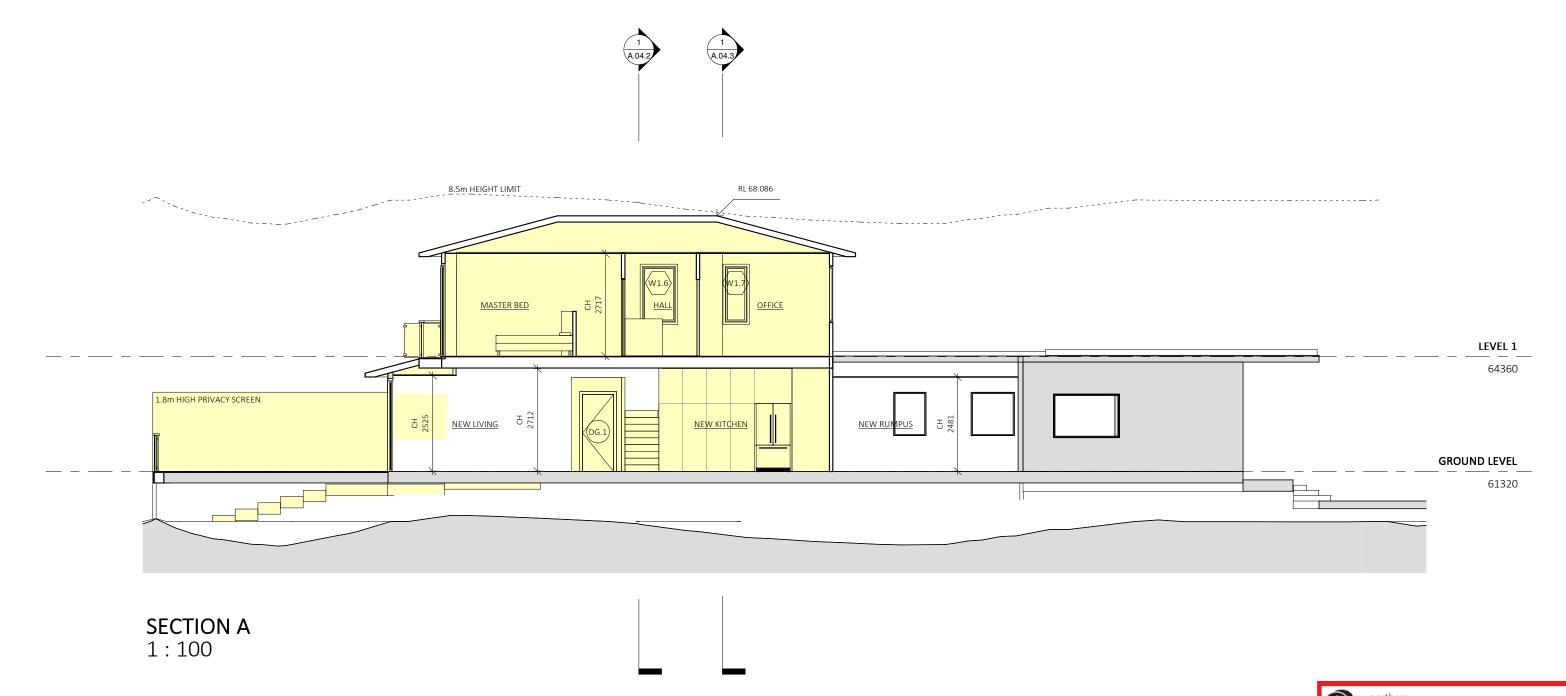







CLIE	PROJECT ADDRESS
	12 HORNING PARADE
SCAL	MANLY VALE NSW 2093

NT	JACKSON	DRAWING NAME	SECTIONS	DRAWING NUMBER	4.04.1
.E	1:100	DATE	11/06/2021	REVISION	D

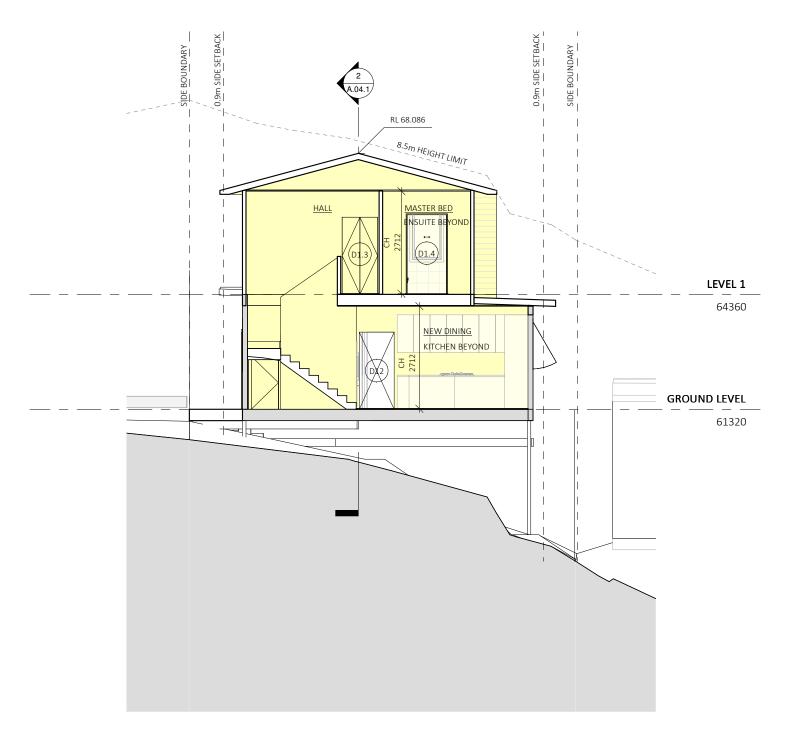


SECTION B 1:100



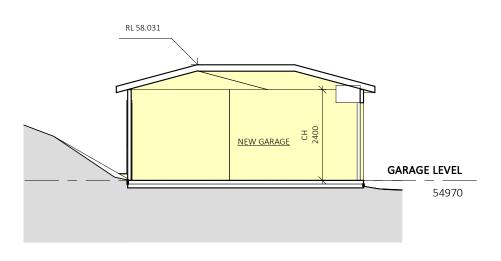

SECTION C 1:100

<b>M</b> D&B	www.mileham.com.au REGISTERED ARCHITECT 10030	PROJECT ADDRESS  12 HORNING PARADE	CLIENT	DRAWING NAME SECTIONS	DRAWING NUMBER A.04.2
MILEHAM Design & Build	CONTRACTOR LICENCE 272736C ABN 41 168 183 506	MANLY VALE NSW 2093	SCALE 1:100	DATE 11/06/2021	REVISION D

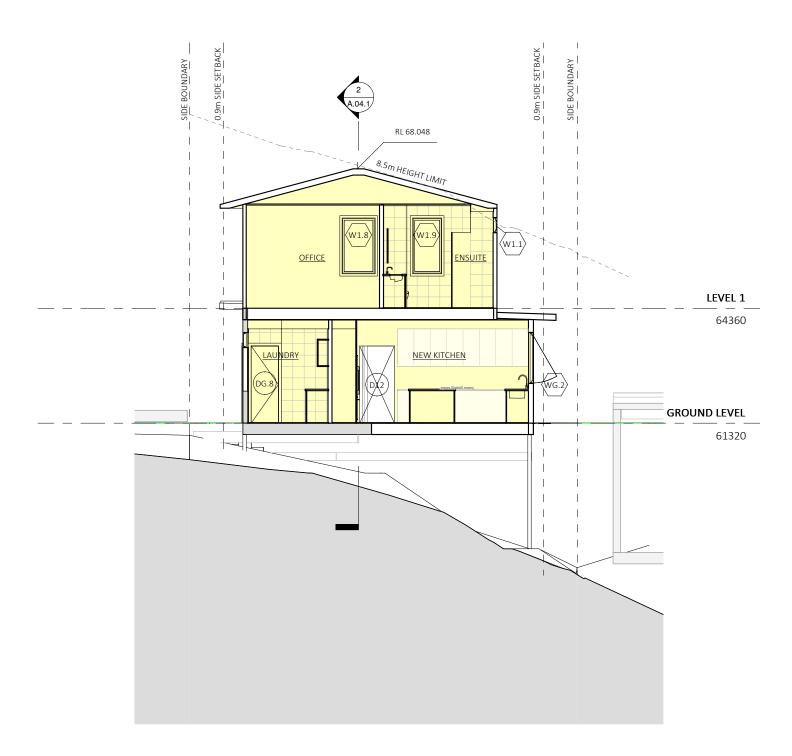



SECTION C - MAX BUILDING HEIGHT 1: 100

<b>M</b> D&B
MILEHAM Design & Build

www.mileham.com.au
REGISTERED ARCHITECT 10030
CONTRACTOR LICENCE 272736C
ABN 41 168 183 506

CLIE	DJECT ADDRESS
	12 HORNING PARADE
SCAL	MANLY VALE NSW 2093

IENT	JACKSON	DRAWING NAME	SECTIONS	DRAWING NUMBER	A.04.3
ALE		DATE	/ /	REVISION	
	1:100		11/06/2021		Αl

Construction			Show on DA Plans	Show on CC/CDC Plans & specs	Certifier Check
nsulation requirements					
	d construction (floor(s), walls, and ceilings/roofs) tion is not required where the area of new constr where insulation already exists.		~	<b>~</b>	~
Construction	Additional insulation required (R-value)	Other specifications			
suspended floor with open subfloor: framed (R0.7).	R0.8 (down) (or R1.50 including construction)				
floor above existing dwelling or building.	nil				
external wall: framed (weatherboard, fibro, metal clad)	R1.30 (or R1.70 including construction)				
flat ceiling, pitched roof	ceiling: R3.00 (up), roof: foil/sarking	medium (solar absorptance 0.475 - 0.70)			

Fixtures and systems	Show on DA Plans	Show on CC/CDC Plans & specs	Certifier Check
Hot water			
The applicant must install the following hot water system in the development: solar (gas-boosted) system that is eligible to create Renewable Energy Certificates under the (Commonwealth) Renewable Energy (Electricity) Regulations 2001 (incorporating Amendment Regulations 2005 (No. 2)).	<b>V</b>	<b>~</b>	~
Lighting			
The applicant must ensure a minimum of 40% of new or altered light fixtures are fitted with fluorescent, compact fluorescent, or light-emitting-diode (LED) lamps.		<b>~</b>	<b>V</b>
Fixtures			
The applicant must ensure new or altered showerheads have a flow rate no greater than 9 litres per minute or a 3 star water rating.		~	~
The applicant must ensure new or altered toilets have a flow rate no greater than 4 litres per average flush or a minimum 3 star water rating.		~	~
The applicant must ensure new or altered taps have a flow rate no greater than 9 litres per minute or minimum 3 star water rating.		~	

Glazing red	quirements						Show on DA Plans	Show on CC/CDC Plans & specs	Certifier Check
Window / do	or Orientation	Area of	Oversha	adowing	Shading device	Frame and glass type			
no.		glass inc. frame (m2)	Height (m)	Distance (m)					
					>=750 mm	U-value: 7.63, SHGC: 0.75)	7		
W1.2	N	1.2	0	0	eave/verandah/pergola/balcony >=750 mm	standard aluminium, single clear, (or U-value: 7.63, SHGC: 0.75)			
W1.3	N	1.1	0	0	eave/verandah/pergola/balcony >=750 mm	standard aluminium, single clear, (or U-value: 7.63, SHGC: 0.75)			
W1.4	E	1.1	0	0	eave/verandah/pergola/balcony >=750 mm	standard aluminium, single toned, (or U-value: 7.57, SHGC: 0.57)			
W1.5	E	1.1	0	0	eave/verandah/pergola/balcony >=750 mm	standard aluminium, single toned, (or U-value: 7.57, SHGC: 0.57)	1		
W1.6	S	1.4	0	0	eave/verandah/pergola/balcony >=750 mm	standard aluminium, single clear, (or U-value: 7.63, SHGC: 0.75)			
W1.7	S	0.9	0	0	eave/verandah/pergola/balcony >=750 mm	standard aluminium, single clear, (or U-value: 7.63, SHGC: 0.75)			
W1.8	W	1.4	0	0	eave/verandah/pergola/balcony >=750 mm	standard aluminium, single clear, (or U-value: 7.63, SHGC: 0.75)			
DG.1	N	8.9	0	0	eave/verandah/pergola/balcony >=750 mm	standard aluminium, single toned, (or U-value: 7.57, SHGC: 0.57)	1		
DG.2	E	11.5	0	0	eave/verandah/pergola/balcony >=750 mm	standard aluminium, single toned, (or U-value: 7.57, SHGC: 0.57)			
D1.1	E	7.6	0	0	eave/verandah/pergola/balcony >=750 mm	standard aluminium, single toned, (or U-value: 7.57, SHGC: 0.57)			
W1.9	W	1.2	0	0	eave/verandah/pergola/balcony >=750 mm	standard aluminium, single clear, (or U-value: 7.63, SHGC: 0.75)			

	equirements						Show on DA Plans	Show on CC/CDC Plans & specs	Certifier Check
Vindows	and glazed	doors							
					hading devices, in accordance with t r each window and glazed door.	the specifications listed in the table below.	~	~	1
The following	ng requirement	ts must also	be satisf	ied in relation	n to each window and glazed door:			~	V
have a U-va	alue and a Sol	ar Heat Gair	n Coefficie	ent (SHGC) r		d glass may either match the description, or, e below. Total system U-values and SHGCs		~	~
					f each eave, pergola, verandah, bald than 2400 mm above the sill.	cony or awning must be no more than 500 mm	~	~	~
Pergolas w	ith polycarbona	ate roof or s	imilar trar	slucent mate	erial must have a shading coefficient	t of less than 0.35.		~	~
									- 6-2
External lo	uvres and blind	ds must fully	shade th	e window or	glazed door beside which they are s	situated when fully drawn or closed.		~	V
Pergolas w	ith fixed batten	ns must have	e battens	parallel to the		situated when fully drawn or closed.		~	1
Pergolas w shades a p <b>Windows</b>	rith fixed batten erpendicular w	ns must have vindow. The	battens spacing b	parallel to the etween batte equireme	e window or glazed door above whic ens must not be more than 50 mm. nts	ch they are situated, unless the pergola also		<b>*</b>	<b>~</b>
Pergolas w shades a p <b>Windows</b> Window / c	ith fixed batten erpendicular w	ns must have vindow. The d doors g	e battens spacing b lazing r Oversha	parallel to the etween batte equirement adowing	e window or glazed door above whice ens must not be more than 50 mm.			<b>*</b>	<b>✓</b>
Pergolas w shades a p <b>Windows</b>	rith fixed batten erpendicular w	ns must have vindow. The	battens spacing b	parallel to the etween batte equireme	e window or glazed door above whic ens must not be more than 50 mm. nts	ch they are situated, unless the pergola also		<b>*</b>	<b>*</b>
Pergolas w shades a p Windows Window / c no.	rith fixed batten erpendicular w	ns must have vindow. The d doors g on Area of glass inc. frame	battens spacing b lazing r Oversha	parallel to the petween batter equirement adowing  Distance	e window or glazed door above whic ens must not be more than 50 mm. nts	ch they are situated, unless the pergola also		<b>*</b>	✓ ✓
Pergolas w shades a p Window s Window / c no.	ith fixed batten erpendicular w s and glazed door Orientatio	ns must have vindow. The d doors g on Area of glass inc. frame (m2)	e battens spacing b lazing r Oversha Height (m)	parallel to the between batte equirement adowing Distance (m)	e window or glazed door above whice the smust not be more than 50 mm.  Shading device  eave/verandah/pergola/balcony	Frame and glass type  standard aluminium, single clear, (or		<b>*</b>	<b>√</b> ✓
Pergolas w shades a p Windows Window / c no. WG.1	ith fixed batten erpendicular w s and glazed door Orientation	ns must have rindow. The  d doors g on Area of glass inc. frame (m2) 2.4	e battens spacing b lazing r Oversha Height (m)	parallel to the petween batte equirement adowing Distance (m)	eave/verandah/pergola/balcony eave/verandah/pergola/balcony eave/verandah/pergola/balcony	Frame and glass type  standard aluminium, single clear, (or U-value: 7.63, SHGC: 0.75) standard aluminium, single clear, (or		<b>*</b>	<b>√</b> ✓
Pergolas w shades a p <b>Windows</b> Window / c	ith fixed batten erpendicular w s and glazed door Orientatio	ns must have rindow. The  d doors g on glass inc. frame (m2) 2.4 3.6	e battens spacing b lazing r Oversha Height (m)	parallel to the tween batter equirement adowing Distance (m)	eave/verandah/pergola/balcony >=750 mm	Frame and glass type  standard aluminium, single clear, (or U-value: 7.63, SHGC: 0.75)  standard aluminium, single clear, (or U-value: 7.63, SHGC: 0.75)  standard aluminium, single clear, (or U-value: 7.63, SHGC: 0.75)		*	<b>*</b>

In these commitments, "applicant" means the person carrying out the development.

Commitments identified with a "
in the "Show on DA plans" column must be shown on the plans accompanying the development application for the proposed development (if a development application is to be lodged for the proposed development).

Commitments identified with a "\sqrt{"}" in the "Show on CC/CDC plans & specs" column must be shown in the plans and specifications accompanying the application for a construction certificate / complying development certificate for the proposed development.

Commitments identified with a "
" in the "Certifier check" column must be certified by a certifying authority as having been fulfilled, before a final occupation certificate for the development may be issued.




THIS PLAN IS TO BE READ IN **CONJUNCTION WITH** THE CONDITIONS OF DEVELOPMENT CONSENT

DA2021/1169

M	D&	В
MILEHAM	Design	& Build

www.mileham.com.au
REGISTERED ARCHITECT 10030
CONTRACTOR LICENCE 272736C
ABN 41 168 183 506


ROJECT ADDRESS	CLIENT	DRAWING NAME	DRAWING NUMBER
12 HORNING PARADE	JACKSON	BASIX	A.06.1
MANLY VALE NSW 2093	SCALE	DATE	REVISION
		11/06/2021	Α

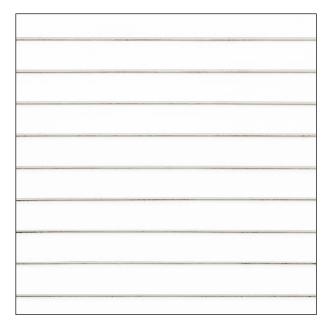

EXTERNAL WALLS
WHITE WEATHERBOARD IN HORIZONTAL PROFILE



ROOFING COLOURBOND SHEETING COLOUR LIGHT-MID GREY OR SIMILAR

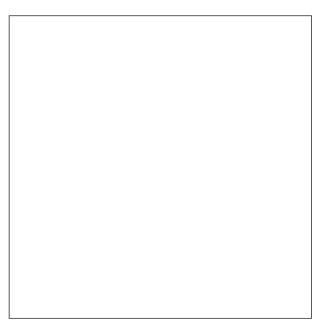

EXTERNAL WINDOWS AND DOOR FINISHES ALUMINIUM FRAME WHITE TRIM



THIS PLAN IS TO BE READ IN CONJUNCTION WITH THE CONDITIONS OF DEVELOPMENT CONSENT


DA2021/1169

A.06.2



PROJECT ADDRESS	CLIENT
12 HORNING PARADE	
MANLY VALE NSW 2093	SCALE

T JACKSON	EVEEDNIAL FINISHES	DRAWING NUMBER
	DATE 11/06/2021	REVISION

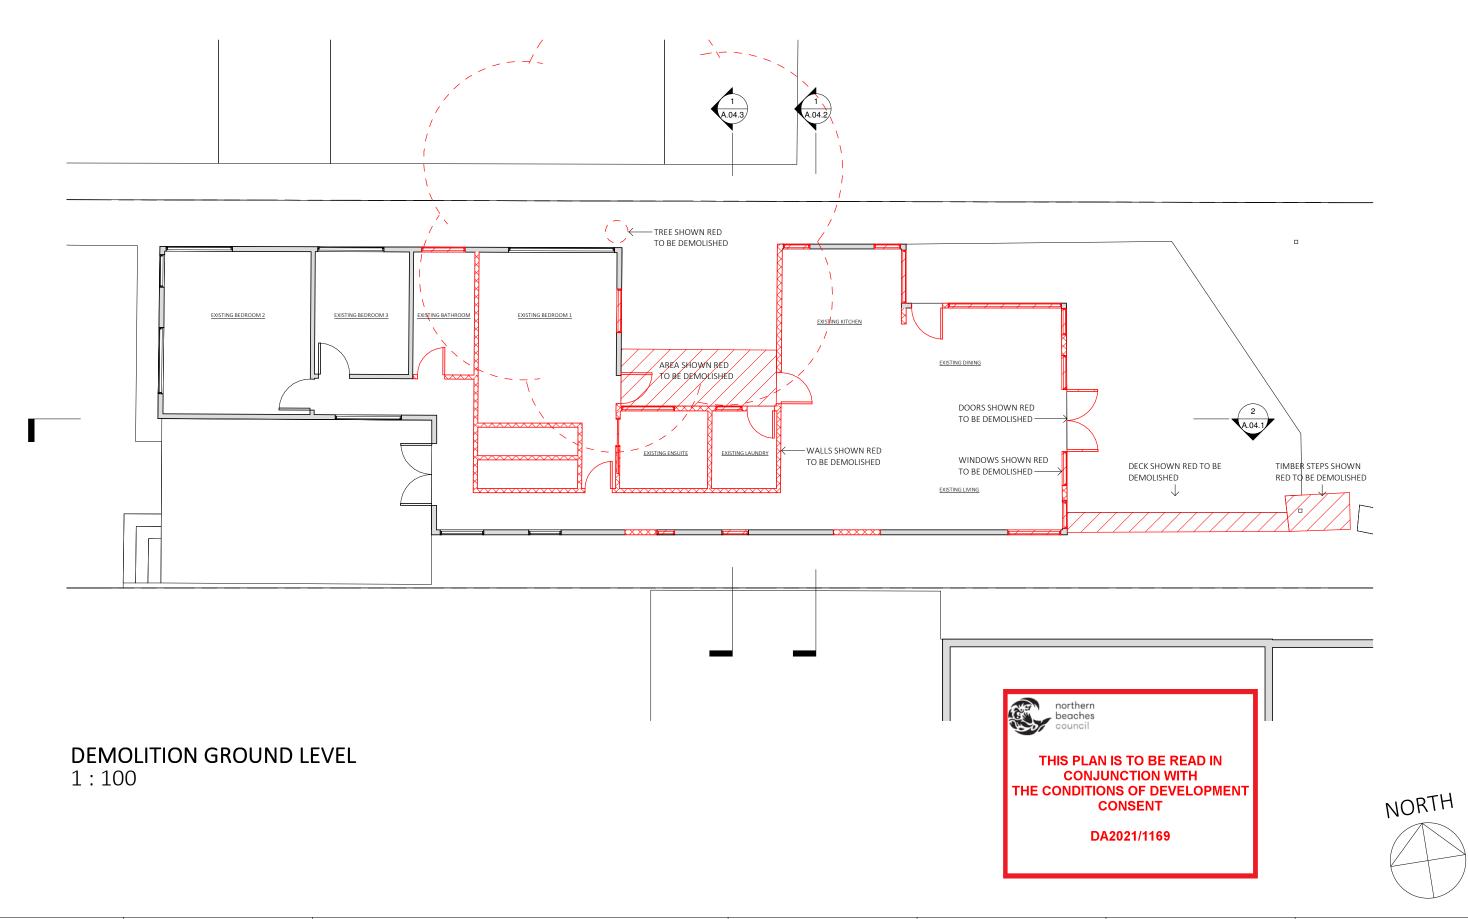



www.mileham.com.au REGISTERED ARCHITECT 10030 CONTRACTOR LICENCE 272736C ABN 41 168 183 506 PROJECT ADDRESS

12 HORNING PARADE

MANLY VALE NSW 2093


SCALE

DRAWING NAME DEMO GROUND LEVEL DATE

1:100

VEL DRAWING NUMBER
D.02.1
REVISION

11/06/2021

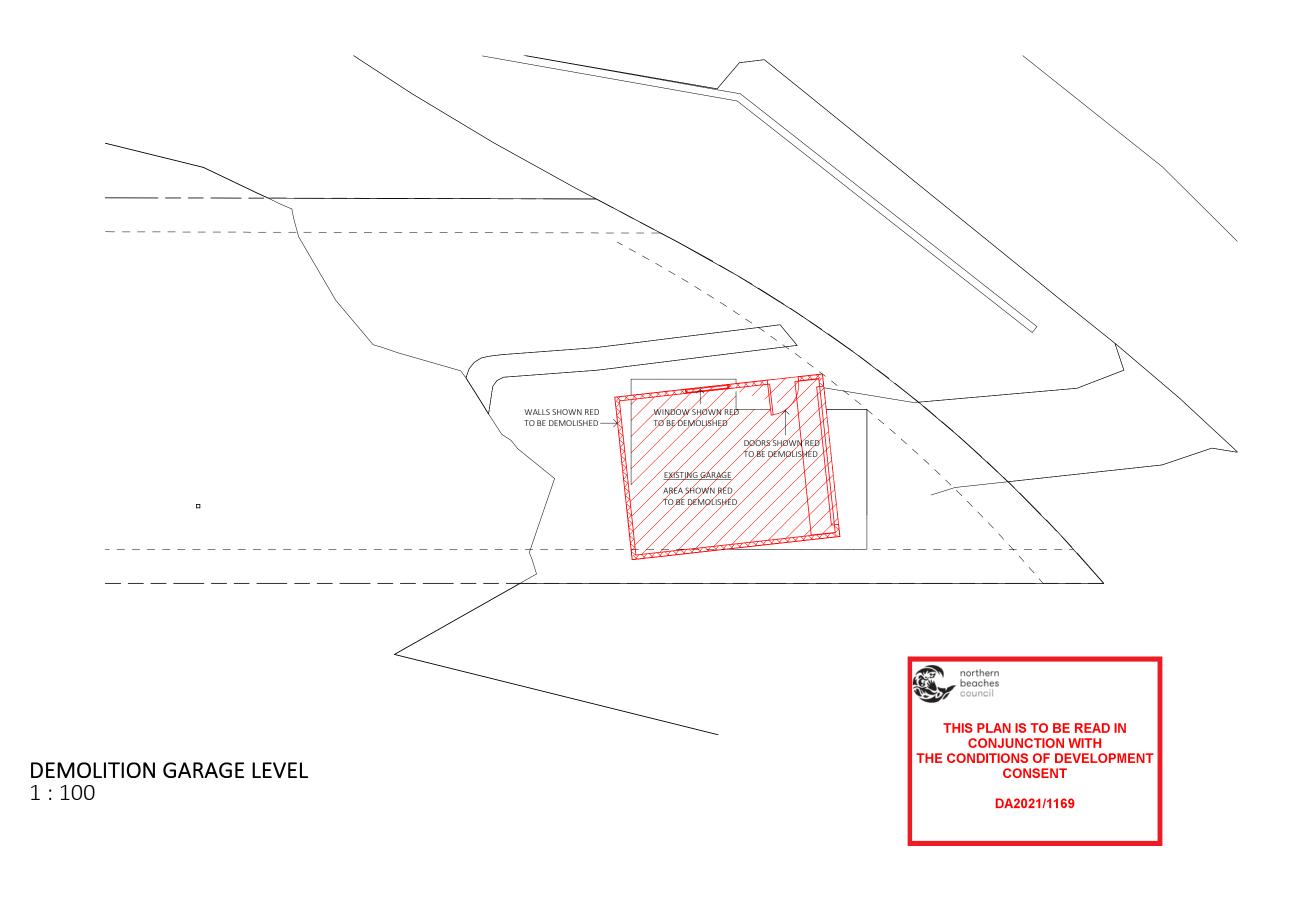




D.02.4


MD&B MILEHAM Design & Build

PROJECT ADDRESS	CLIENT
12 HORNING PARADE	
MANLY VALE NSW 2093	SCALE

JACKSON	DRAWING NAME DEMO GARAGE LEVEL	DRAWING NUMBER
1:100	DATE 11/06/2021	REVISION

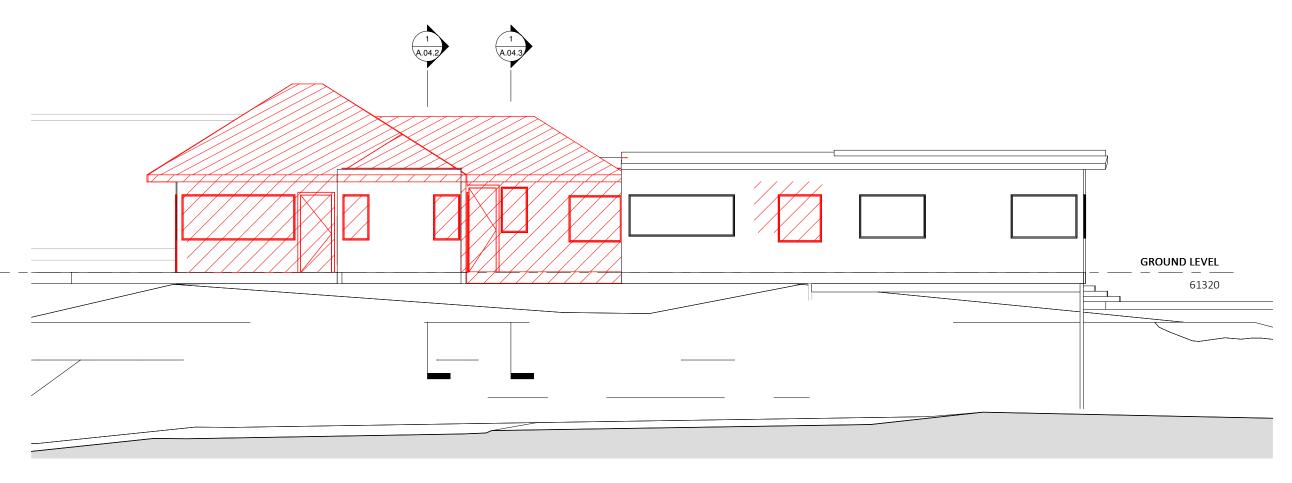

**DEMOLITION ELEVATION NORTH** 1:100

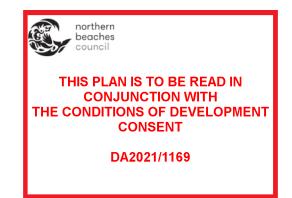




www.mileham.com.au
REGISTERED ARCHITECT 10030
ONTRACTOR LICENCE 272736C
ABN 41 168 183 506

	CLIENT
12 HORNING PARADE	
MANLY VALE NSW 2093	SCALE

nt J <i>A</i>	ACKSON	DRAWING NAME DEMO ELEVATION NORTH	DRAWING NUMBER D.03.1	L
.E		DATE	REVISION	
	1 · 100	11/06/2021		١l

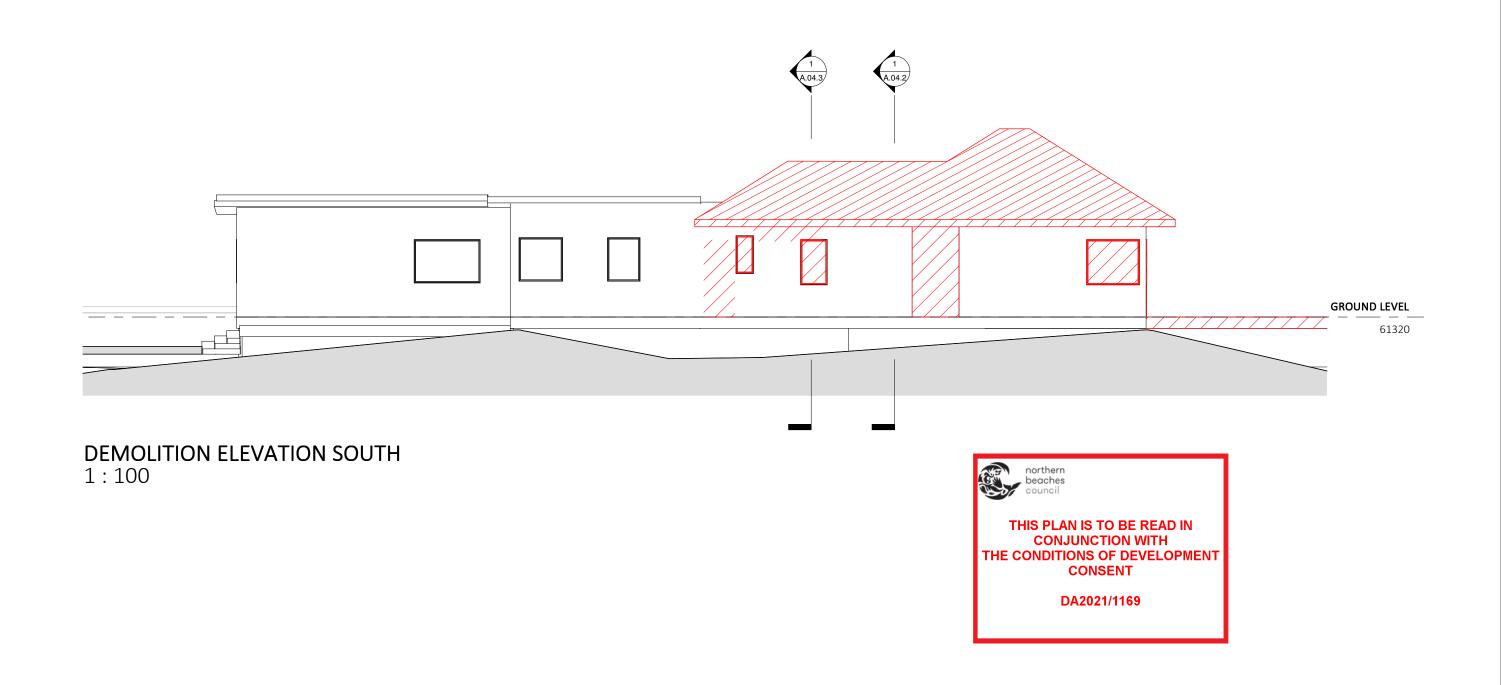





PROJECT ADDRESS CLIENT DRAWING NAME DRAWING NUMBER www.mileham.com.au DEMO ELEVATION SOUTH 12 HORNING PARADE JACKSON REGISTERED ARCHITECT 10030 MANLY VALE NSW 2093 SCALE CONTRACTOR LICENCE 272736C DATE REVISION ABN 41 168 183 506 11/06/2021 1:100

D.03.2

Approver



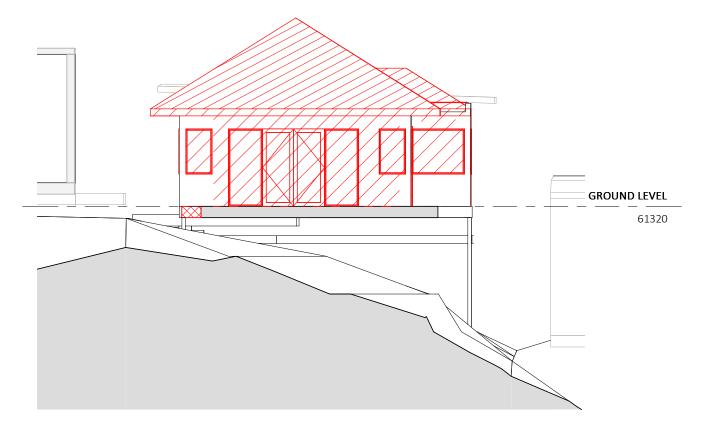

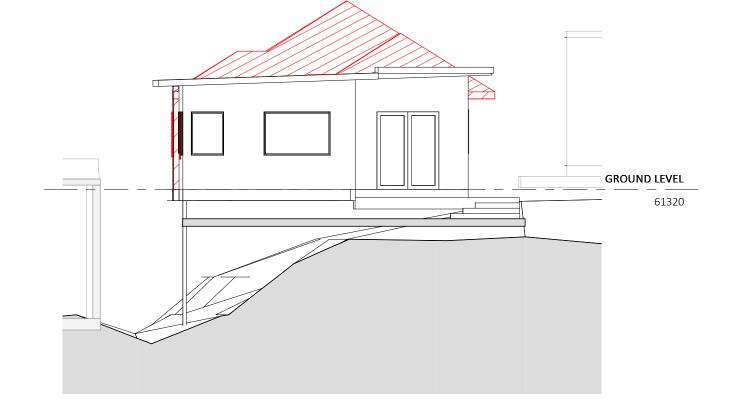


**DEMOLITION ELEVATION EAST** 1: 100

**DEMOLITION ELEVATION WEST** 1:100



PROJECT ADDRESS CLIENT DRAWING NAME DRAWING NUMBER www.mileham.com.au DEMO ELEVATIONS E & W 12 HORNING PARADE JACKSON D.03.3 REGISTERED ARCHITECT 10030 MANLY VALE NSW 2093 SCALE CONTRACTOR LICENCE 272736C DATE REVISION ABN 41 168 183 506 11/06/2021 1:100

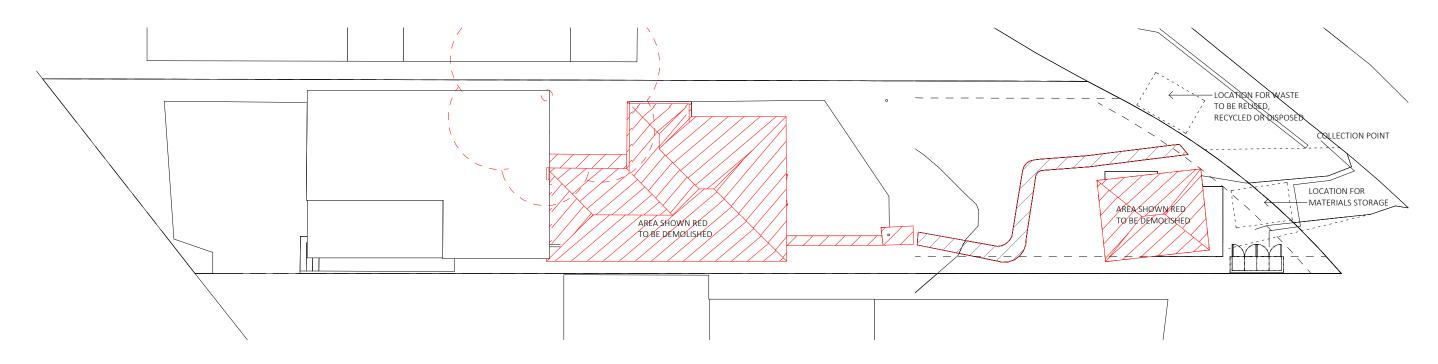

## WASTE MANAGEMENT SITE PLAN 1:200





www.mileham.com.au	PROJECT ADDRESS	CLIENT	DRAWING NAME	DRAWING NUMBER	
REGISTERED ARCHITECT 10030	12 HORNING PARADE		JACKSON	WM SITE PLAN	W.01.1
CONTRACTOR LICENCE 272736C	MANLY VALE NSW 2093	SCALE	DATE	REVISION	
ABN 41 168 183 506			1:200	11/06/2021	Approver