DEVELOPMENT APPLICATION DRAWING LIST

SHEET NUMBER	SHEET NAME	
DA 000	COVER PAGE & DRAWING REGISTER	
DA 001	EXISTING SITE PLAN & SITE ANALYSIS PLAN	
DA 002	PROPOSED SITE PLAN	
DA 003	PROPOSED GARAGE FLOOR PLAN	
DA 004	PROPOSED GROUND FLOOR PLAN	
DA 005	PROPOSED FIRST FLOOR PLAN	سنبند الم
DA 006	PROPOSED ROOF PLAN	X
DA 007	ELEVATION - NORTH-WEST	
DA 008	ELEVATION - NORTH-EAST	X
DA 009	ELEVATION - SOUTH-EAST	\sim $\langle \cdot \rangle$
DA 010	ELEVATION - SOUTH-WEST	
DA 011	SECTION A - MAIN HOUSE	
DA 012	SECTION B - POOL, HOME OFFICE & GARAGE	. *
DA 013	SECTION C - GARAGE AND LIVING	
DA 014	SHADOW DIAGRAMS - 9AM WINTER	
DA 015	SHADOW DIAGRAMS - 12PM WINTER	×.
DA 016	SHADOW DIAGRAMS - 3PM WINTER	
DA 017	NO.9 ELEVATIONAL SHADOW DIAGRAMS	
DA 018	EROSION CONTROL & WASTE MANAGEMENT	· · · · · · · · · · · · · · · · · · ·
DA 019	EXCAVATION AND FILL PLAN	
DA 020	EXTERNAL FINISHES & MATERIALS	
DA 021	LEP MAX 8.5M HEIGHT DIAGRAM	
DA 022	VIEW FROM NO.5 FRONT TERRACE & BALCONY	
DA 023	VIEW FROM NO.9 FRONT ROOM & BALCONY	

THIS PLAN IS TO BE READ IN CONJUNCTION WITH THE CONDITIONS OF DEVELOPMENT CONSENT

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PROJECT 19-030 SPANGL MUNDSPERGER RESIDENCE

PROJECT ADDRESS 7 BOWER STREET MANLY, 2095

CLIENT

SYDNEY HARBOUR NATIONAL PARK

LOCATION PLAN

VIEW FROM BOWER STREET

1:1000

0

JURGEN SPANGL & KARIN MUNDSPERGER

PROJECT CONTACT

RYAN NG (PROJECT ARCHITECT) E: ryan@cplusc.com.au P: +61 2 9690 2211

DOCUMENTS BY OTHER CONSULTANTS

SURVEY PLAN BY C.M.S. SURVEYORS BASIX CERTIFICATE BY CERTIFIED ENERGY STATEMENT OF ENVIRONMENTAL EFFECTS BY WILLANA URBAN LANDSCAPE PLAN BY DUNCAN GIBBS STORMWATER MANAGEMENT PLANS BY STELLEN CONSULTING GEOTECHNICAL REPORT BY WITT CONSULTING BUSHFIRE REPORT BY BUSHFIRE PLANNING SERVICES ECOLOGICAL IMPACT STATEMENT BY ACS ENVIRONMENTAL

FOR DEVELOPMENT APPLICATION

DRAWING TITLE


COVER PAGE & DRAWING REGISTER


REVISION DATE

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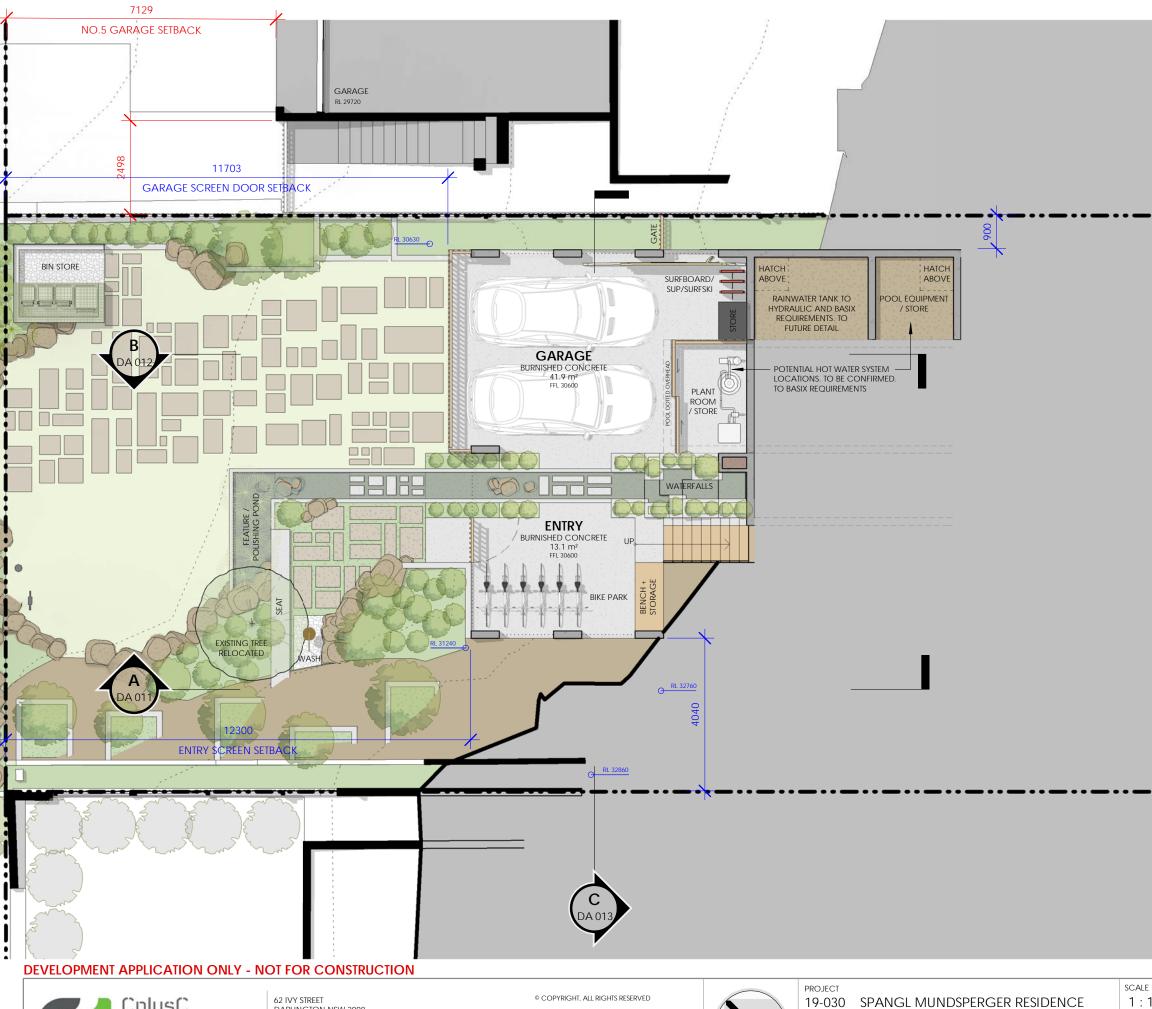
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project adi 7 BOWER MANLY, 2	STREET	^{CLIENT} JURGEN SPANGL & KARIN MUNDSPERGER

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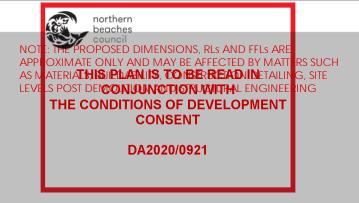
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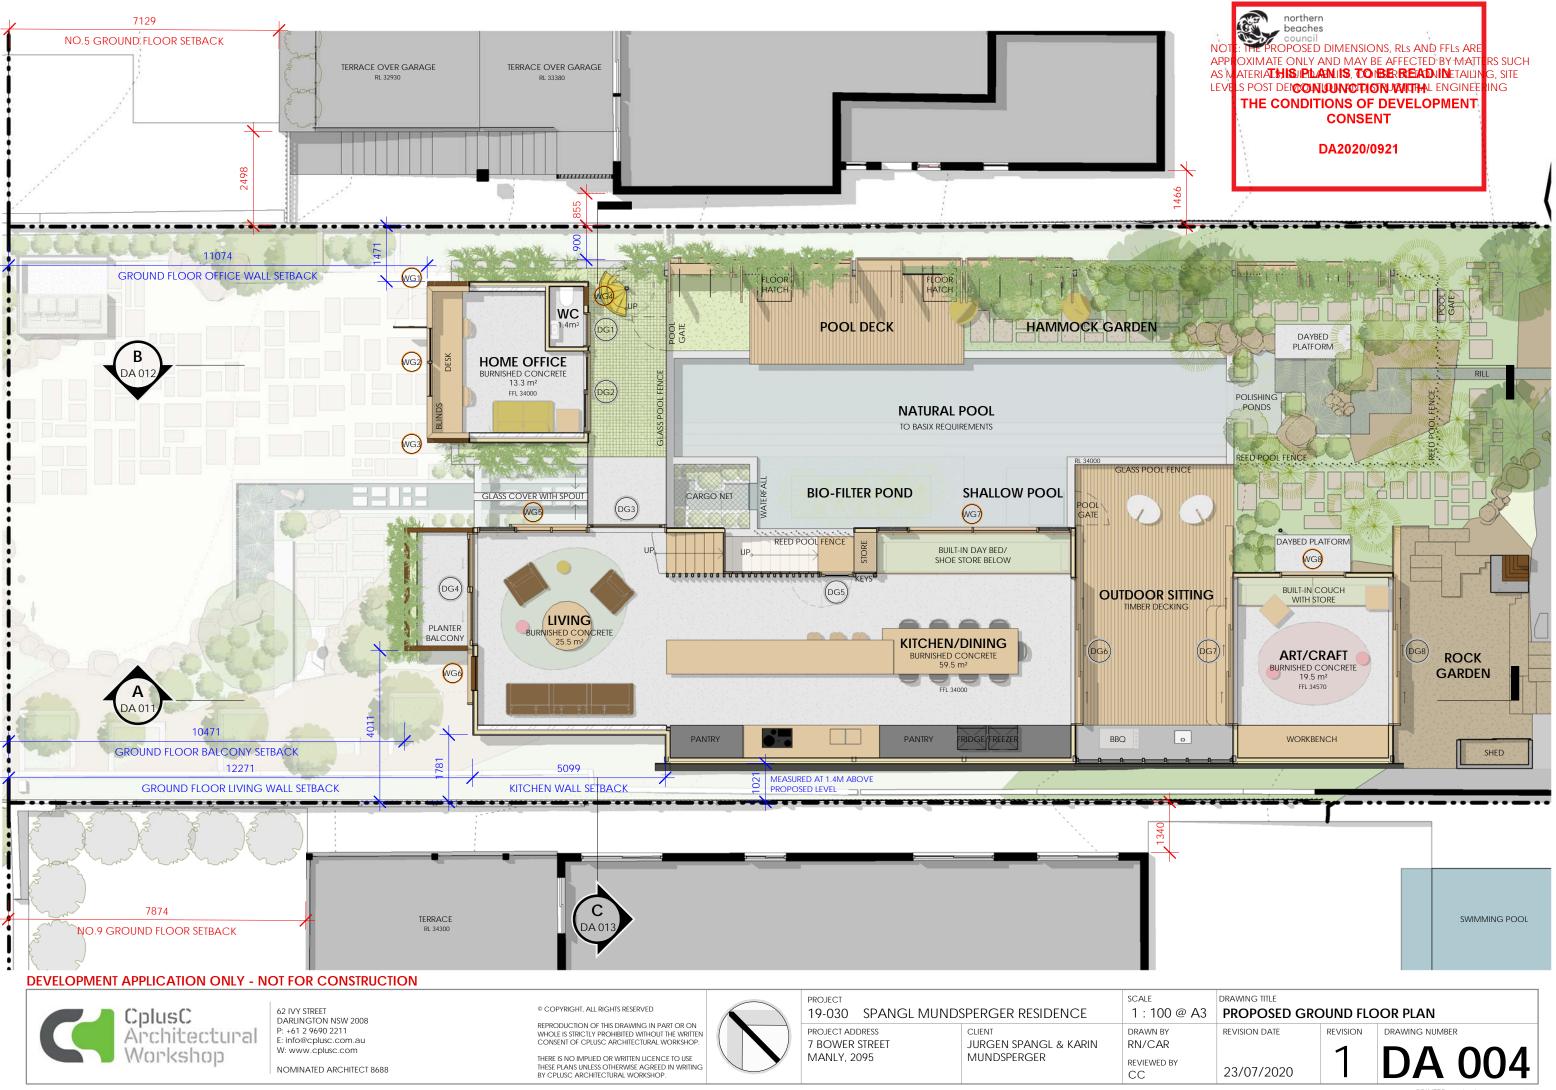
PROJECT ADDRESS **7 BOWER STREET** MANLY, 2095


CLIENT JURGEN SPANGL & KARIN MUNDSPERGER

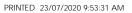1 : 100 @ DRAWN BY RN/CAR REVIEWED BY СС

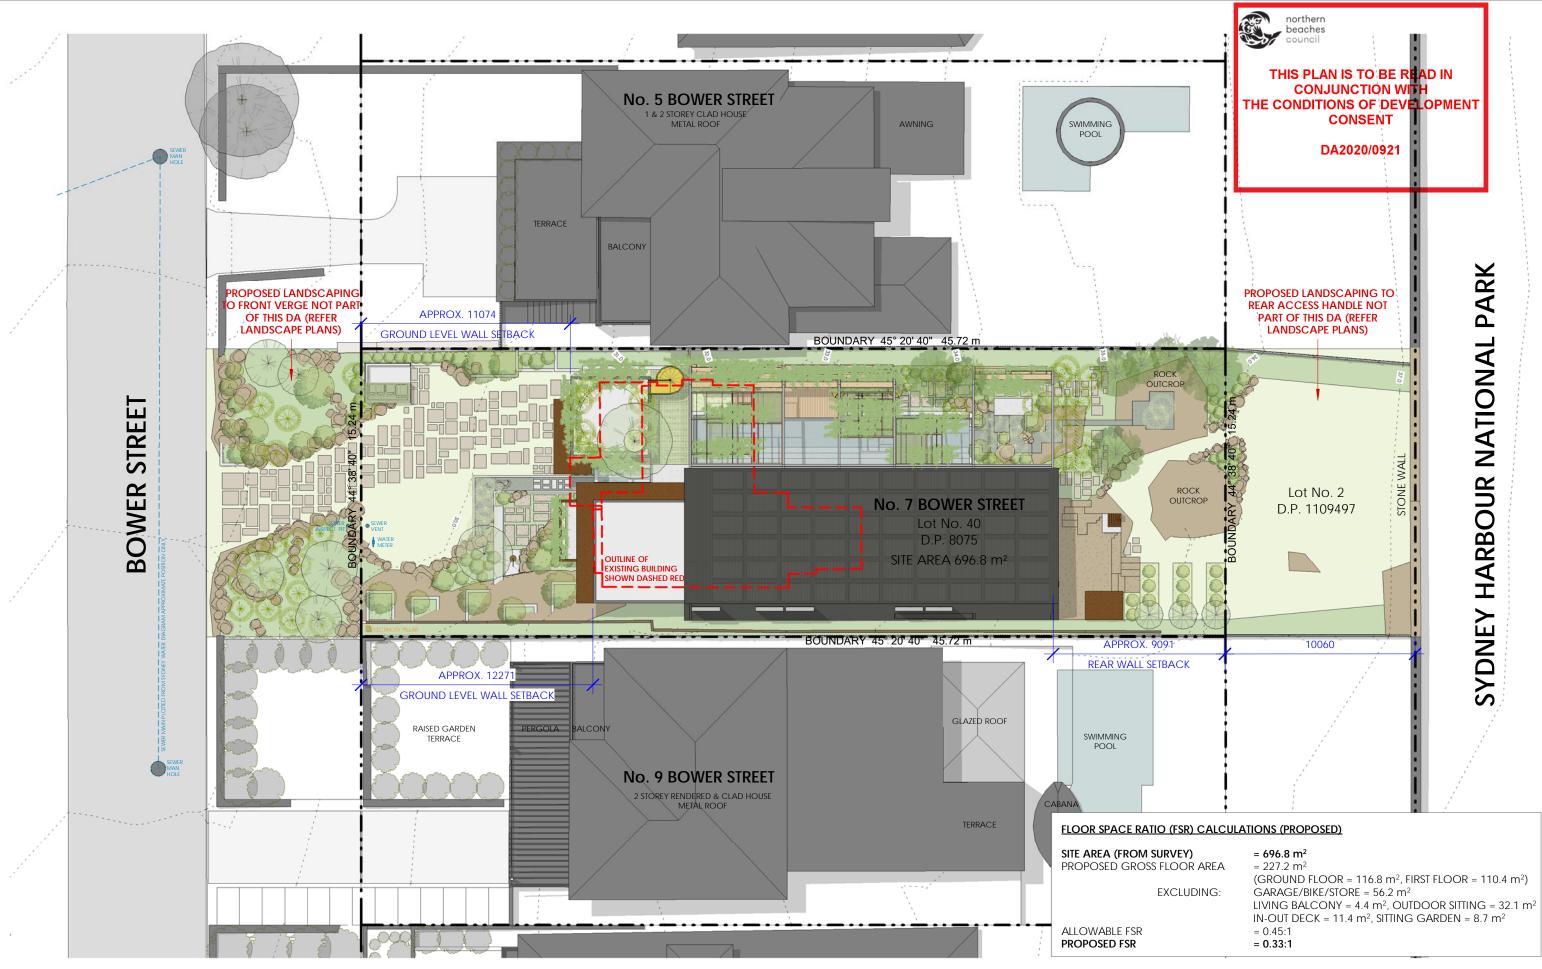



A3	DRAWING TITLE PROPOSED GARAGE FLOOR PLAN		
	REVISION DATE	REVISION	DRAWING NUMBER
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DEVELOPMENT APPLICATION ONLY - NOT FOR CONSTRUCTION

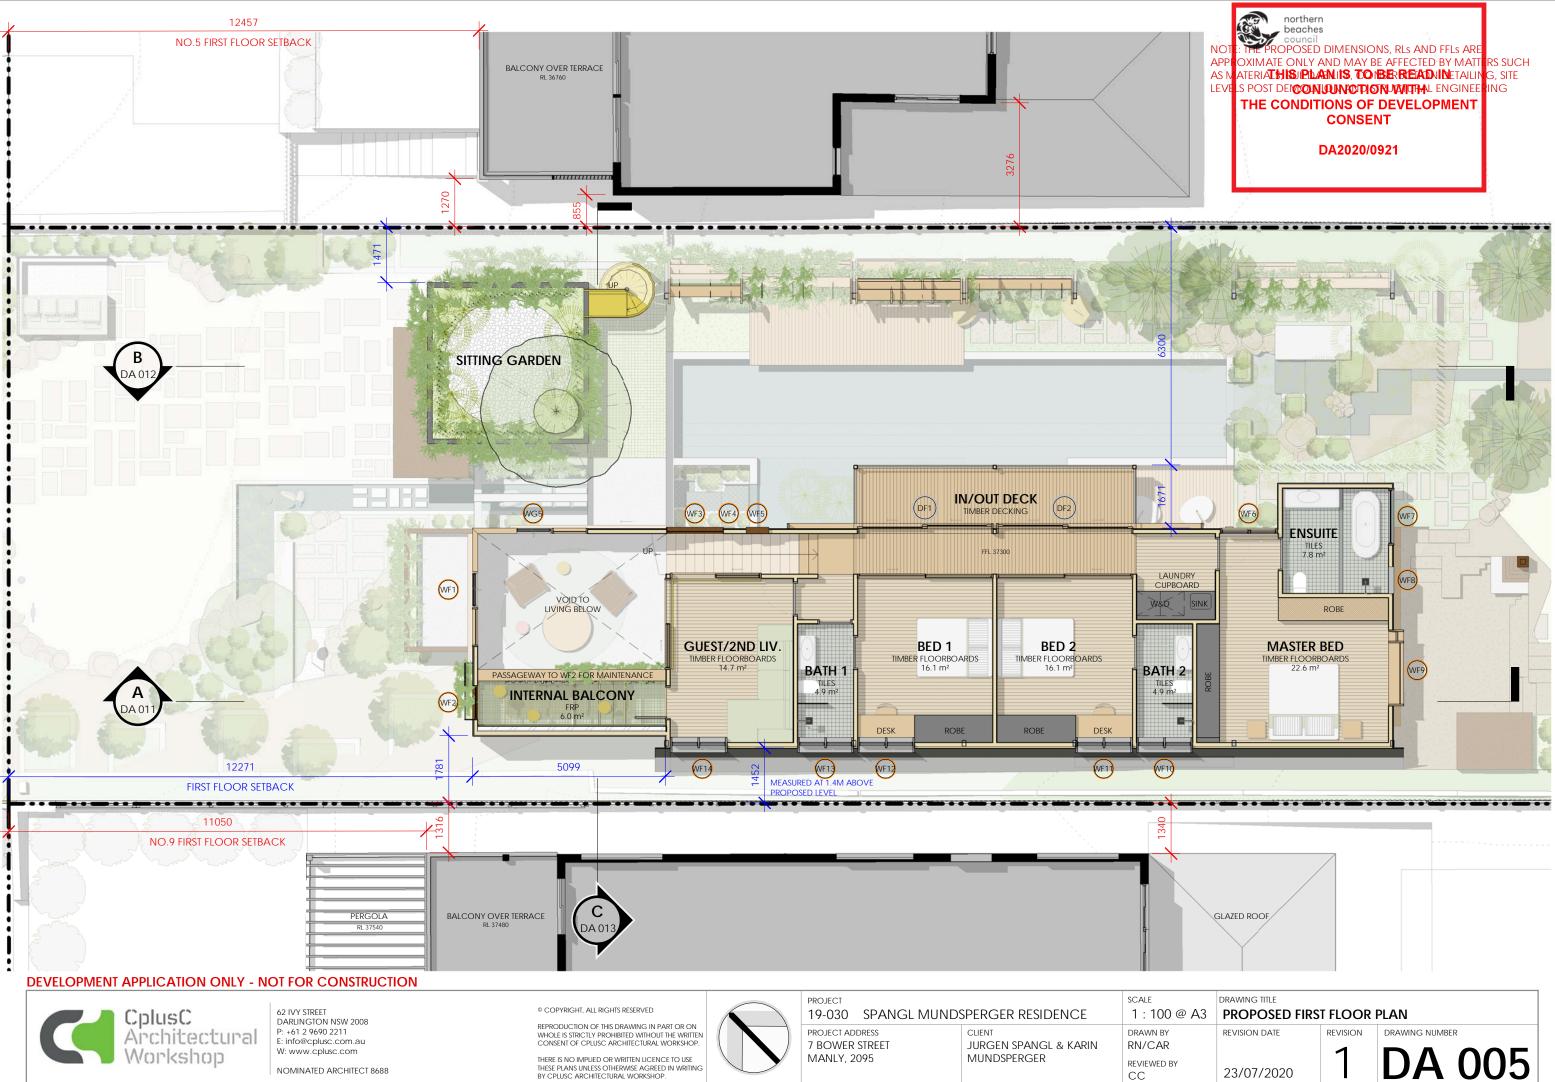


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)95	MUNDSPERGER	REVIEWED		



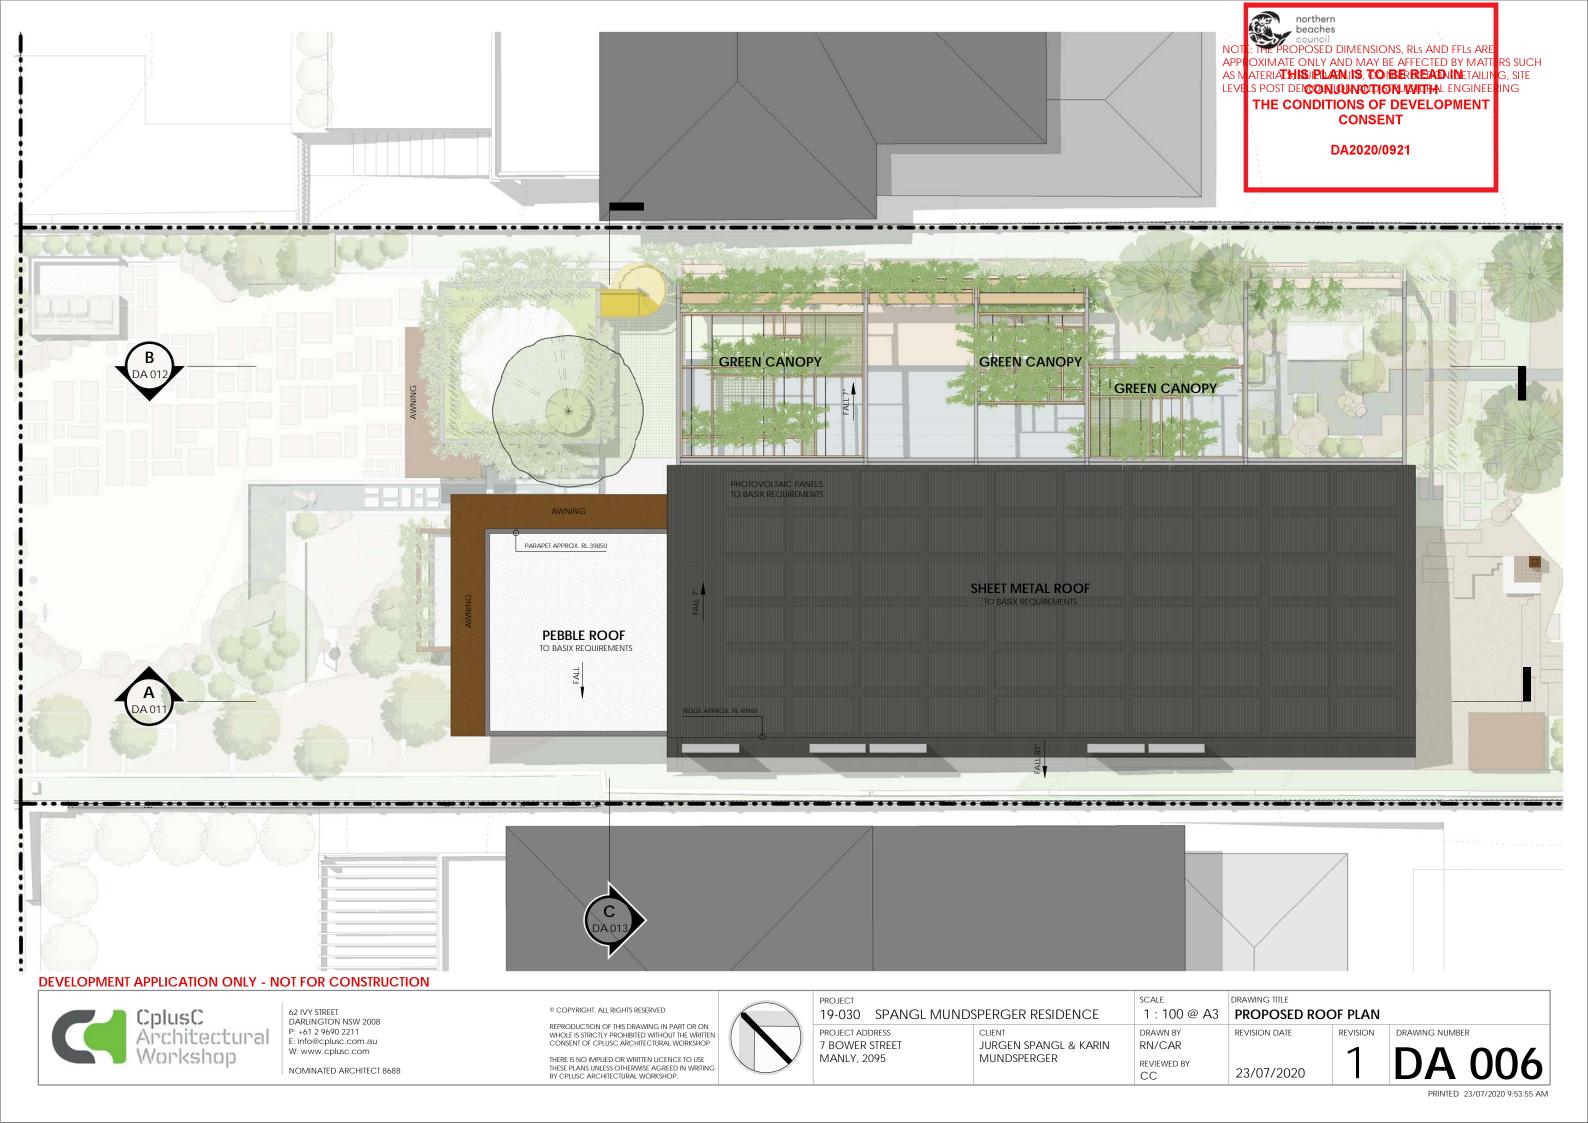

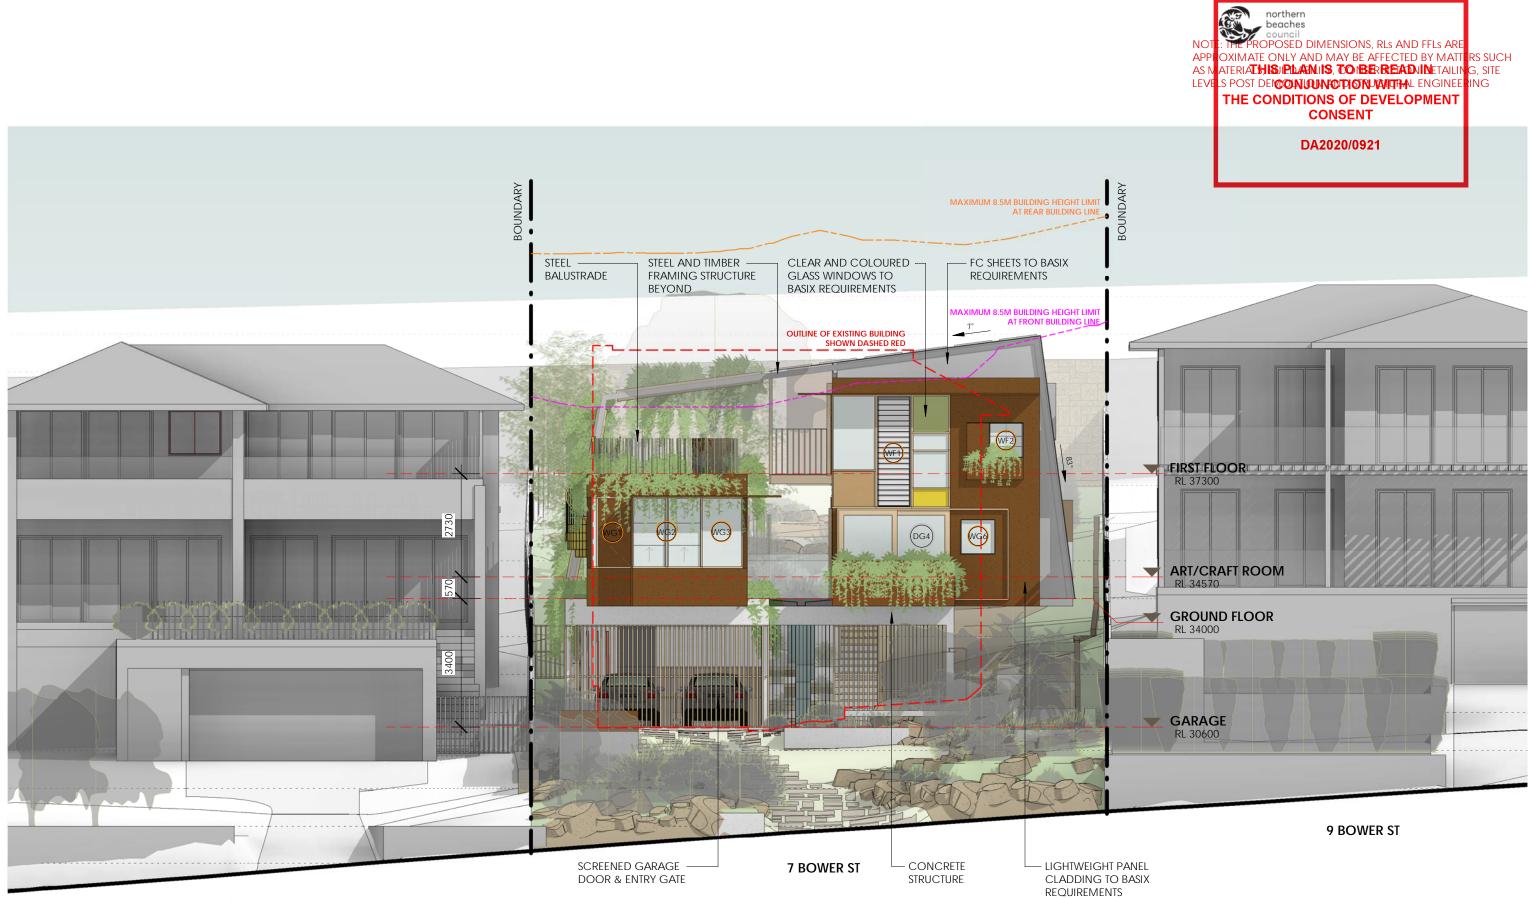
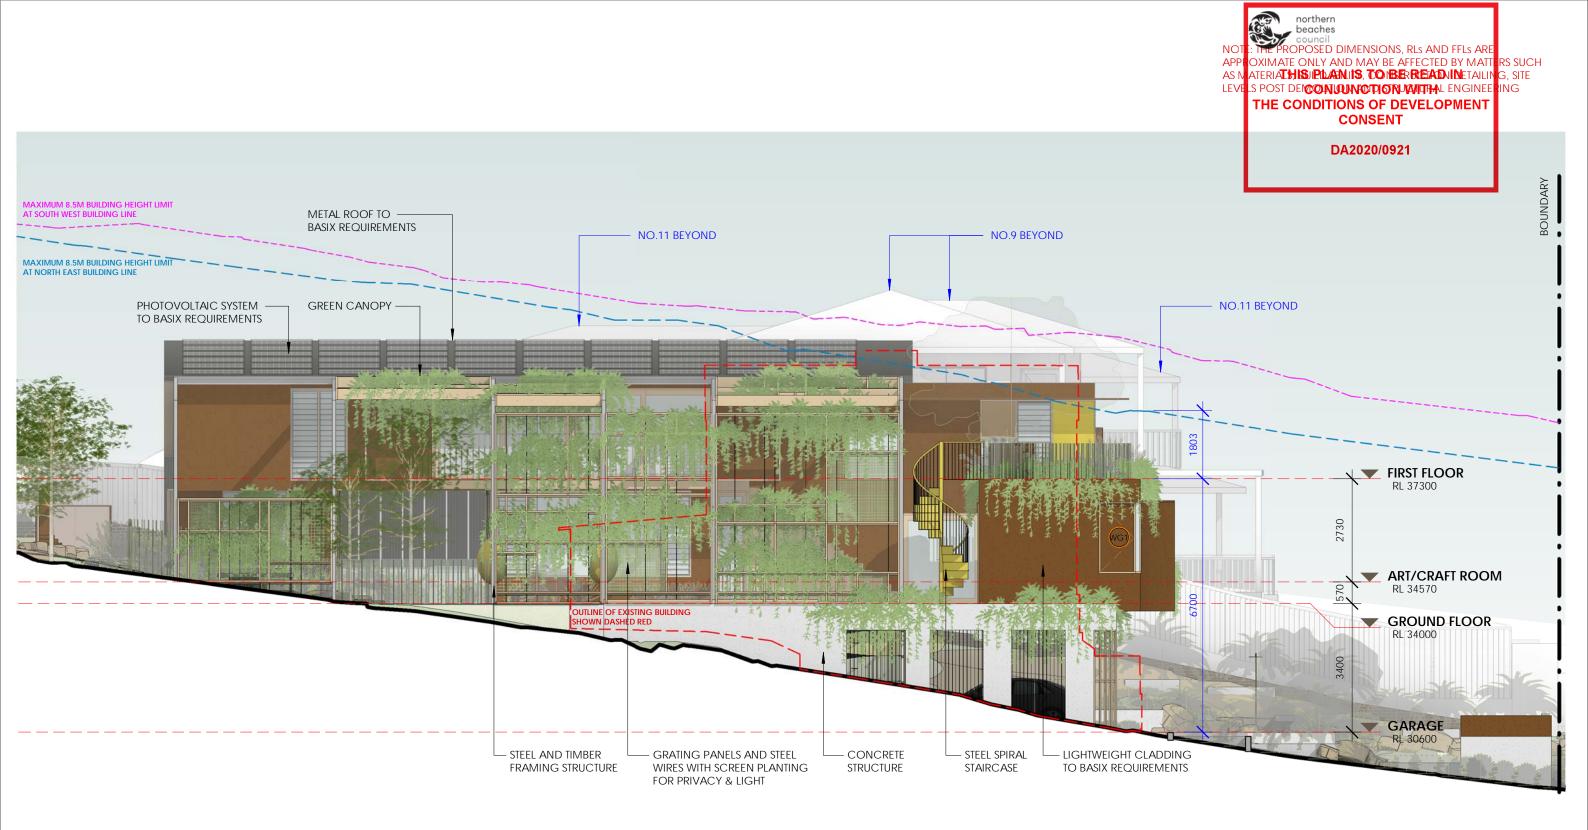
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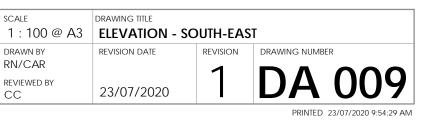
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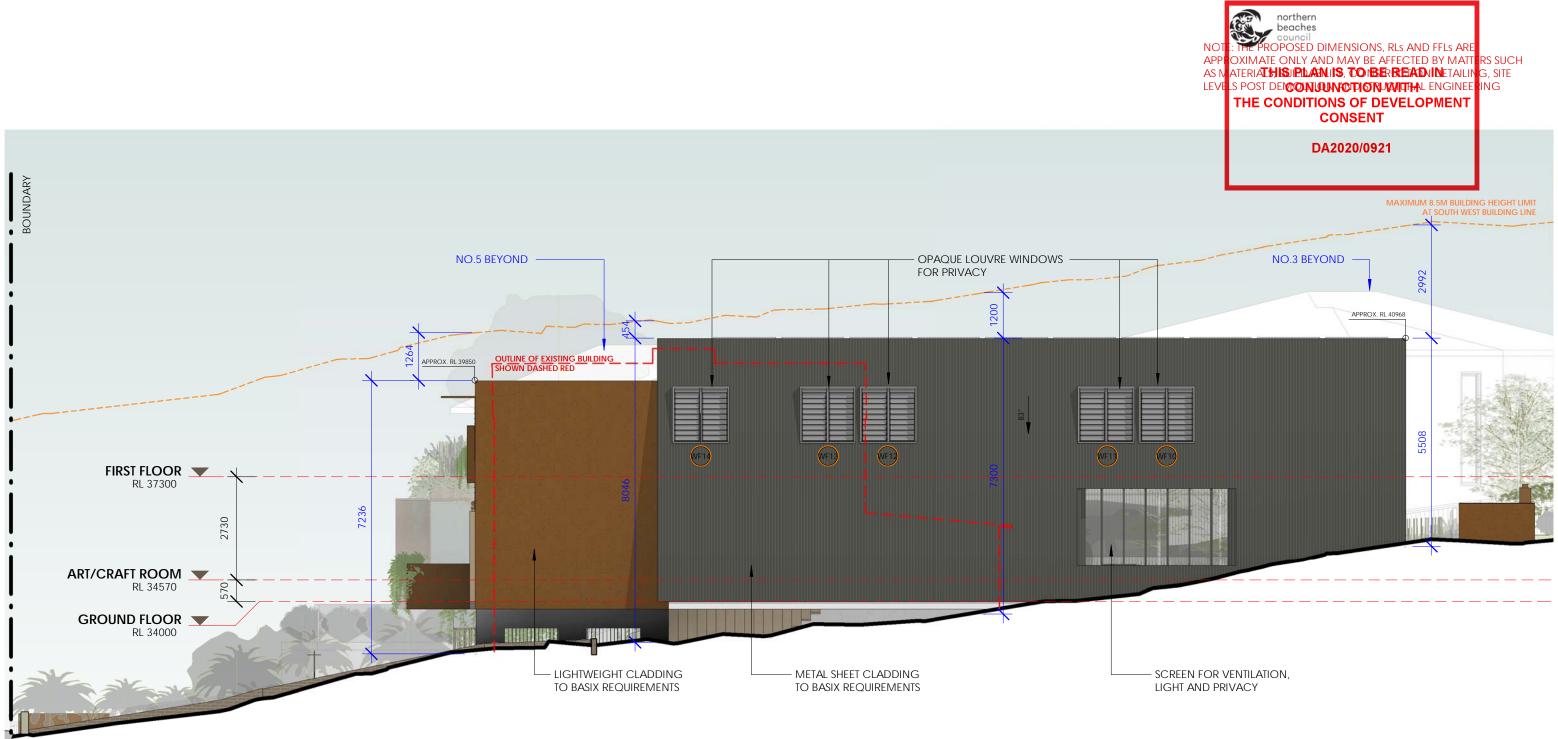
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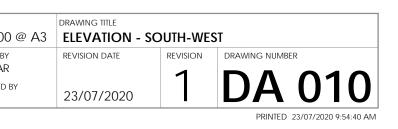


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19-030 SPANGL MUNDSPERGER RESIDENCE			scale 1:100
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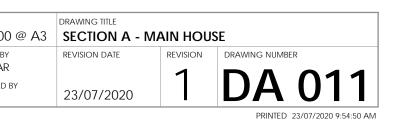



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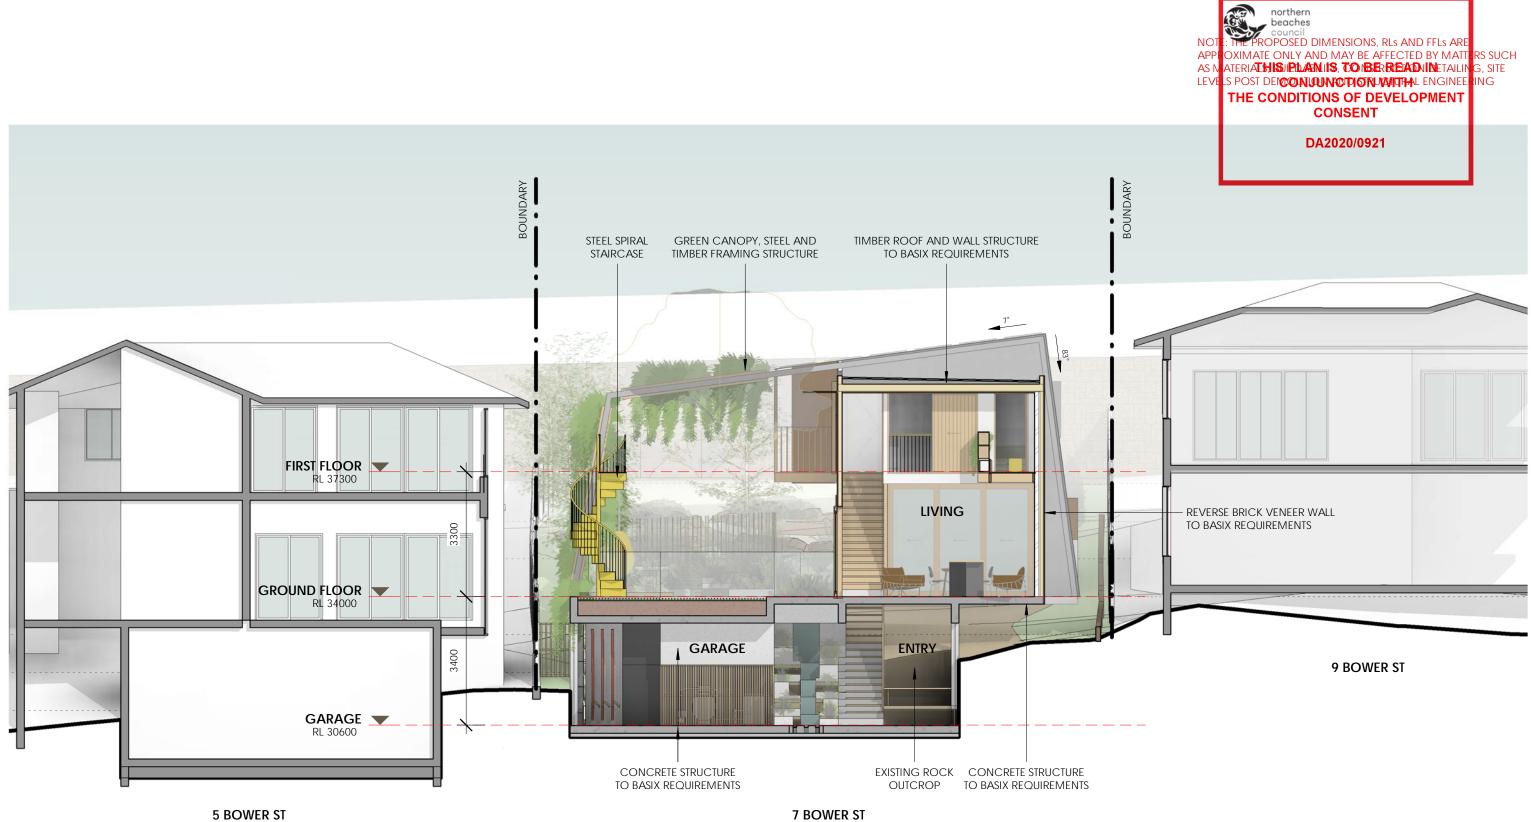
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) SPANGL MUNDS	SPERGER RESIDENCE	scale 1 : 100
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ER STREET	Jurgen Spangl & Karin	RN/CAR
, 2095	Mundsperger	REVIEWED BY









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7 BOWER STREET
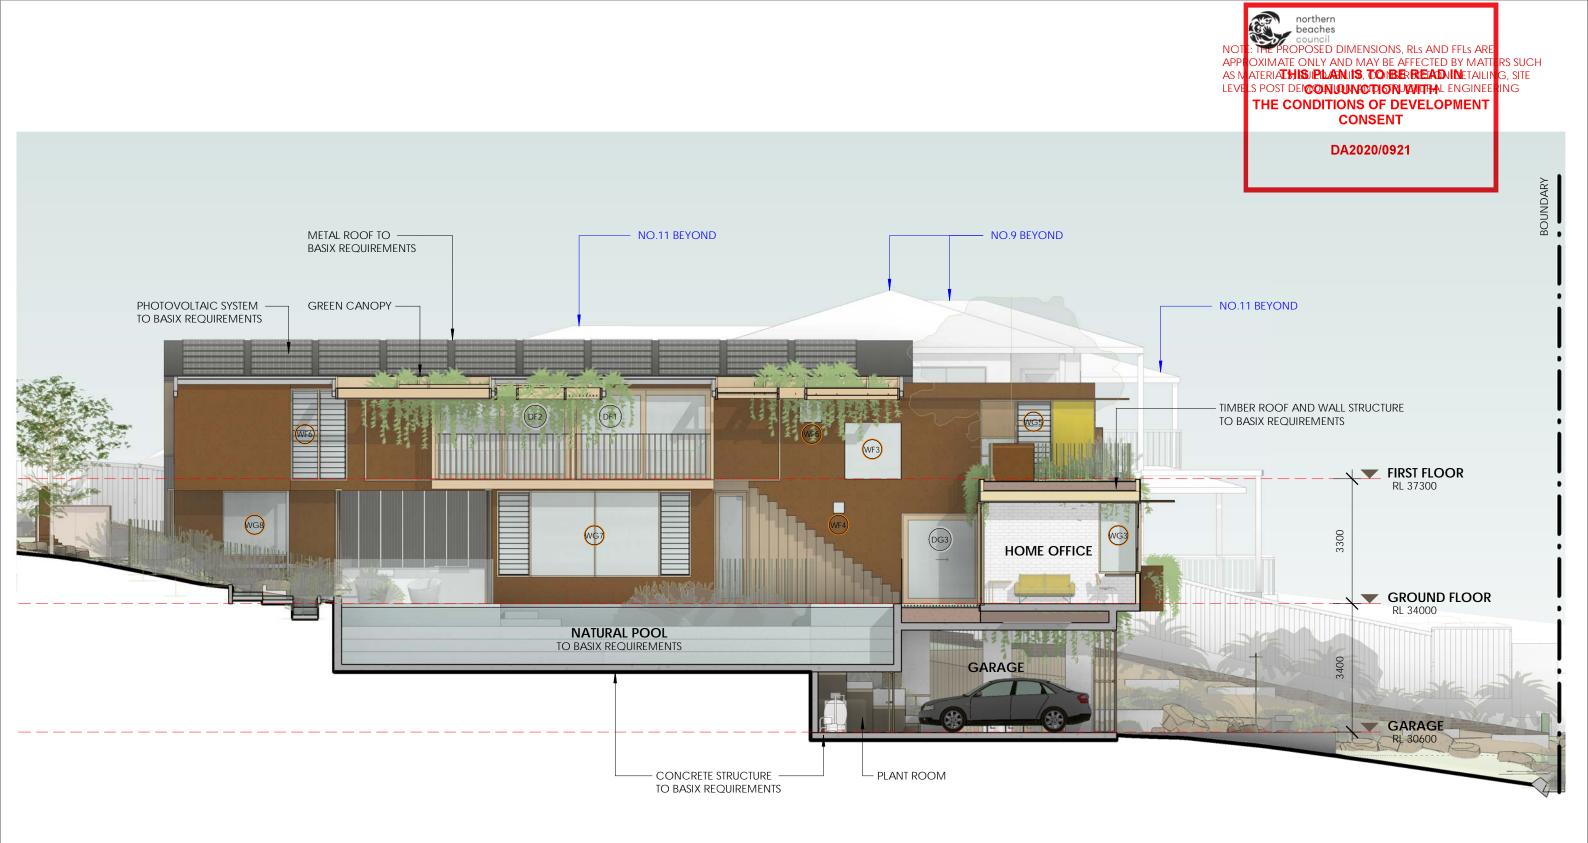
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MUNDSPERGER
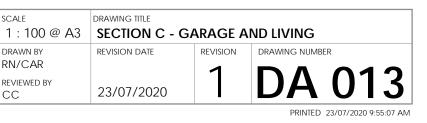
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• A3	DRAWING TITLE EROSION CONTROL & WASTE MANAGEMENT			
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	23/07/2020	1	DA 018	
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PLAN VIEW NOTE: THE PROPOSED EXCAVATION AND FILL AREAS ARE APPROXIMATE ONLY AND ARE SUBJECT TO THE ACTUAL SITE CONDITION DURING CONSTRUCTION

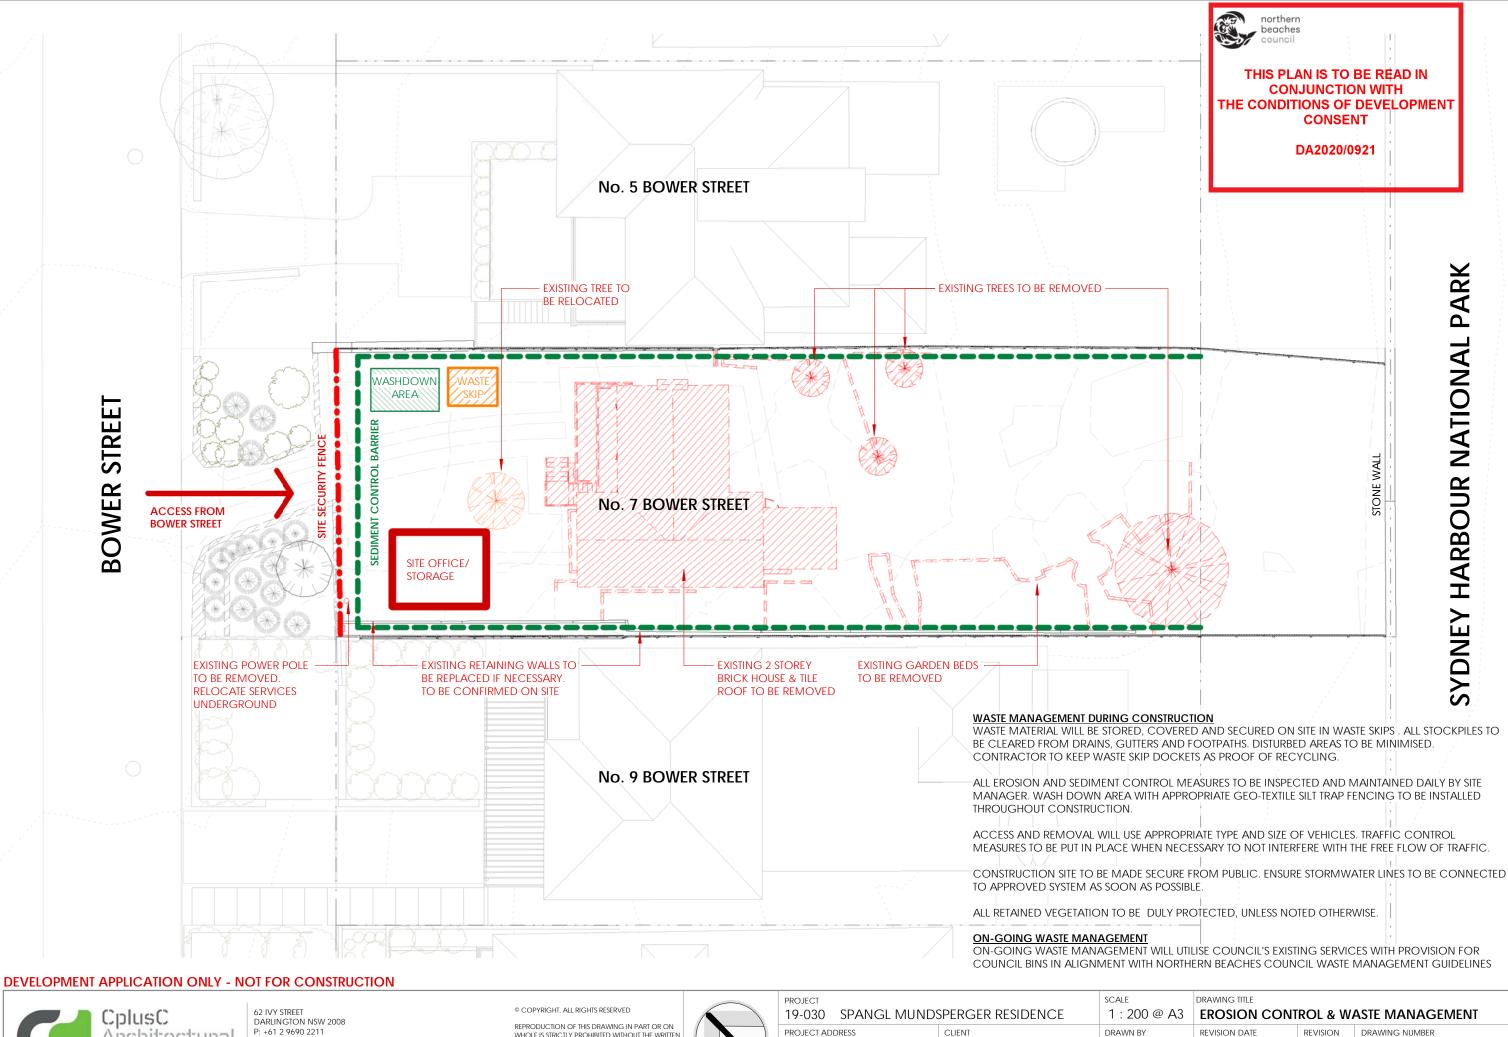EXCAVATION AND FILL PLAN (PROPOSED)



SURFACE AREA: 204m² (APPROX.)

VOL

SURFACE AREA: 54m² (APPROX.)





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7 BOWER S	TREET
MANLY, 20	95

GL MUNDS	scale 1:200 @	
	^{CLIENT} JURGEN SPANGL & KARIN MUNDSPERGER	DRAWN BY RN/CAR REVIEWED BY CC

BOWER STREET



SYDNEY HARBOUR NATIONAL PARK

VOLUME: 90-110m³ (APPROX.)

VOLUME: 20-30m³ (APPROX.)







1 STEEL AND TIMBER FRAME STRUCTURE



2 GRATING PANELS AND STEEL WIRES WITH SCREEN PLANTING



3 LIGHTWEIGHT CLADDING




4 CONCRETE STRUCTURE



5 METAL ROOFING



7 TIMBER BATTENS AND STEEL CABLE WIRES

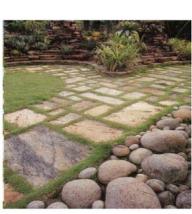

8 INTEGRATED STONE PAVERS



9 CREEPING AND CASCADING PLANTS



10 STEEL BALUSTRADE



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PROJECT

	19-030	SPANGL MUND			
PROJECT ADDRESS 7 BOWER STREET					
	MANLY, 2	095			

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DA2020/0921





6 TIMBER FRAMED DOORS & WINDOWS





11 EXISTING ROCK OUTCROP



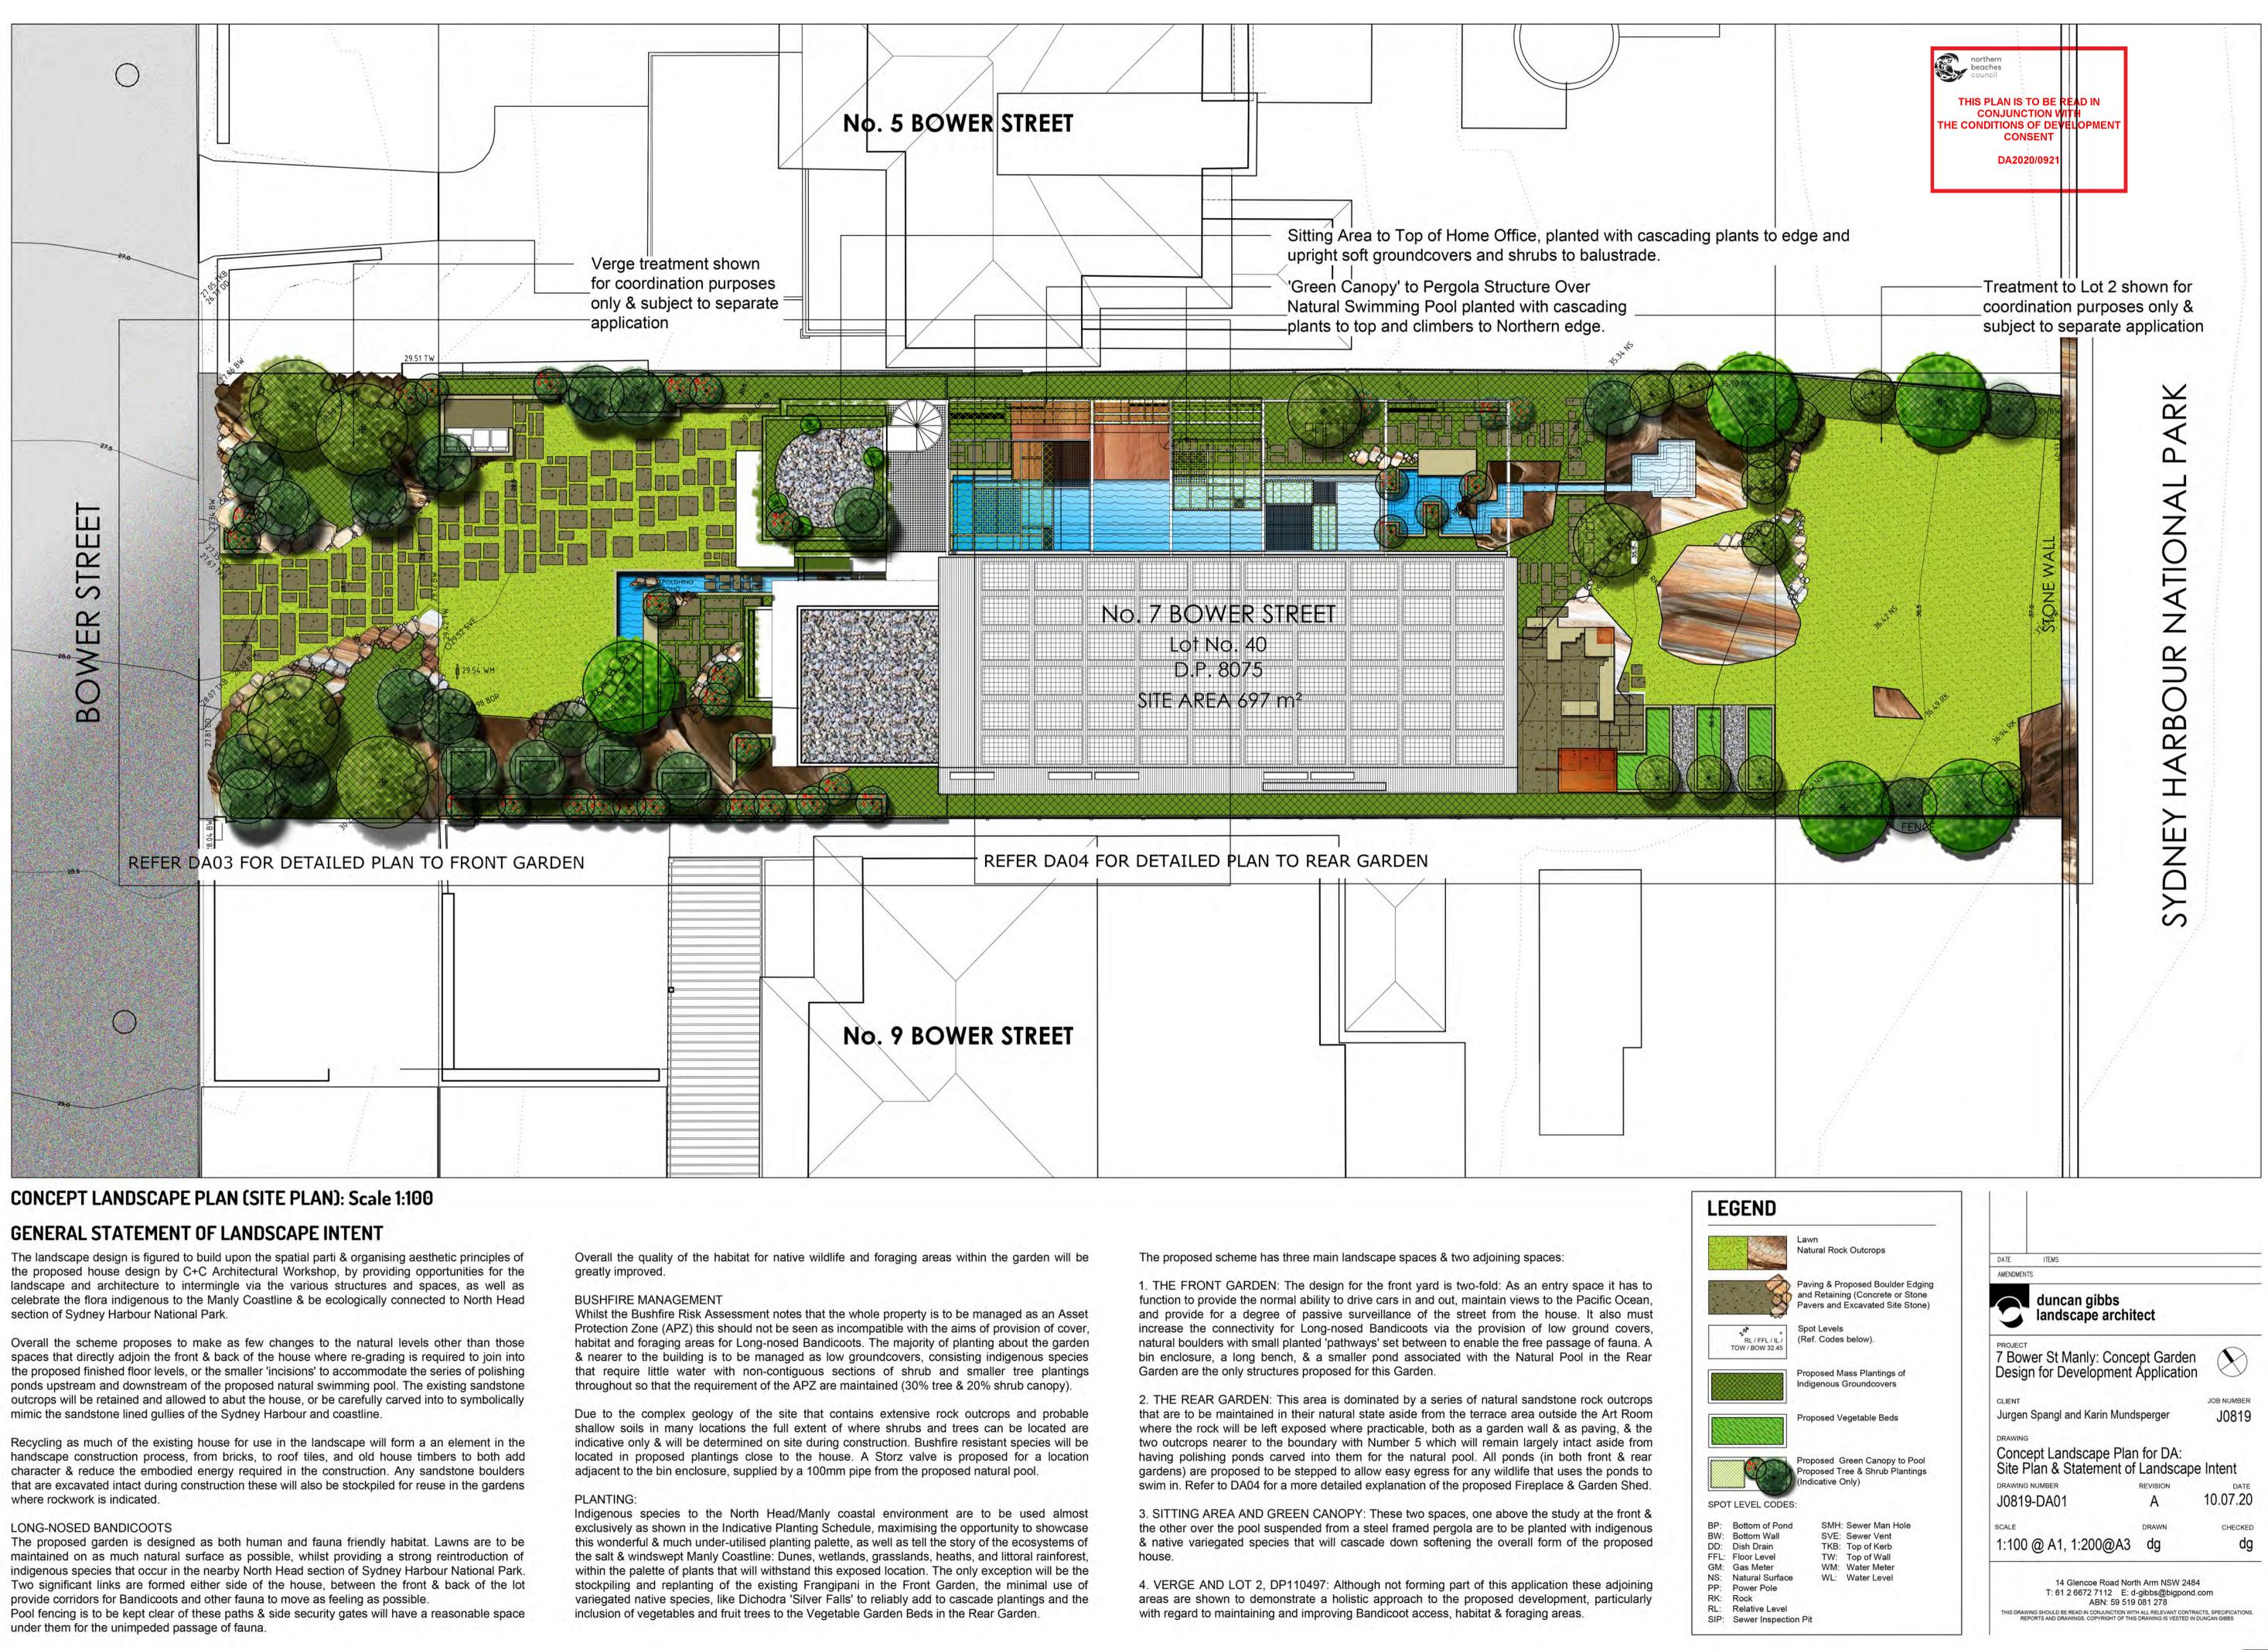

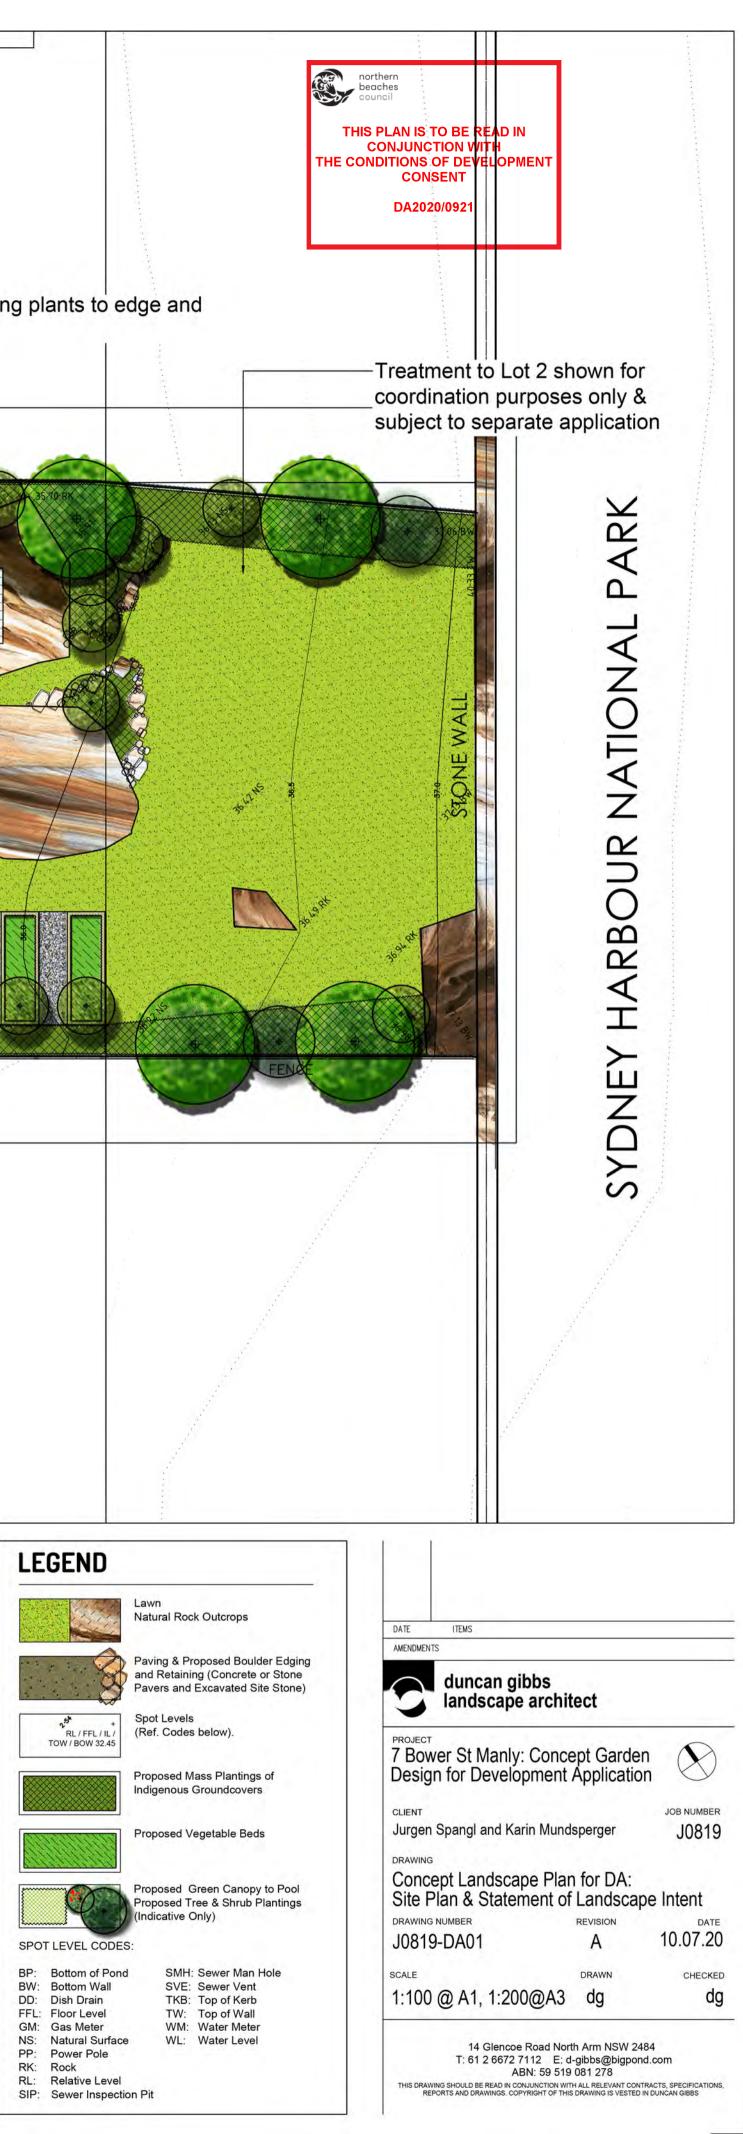


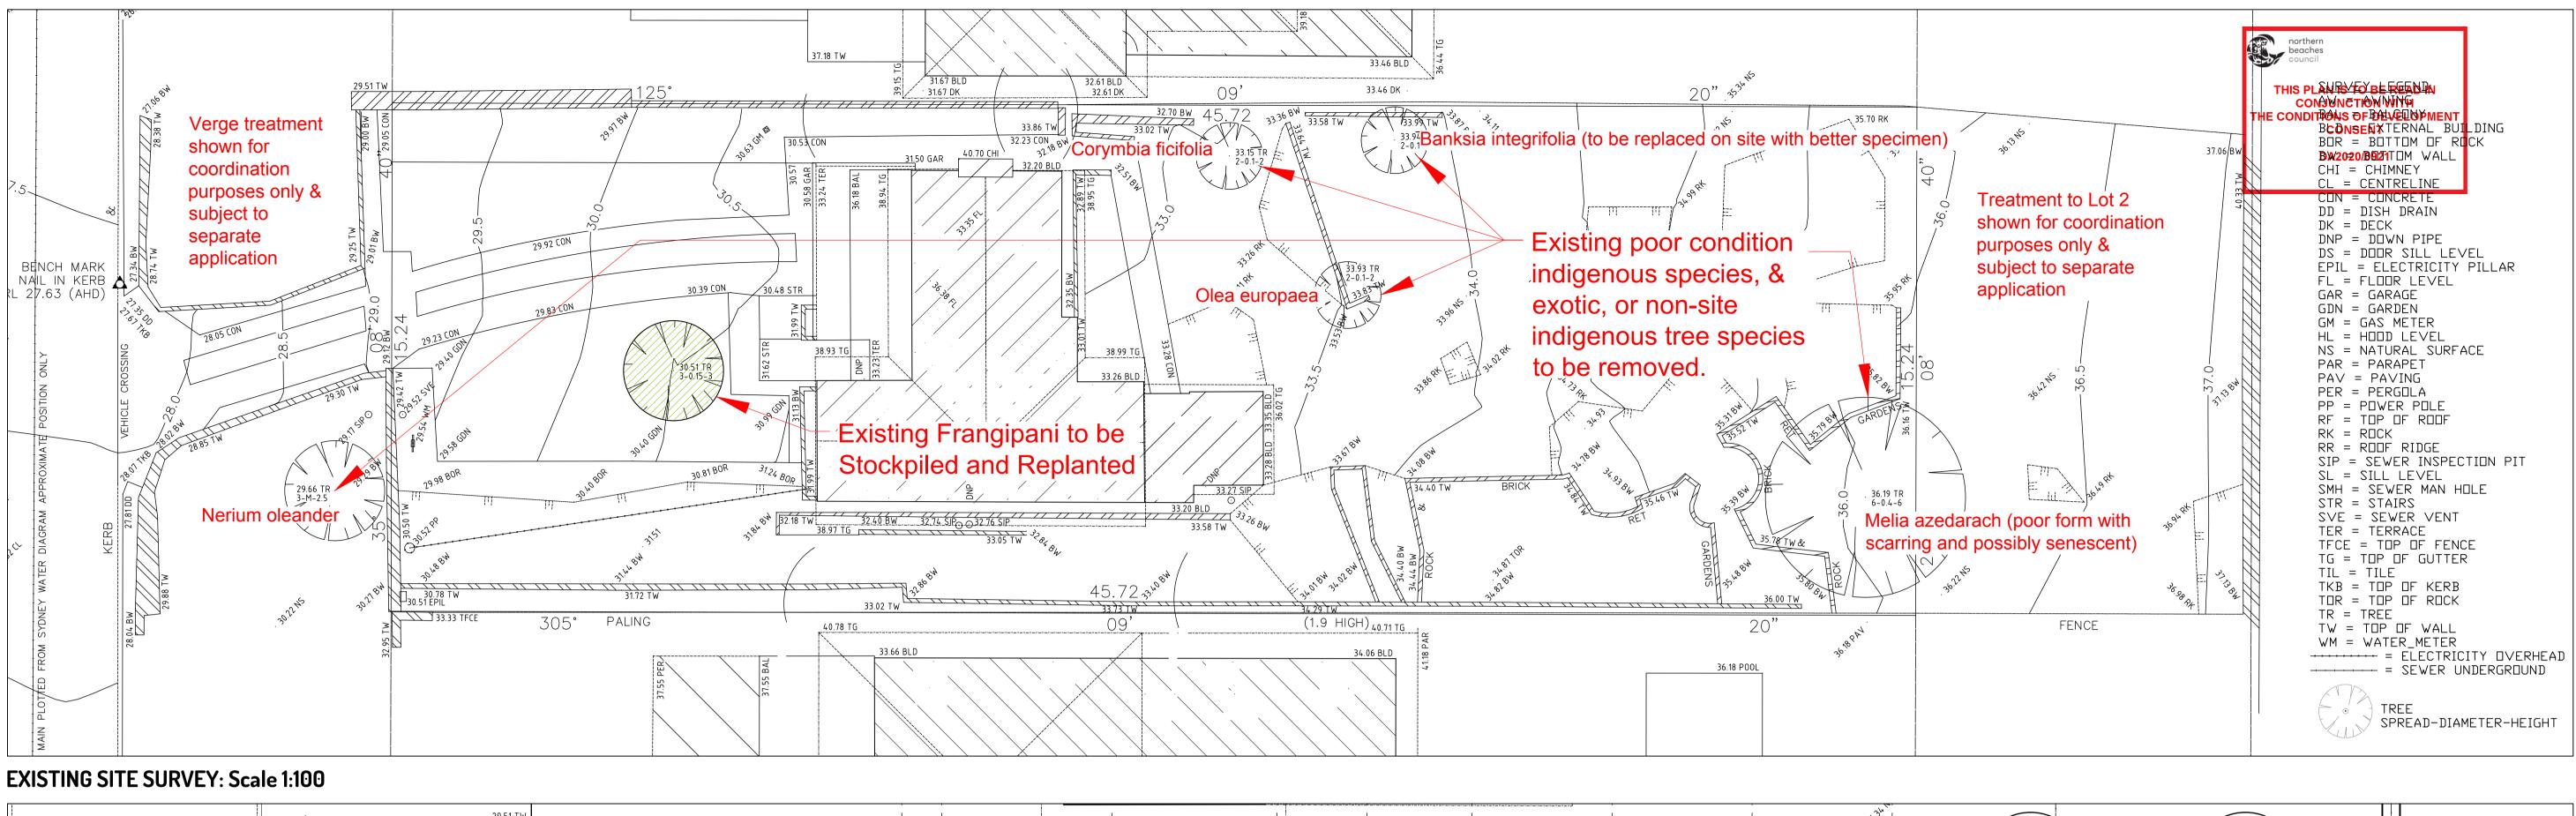


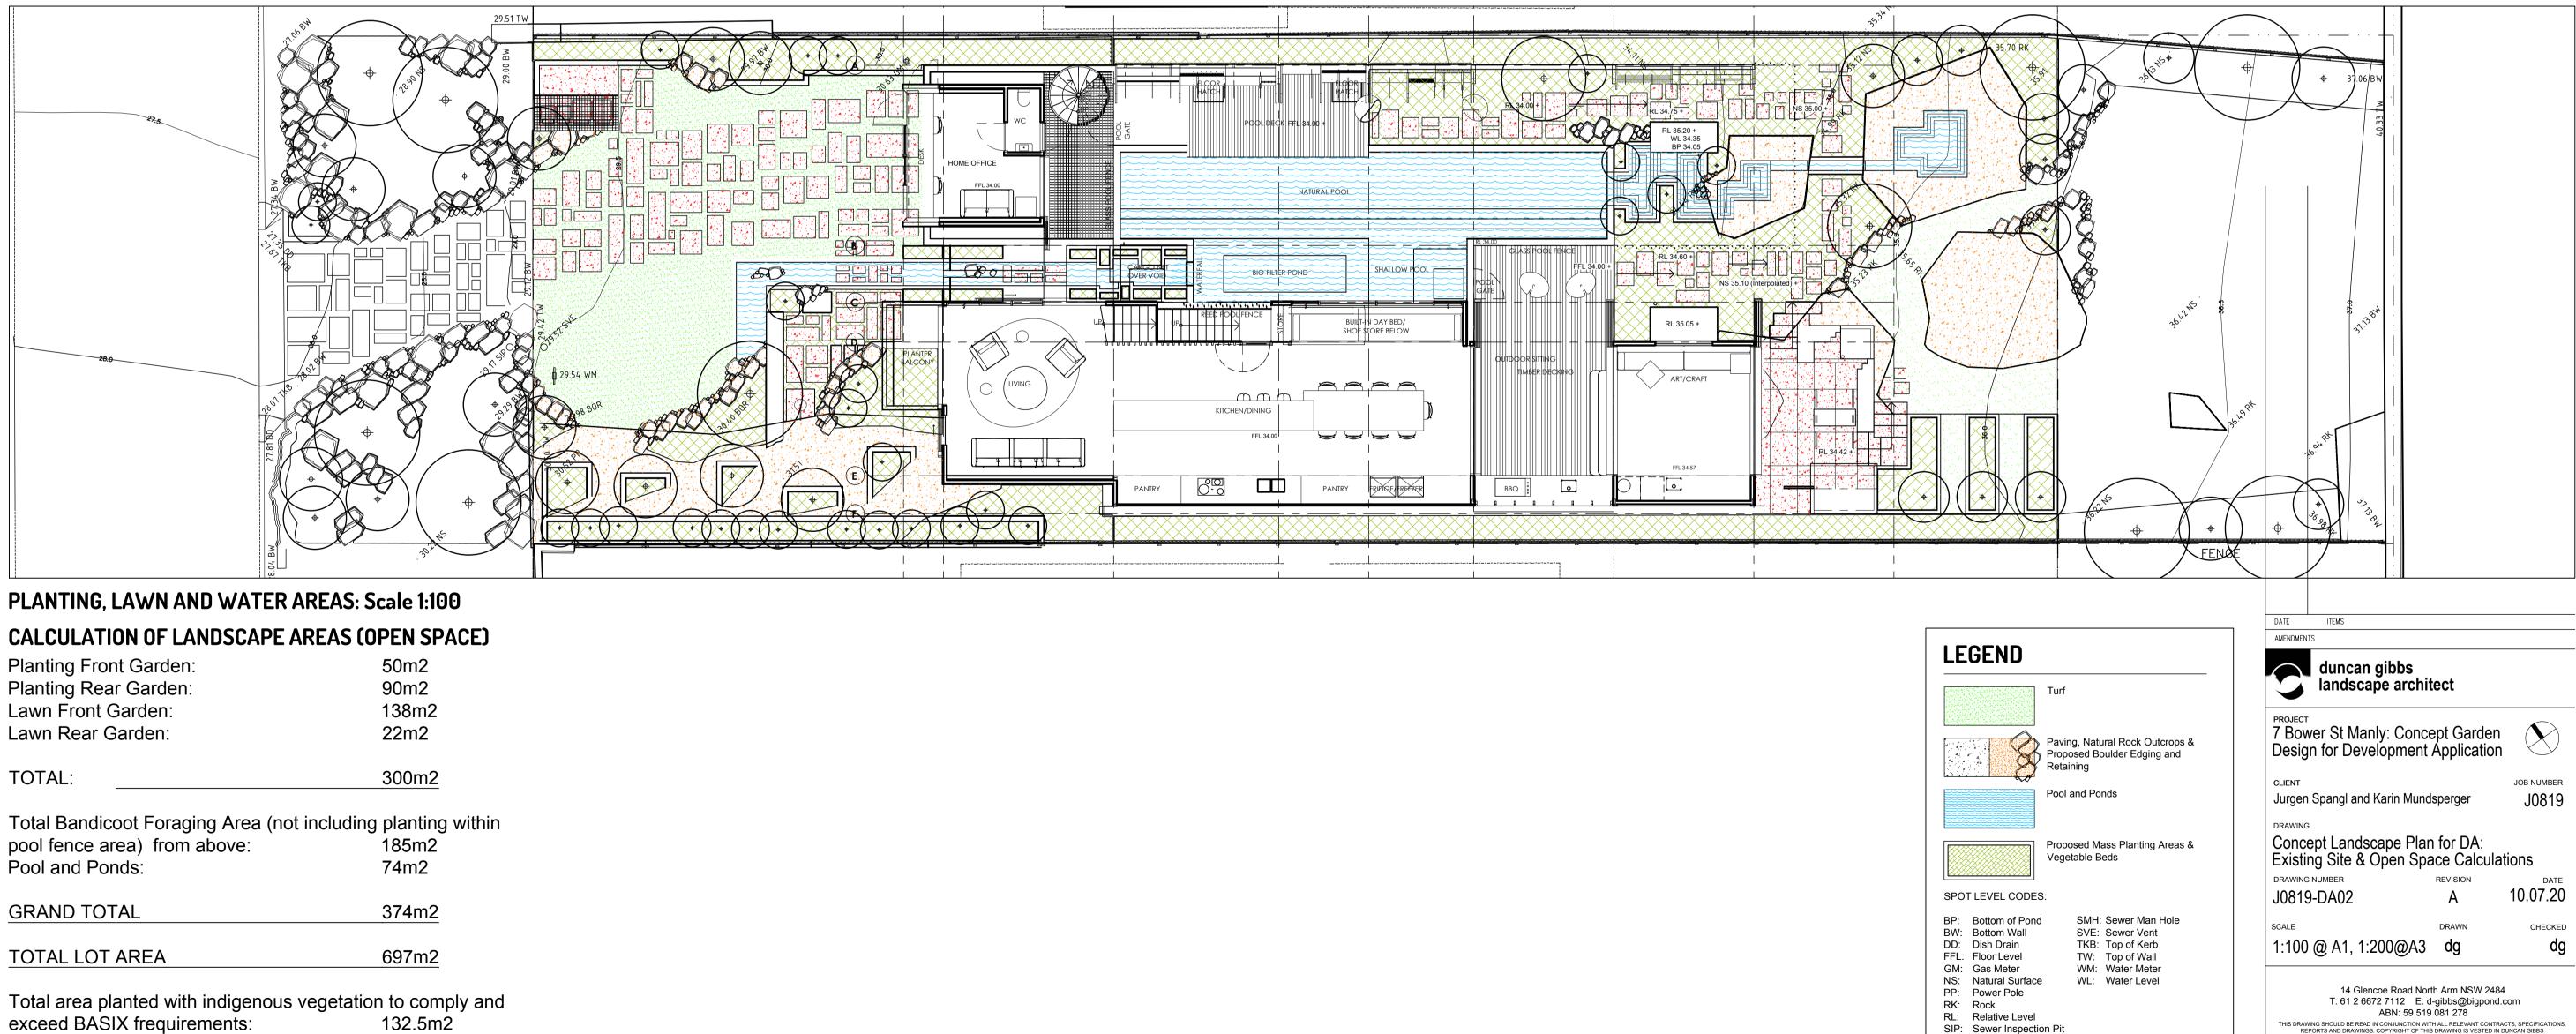


Planting Front Garden:	50m2
Planting Rear Garden:	90m2
Lawn Front Garden:	138m2
Lawn Rear Garden:	22m2


exceed BASIX frequirements: 132.5m2

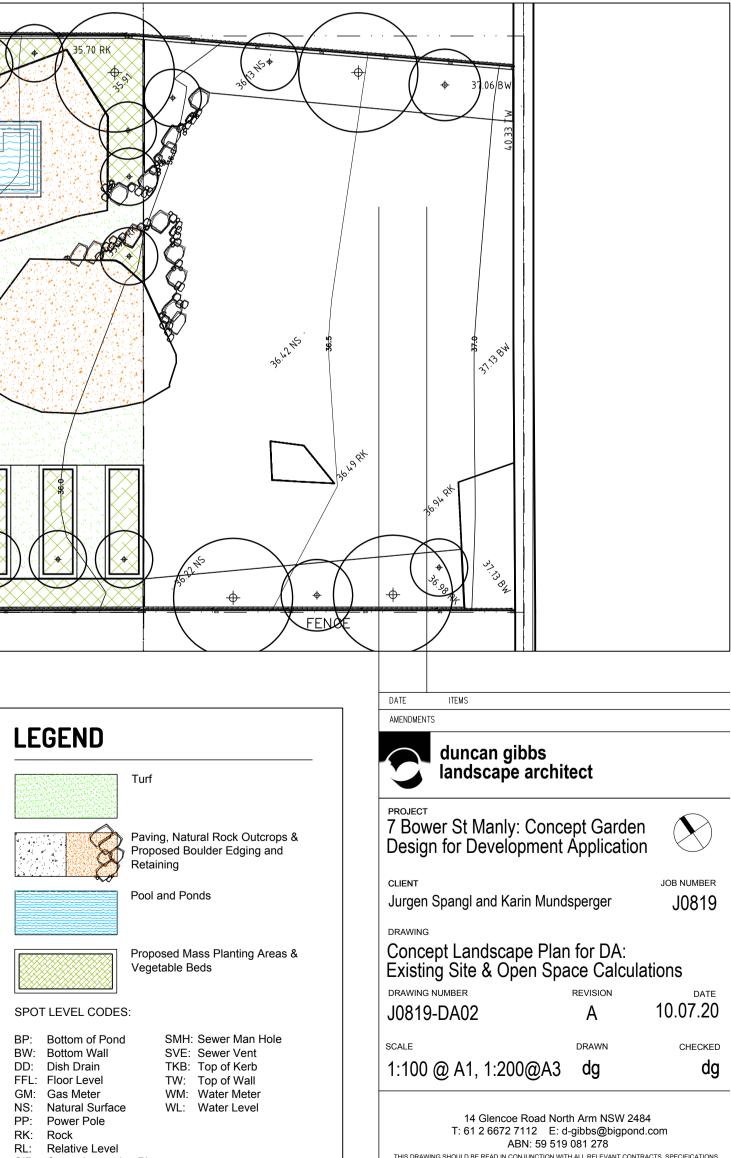


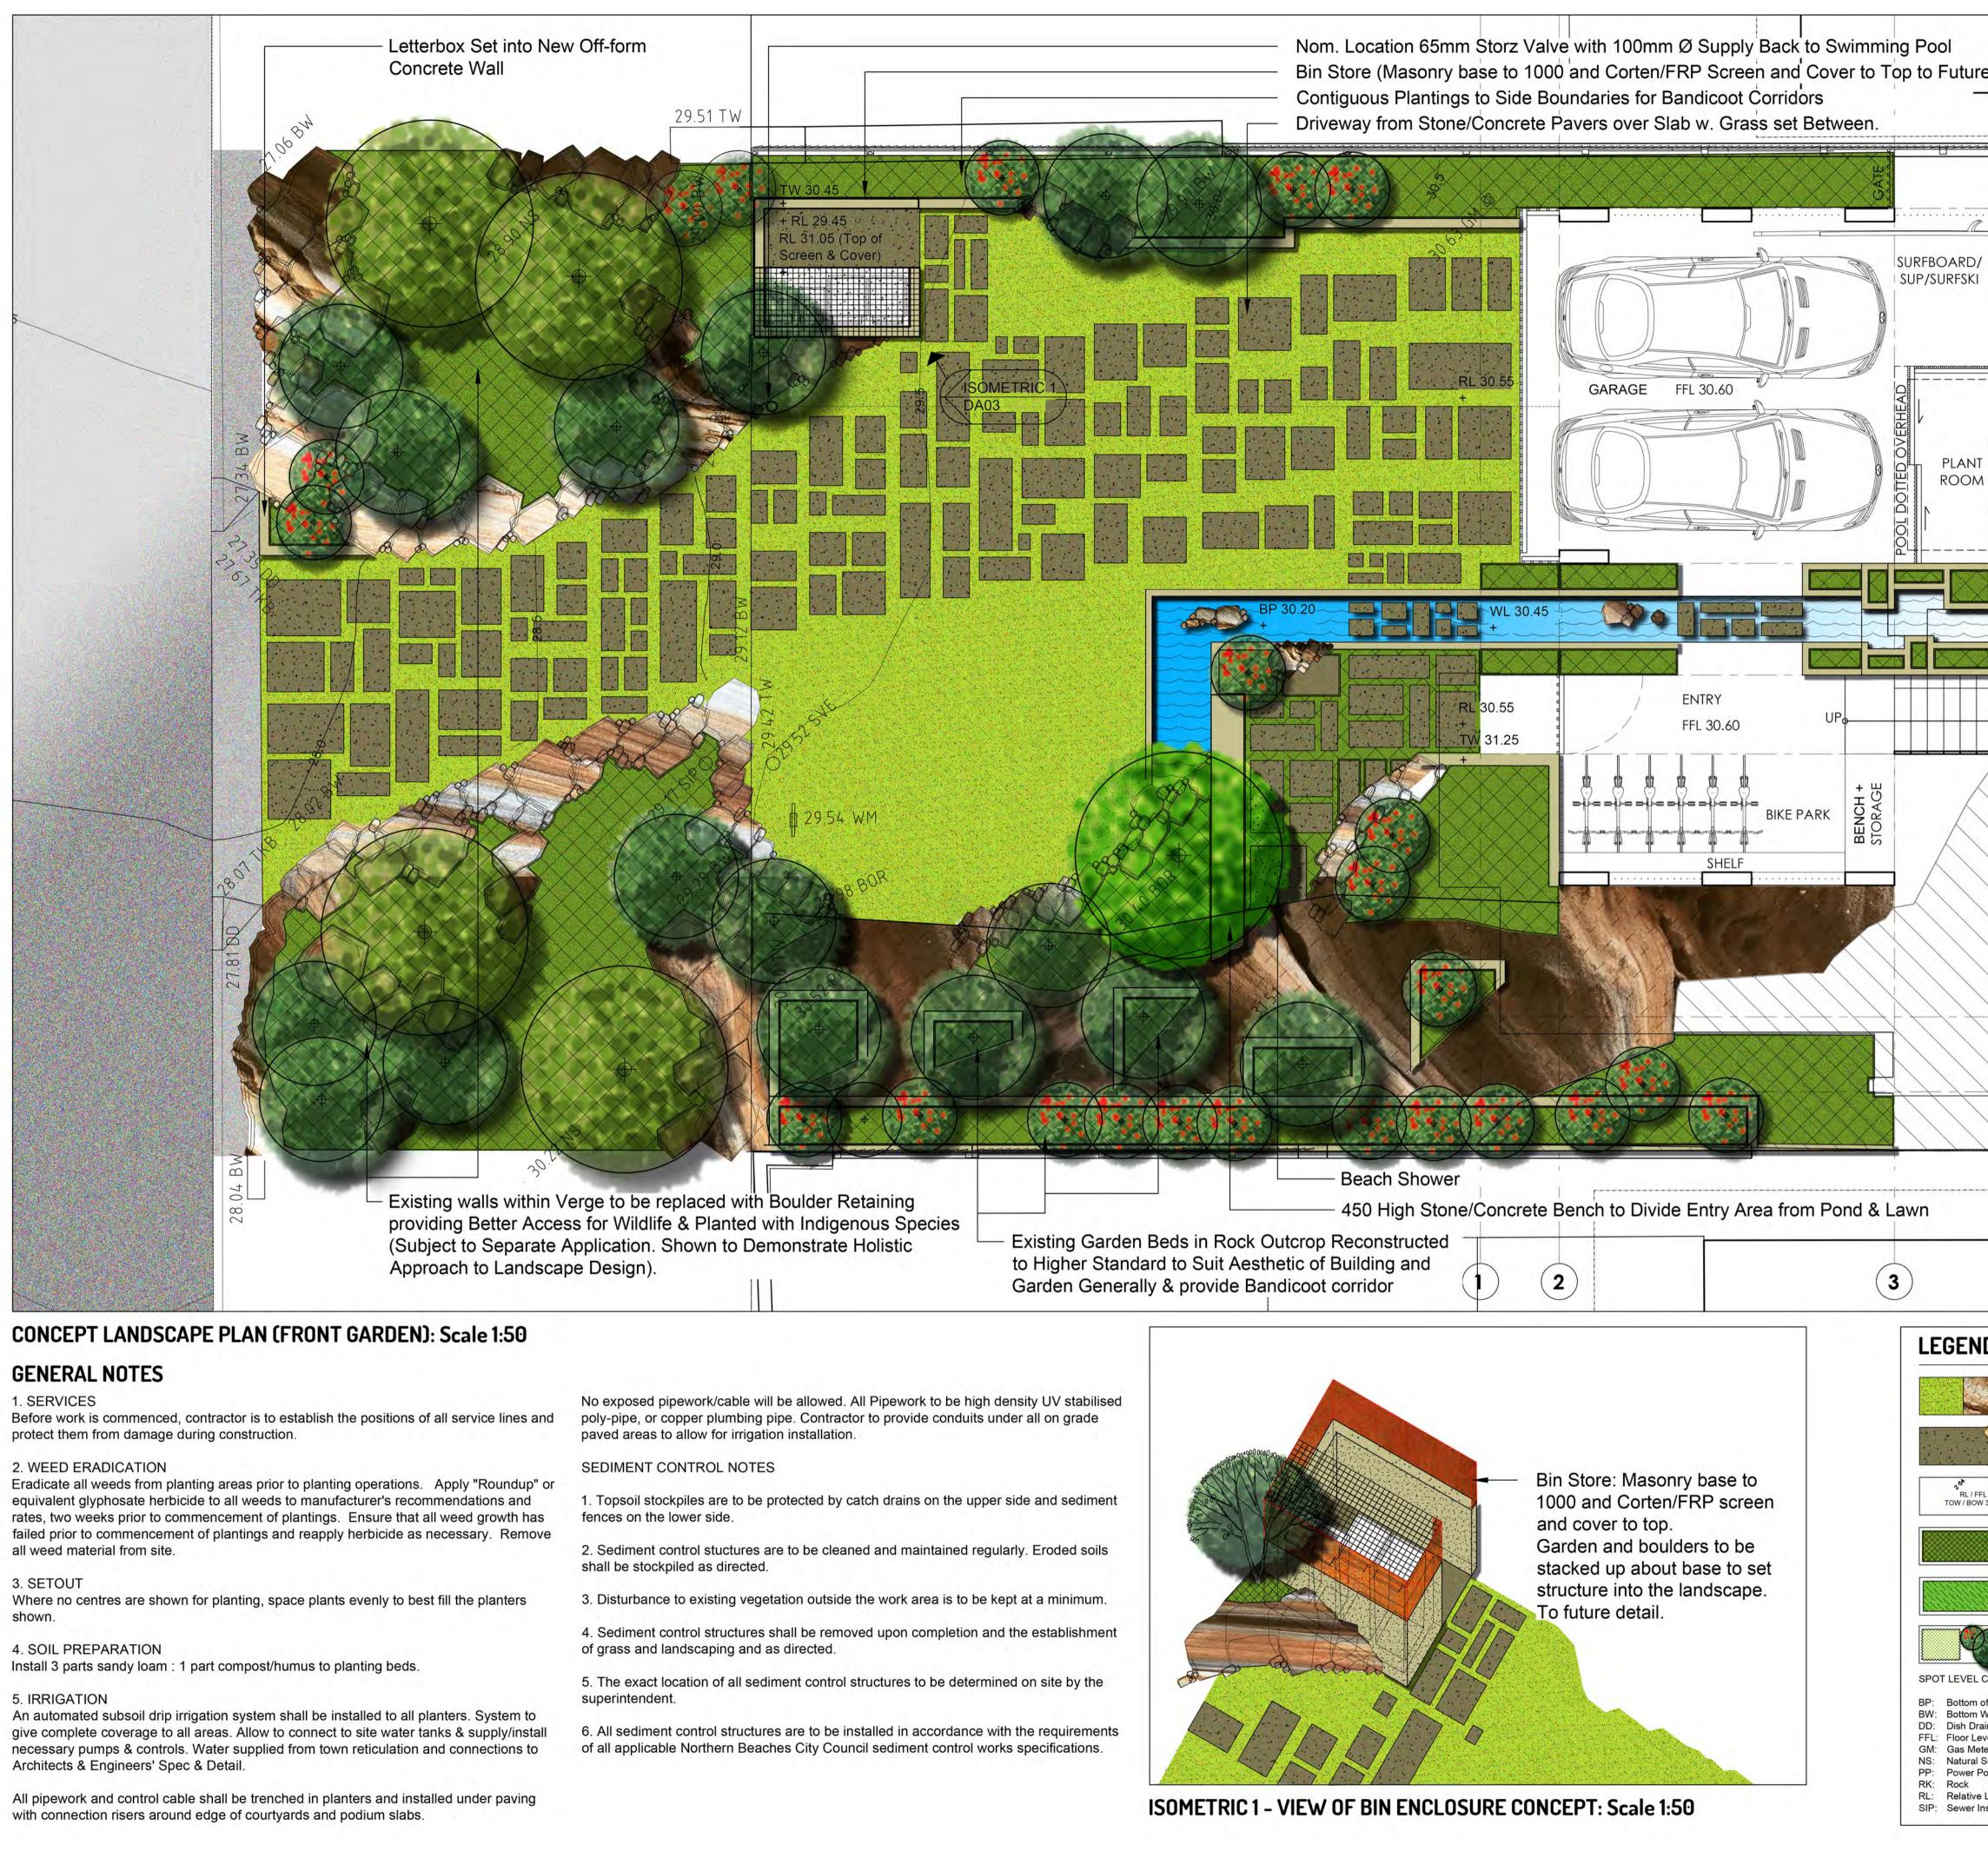

Detail		CONJ THE CONDITIC	I IS TO BE READ IN UNCTION WITH DNS OF DEVELOPMENT CONSENT		
	- Ale and a second		A2020/0921		
STORE	HATCH ABOVE OSD & RAINWATER	RTANK	HATCH ABOVE POOL PUMP AND FILTER		
			down to Lower		B
			n Front Garden		–C
					— E
					F
		4		5	
Paving and Ret Pavers	Rock Outcrops & Proposed Boulder Edging raining (Concrete or Stone and Excavated Site Stone) vels odes below).		duncan gibbs landscape arc	1.1	
Propose	ed Mass Plantings of ous Groundcovers ed Vegetable Beds	cu Ju	Bower St Manly: Co esign for Developme rgen Spangl and Karin Mi awing		en on JOB NUMBER J0819
Propose (Indicati	ed Green Canopy to Pool ed Tree & Shrub Plantings ve Only)	Ga	Dincept Landscape P arden, General Note awing NUMBER 1819-DA03	lan for DA: s, Detail Iso REVISION A	Front ometric View 10.07.20
	MH: Sewer Man Hole VE: Sewer Vent KB: Top of Kerb	SCA		DRAWN	снеске снеске снеске
T T W	W: Top of Wall /M: Water Meter /L: Water Level		14 Glencoe Road T: 61 2 6672 7112		

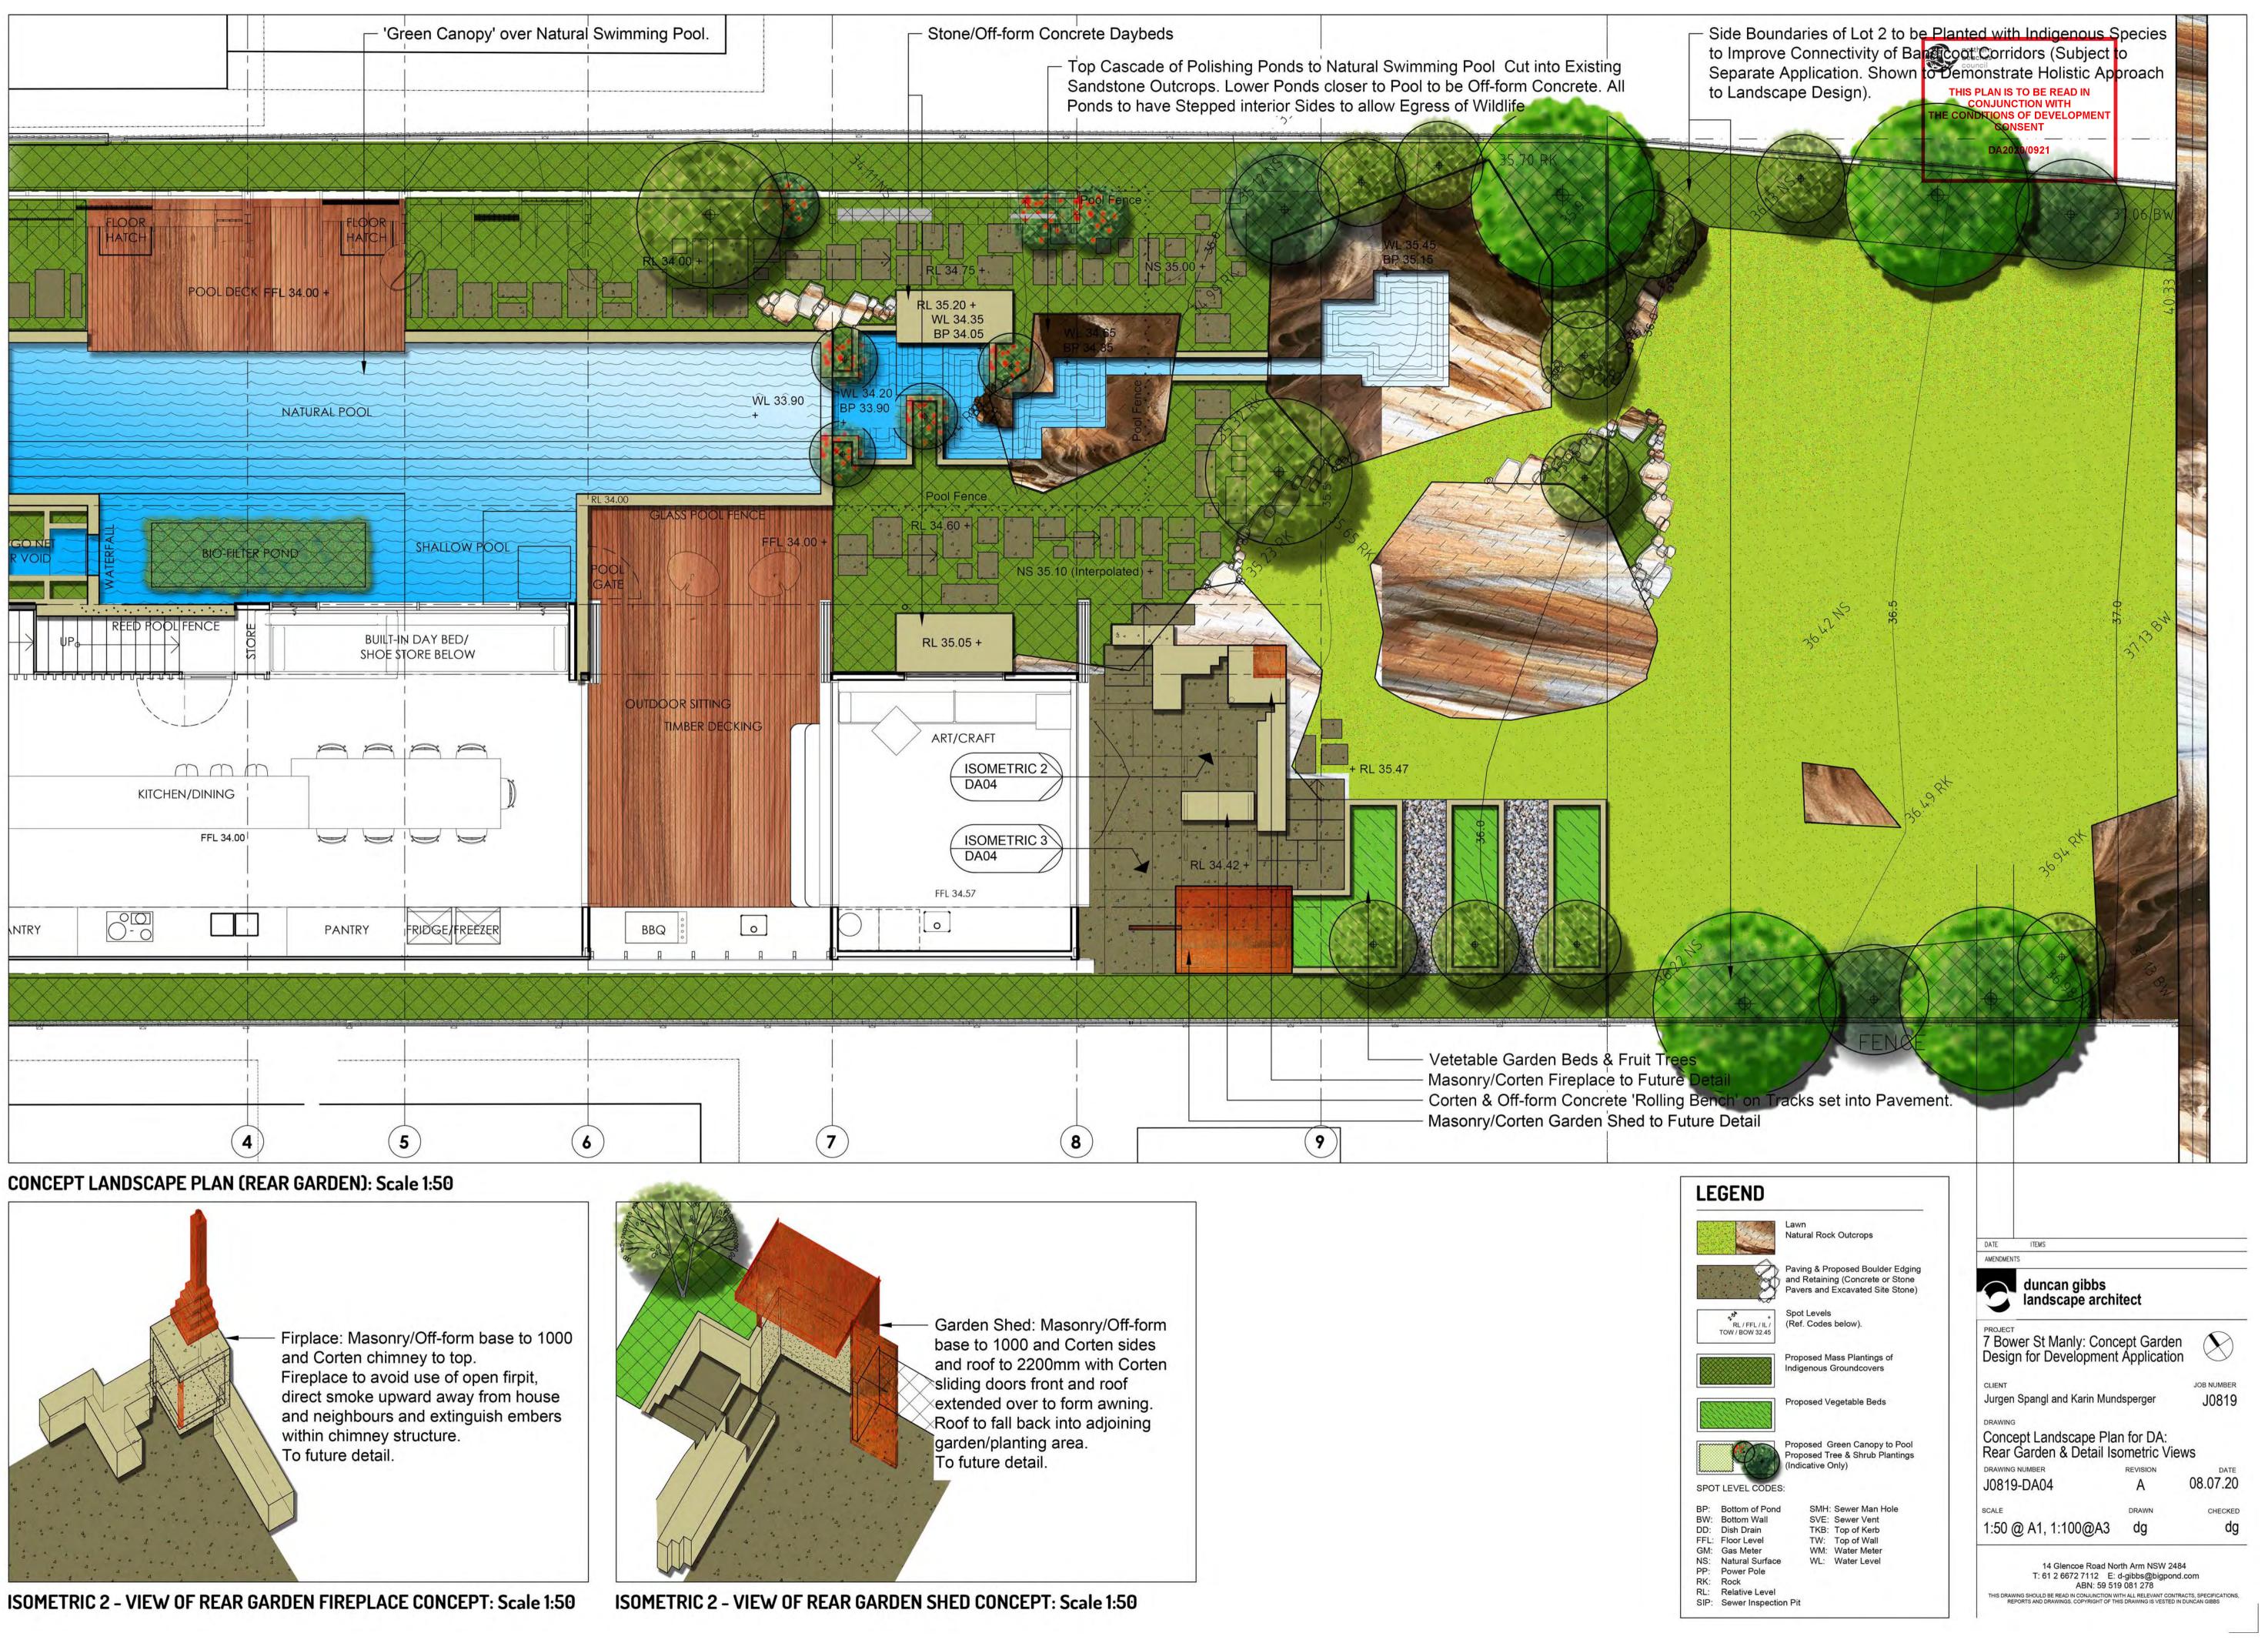

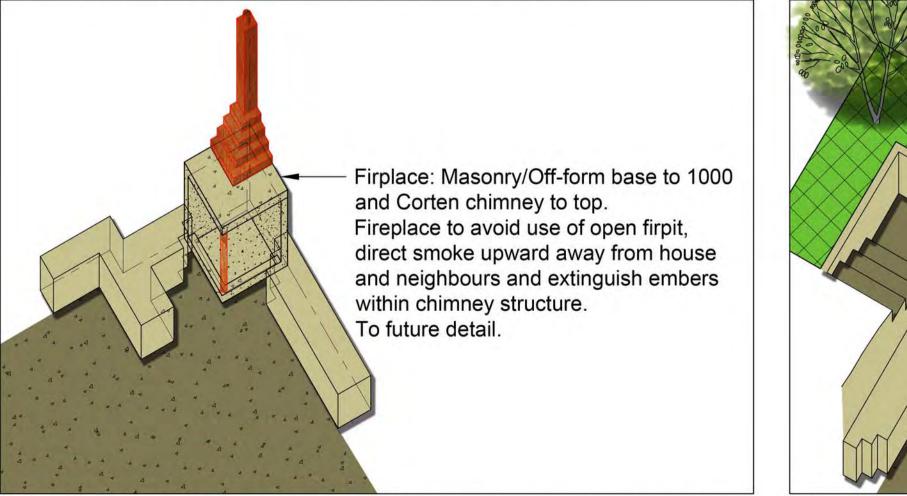

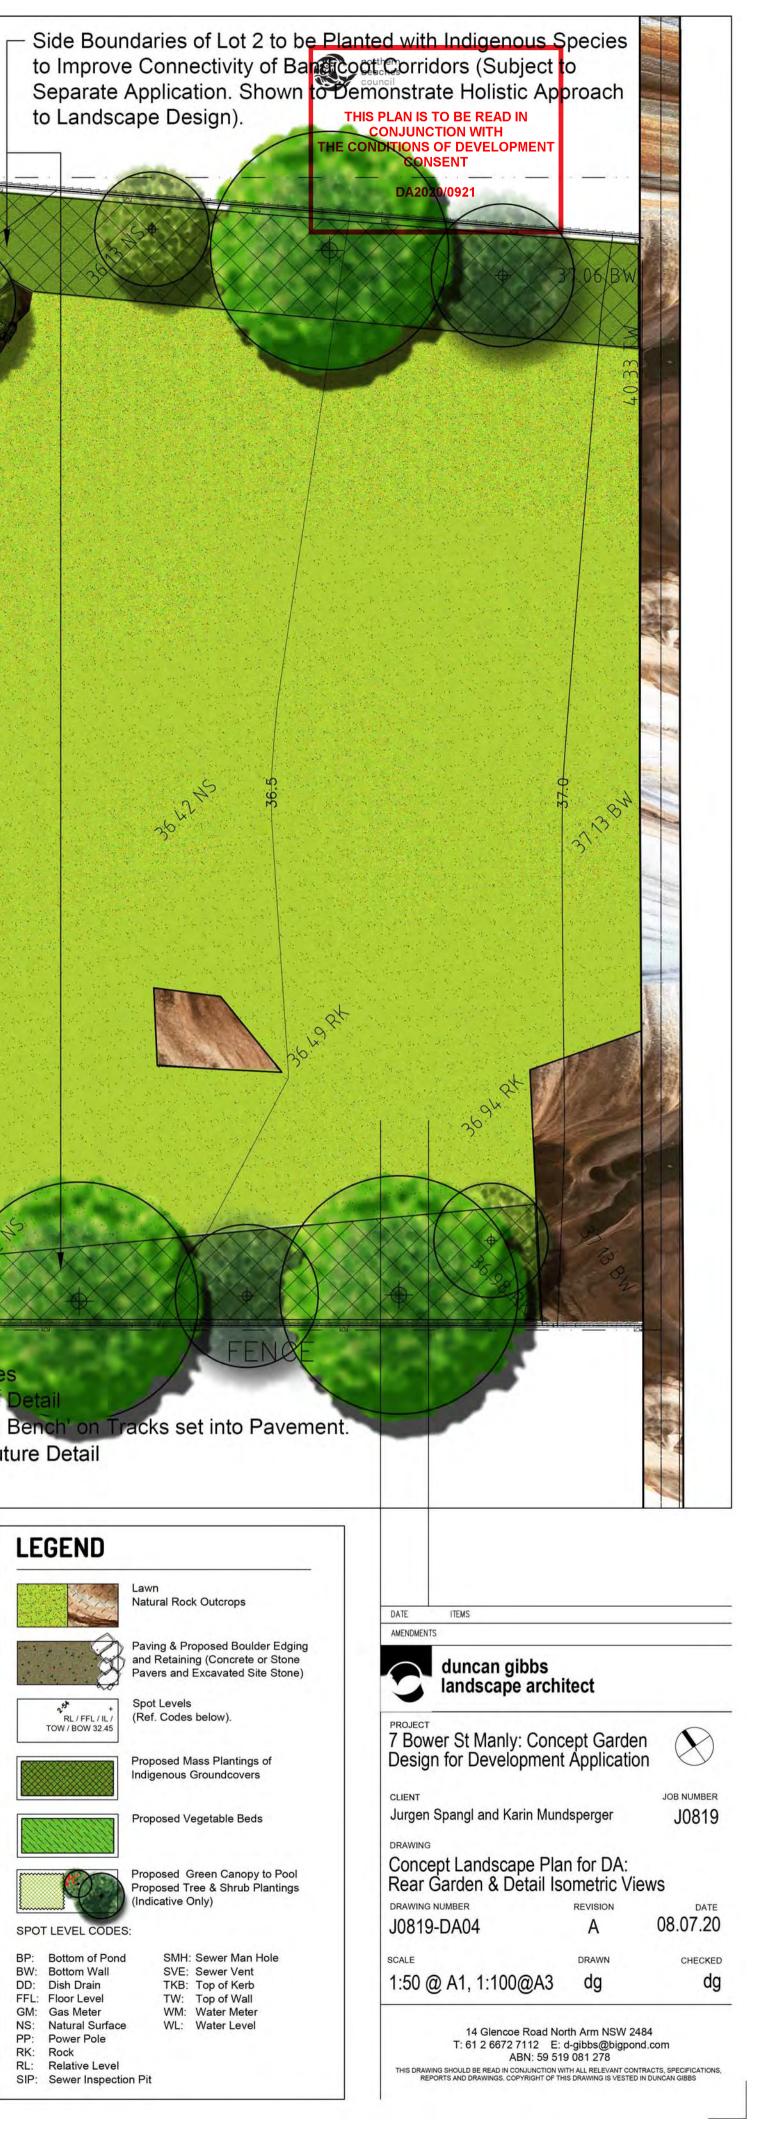


Clients:	TIVE PLANT SCHEDULE Jurgen Spangl and Karin Mu	Indsperger		RT: Roof Top/ Green Canopy, F CY: Courtyards, GC: Green Car		
ode	Botanical Name	Common Name	Prob. Max. Height	Situation	Pot Size	Spacing
	TREES Allocasuarina littoralis Acacia longifolia	Black She Oak Sydney Golden Wattle	NB: all likely smaller 8m 6m	in planters depending on soil de RT, F, B RT	pth and width 25L Super tube	As Shown As Shown
CS LV	Acmena smithii Allocasuarina verticillata	Broad-leaf Lillypilly Drooping She-oak	4m 6m	S, RT, F, B RT, F, B	25L Super tube	As Shown As Shown As Shown
NC	Angophora costata	Smooth-barked Apple	15m	Feature, B, F	45L	As Shown
NH	Angophora hispida	Dwarf Apple	6m	Feature, F, B, RT, GC	Super tube	As Shown
AM	Backhousia myrtifolia	Grey Myrtle	10m	S, RT, F, B	45L	As Shown
AI	Banksia integrifolia	Coastal Banksia	10m	Feature, F, B, RT, GC	45L	As Shown
EG	Ceratopetalum gummiferum	NSW Christmas Bush	6m	Feature, F, B, RT	200mm	As Shown
UA	Cupaniopsis anarcardioides	Tuckeroo	6m	RT, F, B, GC	45L	As Shown
LR	Elaeocarpus reticulatus	Blueberry Ash	8m	RT, F, B, GC	45L	As Showr
NS	Endiandra sieberi	Hard Corkwood	12m	RT, F, B, GC	Super tube	As Showr
IC	Ficus coronata	Creek Sandpaper Fig	8m	RT, F, B, GC	Super tube	As Showr
CO YP	Schizomeria ovata Syzigium paniculatum	Crab Apple Magenta Lilly Pilly	6m 10m	RT, F, B RT, F, B RT, F, B	150mm 150mm	As Shown As Shown As Shown
	PALMS					
IA	Livistona australis SHRUBS	Cabbage Palm	15m	Feature, F, B	100L	As Shown
CL	Acacia linifolia	Flax-Leaved Wattle	3m	RT, F, B	Super tube	As Shown
CSU	Acacia suaveolens	Sweet-scented Wattle	2m	RT, F, B	Super tube	As Shown
CT	Acacia terminalis	Sunshine Wattle	3m	RT, F, B	Super tube	As Shown
OE	Aotus ericoides	Yellow Flowered Aotus	2m	RT, F, B	Super tube	As Shown
4E	Banksia ericifolia	Heath Banksia	3m	RT, F, B	250mm	As Showr
40	Banksia oblongifolia	Fern Leaved Banksia	3m	RT, F, B	250mm	As Showr
AR	Banksia robur	Swamp Banksia	2m	RT, F, B	250mm	As Showr
AS	Banksia serrata	Saw toothed Banksia	3m	RT, F, B	25L	As Showr
ASP AC OR	Banksia spinulosa Callistemon citrinus Correa reflexa	Hairpin Banksia Crimson Bottlebrush	1m 4m	RT, F, B Feature, F, B, RT RT, F, B	25L 150mm	1000mm As Showr 600mm
RS IR	Crowea saligna Dillwynia retorta	Common Correa Crowea Eggs and Bacon	1m 1m 2m	RT, F, B RT, F, B RT, F, B	150mm 150mm Super tube	600mm 600mm 1000mm
PL	Epacris longiflora	Native Fuschia	1m	Mass Plant, Feature, F, B, RT	Super tube	500mm
PM	Epacris microphylla	Coral Heath	1m	Mass Plant, Feature, F, B, RT	Super tube	500mm
RB	Grevillea buxifolia	Grey Spider flower	1.5m	Feature, F, B, RT	250mm	1000mm
RL	Grevillea linearifolia	White spider flower	1m	Feature, F, B, RT	250mm	600mm
RS	Grevillea sericea	Pink spider flower	1.5m	Feature, F, B, RT	250mm	1000mm
RSP	Grevillea speciosa	Red spider flower	1.5m	Feature, F, B, RT	250mm	1000mm
JA	Kunzea ambigua	White Flowering Kunzea	2m	RT, F, B	Super tube	1000mm
EL	Leptospermum laevigatum	Coastal Tea Tree	3m	RT, F, B	Super tube	As Showr
P	Leptospermum petersonii	Lemon Scented Tea-tree	3m	RT, F, B	Super tube	As Showr
S	Leptospermum squarrosum	Pink Tea-Tree	2m	RT, F, B	Super tube	As Showr
ET	Leptospermum trinervium	Paper bark Tea-tree	2m	RT, F, B, CY	Super tube	As Showr
EE	Melaleuca ericifolia	Swamp Paperbark	4m	RT, F, B	Super tube	As Showr
EH	Melaleuca hypericifolia	Melaleuca	2m	RT, F, B	Super tube	As Showr
EL	Melaleuca linearifolia	Snow in Summer	3m	Feature, F, B, RT	Super tube	As Showr
ZD EL	Ozothamnus diosmifolius Persoonia levis Pimelea linifolia	Everlasting Daisy Broad-Leaved Geebung	1.5m 1.5m	RT, F, B RT, F, B Mass Plant PT F B	Tube Tube	800mm As Shown
(L (T	Pimelea linifolia Pittosporum revolutum Platylobium formosum ssp.	Rice flower Rough-fruit pittosporum Flat-pea	1m 2m 1m	Mass Plant, RT, F, B RT, F, B RT, F, B	Super tube 150mm	500mm 1000mm
F S	formosum Polyscias sambucifolia	Elderberry Panex	3m	кт, г, в RT, F, B, СҮ	Super tube	500mm 1000mm
JS RD JE	Prostanthera denticulata Pultenaea elliptica	Native Mint Bush Elliptical Bush-pea	1m 1m	Mass Plant, RT, F, B RT, F, B	Super tube	1000mm 500mm
JF	Pultenaea flexilis	Graceful bush-pea	3m	RT, F, B	Super tube	As Shown
JS	Pultenaea stipularis	Fine-leaf Bush-pea	2m	RT, F, B	Super tube	800mm
P	Ricinocarpus pinifolius	Wedding Bush	2m	RT, F, B	Super tube	1000mm
PD	Syzigium paniculatum "dwarf"	Brush Cherry	3m	RT, F, B, CY, S	150mm	1000mm
ES	Telopea speciosissima	Waratah	3m	Feature, F, B, RT	25L	1500mm
IJ	Viminaria juncea	Native Broom	3m	RT, F, B		800mm
/EF	Westringia fruticosa	Coast Westringia	2m	Mass Plant, RT, F, B	150mm	800mm
AA	Xanthorrhoea australis	Grass Tree	2m	RT, F, B	25L	As Showr
СН	GRASSES & GROUNDCOVERS Actinotus helianthi	Flannel Flower	1m	Mass Plant, RT, F, B	Tube	500mm
	Bossiaea heterophylla Carex appressa	Variable Bossiaea Native Sedge	800mm 700mm	Mass Plant, RT, F, B Mass Plant, RT, F, B Mass Plant, RT, F, B	Tube Tube Tube	500mm 500mm 400mm
AG AF	Carpobrotus glaucescens Caustis flexuosa	Pig Face Curly wigs	150mm/Creeper 1000mm	Mass Plant, RT, F, B Mass Plant, RT, F, B Mass Plant, RT, F, B	150mm Tube	800mm 400mm
YR	Cymbopogon refractus	Barbed-wire Grass	500mm	Mass Plant, RT, F, B	Tube	400mm
AS	Danthonia species	Wallaby Grass	400mm	Mass Plant, RT, F, B	Tube	300mm
IC	Dianella caerulea	Blue Flax Lily	400mm	Mass Plant, RT, F, B	Tube	300mm
IR	Dichondra repens	Kidney weed	50mm	Mass Plant, RT, F, B	Tube	300mm
CC	Echinopogon caespitosus	Tufted Echidna Grass	1200mm	Mass Plant, RT, F, B	Tube	400mm
RB	Eriostemon buxifolius	Box-leaf Wax Flower	500mm	Mass Plant, RT, F, B	Tube	300mm
IN	Ficinia nodosa	Knobby Club Rush	500mm	Mass Plant, RT, F, B	Tube	300mm
CM	Imperata cylindrica var. major	Imperata	500mm	Mass Plant, RT, F, B	Tube	800mm
ER	Kennedia rubicunda	Dusky Coral Pea	150mm/Creeper	Mass Plant, RT, F, B	Tube	1000mm
DA	Lobelia alata	Lobelia	300mm/Creeper	Mass Plant, RT, F, B	Tube	500mm
DM	Lomandra multiflora	Many Flowered Lomandra	500mm	Mass Plant, RT, F, B	Tube	300mm
DO	Lomandra obliqua	Fish bones	200mm	Mass Plant, RT, F, B	Tube	300mm
DL	Lomondra longifolia	Spiny-headed Mat-rush	1.5m	Mass Plant, RT, F, B	Tube	800mm
ET	Melaleuca thymifolia Microlaena stipoides var.	Thyme Scented Melaleuca Weeping rice grass	1m 400mm	Mass Plant, RT, F, B Mass Plant, RT, F, B	Super tube	1000mm
SS IS	stipoides Microlaena stipoides	Weeping Meadow Grass	400mm	Mass Plant, RT, F, B	Tube Tube	300mm 300mm
AS	Patersonia sericea	Silky Purple Flag	200mm	Mass Plant, RT, F, B	Tube	200mm
EA	Pelargonium australe	Coastal Geranium	500mm	Mass Plant, RT, F, B	Super tube	400mm
DA	Poa affinis	Tussock Grass	500mm	Mass Plant, RT, F, B	Tube	500mm
DU	Pomax umbellata	Pomax	400mm	Mass Plant, RT, F, B	Tube	300mm
CR	Scaevola ramosissima	Purple Fanflower	150mm/Creeper	Mass Plant, RT, F, B	Super tube	800mm
HA	Themeda australis	Kangaroo grass	500mm	Mass Plant, RT, F, B	Tube	300mm
AP	Xanthosia pilosa	Woolly Xanthosia	500mm	Mass Plant, RT, F, B	Tube	300mm
IH	Viola hederacea	Native Violet	50mm	Mass Plant, RT, F, B	Tube	250mm
	CLIMBERS & CASCADING PLANTS					
S	PLANTS Billardiera scandens Cissus antarctica	Apple Berry Water Vine	3m 4-6m	Mass Plant, RT, F, B, GC RT, CY, GC (Shade/Semi	150mm	As Showr
IA IH	Cissus hypoglauca	Native Grape	2-20m	Shade) RT, GC (vigorous climber)	150mm Super tube	As Showr As Showr
_A	Clematis aristata	Toothed Clematis	4-6m	RT, CY, GC (Shade/Semi Shade)	150mm	500
_G	Clematis glycinoides	Headache Vine	2-15m	RT, CY, GC (Moist soils)	150mm	As Showr
IR	Dichondra repens 'Silver Falls'	Dichondra Silver Falls	50mm	Mass Plant, RT, F, B	Tube	500mm
	Eustrephus latifolius	Wombat Berry	2-6m	RT, GC	Super tube	As Showr
	Glycine clandestina	Love Creeper	2m	RT, F, B, CY	Super tube	1000mm
AV	Hardenbergia violacea	False Sarsaparilla	2m	RT, CY	Super tube	1000mm
IS	Hibbertia scandens	Climbing Guinea Flower	2m	RT, F, B	Super tube	800mm
DA DJ	Hoya australis Morinda jasminoides	Common waxflower Jasmine Morinda	2m 2m	RT, CY RT, CY, GC (Shade/Semi Shade)	200mm	800mm 1000mm
OJ AP MG	Pandorea pandorana Smilax glyciphylla	Wionga-wonga vine Native sarsaparilla	2-20m 2m	RT, GC (vigorous climber) Mass Plant, RT, F, B, GC	Super tube Super tube Super tube	As Showr 1000mm
	FERNS					
DA	Adiantum aethiopicum	Common Maidenhair Fern	300mm	CY (shade)	150mm	200mm
GN	Asplenium nidus	Birds Nest Fern	600mm	CY (shade)	200mm	800mm
LC	Blechnum cartilagineum	Gristle Fern	500mm	CY (shade)	150mm	400mm
LN	Blechnum nudum	Water Fern	500mm	CY (shade)	150mm	300mm
	Calochlaena dubia Cyathea australis	Soft Bracken Rough Tree Fern	800mm 5m	F, B, CY (Shade/Semi Shade) CY (shade)	250mm	1000mm
DA	Doodia aspera	Rasp Fern	500mm	CY (shade)	150mm	400mm
_D	Gleichenia dicarpa	Pouched Coral Fern	2m (trailing)	F, B, CY, GC	Tube	500mm
TF	Sticherus flabellatus WETLAND PLANTS	Umbrella Fern	500mm/Creeper	CY (shade)	150mm	400mm
٩T	Baloskion tetraphyllum(Syn. Restio tetraphyllus)	Tassel Cord Rush	1m	Ponds/Reed Beds	Tube	350mm
AA	Baumea articulata	Jointed Twig-rush	1.5m	Ponds/Reed Beds	Tube	500mm
AJ	Baumea juncea	Bare Twigrush	1m	Ponds/Reed Beds	Tube	500mm
٩A	Carex appressa	Native Sedge	700mm	Mass Plant, RT, F, B, Wet areas	Tube	400mm
JK	Juncus kraussii Juncus kraussii subsp.	Sea Rush Sea Rush	1m 1m	Ponds/Reed Beds Ponds/Reed Beds	Tube	500mm
<a< td=""><td>australiensis</td><td>1</td><td>I</td><td>1</td><td>Tube</td><td>500mm</td></a<>	australiensis	1	I	1	Tube	500mm







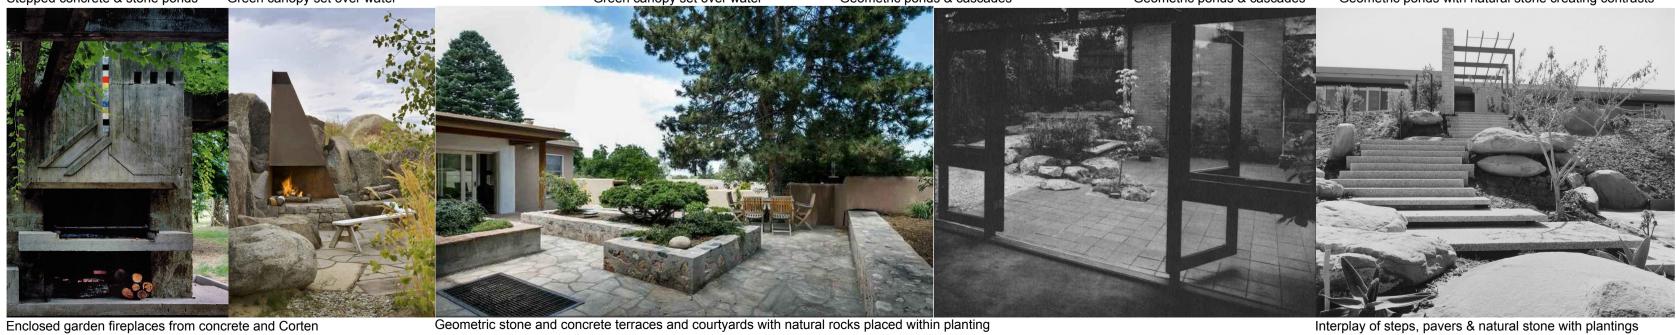

LANDSCAPE DESIGN THEMES AND INDICATIVE LANDSCAPE MATERIALS PALETTE

Interplay of steps, pavers & natural stone with plantings

DATE	ITEMS		
AMENDMEN	TS		
\odot	duncan landsca	gibbs ape architect	
	ver St Mai	nly: Concept Garden elopment Application	\bigcirc
CLIENT Jurgen	n Spangl and	Karin Mundsperger	JOB NUMBER
Conce Indica	ept Lands	cape Plan for DA: ing & Materials Palett	е
	9-DA05	REVISION	DATE 08.07.20
SCALE		DRAWN	CHECKED
NTS	@ A1	dg	dg

14 Glencoe Road North Arm NSW 2484 T: 61 2 6672 7112 E: d-gibbs@bigpond.com ABN: 59 519 081 278 THIS DRAWING SHOULD BE READ IN CONJUNCTION WITH ALL RELEVANT CONTRACTS, SPECIFICATIONS, REPORTS AND DRAWINGS. COPYRIGHT OF THIS DRAWING IS VESTED IN DUNCAN GIBBS



Stellen Consulting Level 1, 27 Belgrave Street Manly NSW 2095

PO Box 151 Freshwater NSW 2096 beaches council +61 450 460 496 tel ABN 61 149 095 189 THIS PLAN IS TO BE READ IN CONJUNCTION WITH THE CONDITIONS OF DEVELOPMENT CONSENT

northern

DA2020/0921

23 July 2020

Jurgen Spangl & Karin Mundsperger 7 Bower Street Manly NSW 2095

c/o ryan@cplusc.com.au

Stormwater design in support of the proposed development at 7 Bower Street, Manly

Dear Jurgen and Karin

Please find attached the drawings describing the stormwater management plan for the proposed development at 7 Bower Street, Manly.

The stormwater management plan is described in the following Stellen Consulting drawings:

DR-000	Revision 0	Legend
DR-001	Revision 0	Pipe Layout
DR-002	Revision 0	Details
DR-003	Revision 0	Site Areas

The stormwater management plan conforms to the relevant requirements of the following:

- Australian Standard AS3500.3 (2018) "Plumbing and Drainage: Part 3 Stormwater Drainage"
- Northern Beaches Council (Manly) "Specification for On-site Stormwater Management" (as amended September 2004)

We recommend the stormwater design (as described in the drawings) as a safe and practical solution to support the development.

Kind regards,

YassER

Drawing List

Architectural Drawings by CplusC Architectural Workshop from DA 000 to DA 020 all dated 23/07/2020.

Yasser Yahya Al-Ashmori Engineer

Stellen Consulting Level 1, 27 Belgrave, Manly, NSW 2095 T. +60137-065430 E. yasser.alashmori@stellenconsulting.com.au




<u>7 BOWER STREET, MANLY</u> STORMWATER MANAGEMENT PLAN

DRAWING NUMBER	DRAWING TITLE
DR-000	LEGEND
DR-001	PIPE LAYOUT
DR-002	DETAILS
DR-003	SITE AREAS

NOTES:

- 1. ALL DIMENSIONS TO BE CONFIRMED ON SITE PRIOR TO CONSTRUCTION.
- 2. SITE LAYOUT BASED ON ARCHITECTURAL PLANS BY CPLUSC ARCHITECTURAL WORKSHOP (23/07/2020).
- 3. LOCATION OF ALL SERVICES MUST BE CONFIRMED ON SITE PRIOR TO COMMENCEMENT OF EXCAVATION WORKS.
- 4. ALL STORMWATER DRAINAGE PIPES AND ASSOCIATED DEVICES ARE TO BE INSTALLED IN ACCORDANCE WITH THE RELEVANT STANDARDS, THE BUILDING CODE OF AUSTRALIA, MANUFACTURER'S RECOMMENDATIONS, SYDNEY CATCHMENT AUTHORITY RECOMMENDED PRACTICE, AND LOCAL COUNCIL, AS APPLICABLE.
- ALL INVERT LEVELS PROVIDED ON THIS DRAWING ARE REDUCED TO AHD AND BASED ON INTERPOLATED SURFACE LEVELS AND SYSTEM REQUIREMENTS

- WHERE POSSIBLE, PIPEWORK SHALL BE LOCATED EXTERNAL TO THE BUILDING.
- DOWNPIPES AND STORMWATER LINES TO BE SEALED DN100 uPVC UNLESS OTHERWISE NOTED.
- 8. STORMWATER PIPES TO BE GRADED AT A MINIMUM 1% UNLESS NOTED OTHERWISE.
- 9. ALTERNATIVE GUTTER AND DOWNPIPE CONFIGURATION MAY BE INSTALLED PROVIDED IT COMPLIES WITH AS3500.
- 10. ALL PIPE AND CONDUITS TO BE MARKED IN ACCORDANCE WITH AS1345 - 1995.
- 11. TRENCHES AND SERVICE SEPARATIONS IN ACCORDANCE WITH AS/NZS 5601, AS/NZS 3500, AND AS/CA S009.

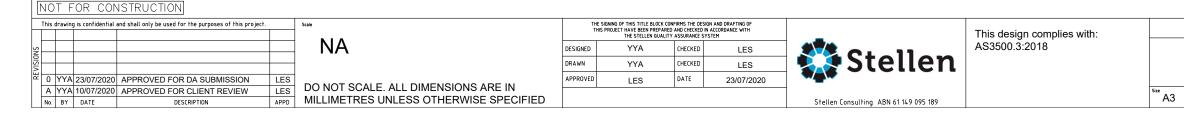

LEGEND:




DOWNPIPE


STORMWATER PIPE


RAINWATER PIPE


DRAINAGE PIT

7 BOWER STREET,	MANLY	
LEGEND		
Status APPROVED FOR DA SUBMISSION	Drg No. DR-00	0 Rev.
-		•

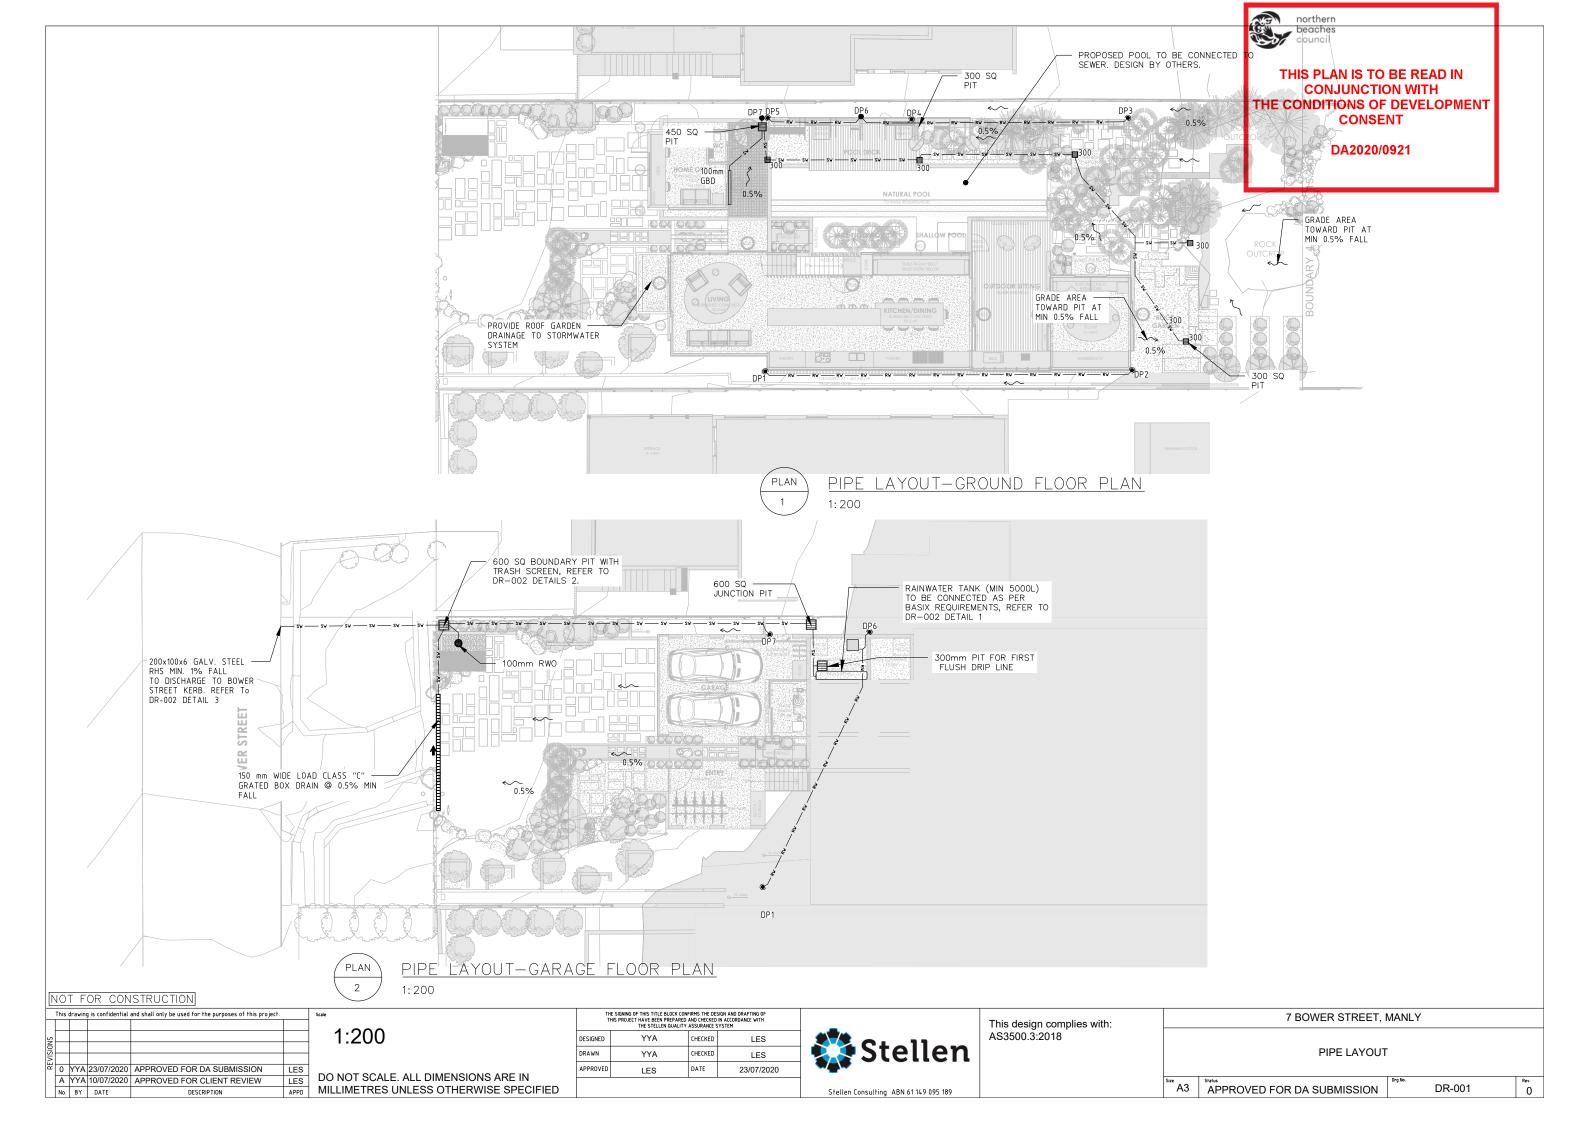

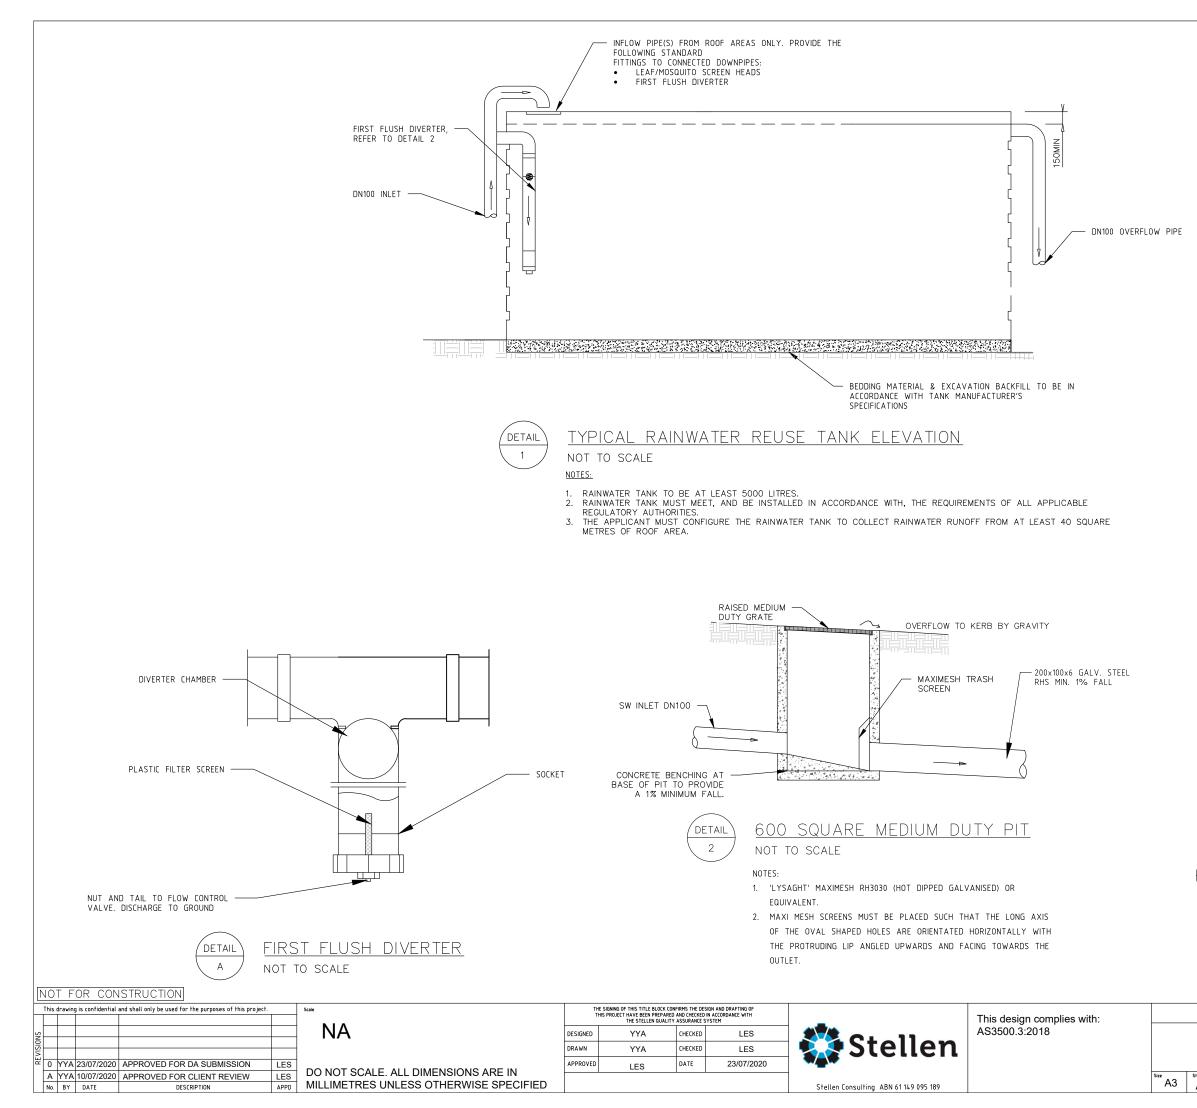

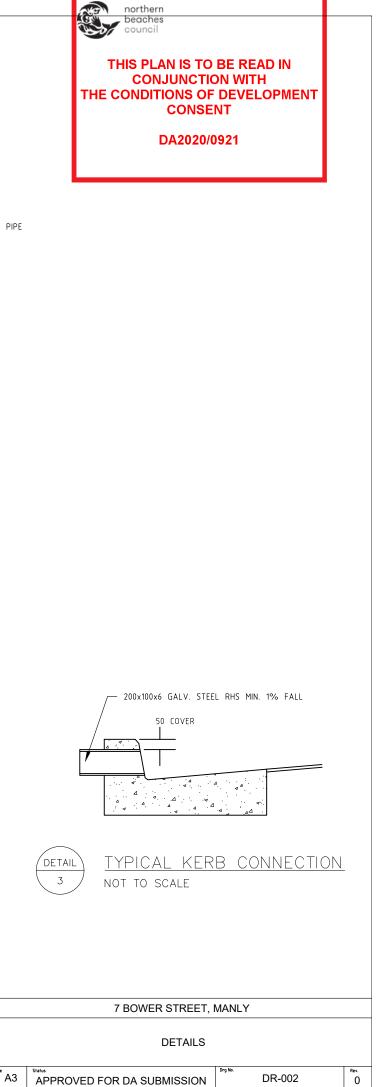

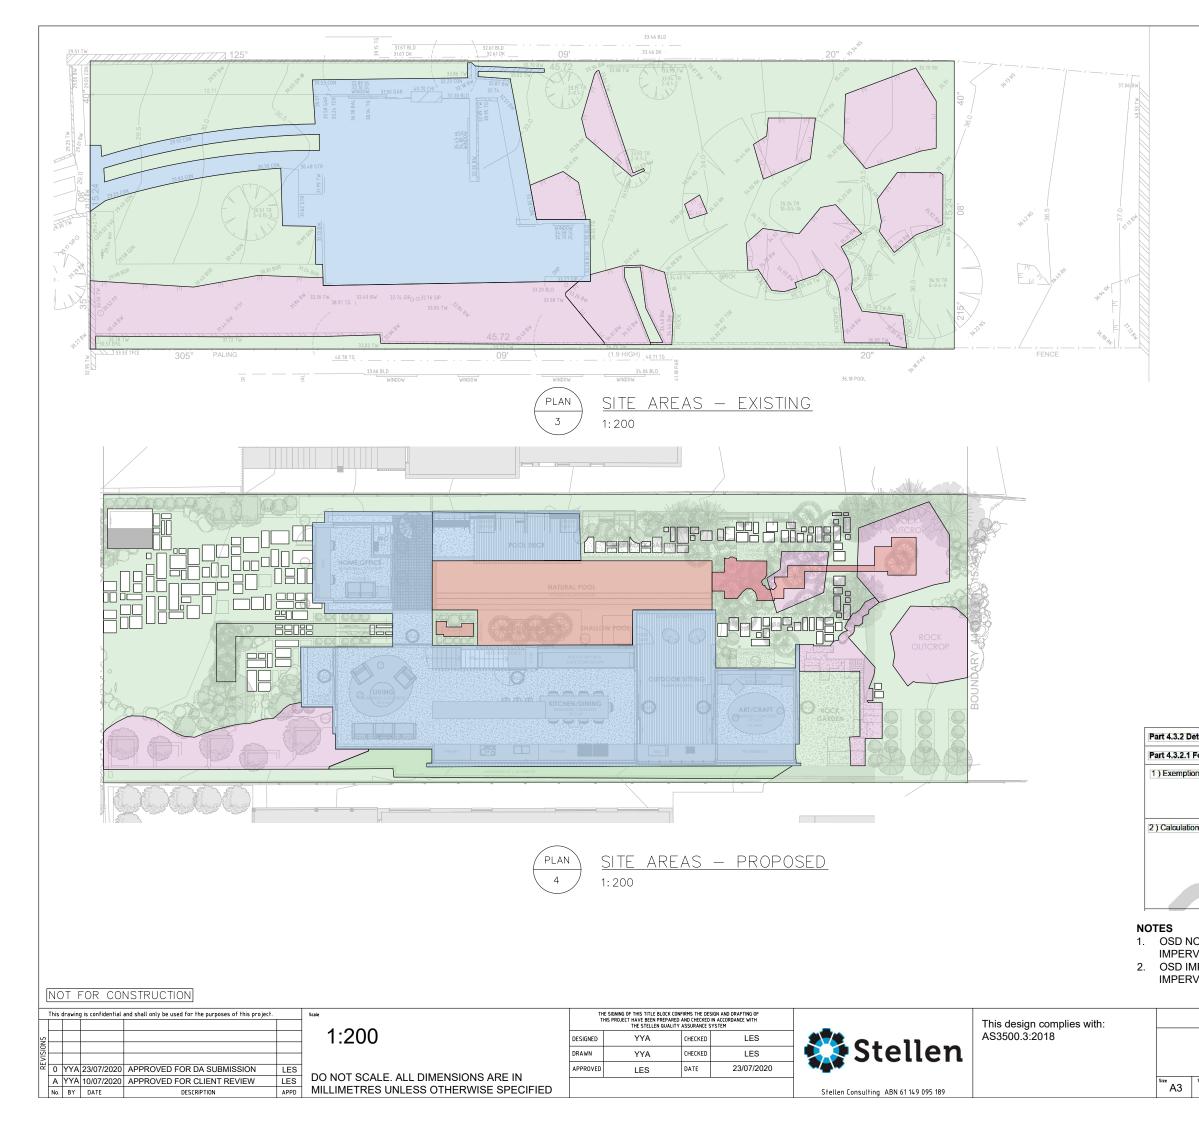

		northern			
		council			
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