PROPOSED RESIDENCE Lot 80, DP 11784 12 Ingleside Road, **INGLESIDE NSW 2101**

DEVELOPMENT APPLICATION

GENERAL SPECIFICATIONS

Builder, sub-contractor to check all dimensions on site prior to commencement of any works.

Provide rubble access throughout construction period to council requirements.

Demolition works to be carried out in accordance with as 2601. All excavation, demolition works to be carried out in a careful systematic manner to avoid damage to excess structures.

All brickwork to comply with AS3700 masonry in buildings.

Provide vertical articulation control joint in brickwork to comply with part 3.3.1.8 of BCA

Provide tree protection measures to trees to be retained in accordance with council requirements.

Refer to Engineers details & specifications for all structural works.

All roof water and storm-water runoff to be connected to a council approved system of collection and/or disposal.

All sewer waste to be connected to the existing mains service in accordance with as 3500.

All pre-fabricated timber trusses and frames to utilize sustainable plantation timbers installed to the manufacturer's detail and specification.(for more detail refer to main specification provided with tender documents)

All timber works to comply with AS1684 national timber framing code.

All concrete slabs, retaining walls, structural steel, foundations and footings to be designed & specified by the consulting structural engineer and built strictly in accordance with such details, as approved.

Plumbing services to be carried out only by licensed tradespersons and in accordance with AS3500.3.2, AS3500.2.2, AS3500.1.2, AG 601 and other associated standards and codes.

Contractor to ensure selected tiles, fittings, etc, are appropriate and suitable for each application.

All insulation to be provided and installed in accordance with AS4859.1, AS3999 (bulk insulation), AS1904 (foil insulation) and associated standards and codes.

Any proposed variations to the details supplied in these documents must be discussed with and approved by Construction by Design Pty Ltd in writing, before the contractor orders or installs the relevant materials or systems.

The contractor must ensure that all proprietary systems and materials used in the construction of these works will be compatible with the details provided by Construction by Design Pty Ltd.

All measurements shown and scheduled are nominal, the contractor shall check all measurements on site before ordering materials and check any anomalies with Construction by Design Pty Ltd before proceeding.

Nibs to internal doorways to allow 100mm min. Clearance to architrave and where this is not possible discuss approved alternative with Construction by Design Pty Ltd.

Provide matching insect screens as approved to all opening window sashes.

Where compliant natural ventilation is not provided to bathrooms, ensuites, wcs, laundries and the like, the room must be provided with mechanical ventilation as per BCA clause 3.8.5.2.



200mn


APPROACH FACADE





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| 13 | LIGHTING PLAN (FF) |
|-------|----------------------|
| 12 | LIGHTING PLAN (GF) |
| 11 | WINDOW SCHEDULE |
| 10 | WINDOW SCHEDULE |
| 9 | BUSHFIRE |
| 8 | ELEVATION & SECTIONS |
| 7 | ELEVATIONS |
| 6 | ELEVATIONS |
| 5 | ROOF PLAN |
| 4 | FIRST FLOOR |
| 3 | GROUND FLOOR |
| 2.2 | SHADOW DIAGRAMS |
| 2.1 | LANDSCAPE PLAN |
| 2 | SITE PLAN |
| 1 | COVER |
| SHEET | DESCRIPTION |

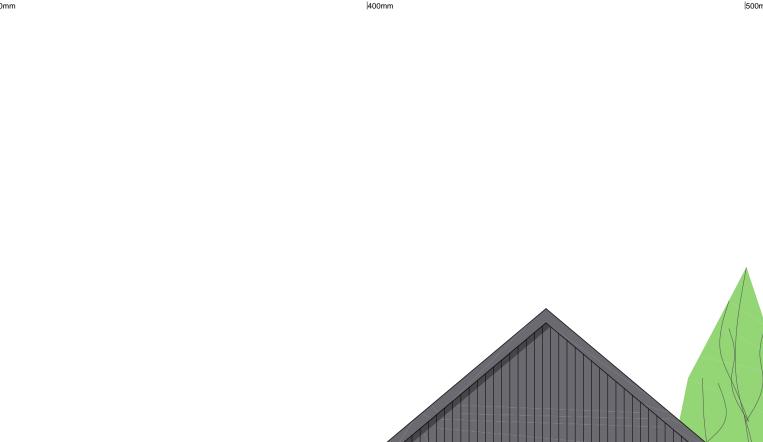

Certificate no .: Assessor Name: Accreditation no .: Certificate date: 31 Jul 2016 Dwelling Address: 12 Ingleside Road INGLESIDE, NSW 2101

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0000568618


Brad Hoad

20731





sheet

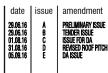






PROPOSED DOUBLE STOREY RESIDENCE LOT 80, DP 11784, 12 INGLESIDE ROAD **INGLESIDE NSW 2101**

| drawin | g title | | | |
|-------------|----------|---------|----|-------------|
| COVER SHEET | | | | |
| date | 03.06.16 | drawn | LR | N -1 |
| | CBD3028 | checked | LW | |
| scale | NTS @ A2 | | | |

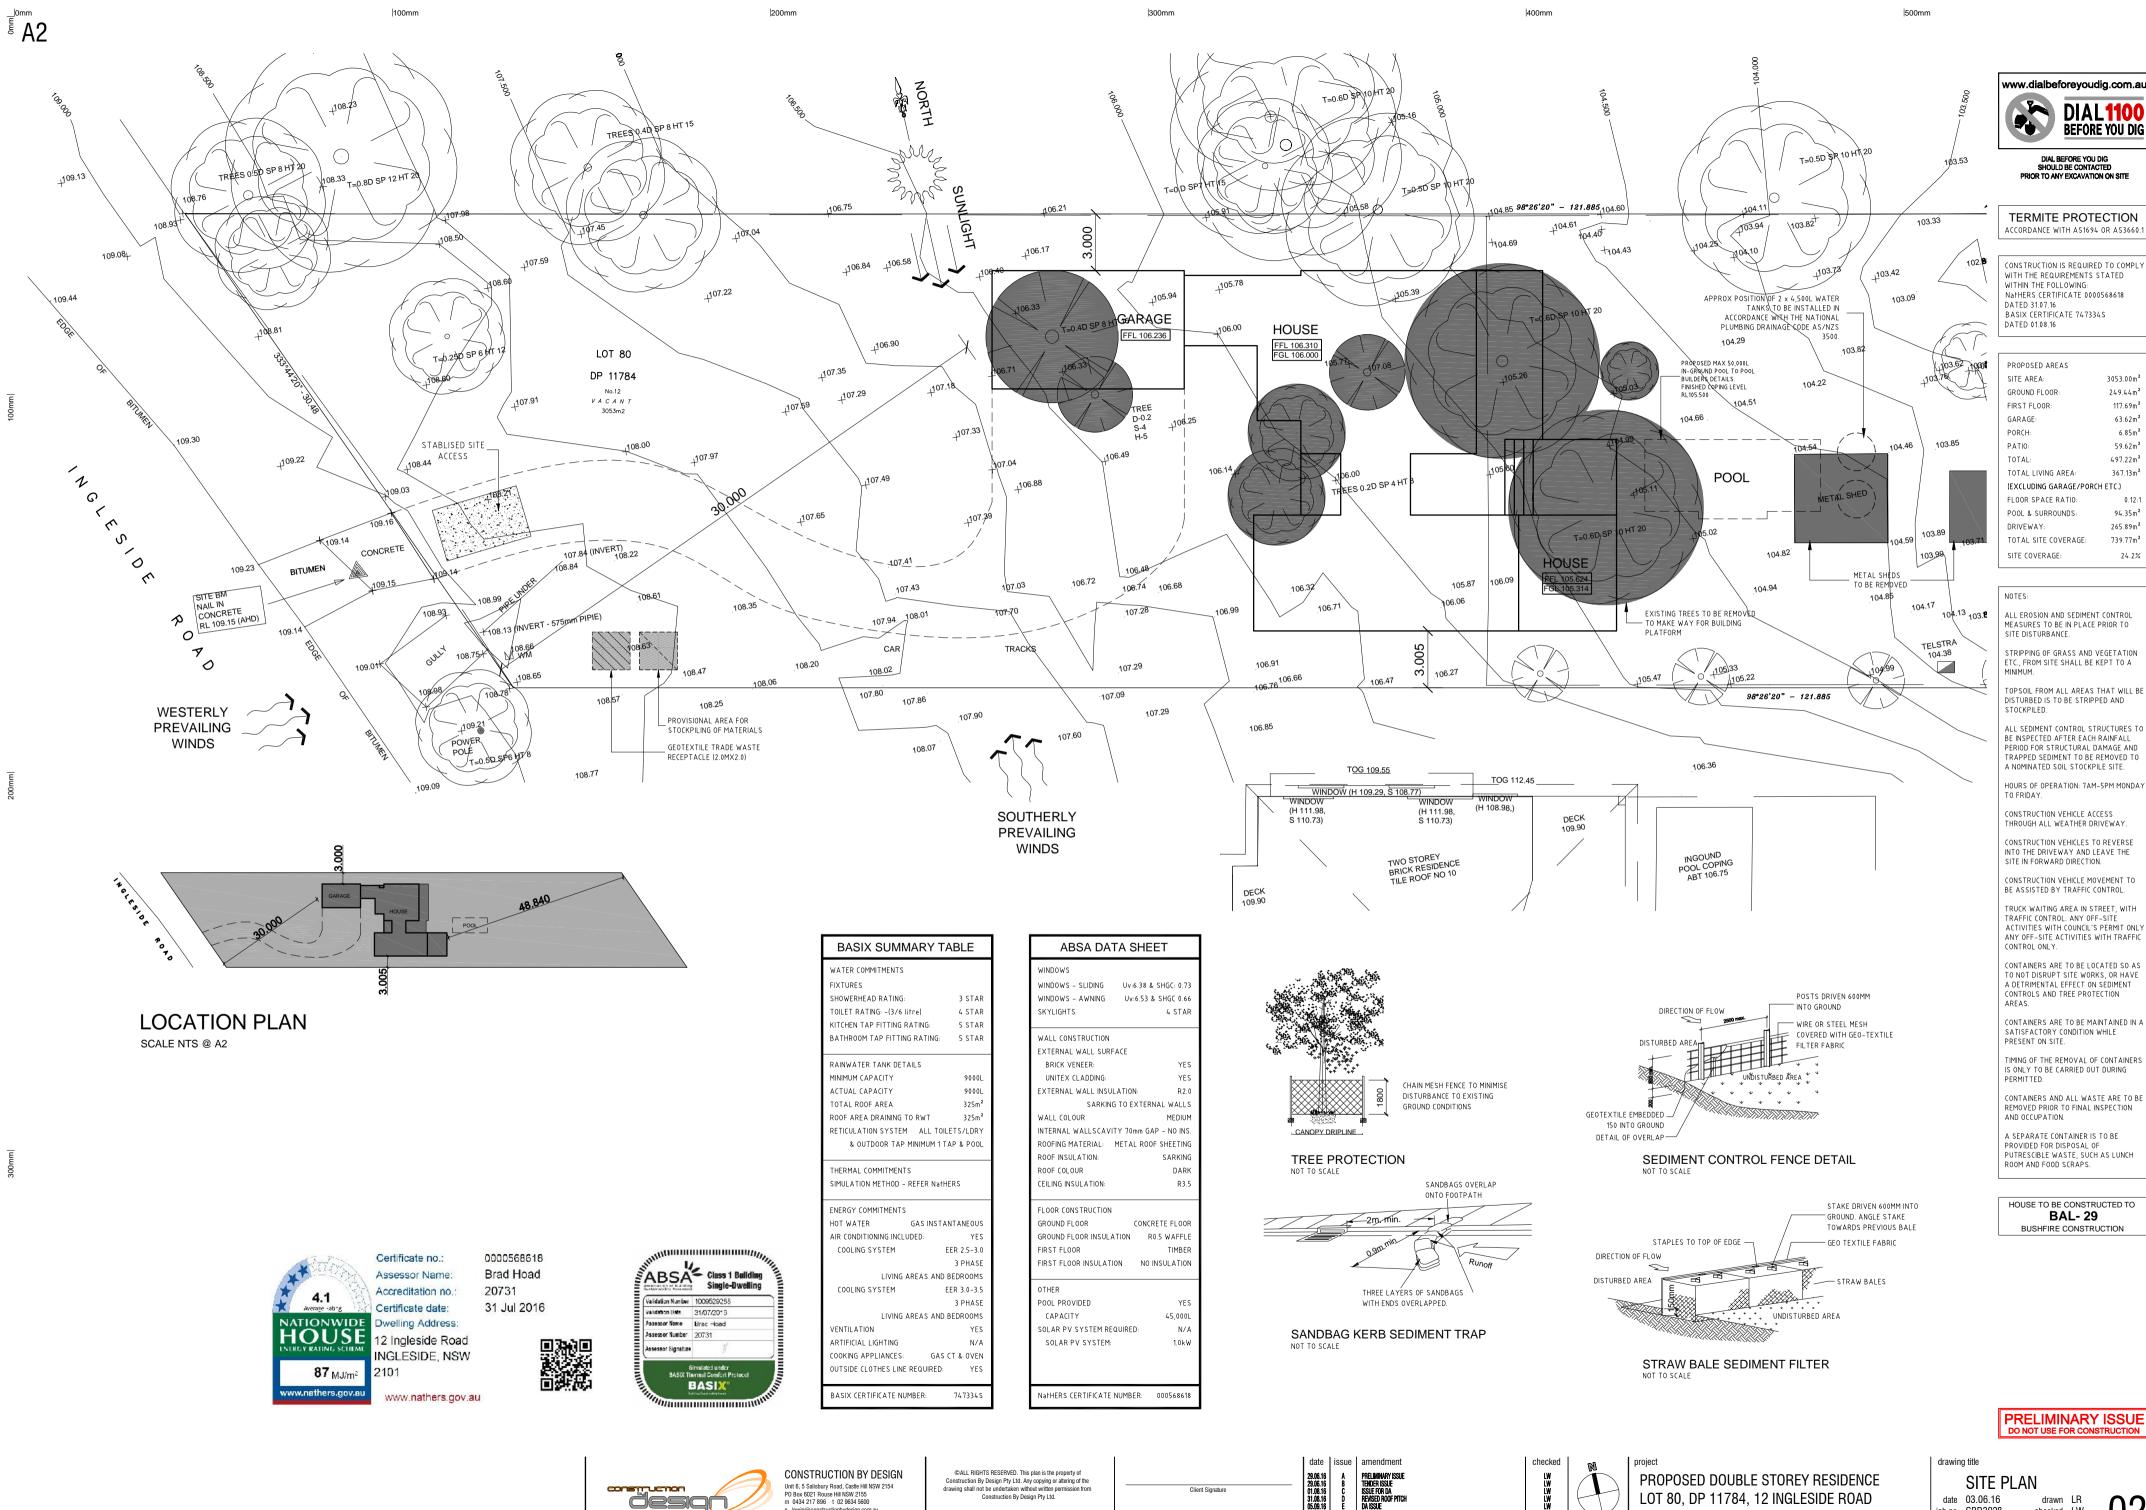

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SITE PLAN date 03.06.16 drawn LR

checked LW

job no CBD3028

scale 1:200 @ A2

LOT 80, DP 11784, 12 INGLESIDE ROAD

INGLESIDE NSW 2101

02 sheet

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NORTH BOUNDARY

DP


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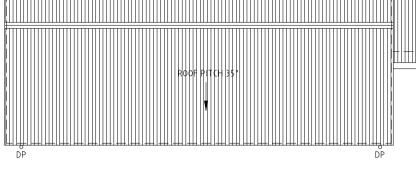
ROOF PITCH 1°


DP

DP

-

_ -

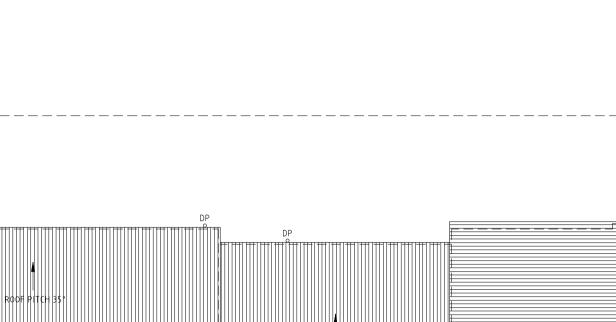

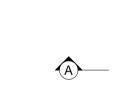



2SOUTH BOUNDARY



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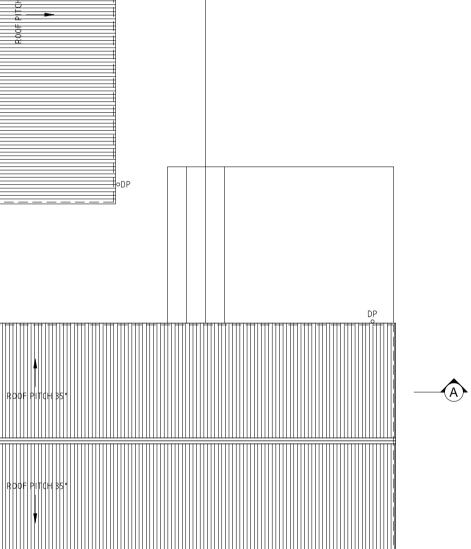


400mm

4

CONSTRUCTION IS REQUIRED TO COMPLY WITH THE REQUIREMENTS STATED WITHIN THE FOLLOWING: NaTHERS CERTIFICATE 000568618 DATED 3107.16 BASIX CERTIFICATE 747334S DATED 01.08.16

HOUSE TO BE CONSTRUCTED TO **BAL-29** BUSHFIRE CONSTRUCTION



—B



3


Certificate no .: Assessor Name: Accreditation no.: Certificate date: INGLESIDE, NSW

0000568618 Brad Hoad 20731 31 Jul 2016






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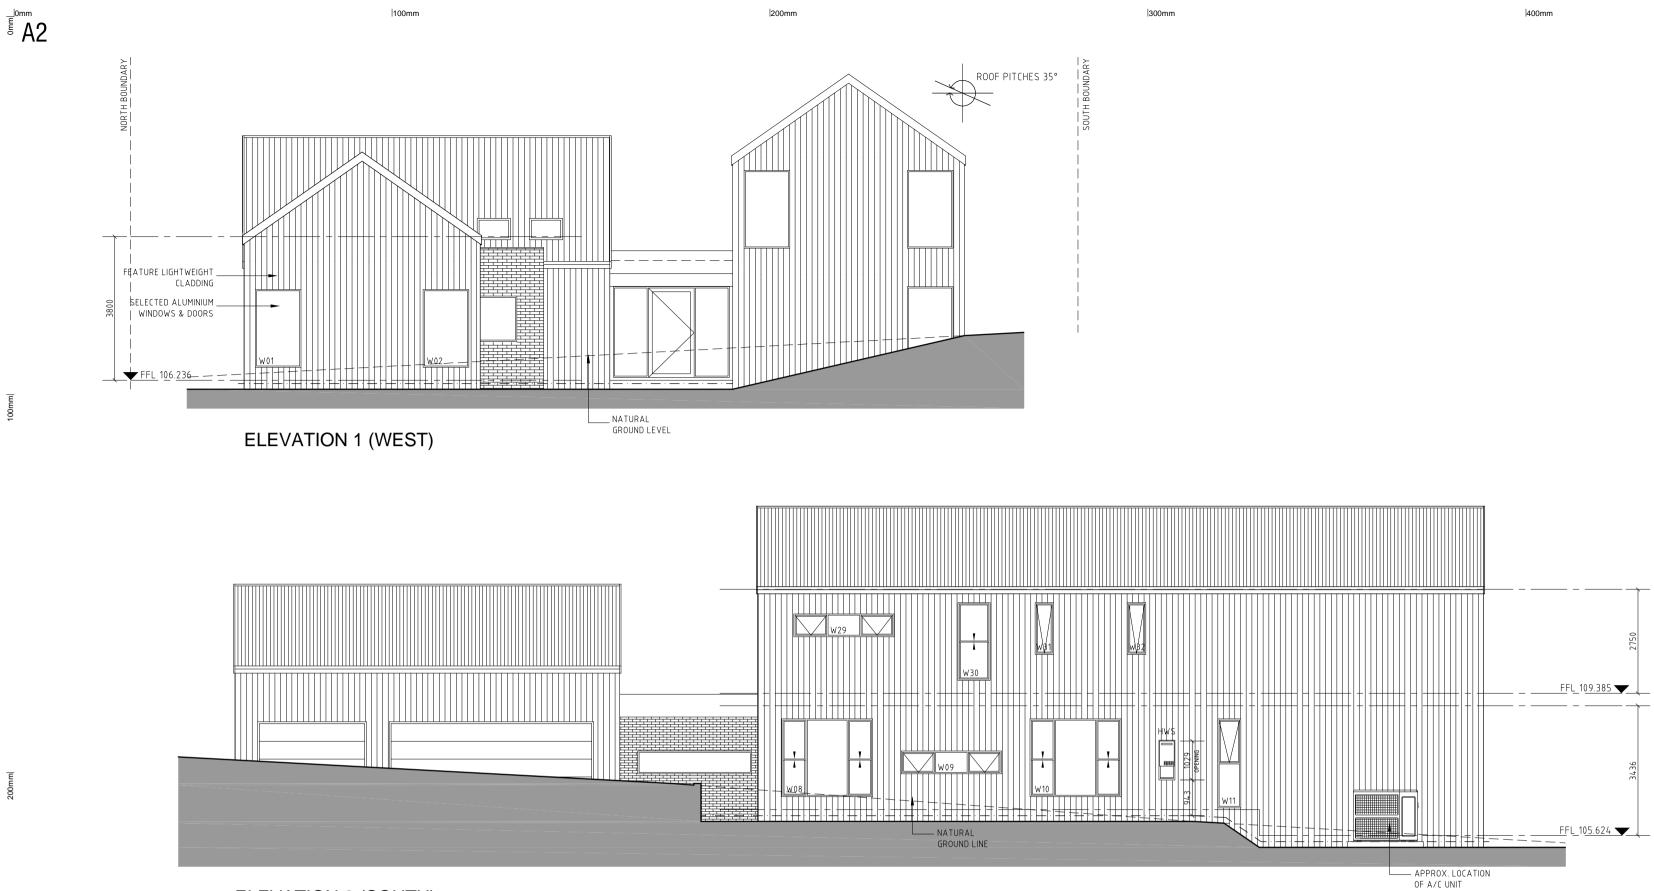


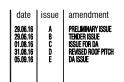
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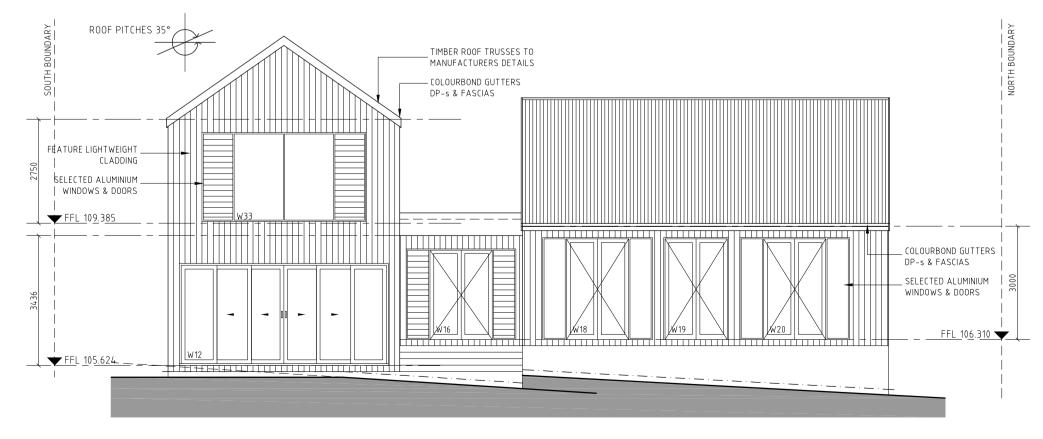
PROPOSED DOUBLE STOREY RESIDENCE LOT 80, DP 11784, 12 INGLESIDE ROAD **INGLESIDE NSW 2101**

drawing title ROOF PLAN date 03.06.16 drawn LR job no CBD3028 checked LW 055 sheet

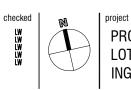





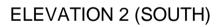

ELEVATION 3 (EAST)



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| PLATFORM DETAIL | | |
|-----------------|---|--|
| | - PROPOSED BUILDING OUT LINE. | |
| | 150mm BATTERED BACKFILL TO TOE OF SLAB, FROM BUILDING PLATFORM, (CENTRE LINE). | |
| | - EXCAVATED BUILDING PLATFORM, (SOLID LINE). | |
| | · · | |
| | – NATURAL GROUND LEVEL, (DASHED). | |

CONSTRUCTION IS REQUIRED TO COMPLY WITH THE REQUIREMENTS STATED WITHIN THE FOLLOWING: NaTHERS CERTIFICATE 0000568618 DATED 3107.16 BASIX CERTIFICATE 747334S DATED 01.08.16






Certificate no .: Assessor Name: Accreditation no .: Certificate date: INGLESIDE, NSW

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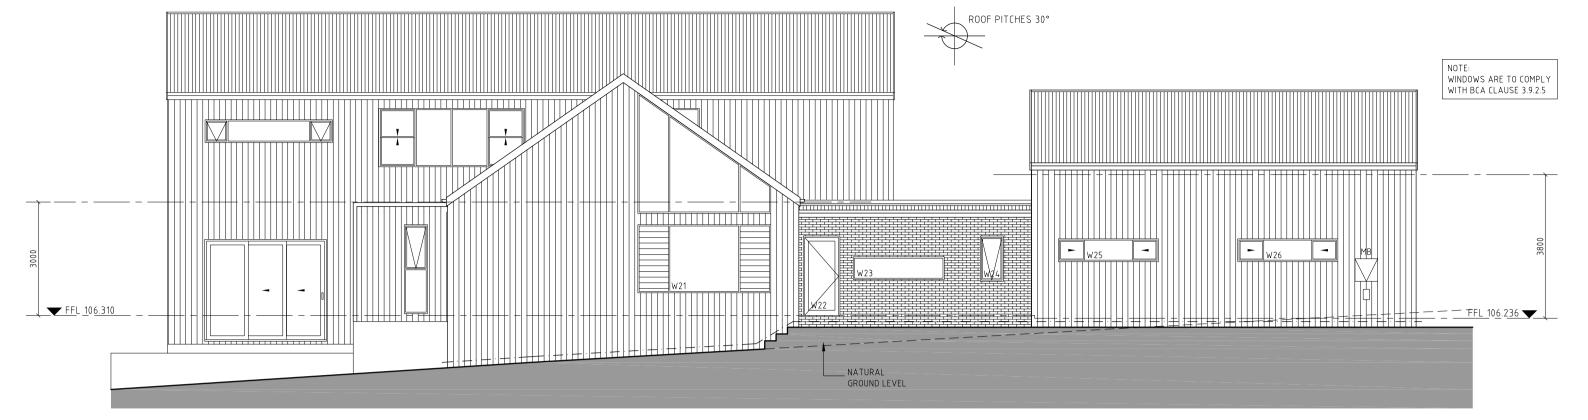
project PROPOSED DOUBLE STOREY RESIDENCE LOT 80, DP 11784, 12 INGLESIDE ROAD **INGLESIDE NSW 2101**


drawing title ELEVATIONS date 03.06.16 drawn LR job no CBD3028 checked LW scale 1:100 @ A2




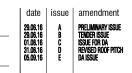


200mm



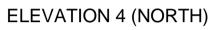

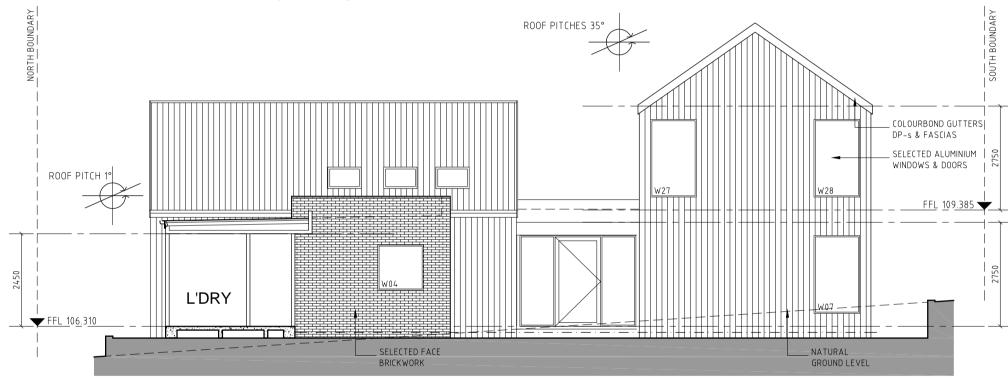



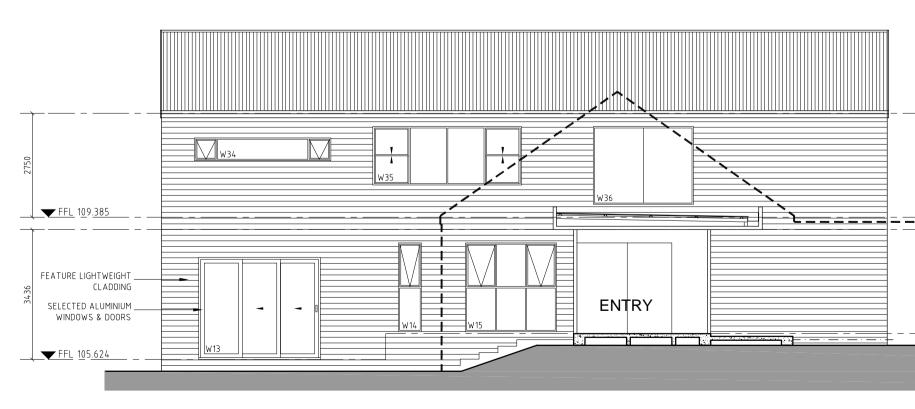





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500mm

| PLATFORM DETAIL | | |
|-----------------|---|--|
| | - PROPOSED BUILDING OUT LINE. | |
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| | - EXCAVATED BUILDING PLATFORM, (SOLID LINE). | |
| | | |
| Ť | – NATURAL GROUND LEVEL, (DASHED). | |


CONSTRUCTION IS REQUIRED TO COMPLY WITH THE REQUIREMENTS STATED WITHIN THE FOLLOWING: NaTHERS CERTIFICATE 0000568618 DATED 3107.16 BASIX CERTIFICATE 747334S DATED 01.08.16

HOUSE TO BE CONSTRUCTED TO BAL- 29 BUSHFIRE CONSTRUCTION

date 03.06.16 drawn LR job no CBD3028 checked LW


scale 1:100 @ A2

07 sheet

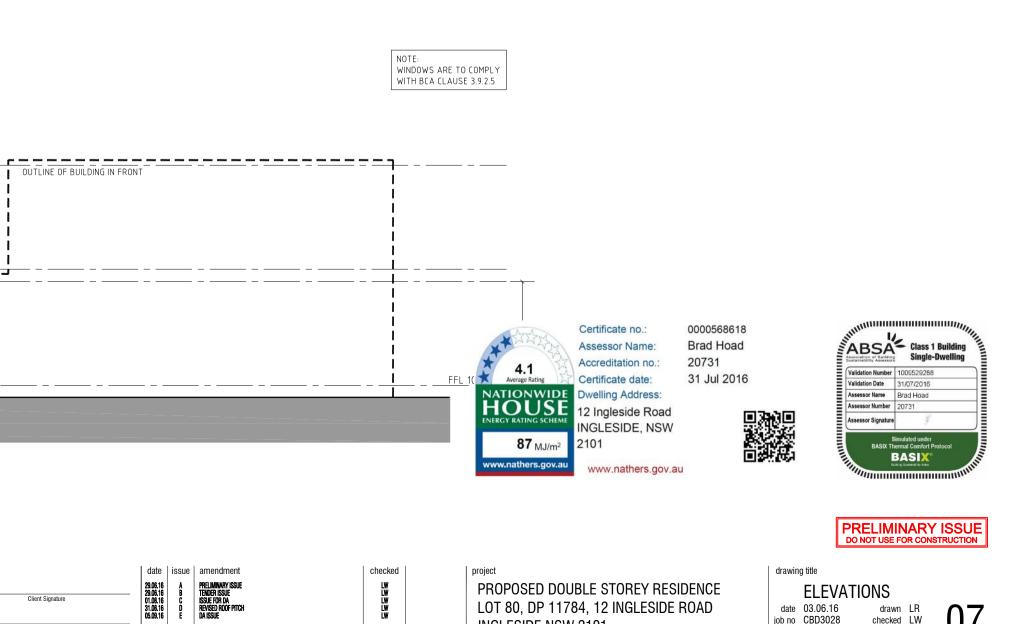

LOT 80, DP 11784, 12 INGLESIDE ROAD

INGLESIDE NSW 2101

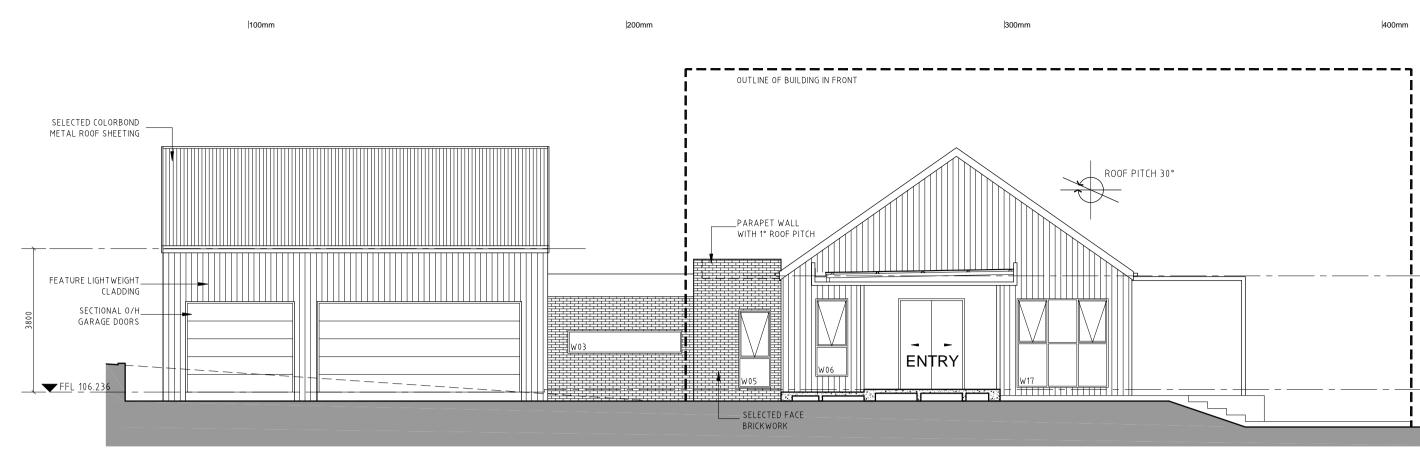

ELEVATION 7





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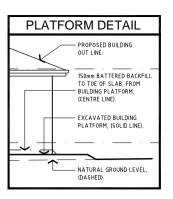


NOTE: WINDOWS ARE TO COMPLY

WITH BCA CLAUSE 3.9.2.5

FFL_106.310

500mm



CONSTRUCTION IS REQUIRED TO COMPLY WITH THE REQUIREMENTS STATED WITHIN THE FOLLOWING: NaTHERS CERTIFICATE 0000568618 DATED 31.07.16 BASIX CERTIFICATE 747334S DATED 01.08.16






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project PROPOSED DOUBLE STOREY RESIDENCE LOT 80, DP 11784, 12 INGLESIDE ROAD **INGLESIDE NSW 2101**

drawing title



HOUSE TO BE CONSTRUCTED TO BAL-29 BUSHFIRE CONSTRUCTION (EAST ELEVATIONS

| TEM | | BY |
|---|---|-------|
| EXTERNAL WALLS. | BRICK VENEER | |
| PROVIDE A SCREEN , HAVING AN APER OF CORROSION RESISTANT ALUMINIUM | TURE SIZE NO GREATER THAN 2mm , CONSTRUCTED TO ALL WEEP HOLES AND VENTS. | |
| WINDOWS | ALUMINIUM FRAME | |
| THE GLAZING SHALL BE MIN.5mm TOUGHE | NED GLAZING | |
| PROVIDE A SCREEN , HAVING AN APERTU CONSTRUCTED OF CORROSION RESISTANT PORTIONS OF THE WINDOWS | | |
| CARPORT ROOFS, AWNINGS & SIMILAR EL | COM THE GROUND OR LESS THAN 400mm ABOVE DECKS, EMENTS OR FITTINGS HAVING AN ANGLE LESS THAN 18 TION SHALL BE SCREENED WITH A CORROSION X. APERTURE OF 2mm. | |
| ALL EXTERNALLY FITTED HARDWARE TO | BE CONSTRUCTED OF METAL. | |
| EXTERNAL DOORS | | |
| SIDE HUNG DOORS | | |
| MAIN ENTRY | | ***** |
| BUSHFIRE RESISTANT FRAME IN ACCORDA APPLICABLE MINIMUM 5mm GRADE 'A' SA TO BE TIGHT FITTING TO THE DOOR FRAM | FETY GLASS TO SIDELITE. DOORS | |
| COMPLETELY PROTECTED EXTERNALLY B APERTURE SIZE NO GREATER THAN 2mm RESISTANT ALUMINIUM. | | |
| PROVIDE WEATHER STRIPS, DRAUGHT EX | CLUDERS, OR DRAFT SEALS. | |
| EXTERNAL HUNG DOORS (ie LAUNDRY , G | | |
| BUSHFIRE RESISTANT FRAME IN ACCORDA TIGHT FITTING TO THE DOOR FRAME AND, | | |
| COMPLETELY PROTECTED EXTERNALLY B SIZE NO GREATER THAN 2mm , CONSTRUC ALUMINIUM. | , | |
| PROVIDE WEATHER STRIPS, DRAUGHT EX | CLUDERS, OR DRAFT SEALS. | |
| SLIDING DOORS | | |
| FULLY FRAMED ALUMINIUM W/- GRADE 'A | Y SAFETY GLASS COMPLIANT W/- AS1288. | |
| OPENING SECTION COMPLETELY PROTECT HAVING AN APERTURE SIZE NO GREATER CORROSION RESISTANT ALUMINIUM. | | |
| GARAGE DOORS | | ***** |
| SECTIONAL OVERHEAD DOOR TO BE OF NO FITTED W/- SUITABLE SEALS WITH A MA TO PREVENT ENTRY OF EMBERS. | | |
| ROOF | METAL ROOF | ***** |
| THE ROOF TO WALL JUNCTION TO BE SEA GREATER THAN 3mm | LED SO THAT THERE ARE NO GAPS | |
| THE ROOF TO BE FULLY SARKED WITH SA RATING OF NO GREATER THAN 5 AND DIR THAT THE ENTIRE ROOF IS COVERED, INCL LEFT THAT WOULD PERMIT THE ENTRY OI FASCIAS, GUTTERS & VALLEYS ETC. | ECTLY BELOW THE ROOF BATTENS SUCH .UDING THE RIDGE. NO GAPS ARE TO BE | |
| ANY PENETRATION THROUGH THE ROOF V NON-COMBUSTIBLE MATERIALS TO PREVE | | |
| EAVES | | ***** |
| ANY PENETRATION THROUGH THE EAVES NON-COMBUSTIBLE MATERIALS TO PREVE ANY GAPS IN THE EAVES GREATER THAN GUARDS MADE OF NON-COMBUSTIBLE MA SHEET HAVING A MAXIMUM APERTURE SI | ENT ANY GAPS GREATER THAN 3mm. I 3mm WILL BE FITTED WITH EMBER TERIALS , OR A MESH OR PERFORATED | |
| ALUMINIUM. JOINTS IN EAVES LININGS TO BE SEALED STORM MOULDS AS PERMITTED BY AS395 | | |
| WATER & GAS SUPPLY F | | ***** |
| | GAS SUPPLY PIPES TO BE METAL. | |
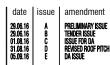
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design

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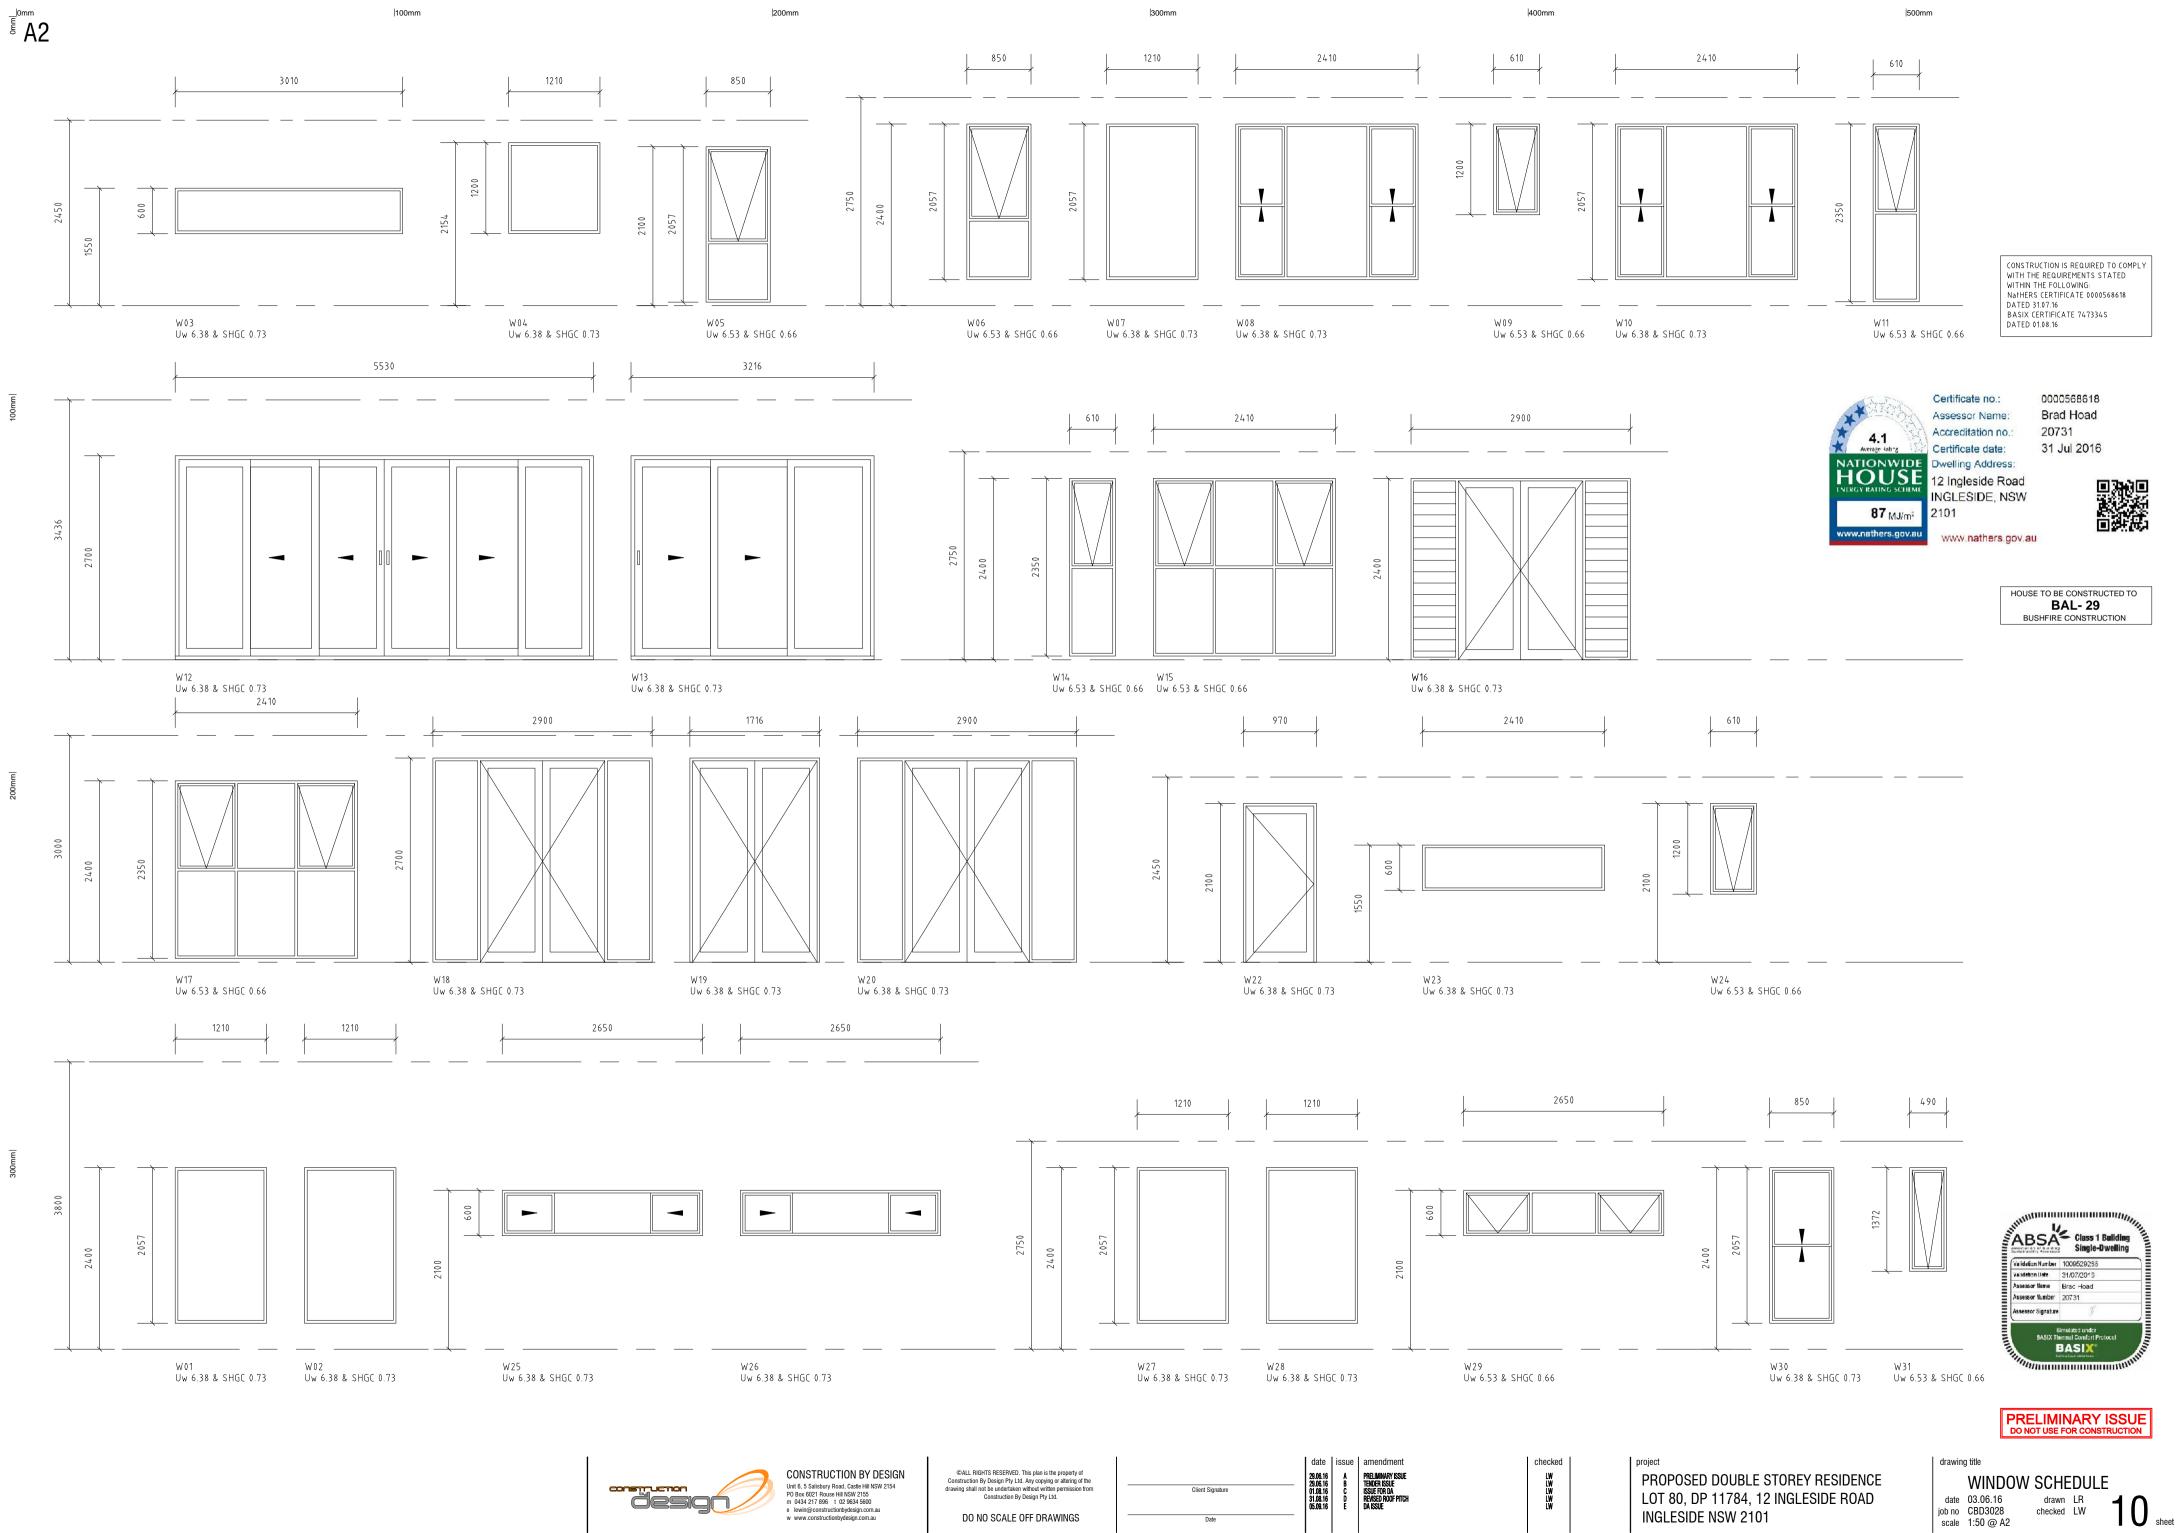





project PROPOSED DOUBLE STOREY RESIDENCE LOT 80, DP 11784, 12 INGLESIDE ROAD **INGLESIDE NSW 2101**

drawing title BUSHFIRE date 03.06.16 drawn LR job no CBD3028 checked LW scale NTS @ A2







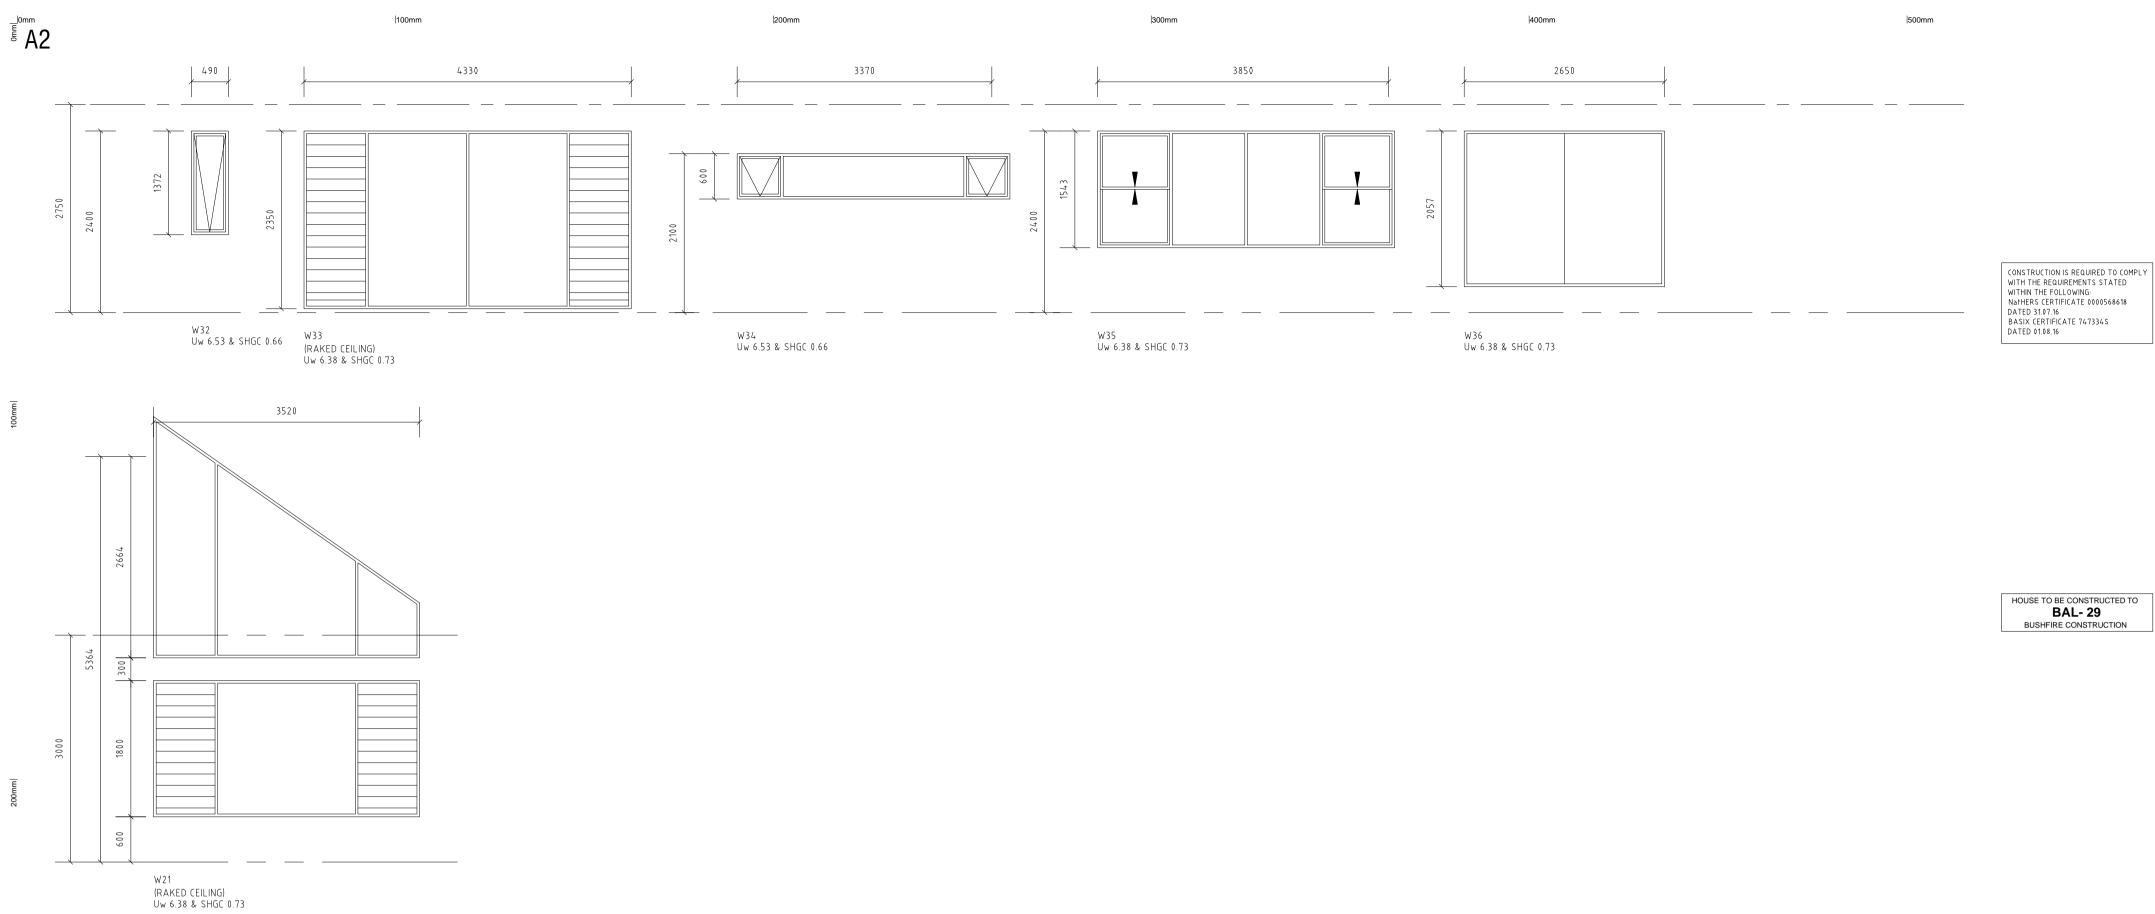



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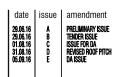


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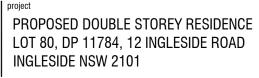


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checked

LW LW LW LW




drawing title WINDOW SCHEDULE date 03.06.16 drawn LR job no CBD3028 checked LW scale 1:50 @ A2 sheet

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200mm

INGLESIDE ROAD - 9am Nege Kong Poly constant



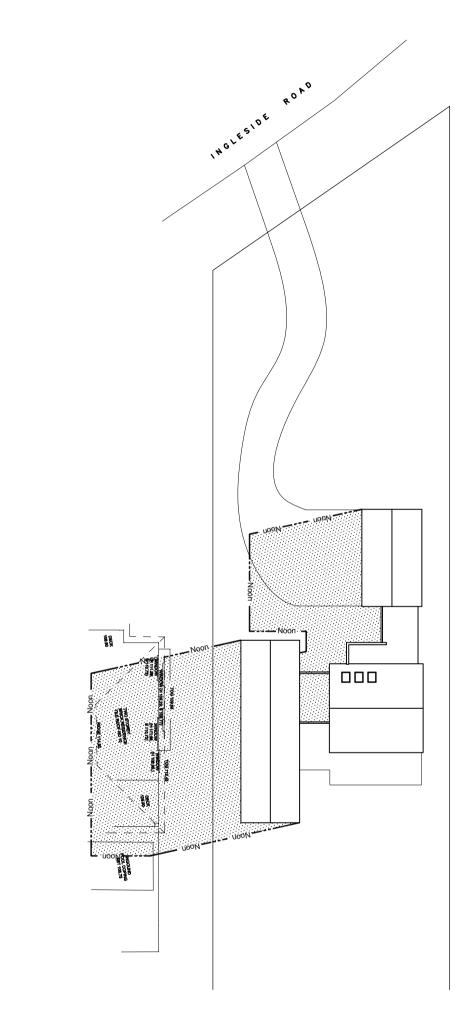


THIO STOREY RESIDENCE

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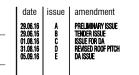
DO NO SCALE OFF DRAWINGS






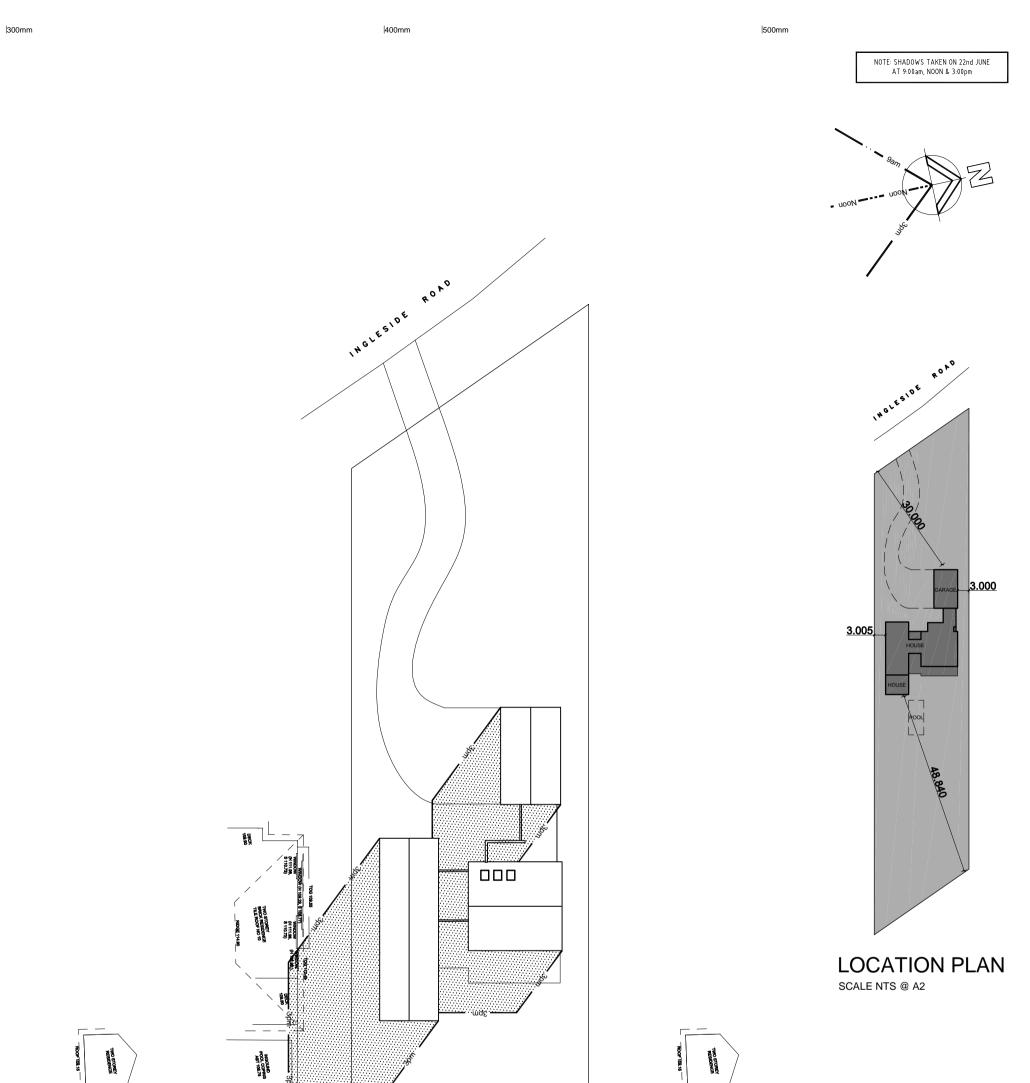

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PROPOSED DOUBLE STOREY RESIDENCE LOT 80, DP 11784, 12 INGLESIDE ROAD INGLESIDE NSW 2101

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SHADOW DIAGRAMS date 03.06.16 drawn LR job no CBD3028 checked LW 2.22 sheet

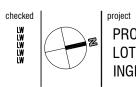drawing title



EXTERIOR SCHEDULE OF FINISHES

PROJECT

12 INGLESIDE RD, INGLESIDE

PROJECT NUMBER CBD3028

SELECTIONS ARE SUBJECT TO MANUFACTUERS AVAILABILITY AND STOCK. IF A PRODUCT IS CHOSEN THAT IS NO LONGER AVAILABLE FROM A SUPPLIER THEN AN ALTERNATIVE PRODUCT/COLOUR WILL BE SELECTED THAT IS CLOSE TO THE ORIGINAL. COLOURS MAY VARY FROM SAMPLES GIVEN.

| ITEM | DESCRIPTION | SELECTION | SAMPLE |
|-----------------------|---|-----------------------------|--------|
| Roof/Gutter/Facia (1) | Colorbond www.colorbond.com | Colorbond Shale Grey | |
| Roof/Gutter/Facia (2) | Colorbond www.colorbond.com | Colorbond Monument | |
| Windows | Vantage Windows | Annotec Natural Pearl | |
| Garage Door | B&D Garage Doors www.bnd.com.au | Colorbond Shale Grey | |
| Entry Door | Hume Doors & Timber www.humedoors.com.au | Dark Oak (Intergrain Stain) | |
| Brickwork / Mortar | Boral Bricks - Off White | Austral Symmetry Earth | |
| Cladding Type (1) | Taubmans | Colorbond Monument | |
| Cladding Type (2) | Taubmans | Colorbond Shale Grey | |
| Driveway & Paths | | | |
| | | | |