




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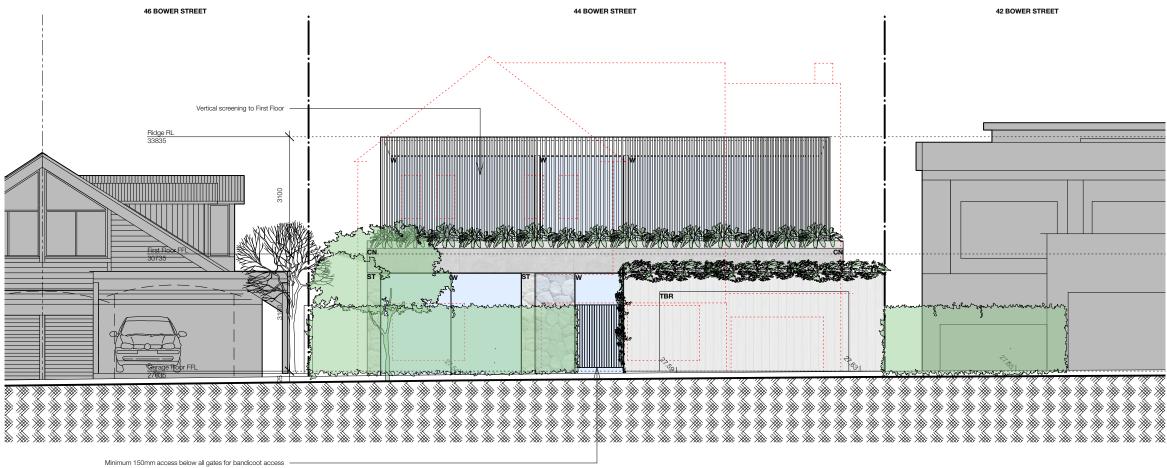
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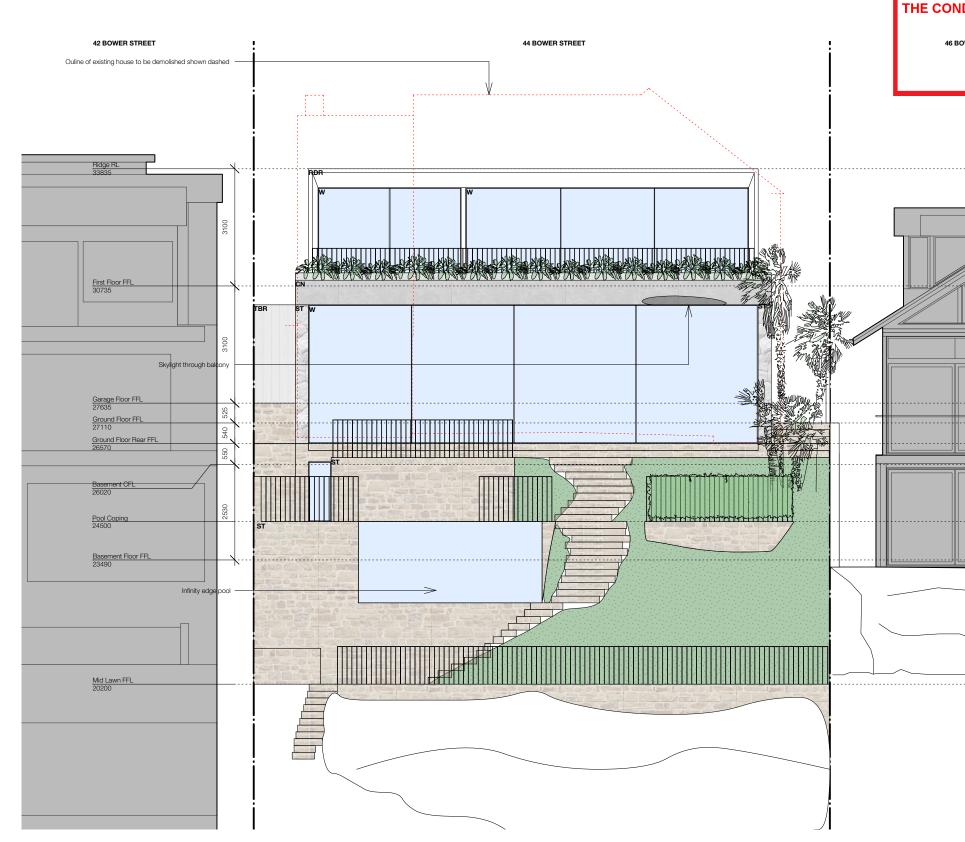
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RDR Render

TBR Light weight timber cladding

W Windows aluminium framed

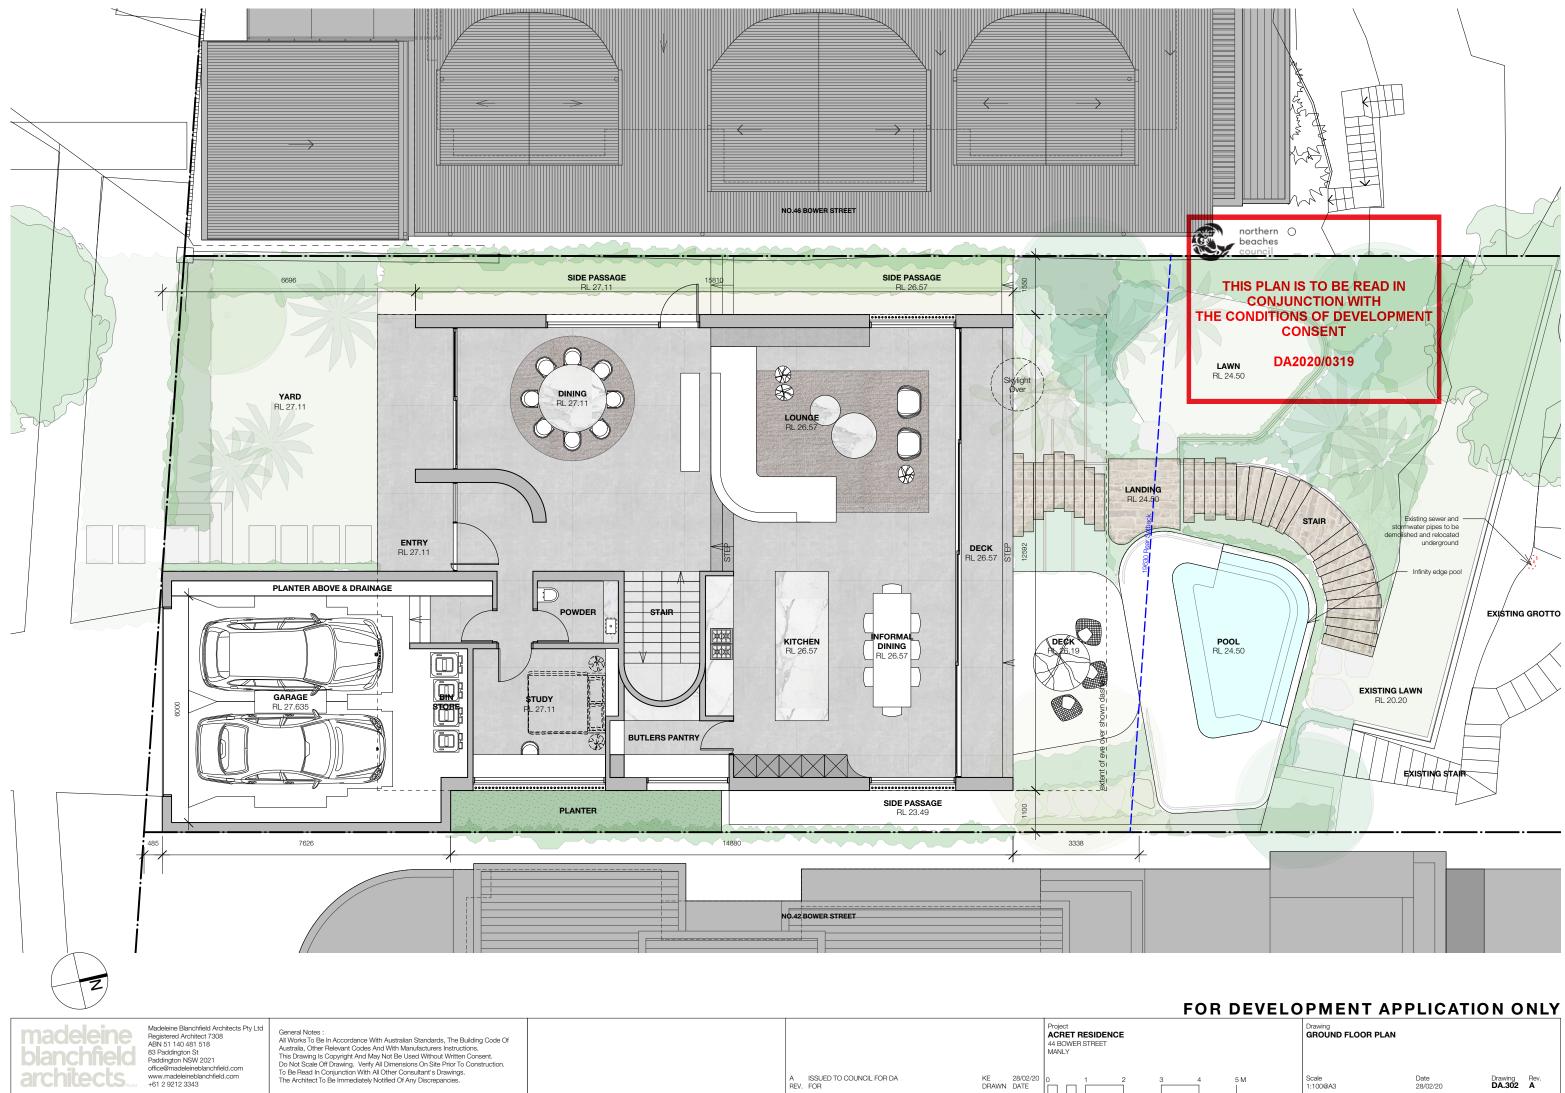

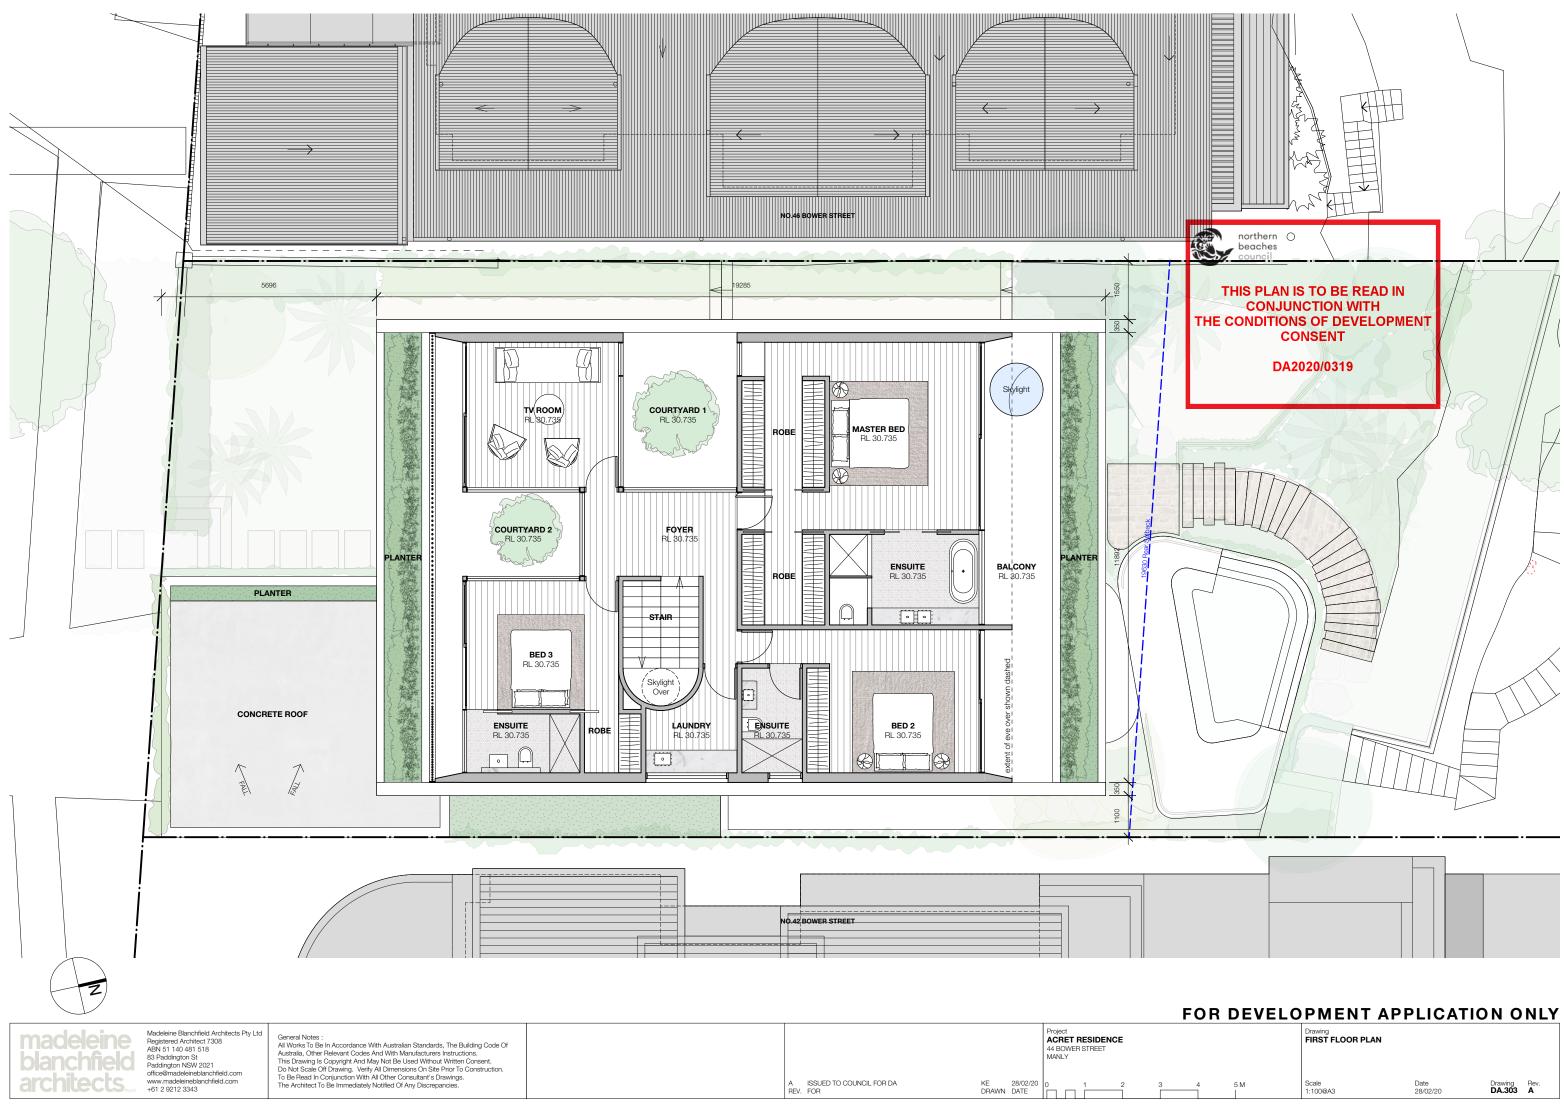


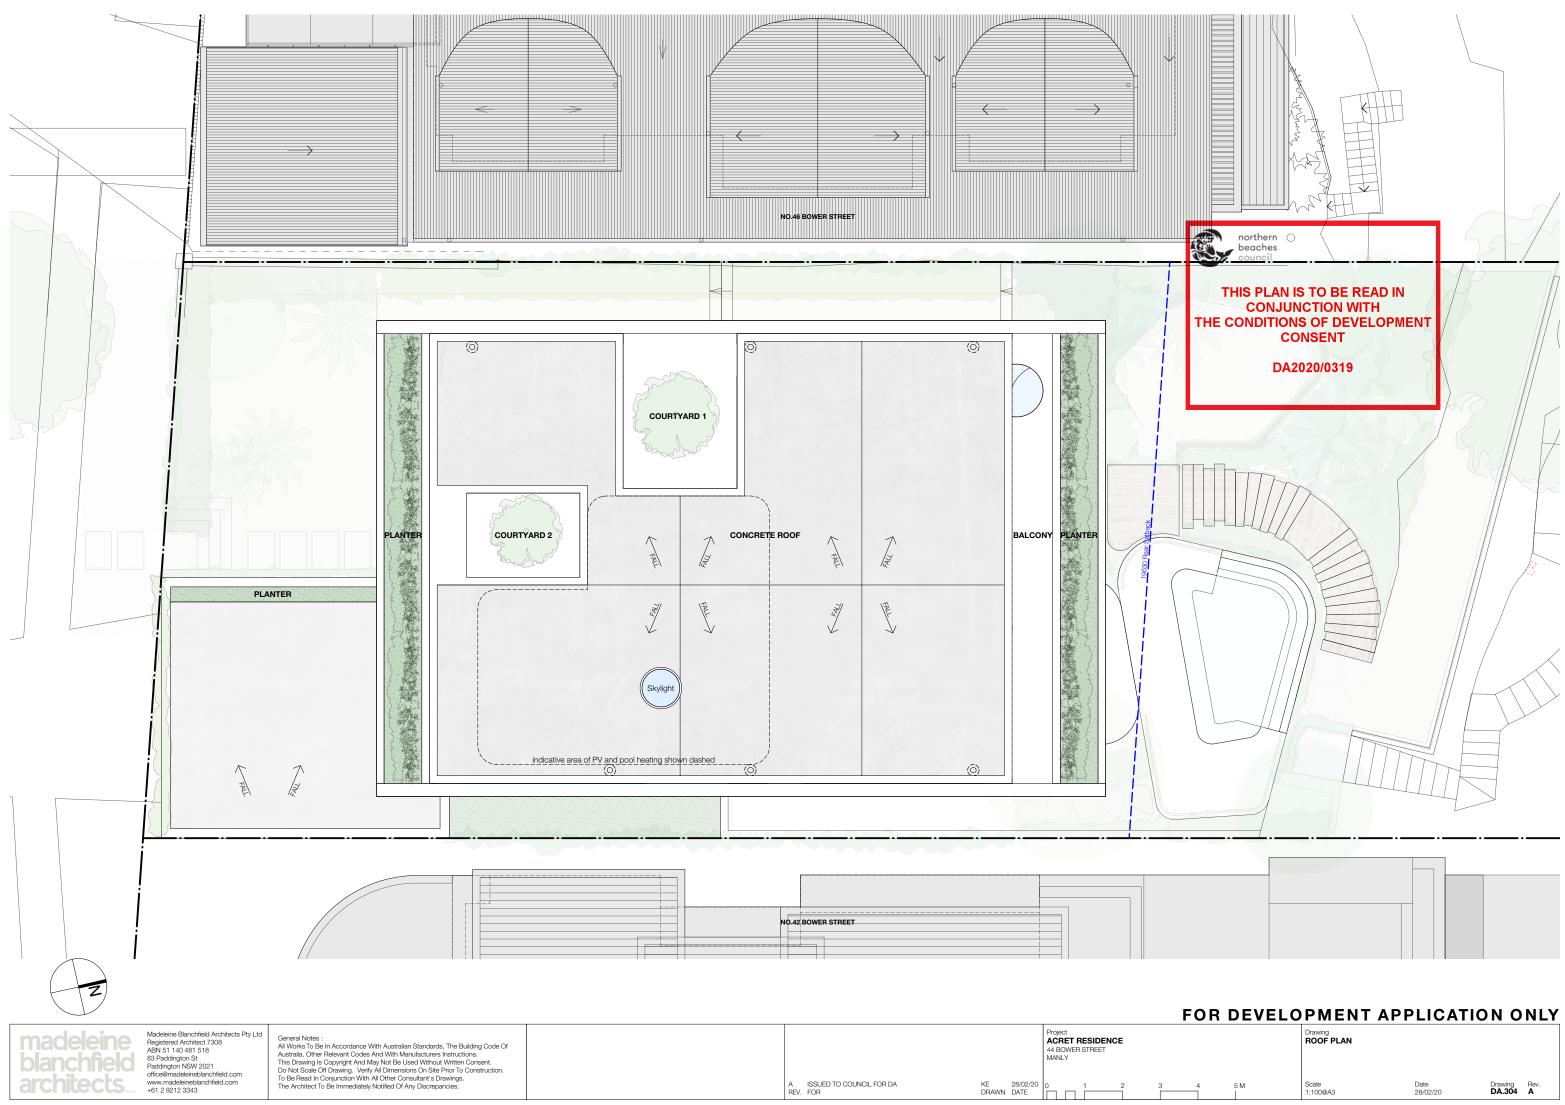

Madeleine Blanchfield Architects Pty Ltd Registered Architect 7308 ABN 51 140 481 518 83 Paddington St Paddington NSW 2021 office@madeleineblanchfield.com www.madeleineblanchfield.com +61 2 9212 3343 General Notes :

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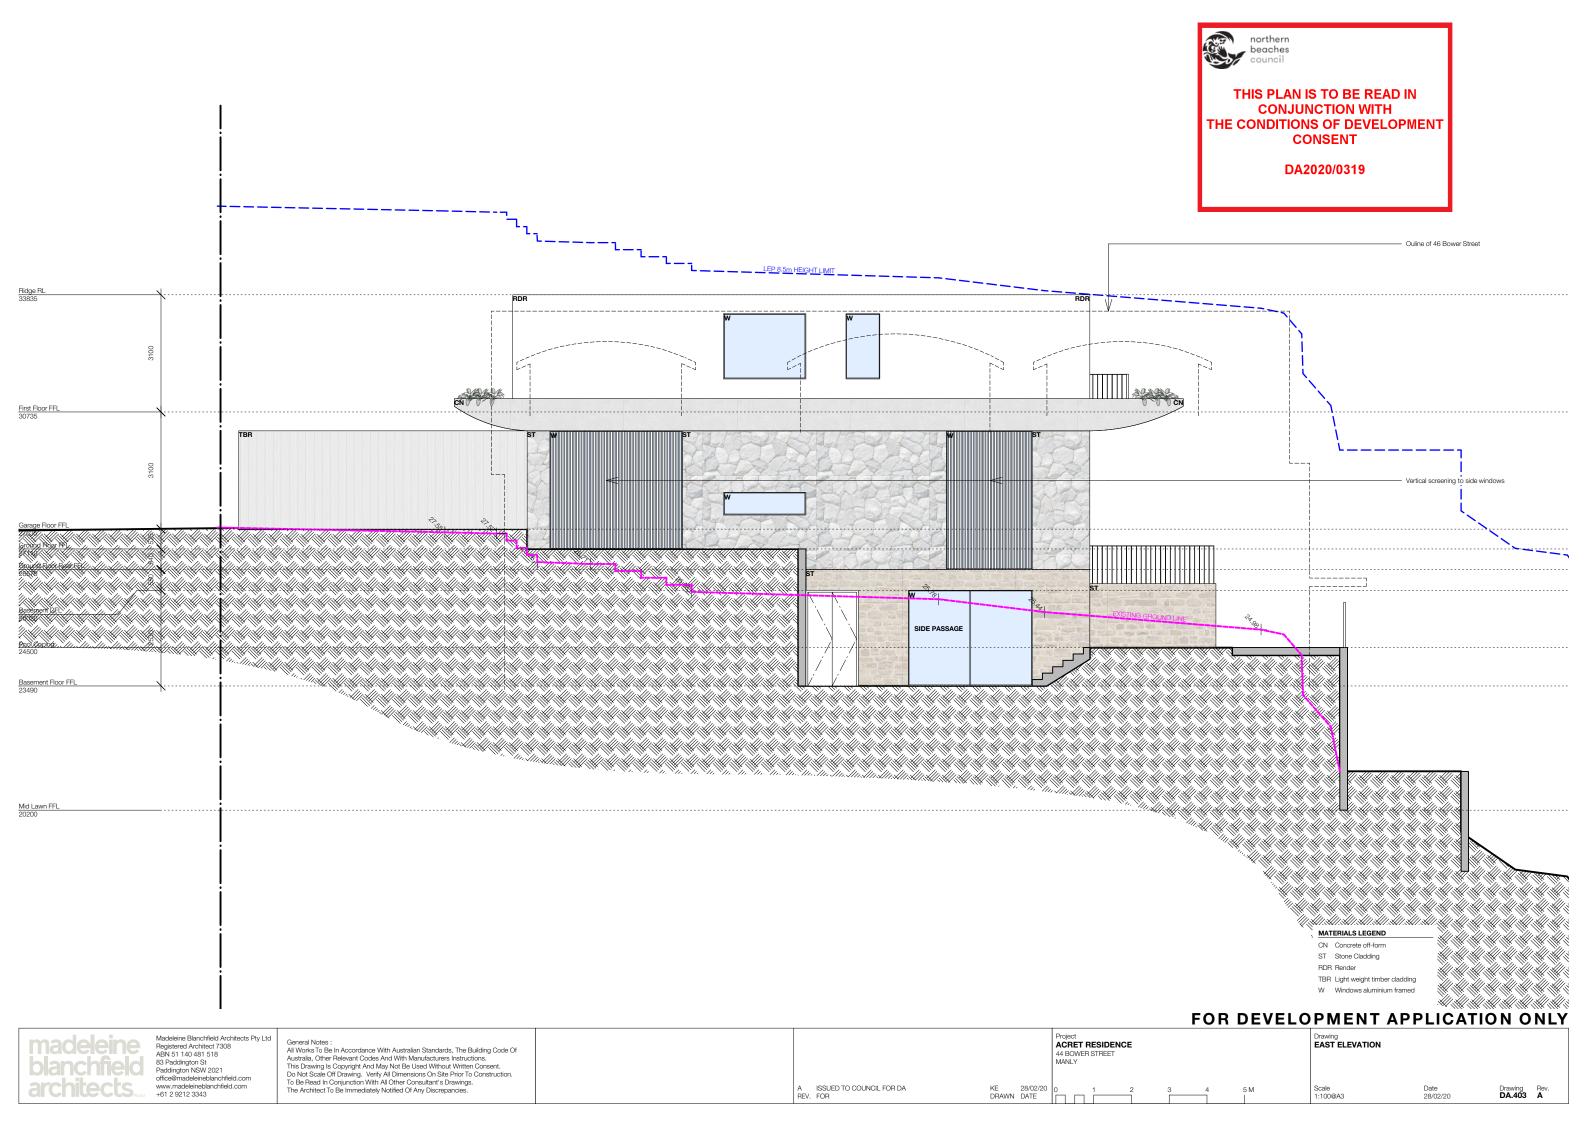
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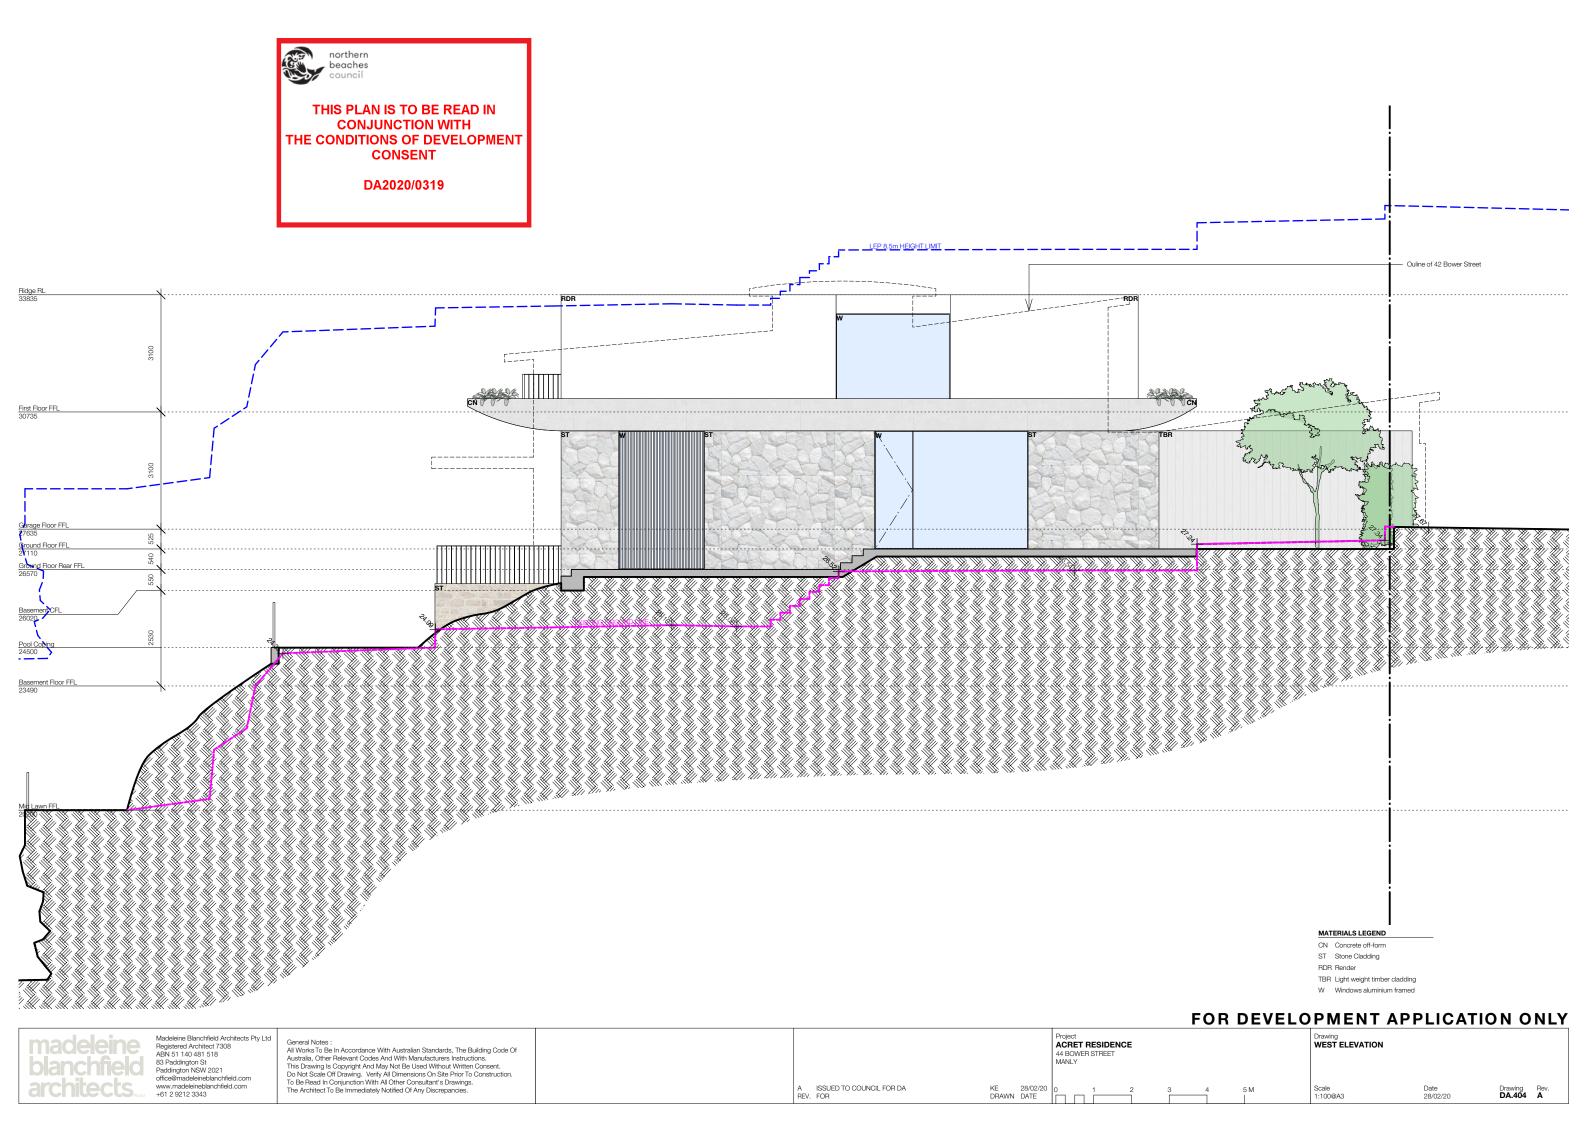
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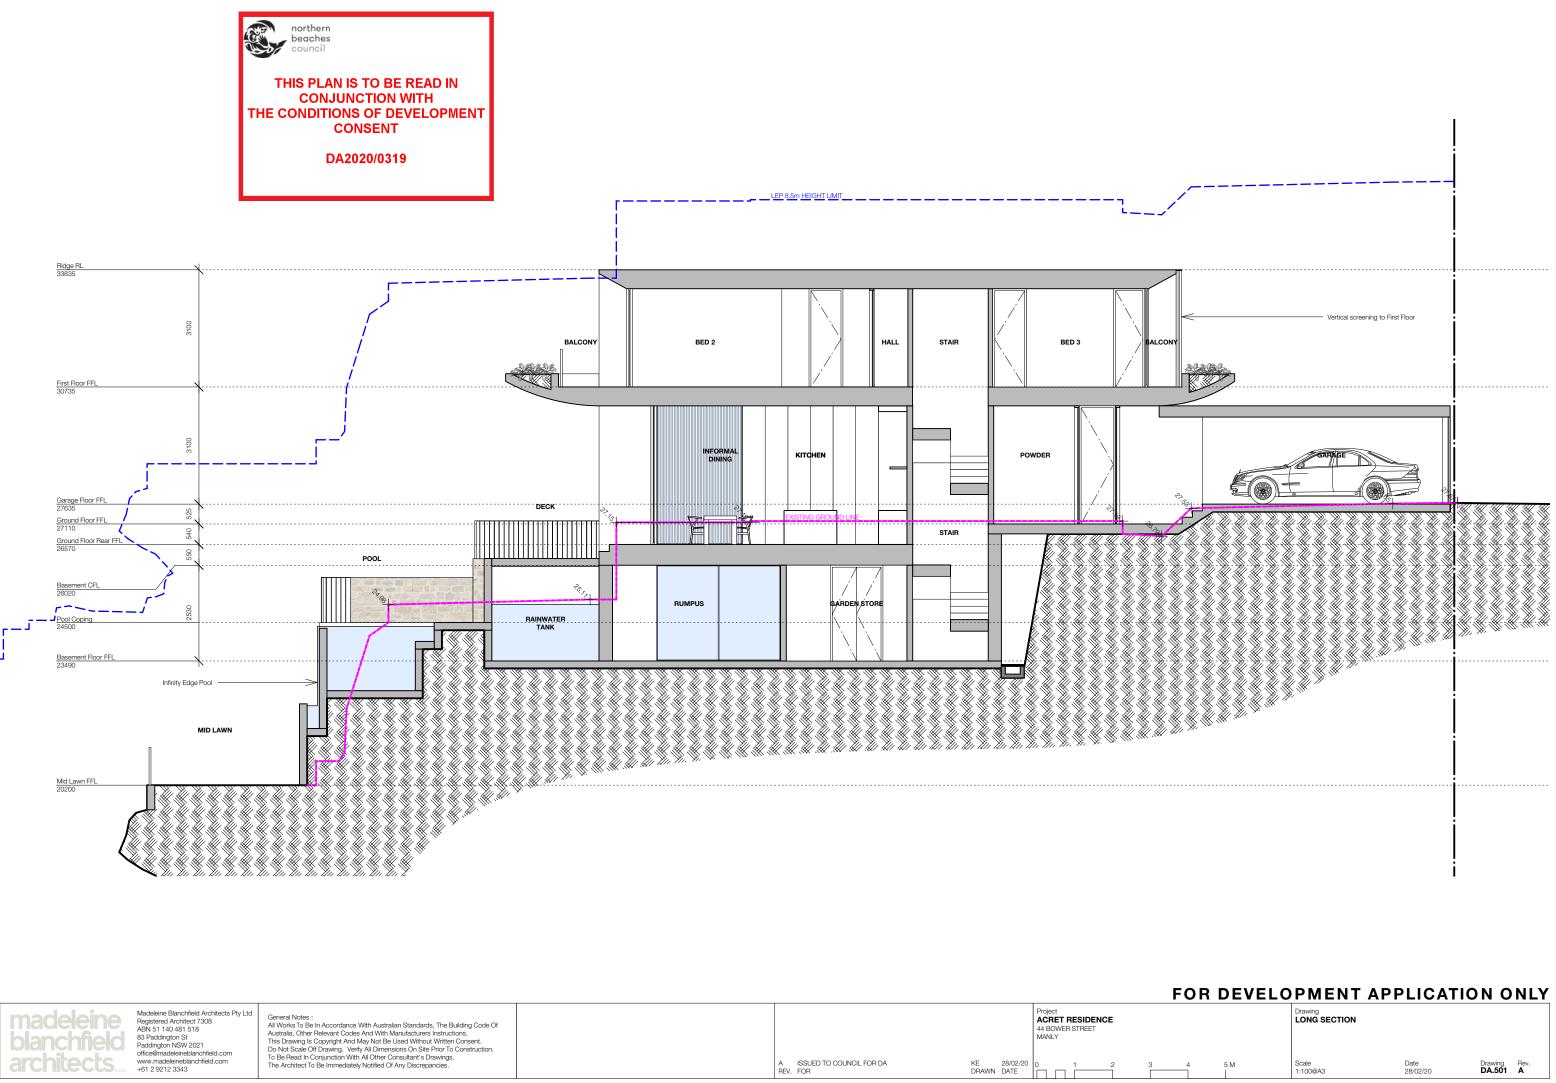
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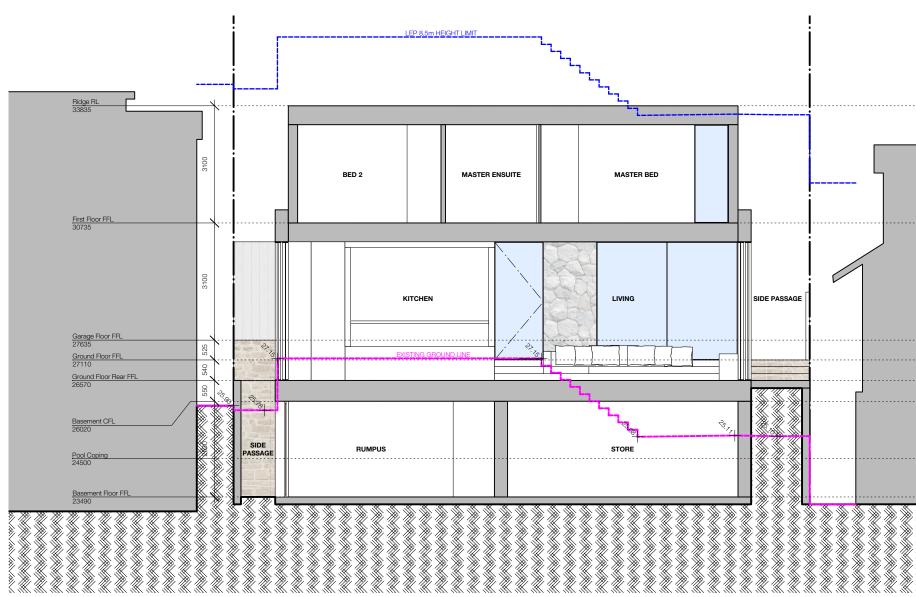
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nadeleine lanchfield rchitects	Madeleine Blanchfield Architects Pty Ltd Registered Architect 7308 ABN 51 140 481 518 83 Paddington St Paddington NSW 2021 office@madeleineblanchfield.com www.madeleineblanchfield.com +61 2 9212 3343	General Notes : All Works To Be in Accordance With Australian Standards, The Building Code Of Australia, Other Relevant Codes And With Manufacturers Instructions. This Drawing Is Copyright And May Not Be Used Without Written Consent. Do Not Scale Off Drawing. Verify All Dimensions On Site Prior To Construction. To Be Read In Conjunction With All Other Consultant's Drawings. The Architect To Be Immediately Notified Of Any Discrepancies.	A ISSUED TO COUNCIL FOR DA REV. FOR	KE 28/02/20 DRAWN DATE	Project <b>ACRET RESIDENCE</b> 44 BOWER STREET MANLY 0 1 2 3 0 1 2 3

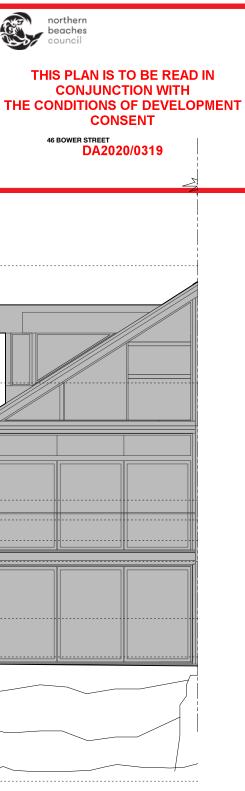

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44 BOWER STREET

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Project ACRET RESIDENCE 44 BOWER STREET MANLY

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### 46 BOWER STREET

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northern beaches council

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 FOR DEVELOPMENT APPLICATION ONLY

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Date 28/02/20

Drawing Rev. DA.902 A



### PLANT SCHEDULE

Botanic Name	Common Name	Mature Height (m)	Pot Size	Qty
Acer palmatum	Japanese maple	5	100Ltr	2
Aloe 'Bush Baby Yellow'	Bush Baby Yellow	0.4	200mm	25
Aloe 'Ferox'	Bitter Aloe	1	300mm	23
Alpinia nutans	Dwarf Cardamom	1.2	200mm	23
Aptenia cordifolia	Desert Rose	0.1	140mm	40
Asplenium 'Lime Wave'	Bird's Nest Fern	0.5-1.5	200mm	21
Banksia spinulosa	Hairpin banksia	0.6	300mm	18
Blechnum nudum	Fishbone Waterfern	0.4	200mm	12
Beaumontia grandiflora	Herald's Trumpet	Climber	300mm	1
Bougainvillea Sp.	Bougainvillea	Climber	300mm	21
Carpobrotus glaucescens	Pig Face	0.3	140mm	160
Cissus antarctica	Kangaroo Vine	0.3	200mm	83
Chamaerops humilis	European Fan Palm	3.5	400Ltr	2
Cordyline australis	New Zealand Cabbage Tree	4	300mm	3
Cupaniopsis anacardioides	Tuckeroo	5-10	100L	2
Dichondra repens	Kidney weed	Ground cover	100mm	217
Grevillea robyn gordon	Robyn Gordon Grevillea	Ground cover	1500mm	9
Hibbertia scandens	Guinea Flower	Ground cover	140mm	15
Howea forsteriana	Kentia Palm	5-12	Advanced	6
Juncus sp.	Common Rush	Ground cover	140mm	16
Kalanchoe beharensis	Felt bush	0.5	300mm	9
Lomandra katrinus	Katrinus	0.7	200mm	12
Lomandra 'Tanika'	Fine Matt Grass	0.7	200mm	21
Monstera deliciosa	Fruit Salad Plant	0.5-1.5	200mm	7
Pandorea jasminoides	Bower Plant	Climber	200mm	16
Parthenocissus tricuspidata	Boston ivy	Climber	140mm	5
Philodendron 'Xanadu'	Xanadu	0.7	200mm	13
Plumeria sp.	Frangipani	3-5	200L	2
Rhapis excelsa	Lady Palm	4-5	45L	5
Syzygium resilience	Syzygium resilience	4	75Ltr	27
Strelitzia nicolai	Giant Bird Of Paradise	5-7	75L	16
Trachelospermum jasminoides	Star Jasmine	Climber	200mm	48
Vibirnum sp.	Sweet Viburnum	3-4	400mm	12

CONSENT

DA2020/0319

Note: Landscape plan consists of 71% Proposed notive plant species READ IN

**GENERAL NOTES:** 

### **GRAPHIC ILLUSTRATION**

Please note that the plant graphics are indicative sizes only and not an accurate representation at time of purchase

### SITE PREPARATION

All existing plants marked for retention shall be protected for the duration of works. Remove from site all perennial weeds and rubbish before commencing landscape works.

### SOILWORKS

Thoroughly cultivate the subsoil to a depth of 200mm. Supply and install to a depth of 300mm quality garden soil mix to all planting beds and 150mm turf underlay to lawn areas.

### MULCH


Supply and install a 75mm layer of hardwood horticultural grade mulch to all planting beds set down 25mm from adjacent paving or garden edge.

### MAINTENANCE

All failed or defective plant species to be replaced by landscaper for a 3 months period following completion of work. Further maintenance during and after this period should include watering, weeding, fertilising, pest and disease control, pruning and hedging, reinstatement of mulch and keeping the site neat and tidy.

### **TERRESTRIAL BIODIVERSITY REPORT:**

NOTE: It is recommended that the ameliorative conditions (pg. 30) and management recommendations (pg. 32) in the Terrestrial Biodiversity Report prepared on 07/02/20 by GIS Environmental Consultants be followed to limit disturbance during construction and to further reduce the impact of the proposal on potential bandicoot habitat and access regarding 44 Bower St, Manly.

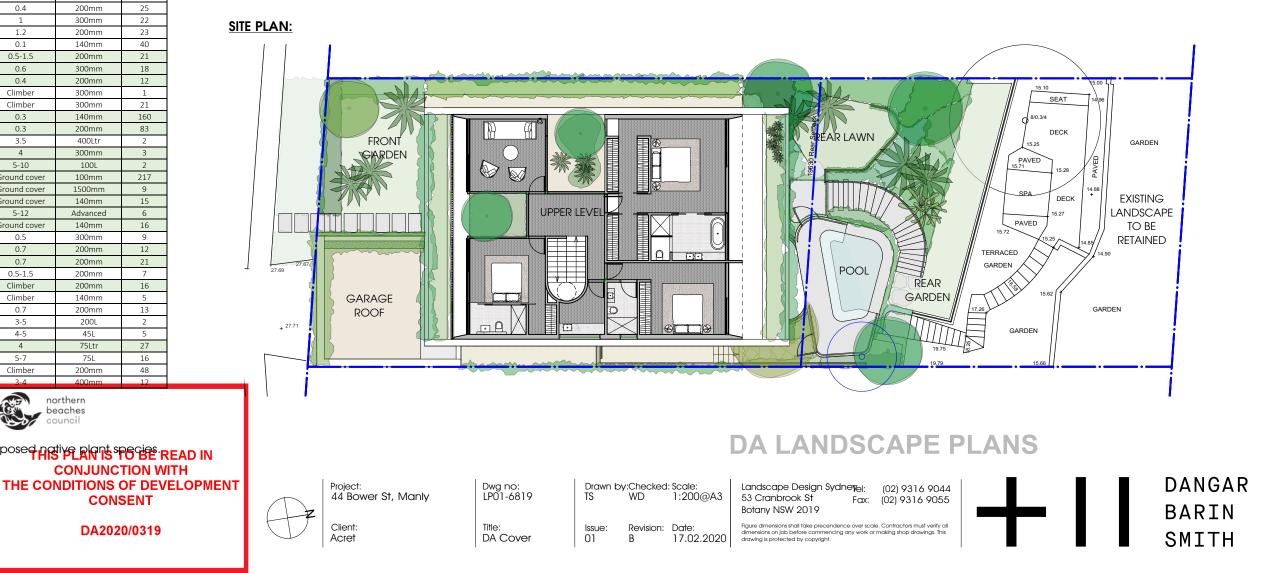


### **GENERAL PLANTING NOTES:**

**NOTE:** It is recommended that all plants used be subject to an establishment period. During this period maintenance work carried out will include; watering, mowing, weeding, fertilising, pest and disease control, reseeding, returfing, staking and tying, replanting, cultivating, pruning, hedge clipping, aerating, reinstatement of mulch, top dressing and keeping the site neat and tidy.

**NOTE:** Plants shall be vigorous, well established, of good form consistent with species or variety, not soft or forced, free from disease and insect pests, with large healthy root systems and no evidence of having been restricted in growth or damaged. Root system shall be well balanced in relation to the size of the plant.

**NOTE:** Install 'root barrier' or equivalent to manufacturers specifications to protect nearby structures and services.

NOTE: Install temporary drip irrigation system under mulch in tree protection zones and water on allotted days.

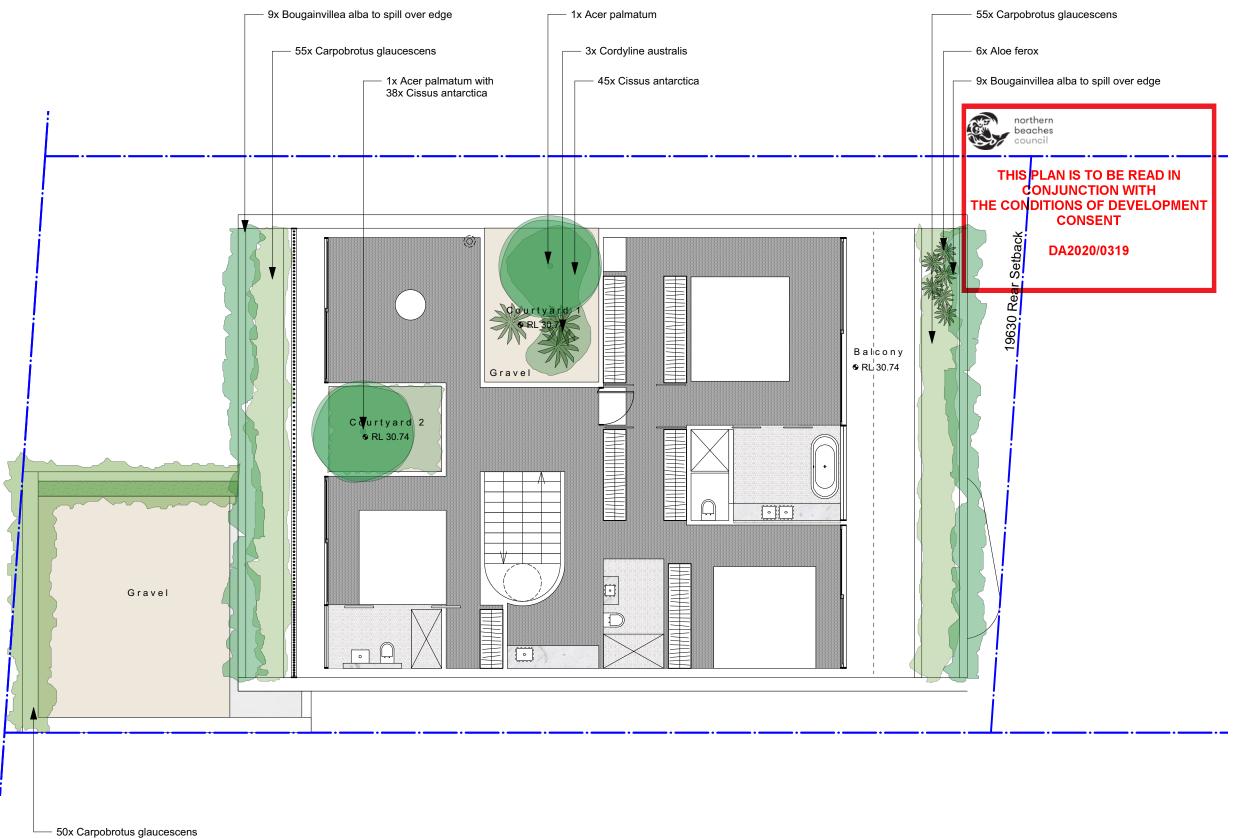


### **DA LANDSCAPE PLANS**




Dwg no: LP01-6819	Drawn b TS	y:Checked WD	: Scale: 1:100@A3	Landscape Design Sydne <mark>y<sub>el:</sub></mark> 53 Cranbrook St Fax: Botany NSW 2019
Title: Landscape Plan Level 1	lssue: 01	Revision: B	Date: 17.02.2020	Figure dimensions shall take precendence over scc dimensions on job before commencing any work o drawing is protected by copyright.



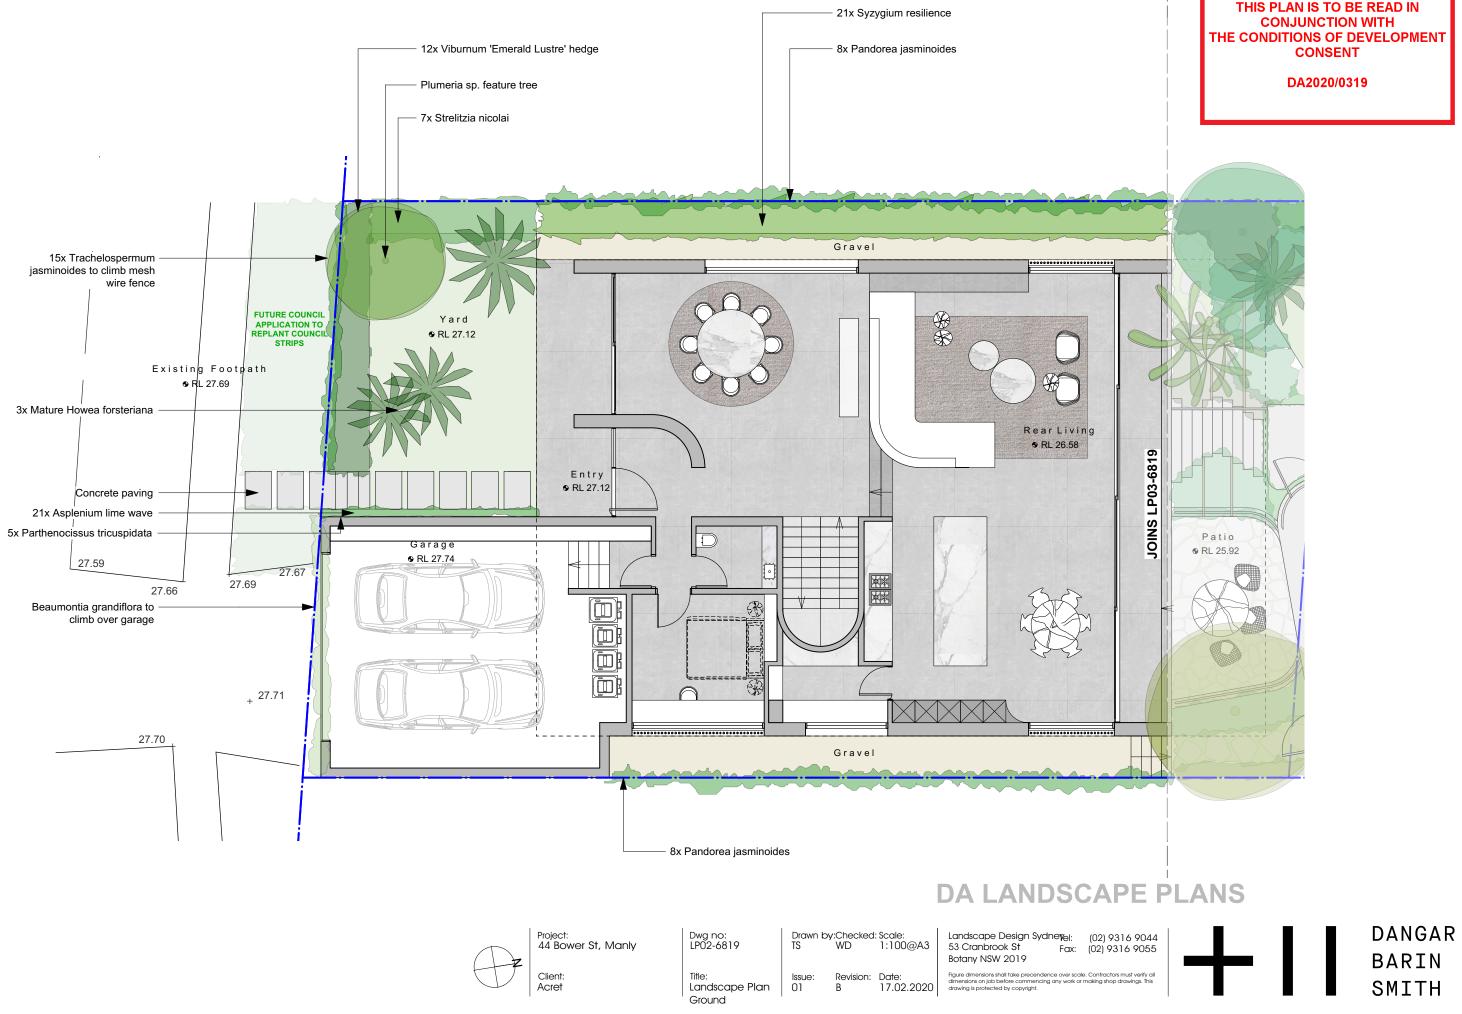



## THIS PLAN IS TO BE READ IN

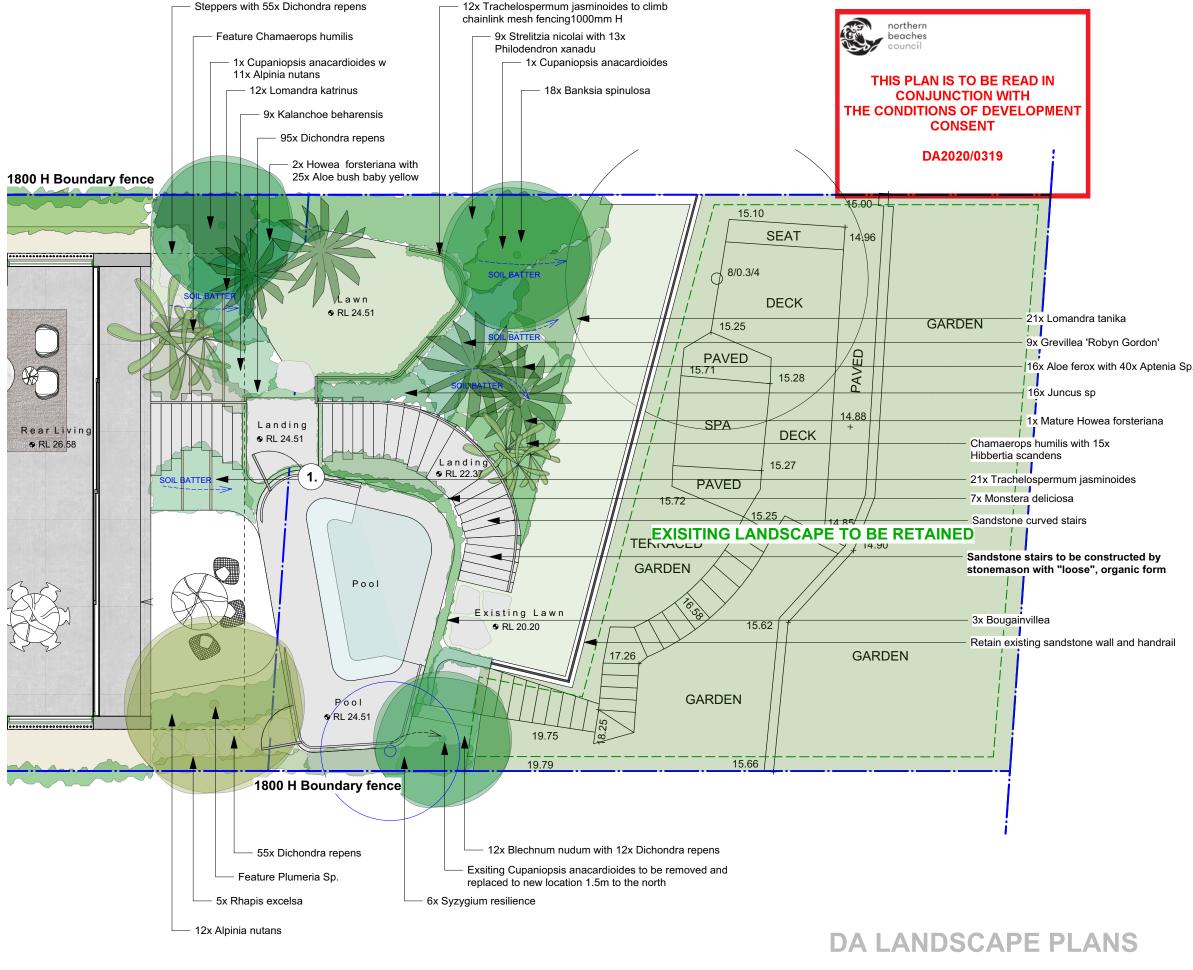



Dwg no: LP03-6819

Plan

Rear Landscape



53 Cranbrook St

Botany NSW 2019

1:100@A3

17.02.2020

Drawn by:Checked: Scale

Revision: Date

WD

В

TS

lssue: 01

### LANDSCAPE NOTATIONS



### Pool fencing to comply with Australian standards:

AS1926.1-2012 "Swimming pool safety -Part 1: Safety Barriers for swimming pools"

AS1926.2-2007 "Swimming pool safety -Part 2: Location of safety barriers for swimming pools"

AS2820-1993 "Gate units for private swimming pools"

**GIS ENVIRONMENTAL CONSULTANTS Terrestrial Biodiversity Report & DBS** design notations

- All replacement boundary fences are to have 150mm-300mm gaps every two metres along the fence (or in places where the soil level is the same on both site of the fence).

- Any new external and internal gates are to have gaps of a minimum of 150mm under the full length of the gate to allow for bandicoot access

- In areas of habitat for the lona-nosed bandicoot, landscape design should include native plant species to provide new and/or improved low dense clumping habitat to provide for potential foraging and nesting. The planting schedule should comprise species such as Lomandra sp. Dianella sp., Banksia spinulosa, Caustis sp., Xanthorrhoea sp., Isolepis sp., Juncus sp., Calochlaena sp., Callistemon sp. Gleichenia sp. and Grevillea Robyn Gordon' (Manly DCP 2013 Section 3.3.1 (a)(iv)).

- No landscape garden bed lighting propsed (as to not effect bandicoots). Step lighting to future detail only.

-Bandicoots are to be excluded from the propsed pool area with pool fencing to have an integrated perspex barrier 300mm in height from the base gap of less than 120mm, so as to exclude bandicoots from entering the pool area



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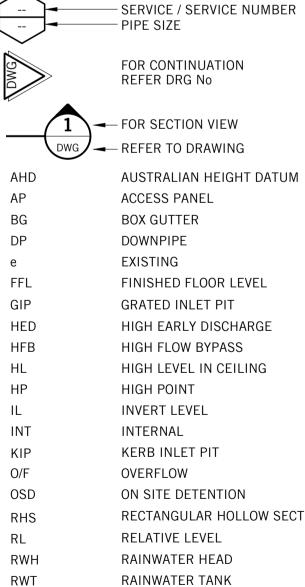


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### PIPEWORK

RAINWATER DRAINAGE RAINWATER CHARGED STORMWATER DRAINAGE STORMWATER RISING MAIN SUBSOIL DRAINAGE BARRIER FENCE EXISTING PIPE EXISTING PIPE MADE REDUNDANT SEDIMENT FENCE LINE PROPERTY BOUNDARY SWALE DROPPER RISER TURBIDITY BARRIER DIRECTION OF FALL OR FLOW
DOWN PIPE PLANTER BOX OUTLET RAIN WATER OUTLET / BALCONY OUTLET STORMWATER PIT (GRATE)
STORMWATER PIT (RWO IN BASE) SEALED PIT COVER
GULLY PIT REFLUX VALVE PIPE CONNECTION POINT PIPE PENETRATING PIPE NOT PENETRATING PUMP OVERLAND FLOW PATH CLEAR OUT TUNDISH TRENCH GRATE DOWNPIPE SPREADER



SRL

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MISCELLANEOUS

RECTANGULAR HOLLOW SECTION RAINWATER HEAD RAINWATER TANK SLAB RELATIVE LEVEL STRUCTURAL ROOT ZONE TO BE ADVISED TOP KERB LEVEL TREE ROOT ZONE TOP WATER LEVEL

UNLESS NOTED OTHERWISE

# **NEW RESIDENCE** AT

# **44 BOWER STREET** MANLY

FOR

**MR CHRIS ACRET** 

DRAWING LIST			
DRAWING No.	TITLE		
SWDA 1.1	COVER SHEET AND DRAWING LEGEND		
SWDA 1.2	BASEMENT LAYOUT AND DETAILS		
SWDA 1.3	GROUND FLOOR PLAN		
SWDA 1.4	EROSION & SEDIMENT CONTROL PLAN DETAILS		



## NOTES

- 1) ALL DRAINAGE WORKS ARE TO BE IN ACCORDANCE WITH AS/NZS 3500 -STORMWATER DRAINAGE, NORTHERN BEACHES COUNCIL (FORMERLY KNOWN AS MANLY COUNCIL) SPECIFICATION FOR ON SITE STORMWATER MANAGEMENT 2003 AND THE LATEST BASIX CERTIFICATE.
- 2) SITE AREA =  $696.8m^2$
- 3) REFERRING TO THE NORTHERN BEACHES COUNCIL STORMWATER CONTROL ZONES, THE SITE IS LOCATED WITHIN ZONE 3: SCOUR AND EROSION CONTROL
- 4) A SILT TRAP PIT IS TO BE INCORPORATED WITHIN THE DOWNSTREAM END OF THE EXISTING STORMWATER SYSTEM SERVING THE SITE IN ACCORDANCE WITH NORTHERN BEACHES COUNCIL REQUIREMENTS. THIS IS TO BE REGULARLY MAINTAINED AND CLEARED OF ALL DEBRIS IN ACCORDANCE WITH THE MAINTENANCE SCHEDULE.
- 5) IN ACCORDANCE WITH THE BASIX CERTIFICATE A RAINWATER TANK WITH A MIN CAPACITY OF 10,000L IS PROPOSED. THIS IS TO COLLECT A MINIMUM ROOF AREA OF 141 m<sup>2</sup> AND MUST BE CONNECTED TO HOSE TAPS FOR IRRIGATION & POOL TOP UP IN THE DEVELOPMENT.

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PRESSURE SERVICES SHOWN ON THIS DRAWING ARE LOCATED AT HIGH LEVEL UNLESS NOTES OTHERWISE

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P2	PROGRESS ISSUE	DH	GB	24.02.20
P1	PROGRESS ISSUE	DH	GB	20.02.20
Rev.	Issue / Amendment	Ву	App.	Date

# PARTRIDGE

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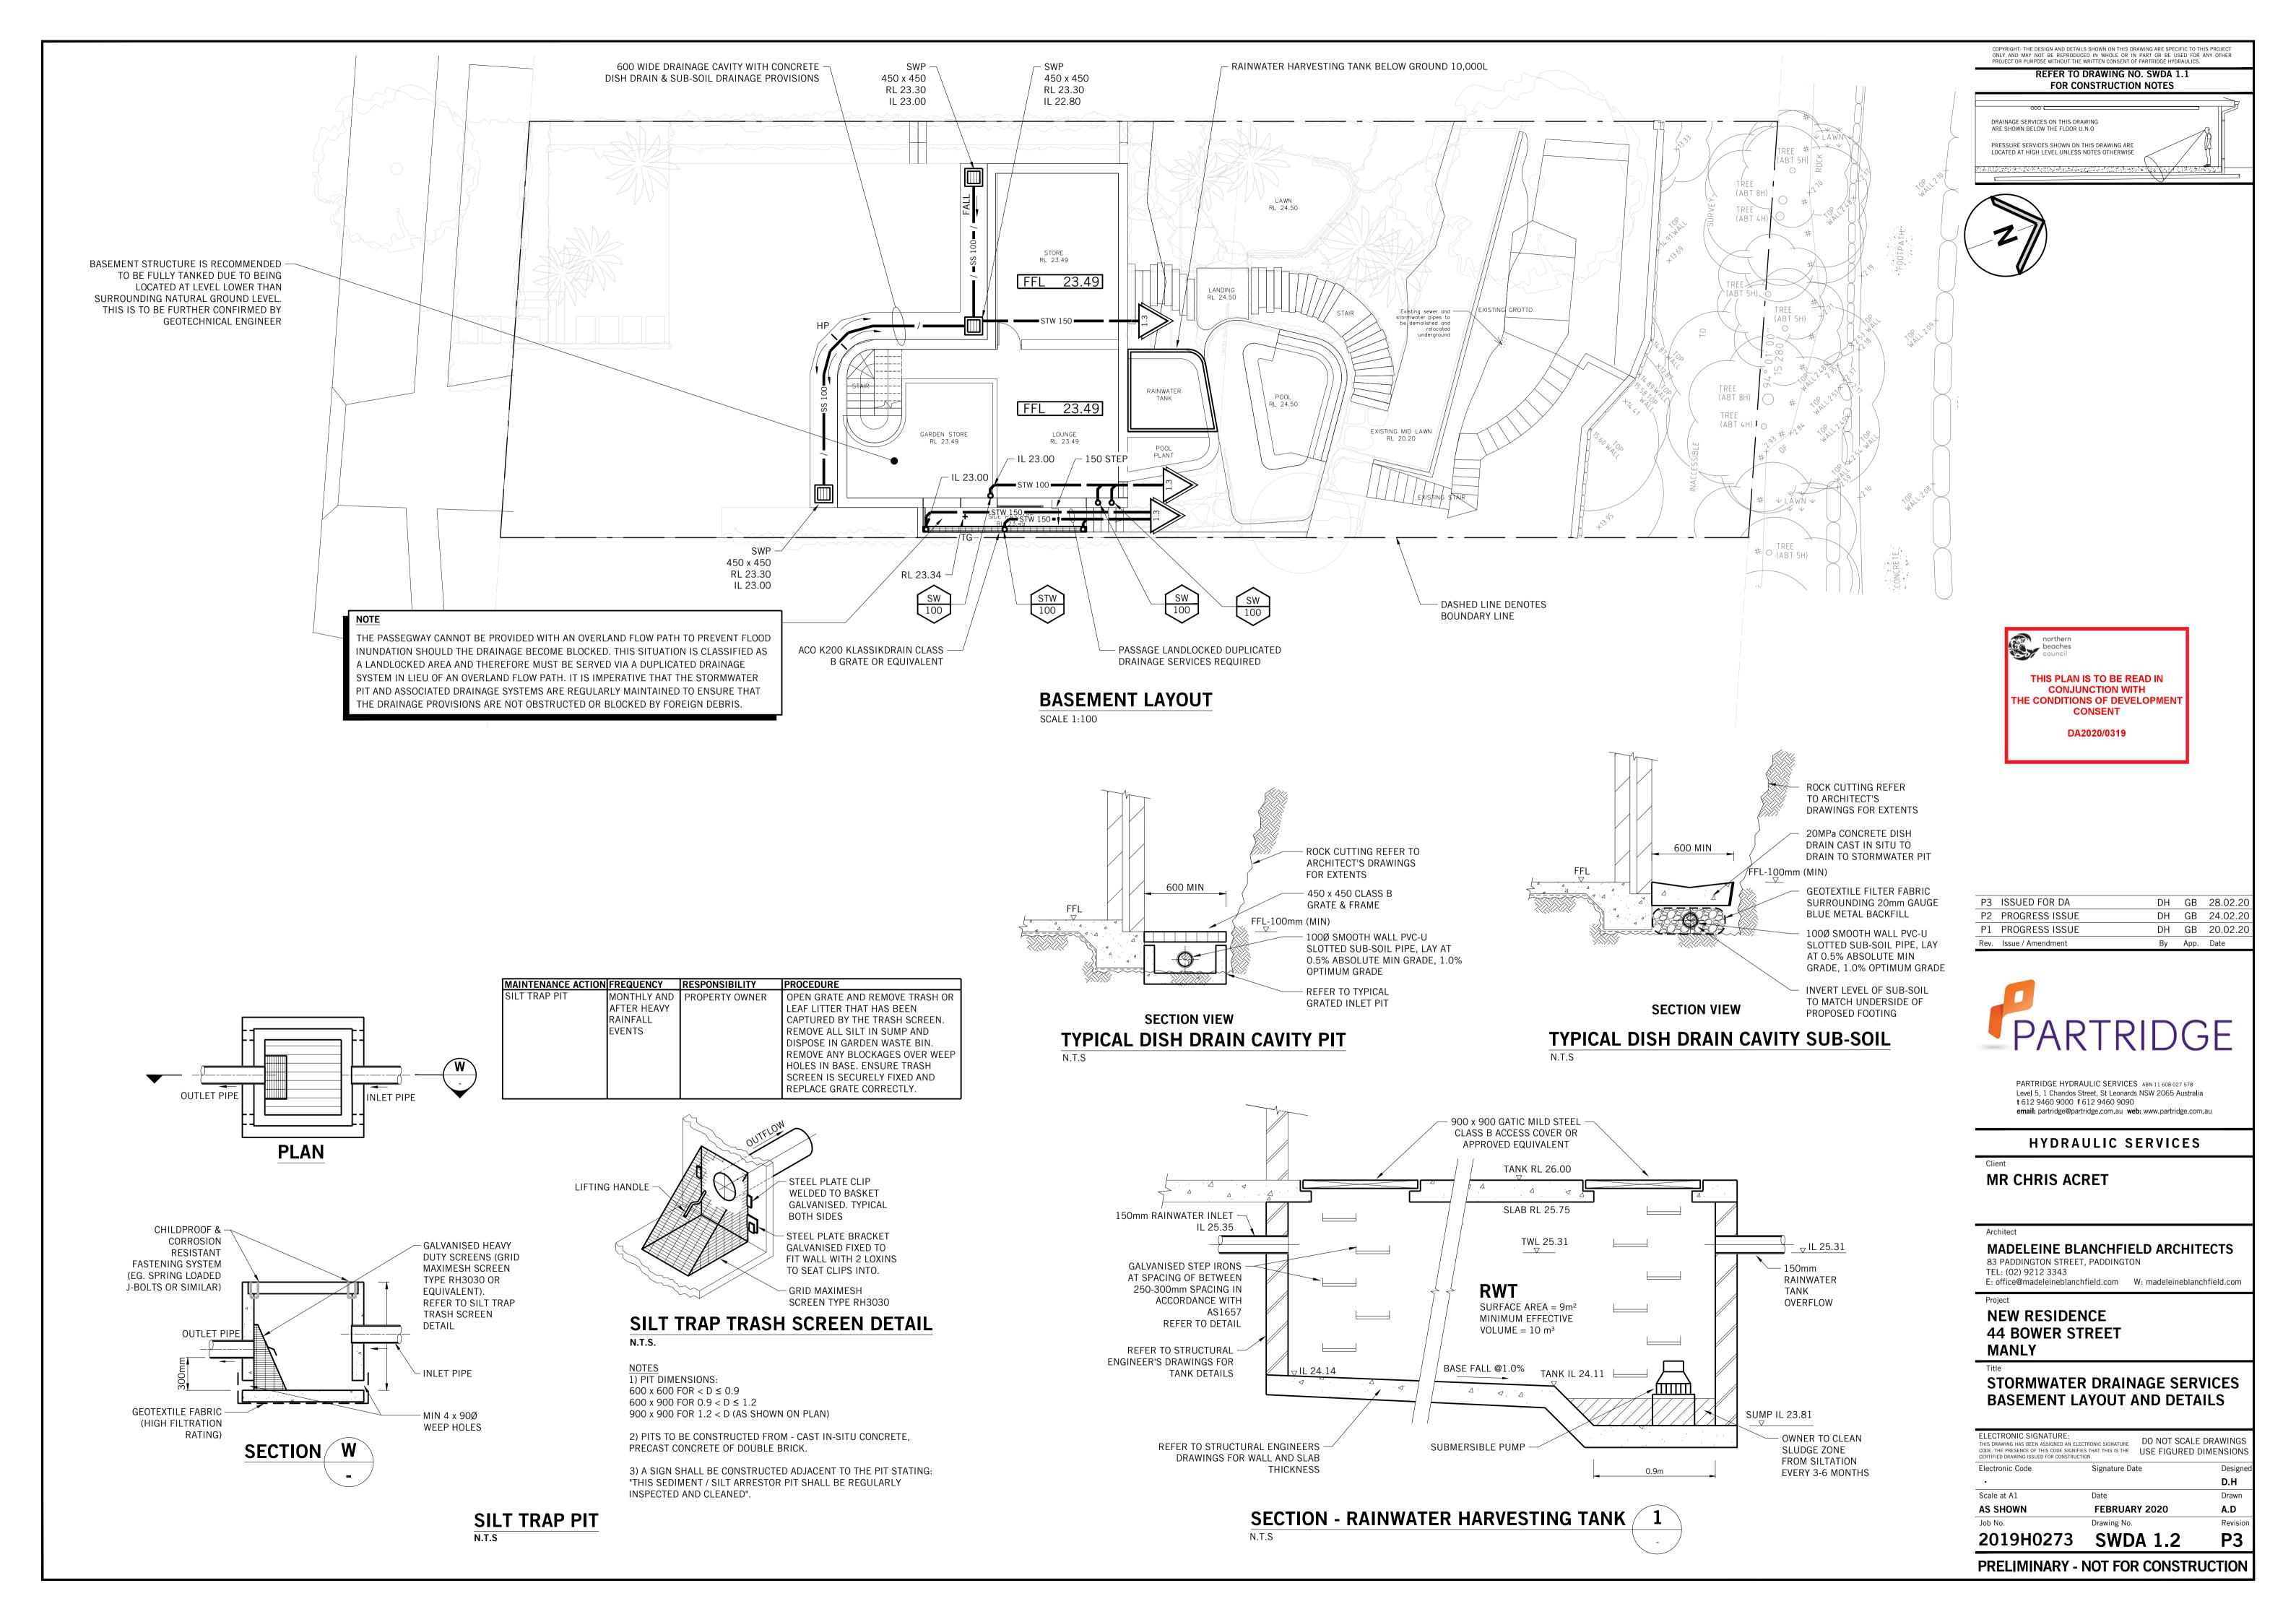
email: partridge@partridge.com.au web: www.partridge.com.au


### HYDRAULIC SERVICES


### MR CHRIS ACRET


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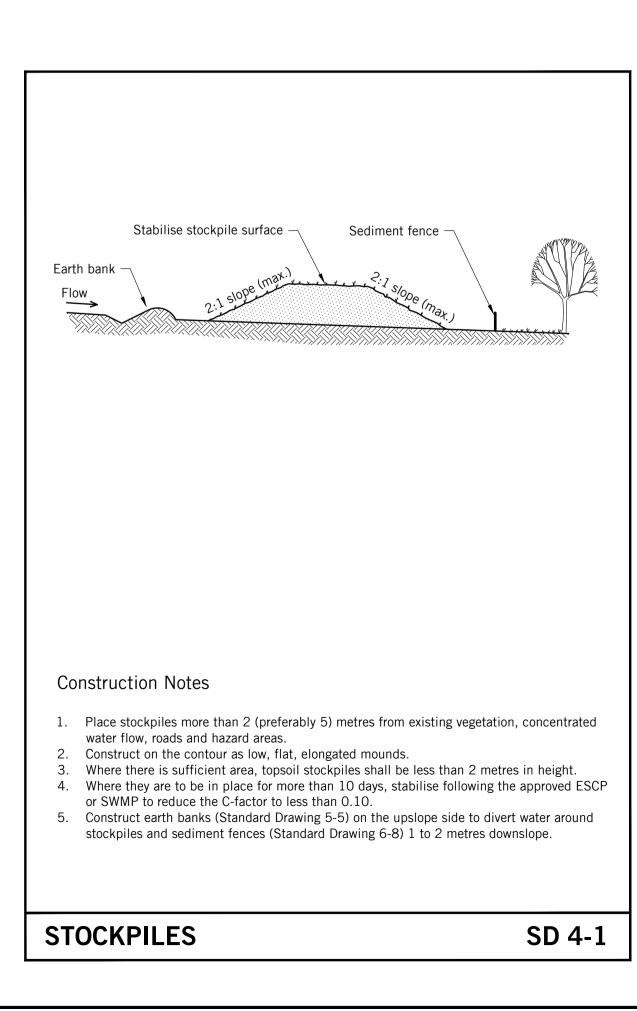
Architect						
<b>MADELEINE BL</b> 83 PADDINGTON STREE TEL: (02) 9212 3343 E: office@madeleineblanc						
Project						
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	STORMWATER DRAINAGE SERVICES COVER SHEET NOTES AND DRAWING LEGEND					
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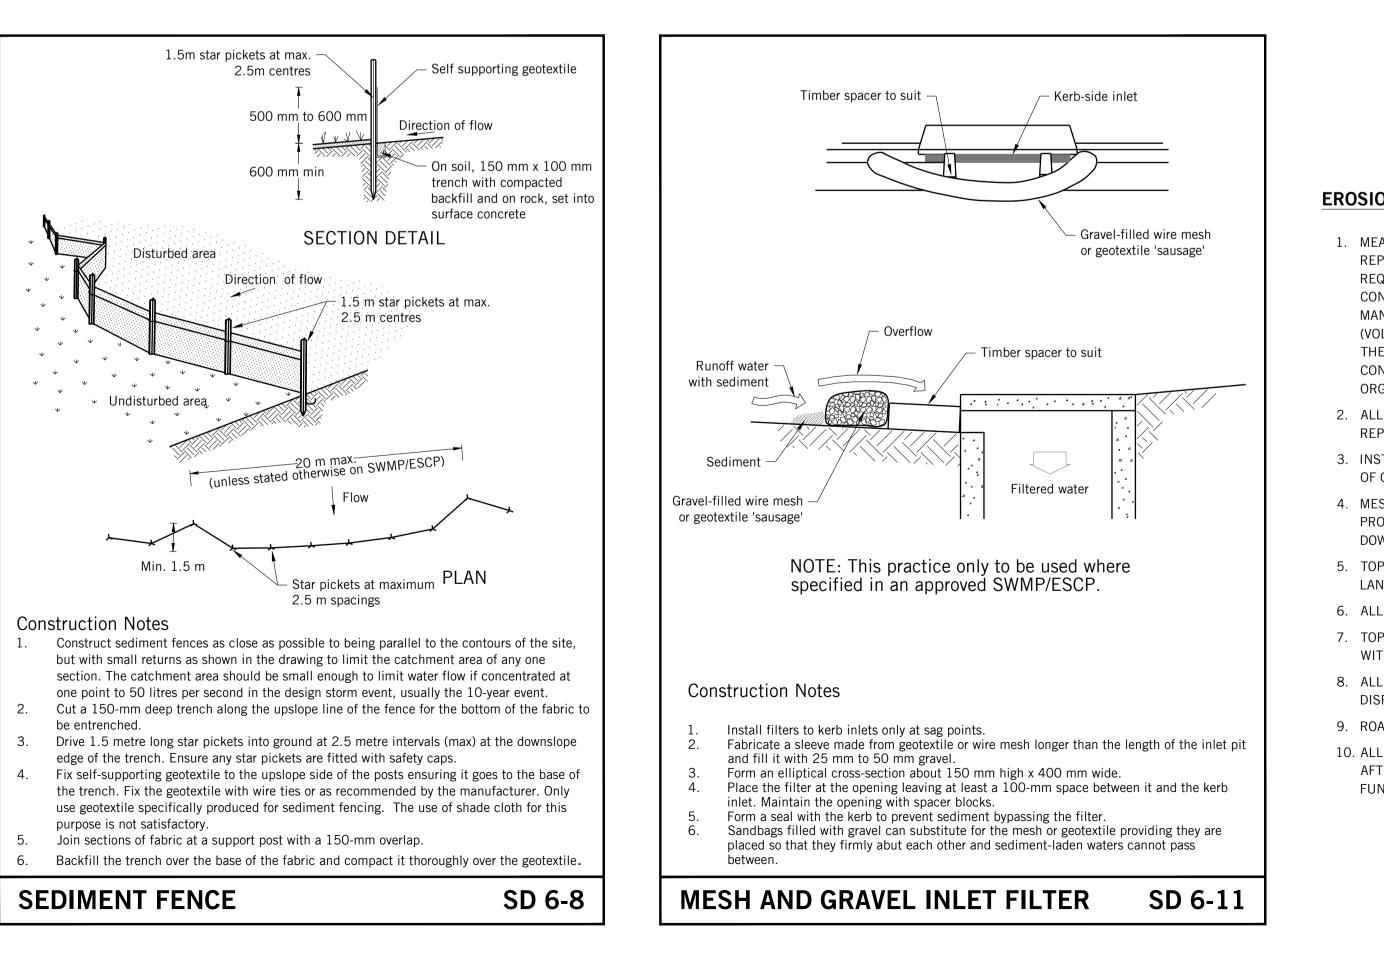






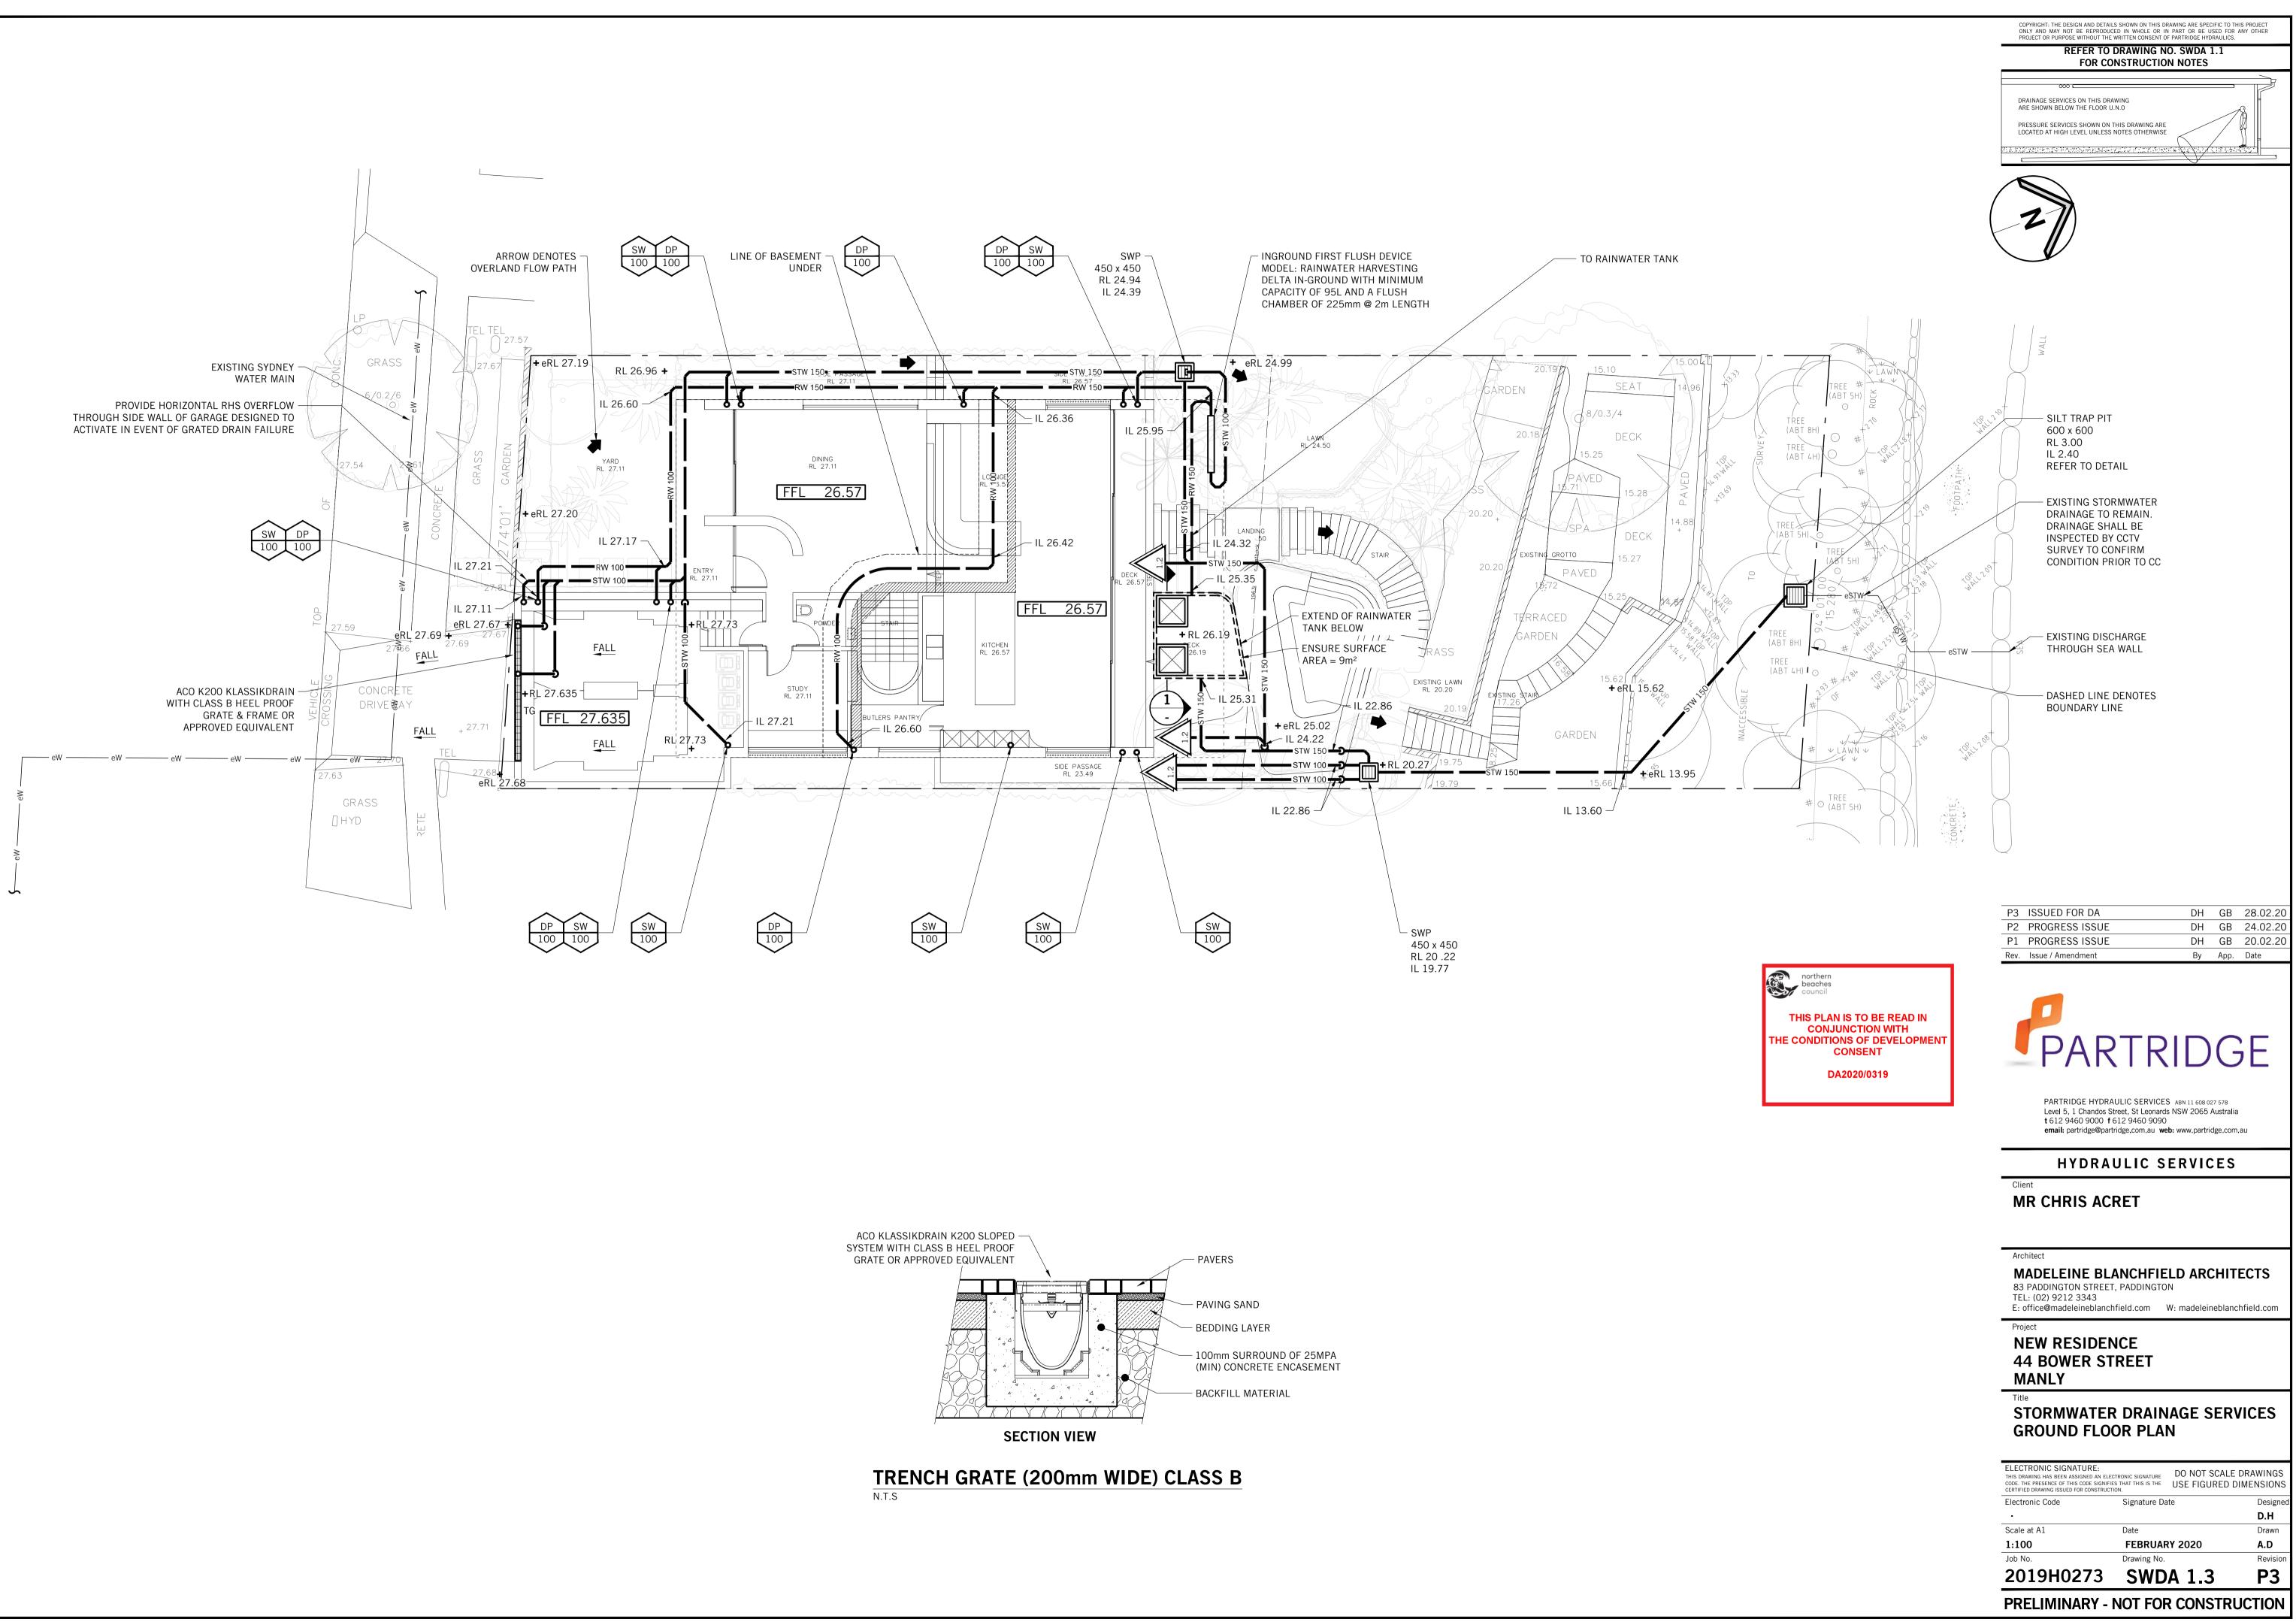

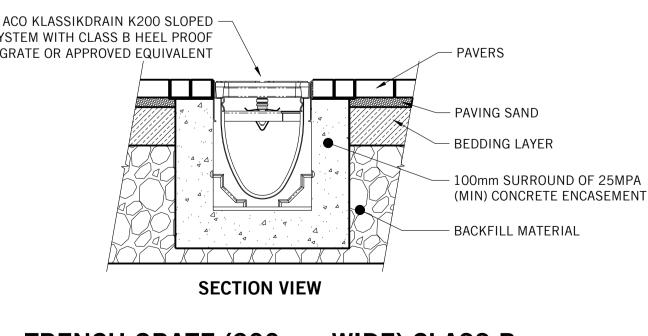

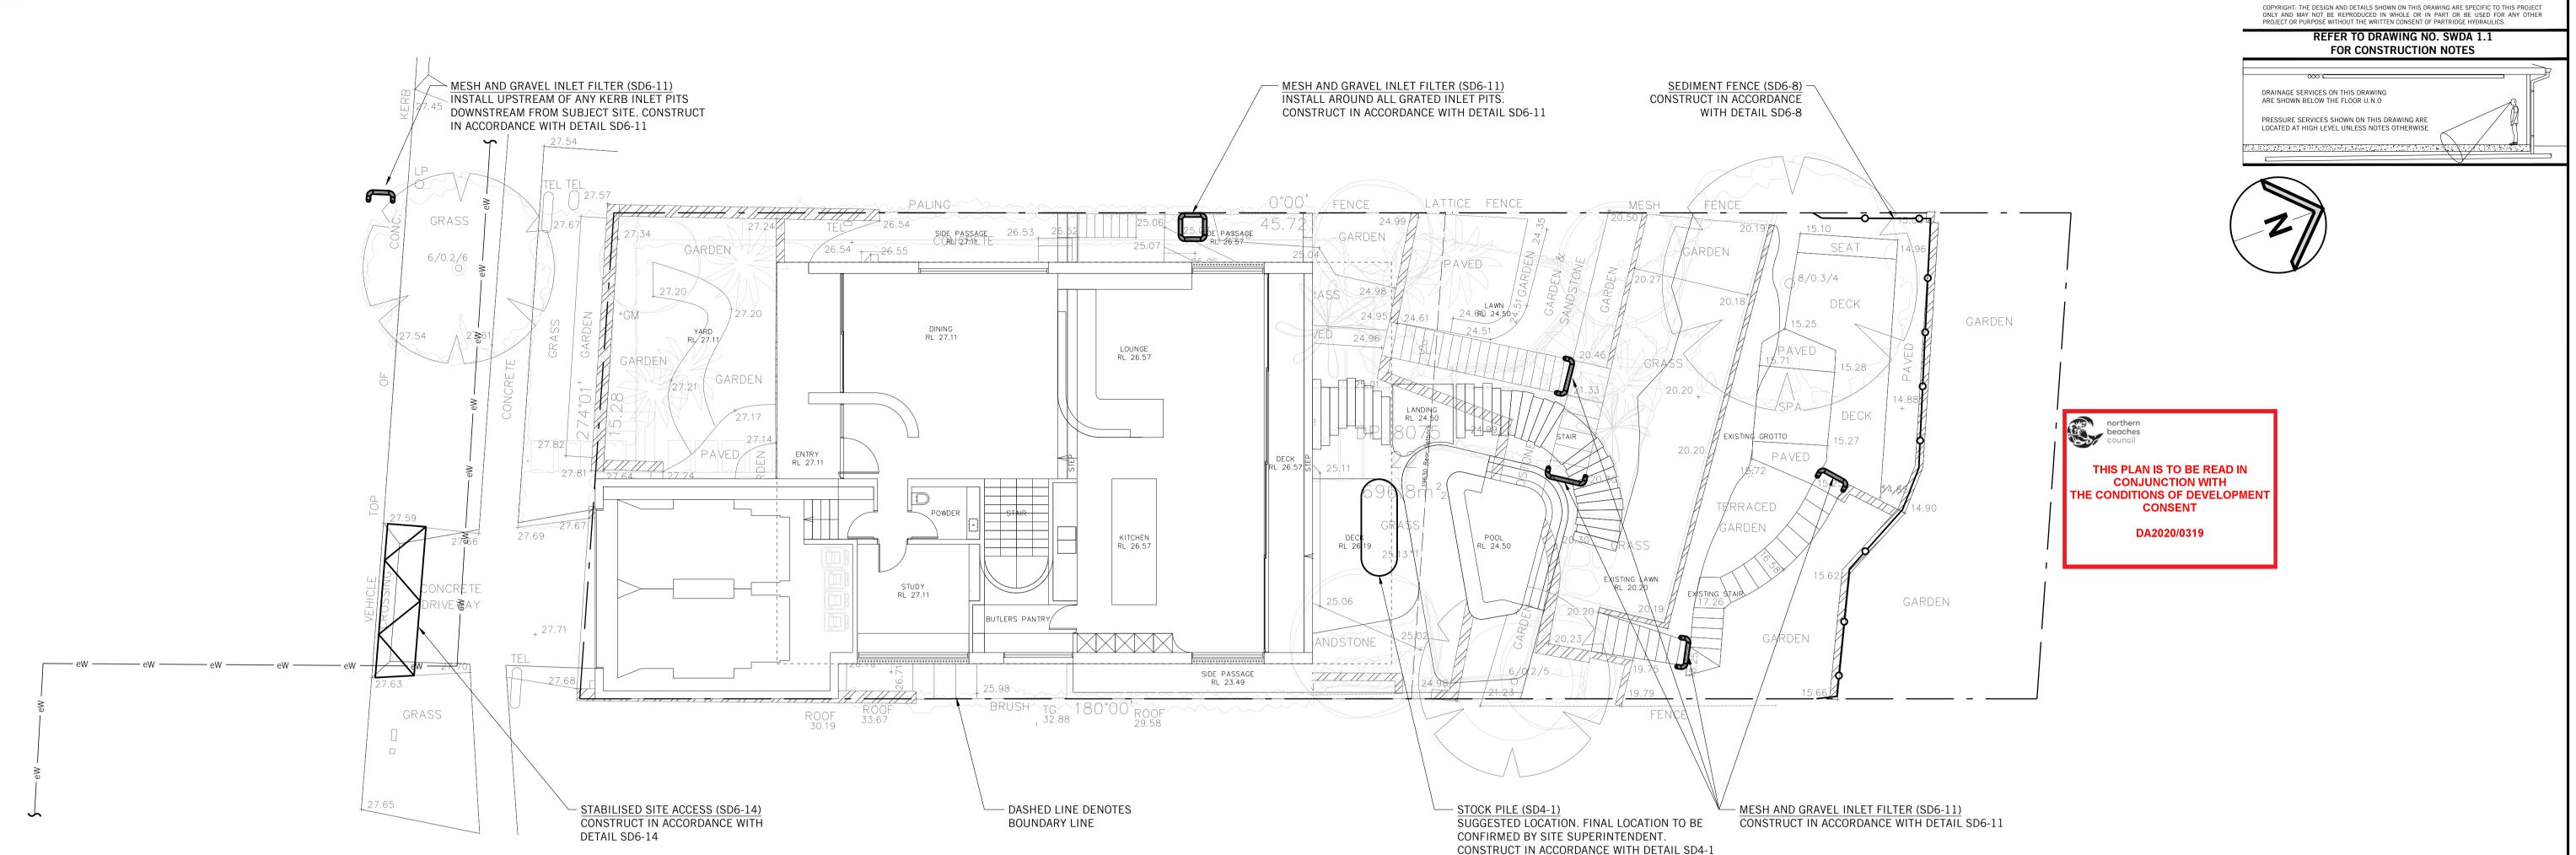

### **EROSION AND SEDIMENT CONTROL PLAN**

- 1. MEASURES PROVIDED WILL BE TO THE SATISFACTION OF THE PRINCIPAL'S REPRESENTATIVE IN ACCORDANCE WITH THE LOCAL AND STATUTORY REQUIREMENTS UNLESS NOTED OTHERWISE. ALL WORKS SHALL BE ERECTED AND CONSTRUCTED IN ACCORDANCE WITH THE LATEST EDITIONS OF THE 'BLUE BOOK'-MANAGING URBAN STORMWATER (MUS): SOILS AND CONSTRUCTION, LANDCOM (VOL 1), NORTHERN BEACHES COUNCIL'S DEVELOPMENT CONTROL PLAN (DCP) AND THE "DO IT RIGHT ON SITE, SOIL AND WATER MANAGEMENT FOR THE CONSTRUCTION INDUSTRY" PUBLISHED BY THE SOUTHERN SYDNEY REGIONAL ORGANISATION OF COUNCILS 2001.
- 2. ALL EXCAVATION WORKS ARE TO BE IN ACCORDANCE WITH THE GEOTECHNICAL REPORT, IF AVAILABLE, AND THE STRUCTURAL ENGINEER'S DRAWINGS.
- 3. INSTALL EROSION AND SEDIMENT CONTROL MEASURES PRIOR TO COMMENCEMENT OF CONSTRUCTION WORKS.
- 4. MESH AND GRAVEL INLET FILTERS (SD 6-11) TO BE INSTALLED UPSTREAM OF PROPOSED STORMWATER PITS AS WELL AS EXISTING STORMWATER PITS DOWNSTREAM OF DISTURBED AREAS.
- 5. TOP SOIL WILL BE STRIPPED AND STOCKPILED (SD 4-1) FOR LATER USE IN LANDSCAPING.
- 6. ALL STOCKPILES TO BE CLEAR FROM DRAINS, GUTTERS AND FOOTPATHS.
- WITHIN 20 WORKING DAYS OF THE COMPLETION OF WORKS.
- DISPOSAL AT A LICENSED TREATMENT FACILITY. 9. ROADS AND FOOTWAYS TO BE SWEPT AT THE END OF THE DAY.
- 10. ALL EROSION AND SEDIMENT CONTROLS WILL BE CHECKED AT LEAST WEEKLY AND AFTER RAINFALL EVENTS TO MAKE SURE THEY ARE MAINTAINED TO A FULLY FUNCTIONAL CONDITION.

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P1	PROGRESS ISSUE	DH	GB	20.02.20
Rev.	Issue / Amendment	Bv	App.	Date

7. TOP SOIL WILL BE RE SPREAD AND ALL DISTURBED AREAS WILL BE REHABILITATED

8. ALL SEDIMENT TO BE STORED AND COLLECTED BY A LIQUID WASTE COMPANY FOR

# PARTRIDGE

PARTRIDGE HYDRAULIC SERVICES ABN 11 608 027 578 Level 5, 1 Chandos Street, St Leonards NSW 2065 Australia t 612 9460 9000 f 612 9460 9090 email: partridge@partridge.com.au web: www.partridge.com.au

HYDRAULIC SERVICES

### MR CHRIS ACRET

Client

Architect				
<b>MADELEINE BLA</b> 83 PADDINGTON STREET TEL: (02) 9212 3343 E: office@madeleineblanch	, PADDING	TON	<b>ARCHIT</b>	
Project NEW RESIDEN 44 BOWER ST MANLY				
Title STORMWATER DRAINAGE SERVICES EROSION AND SEDIMENT CONTROL				
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