## COVICH RESIDENCE

# PROPOSED ALTERATIONS AND ADDITIONS

11 BEACON AVENUE, BEACON HILL N.S.W. 2100

20 JUNE, 2019

#### PLAN OR DOCUMENT CERTIFICATION

I AM A QUALIFIED STRUCTURAL DRAFTSPERSON I HOLD THE FOLLOWING QUALIFICATIONS

BUILDING CERTIFICATE - SYDNEY TAFE
MEMBER: BUILDING DESIGNERS ASSOCIATION AUSTRALIA - Accreditation No. 6255

FURTHER I AM APPROPRIATELY QUALIFIED TO CERTIFY THIS

COMPONENT OF THE PROJECT.

I HEREBY STATE THAT THESE PLANS OR DETAILS COMPLY WITH THE CONDITIONS OF DEVELOPMENT CONSENT OF THE APPROPRIATE LOCAL GOVERNMENT AUTHORITY AND / OR THE RELEVANT AUSTRALIAN

BUILDING INDUSTRY STANDARDS.

SALLY GARDNER 20/06/19

NAME

20/06/19 DATE Sally Gardner





47 Towradgi Street, Narraweena, NSW, 2099 Australia ABN 17 751 732 195 Accreditation Number 6255 www.designanddraft.com.au

#### SPECIFICATION:

- "Approval" obtained by either an "Accredited Certifying Authority" or "Local Council".
- The Owner will directly pay all fees associated with the following: building approval from Council or Accredited Certifier, any footpath and kerb deposits with the local council, insurance fees to Building Services Corporation, Long Service Leave Levies and approval fees by water and sewerage authorities. All other fees are to be paid by the Builder.
- The amount of any local authority deposits which are forfeited due to damage or other causes, will be deducted from payments due to the Builder.
- The Builder is to provide at his/her own expense, adequate Public Risk Insurance and arrange indemnification under the Workers Compensation Act. Works insurance to be as stated in the contract conditions.
- All tenderers are to visit the site to satisfy themselves as to the nature and extent of the works, facilities available and difficulties entailed in the works, as variations will not be allowed due to work arising owing to neglect of this clause.
- These drawings shall be read in conjunction with all structural and other consultant's drawings and specifications and with any such written instructions as may be issued during the course of the contract.
- Set out dimensions shown on the drawings shall be verified by the Builder on site before commencement of any work. Dimensions shall not be obtained by scaling the drawings. Use only figured dimensions. All dimensions are in millimetres.
- The Builder is to ensure all construction, levels and other items comply with the conditions of the Building Approval.
- Any detailing in addition to what is supplied shall be resolved between the Owner and the Builder, to the Owner's approval, except for any structural details or design which is to be supplied by the Engineer.
- All work to be carried out in a tradesman like manner and in accordance with the standards, codes and regulations of the Standards Association of Australia, National Construction Code of Australia and any Statutory Authority having jurisdiction over the works.
- All structural work is to be in accordance with the structural details prepared by a suitably qualified Structural Engineer. Including but not limited to, all piers, footings, concrete slabs, retaining walls, steelwork, formwork, underpinning, additional structural loads, timber framing, wind bracing and associated connections. Builder to obtain prior to finalising tender, unless previously obtained by owners.
- All brickwork is to be selected by owners and is to comply with AS 1640. All masonry is to comply with AS 3700.
- -Provide all metalwork and flashings necessary to satisfactorily complete the works.
- All timber construction to be in accordance with AS 1684 "Timber Framina Code".
- All glazing installed is to comply with AS 1288, AS 2047 and in accordance with manufacturer's recommendations.

- All wall and ceiling linings to be plasterboard or cement render as selected and villaboard or equal in wet areas. Workmanship is to comply with the relevant Australian Standards or installed in accordance with manufacturer's specifications.
- All bathrooms and wet areas to be adequately waterproofed to manufacturer's specification and in accordance with AS 3740 and Part 3.8.1 of the National Construction Code - Volume 2, provisions for Class 1 and Class 10 buildings.
- All architraves and skirtings to be to owner's selection or provide standard colonial mouldings or to match existing. Paint or stain finish as selected.
- All plumbing and drainage works to be installed and completed by a licenced tradesperson and in accordance with the statutory body having authority over the works. Connect all waste to Sydney Water sewer line.
- Connect all stormwater to existing system or street drainage system in accordance with AS 3500 and part 3.1.2 Drainage, of the National Construction Code - Volume 2, provisions for Class 1 and Class 10
- Smoke detector alarms to be installed in accordance with AS3786 and part 3.7.2 of the National Construction Code - Volume 2, provisions for Class 1 and Class 10 buildings
- Termite protection measures to comply with AS3660 and be installed to manufacturer's specification.
- Stairs and Balustrades to comply with part 3.9.1 & 3.9.2 of the National Construction Code - Volume 2, provisions for Class 1 and Class 10 buildings.
- Electrical works to be in accordance with SAA wiring rules and be done by a licensed tradesman. Obtain electrical layout prior to proceeding. All electrical power (GPO) and light outlets to be determined by owner.
- Any work indicated on the plans but not specified and any item not shown on the plans which is obviously necessary as part of proper construction and/or finish, is to be considered as shown and specified and is to be undertaken at the Builder's expense.
- Variations will not be permitted without prior written approval by the
- The Builder shall provide sediment and siltration control measures as required by Council and maintain them throughout the duration of
- A legible copy of the plans bearing approval stamps, must be maintained on the job site at all times. Hours of construction shall be restricted to the times as required by the building approval.
- The Builder is to arrange for all inspections required by the relevant authorities and/or lending institutions, to their requirements.
- The Builder is to obtain approval for interruptions to existing services and minimise the duration and number of interruptions. Any interruptions to existing services and equipment is to be undertaken by appropriately qualified tradespersons.
- The Builder shall restore, reinstate or replace any damage to existing structures or landscaping caused by the construction works or
- Provide protection to existing trees to remain, or as required by the Approval Conditions.

#### DRAWING SCHEDULE

Title Sheet

- N1. Specification & Drawing List
- N2. Schedules & Basix Commitments
- E1. Existing Ground Floor Plan
- A1. Roof Plan
- A2. Proposed Upper Floor Plan
- A3. Proposed Ground Floor Plan
- A4. Elevations Sheet 1 of 2
- A5. Elevations Sheet 2 of 2
- A6. Sections
- S1. Site Analysis Plan
- 52. Site Plan and Calculations
- S3. Sediment Control & Site Management Plan
- 54. Shadow Diagram at 9am
- 55. Shadow Diagram at 12 noon
- S6. Shadow Diagram at 3pm



THIS PLAN IS TO BE READ IN **CONJUNCTION WITH** THE CONDITIONS OF DEVELOPMENT CONSENT

DA2019/0807

		Accreditation Number 6255 🔷 🇳	
			No.
		BUILDING DESIGNERS SALLY GARDNER DESIGN AND DRAFT	
Data	Amondmonta	ASSOCIATION OF AUSTRALIA PLANS DRAWN FOR APPROVAL	

47 Towradgi Street Clients Narraweena, NSW, 2099

http://www.designanddraft.com.au

ABN 17 751 732 195

Adrian & Nicole COVICH

Project PROPOSED ALTERATIONS & ADDITIONS 11 BEACON AVENUE, BEACON HILL

Drawing Title

SPECIFICATION & DRAWING LIST

rue North	Scale 1:100	1:100 @ A3		
	Drawn	Checked		
	R.G.	S.G.		

20 June, 2019

N1

18-1206

#### WINDOW SCHEDULE LOCATION FRAME / GLAZING STYLE U value: SHGC NO HEIGHT WIDTH Additional Basix Requirements W1 0.600 2.400 Bed 1 Powder Coated Aluminium framed Fixed / Louvred window with clear glazing 6.44 : 0.75 W2 1.100 Bed 1 Powder Coated Aluminium framed Fixed / Double Hung window with clear glazing 6.44 : 0.75 3.000 6.44 : 0.75 W3 0.600 2.400 Bed 1 Powder Coated Aluminium framed Fixed / Louvred window with clear glazing W4 1.100 1.250 Bathroom Powder Coated Aluminium framed Sliding window with clear glazing 6.44 : 0.75 W5 0.750 1.100 Bathroom Powder Coated Aluminium framed Louvred window with frosted glazing 6.44 : 0.75 W6 1.100 0.995 Retreat Powder Coated Aluminium framed Double Hung window with clear glazing 6.44 : 0.75 W7 0.850 Retreat Powder Coated Aluminium framed Double Hung window with clear glazing 1.100 6.44 : 0.75 Powder Coated Aluminium framed Double Hung window with clear glazing Require Fixed Awning to 900mm projection W8 1.100 1.000 Retreat 6.44 : 0.75 W9 Powder Coated Aluminium framed Double Hung window with clear glazing Require Fixed Awning to 900mm projection 1.100 1.000 Retreat 6.44 : 0.75 W10 1.100 0.455 Retreat Powder Coated Aluminium framed Louvred window with clear glazing 6.44 : 0.75 W11 Retreat Powder Coated Aluminium framed Fixed / Double Hung window with clear glazing 1.100 1.500 6.44 : 0.75 W12 1.100 1.225 Retreat Powder Coated Aluminium framed Sliding window with clear glazing 6.44 : 0.75 W.I.R. W13 0.600 0.650 Powder Coated Aluminium framed Louvred window with clear glazing 6.44 : 0.75 W14 0.600 Open Plan Living Powder Coated Aluminium framed Double Hung window with clear glazing 1.155 6.44 : 0.75 W15 1.155 0.600 Open Plan Living Powder Coated Aluminium framed Double Hung window with clear glazing 6.44 : 0.75 W16 1.300 3.710 Open Plan Living Powder Coated Aluminium framed Bi-fold Doors with clear glazing 6.44 : 0.75 W17 2.100 Open Plan Living Powder Coated Aluminium framed Sliding Door with clear glazing 6.44 : 0.75 1.930 W18 2.100 3.170 Open Plan Living Powder Coated Aluminium framed Stacking Sliding Doors with clear glazing 6.44 : 0.75 W19 Kitchen Powder Coated Aluminium framed Fixed window with frosted glazing 0.600 2.400 6.39 : 0.56 Requires Shade Projection to min. 260mm W20 Powder Coated Aluminium framed Louvred window with clear glazing 1.210 0.600 Pantry Requires Shade Projection to min. 510mm 6.44 : 0.75

#### BASIX COMMITMENTS

TAPS: Must have a flow rate no greater than 9 litres per minute or a minimum 3 star water rating.

TOILETS: Must have a flow rate no greater than 4 litres per average flush or a minimum 3 star water rating.

SHOWER HEADS: Must have a flow rate no greater than 9 litres per minute or a 3 star water rating.

Install aerators on bathroom hand basins & kitchen sinks.

LIGHTING: Basix requirements
A minimum of 40% of new or altered light
fixtures must be fitted with flourescent,
compact flourescent or light-emitting diode
(LED) lamps.

All sizes listed include the frame and are nominal sizes for BASIX Certification.

All glazing assemblies will comply with AS2047 and AS1288

All external glazing is to have a maximum reflectivity index of 25%.

#### DOOR & WINDOW NOTE:

All Doors and Windows to be keyed alike with deadlocks to all sashes & doors. Provide weather strips and door seals around openings to prevent drafts.

All new bedroom windows, where the floor level of the room is 2.0m or more above outside finished ground level, must be supplied with either permanently fixed robust mesh screens or permanent window locks which prevent the window from opening more than 125mm, if the lowest openable portion of the window is within 1.7m of the floor, in accordance with NCC requirements, for child safety.

Wind loading compliance to all new windows and glazed doors to be confirmed by the Engineer prior to ordering and installation.

#### SKYLIGHT SCHEDULE

NO.	HEIGHT	WIDTH	LOCATION	FRAME / GLAZING STYLE	U value : SHGC
S1	0.98	0.55	Open Plan Living	Timber framed Double clear / Air filled	4.3 : 0.5
S2	0.98	0.55	Open Plan Living	Timber framed Low-e / Argon filled / clear external	2.5 : 0.456
S3	0.98	0.55	Kitchen	Timber framed Low-e / Argon filled / clear external	2.5 : 0.456
S4	0.98	0.55	Kitchen	Timber framed Low-e / Argon filled / clear external	2.5 : 0.456
S5	0.98	0.55	Kitchen	Timber framed Low-e / Argon filled / clear external	2.5 : 0.456

#### BASIX INSULATION SCHEDULE

Construction	Additional insulation required (R-value)	
suspended floor with open subfloor: framed (R0.7).	R0.8 (down) (or R1.50 including construction)	
floor above existing dwelling or building.	nil	
external wall: framed (weatherboard, fibro, metal clad) (R0.40)	R1.30 (or R1.70 including construction)	
flat ceiling, pitched roof	ceiling: R3.00 (up), roof: foil/sarking	

Accorditation Number 6255

		all all	Accidentation Number 0233		
					(cpc)
			DECICE.		(SDS)
		BUILDING DESIGNERS	SALLY GARDNER DESIGN AND	DRAFT	
Date	Amendments	ASSOCIATION OF AUSTRALIA	PLANS DRAWN FOR APPROVAL	JIMI I	SustainAbility Design™ Specialist

47 Towradgi Street Clients Narraweena, NSW, 2099

ABN 17 751 732 195


list http://www.designanddraft.com.au

Adrian & Nicole

COVICH

Drawing Title

### ROOF / GUTTERING COLOUR

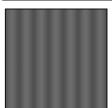

Colour classification in accordance with NSW Basix (Dark - solar absorbance > 0.70) "Basalt" - Colorbond roof sheeting.

#### WALLS / DOWNPIPES COLOUR



PROPOSED ALTERATIONS & ADDITIONS
11 BEACON AVENUE, BEACON HILL

SCHEDULES & BASIX NOTES

True North

1:100 @ A3


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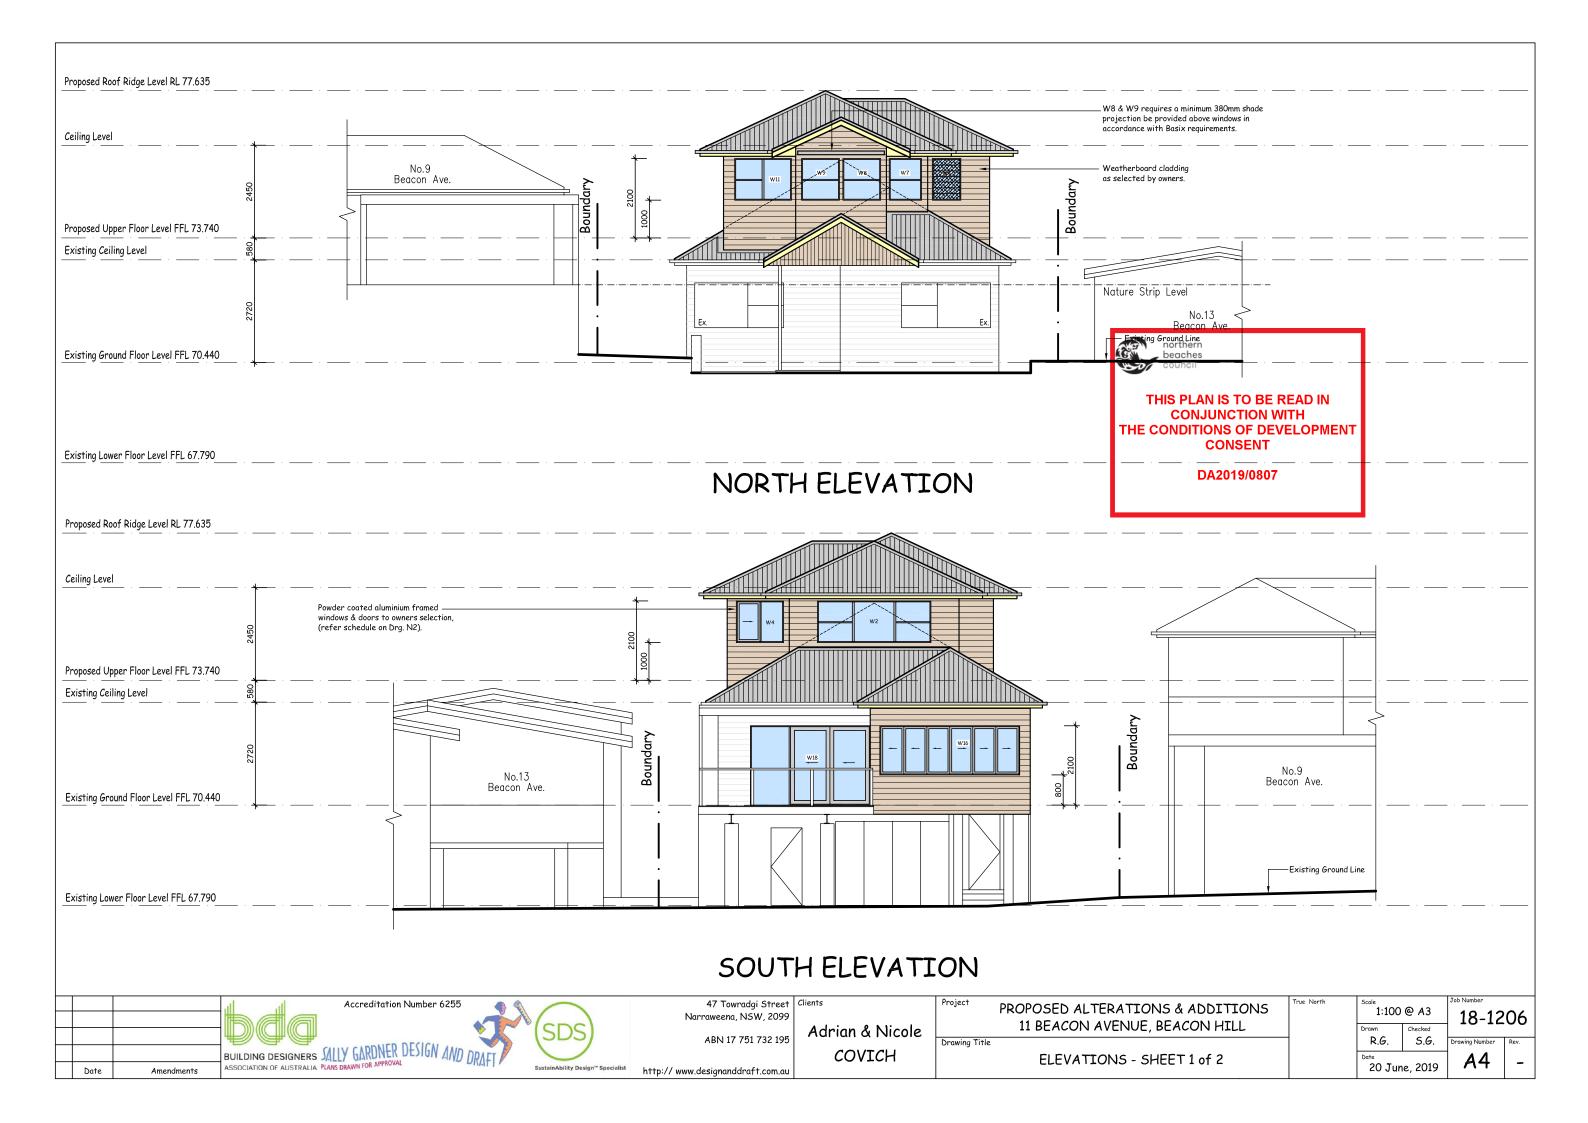
Date


Job Number
18–1206


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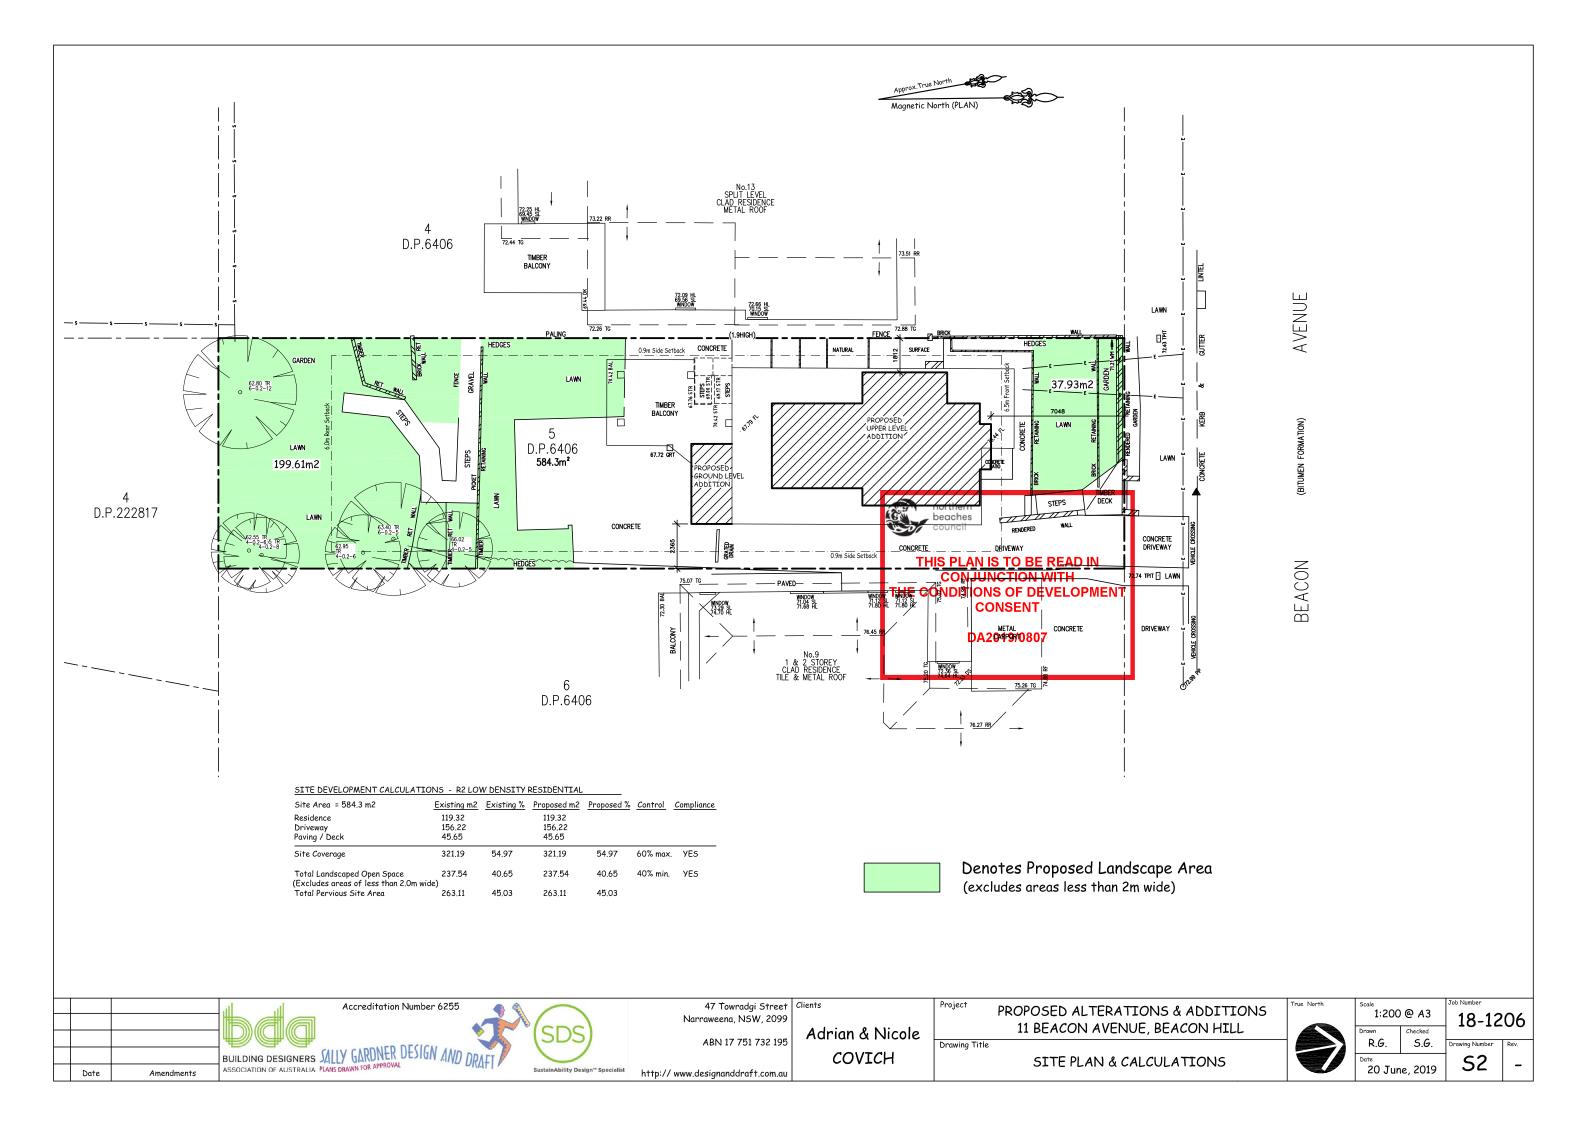
ate 20 June, 2019 N2






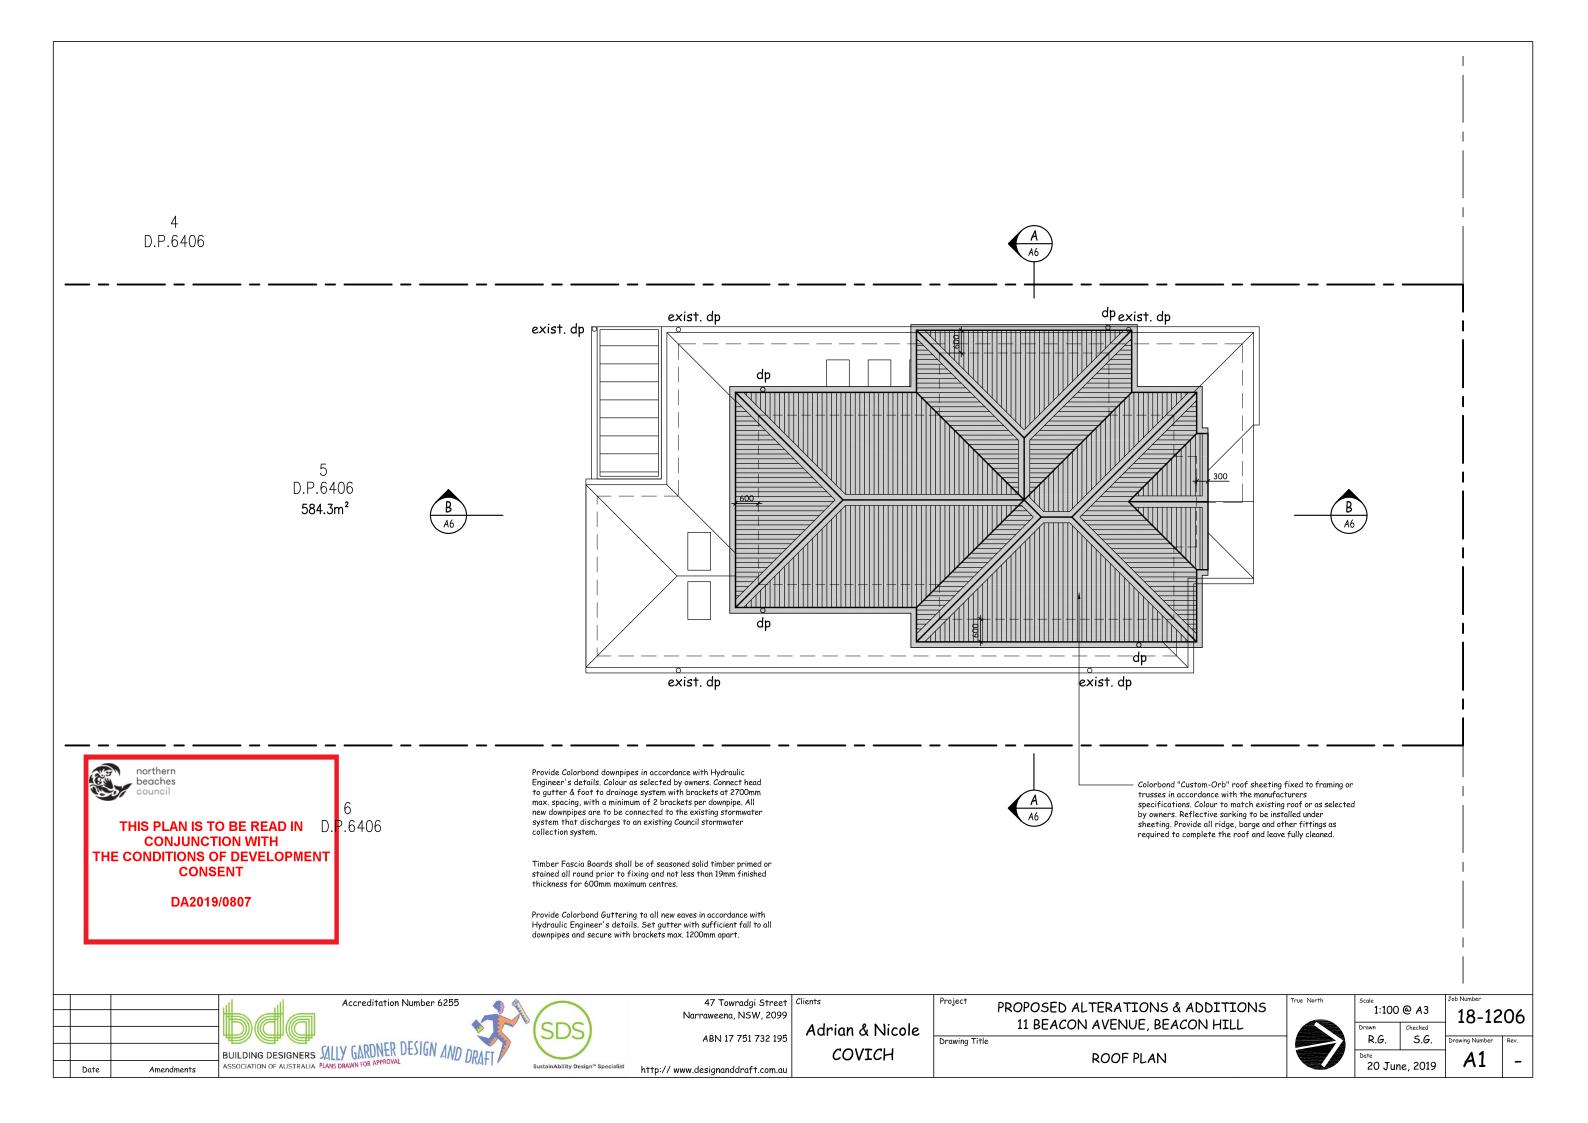

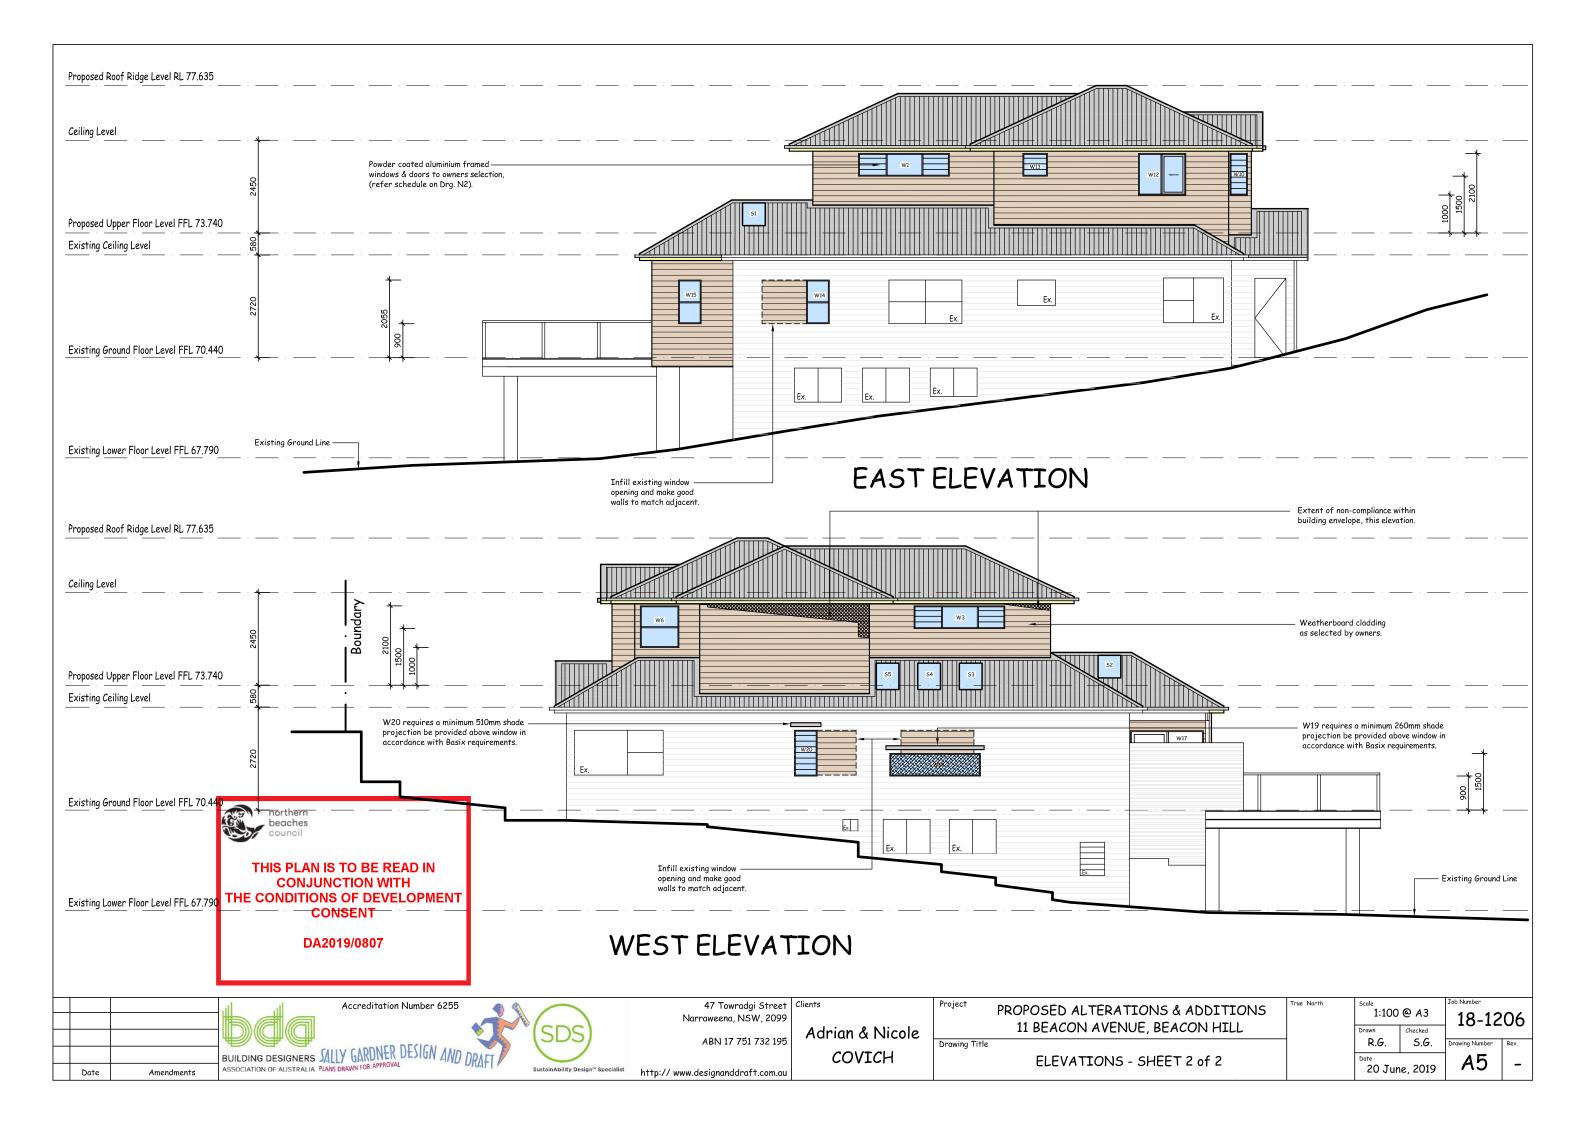

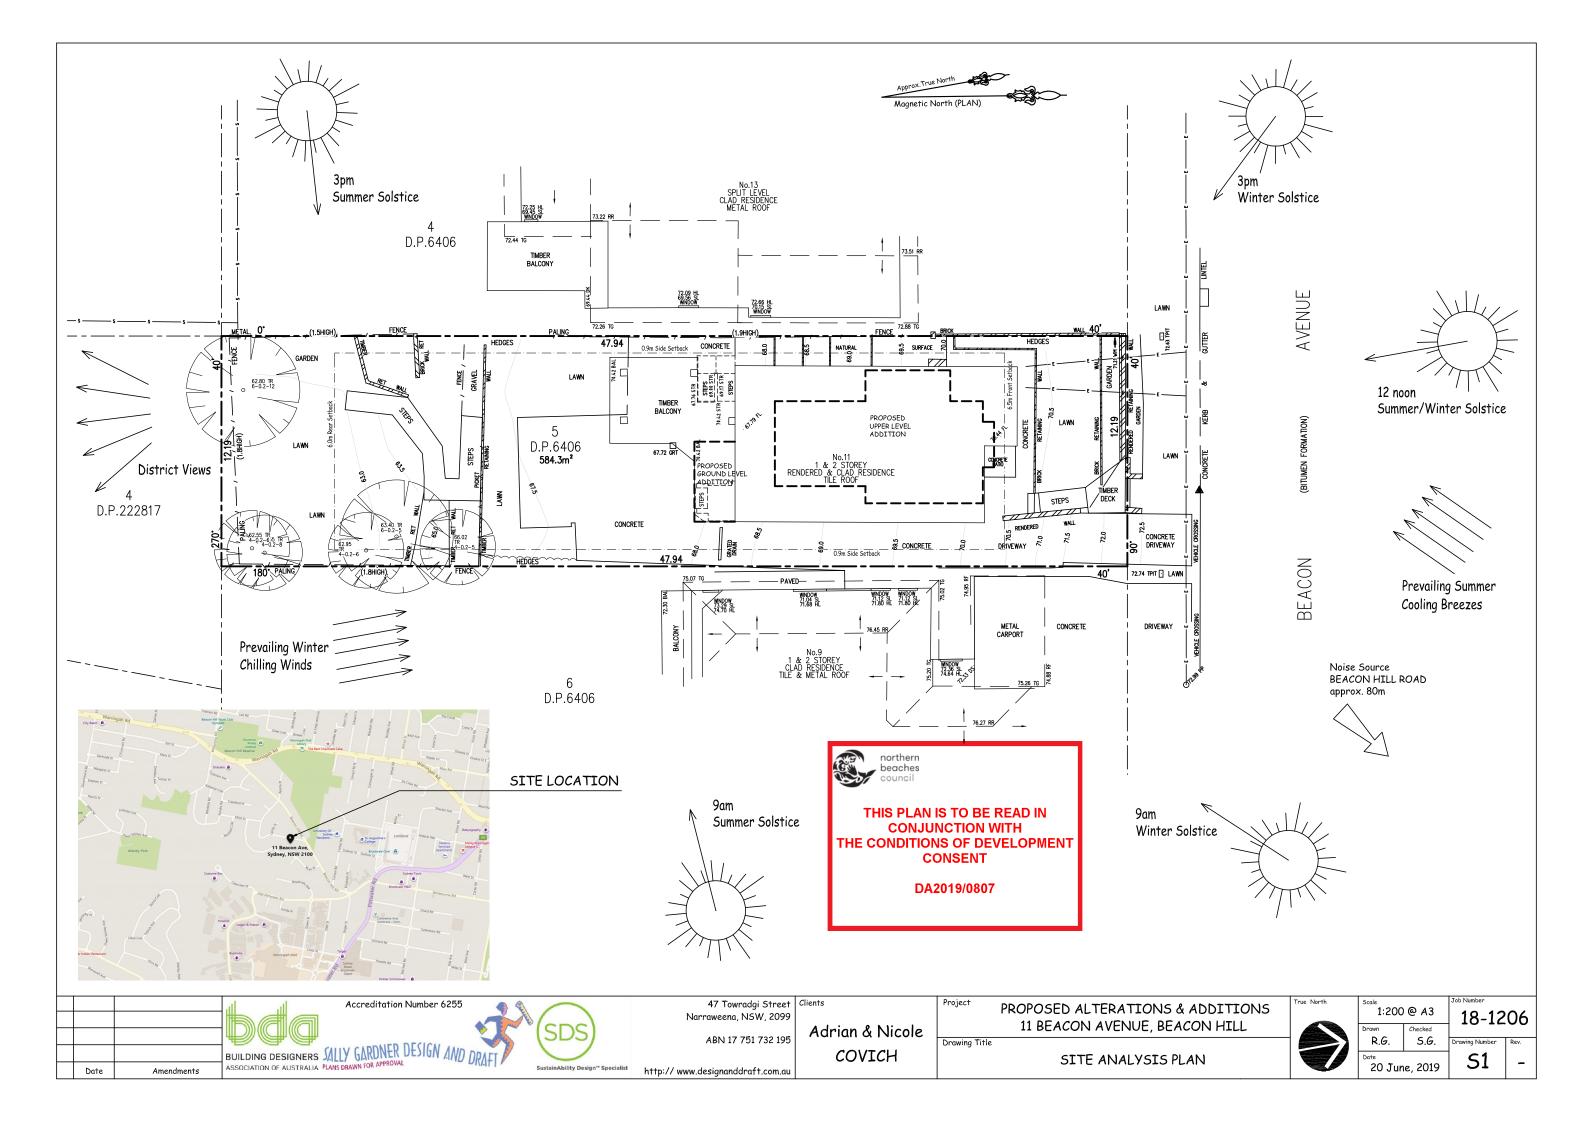

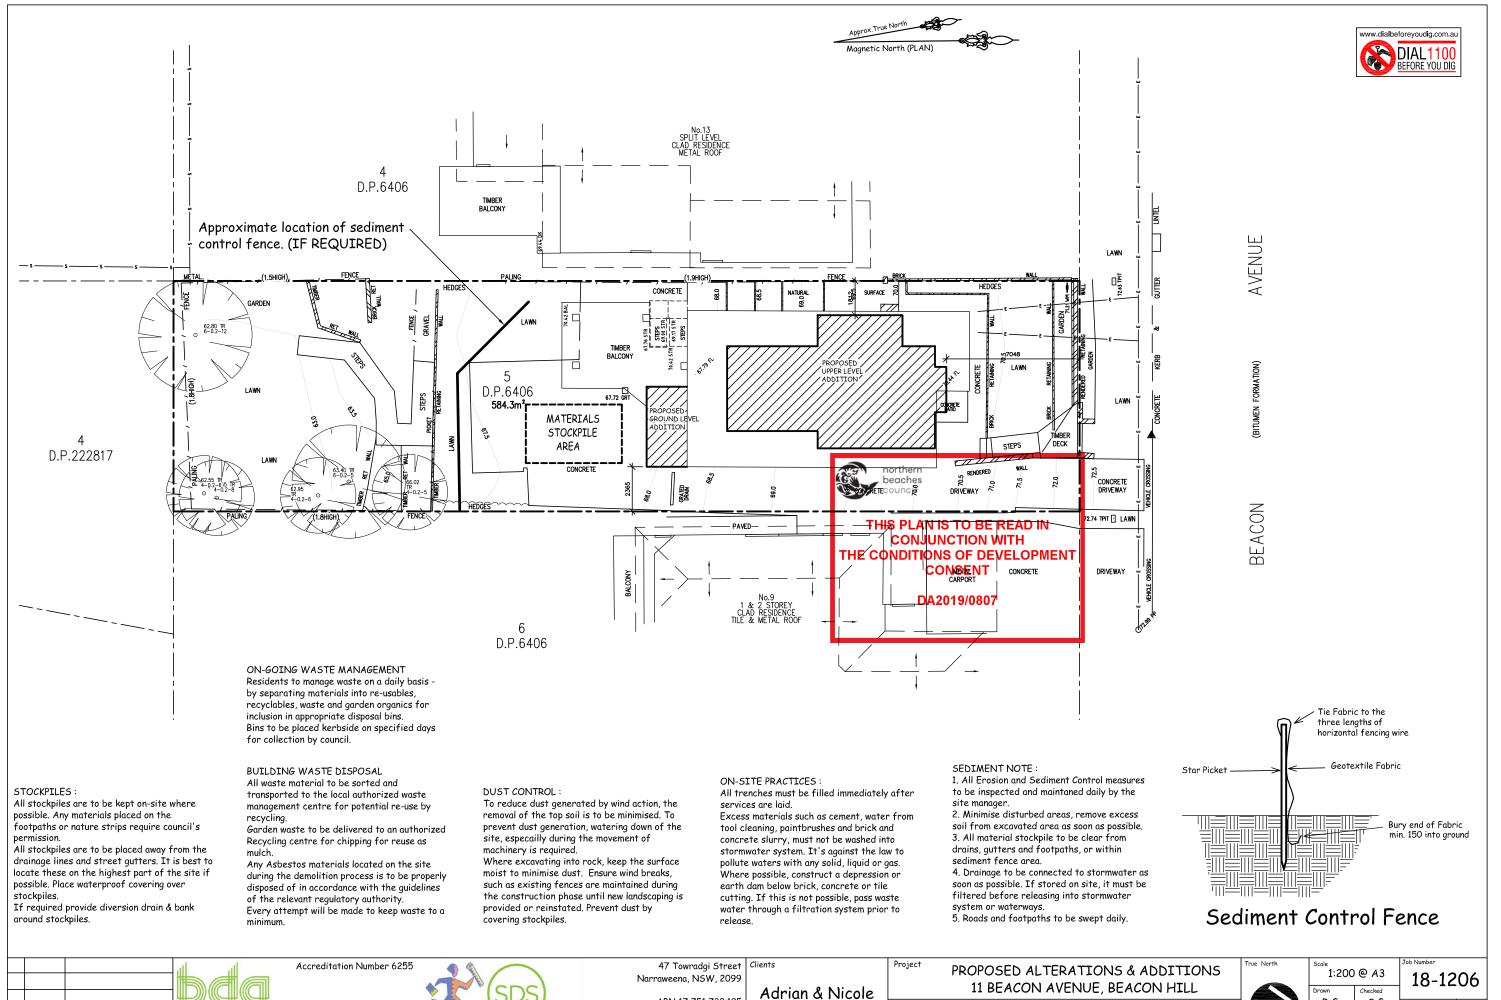

ABN 17 751 732 195 BUILDING DESIGNERS SALLY GARDNER DESIGN AND DRAFT COVICH Date Amendments http://www.designanddraft.com.au

SEDIMENT CONTROL & SITE MANAGEMENT PLAN

North	1:200	18-1	
	Drawn R.G.	Checked <b>5.G</b> .	Drawing Numbe
	Date 20 Jun	53	

