

# **ACTION PLANS**

m: 0426 957 518

e: operations@actionplans.com.au

w: www.actionplans.com.au


### **DEVELOPMENT APPLICATION**

These plans are for Development Approval only.

SHEET NUMBER	SHEET NAME	DATE PUBLISHED
DA00	COVER	9/12/2019
DA01	SITE ANALYSIS	9/12/2019
DA02	SITE / ROOF / SEDIMENT EROSION / WASTE MANAGEMENT / STORMWATER CONCEPT PLAN	9/12/2019
DA03	EXISTING GROUND FLOOR PLAN	9/12/2019
DA04	EXISTING FIRST FLOOR PLAN	9/12/2019
DA05	PROPOSED GROUND FLOOR PLAN	9/12/2019
DA06	PROPOSED FIRST FLOOR PLAN	9/12/2019
DA07	NORTH / SOUTH ELEVATION	9/12/2019
DA08	EAST ELEVATION	9/12/2019
DA09	WEST ELEVATION	9/12/2019
DA10	LONG / CROSS SECTION	9/12/2019
DA11	AREA CALCULATIONS / SAMPLE BOARD	9/12/2019
DA12	WINTER SOLSTICE 9 AM	9/12/2019
DA13	WINTER SOLSTICE 12 PM	9/12/2019
DA14	WINTER SOLSTICE 3 PM	9/12/2019
DA15	BASIX COMMITMENTS	9/12/2019

ITEM DETAILS	DEVELOPMENT APPLICATION			
ADDRESS	18-20 DENISON STREET, MANLY NSW, 2095			
LOT & DP/SP	SP 85482			
COUNCIL	NORTHERN BEACHES COUNCIL (MANI	LY)		
SITE AREA	331.4m²	-		
FRONTAGE	10.69m			
CONTROLS	PERMISSIBLE / REQUIRED	EXISTING	PROPOSED	COMPLIANCE
	m / m² / %	m / m² / %	m / m² / %	
<u>LEP</u>				
LAND ZONING	R3 – MEDIUM DENSITY RESIDENTIAL	R3	R3	YES
MINIMUM LOT SIZE	250m²	331.4m²	UNCHANGED	YES
FLOOR SPACE RATIO	0.75 : 1 (248.55m²)	0.71 : 1 (227.92m²)	0.74 : 1 (242.03m²)	YES
MAXIMUM BUILDING HEIGHT	11m	7.45m	UNCHANGED	YES
HAZARDS				
ACID SULFATE SOILS	CLASS 4			
FORSHORE SCENIC PROTECTION AREA	YES			
HERITAGE CONSERVATION AREA	YES			
DCP				
RESIDENTIAL OPEN SPACE	AREA OS2			
TOTAL OPEN SPACE (TOS)	50% (165.70m²)	22.55% (74.75m²)	22.46% (74.45m²)	NO
LANDSCAPED AREA	30% OF TOS (50%): 49.71m <sup>2</sup>	39.1 % (64.84m²)	UNCHANGED	YES
OPEN SPACE ABOVE GROUND	MAX. 40% OF TOS (50%): 66.28m <sup>2</sup>	N/A	N/A	YES
PRINCIPAL PRIVATE OPEN SPACE	12m² per dwelling	34.45m² / 34.68m²	UNCHANGED	YES
FRONT SETBACK	PREVALING BULDING LINE (1.43m)	1.46m	UNCHANGED	YES
REAR SETBACK	8.0m	7.475m	UNCHANGED	NO
SIDE SETBACKS	1/3 WALL HEIGHT Wall 7.175/3= 2.39m	No. 18 E: 1.007m No. 20 W: 0.32m	UNCHANGED	NO
CAR PARKING SPACES	Required: 1	1	UNCHANGED	YES

### **18-20 DENISON STREET MANLY NSW 2095**

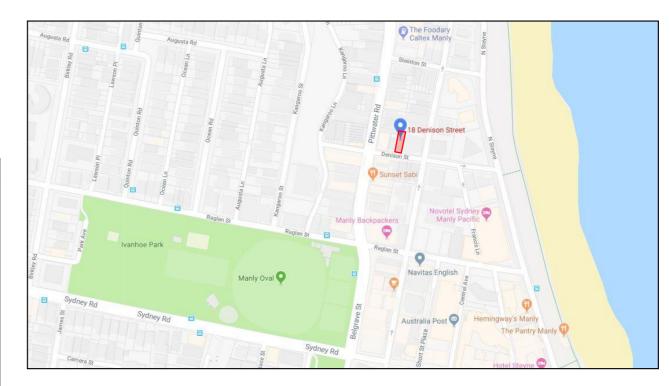

### **NCC & AS COMPLIANCES SPECIFICATIONS**

- EARTHWORKS: METHOD OF EXCAVATION AND FILL - PART 3.1.1 OF NCC - SURFACE SUBSOIL-STORMWATER DRAINAGE - PART 3.1.2 OF NCC

- TERMITE-RISK MANAGEMENT - PART 3.1.3 OF NCC

- FOOTINGS & SLAB - PART 3.2 OF NCC INCLUDING AS2870 - MASONRY CONSTRUCTION - PART 3.3 OF NCC INCLUDING AS3700

- SUB FLOOR VENTILATION - PART 3.4.1 OF NCC

- FRAMING - PART 3.4 OF NCC

- ROOF, WALL-CLADDING, GUTTERS & DOWNPIPES - PART 3.5 OF NCC - GLAZING - PART 3.6 OF NCC INCLUDING AS1288

- FIRE SEPARATION - PART 3.7.1 OF NCC - SMOKE ALARMS - PART 3.7.2 OF NCC

- HEATING APPLIANCES - PART 3.7.3 OF NCC

- WET AREAS-PROTECTION OF WALLS & FLOORS - PART 3.8.1 OF NCC

- MINIMUM ROOF HEIGHTS - PART 3.8.3 OF NCC

- FACILITIES REQUIRRED & SANITARY DOOR CONSTRUCTION - PART 3.8.3 OF NCC - LIGHT: NATURAL AND ARTIFICIAL - PART 3.8.4 OF NCC

- VENTILATION & LOCATION OF TOILETS - PART 3.8.5 OF NCC

- SOUND INSULATION - PART 3.8.6 OF NCC

- STAIR CONSTRUCTION INCLUDING DIMENSIONS - PART 3.9.1 OF NCC

- BALUSTRADES & OTHER BARRIERS - PART 3.9.2 OF NCC

- FENCING & OTHER PROVISIONS - REGS & AS1926

- DEMOLITION WORKS - AS2601-1991 THE DEMOLITION OF STRUCTURES.

- ALL WATERPROOF MEMBRANES TO COMPLY WITH WITH AS 3740-2004 - ALL PLUMBING & DRAINAGE WORK TO COMPLY WITH AS 3500

- SITE CLASSIFICATION AS TO AS 2870

- ALL PLASTERBOARD WORK TO COMPLY WITH AS 2588-1998

- ALL STRUCTURAL STEEL WORK TO COMPLY WITH AS 4100 & AS 1554

- ALL CONCRETE WORK TO COMPLY WITH AS 3600

- ALL ROOF SHEETING WORK TO COMPLY WITH AS 1562-1992

- ALL SKYLIGHTS TO COMPLY WITH WITH AS 4285-2007


- ALL CERAMIC TILING TO COMPLY WITH AS 3958.1-2007 & 3958.2-1992


- ALL GLAZING ASSEMBLIES TO COMPLY WITH AS2047 & 1288 - ALL TIMBER RETAINING WALLS ARE TO COMPLY WITH AS 1720.1-2010,


AS 1720.2-2006, AS 1720.4-2006, AS 1170.1-1989 & AS 1170.4-1993

- ALL RETAINING WALLS ARE TO COMPLY WITH 3700 - 2011 & AS 3600 -2001

- ALL CONSTRUCTION TO COMPLY TO AS3959- 1991

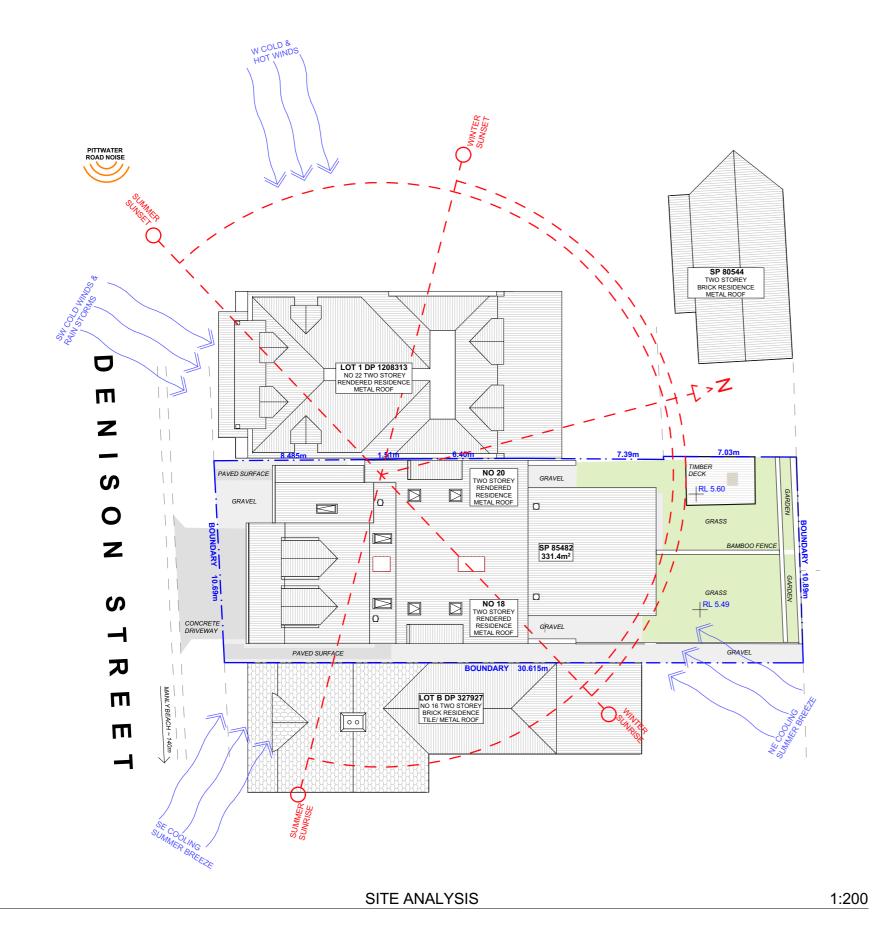

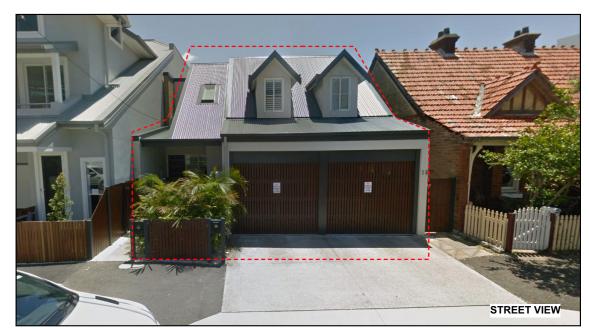

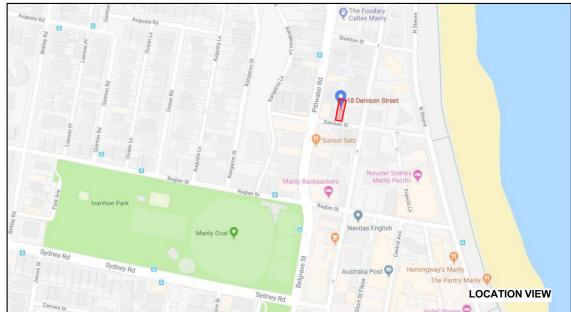




NOTE: ALL DEMOLISHED ELEMENTS TO ENG. SPECIFICATIONS AND AS. 2601 - 2001



REV.	DATE	COMMENTS	DRWN	NOTES This drawing is the copyright of Action Plans and not be	
А	30/08/19	DEVELOPMENT APPLICATION	AL	altered, reproduced or transmitted in any form or by any means in part or in whole with the written permission of	
В	09/12/19	REV A	EAS	Action Plans.  Do not scale measure from drawings. Figured dimensions	
				are to be used only. The Builder/Contractor shall check and verify all levels	
				dimensions on site prior to commencement of any work, creation of shop drawings, or fabrication of components.	
				All errors and omissions are to be verified by the Builder/Contractor and referred to the designer prior to the	

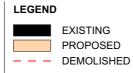

CLIENT

ADAM & SABINE MOORE and IAN & RHONDAH MCKELLAR

PROJECT ADDRESS


18-20 DENISON STREET MANLY NSW 2095


DRAWING NO.


**DA01** 

DATE Monday, 9 December 2019 DRAWING NAME SITE ANALYSIS

**SCALE** 1:200 @A3

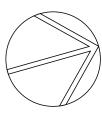

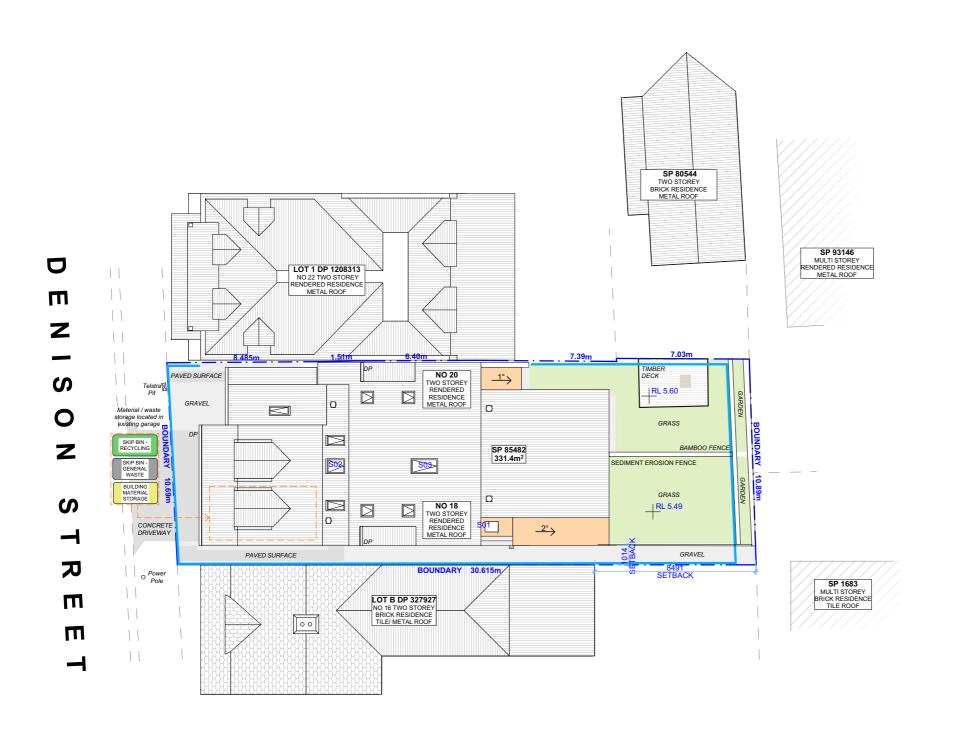

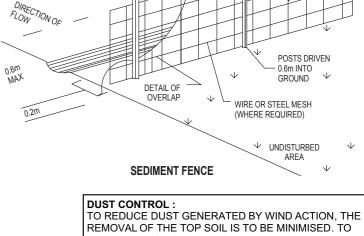

3m MAX

DISTURBED AREA

PREVENT DUST GENERATION, WATERING DOWN OF THE SITE, ESPECIALLY DURING THE MOVEMENT OF MACHINERY IS REQUIRED. WHERE EXCAVATING INTO ROCK, KEEP THE SURFACE MOIST TO MINIMISE DUST. CONSTRUCT A GRAVEL ENTRY/EXIT POINT USING BLUE METAL AND RESTRICT ALL VEHICLE MOVEMENTS WITHIN THE SITE TO A MINIMUM. ENSURE WIND BREAKS, SUCH AS EXISTING FENCES ARE MAINTAINED DURING THE CONSTRUCTION PHASE UNTIL NEW LANDSCAPING IS PROVIDED OR REINSTATED. PREVENT DUST BY COVERING STOCKPILES

### SEDIMENT NOTE:

1. ALL EROSION AND SEDIMENT CONTROL MEASURES TO BE INSPECTED AND MAINTAINED DAILY BY THE SITE MANAGER.

2. MINIMISE DISTURBED AREAS, REMOVE EXCESS SOIL FROM EXCAVATEDAREA AS SOON AS POSSIBLE. 3. ALL MATERIAL STOCKPILE TO BE CLEAR FROM DRAINS, GUTTERS AND FOOTPATHS, OR WITHIN SEDIMENT FENCE AREA.

4. DRAINAGE TO BE CONNECTED TO STORMWATER AS SOON AS POSSIBLE. IF STORED ON SITE, IT MUST BE FILTERED BEFORE RELEASING INTO STORMWATER SYSTEM OR WATERWAYS.

5. ROADS AND FOOTPATHS TO BE SWEPT DAILY.

### STOCKPILES:

ALL STOCKPILES ARE TO BE KEPT ON-SITE WHERE POSSIBLE. ANY MATERIALS PLACED ON THE FOOTPATHS OR NATURE STRIPS REQUIRE COUNCIL'S PERMISSION

ALL STOCKPILES ARE TO BE PLACED AWAY FROM THE DRAINAGE LINES AND STREET GUTTERS. IT IS BEST TO LOCATE THESE ON THE HIGHEST PART OF THE SITE IF POSSIBLE. PLACE WATERPROOF COVERING OVER STOCKPILES.

IF REQUIRED PROVIDE DIVERSION DRAIN & BANK AROUND STOCKPILES.

### **GUTTER PROTECTION:**

PROVIDE PROTECTION TO DOWNHILL GRATE IN GUTTER BY MEANS OF SAND BAGS OR BLUE METAL WRAPPED IN GEOTEXTILE FABRIC. WHEN SOIL OR SAND BUILDS UP AROUND THIS SEDIMENT BARRIER, THE MATERIAL SHOULD BE RELOCATED BACK TO THE SITE FOR DISPOSAL.

NOTE: ALL PROPOSED STORMWATER TO CONNECT WITH EXISTING

SITE / ROOF / SEDIMENT EROSION / WASTE MANAGEMENT / STORMWATER CONCEPT PLAN


nmencement of works.

Builder/Contractor and referred to the designer prior to the

**ACTION PL** m: 0426 957 518 e:operations@actionpla w: www.actionplans.com

ANS	А
	В
ans.com.au m.au	

REV.	DATE	COMMENTS	DRWN	NOTES This drawing is the copyright of Action Plans and not be
А	30/08/19	DEVELOPMENT APPLICATION	AL	altered, reproduced or transmitted in any form or by any means in part or in whole with the written permission of
В	09/12/19	REV A	EAS	Action Plans.  Do not scale measure from drawings. Figured dimensions
				are to be used only. The Builder/Contractor shall check and verify all levels and
				dimensions on site prior to commencement of any work, creation of shop drawings, or fabrication of components.
				All errors and omissions are to be verified by the

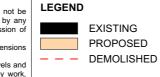

### CLIENT

ADAM & SABINE MOORE and IAN & RHONDAH MCKELLAR

1:200

### PROJECT ADDRESS

18-20 DENISON STREET MANLY NSW 2095

### DRAWING NO.

**DA02** 

### DATE


Monday, 9 December 2019


#### **DRAWING NAME**


SITE / ROOF / SEDIMENT EROSION / WASTE MANAGEMENT / STORMWATER CONCEPT PLAN

#### **SCALE**

1:200 @A3

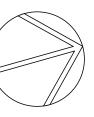

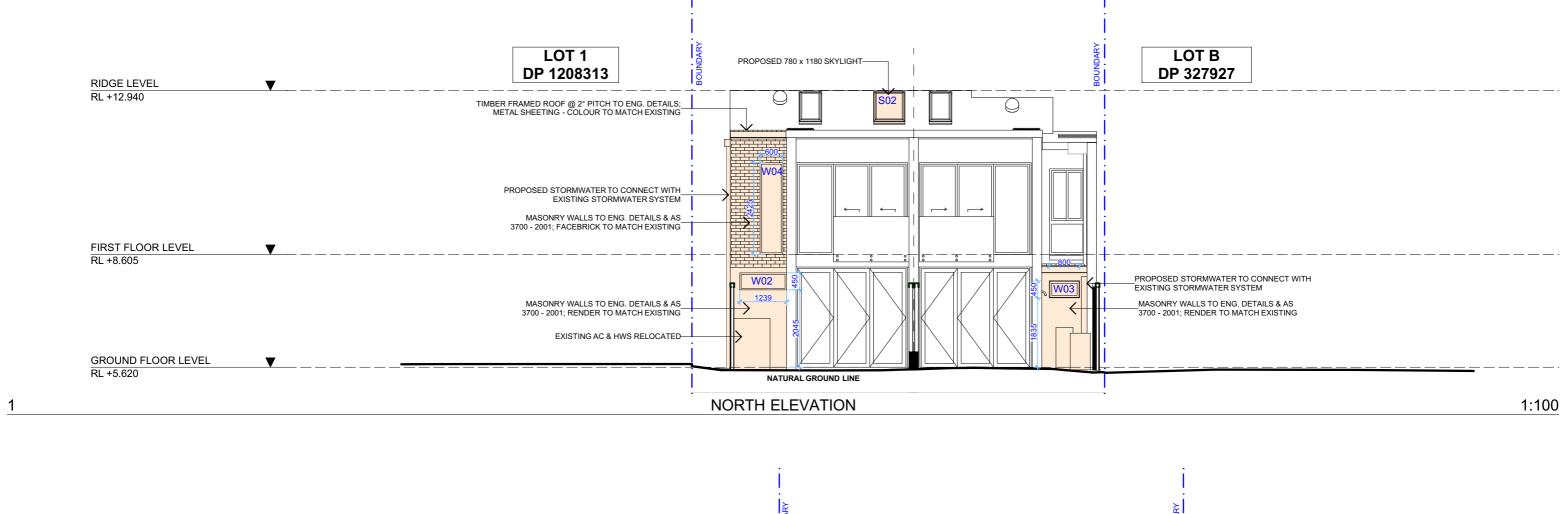

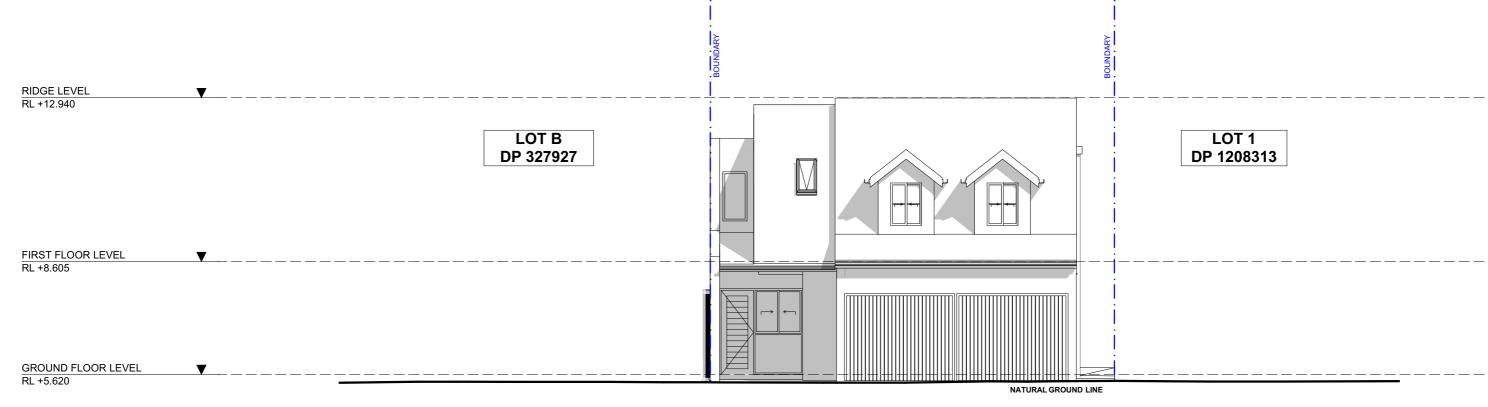


SOUTH ELEVATION 1:100

### NOTE: NO CHANGES TO THE SOUTH ELEVATION



REV.	DATE	COMMENTS	DRWN	NOTES This drawing is the copyright of Action Plans and not be
Α	30/08/19	DEVELOPMENT APPLICATION	AL	altered, reproduced or transmitted in any form or by any means in part or in whole with the written permission of
В	B 09/12/19	REV A	EAS	Action Plans.  Do not scale measure from drawings. Figured dimensions
				are to be used only.  The Builder/Contractor shall check and verify all levels and
				dimensions on site prior to commencement of any work, creation of shop drawings, or fabrication of components.
				All errors and omissions are to be verified by the Builder/Contractor and referred to the designer prior to the

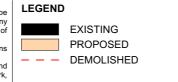

CLIENT
ADAM & SABINE MOORE and IAN & RHONDAH MCKELLAR
PROJECT ADDRESS
18-20 DENISON STREET MANLY NSW

2095


DRAWING NO.
<b>DA07</b>
DATE

1:100 @A3

DA	ΓΕ	


Monday, 9 December 2019

DRAWING NAME
NORTH / SOUTH ELEVATION
SCALE

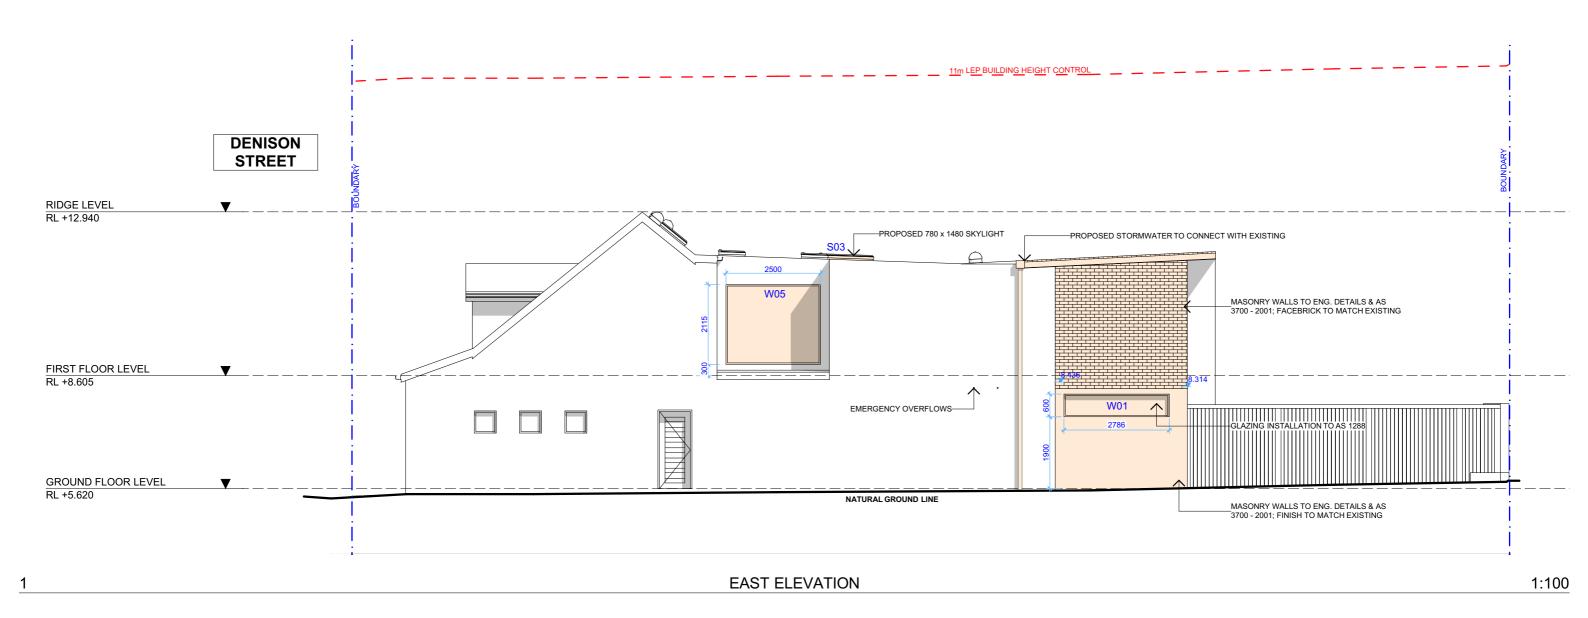




	REV.	DATE	COMMENTS	DRWN	NOTES This drawing is the copyright of Action Plans and not be
	А	A 30/08/19 DEVELOPMENT APPLICATION AL altered, reproduced or trans	altered, reproduced or transmitted in any form or by any means in part or in whole with the written permission of		
	В	09/12/19	REV A	EAS	Action Plans. Do not scale measure from drawings. Figured dimensions
					are to be used only.  The Builder/Contractor shall check and verify all levels an
J				dimensions on site prior to commenceme	dimensions on site prior to commencement of any work, creation of shop drawings, or fabrication of components.
					All errors and omissions are to be verified by the Builder/Contractor and referred to the designer prior to the
				•	commencement of works.

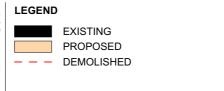

CLIENT
ADAM & SABINE MOORE and IAN & RHONDAH MCKELLAR
PROJECT ADDRESS
18-20 DENISON STREET MANLY NSW
2095

DRAWING NO.	DRAWING NAME
DA08	EAST ELEVATION
DATE	

DAUG	
DATE	
Monday, 9 December	SCALE
2019	1:100 @A3

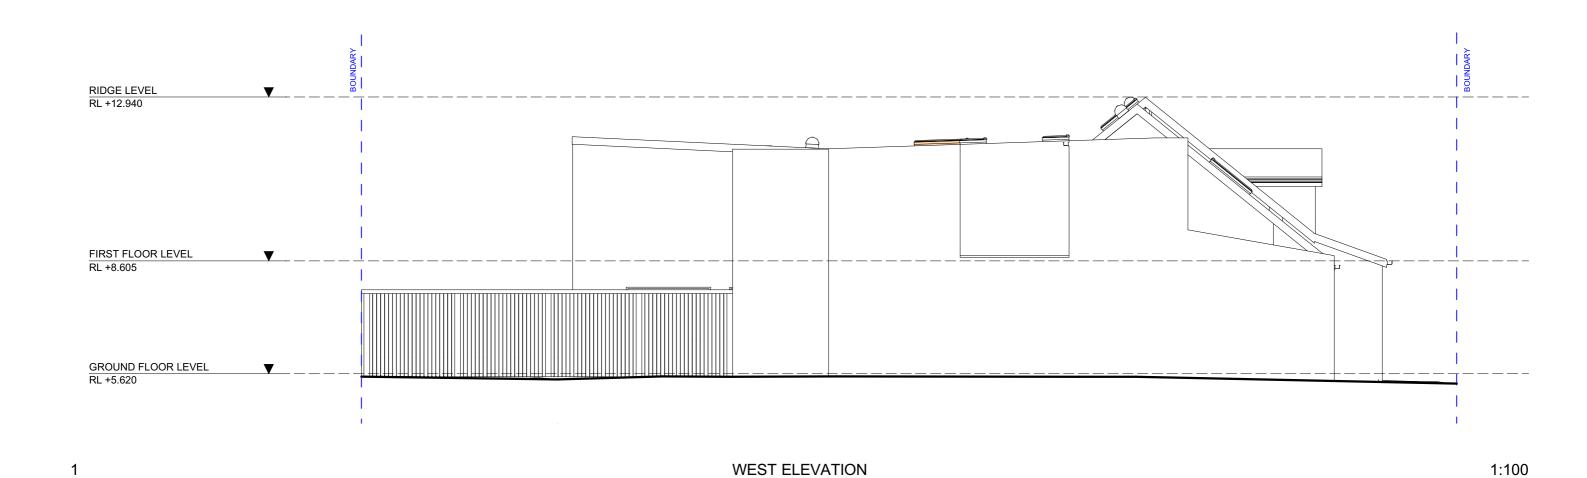




m: 0426 957 518
e:operations@actionplans.com.au
w: www.actionplans.com.au

					i i nis drawind is the col
	А	30/08/19	DEVELOPMENT APPLICATION	AL	altered, reproduced or means in part or in wh
	В	B 09/12/19 R	REV A	EAS	Action Plans. Do not scale measure
					are to be used only. The Builder/Contractor
1					dimensions on site pric creation of shop drawing
					All errors and omiss Builder/Contractor and
					commencement of work

COMMENTS

DRWN NOTES

REV. DATE

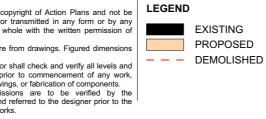

CLIENT

ADAM & SABINE
MOORE and IAN &
RHONDAH MCKELLAR
PROJECT ADDRESS

18-20 DENISON
STREET MANLY NSW
2095

DA09

DATE


E

Monday, 9 December 2019

SCALE 1:100 @A3


DRAWING NAME

WEST ELEVATION

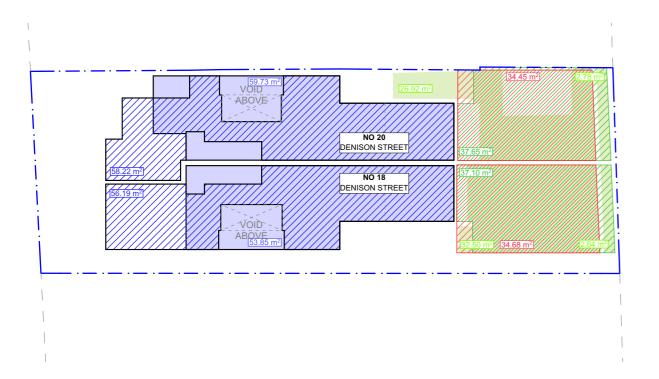

AREA CALCULATIONS EXISTING

**AREA CALCULATIONS TABLE** SITE AREA EXISTING: 331.4m<sup>2</sup> **TOTAL OPEN SPACE (TOS)** CONTROL: 50% of site (165.70m<sup>2</sup>) TOTAL SITE: EXISTING: 37.65m<sup>2</sup> EXISTING: 37.10m<sup>2</sup> EXISTING: 22.55% (74.75m<sup>2</sup>) PROPOSED: UNCHANGED PROPOSED: 36.80m<sup>2</sup> PROPOSED: 22.46% (74.45m<sup>2</sup>) LANDSCAPED AREA CONTROL: 30% of TOS (49.71m<sup>2</sup>) TOTAL SITE: NO 20: EXISTING: 29.70m<sup>2</sup> EXISTING: <u>35.14m<sup>2</sup></u> EXISTING: 39.1% (64.84m<sup>2</sup>) PROPOSED: UNCHANGED PROPOSED: UNCHANGED PROPOSED: UNCHANGED PRIVATE OPEN SPACE CONTROL: 12m<sup>2</sup> Per Dwelling NO 20: NO 18: EXISTING: 34.68m<sup>2</sup> EXISTING: 34.45m<sup>2</sup> PROPOSED: UNCHANGED PROPOSED: UNCHANGED NO 20: FLOOR SPACE RATIO TOTAL SITE: GROUND FLOOR LEVEL CONTROL: 0.75:1 (248.55m<sup>2</sup>) EXISTING: 177.88m<sup>2</sup> PROPOSED: 120.99m² EXISTING: 0.71:1 (227.92m<sup>2</sup>) NO 18: PROPOSED: 0.74:1 (242.03m<sup>2</sup>) FLOOR SPACE RATIO EXISTING: 110.04m<sup>2</sup> FIRST FLOOR LEVEL PROPOSED: 121.04m<sup>2</sup>

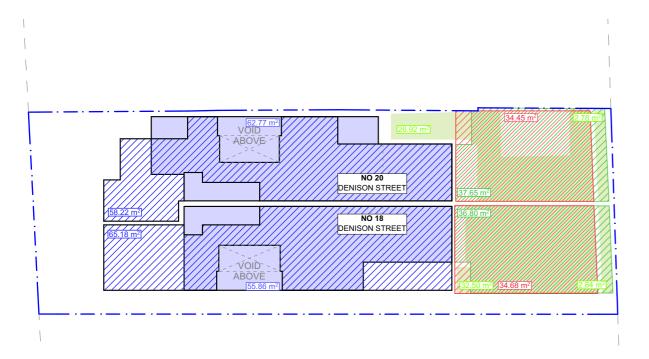

COLORBOND METAL ROOF COLOUR TO MATCH EXISTING **FIXED SKYLIGHT WINDOWS** BY VELUX

RENDERED BRICK COLOUR TO MATCH EXISTING

AREA CALCULATIONS PROPOSED

3 MATERIAL SAMPLE BOARD

**ACTION PLANS** m: 0426 957 518 e:operations@actionplans.com.au

w: www.actionplans.com.au

REV.	DATE	COMMENTS	DRWN	NOTES This drawing is the copyright of Action Plans and not be			
А	30/08/19	DEVELOPMENT APPLICATION	AL	altered, reproduced or transmitted in any form or by any means in part or in whole with the written permission or			
В	09/12/19	REV A	EAS	Action Plans.  Do not scale measure from drawings. Figured dimens			
				are to be used only.			
				The Builder/Contractor shall check and verify all levels and			
				dimensions on site prior to commencement of any work creation of shop drawings, or fabrication of components.			
				All errors and omissions are to be verified by the Builder/Contractor and referred to the designer prior to the			
				commencement of works.			

**LEGEND** 

1:200

1:200

CLIENT ADAM & SABINE MOORE and IAN & RHONDAH MCKELLAR

PROJECT ADDRESS

18-20 DENISON STREET MANLY NSW 2095

DRAWING NO. **DA11** 

DRAWING NAME


AREA CALCULATIONS / SAMPLE BOARD

DATE

Monday, 9 December 2019

**SCALE** 1:200 @A3




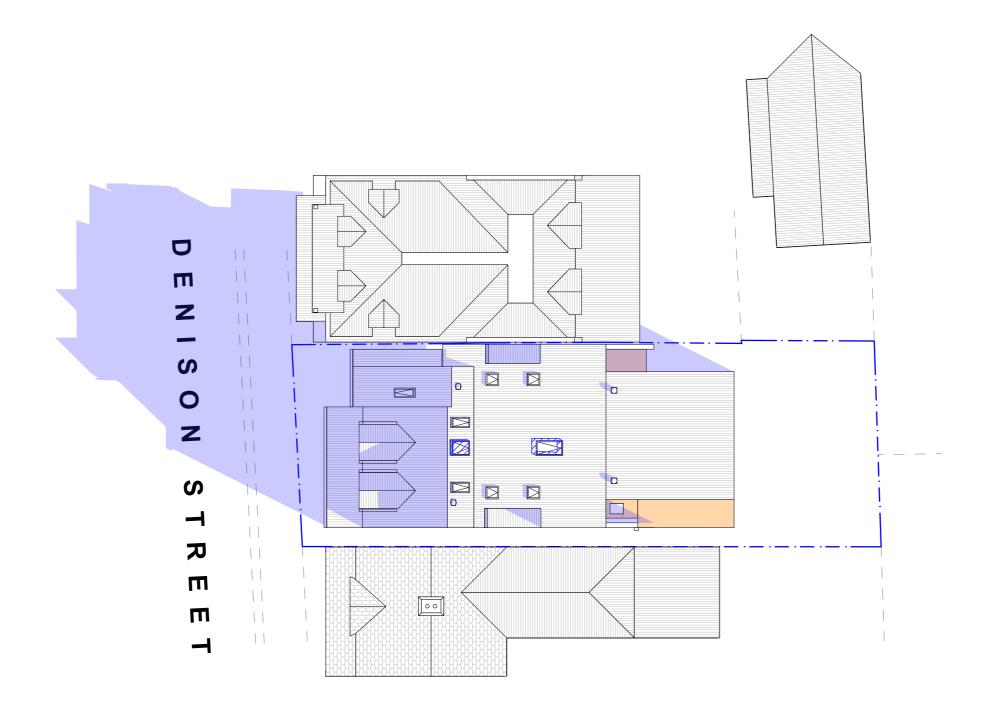

WINTER SOLSTICE 9AM 1:200



REV.	DATE	COMMENTS	DRWN	NOTES  This drawing is the copyright of Action Plans and not be
А	30/08/19	DEVELOPMENT APPLICATION	AL	altered, reproduced or transmitted in any form or by any means in part or in whole with the written permission of
В	09/12/19	REV A	EAS	Action Plans.  Do not scale measure from drawings. Figured dimensions
				are to be used only.  The Builder/Contractor shall check and verify all levels and dimensions on site prior to commencement of any work, creation of shop drawings, or fabrication of components.  All errors and omissions are to be verified by the
				Builder/Contractor and referred to the designer prior to the commencement of works.

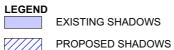

EXISTING SHADOWS

ADAM & SABINE MOORE and IAN & RHONDAH MCKELLAR PROJECT ADDRESS

CLIENT

2095

18-20 DENISON STREET MANLY NSW DRAWING NO.


**DA12** 


DATE Monday, 9 December 2019

WINTER SOLSTICE 9 AM

DRAWING NAME



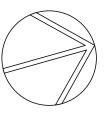


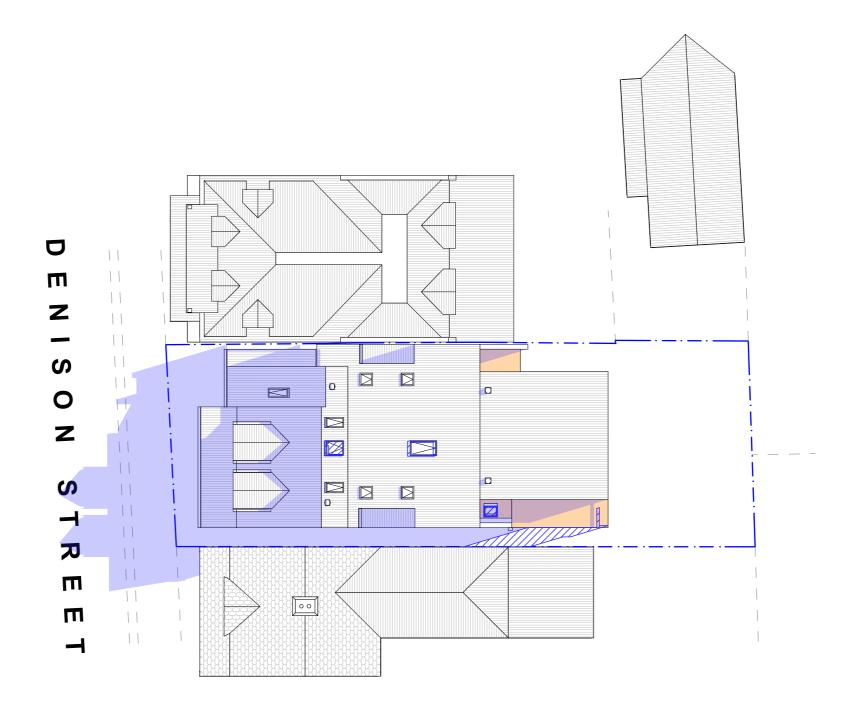

1 WINTER SOLSTICE 12PM 1:200



REV.	DATE	COMMENTS	DRWN	NOTES
Α	30/08/19	DEVELOPMENT APPLICATION	AL	This drawing is the copyright of Action Plans and not be altered, reproduced or transmitted in any form or by any means in part or in whole with the written permission or
В	09/12/19	REV A	EAS	Action Plans.  Do not scale measure from drawings. Figured dimensions
				are to be used only.  The Builder/Contractor shall check and verify all levels and
				dimensions on site prior to commencement of any work creation of shop drawings, or fabrication of components.
				All errors and omissions are to be verified by the Builder/Contractor and referred to the designer prior to the
				commencement of works.

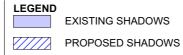


ADAM & SABINE MOORE and IAN & RHONDAH MCKELLAR

CLIENT


2095

PROJECT ADDRESS 18-20 DENISON STREET MANLY NSW DRAWING NO.

DATE

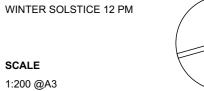


DRAWING NAME

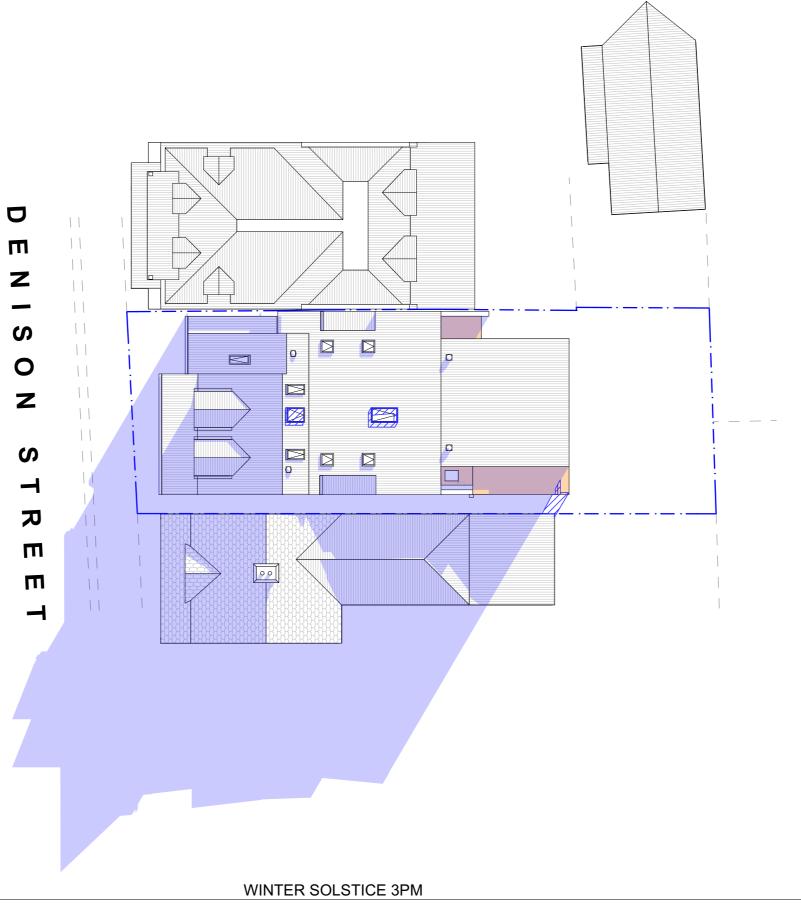

1:200



REV.	DATE	COMMENTS	DRWN	NOTES  This drawing is the copyright of Action Plans and not be
Α	30/08/19	DEVELOPMENT APPLICATION	AL	altered, reproduced or transmitted in any form or by any means in part or in whole with the written permission or
В	09/12/19	REV A	EAS	Action Plans.  Do not scale measure from drawings. Figured dimensions
				are to be used only. The Builder/Contractor shall check and verify all levels and
				dimensions on site prior to commencement of any work creation of shop drawings, or fabrication of components.
				All errors and omissions are to be verified by the Builder/Contractor and referred to the designer prior to the
				commencement of works.

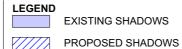

EXISTING SHADOWS

ADAM & SABINE MOORE and IAN & RHONDAH MCKELLAR PROJECT ADDRESS

CLIENT

2095

18-20 DENISON STREET MANLY NSW DRAWING NO.

**DA14** 


DATE

Monday, 9 December 2019

DRAWING NAME

WINTER SOLSTICE 3 PM

SCALE 1:200 @A3

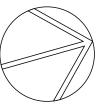

## **BASIX** Certificate

Building Sustainability Index www.basix.nsw.gov.au

#### Alterations and Additions

Certificate number: A345441\_02

This certificate confirms that the proposed development will meet the NSW government's requirements for sustainability, if it is built in accordance with the commitments set out below. Terms used in this certificate, or in the commitments, have the meaning given by the document entitled "BASIX Alterations and Additions Definitions" dated 06/10/2017 published by the Department. This document is available at www.basix.nsw.gov.au

Secretary

Date of issue: Friday, 16, August 2019 To be valid, this certificate must be lodged within 3 months of the date of issue.

NSW Planning & Environment

ĕ 18-20 DENISON STREET 02 Project name 0 Street address 18-20 DENISON Street MANLY 2095 Local Government Area Northern Beaches Council pr Plan type and number Strata Plan 85482 Lot number N/A of Section number Project type criptio Dwelling type Attached dwelling house Type of alteration and My renovation work is valued at \$50,000 or more, and does not include a pool (and/or spa). addition es

Windows and glazed doors The applicant must install the windows, glazed doors and shading devices, in accordance with the specifications listed in the table below. Relevant overshadowing specifications must be satisfied for each window and glazed door. The following requirements must also be satisfied in relation to each window and glazed door: Each window or glazed door with standard aluminium or timber frames and single clear or toned glass may either match the description, or, have a U-value and a Solar Heat Gain Coefficient (SHGC) no greater than that listed in the table below. Total system U-values and SHGCs must be calculated in accordance with National Fenestration Rating Council (NFRC) conditions For projections described in millimetres, the leading edge of each eave, pergola, verandah, balcony or awning must be no more than 500 mm above the head of the window or glazed door and no more than 2400 mm above the sill. Pergolas with polycarbonate roof or similar translucent material must have a shading coefficient of less than 0.35. Pergolas with fixed battens must have battens parallel to the window or glazed door above which they are situated, unless the pergola also shades a perpendicular window. The spacing between battens must not be more than 50 mm. Overshadowing buildings or vegetation must be of the height and distance from the centre and the base of the window and glazed door, as specified in the 'overshadowing' column in the table below. Windows and glazed doors glazing requirements Overshadowing rame and glass type

Certificate Prepared by (please complete before submitting to Council or PCA) W01 Name / Company Name: Action Plans W02 ABN (if applicable): 17118297587 W03

Glazing requirements

Glazing requirements

1 09

Skylights

S3

1.67 1.178 1.03 standard aluminium, single clear, (or none U-value: 7.63, SHGC: 0.75) 0.55 eave/verandah/pergola/balcony standard aluminium, single clear, (or >=750 mm U-value: 7.63, SHGC: 0.75) standard aluminium, single clear, (or 0.36 none U-value: 7.63. SHGC: 0.75) W04 1.44 eave/verandah/pergola/balcony standard aluminium, single clear, (or U-value: 7.63, SHGC: 0.75) >=750 mm

Fixtures and systems			Show on DA Plans	Show on CC/CDC Plans & specs	Certifier Check
Lighting					
The applicant must ensure a minimum of 40% light-emitting-diode (LED) lamps.	of new or altered light fixtures are fitted with fl	luorescent, compact fluorescent, or		<b>✓</b>	~
Fixtures			•	•	
The applicant must ensure new or altered sho	werheads have a flow rate no greater than 9 li	tres per minute or a 3 star water rating.		✓	✓
The applicant must ensure new or altered toile	ets have a flow rate no greater than 4 litres per	average flush or a minimum 3 star water rating.		<b>✓</b>	<b>✓</b>
The applicant must ensure new or altered taps	s have a flow rate no greater than 9 litres per n	ninute or minimum 3 star water rating.		✓	
Construction			Show on DA Plans	Show on CC/CDC Plans & specs	Certifier Check
Insulation requirements					
	ation is not required where the area of new cor	ofs) in accordance with the specifications listed in instruction is less than 2m2, b) insulation specified	<b>V</b>	<b>✓</b>	<b>✓</b>
Construction	Additional insulation required (R-value)	Other specifications			
concrete slab on ground floor.	nil				
external wall: brick veneer	R1.16 (or R1.70 including construction)				
external wall: framed (weatherboard, fibro, metal clad)	R1.30 (or R1.70 including construction)				
	ceiling: R2.50 (up), roof: foil/sarking				

The applicant must install the skylights in accordance with the specifications listed in the table below.					✓	<b>~</b>
The following requ	uirements must also	be satisfied in relation to each skyligh	t:		<b>~</b>	<b>✓</b>
Each skylight may either match the description, or, have a U-value and a Solar Heat Gain Coefficient (SHGC) no greater than that listed in the table below.					<b>✓</b>	<b>✓</b>
External awnings and louvres must fully shade the skylight above which they are situated when fully drawn or closed.					✓	<b>✓</b>
Skylights glaz	zing requiremer	nts				
Skylight number	Area of glazing inc. frame (m2)	Shading device	Frame and glass type			
S1	0.38	no shading	aluminium, moulded plastic single clear, (or U-value: 6.21, SHGC: 0.808)			
S2	0.92	external fixed awning or blind	aluminium, moulded plastic single clear, (or U-value: 6.21, SHGC: 0.808)			

6.21, SHGC: 0.808)

NOTE: All window & door dimensions, orientation, glazing materials, opening types, frame types are to be confirmed by a suitably qualified person prior to the ordering of any such materials are to take place. U value takes precedence over glazing type/colour in all cases. All new glazing must meet the BASIX specified frame and glass type, OR meet the specified U value and SHGC value.

**ACTION PLANS** m: 0426 957 518 e:operations@actionplans.com.au w: www.actionplans.com.au

	REV.	DATE	COMMENTS	ט
	А	30/08/19	DEVELOPMENT APPLICATION	
	В	09/12/19	REV A	
ı				

COMMENTS

DEV DATE

DRWN NOTES This drawing is the copyright of Action Plans and not be altered, reproduced or transmitted in any form or by any means in part or in whole with the written permission of Action Plans.

Do not scale measure from drawings. Figured dimensions are to be used only.

The Builder/Contractor shall check and verify all levels and dimensions on site prior to commencement of any work, creation of shop drawings or febrication of commencement. drawings, or fabrication of components.

All errors and omissions are to be verified by the Builder/Contractor and referred to the designer prior to the commencement of works. All window & door dimensions, orientation, glazing materials, opening types, frame types are to be confirmed by a suitably qual person prior to the ordering of any such materials are to take place. U value takes precedence over glazing type/colour in all cases.
all new glazing must meet the BASIX specified frame and glass type, <u>OR</u> meet the ecified U value and SHGC value.

CLIENT

2095

external fixed awning or blind

ADAM & SABINE MOORE and IAN & RHONDAH MCKELLAR PROJECT ADDRESS

18-20 DENISON STREET MANLY NSW DRAWING NO.

**DA15** 

aluminium, moulded plastic single clear, (or U-value:

BASIX COMMITMENTS

Show on CC/CDC Plans &

DATE Monday, 9 December 2019

DRAWING NAME