BASIX COMMITMENTS

READ DRAWINGS IN CONJUNCTION WITH THE ATTACHED BASIX CERTIFICATE #A329994 SUBMITTED WITH THE DEVELOPMENT APPLICATION:

- THE OUTDOOR SWIMMING POOL MUST NOT HAVE A CAPACITY GREATER THAN 36 KILOLITRES. INSTALL A POOL PUMP & HEATING SYSTEM FOR THE SWIMMING POOL TO BE SOLAR ONLY.

- THE APPLICANT MUST INSTALL A RAINWATER TANK OF AT LEAST 1575 LITRES ON THE SITE. THE RAINWATER TANK TO COLLECT RAINWATER RUNOFF FROM AT LEAST 90 SQUARE METRES OF ROOF AREA. CONNECT THE RAINWATER TANK TO A TAP LOCATED WITHIN 10 METRES OF THE EDGE OF THE POOL.

- PROVIDE A HEATING/COOLING SYSTEM TO ACHIEVE THE REQUIRED STAR ENERGY RATING.

- A NEW 'GAS INSTANTANEOUS 'HOT WATER SYSTEM TO BE INSTALLED [POSITION T.B.C]

- A MINIMUM OF 40% OF NEW OR ALTERED LIGHT FIXTURES ARE TO BE FITTED WITH FLUORESCENT, COMPACT FLUORESCENT, OR LIGHT-EMITTING-DIODE (LED) LAMPS.

- ALL NEW or ALTERED SHOWERHEAD, TOILET & TAP FIXTURES TO ACHIEVE THE REQUIRED STAR WATER RATING.

- ADDITIONAL NEW FLOOR, WALL & ROOF CEILING INSULATION TO HAVE THE MINIMUM R-VALUES AS SPECIFIED IN THE CERTIFICATE

- ALL NEW WINDOWS & SKYLIGHTS TO HAVE U-VALUE AND A SOLAR HEAT GAIN COEFFICIENT NO GREATER THAN THAT LISTED IN THE BASIX TABLE REQUIREMENTS.

- THE NEW ROOF COLOUR TO BE OF MEDIUM SOLAR ABSORPTANCE.

LEGEND

EXISTING HOUSE WALLS:

HOUE WALLS AS IS AND PER SURVEY

PROPOSED NEW BLD WALLS EXTERNAL WALLS BRICK AND/OR WEATHERBOARD WALLS INTERNAL FRAMED LIGHT WEIGHT PLASTERBOARD WALLS

PROPOSED ADDITION: HOUSE EXTENSION EXTRA GFA

DEMOLITION, EXISITING SEMI WALLS & FIXTURES TO BE DEMOLISHED

ADJOINING NEIGHBOURING PROPERTIES AS PER SITE SURVEY PLAN

CONCRETE REINFORCED CONCRETE TO ENGINEER DETAILS

TIMBER FLOOR:
SELECTED HARDWOOD FLOOR TIMBER FLOOR:

WET AREA TILING SELECTED FLOOR TILES TO FALLS & SET-OUT TO DETAIL

ROOFING COLOURBOND METAL ROOFING TO FALLS

SYMBOLS

WINDOW LABEL

N° PLAN/ SECTION REFERENCE EXISTING WINDOW PLAN/ ELEVATION REFERENCE

DOOR LABEL DCP/LEP WALL HEIGHT LINE

FLOOR LEVELS

RL (LEVELS)

DRAWING LIST

ARCHITECTURAL DRAWING SET - DA

DRAWING ISSUE ISSUE DRAWING NAME (PAGE SIZE) ISSUED Cover Sheet + Site Plan 1/200 05/11/2018 1/100 05/11/2018 DA.02 Roof Plan DA.03 05/11/2018 Existing Lower Ground Floor Plan DA.04 Existing Ground Floor Plan 1/100 05/11/2018 Demolition Lower Ground Floor Plan 1/100 05/11/2018 Demolition Ground Floor Plan 05/11/2018 DA.07 05/11/2018 Lower Ground Floor Plan 1/100 05/11/2018 Ground Floor Plan First Floor Plan 05/11/2018 DA.10 DA Elevations North/South 05/11/2018 1/100 Elevations East/West 05/11/2018 DA.12 1/100 05/11/2018 Sections DA.13 05/11/2018 DA C Perspectives DA Glazing Schedule 05/11/2018

PROJECT TEAM

<u>CLIENT</u> GEORGE & TATIANA OPADCHY 7 CLIFFORD AVENUE, FAIRLIGHT NSW 2093 EMAIL: GEORGE@THECONSTRUCTIONSITE.COM.AU

ARCHITECT
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SURVEYOR
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ENGINEER
GZ CONSULTING ENGINEERS 133 QUEENSCLIFF ROAD, QUEENSCLIFF NSW 2096 PHONE: 0403071853 EMAIL: GREG@GZENGINEERS.COM.AU CONTACT: GREG ZACCONE

THE CERTIFYING AUTHORITY IN ACCORDANCE WITH THE ACT.

UNIT 2A WINBOURNE ESTATE 9-13 WINBOURNE RD. BROOKVALE NSW 2100 PHONE: 99395350 EMAIL: INFO@PLATEAUTREES.COM.AU CONTACT: NICK NELSON

<u>PLANNER</u> NOLAN PLANNING

75 OLIVER STREET, FRESHWATER NSW 2096 PHONE: 0403524583 EMAIL: NATALIE@NOLANPLANNING.COM.AU CONTACT: NATALIE NOLAN

SHADOW DIAGRAM & ENERGY CONSULTANT DENEB DESIGN

PO BOX 539, MONA VALE, NSW 1660 PHONE: 99977480 EMAIL: INFO@DENEBDESIGN.COM CONTACT: CAMERON FIAZ

COUNCIL
NORTHERN BEACHES COUNCIL MANLY CIVIC CENTRE

1 BELGRAVE STREET MANLY NSW 2095

DA 11

DA.11

terrace

west site boundary 45.72m 8°48'

east site boundary 45.72m 188°48'

RL: 19.24

rear garden

P315261 A=522.5m2

PALM TREES:

20 LAUDERDALE AVE

2 STOREY RESIDENCE

_ _ _ _ _ _ _ _ _ _ _ _

REMOVED

SCREEN

STORMWATER EASEMENT

GENERAL

+ DA NOTICE OF DETERMINATION & DEVELOPMENT CONSENT: THE DEVELOPMENT TO BE SUBSTANTIALLY IN ACCORDANCE WITH THE APPROVED CONSENT PLANS AND SUPPORTING INFORMATION SUBMITTED WITH THE DA THIS SET OF DRAWINGS HAVE TO BE READ IN CONJUNCTION WITH THE ISSUED CONSENT AND 'STAMPED APPROVED' PLANS. PRIOR TO THE COMMENCEMENT OF ANY CONSTRUCTION WORK ON SITE THE NECESSARY CDC or CC APPROVALS & NOTICE OF COMMENCEMENT PAPERS MUST BE SUBMITTED/OBTAINED FROM

+ DRAWING INFORMATION: THE BUILDING IS PRINCIPALLY THAT WHICH IS DEPICTED IN THE ARCHITECTURAL PLANS, DETAILS & SPECIFICATIONS PREPARED BY DU PLESSIS + DU PLESSIS ARCHITECTS TOGETHER WITH SUPPORTING CONSULTANT DOCUMENTATION.

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EXECUTE THE WORKS IN COMPLIANCE WITH THE CURRENT EDITION OF THE NCC NATIONAL CONSTRUCTION CODE, CURRENT EDITIONS OF RELEVENT AUSTRALIAN AND OTHER PUBLISHED STANDARDS (AS AMENDED) AND THE REQUIREMENTS OF OTHER AUTHORITIES RELEVENT TO THE EXECUTION OF THE

AC AIR CONDITIONED AHD AUSTRALIAN HEIGHT DATUM FFL FINISHED FLOOR LEVEL **ADH ADHESIVE** AG AGGREGATE AL ALUMINIUM AW AWNING B BALUSTRADE **BK BRICK WALL** BIT BITUMEN BHD BULKHEAD **BOW BOTTOM OF WALL** BM BENCHMARK **BW BLOCKWORK WALL** C CONCRETE **CANT CANTILEVER** CJ CONSTRUCTION JOINT CL CENTRE LINE CW CONCRETE WALL

CLMN COLUMN

DIM DIMENSION

ENG ENGINEER

EX EXISTING

EXH EXHAUST

F FALL TO SCREED

FG FIXED GLAZING

EJ EXPANSION JOINT

DP DOWNPIPE

DR DRAIN

CPT CARPET

ABBREVIATIONS

GALV GALVANIZED GP GAS POINT H HYDRANT HWS HOT WATER SYSTEM HYD HYDRAULIC LS LANDSCAPING LV LOUVRE MECH MECHANICAL MDF MEDIUM DENSITY FIBRO BOARD MOD MODIFICATION MR METAL ROOFING MS MILD STEEL MV MECHANICAL VENTILATION NGL NATURAL GROUND LEVEL NTS NOT TO SCALE OFC OFF FORM CONCRETE OG OBSCURE GLAZING OH OVER HEAD P SELECTED PAVING EWS EXTERNAL WALL SYSTEM PB PLASTERBOARD PFC PARALLEL FLANCE CHANNEL

PL PLANTER

PP POWER POLE

PS PRIVACY SCREEN

FIG FIGURE

G GLASS

FE FIRE EXTINGUISHER

FR FIRE RESISTANT

FW FLOOR WASTE

RWP RAIN WATER PIPE RL REDUCED LEVEL RC REINFORCED CONCRETE SB MAIN ELECTRICAL SWITCH BOARD SC STEEL COLUMN SHR SHOWER SLD SLIDING DOOR SPEC SPECIFICATION SS STAINLESS STEEL SSL STRUCTURAL SLAB LEVEL SW STONE WALL STD STANDARD SWP STORM WATER PIT T TILE TD TIMBER DECKING TOW TOP OF WALL TYP TYPICAL UR UNIVERSAL BEAM US UNDERSIDE **V VENTILATION** W WINDOW WC WATER CLOSET WM WATER MAIN WPM WATER PROOFING MEMBRANE

PW PLASTERBOARD WALL

RWH RAIN WATER HEAD

RW RENDERED & PAINTED WALL

QTY QUANTITY

REF REFERENCE

N°9 CLIFFORD AVENUE

1 & 2 STOREY BRICK RESIDENCE

tile roof

N°7 CLIFFORD AVENUE

RL: 32.73

N°5 CLIFFORD AVENUE

1 & 2 STOREY BRICK & CLAD RESIDENCE

lile roof

1 & 2 STOREY BRICK & WEATHERBOARD HOUSE RIDGE METAL ROOF

RL: 32.81

RL: 25.59

RL: 25.57

RL: 25.49

Residential Alterations & Additions CLASS 1a Building 7 CLIFFORD AVENUE, FAIRLIGHT LOT B; SEC 1 - D.P. 315261 EXISTING SITE AREA 522.5m²

RIDGE 40.26

GUTTER 38.42

ಿ ಸ್ಥ N°12 CLIFFORD AVENUE

RENDERED UNITS

N°8 CLIFFORD AVENUE

RENDERED MULTI-TERRACED

RESIDENCES


34.05 HL

N°10 CLIFFORD AVENUE

RENDERED MULTI-TERRAGED

RESIDENCES

39.93 HL

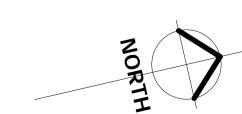



NOTES

EXECUTION OF THE WORKS.

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issue	date	description
А	02/07/2018	Preliminary DA Issue for Review
В	19/10/2018	DA Issue for Review
С	05/11/2018	DEVELOPMENT APPLICATION

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DU PLESSIS

h@droom.com.au 0433408368 www.droom.com.au

NSW REGISTERED ARCHITECT #7435 NOMINATED ARCHITECT: EUGENE DU PLESSIS

PROJECT TITLE: OPADCHY House Alterations & Additions

CLIENT NAME: GEORGE + TATIANA OPADCHY

ADDRESS: 7 Clifford Avenue Fairlight NSW 2094


DRAWING TITLE: Cover Sheet + Site Plan

DRAWN **EDUP** AΗ

SCALE: 1:200@A1

DRAWING NO:

05/11/2018

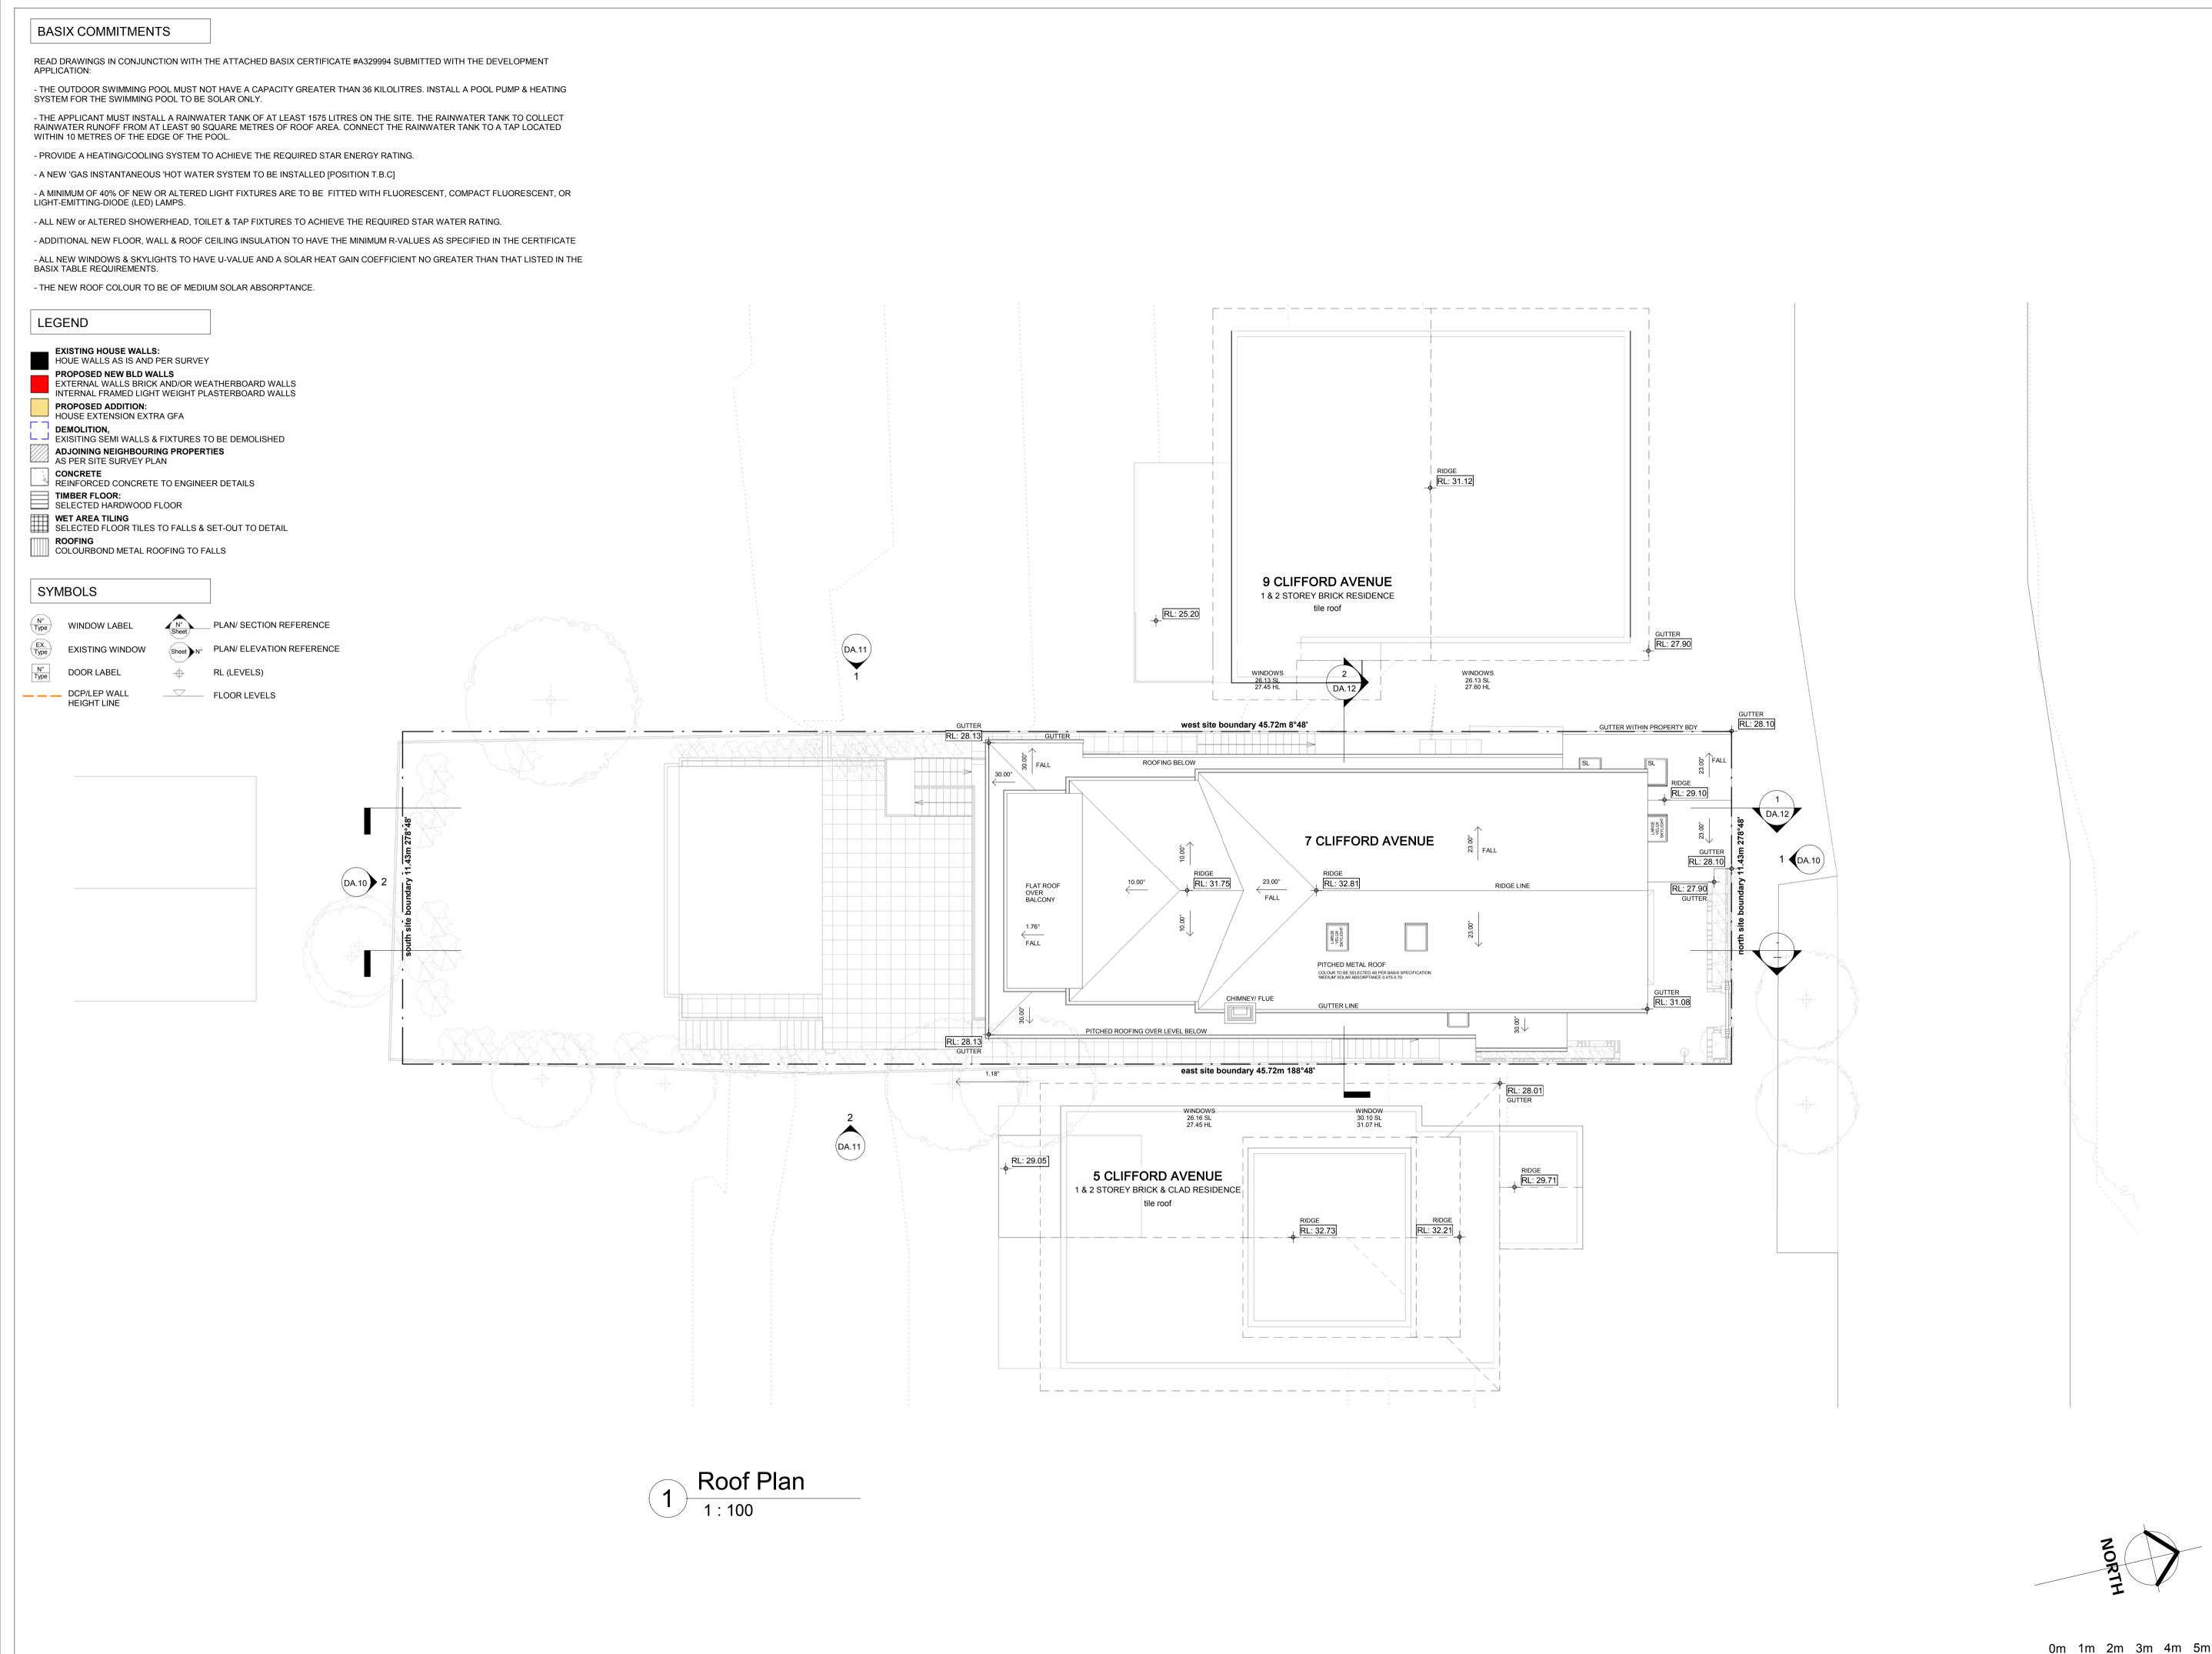



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B C	19/10/2018 05/11/2018	DA Issue for Review DEVELOPMENT
Ü	00/11/2010	APPLICATION

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NSW REGISTERED ARCHITECT #7435 NOMINATED ARCHITECT: EUGENE DU PLESSIS

PROJECT TITLE: OPADCHY House Alterations & Additions

CLIENT NAME: GEORGE + TATIANA OPADCHY

ADDRESS: 7 Clifford Avenue Fairlight NSW 2094

DRAWING TITLE: Roof Plan

> CHECKED: EDUP

SCALE: 1:100@A1

1:100 @ A1

DRAWING NO:

DA.02

05/11/2018

BASIX COMMITMENTS READ DRAWINGS IN CONJUNCTION WITH THE ATTACHED BASIX CERTIFICATE #A329994 SUBMITTED WITH THE DEVELOPMENT - THE OUTDOOR SWIMMING POOL MUST NOT HAVE A CAPACITY GREATER THAN 36 KILOLITRES. INSTALL A POOL PUMP & HEATING SYSTEM FOR THE SWIMMING POOL TO BE SOLAR ONLY. - THE APPLICANT MUST INSTALL A RAINWATER TANK OF AT LEAST 1575 LITRES ON THE SITE. THE RAINWATER TANK TO COLLECT RAINWATER RUNOFF FROM AT LEAST 90 SQUARE METRES OF ROOF AREA. CONNECT THE RAINWATER TANK TO A TAP LOCATED WITHIN 10 METRES OF THE EDGE OF THE POOL. - PROVIDE A HEATING/COOLING SYSTEM TO ACHIEVE THE REQUIRED STAR ENERGY RATING. - A NEW 'GAS INSTANTANEOUS 'HOT WATER SYSTEM TO BE INSTALLED [POSITION T.B.C] - A MINIMUM OF 40% OF NEW OR ALTERED LIGHT FIXTURES ARE TO BE FITTED WITH FLUORESCENT, COMPACT FLUORESCENT, OR LIGHT-EMITTING-DIODE (LED) LAMPS. - ALL NEW or ALTERED SHOWERHEAD, TOILET & TAP FIXTURES TO ACHIEVE THE REQUIRED STAR WATER RATING. - ADDITIONAL NEW FLOOR, WALL & ROOF CEILING INSULATION TO HAVE THE MINIMUM R-VALUES AS SPECIFIED IN THE CERTIFICATE - ALL NEW WINDOWS & SKYLIGHTS TO HAVE U-VALUE AND A SOLAR HEAT GAIN COEFFICIENT NO GREATER THAN THAT LISTED IN THE - THE NEW ROOF COLOUR TO BE OF MEDIUM SOLAR ABSORPTANCE. LEGEND **EXISTING HOUSE WALLS:** HOUE WALLS AS IS AND PER SURVEY PROPOSED NEW BLD WALLS EXTERNAL WALLS BRICK AND/OR WEATHERBOARD WALLS INTERNAL FRAMED LIGHT WEIGHT PLASTERBOARD WALLS PROPOSED ADDITION: HOUSE EXTENSION EXTRA GFA DEMOLITION, EXISITING SEMI WALLS & FIXTURES TO BE DEMOLISHED ADJOINING NEIGHBOURING PROPERTIES AS PER SITE SURVEY PLAN CONCRETE REINFORCED CONCRETE TO ENGINEER DETAILS TIMBER FLOOR: SELECTED HARDWOOD FLOOR WET AREA TILING SELECTED FLOOR TILES TO FALLS & SET-OUT TO DETAIL COLOURBOND METAL ROOFING TO FALLS


SYMBOLS


WINDOW LABEL

DOOR LABEL

DCP/LEP WALL

HEIGHT LINE

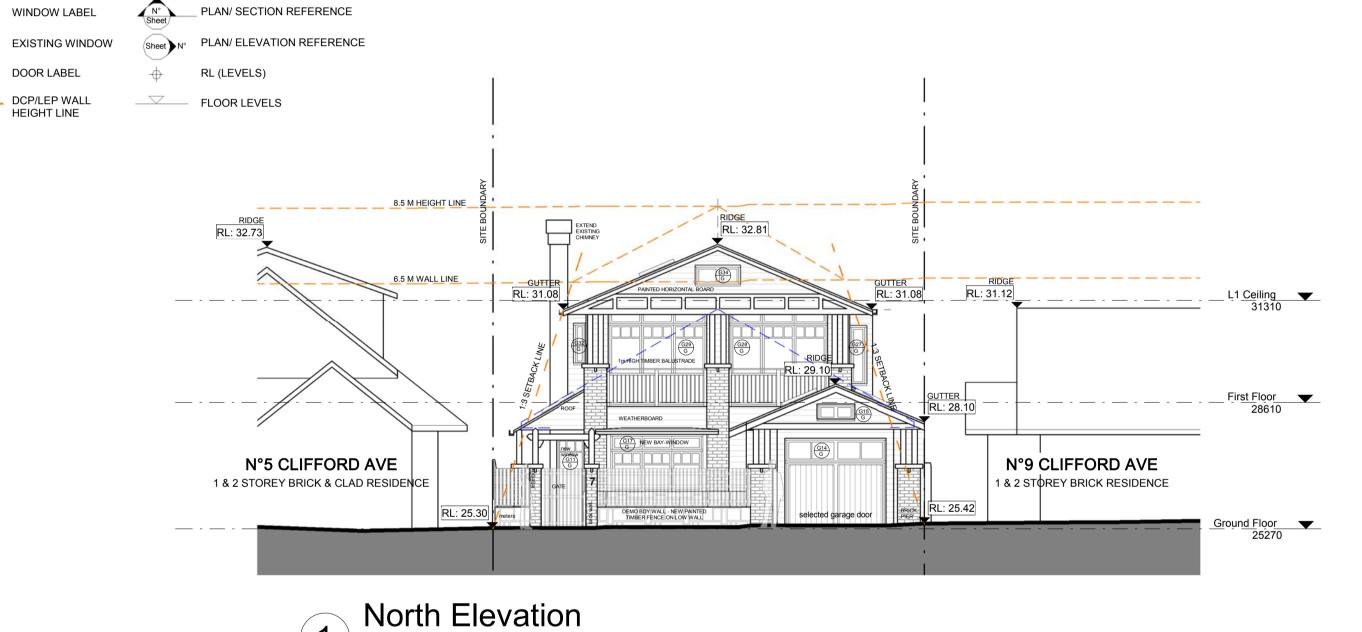

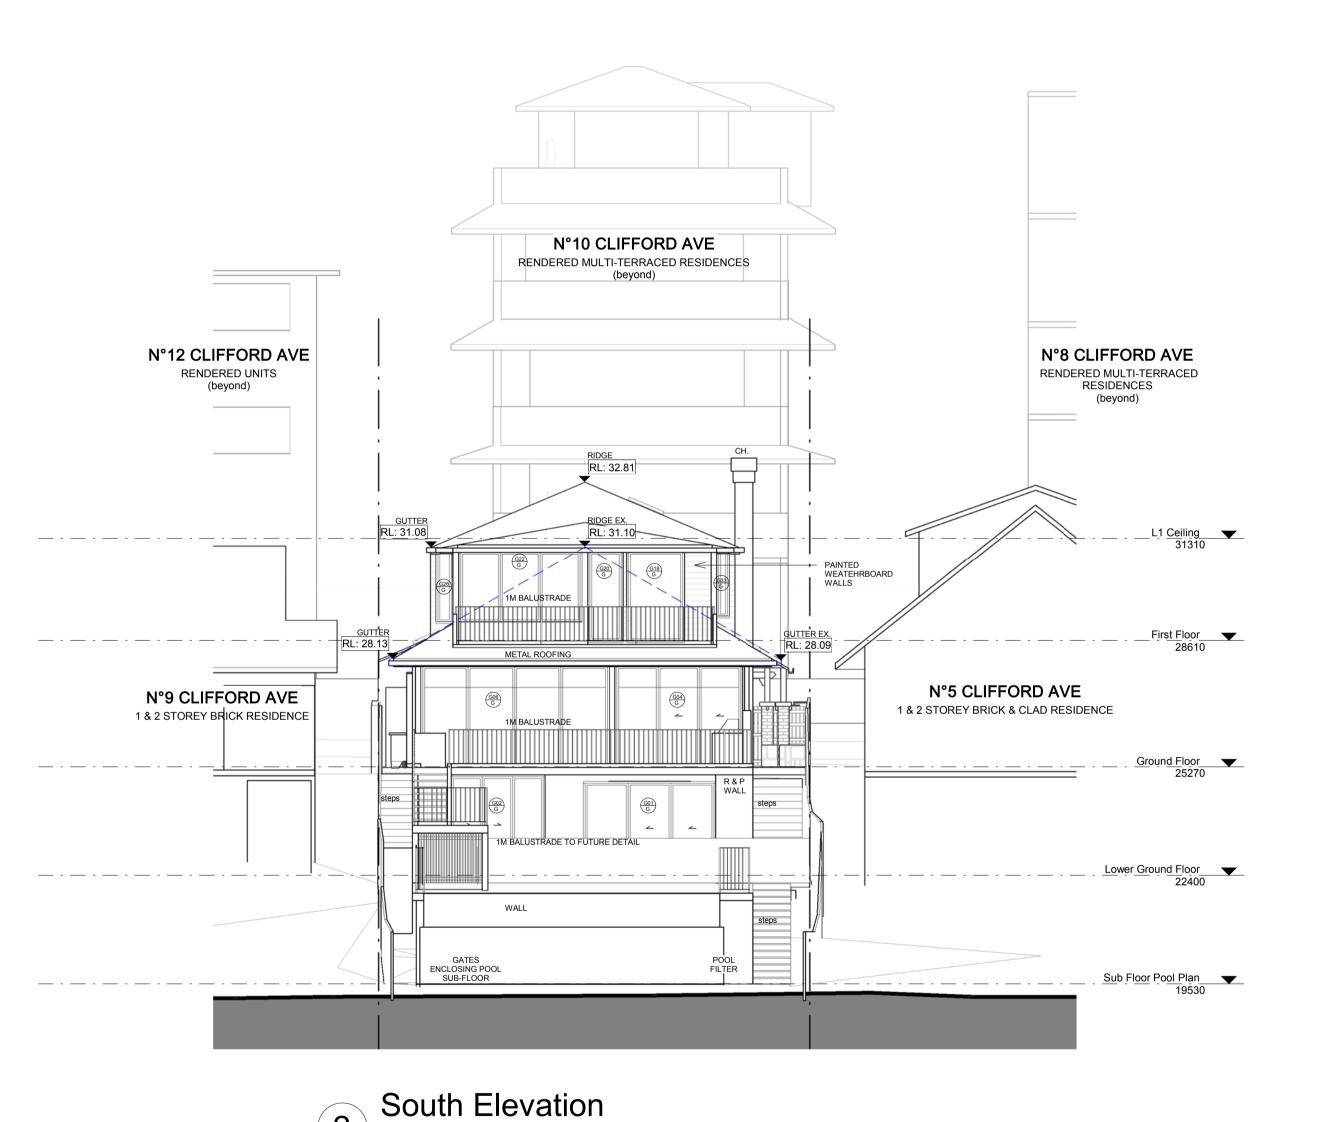

0m 1m 2m 3m 4m 5m 1:100 @ A1

NOTES

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issue date description 02/07/2018 Preliminary DA Issue for Review 19/10/2018 DA Issue for Review 05/11/2018 DEVELOPMENT APPLICATION

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DU PLESSIS DU PLESSIS ARCHITECTS

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NSW REGISTERED ARCHITECT #7435 NOMINATED ARCHITECT: EUGENE DU PLESSIS

PROJECT TITLE: OPADCHY House Alterations & Additions

CLIENT NAME: GEORGE + TATIANA OPADCHY

ADDRESS: 7 Clifford Avenue Fairlight NSW 2094

DRAWING TITLE:

Elevations North/South

EDUP AH SCALE:

CHECKED:

1:100@A1

DRAWING NO:

DRAWN:

DA.10

DATE: 05/11/2018


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SYMBOLS




DOOR LABEL __ _ DCP/LEP WALL


HEIGHT LINE

RL (LEVELS) FLOOR LEVELS

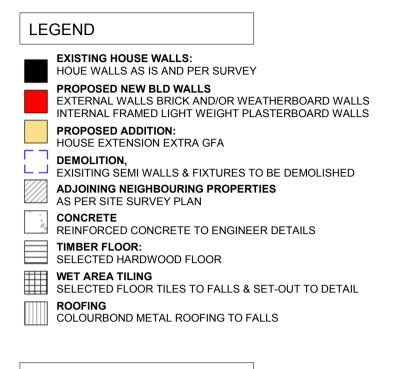
PLAN/ SECTION REFERENCE

Sheet N° PLAN/ ELEVATION REFERENCE

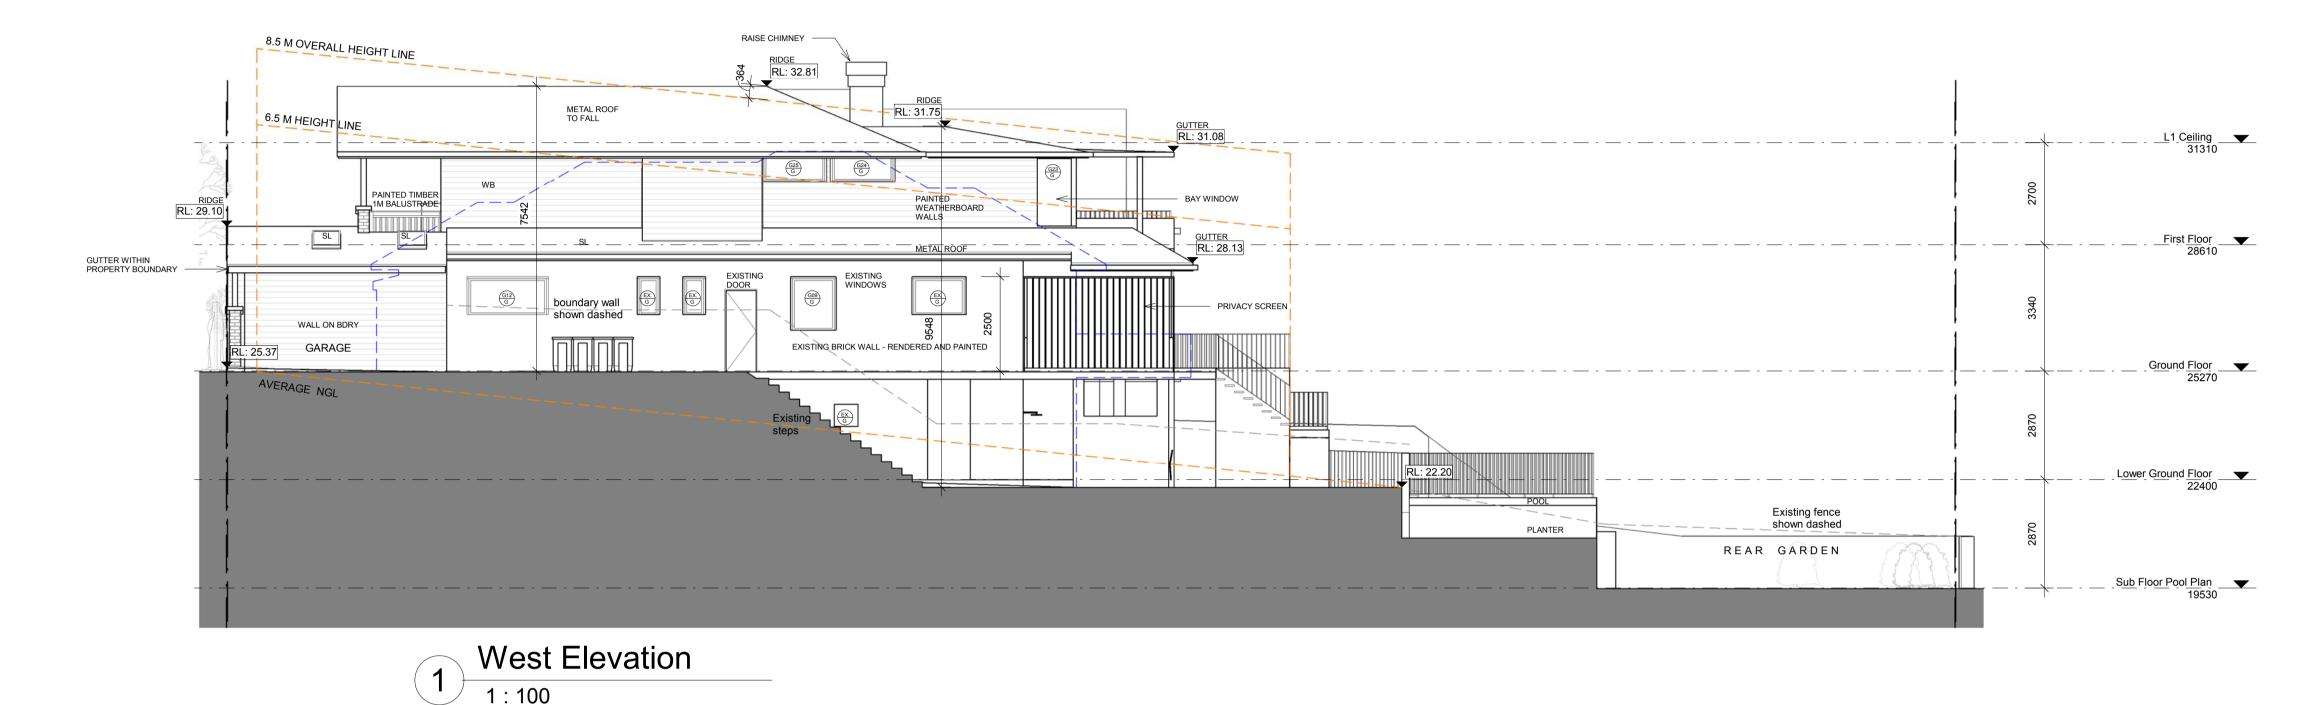

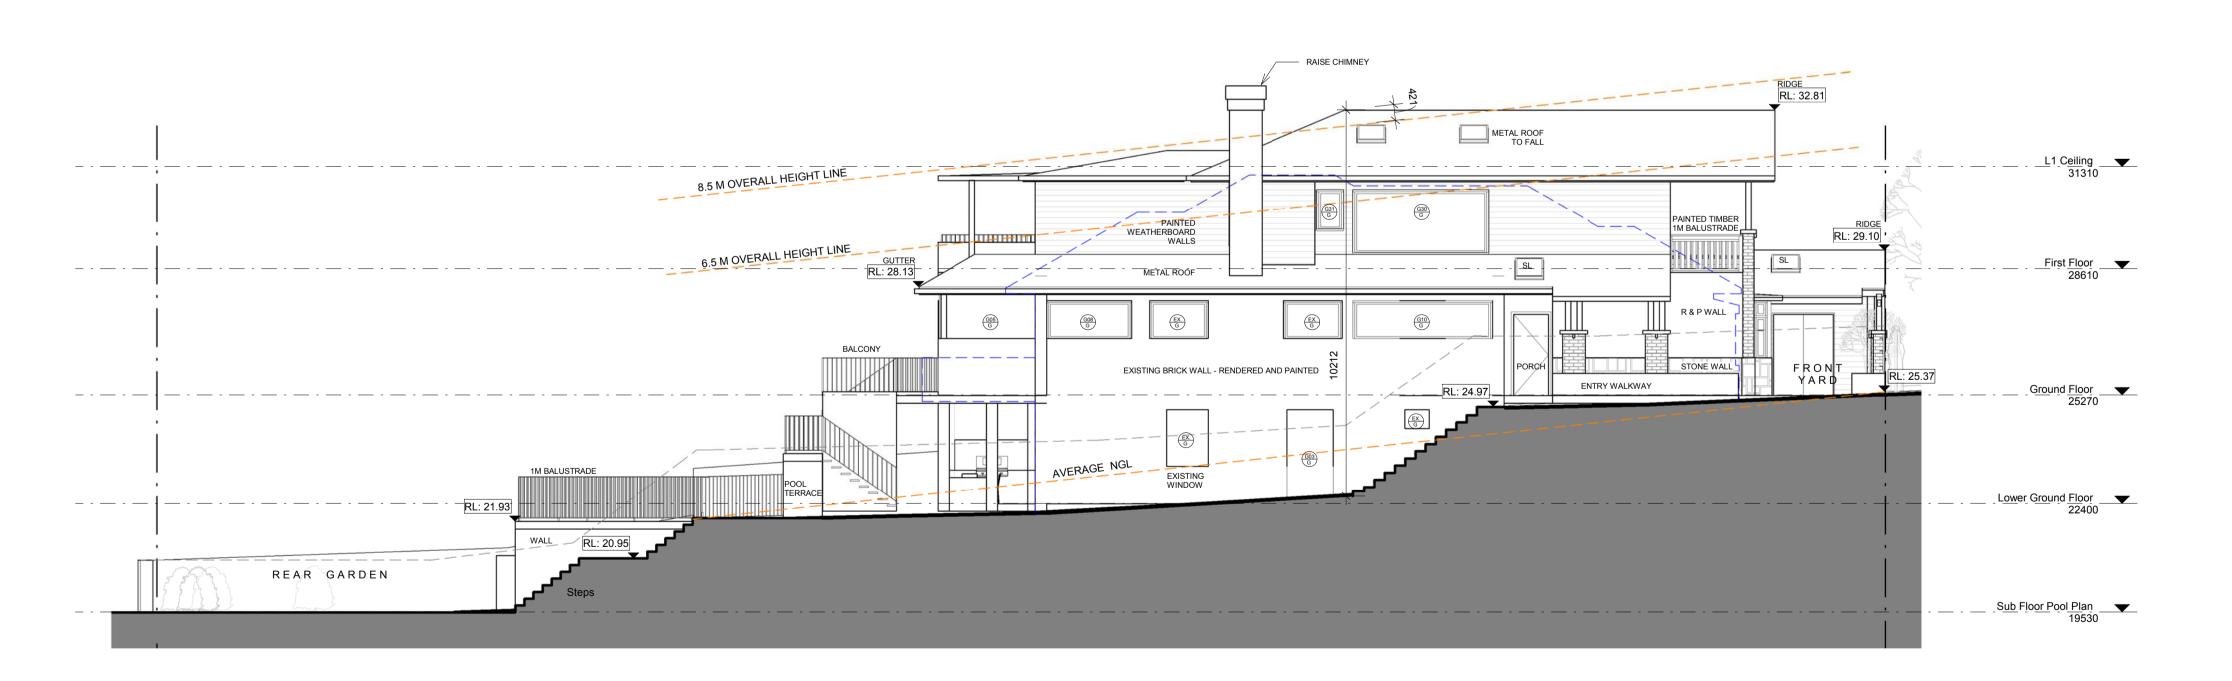



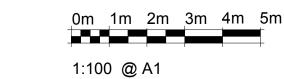

NOTES

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DU PLESSIS DU PLESSIS ARCHITECTS

NOMINATED ARCHITECT: EUGENE DU PLESSIS

0433408368 www.droom.com.au NSW REGISTERED ARCHITECT #7435

h@droom.com.au

PROJECT TITLE:

House Alterations & Additions CLIENT NAME:

GEORGE + TATIANA OPADCHY

ADDRESS:

7 Clifford Avenue Fairlight NSW 2094

OPADCHY

DRAWING TITLE: Elevations East/West

DRAWN: CHECKED: EDUP AH

SCALE: 1:100@A1


DRAWING NO:

DA.11


DATE: 05/11/2018





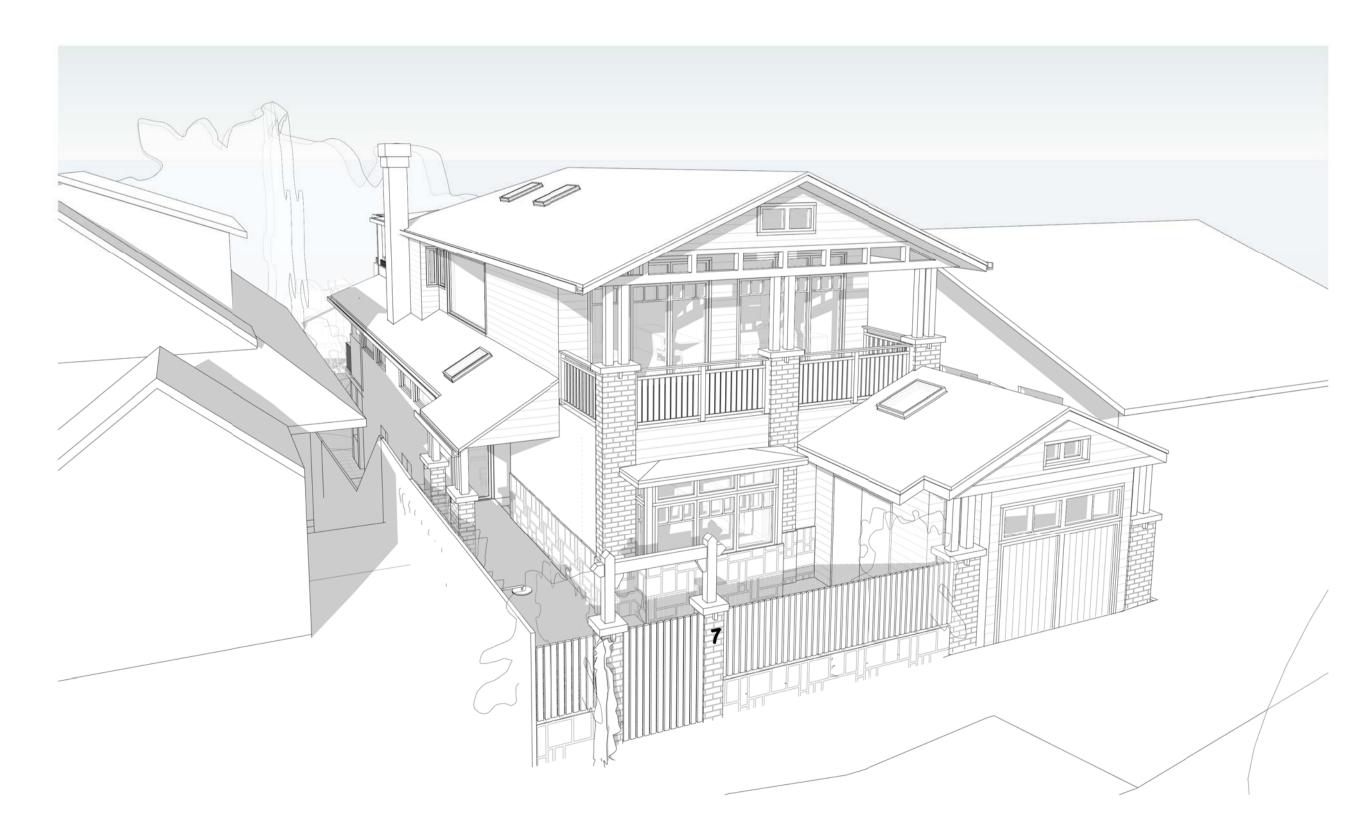

Perspective Northeast

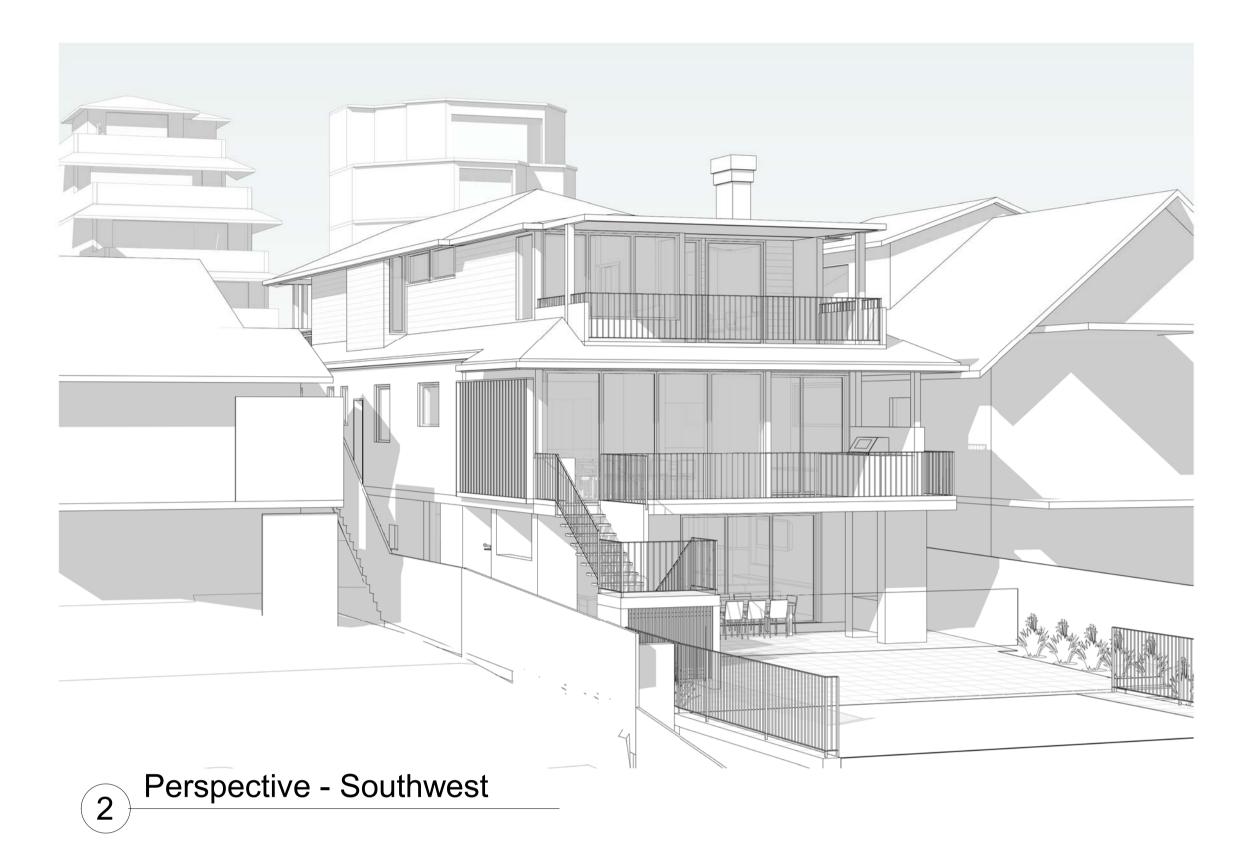



Perspective Northwest

NOTES

+ SITE SURVEY INFORMATION:
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+ COORDINATION:
REFER TO AND COORDINATE INFORMATION CONTAINED IN THE ARCHITECTURAL DRAWINGS AND THE DOCUMENTATION OF OTHER CONSULTANTS WITH THE 'SPECIFICATION FOR BUILDING WORKS'. REPORT DISCREPANCIES BETWEEN THE DOCUMENTS AND/OR WITH CONDITIONS ON SITE TO THE ARCHITECT FOR DIRECTION PRIOR TO PROCEEDING WITH THE WORKS.

+ DETAIL DRAWINGS:
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+ EXECUTE THE WORKS:
EXECUTE THE WORKS IN COMPLIANCE WITH THE CURRENT EDITION OF THE BUILDING CODE OF AUSTRALIA (AS AMENDED), CURRENT EDITIONS OF RELEVANT AUSTRALIAN AND OTHER PUBBLISHED STANDARDS (AS AMENDED) AND THE EXECUTION OF THE WORKS.

issue date description 02/07/2018 Preliminary DA Issue for Review 19/10/2018 DA Issue for Review 05/11/2018 DEVELOPMENT APPLICATION

- CONTRACTORS TO VERIFY ALL DIMENSIONS ON SITE BEFORE COMMENCING WORK.
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DU PLESSIS DU PLESSIS ARCHITECTS

h@droom.com.au 0433408368 www.droom.com.au NSW REGISTERED ARCHITECT #7435 NOMINATED ARCHITECT: EUGENE DU PLESSIS

PROJECT TITLE: OPADCHY House Alterations & Additions

CLIENT NAME: GEORGE + TATIANA OPADCHY

ADDRESS: 7 Clifford Avenue Fairlight NSW 2094

DRAWING TITLE: Perspectives

 AH SCALE:

DRAWING NO:

DA.13

05/11/2018

CHECKED: EDUP

						Glazi	ng Schedule					
GLAZING	WINDOW TYPE	FLOOR	AREA	LENGTH	HEIGHT	SILL HEIGHT	ORIENTATION	FUNCTION	QUANTITY	FRAME TYPE	SHADING	HARDWARE
G01		LG	9 m²	3486	2500	0		Exterior	1	TIMBER		
G02		LG	7 m²	2523	2670	0		Exterior	1	TIMBER		
G03		LG	3 m²	1220	2500	0		Exterior	1	TIMBER		
G04		GF	9 m²	3365	2700	0		Exterior	1	TIMBER		
G05		GF	6 m²	2401	2700	0		Exterior	1	TIMBER		
G06		GF	13 m²	4990	2700	0		Exterior	1	TIMBER		
G07		GF	9 m²	3775	2500	0		Exterior	1	TIMBER		
G08		GF	2 m²	2250	1000	1500		Exterior	1	TIMBER		
G09		GF	2 m²	1200	1400	1100		Exterior	1	TIMBER		
G10		GF	4 m²	3681	1000	1500		Exterior	1	TIMBER		
G11		GF	2 m²	797	2425	0		Exterior	1	TIMBER		
G12		GF	2 m²	2147	1000	1500		Exterior	1	TIMBER		
G13		GF	1 m²	700	2100	0		Exterior	1	TIMBER		
G14		GF	6 m²	2700	2400	0		Exterior	1	TIMBER		
G15		GF	0 m²	1000	400	2908		Exterior	1	TIMBER		
G16		GF	1 m²	350	1500	1000		Exterior	1	TIMBER		
G17		GF	4 m²	2635	1500	1000		Exterior	1	TIMBER		
G18		GF	1 m²	350	1500	1000		Exterior	1	TIMBER		
G19		FF	4 m²	1520	2400	0		Exterior	1	TIMBER		
G20		FF	2 m²	930	2400	0		Exterior	1	TIMBER		
G21		FF	2 m²	900	1800	500		Exterior	1	TIMBER		
G22		FF	6 m²	3250	1900	500		Exterior	1	TIMBER		
G23		FF	2 m²	900	1800	500		Exterior	1	TIMBER		
G24		FF	1 m²	1700	800	1700		Exterior	1	TIMBER		
G25		FF	1 m²	1700	800	1700		Exterior	1	TIMBER		
G26		FF	1 m²	450	2000	500		Exterior	1	TIMBER		
G27		FF	1 m²	450	1540	500		Exterior	1	TIMBER		
G28		FF	7 m²	2605	2500	0		Exterior	1	TIMBER		
G29		FF	7 m²	2605	2500	0		Exterior	1	TIMBER		
G30		FF	6 m²	3580	1670	430		Exterior	1	TIMBER		
G31		FF	1 m²	700	1050	1050		Exterior	1	TIMBER		
G32		FF	0 m²	330	1050	1050		Exterior	1	TIMBER		
G33		FF	1 m²	330	1895	650		Exterior	1	TIMBER		
G34		FF	1 m²	1200	500	3150		Exterior	1	TIMBER		

NOTES

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EXECUTION O	F THE WORKS.	
issue	date	description
А	02/07/2018	Preliminary DA Issue for Review
R	10/10/2018	DA Issue for Peview

19/10/2018 DA Issue for Review C 05/11/2018 DEVELOPMENT APPLICATION

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h@droom.com.au 0433408368 www.droom.com.au

NSW REGISTERED ARCHITECT #7435 NOMINATED ARCHITECT: EUGENE DU PLESSIS

PROJECT TITLE: OPADCHY House Alterations & Additions

CLIENT NAME: GEORGE + TATIANA OPADCHY

ADDRESS: 7 Clifford Avenue Fairlight NSW 2094

DRAWING TITLE: Glazing Schedule

AH

SCALE:

DRAWING NO:


DA.14

ISSUE:

DATE: 05/11/2018

CHECKED:

EDUP

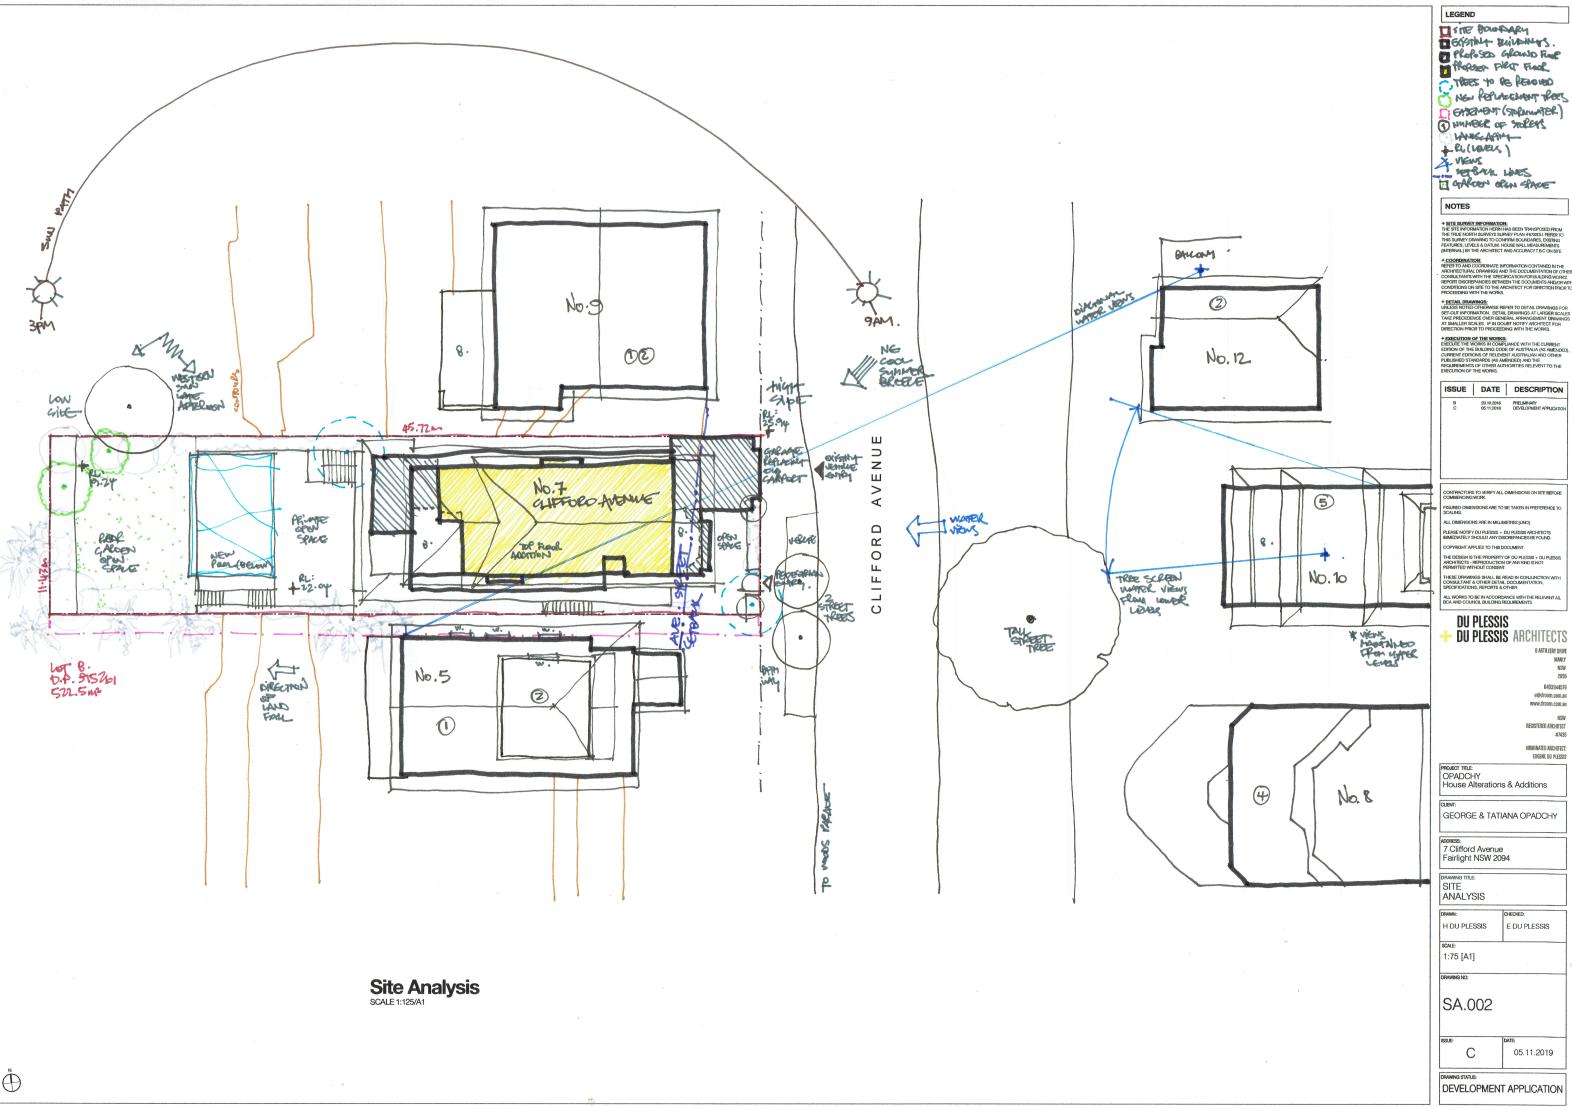


DU PLESSIS+ DU PLESSIS ARCHITECTS

20 MULGOWRIE CRESCENT BALGOWLAH HEIGHTS NSW 2093

> 0403944576 e@droom.com.au www.droom.com.au

> > NSW REGISTERED ARCHITECT: #7/135

NOMINATED ARCHITECT: Eugene du Plessis

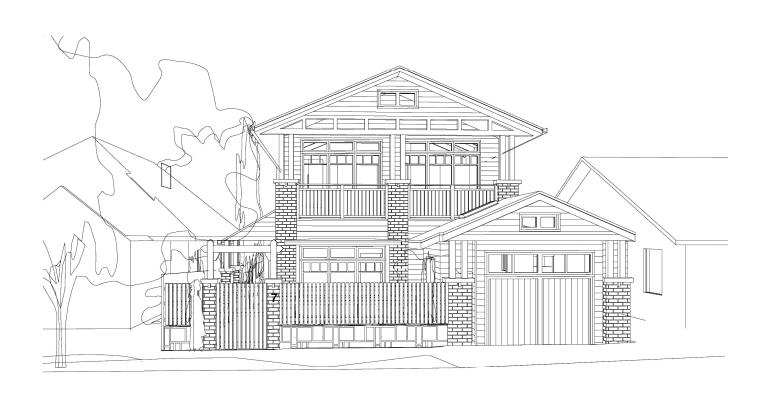

SCHEDULE OF EXTERNAL COLOURS & FINISHES

Address: No. 7 Clifford Avenue, Fairlight NSW 2093

Project: Alterations to an existing residential dwelling

Applicants & Owners: George & Tatiana Opadchy

Prepared by: Du Plessis + DuPlessis Architects

Date: March 2019

Issue: NBC Council Development Application

WALLS

1. Existing house masonry walls

Make good and re-paint existing house lower level brick and/or rendered walls. *Refer Dulux paint colours below.*

2. Proposed addition framed light-weight walls

Painted weatherboard cladding (typically Scyon Linea). Refer Dulux paint colours below.

3. Garden & other feature walls

Selected sandstone wall cladding (typically Eco Outdoor).

ROOFS

4. All roofing

Pitched Colorbond metal roofs to falls [0.58 Solar Absorptance & BCA Class 'M') Refer Colorbond roof colour below 'Windspray'

5. All roof gutters, downpipes, etc

Selected profiles (typically Stratco)
Refer Colorbond roof colour below 'Windspray'

FLOORING

6. House Terraces & Balconies

Selected large format slip free tiles to falls
Selected external grade travertine large format tiles

WINDOW & DOORS

7. All doors & Windows

White painted hardwood timber frame window & doors *Refer Dulux paint colours below.*

OTHER

8. Gables, fascia, eaves, timber fretwork, privacy screens, balustrades, street picket fence, etc

White painted hardwood timber, board & other *Refer Dulux paint colours below.*


9. Pool safety fencing


Frameless glass to detail [to comply with regulations)


10. Skylights


Proprietary as per manufacturer's details [Velux or similar glazing to comply with BASIX].


^{*} Refer enclosed External & Internal Mood Boards

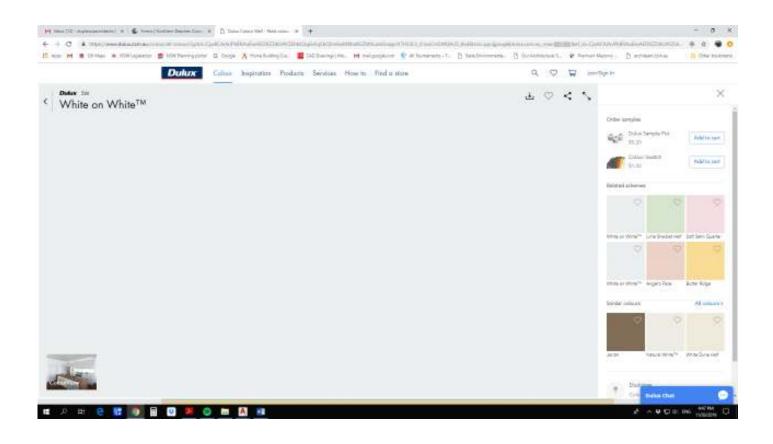


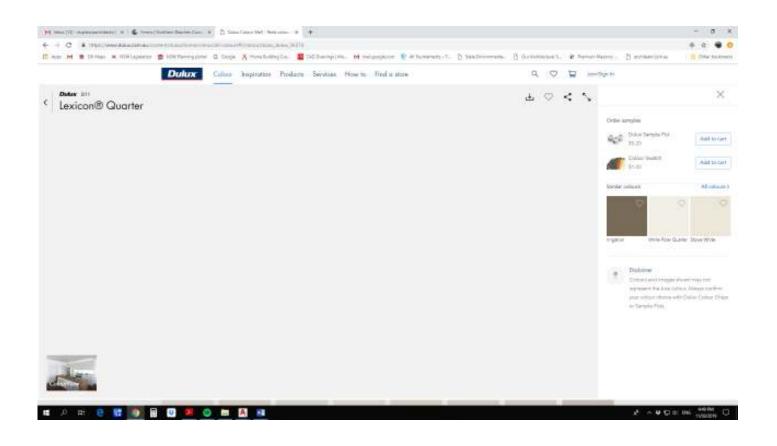

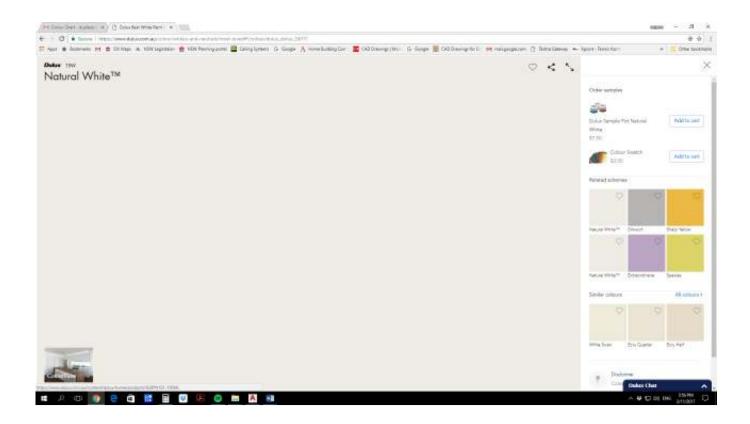

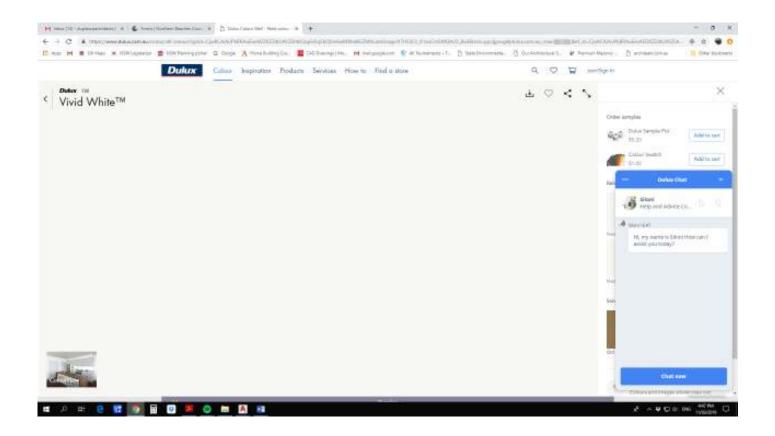

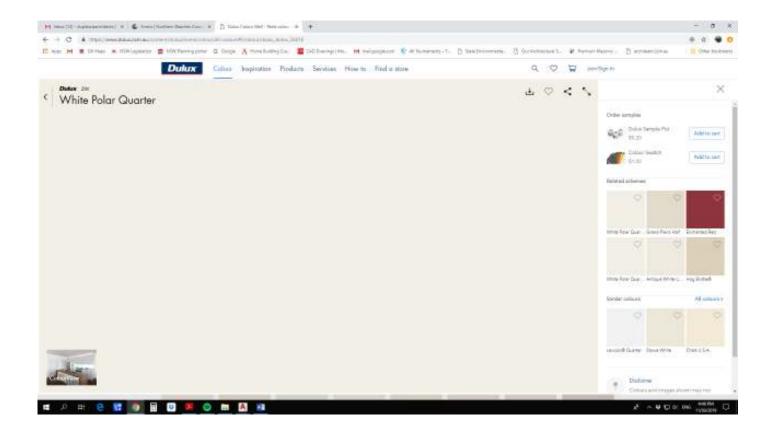

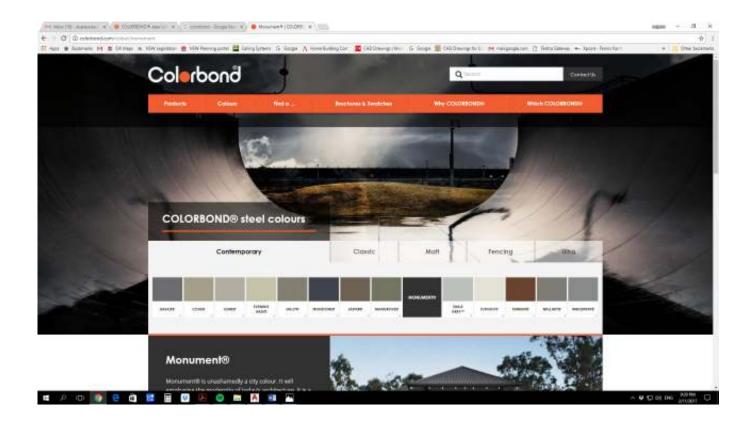

Exteriors

Colours, Gates, Flooring





































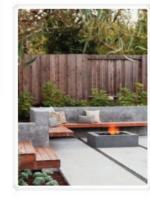





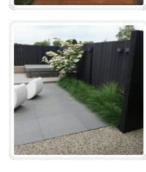






















Interiors
Living and Dining Areas / 1







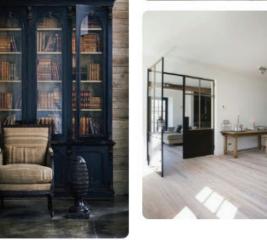



























































Interiors Living and Dining Areas / 2
























































Colour Palette

Options

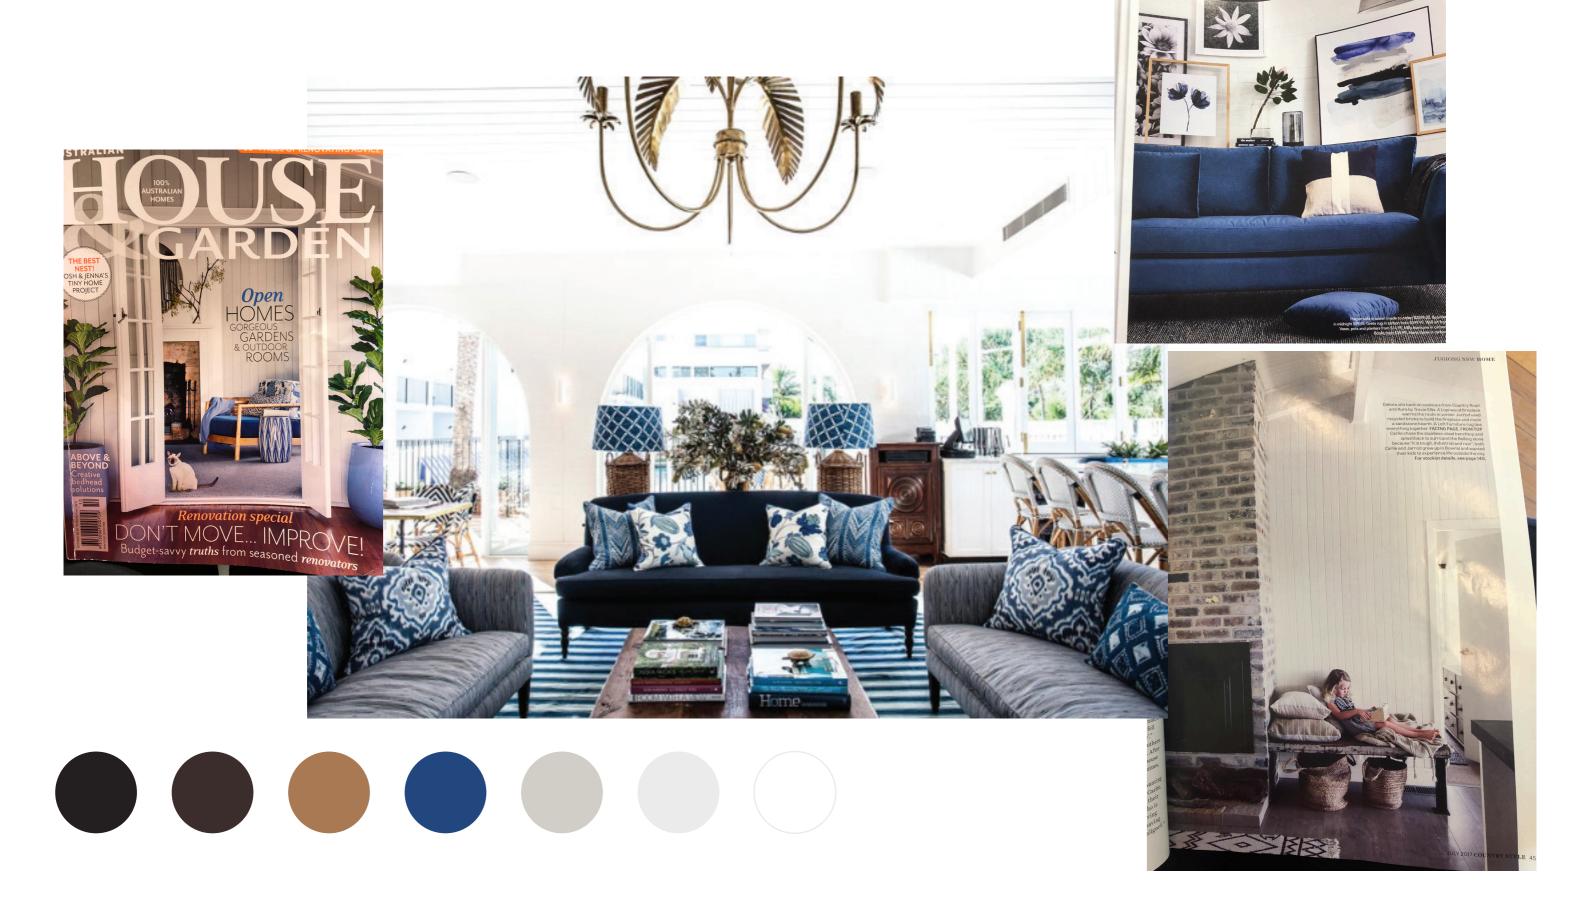

planting schedule LANDSCAPE NOTES POOL NOTES **BOTANICAL NAME COMMON NAME** 1. POOL DESIGN 1. SITE PREPARATION ANY EXISTING TREES AND VEGETATION TO BE RETAINED SHALL BE PRESERVED AND PROTECTED FROM DAMAGE OF ANY SORT DURING THE EXECUTION OF LANDSCAPE POOL SIZE = 7.8m X 4.9m POOL VOLUME = MAXIMUM 36 KILOLITRES WORK. IN PARTICULAR, ROOT SYSTEMS OF EXISTING PLANTS MUST NOT BE DISTURBED IF POSSIBLE. PLUMERIA ACUTIFOLIA FRANGIPANI POOL COPING LEVEL = RL:21.93 POOL FENCING = 1.2m FRAMELESS GLASS SAFETY FENCE & GATES TO COMPLY WITH STANDARDS NSW XMAS BUSH ANY NEARBY SITE WORKS SHOULD BE CARRIED OUT CAREFULLY USING HAND TOOLS. TO ENSURE THE SURVIVAL AND GROWTH OF EXISTING TREES DURING LANDSCAPING POOL FILTER BOX = LOCATED IN BELOW ENCLOSED POOL VOID AREA (ACCESSED FROM LOWER GARDEN AREA) TREES SHALL NOT BE REMOVED OR LOPPED UNLESS SPECIFIC WRITTEN APPROVAL TO DO SO IS GIVEN OR IS INDICATED ON PLAN. STORAGE OF MATERIALS, MIXING OF NOTE: POOL SUBJECT TO DETAIL STRUCTURAL ENGINEERING DESIGN BY OTHERS. MATERIALS, VEHICLE PARKING, DISPOSAL OF LIQUIDS, MACHINERY REPAIRS AND REFUELING, SITE OFFICE AND SHEDS, AND THE LIGHTING OF FIRES SHALL NOT OCCUR BUXUS MICROPHYLLA 'JAPONICUM' JAPANESE BOX 2.POOL FENCING ORANGE JESSAMINE SYZYGIUM RESILIENCE LILLY PILLY [HEDGED] DO NOT STOCKPILE SOIL, RUBBLE OR OTHER DEBRIS CLEARED FROM THE SITE, OR BUILDING MATERIALS, WITHIN THE DRIPLINE OF EXISTING TREES. VEHICULAR ACCESS POOL SAFETY FENCE MUST: SHALL NOT BE PERMITTED WITHIN THREE (3) METERS OF ANY TREE. BE AT LEAST 1.2M HIGH (AS MEASURED FROM THE FINISHED GROUND LEVEL) ORNAMENTAL GRASSES NOT LEAVE A GAP AT THE BOTTOM BIGGER THAN 100mm FROM THE FINISHED GROUND LEVEL IF A BOUNDARY FENCE IS PART OF THE POOL FENCE, THE BARRIER MUST BE 1.8m HIGH 2. SOIL PREPARATION LOMANDRA LONGIFOLIA FINE LEAF DWARF LOMANDRA 6 ALL PROPOSED PLANTING AREAS TO BE DEEP RIPPED TO 300MM AND CLAY SOILS TO BE TREATED WITH CLAY BREAKER. HARVEST EXISTING TOP SOIL FROM SITE AND NOT HAVE GAPS OF MORE THAN 100mm BETWEEN ANY VERTICAL BARS IN THE FENCE STORE ON SITE. MIX WITH 25% A.N.L. GREENLIFE COMPOST OR APPROVED EQUIVALENT. APPLY AT LEAST 200MM SOIL DEPTH TO PLANTING ARES. ADDITIONAL REQUIRED SOIL TO BE OF GOOD QUALITY PLANTING MIX TO BE IMPORTED AND COMBINED WITH 25% SIR WALTER BUFFALO BUFFALO LAWN DEPTH A.N.L. GREENLIFE COMPOST OR APPROVED EQUIVALENT. OWNERS TO REGISTER THE POOL WITH COUNCIL and/or FTNSW TO BE FULLY MIXED PRIOR TO INSTALLATION AND THEN WORKED IN WITH HOE. CARE TAKEN TO HAND CULTIVATE IN ANY AREA WHERE EXISTING TREE ROOTS EXIST TO 4. OTHER PRESERVE HEALTH OF TREES. POOL TILES, LIGHTS, ETC TO BE DECIDED. POOL HEATING TO BE CONFIRMED. POOL DRAINAGE TO STORMWATER ENGINEER DETAILS. 3. NEW PLANTINGS NEWLY PLANTED TREES AND LARGE SHRUBS SHOULD BE SECURED TO STAKES WITH HESSIAN TIES TO PREVENT ROCKING BY WIND. PLANTING HOLES FOR PLANT MATERIAL SHOULD BE LARGE ENOUGH IN SIZE TO TAKE ROOT BALL WITH ADDITIONAL SPACE TO TAKE BACK FILLING OF GOOD QUALITY PLANTING MIX. (SEE DETAIL) MATURE HEIGHTS OF PLANTING AS SHOWN ON PLANTI G SCHEDULE SHOW THE GREATEST HEIGHT POSSIBLE IN IDEAL CONDITIONS. THESE HEIGHTS ARE SUBJECT TO PARTICULAR SITE CONDITIONS. POSSIBLE CONTAINER ENVIRONMENTS AND INTENDED HEDGING OR PRUNING FOR FUNCTIONAL REQUIREMENTS SUCH AS AVAILABLE PLANTING WIDTH INTENDED ACCESS UNDER BRANCHES AND SOLAR ACCESS. ALL PLANTING AREAS TO BE MULCHED WITH A MINIMUM 100MM THICK COVER OF FOREST FINES MULCH AND THEN ALL PLANT AREAS TO BE THOROUGHLY SOAKED WITH 5. FERTILIZER ALL PLANTING AREAS TO BE FERTILIZED WITH 9 MONTH' NP'K SLOW RELEASE FERTILIZER 6. STAKING Hardwood stakes as specified TO THOSE PLANTS INDICATED ON THE PLANTING SCHEDULES PROVIDE HARDWOOD STAKES AS NOMINATED AND DRIVEN INTO GROUND TO A DEPTH ABLE TO ACHIEVE RIGID - Top of rootball 100mm above surrounding ground 7. LAWN EDGING ALL PLANTER BEDS ADJACENT TO LAWN AREAS TO HAVE FLUSH TIMBER EDGING TO FUTURE DETAIL. Root prune with saw or shovel outside 3-4cm of rootball to remove any roots growing around the outside of the pot/bag or vertically immediately prior to AUTOMATIC WATERING SYSTEM TO BE SELECTED. TO EXTEND TO ALL LANDSCAPED AREAS INCLUDED IN WORKS. IN GROUND DRIP LINE IRRIGATION ONLY EXCLUDING LAWN AREAS. THE LANDSCAPE CONTRACTOR IS TO LIAISE WITH COUNCIL AS NECESSARY TO ENSURE THAT THE IRRIGATION SYSTEM CONFORMS WITH ALL WATER BOARD. COUNCIL AND AUSTRALIAN STANDARDS (AS) TO BE CONNECTED TO PREFABRICATED RAINWATER STORAGE TANKS LOCATED IN SUB-BASE AREA. Loosely loop hessian tie 9. TURFING — 50mm depth mulch as specified, 2 x 2m Apply 50mm depth of area. keep mulch away from trunk of mulch uniformly applied TURF TO BE SOFT LEAF BUFFALO ON 150mm GOOD QUALITY TURF UNDERLAY OVER SOIL AREAS TO BE DEEP RIPPED TO 300MM DEPTH PRIOR TO INSTALLATION. 10. STRUCTURAL - Scarify existing subsoil to a Turf laid tightly butted & well Premium garden mix as specified depth of 150mm minimum ALL STRUCTURAL PLANTER RETAINING WALLS TO ENGINEER'S DETAILS to facilitate root growth Loosen soil on sides of hole 11. MAINTENANCE - 100mm bedding layer of turf underlay Planting hole to be twice - 50/50 mix of site soil and 75mm layer of site topsoil THE LANDSCAPE CONTRACTOR SHALL MAINTAIN THE CONTRACT AREAS BY ACCEPTED HORTICULTURAL PRACTICES AS WELL AS RECTIFYING ANY DEFECTS THAT BECOME premium garden mix as specified APPARENT IN THE WORKS UNDER NORMAL USE. THE LANDSCAPE CONTRACTOR SHALL MAINTAIN THE WORKS AND MAKE GOOD ALL DEFECTS FOR A PERIOD OF THIRTEEN as deep as container. Break up subgrade 100mm deep (13) WEEKS AFTER THE DATE OF PRACTICAL COMPLETION. Cultivate base 150mm backfilled with garden mix PRACTICAL COMPLETION OF THE LANDSCAPE WORKS SHALL INCLUDE BUT NOT BE LIMITED TO THE REPLACEMENT OF PLANTS WHICH HAVE FAILED OR BEEN DAMAGED OR as specified DETAIL C STOLEN DURING WORK UNDER THE CONTRACT. SHRUB PLANTING DETAIL N.T.S TURF DETAIL N.T.S PHOTOGRAPH 1 EXISTING REAR YARD GARDEN LANDSCAPE MAINTENANCE SHALL INCLUDE BUT NOT BE LIMITED TO THE FOLLOWING: WATERING, RUBBISH REMOVAL, SPRAYING AND WIPING LEAF SURFACES, REPLACING **ADJOINING NEIGHBOUR TREE** EXISTING POMEGRANATE TREE RETAIN (AS IS) NEW SHRUB (HEDGE PLANTING) MURRAYA [MP] NEW ENDEMIC TREE **NEW SHRUB (HEDGE PLANTING)** EXISTING STEPS EXISTING LEMON TREE RETAIN (AS IS) EXISTING BLACK FIG TREE deep end (1.8m max) NEW ENDEMIC TREE CHRISTMAS BOX [CB] lawn PHOTOGRAPH 1 open POOL TERRACE covered TERRACE EXISTING MANGO TREE RETAIN (AS IS) SWIMMING POOL REAR GARDEN No. 7 CLIFFORD AVENUE NEW TREE PAVERS ON SLAB TERRACE EXISTING PLANTER RETAIN (AS IS), PLANTING TO REMAIN

PAVED PATHWAY

shallow end (1.1m)

Landscape Plan
SCALE 1:75/A1

NEW SHRUB (HEDGE PLANTING)
LILLY PILLY [SYR]

ETAIN EXISTING or REPLACE IF/AS NECESSARY

EXISTING LILLY PILLY HEDGE

EXISTING MACADAMIA TREE

SELECTED POOL PAVERS

NEW SHRUB (HEDGE PLANTING) MURRAYA [MP]

ADJOINING NEIGHBOUR PALM TREES

NEW LOW HEDGE -JAPANESE BOX [BMJ]

PLANTER ON SLAB

NEW ORNAMANETAL GRASSES

PLANTING BEDS GARDEN AREAS EXISTING SITE TREES TO REMAIN NEW SITE TREES TREES TO BE REMOVED
REFER ARBORIST REPORT NOTES + SITE SURVEY INFORMATION:
THE SITE INFORMATION HERIN HAS BEEN TRANSPOSED FROM THE TRUE NORTH SURVEYS SURVEY PLAN #8732DU. REFER TO THIS SURVEY DRAWING TO CONFIRM BOUNDARIES, EXISTING FEATURES, LEVELS & DATUM. HOUSE WALL MEASUREMENTS [INTERNAL] BY THE ARCHITECT AND ACCURACY T.B.C ON SITE. + COORDINATION:
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LEGEND

EXECUTION OF THE WORKS.

+ EXECUTION OF THE WORKS:

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ISSUE DATE DESCRIPTION 20.10.2018 PRELIMINARY 05.11.2018 DEVELOPMENT APPLICATION

CONTRACTORS TO VERIFY ALL DIMENSIONS ON SITE BEFORE COMMENCING WORK. FIGURED DIMENSIONS ARE TO BE TAKEN IN PREFERENCE TO

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THESE DRAWINGS SHALL BE READ IN CONJUNCTION WITH CONSULTANT & OTHER DETAIL DOCUMENTATION, SPECIFICATIONS, REPORTS & OTHER.

BCA AND COUNCIL BUILDING REQUIREMENTS.

DU PLESSIS DU PLESSIS ARCHITECTS

> 0403944576 e@droom.com.au www.droom.com.au REGISTERED ARCHITECT

> > MOMINATED ARCHITECT: EUGENE DU PLESSIS

OPADCHY

House Alterations & Additions

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Z

EXISTING STREET TREES

PROTECT & RETAIN (AS I

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NEW TREE

GEORGE & TATIANA OPADCHY

7 Clifford Avenue Fairlight NSW 2094

DRAWING TITLE: CONCEPT LANDSCAPE PLAN

E DU PLESSIS H DU PLESSIS

SCALE:

1:75 [A1] DRAWING NO:

05.11.2019

DRAWING STATUS: DEVELOPMENT APPLICATION