

0 1 2 3 4 5 10 M SCALE 1:200

GENERAL NOTES:

- Builder to check and confirm all necessary dimensions on site prior to construction. Do not scale the drawing. 2. All dimensions that relate to site boundaries and easments are subjuct to verification by site survey, 3. All work to be in accordance with BUILDING CODE of AUSTRALIA & to the satisfaction of local council requirems 4. All timber construction to be in accordance with the "TIMBER FRAMING" code.
- Any detailing in addition to what is supplied shall be resolved between the owner and the builder to the owner's approval, except for any structual details or design which is to be supplied by Structual Engineer.
- 6 Roof water & sub-soil drainage to be disposed of in the approved manner or as directed by local council inspectors 7 All electrical power & light outlets to be determined by owner. 8 Make good and repair all existing finishes damaged by new work. Reuse existing material where possible.
- 11/09/19 DATE ISSUED FOR DA AMENDMENT No.

DESIGN BY:


MICHAL KORECKY

21 NALYA ROAD, NARRAWEENA NSW 2099 ABN: 79 393 130 294


Email: koreckym@gmail.com Phone: 99813332, Mob: 0438 148 944 PROJECT:

PROPOSED ADDITIONS AND ALTERATIONS No 30 NARRABEEN PARK PARADE WARRIEWOOD NSW 2102 **BON KAIN** LOT 23 DP 15763

DATE:	11/09/19	SCALE:	AS NOTED
DRAWN:	MK	ISSUE:	1
DRAWIN	9006	SHEET:	1

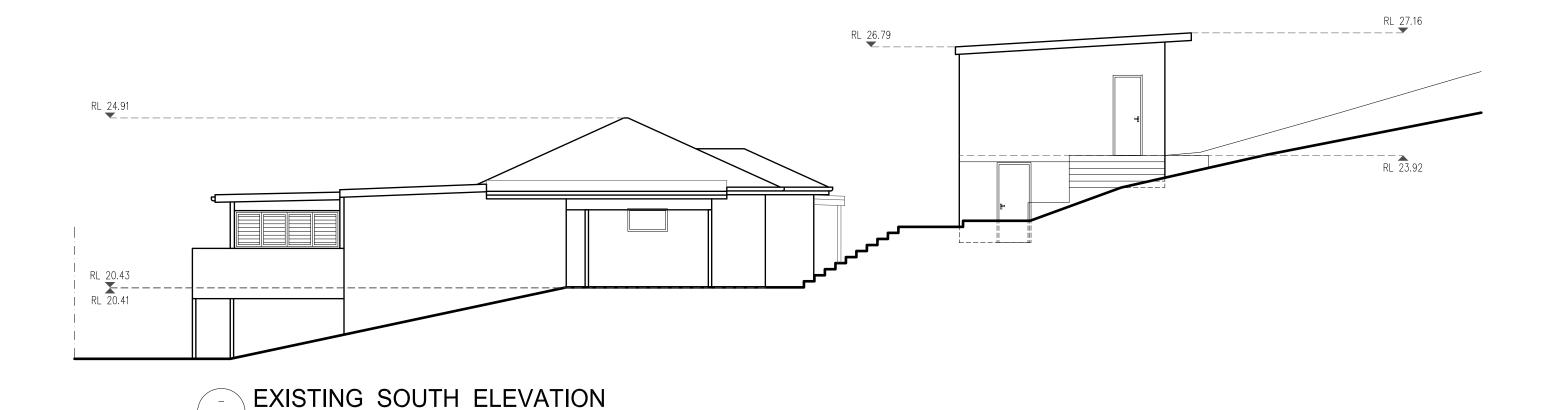



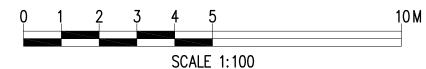

- 1 Builder to check and confirm all necessary dimensions on site prior to construction. Do not scale the drawing.
 2 All dimensions that relate to site boundaries and easments are subjuct to verification by site survey.
 3 All work to be in accordance with BUILDING CODE of AUSTRAIA & to the satisfaction of local council requirements & other authoriti
 4 All timber construction to be in accordance with the "IMBER FRAMING" code.
 5 Any detailing in addition to what is supplied shall be resolved between the owner and the builder to the owner's approval, except for any structual details or design which is to be supplied by Structual Engineer.
- A structure devices or design which is to be applied by stated Engineer.

 Roof water & sub-soil drainage to be disposed of in the approved manner or as directed by local council inspectors.

 All electrical power & light outlets to be determined by owner.


 Make good and repair all existing finishes damaged by new work. Reuse existing material where possible.
- 11/09/19 DATE ISSUED FOR DA AMENDMENT No.

DESIGN BY: MICHAL KORECKY

21 NALYA ROAD, NARRAWEENA NSW 2099

PROJECT: PROPOSED ADDITIONS AND ALTERATIONS
No 30 NARRABEEN PARK PARADE
WARRIEWOOD NSW 2102 CLIENT: BON KAIN LOT 23 DP 15763

•	LL 11.100	
	DATE: 11/09/19	SCALE: AS NOTED
	DRAWN: MK	ISSUE: 1
	DRAWING Nr : 1906	SHEET: 4

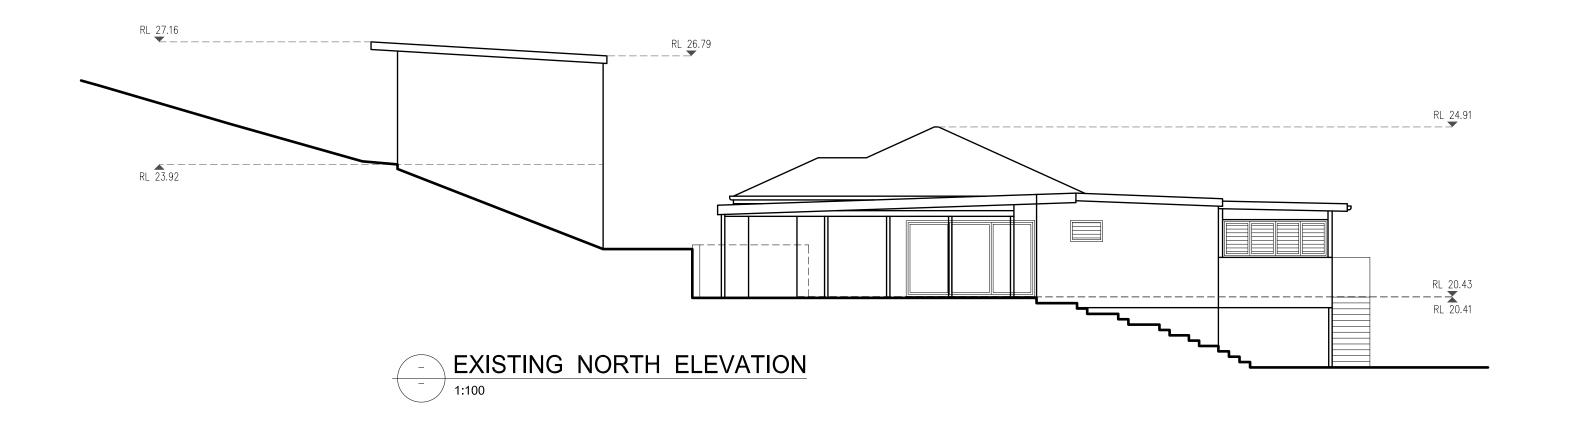





- I Builder to check and confirm all necessary dimensions on site prior to construction. Do not scale the drawing.

 2 All dimensions that relate to site boundaries and easments are subjuct to verification by site survey.

 3 All work to be in accordance with BUILDING CODE of AUSTRALIA & to the satisfaction of local council requirements & other authorities.

 4 All timber construction to be in accordance with the "TIMBER FRAMING" code.

 5 Any detailing in addition to what is supplied shall be resolved between the owner and the builder to the owner's approval, except for any structual details or design which is to be supplied by Structual Engineer.
- Any structure when so design which is to be supplied by structure Engineer.

 Roof water & sub-soil drainage to be disposed of in the approved manner or as directed by local council inspectors.

 All electrical power & light outlets to be determined by owner.

 Make good and repair all existing finishes damaged by new work. Reuse existing material where possible.

-	T		_
1 -			ı
			1
		11 /22 /12	1
1	ISSUED FOR DA	11/09/19	1
No	. AMENDMENT	DATE	l
C	COPYRIGHT:		

DESIGN BY:


MICHAL KORECKY

21 NALYA ROAD, NARRAWEENA NSW 2099
ABN: 79 393 130 294
Email: koreckym@gmail.com www.plansdesign.com.au
Phone: 99813332, Mob: 0438 148 944

PROPOSED ADDITIONS AND ALTERATIONS
No 30 NARRABEEN PARK PARADE
WARRIEWOOD NSW 2102 CLIENT: BON KAIN LOT 23 DP 15763

SCALE 1:100				
WC.	DATE: 11/09/19	SCALE: AS NOTED		
)NS	DRAWN: MK	ISSUE: 1		
763	19006	SHEET: 5		

10 M

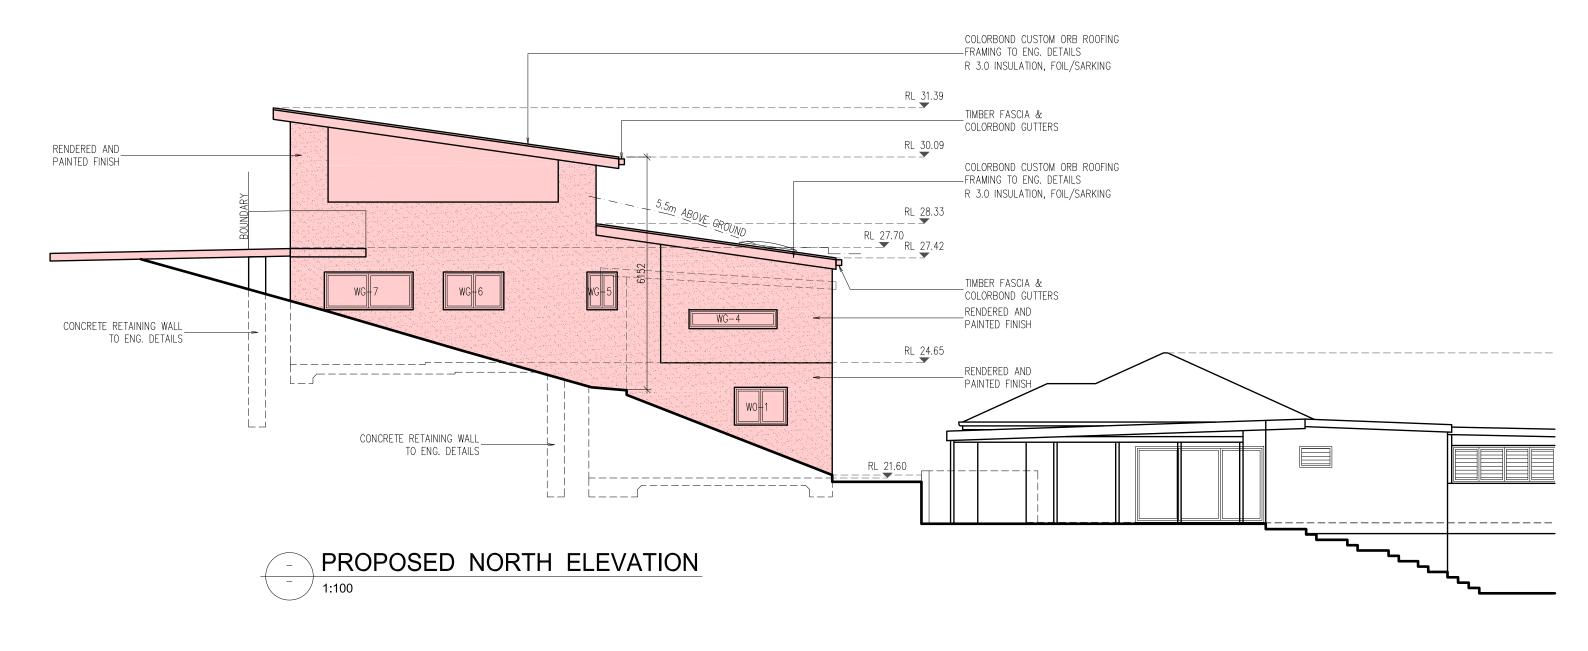



- 1 Builder to check and confirm all necessary dimensions on site prior to construction. Do not scale the drawing.
 2 All dimensions that relate to site boundaries and easments are subject to verification by site survey.
 3 All work to be in accordance with BUILDING CODE of AUSTRAIJA & to the satisfaction of local council requirements & other authorities
 4 All timber construction to be in accordance with the "TIMBER FRAMING" code.
 5 Any detailing in addition to what is supplied shall be resolved between the owner and the builder to the owner's approval, except for any structual details or design which is to be supplied by Structual Engineer.
- 6 Roof water & sub-soil drainage to be disposed of in the approved manner or as directed by local council inspectors 7 All electrical power & light outlets to be determined by owner. 8 Make good and repair all existing finishes damaged by new work. Reuse existing material where possible.
- 11/09/19 DATE ISSUED FOR DA AMENDMENT No.


DESIGN BY: MICHAL KORECKY

21 NALYA ROAD, NARRAWEENA NSW 2099 ABN: 79 393 130 294

Email: koreckym@gmail.com www.plansdesign.com.au Phone: 99813332, Mob: 0438 148 944 PROJECT:

PROPOSED ADDITIONS AND ALTERATIONS No 30 NARRABEEN PARK PARADE WARRIEWOOD NSW 2102 CLIENT: BON KAIN LOT 23 DP 15763

•		•		
	DATE: 1	1/09/19	SCALE:	AS NOTED
	DRAWN: M	IK	ISSUE:	1
	drawing n	006	SHEET:	9

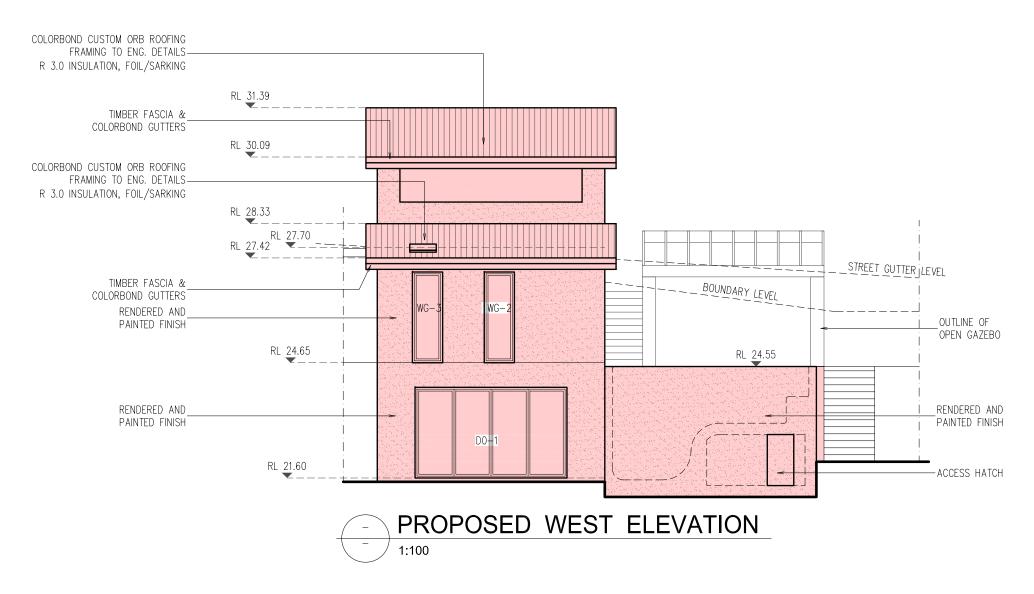

WINDOWS AND DOOR SCHEDULE				
	ORIENT.	SI	ZE	AREA (m2)
	OTTLETT	Н	W	(***=)
WG-1	SOUTH	2400	1810	4.34
WG-2	WEST	2400	800	1.92
WG-3	WEST	2400	800	1.92
WG-4	NORTH	500	2350	1.17
WG-5	NORTH	1000	800	0.80
WG-6	NORTH	1000	1600	1.60
WG-7	NORTH	1000	2350	2.35
WG-8	SOUTH	1000	500	0.50
DG-1	SOUTH	2400	2400	5.76
DG-2	SOUTH	2400	2700	6.48
W0-1	NORTH	1000	1400	10.5
D0-1	WEST	2400	4020	9.65

11/09/19 DATE ISSUED FOR DA AMENDMENT No.

DESIGN BY:

MICHAL KORECKY

21 NALYA ROAD, NARRAWEENA NSW 2099 ABN: 79 393 130 294

Email: koreckym@gmail.com www.plansdesign.com.au Phone: 99813332, Mob: 0438 148 944 PROJECT:

PROPOSED ADDITIONS AND ALTERATIONS No 30 NARRABEEN PARK PARADE WARRIEWOOD NSW 2102 CLIENT: BON KAIN LOT 23 DP 15763


SC	SCALE 1:100				
NC	DATE: 11/09/19	SCALE: AS NOTED			
NS	DRAWN: MK	ISSUE: 1			
63	19006	SHEET: 10			

10 M



1 Builder to check and confirm all necessary dimensions on site prior to construction. Do not scale the drawing.
2 All dimensions that relate to site boundaries and assments are subjuct to verification by site survey.
3 All work to be in accordance with BUILDING CODE of AUSTRAILA & to the satisfaction of local council requirements & other authorities
4 All timber construction to be in accordance with the "TIMBER FRAMING" code.
5 Any detailing in addition to what is supplied shall be resolved between the owner and the builder to the owner's approval, except for any structual details or design which is to be supplied by Structual Engineer.

6 Roof water & sub-soil drainage to be disposed of in the approved manner or as directed by local council inspectors.
7 All electrical power & light outlets to be determined by owner.
8 Make good and repair all existing finishes damaged by new work. Reuse existing material where possible.

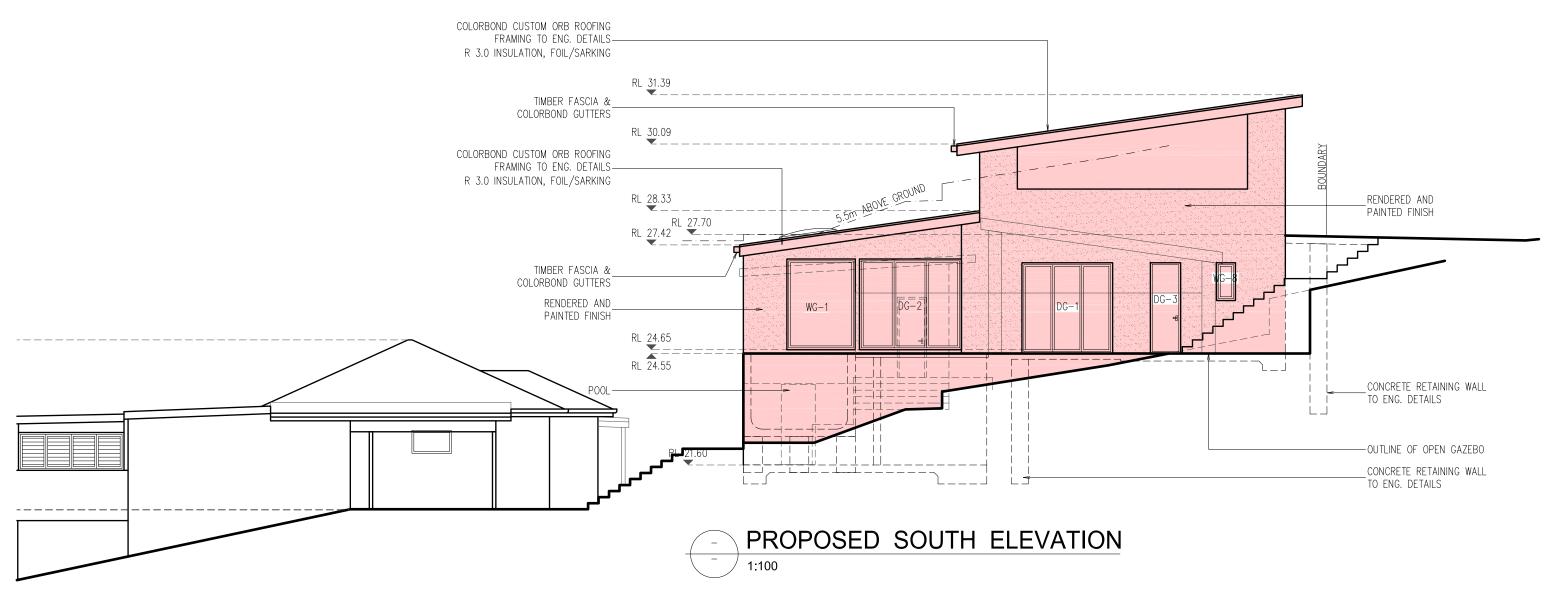

POOL FENCES

Essentially a barrier fence can be made of any material that has a reasonable life span when exposed to the likely conditions of weather, pool chemicals, pollution, decay, insects, salt water spray, etc. Fences must have an effective perpendicular height of 1.2 metres. Existing standard paling fences can be used provided that they are well-maintained and at least 1650mm high. If the rails are on the outside of the pool area, then 60 degree splayed sections are to be fitted securely to the middle and top rails (unless fence height is over 2400mm).

When a fence is not controlled by the pool owners, i.e. a neighbour's boundary fence, then the pool area must be protected for a radius of 1.2 metres by an approved safety fence.

Ground clearance between bottom of fence and ground level is not to exceed 100mm and any horizontal rails, rods, etc, which could assist climbing, should be on the pool side of the fence. If they're on the outside, they should be at least 900mm apart. The space between vertical members must not exceed 100mm.

POOL GATES

These must open outward only and have an effective perpendicular height of 1.2 metres. They must return to the closed position and engage the latch automatically from any position and not re-open without using the manual release mechanism. The latch must be at least 1.5 metres above ground level unless it is inside the fence can only be reached over or through a fence higher than 1.2 metres or is 150mm below the fence top (no hand hole) or at least 150mm away from the edge of any hand hole opening. Latches less than 1.5 metres above ground level must be shielded so that no opening greater than 10mm is closer than 450mm. Any hand hole shall be at least 1.2 metres from ground level.

10 M SCALE 1:100

GENERAL NOTES:

- 2 All dimensions that relate to site boundaries and easements are subject to verification by site survey.

 3 All work to be in accordance with BUILDING CODE of AUSTRALA & to the satisfaction of local council requirements & other authorities.

 4 All timber construction to be in accordance with the "TIMBLE REAMING" code.
- Any detailing in addition to what is supplied shall be resolved between the owner and the builder to the owner's approval, except fo any structual details or design which is to be supplied by Structual Engineer.
- 5 Roof water & sub—soil drainage to be disposed of in the approved manner or as directed by local council inspectors.

 All electrical power & light outlets to be determined by owner.

 Make good and repair all existing finishes damaged by new work. Reuse existing material where possible.

11/09/19 DATE ISSUED FOR DA <u>AMENDME</u>NT No.


DESIGN BY: MICHAL KORECKY


21 NALYA ROAD, NARRAWEENA NSW 2099 ABN: 79 393 130 294


Fmail: koreckym@amail.com Phone: 99813332, Mob: 0438 148 944

PROJECT: PROPOSED ADDITIONS AND ALTERATIONS No 30 NARRABEEN PARK PARADE WARRIEWOOD NSW 2102 BON KAIN LOT 23 DP 15763

, A	ALE 1.100				
]	DATE: 11/09/19	SCALE:	AS NOTED		
	DRAWN: MK	ISSUE:	1		
	DRAWING Nr : 1906	SHEET:	11		

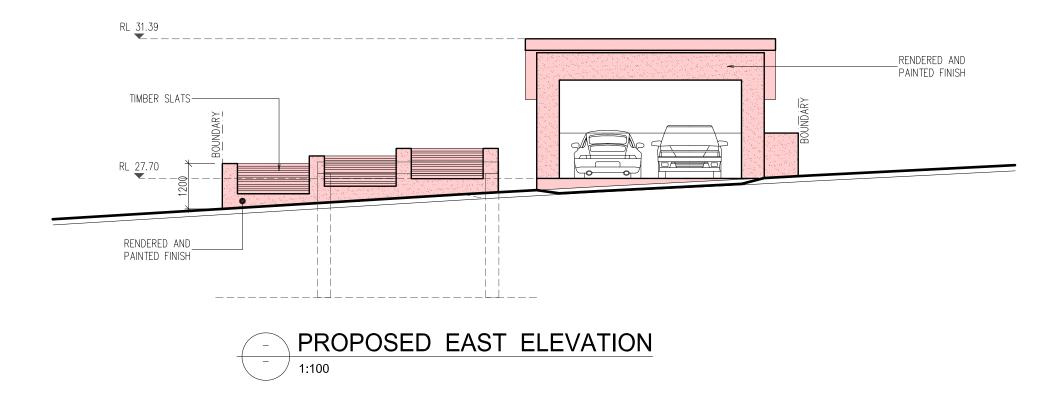

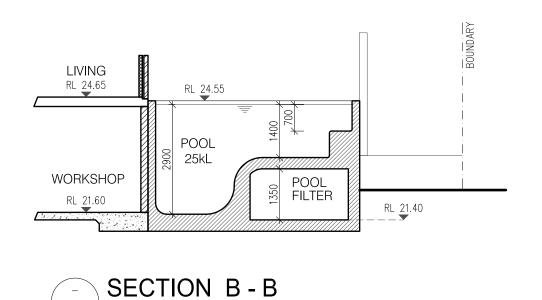

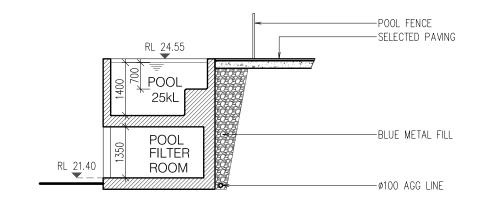



1 Builder to check and confirm all necessary dimensions on site prior to construction. Do not scale the drawing.
2 All dimensions that relate to site boundaries and easments are subject to verification by site survey.
3 All work to be in accordance with BUILDING CODE of AUSTRALIA & to the satisfaction of local council requirements & other authorities.
4 All timber construction to be in accordance with the "TIMBER FRAMING" code.
5 Any detailing in addition to what is supplied shall be resolved between the owner and the builder to the owner's approval, except for any structual details or design which is to be supplied by Structual Engineer.

1:100

6 Roof water & sub-soil drainage to be disposed of in the approved manner or as directed by local council inspectors.
7 All electrical power & light outlets to be determined by owner.
8 Make good and repair all existing finishes damaged by new work. Reuse existing material where possible.

			11
			11
			11
1	ISSUED FOR DA	11/09/19	11
No.	AMENDMENT	DATE] [
CODY	VDICUT.		٦l

All plans and drawings are subject of copyright and any attempt or actual infringement by using, reproducting or copying same, wholly or in part, without prior written permission will result in legal proceedings.

DESIGN BY: MICHAL KORECKY

21 NALYA ROAD, NARRAWEENA NSW 2099 ABN: 79 393 130 294


Email: koreckym@gmail.com Phone: 99813332, Mob: 0438 148 944

PROJECT: PROPOSED ADDITIONS AND ALTERATIONS
No 30 NARRABEEN PARK PARADE
WARRIEWOOD NSW 2102 CLIENT: BON KAIN

LOT 23 DP 15763


SC	SCALE 1:100				
NC	DATE: 11/09/19	SCALE:	AS NOTED		
NS	DRAWN: MK	ISSUE:	1		
63	DRAWING Nr : 1906	SHEET:	12		


10 M

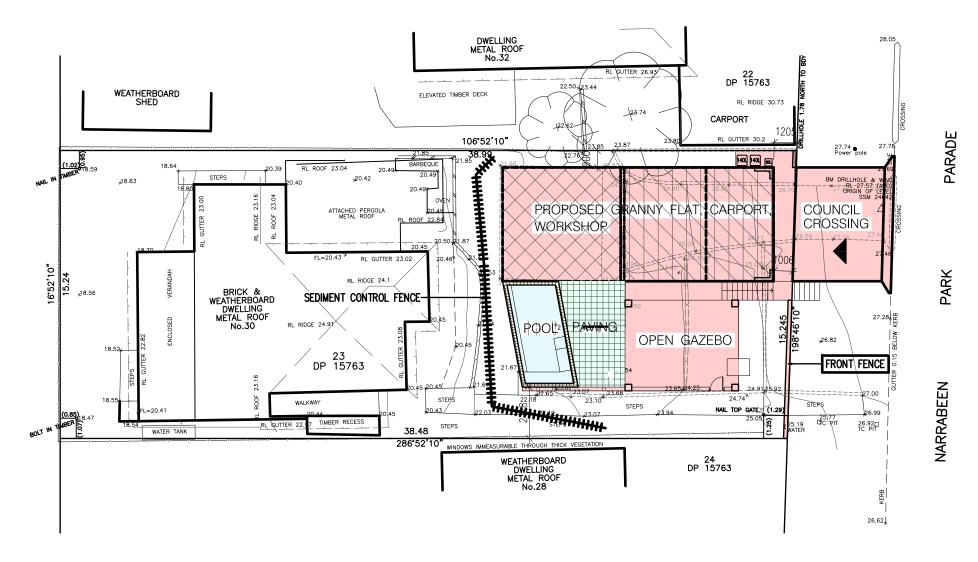

EROSION AND SEDIMENT MANAGEMENT PLAN

1:200

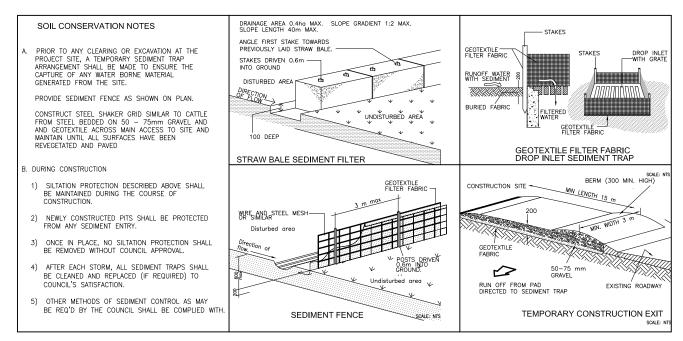

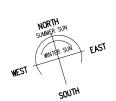

0 1 2 3 4 5 10 M SCALE 1:200

GENERAL NOTES:

- Builder to check and confirm all necessary dimensions on site prior to construction. Do not scale the drawing.

 2. All dimensions that relate to site boundaries and easments are subject to verification by site survey.

 3. All work to be in accordance with BUILDING CODE of AUSTRALIA & to the satisfaction of local council requirements & other authorities.

 4. All timber construction to be in accordance with the "TIMBER FRAMING" code.
- Any detailing in addition to what is supplied shall be resolved between the owner and the builder to the owner's approval, except for any structual details or design which is to be supplied by Structual Engineer.

- 6 Roof water & sub-soil drainage to be disposed of in the approved manner or as directed by local council inspectors 7 All electrical power & light outlets to be determined by owner. 8 Make good and repoir all estisting finishes damaged by new work. Reuse existing material where possible.

1	ISSUED FOR DA	11/09/19
No.	AMENDMENT	DATE
COPYRIGHT:		
All pla actual part,	ins and drawings are subject of copyright and any attempt or infringement by using, reproducting or copying same, wholly or in without prior written permission will result in legal proceedings.	


DESIGN BY: MICHAL KORECKY

21 NALYA ROAD, NARRAWEENA NSW 2099 ABN: 79 393 130 294

Email: koreckym@gmail.com Phone: 99813332, Mob: 0438 148 944

PROJECT: PROPOSED ADDITIONS AND ALTERATIONS No 30 NARRABEEN PARK PARADE WARRIEWOOD NSW 2102 BON KAIN LOT 23 DP 15763

DATE: 11/09/19	SCALE:	AS NOTED
DRAWN: MK	ISSUE:	1
DRAWING Nr : 1906	SHEET:	14

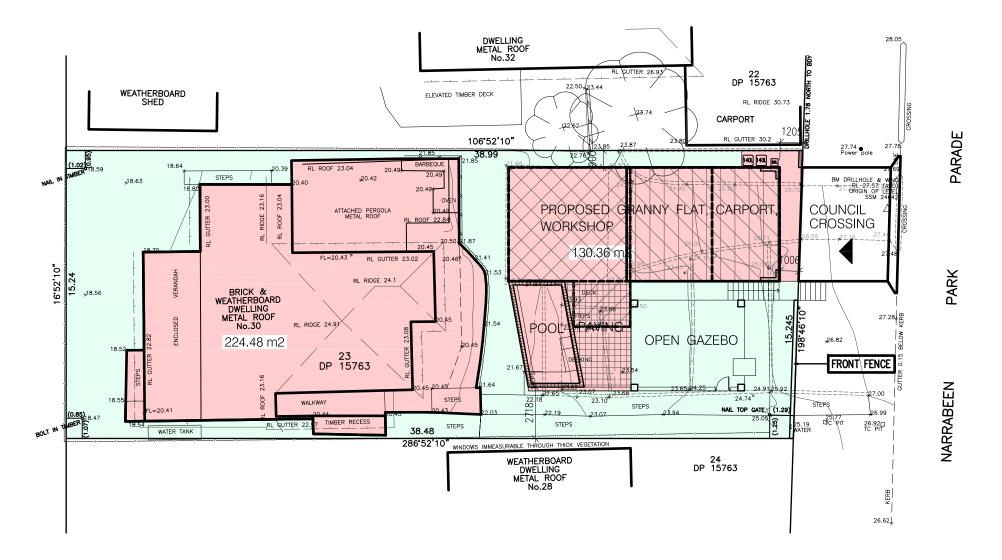


SITE COVERAGE AND LANDSCAPE AREA

SITE AREA: 590.2 m2 (100.00 %)

(60.00 %) SITE COVERAGE: 224.48 m2 + 130.36 m2 = 354.81 m2

(40.00 %) 235.39 m2 LANDSCAPE AREA:

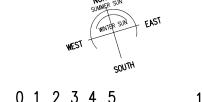



GENERAL NOTES:

- Builder to check and confirm all necessary dimensions on site prior to construction. Do not scale the drawing All dimensions that relate to site boundaries and easments are subjuct to verification by site survey. All work to be in accordance with BUILDING CODE of AUSTRALIA & to the susfactation of local council requirer All timber construction to be in accordance with the "TIMBER FRAMING" code.
- Any detailing in addition to what is supplied shall be resolved between the owner and the builde any structual details or design which is to be supplied by Structual Engineer.
- 5 Roof water & sub-soil drainage to be disposed of in the approved manner or as 7 All electrical power & light outlets to be determined by owner. 3 Make good and repair all existing finishes damaged by new work. Reuse existing

			ıГ
			П
			Н
1	ISSUED FOR DA	11/09/19	
No.	AMENDMENT	DATE	П
COE	COPYRIGHT:		
	TRIGHT:		П


DESIGN BY: MICHAL KORECKY

21 NALYA ROAD, NARRAWEENA NSW 2099 ABN: 79 393 130 294

Email: koreckym@gmail.com Phone: 99813332, Mob: 0438 148 944

PROPOSED ADDITIONS AND ALTERATIONS No 30 NARRABEEN PARK PARADE WARRIEWOOD NSW 2102 CLIENT: BON KAIN LOT 23 DP 15763

DATE: 11/09/19	SCALE: AS NOTED
DRAWN: MK	ISSUE: 1
DRAWING Nr : 1906	SHEET: 15

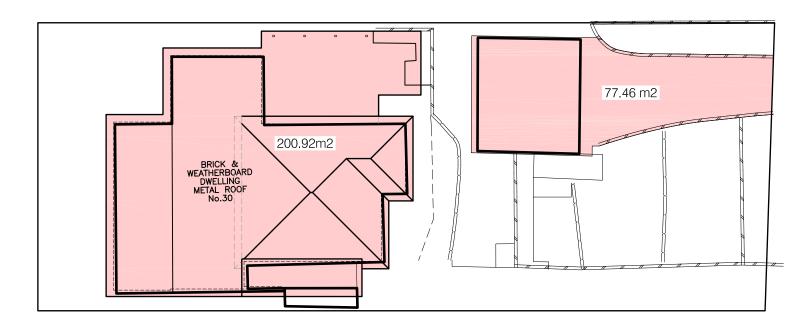

PRE - DEVELOPMENT IMPERVIOUS AREAS - 278.38 m²




POST - DEVELOPMENT IMPERVIOUS AREAS - 322.53 m2

322.53 m2 - 278.38 m2 = 44.15m2

=> OSD NOT REQUIRED



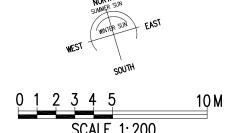

GENERAL NOTES:

ı	OLITEITAL ITO ILO.
	1 Builder to check and confirm all necessary dimensions on site prior to construction. Do not scale the drawing.
ı	2 All dimensions that relate to site boundaries and easments are subjuct to verification by site survey.
ı	3 All work to be in accordance with BUILDING CODE of AUSTRALIA & to the satisfaction of local council requirements & other authorities.
ı	4 All timber construction to be in accordance with the "TIMBER FRAMING" code.
	5 Any detailing in addition to what is supplied shall be resolved between the owner and the builder to the owner's approval, except for any structual details or design which is to be supplied by Structual Engineer.
ı	6 Roof water & sub—soil drainage to be disposed of in the approved manner or as directed by local council inspectors.
ı	7 All electrical power & light outlets to be determined by owner.
	8 Make good and repair all existing finishes damaged by new work. Reuse existing material where possible.

1	ISSUED FOR DA	11/09/19	[
No.	No. AMENDMENT DATE		
COPYRIGHT: All plans and drawings are subject of copyright and any attempt or			


DESIGN BY: MICHAL KORECKY

21 NALYA ROAD, NARRAWEENA NSW 2099 ABN: 79 393 130 294

Email: koreckym@gmail.com Phone: 99813332, Mob: 0438 148 944

PROJECT: PROPOSED ADDITIONS AND ALTERATIONS No 30 NARRABEEN PARK PARADE WARRIEWOOD NSW 2102 CLIENT: BON KAIN LOT 23 DP 15763


JUALL	1.200
DATE: 11/09/19	SCALE: AS NOTED
DRAWN: MK	ISSUE: 1
DRAWING Nr : 1906	SHEET: 16

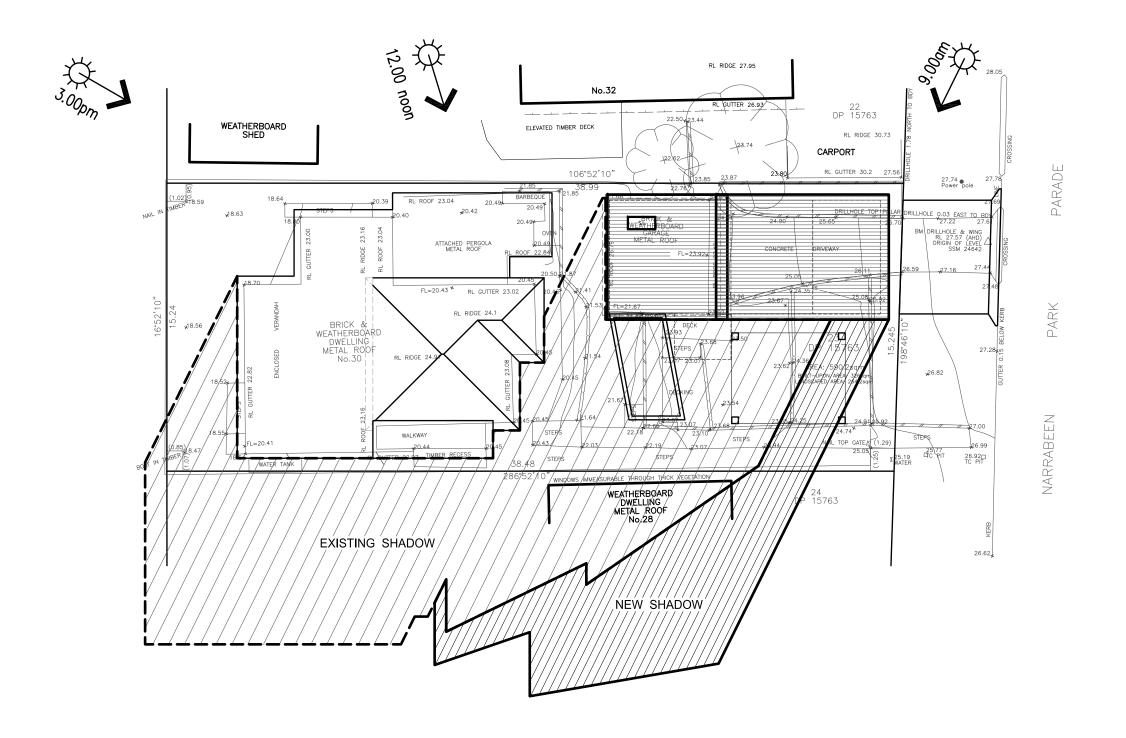



SHADOW DIAGRAM AZIMUTH 43° ALTITUDE 20° 21/6 - 9:00

1:200

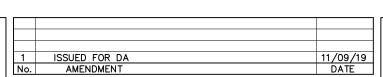

1 Builder to check and confirm all necessary dimensions on site prior to construction. Do not scale the drawing.
2 All dimensions that relate to site boundaries and easments are subjuct to verification by site survey.
3 All work to be in accordance with BUILDING CODE of AUSTRAIA & to the satisfaction of local council requirements & other authoriti
4 All timber construction to be in accordance with the "IMBER FRAMING" code.
5 Any detailing in addition to what is supplied shall be resolved between the owner and the builder to the owner's approval, except for any structual details or design which is to be supplied by Structual Engineer. 6 Roof water & sub-soil drainage to be disposed of in the approved manner or as directed by local council inspectors 7 All electrical power & light outlets to be determined by owner. 8 Make good and repair all existing finishes damaged by new work. Reuse existing material where possible.

GENERAL NOTES:

COPYRIGHT:

DESIGN BY: MICHAL KORECKY

21 NALYA ROAD, NARRAWEENA NSW 2099 ABN: 79 393 130 294

Email: koreckym@gmail.com Phone: 99813332, Mob: 0438 148 944


PROJECT: PROPOSED ADDITIONS AND ALTERATIONS No 30 NARRABEEN PARK PARADE WARRIEWOOD NSW 2102 CLIENT: BON KAIN


LOT 23 DP 15763

NORTH SUMMER SUM VINITER SUM EAST SOUTH

0 1 2 3 4 5 10 M SCALE 1: 200

DATE: 11/09/19	SCALE: AS NOTED			
DRAWN: MK	ISSUE: 1			
DRAWING Nr : 1906	SHEET: 17			

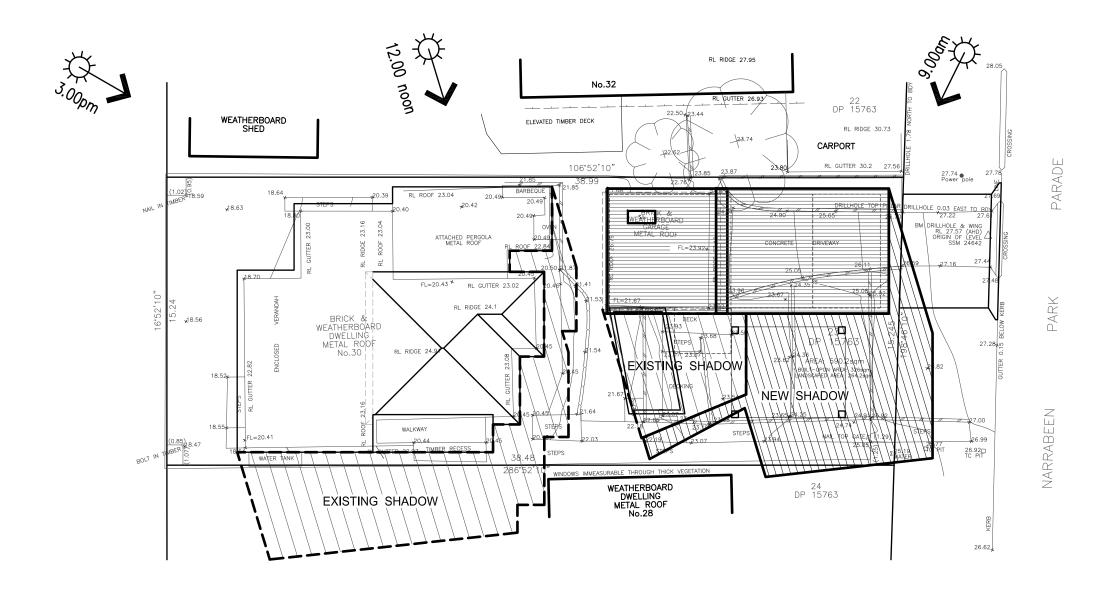

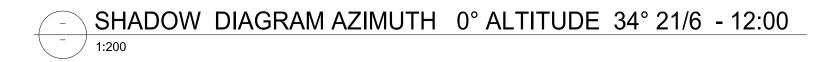



0 1 2 3 4 5 10 M SCALE 1: 200

GENERAL NOTES:

Builder to check and confirm all necessary dimensions on site prior to construction. Do not scale the drawing. 2 All dimensions that relate to site boundaries and easments are subjuct to verification by site survey. 3 All work to be in accordance with BUILDING CODE of AUSTRALIA & to the satisfaction of local council requirements 4 All timber construction to be in accordance with the "TIMBER FRAMING" code. 5 Any detailing in addition to what is supplied shall be resolved between the owner and the builder to the owner's appropriate and statement of the source of the source of the supplied by Structual Engineer.

6 Roof water & sub-soil drainage to be disposed of in the approved manner or as directed by local council inspectors 7 All electrical power & light outlets to be determined by owner. 8 Make good and repair all existing finishes damaged by new work. Reuse existing material where possible.

s & other authorities.	1
pproval, except for	No.
pproval, except for	00

ISSUED FOR DA AMENDMENT

DESIGN BY: MICHAL KORECKY

21 NALYA ROAD, NARRAWEENA NSW 2099 ABN: 79 393 130 294


11/09/19 DATE

Email: koreckym@gmail.com Phone: 99813332, Mob: 0438 148 944

PROJECT: PROPOSED ADDITIONS AND ALTERATIONS No 30 NARRABEEN PARK PARADE WARRIEWOOD NSW 2102 CLIENT: BON KAIN

LOT 23 DP 15763

DATE:	11/09/19	SCALE:	AS NOTED
DRAWN:	MK	ISSUE:	1
DRAWING Nr : 1906		SHEET:	18

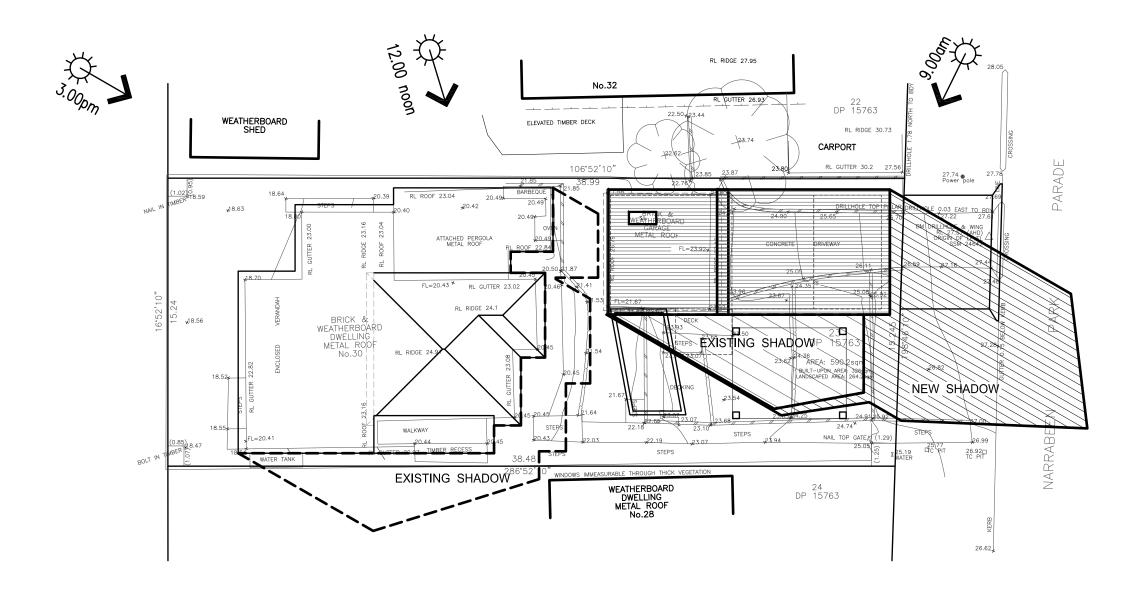



SHADOW DIAGRAM AZIMUTH -43° ALTITUDE 20° 21/6 - 3:00

ISSUED FOR DA AMENDMENT 11/09/19 DATE No.

DESIGN BY: MICHAL KORECKY

21 NALYA ROAD, NARRAWEENA NSW 2099 ABN: 79 393 130 294

Email: koreckym@gmail.com Phone: 99813332, Mob: 0438 148 944

PROJECT: PROPOSED ADDITIONS AND ALTERATIONS No 30 NARRABEEN PARK PARADE WARRIEWOOD NSW 2102 CLIENT: BON KAIN

0 1 2 3 4 5 10 M SCALE 1:200


SCALE: AS NOTED DATE: 11/09/19 DRAWN: MK ISSUE: DRAWING Nr SHEET: 19 19006 LOT 23 DP 15763

GENERAL NOTES:

Builder to check and confirm all necessary dimensions on site prior to construction. Do not scale the drawing. 2. All dimensions that relate to site boundaries and easments are subjuct to verification by site survey. 3. All work to be in accordance with BUILDING CODE of AUSTRALIA & to the satisfaction of local council requirem 4. All timber construction to be in accordance with the "IMBER FRAMING" code.

Any detailing in addition to what is supplied shall be resolved between the owner and the builder to the owner's appr any structual details or design which is to be supplied by Structual Engineer.

6 Roof water & sub-soil drainage to be disposed of in the approved manner or as directed by local council inspectors 7 All electrical power & light outlets to be determined by owner. 8 Make good and repair all existing finishes damaged by new work. Reuse existing material where possible.

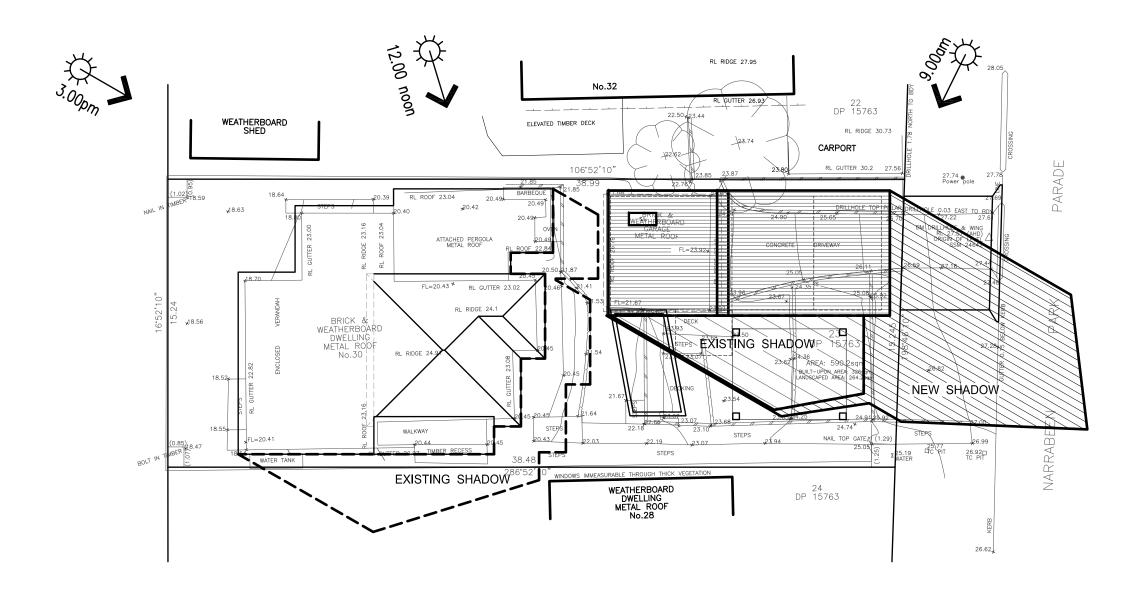



SHADOW DIAGRAM AZIMUTH -43° ALTITUDE 20° 21/6 - 3:00

11/09/19 DATE ISSUED FOR DA AMENDMENT No.

DESIGN BY: MICHAL KORECKY

21 NALYA ROAD, NARRAWEENA NSW 2099 ABN: 79 393 130 294

Email: koreckym@gmail.com Phone: 99813332, Mob: 0438 148 944

PROJECT: PROPOSED ADDITIONS AND ALTERATIONS
No 30 NARRABEEN PARK PARADE
WARRIEWOOD NSW 2102 CLIENT: BON KAIN LOT 23 DP 15763

0 1 2 3 4 5 10 M

SCALE 1: 200				
DATE:	11/09/19	SCALE:	AS NOTE	
DRAWN:	MK	ISSUE:	1	
DD V WIN	^ Nr .	CHEET.	• •	

19006

GENERAL NOTES:

Builder to check and confirm all necessary dimensions on site prior to construction. Do not scale the drawing.


2 All dimensions that relate to site boundaries and easments are subjuct to verification by site survey.

3 All work to be in accordance with BULDING CODE of AUSTRAIA & to the satisfaction of local council requirements &

4 All timber construction to be in accordance with the "IMBEER FRAMING" code.

5 Any detailing in addition to what is supplied shall be resolved between the owner and the builder to the owner's approary structual details or design which is to be supplied by Structual Engineer.

6 Roof water & sub-soil drainage to be disposed of in the approved manner or as directed by local council inspectors 7 All electrical power & light outlets to be determined by owner. 8 Make good and repair all existing finishes damaged by new work. Reuse existing material where possible.

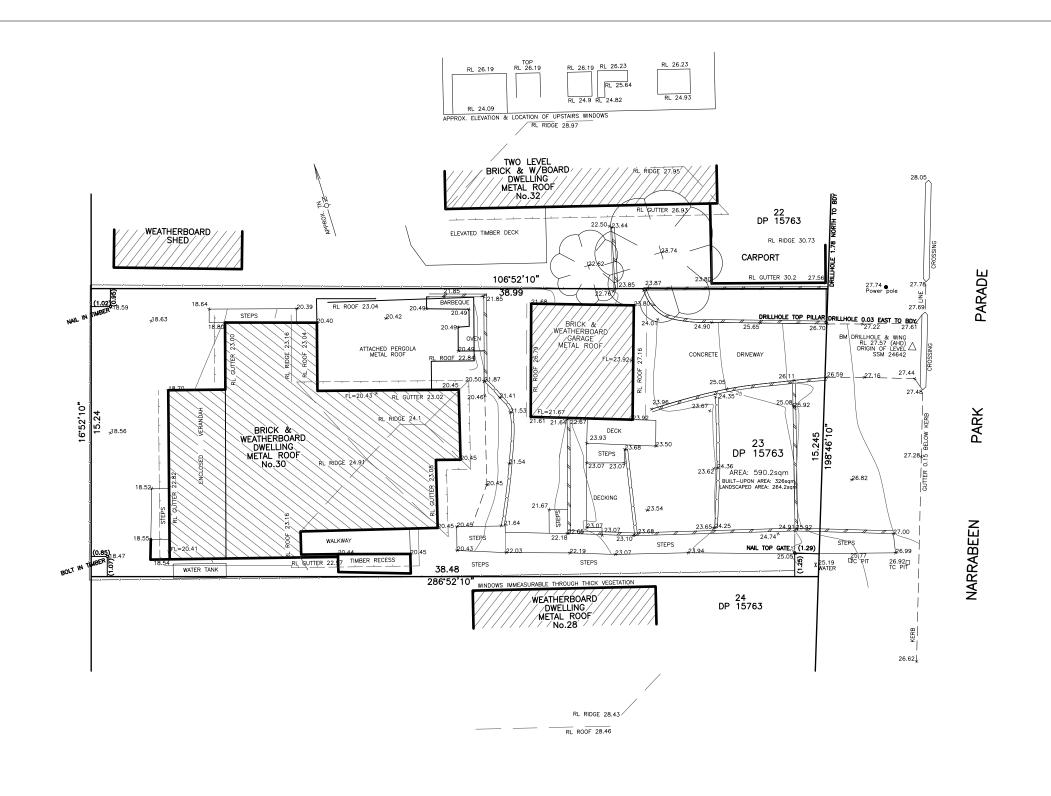

NOTES 1, ONLY VISIBLE UTILITY SERVICES HAVE BEEN LOCATED.

RELEVANT AUTHORITIES SHOULD BE NOTHED PRIOR TO EXCAVATION ON OR NEAR THE SITE.

2. LIMITED BOUNDARY DEBEN CREATED. IF ANY CONSTRUCTION
IS PROPOSED IN PROXIMITY OF BOUNDARIES, IT IS RECOMMENDED.

THAT A FURTHER SURVEY BE REQUESTED FOR MARKING OF RELEVANT BOUNDARIES.

3. COVENANTS, RESTRICTIONS ON LAND USE (IF ANY) NOT INVESTIGATED.

4. ROOF LINES SHOWN ARE APPROXIMATE. SIGNIFICANT TREES (WHERE ACCESSIBLE) GREATER THAN 0.4 DIAM. SHOWN

5. APPROX. SEWER LINE (IF SHOWN) MUST BE VERIFIED BY SYDNEY WATER.

NOTE: CONTOURS ARE FOR INDICATIVE PURPOSES ONLY. FOR MORE CONCLUSIVE EVIDENCE OF LEVELS USE THE SPOT HEIGHTS GIVEN.

B. KAIN

DETAILED SURVEYS (A.B.N. 36 233 529 164) CONSULTING SURVEYORS

LOT 23 DP 15763 LEVELS TO AHD

A1 REDUCTION RATIO: 1:100 DRAWING No. SURVEY J.McC DRAWN A1 J.McC REFERENCE 095/18