

ACTION PLANS

m: 0426 957 518

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DEVELOPMENT APPLICATION

These plans are for Development Approval only.

SHEET NUMBER	s for Development Approval only.	HEET NAME	DATE PUBLISHED
DA00	COVER		16-Aug-19
DA01	SITE ANALYSIS		16-Aug-19
DA02	SITE / ROOF / SEDIMENT EROSION / WASTE MANAGEMENT / STORMWATER CON	CEPT PLAN	16-Aug-19
DA03	EXISTING GROUND FLOOR PLAN		16-Aug-19
DA04	PROPOSED GROUND FLOOR PLAN		16-Aug-19
DA05	NORTH / EAST ELEVATION		16-Aug-19
DA06	SOUTH / WEST ELEVATION		16-Aug-19
DA07	LONG / CROSS SECTION		16-Aug-19
DA08	AREA CALCULATIONS / SAMPLE BOARD		16-Aug-19
DA09	WINTER SOLSTICE 9 AM		16-Aug-19
DA10	WINTER SOLSTICE 12 PM		16-Aug-19
DA11	WINTER SOLSTICE 3 PM		16-Aug-19
DA12	BASIX COMMITMENTS		16-Aug-19

-				
ITEM DETAILS	DEVELOPMENT APPLICATION			
ADDRESS	4 PUSAN PLACE, BELROSE, NSW 2085			
LOT & DP/SP	LOT 39 DP 223046			
COUNCIL	NORTHERN BEACHES COUNCIL (WARRINGA	H)		
SITE AREA	726m²			
FRONTAGE	12.98m			
CONTROLS	PERMISSIBLE / REQUIRED	EXISTING	PROPOSED	COMPLIANCE
	m / m² / %	m / m² / %	m / m² / %	
<u>LEP</u>				
LAND ZONING	R2 – LOW DENSITY RESIDENTIAL	R2	R2	YES
MINIMUM LOT SIZE	600m²	726m²	UNCHANGED	YES
MAXIMUM BUILDING HEIGHT	8.5m	5.486m	UNCHANGED	YES
<u>HAZARDS</u>				
DEVELOPMENT ON SLOPING LAND	AREA B - FLANKING SLOPES 5° TO 25°	YES	UNCHANGED	YES
COASTAL HAZARDS	NOT IDENTIFIED	N/A	N/A	N/A
HIGH/MED/LOW FLOOD RISK	NOT IDENTIFIED	N/A	N/A	N/A
PRECINCT	NOT IDENTIFIED	IN/A	IN/A	IWA
NATIVE VEGETATION	NOT IDENTIFIED	N/A	N/A	N/A
WILDLIFE CORRIDORS	NOT IDENTIFIED	N/A	N/A	N/A
WATERWAYS AND RIPARIAN LAND	NOT IDENTIFIED	N/A	N/A	N/A
THREATEND HIGH CONSERVATION HABITAT	NOT IDENTIFIED	N/A	N/A	N/A
LAND ADJOINING PUBLIC OPEN SPACE	IDENTIFIED	YES	UNCHANGED	YES
DCP				
WALL HEIGHT	7.2m	3.54m	UNCHANGED	YES
NUMBER OF STOREYS	2	1	UNCHANGED	YES
SIDE BOUNDARY ENVELOPE	4m		UNCHANGED	YES
SIDE BOUNDARY SETBACKS	0.9m	N: 0.96m S: 0.425m	UNCHANGED UNCHANGED	YES YES
FRONT BOUNDARY SETBACK	6.5m	11.45m	UNCHANGED	YES
REAR BOUNDARY SETBACK	6.0m	6.625m	UNCHANGED	YES
LANDSCAPE OPEN SPACE	40% (290.4m²)	27.9% (203.25m)	27.1% (197.27m)	NO
PRIVATE OPEN SPACE	60m²	78.95m²	72.45m	YES

4 PUSAN PLACE BELROSE, NSW, 2085



NCC & AS COMPLIANCES SPECIFICATIONS

- EARTHWORKS: METHOD OF EXCAVATION AND FILL - PART 3.1.1 OF NCC - SURFACE SUBSOIL-STORMWATER DRAINAGE - PART 3.1.2 OF NCC - TERMITE-RISK MANAGEMENT - PART 3.1.3 OF NCC - FOOTINGS & SLAB - PART 3.2 OF NCC INCLUDING AS2870 - MASONRY CONSTRUCTION - PART 3.3 OF NCC INCLUDING AS3700 - SUB FLOOR VENTILATION - PART 3.4.1 OF NCC - FRAMING - PART 3.4 OF NCC - ROOF, WALL-CLADDING, GUTTERS & DOWNPIPES - PART 3.5 OF NCC - GLAZING - PART 3.6 OF NCC INCLUDING AS1288 - FIRE SEPARATION - PART 3.7.1 OF NCC - SMOKE ALARMS - PART 3.7.2 OF NCC

> - HEATING APPLIANCES - PART 3.7.3 OF NCC - WET AREAS-PROTECTION OF WALLS & FLOORS - PART 3.8.1 OF NCC

- MINIMUM ROOF HEIGHTS - PART 3.8.3 OF NCC - FACILITIES REQUIRRED & SANITARY DOOR CONSTRUCTION - PART 3.8.3 OF NCC

- LIGHT: NATURAL AND ARTIFICIAL - PART 3.8.4 OF NCC

- VENTILATION & LOCATION OF TOILETS - PART 3.8.5 OF NCC

- SOUND INSULATION - PART 3.8.6 OF NCC

- STAIR CONSTRUCTION INCLUDING DIMENSIONS - PART 3.9.1 OF NCC - BALUSTRADES & OTHER BARRIERS - PART 3.9.2 OF NCC

- FENCING & OTHER PROVISIONS - REGS & AS1926 - DEMOLITION WORKS - AS2601-1991 THE DEMOLITION OF STRUCTURES.

- ALL WATERPROOF MEMBRANES TO COMPLY WITH WITH AS 3740-2004 - ALL PLUMBING & DRAINAGE WORK TO COMPLY WITH AS 3500

- SITE CLASSIFICATION AS TO AS 2870

- ALL PLASTERBOARD WORK TO COMPLY WITH AS 2588-1998

- ALL STRUCTURAL STEEL WORK TO COMPLY WITH AS 4100 & AS 1554 - ALL CONCRETE WORK TO COMPLY WITH AS 3600

- ALL ROOF SHEETING WORK TO COMPLY WITH AS 1562-1992


- ALL SKYLIGHTS TO COMPLY WITH WITH AS 4285-2007

- ALL CERAMIC TILING TO COMPLY WITH AS 3958.1-2007 & 3958.2-1992

- ALL GLAZING ASSEMBLIES TO COMPLY WITH AS2047 & 1288 - ALL TIMBER RETAINING WALLS ARE TO COMPLY WITH AS 1720.1-2010,

AS 1720.2-2006, AS 1720.4-2006, AS 1170.1-1989 & AS 1170.4-1993 - ALL RETAINING WALLS ARE TO COMPLY WITH 3700 - 2011 & AS 3600 -2001

- ALL CONSTRUCTION TO COMPLY TO AS3959- 1991

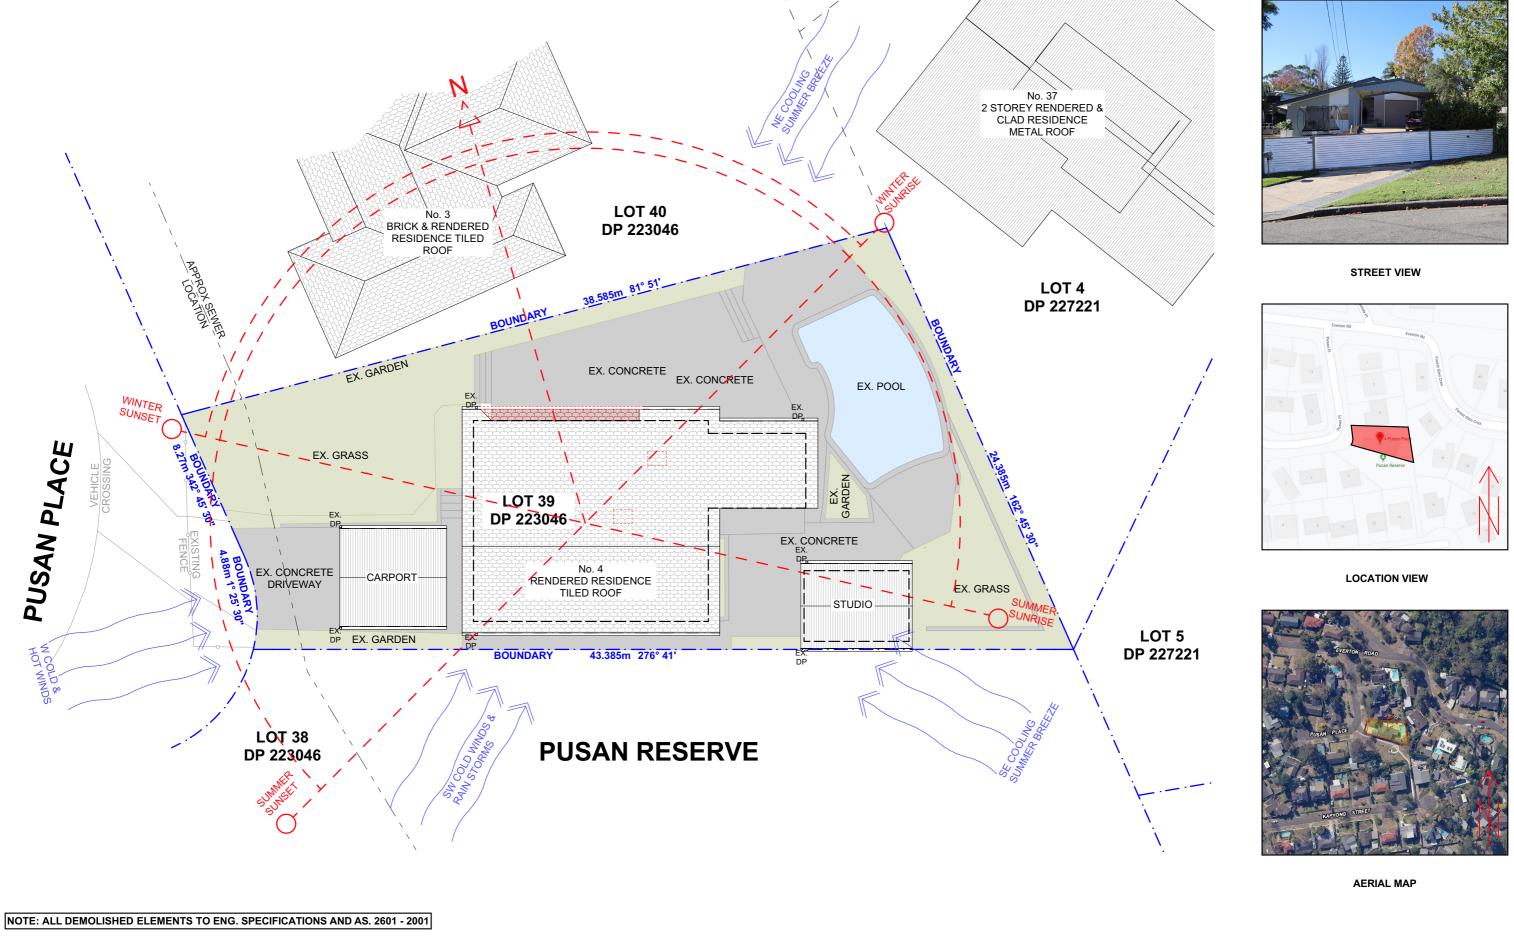



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	С	18/06/2019	SECOND DESIGN AMENDMENT	AJF	are to be used only. The Builder/Contractor shall check and verify all levels and	
u	D	16/08/19	DOCUMENTED SET	AP	dimensions on site prior to commencement of any work, creation of shop drawings, or fabrication of components.	Z
					All errors and omissions are to be verified by the Builder/Contractor and referred to the designer prior to the	
					commencement of works.	




CLIENT TONY & LEE-ANNE NEVILLE


PROJECT ADDRESS 4 PUSAN PLACE BELROSE, NSW, 2085 DRAWING NO. **DA01** DATE

Friday, August 16, 2019

DRAWING NAME SITE ANALYSIS **SCALE**

1:200, 1:18.20

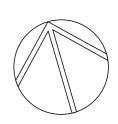

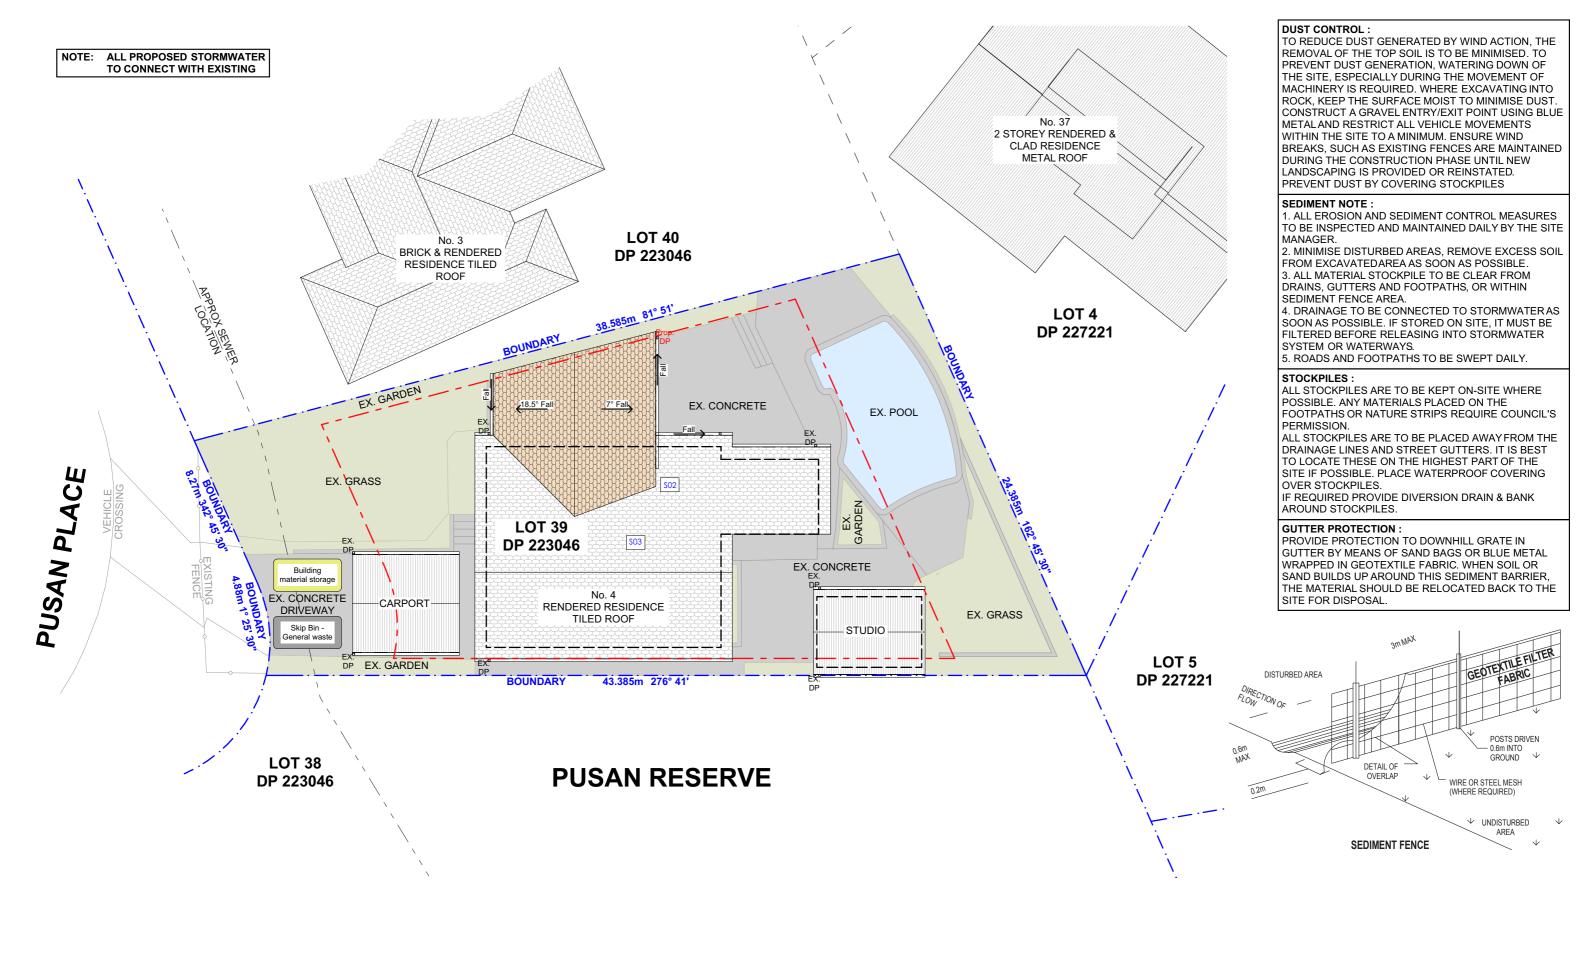



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					commencement of works.

DRWN NOTES



TONY & LEE-ANNE NEVILLE

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PROJECT ADDRESS

PROJECT ADDRESS	
4 PUSAN PLACE	
BELROSE, NSW, 2085	

DA02

DATE	
Friday, August 2019	16,


DRAWING NAME

SITE / ROOF / SEDIMENT EROSION / WASTE MANAGEMENT / STORMWATER CONCEPT PLAN




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EAST ELEVATION 1:100

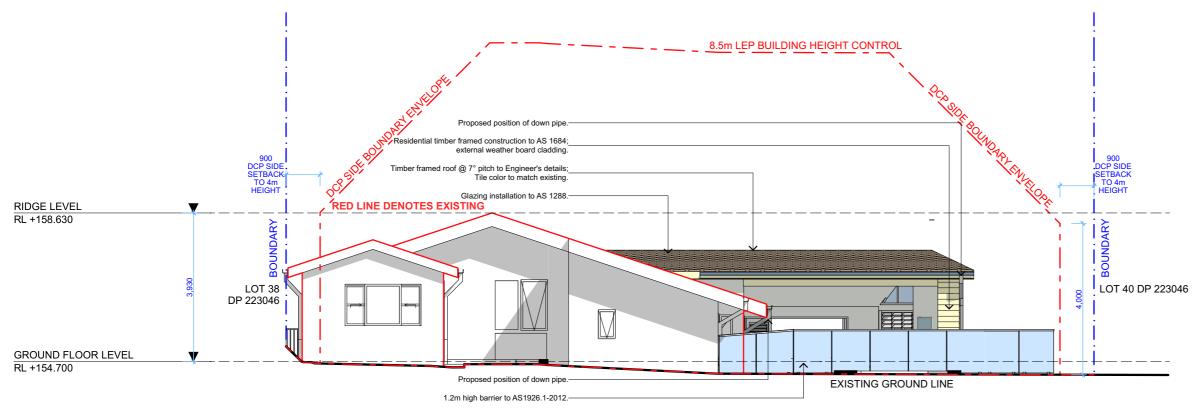

1:100 **NORTH ELEVATION**

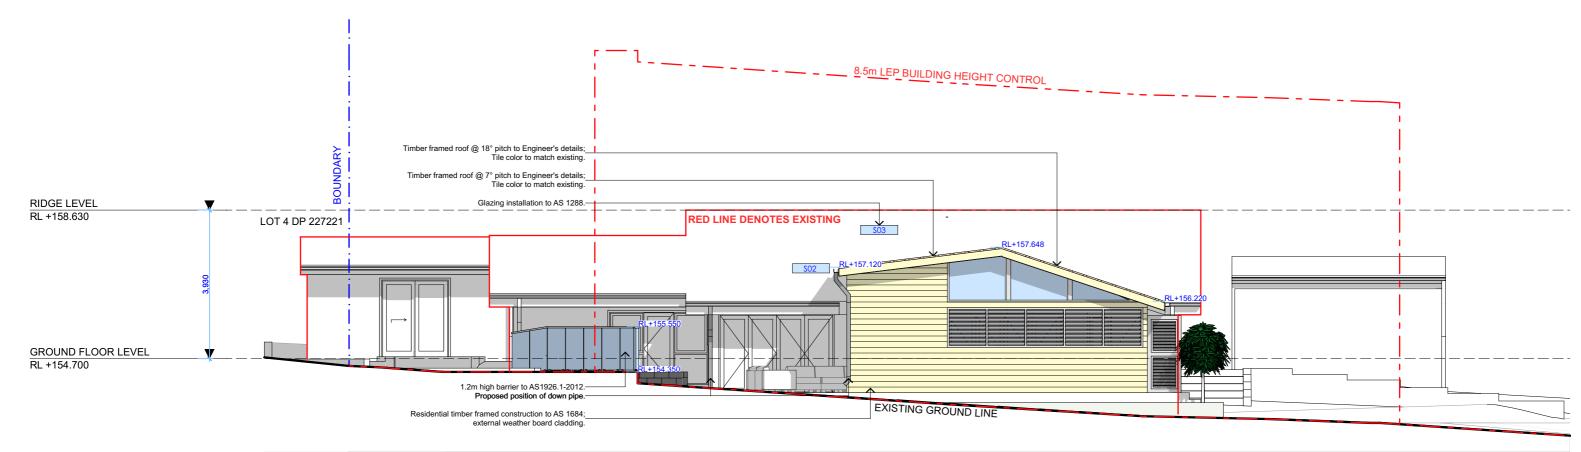

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D	16/08/19	DOCUMENTED SET	AP	dimensions on site prior to commencement of any work, creation of shop drawings, or fabrication of components.
				All errors and omissions are to be verified by the Builder/Contractor and referred to the designer prior to the




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ING	PROJECT ADDRESS
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DA05 DATE SAN PLACE

DRAWING NO.

NORTH / EAST ELEVATION Friday, August 16, SCALE 2019 1:100 @A3


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AREA CALCULATIONS 1:200



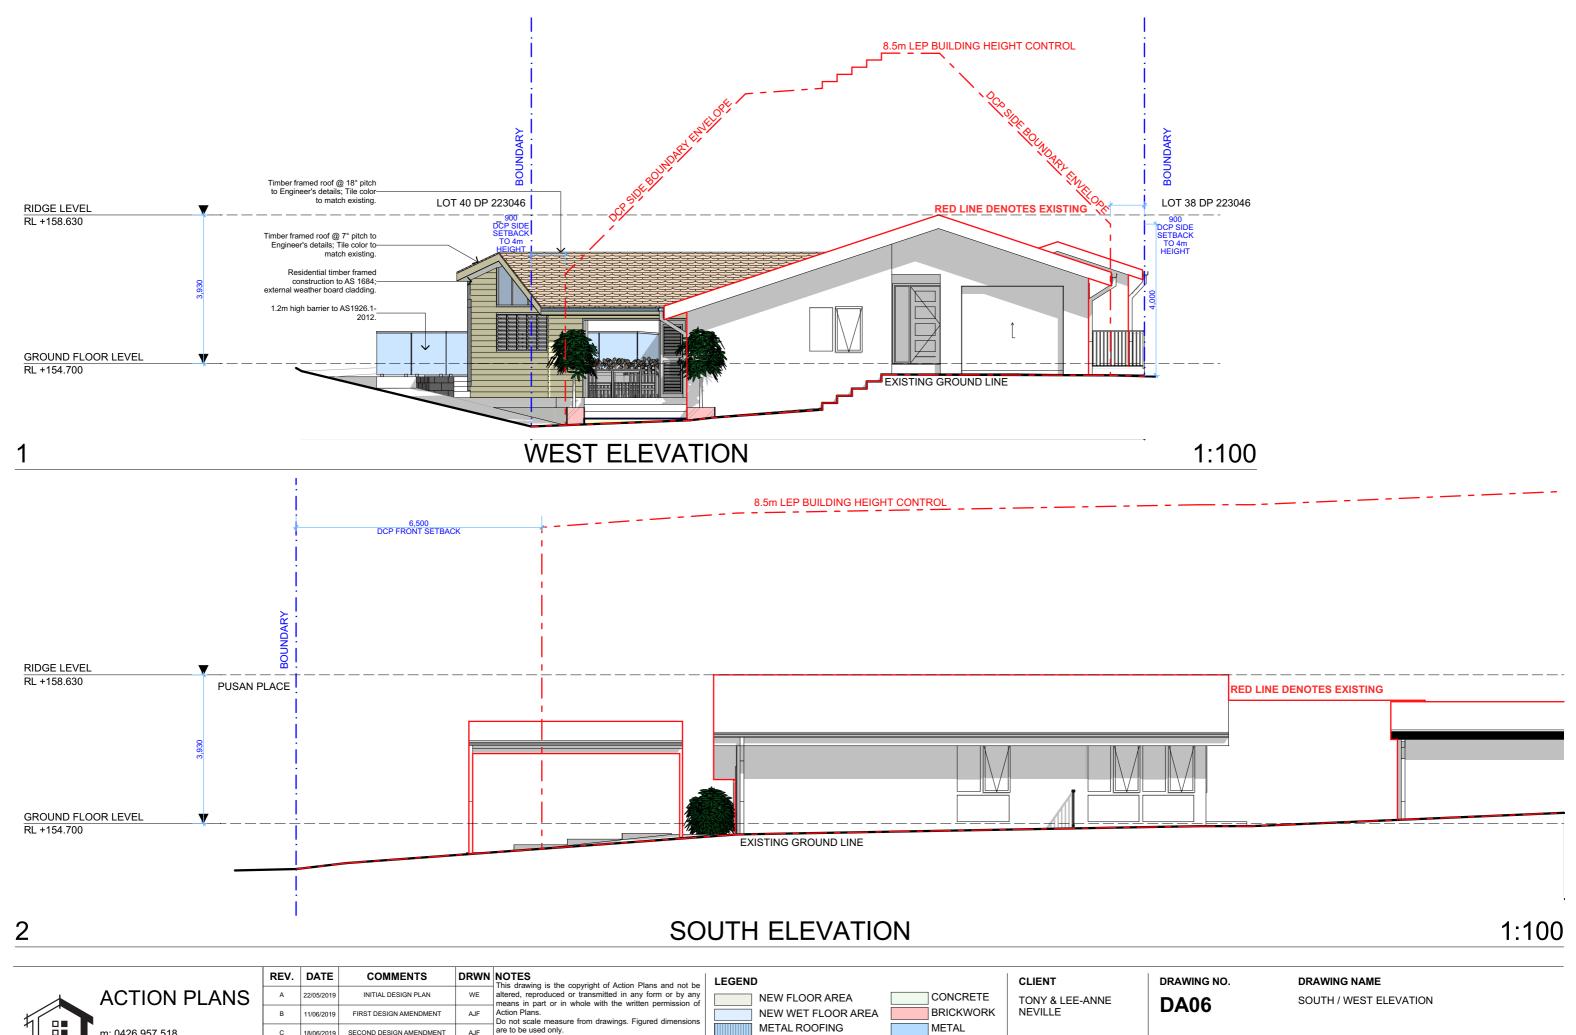

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LEGEND

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4 PUSAN PLACE BELROSE, NSW, 2085

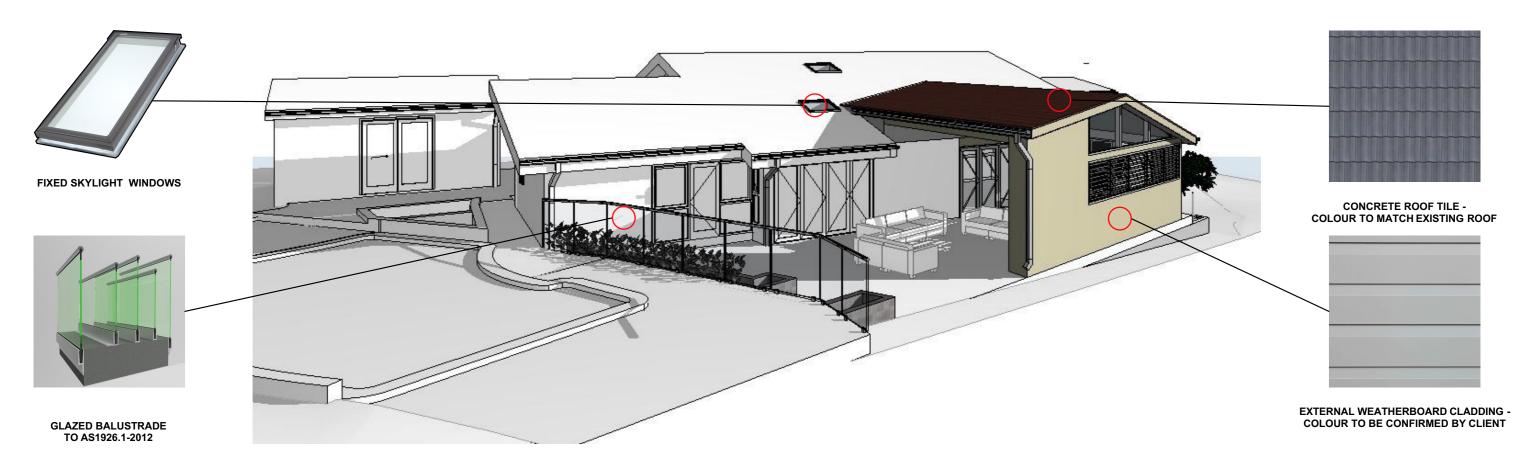DRAWING NO.


DA08


Friday, August 16, 2019

DATE

AREA CALCULATIONS / SAMPLE BOARD

DRAWING NAME

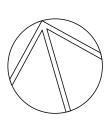


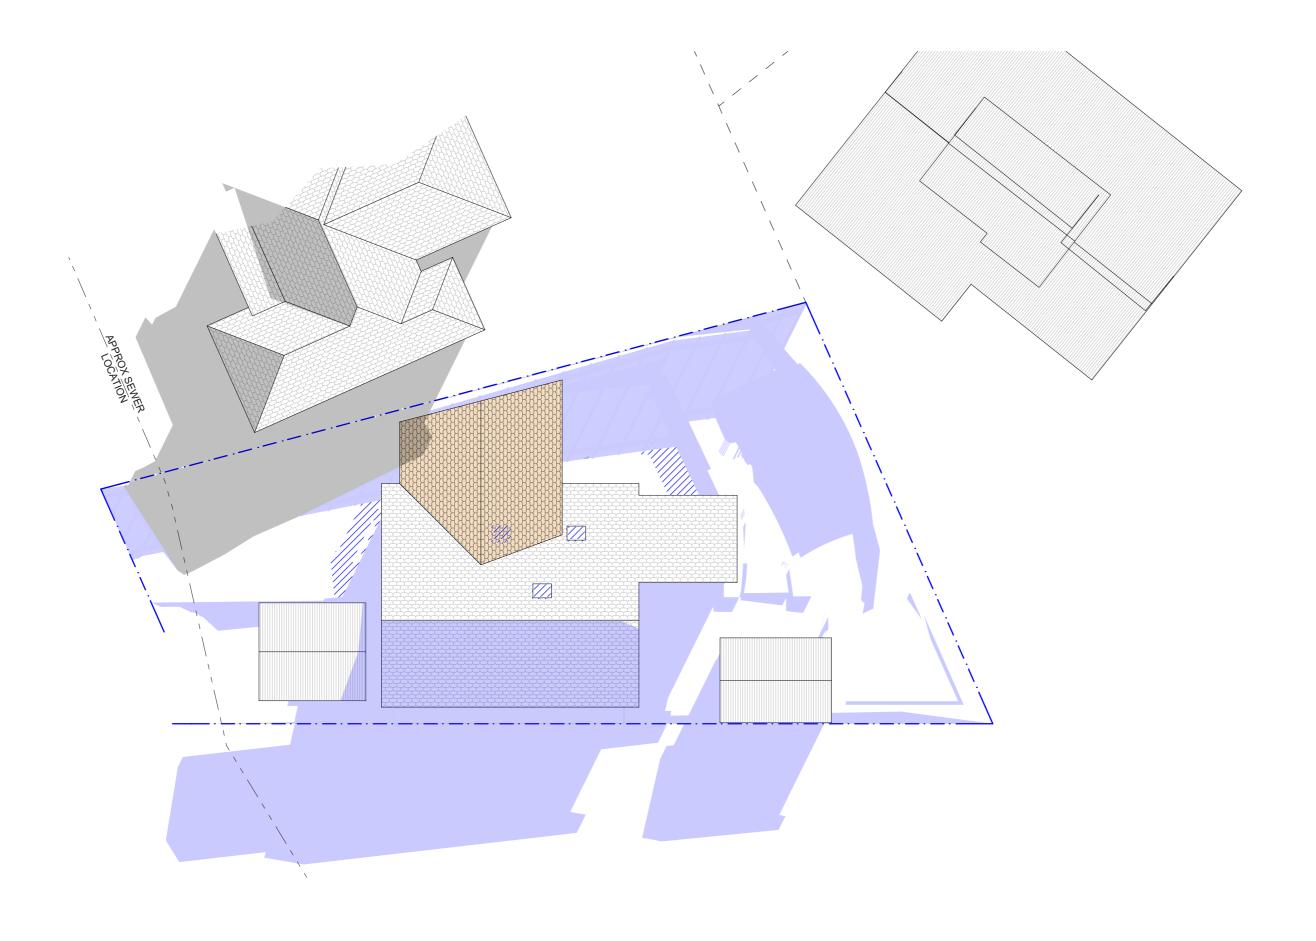



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LEGEND EXISTING SHADOWS PROPOSED SHADOWS

NEIGHBOURING SHADOWS

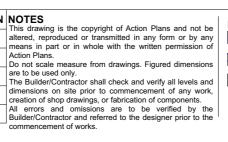
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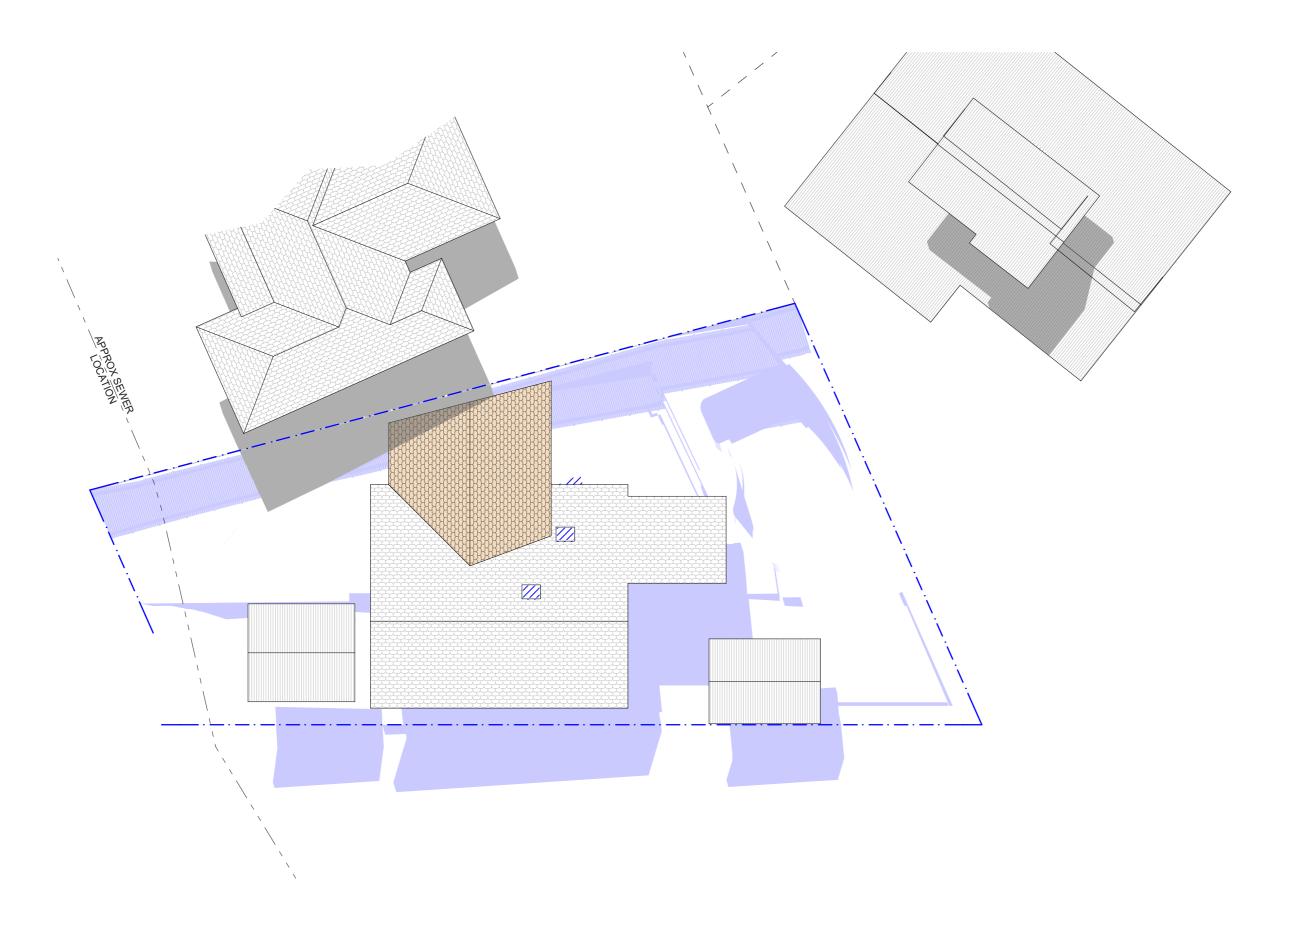
PROJECT ADDRESS 4 PUSAN PLACE BELROSE, NSW, 2085 DRAWING NO.

DA09

DATE Friday, August 16, 2019 DRAWING NAME WINTER SOLSTICE 9 AM

SCALE 1:200 @A3




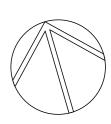



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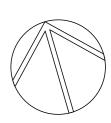
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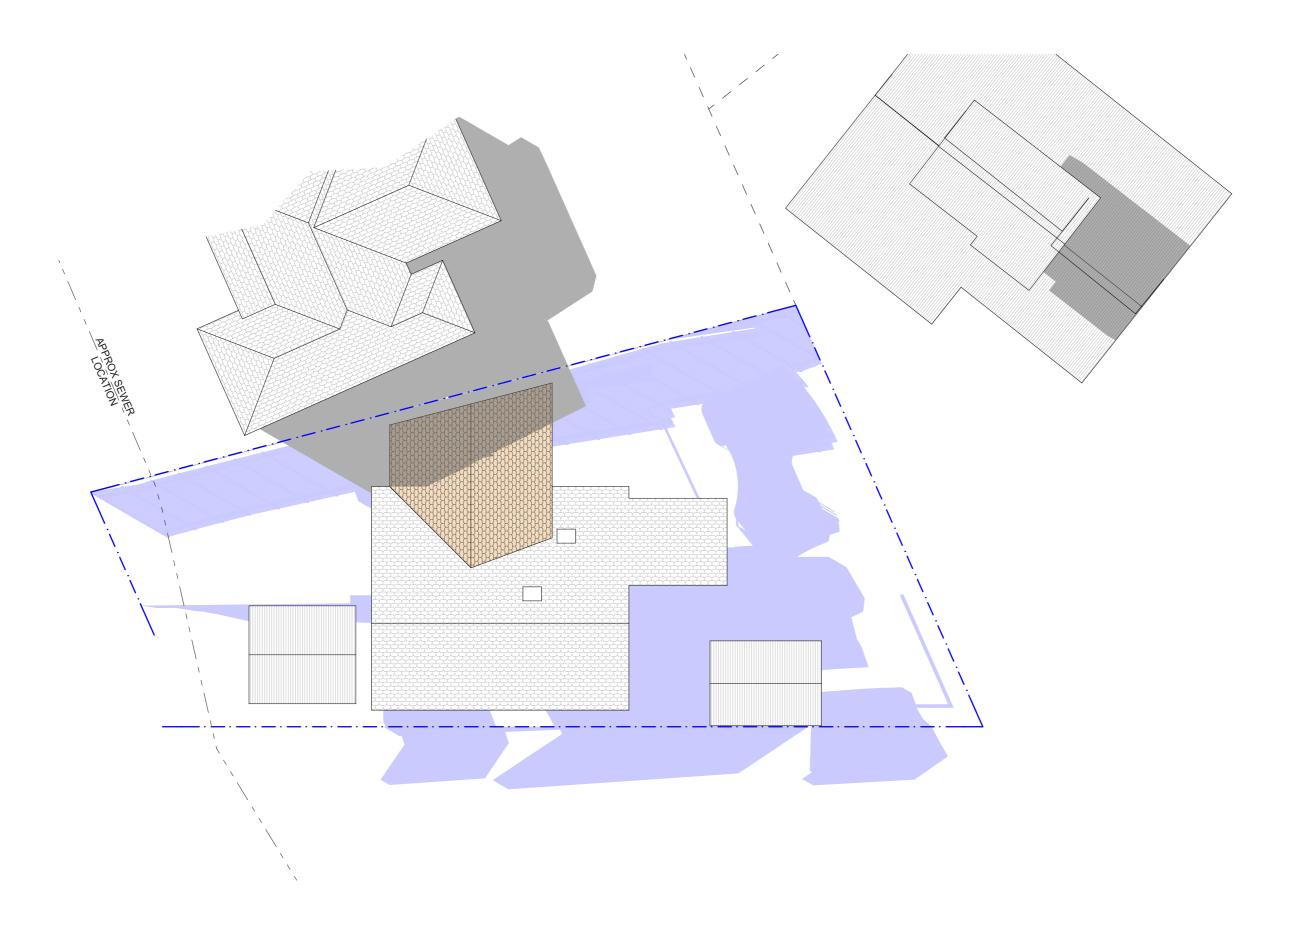
DA10

DATE Friday, August 16, 2019 DRAWING NAME

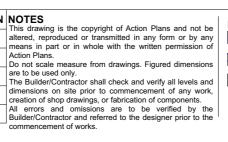WINTER SOLSTICE 12 PM

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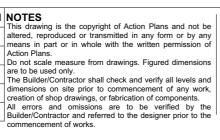








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NEIGHBOURING SHADOWS

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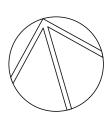
PROJECT ADDRESS 4 PUSAN PLACE BELROSE, NSW, 2085 DRAWING NO.

DA11

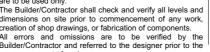DATE Friday, August 16, 2019 DRAWING NAME WINTER SOLSTICE 3 PM

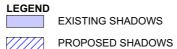SCALE

1:200 @A3



Insulation requirements

external wall: brick veneer

page 5 / 6

page 6 / 6

DATE

DRAWING NO.

DA12

BASIX Certificate Building Sustainability Index www.basix.nsw.gov.au

Alterations and Additions

Certificate number: A355438

This certificate confirms that the proposed development will meet the NSW government's requirements for sustainability, if it is built in accordance with the commitments set out below. Terms used in this certificate, or in the commitments, have the meaning given by the document entitled "BASIX Alterations and Additions Definitions" dated 06/10/2017 published by the Department. This document is available at www.basix.nsw.gov.au

Secretary
Date of issue: Tuesday, 13, August 2019
To be valid, this certificate must be lodged within 3 months of the date of issue.



Project address	
Project name	4 PUSAN PLACE
Street address	4 PUSAN Place BELROSE 2085
Local Government Area	Northern Beaches Council
Plan type and number	Deposited Plan 223046
Lot number	39
Section number	
Project type	
Dwelling type	Separate dwelling house
Type of alteration and addition	My renovation work is valued at \$50,000 or mor and does not include a pool (and/or spa).

Certificate Prepared by (please complete before submitting to Council or PCA)
Name / Company Name: Action Plans
ABN (if applicable): 17118297587

	DA Plans	Show on CC/CDC Plans & specs	Certifier Check
Lighting			
The applicant must ensure a minimum of 40% of new or altered light fixtures are fitted with fluorescent, compact fluorescent, or light-emitting-diode (LED) lamps.		✓	✓

Certificate Prepared by (please complete before submitting to Council or PCA)					
Name / Company Name: Action Plans					
ABN (if applicable): 17118297587					

Commitments identified with a "\square" in the "Show on DA plans" column must be shown on the plans accompanying the development application for the proposed development (if a development application is to be lodged for the proposed development).

Commitments identified with a "\sqrt in the "Show on CC/CDC plans & specs" column must be shown in the plans and specifications accompanying the application for a construction certificate / complying development certificate for the proposed development.

Commitments identified with a */v" in the *Certifier check* column must be certified by a certifying authority as having been fulfilled, before a final occupation certificate for the development may be issued.

In these commitments, "applicant" means the person carrying out the development.

The applicant must construct the new or altered construction (floor(s), walls, and ceilings/roofs) in accordance with the specifications listed in the table below, except that a) additional insulation is not required where the area of new construction is less than 2m2, b) insulation specified is not required for parts of altered construction where insulation alteredy exists.

R1.16 (or R1.70 including construction)

Glazing re	quirement	ts					Show on DA Plans	Show on CC/CDC Plans & specs	Certifier Check
Windows a	nd glazed	doors							
					hading devices, in accordance with r each window and glazed door.	the specifications listed in the table below.	✓	✓	✓
The following requirements must also be satisfied in relation to each window and glazed door:						✓	~		
have a U-val	ue and a So	olar Heat Gair	n Coefficie	ent (SHGC)		ed glass may either match the description, or, le below. Total system U-values and SHGCs s.		✓	~
					f each eave, pergola, verandah, bal than 2400 mm above the sill.	lcony or awning must be no more than 500 mm	✓	✓	✓
Pergolas with polycarbonate roof or similar translucent material must have a shading coefficient of less than 0.35.					✓	V			
					e window or glazed door above whi ens must not be more than 50 mm.	ich they are situated, unless the pergola also		✓	~
Windows	and glaze	ed doors g	lazing r	equireme	nts				
Window / do no.	or Orienta	tion Area of glass inc. frame (m2)	Oversha Height (m)	Distance (m)	Shading device	Frame and glass type			
D01	N	6.31	0	0	eave/verandah/pergola/balcony >=900 mm	standard aluminium, single clear, (or U-value: 7.63, SHGC: 0.75)			
Skylights							1		-
The applican	t must insta	all the skylight	s in accor	dance with t	the specifications listed in the table	below.	V	V	V
The following	g requireme	nts must also	be satisfi	ed in relation	n to each skylight:			V	V
Each skylight may either match the description, or, have a U-value and a Solar Heat Gain Coefficient (SHGC) no greater than that listed in						1	1		

Skylights glazing requirements timber, low-E internal/argon fill/clear external, (or U-value: 2.5, SHGC: 0.456) timber, low-E internal/argon U-value: 2.5, SHGC: 0.456)

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16/08/19	DOCUMENTED SET	AP
	22/05/2019 11/06/2019 18/06/2019	22/05/2019 INITIAL DESIGN PLAN 11/06/2019 FIRST DESIGN AMENDMENT 18/06/2019 SECOND DESIGN AMENDMENT

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drawings, or fabrication of components.

All errors and omissions are to be verified by the Builder/Contractor and referred to the designer prior to the commencement of works. All window & door dimensions, orientation, glazing materials, opening types, frame types are to be confirmed by a suitably qualified person prior to the ordering of any such materials are to take place.

U value takes precedence over glazing type/colour in all cases.

all new glazing must meet the BASIX specified frame and glass type, *QR* meet the ecified U value and SHGC value.

4 PUSAN PLACE BELROSE, NSW, 2085

PROJECT ADDRESS

TONY & LEE-ANNE

CLIENT

NEVILLE

Friday, August 16, 2019