## BASIX COMMITMENTS

SYSTEM FOR THE SWIMMING POOL TO BE SOLAR ONLY.

READ DRAWINGS IN CONJUNCTION WITH THE ATTACHED BASIX CERTIFICATE #A329994 SUBMITTED WITH THE DEVELOPMENT APPLICATION:

- THE OUTDOOR SWIMMING POOL MUST NOT HAVE A CAPACITY GREATER THAN 36 KILOLITRES. INSTALL A POOL PUMP & HEATING

- THE APPLICANT MUST INSTALL A RAINWATER TANK OF AT LEAST 1575 LITRES ON THE SITE. THE RAINWATER TANK TO COLLECT RAINWATER RUNOFF FROM AT LEAST 90 SQUARE METRES OF ROOF AREA. CONNECT THE RAINWATER TANK TO A TAP LOCATED WITHIN 10 METRES OF THE EDGE OF THE POOL.

- PROVIDE A HEATING/COOLING SYSTEM TO ACHIEVE THE REQUIRED STAR ENERGY RATING.

- A NEW 'GAS INSTANTANEOUS 'HOT WATER SYSTEM TO BE INSTALLED [POSITION T.B.C]

- A MINIMUM OF 40% OF NEW OR ALTERED LIGHT FIXTURES ARE TO BE FITTED WITH FLUORESCENT, COMPACT FLUORESCENT, OR LIGHT-EMITTING-DIODE (LED) LAMPS.

- ALL NEW or ALTERED SHOWERHEAD, TOILET & TAP FIXTURES TO ACHIEVE THE REQUIRED STAR WATER RATING.

- ADDITIONAL NEW FLOOR, WALL & ROOF CEILING INSULATION TO HAVE THE MINIMUM R-VALUES AS SPECIFIED IN THE CERTIFICATE

- ALL NEW WINDOWS & SKYLIGHTS TO HAVE U-VALUE AND A SOLAR HEAT GAIN COEFFICIENT NO GREATER THAN THAT LISTED IN THE BASIX TABLE REQUIREMENTS.

- THE NEW ROOF COLOUR TO BE OF MEDIUM SOLAR ABSORPTANCE.

# LEGEND

**EXISTING HOUSE WALLS:** 

HOUE WALLS AS IS AND PER SURVEY PROPOSED NEW BLD WALLS

EXTERNAL WALLS BRICK AND/OR WEATHERBOARD WALLS INTERNAL FRAMED LIGHT WEIGHT PLASTERBOARD WALLS

PROPOSED ADDITION: HOUSE EXTENSION EXTRA GFA

DEMOLITION, EXISITING SEMI WALLS & FIXTURES TO BE DEMOLISHED ADJOINING NEIGHBOURING PROPERTIES

AS PER SITE SURVEY PLAN CONCRETE

REINFORCED CONCRETE TO ENGINEER DETAILS TIMBER FLOOR:
SELECTED HARDWOOD FLOOR TIMBER FLOOR:

WET AREA TILING

SELECTED FLOOR TILES TO FALLS & SET-OUT TO DETAIL ROOFING

COLOURBOND METAL ROOFING TO FALLS

### SYMBOLS

WINDOW LABEL

N° PLAN/ SECTION REFERENCE EXISTING WINDOW PLAN/ ELEVATION REFERENCE

DOOR LABEL DCP/LEP WALL HEIGHT LINE

FLOOR LEVELS

RL (LEVELS)

### DRAWING LIST

### ARCHITECTURAL DRAWING SET - DA

DRAWING ISSUE ISSUE DRAWING NAME (PAGE SIZE) ISSUED Cover Sheet + Site Plan 1/200 05/11/2018 1/100 05/11/2018 DA.02 Roof Plan DA.03 05/11/2018 Existing Lower Ground Floor Plan DA.04 Existing Ground Floor Plan 1/100 05/11/2018 Demolition Lower Ground Floor Plan 1/100 05/11/2018 Demolition Ground Floor Plan 05/11/2018 DA.07 05/11/2018 Lower Ground Floor Plan 1/100 05/11/2018 Ground Floor Plan First Floor Plan 05/11/2018 DA.10 DA Elevations North/South 05/11/2018 1/100 Elevations East/West 05/11/2018 DA.12 1/100 05/11/2018 Sections DA.13 05/11/2018 DA C Perspectives DA Glazing Schedule 05/11/2018

<u>CLIENT</u> GEORGE & TATIANA OPADCHY

7 CLIFFORD AVENUE, FAIRLIGHT NSW 2093 EMAIL: GEORGE@THECONSTRUCTIONSITE.COM.AU

PROJECT TEAM

ARCHITECT
DU PLESSIS + DU PLESSIS ARCHITECTS 20 MULGOWRIE CRESCENT, BALGOWLAH HEIGHTS NSW 2093 PHONE: 0403944576 EMAIL: E@DROOM.COM.AU CONTACT: EUGENE DU PLESSIS

SURVEYOR
TRUE NORTH SURVEYS PTY LTD 16/9 NARABANG WAY BELROSE NSW 2085 PHONE: 94500868 EMAIL: ADMIN@TRUENORTHSURVEYS.COM.AU CONTACT: TOM GILBERT

ENGINEER
GZ CONSULTING ENGINEERS 133 QUEENSCLIFF ROAD, QUEENSCLIFF NSW 2096 PHONE: 0403071853 EMAIL: GREG@GZENGINEERS.COM.AU CONTACT: GREG ZACCONE

THE CERTIFYING AUTHORITY IN ACCORDANCE WITH THE ACT.

UNIT 2A WINBOURNE ESTATE 9-13 WINBOURNE RD. BROOKVALE NSW 2100 PHONE: 99395350 EMAIL: INFO@PLATEAUTREES.COM.AU CONTACT: NICK NELSON

<u>PLANNER</u> NOLAN PLANNING

75 OLIVER STREET, FRESHWATER NSW 2096 PHONE: 0403524583 EMAIL: NATALIE@NOLANPLANNING.COM.AU CONTACT: NATALIE NOLAN

SHADOW DIAGRAM & ENERGY CONSULTANT DENEB DESIGN

PO BOX 539, MONA VALE, NSW 1660 PHONE: 99977480 EMAIL: INFO@DENEBDESIGN.COM CONTACT: CAMERON FIAZ

MANLY CIVIC CENTRE

1 BELGRAVE STREET MANLY NSW 2095

COUNCIL
NORTHERN BEACHES COUNCIL

### **GENERAL**

+ DA NOTICE OF DETERMINATION & DEVELOPMENT CONSENT: THE DEVELOPMENT TO BE SUBSTANTIALLY IN ACCORDANCE WITH THE APPROVED CONSENT PLANS AND SUPPORTING INFORMATION SUBMITTED WITH THE DA THIS SET OF DRAWINGS HAVE TO BE READ IN CONJUNCTION WITH THE ISSUED CONSENT AND 'STAMPED APPROVED' PLANS. PRIOR TO THE COMMENCEMENT OF ANY CONSTRUCTION WORK ON SITE THE NECESSARY CDC or CC APPROVALS & NOTICE OF COMMENCEMENT PAPERS MUST BE SUBMITTED/OBTAINED FROM


+ DRAWING INFORMATION: THE BUILDING IS PRINCIPALLY THAT WHICH IS DEPICTED IN THE ARCHITECTURAL PLANS, DETAILS & SPECIFICATIONS PREPARED BY DU PLESSIS + DU PLESSIS ARCHITECTS TOGETHER WITH SUPPORTING CONSULTANT DOCUMENTATION.

THE SITE INFORMATION HEREIN HAS BEEN TRANSPOSED FROM THE TRUE NORTH SURVEY PLAN #8732DU. REFER TO THIS SURVEY DRAWING TO CONFIRM BOUNDARIES, EXISTING FEATURES, LEVELS & DATUM. ALL LEVELS AND BOUNDARY SETBACKS TO BE CONFIRMED ON SITE. NOTE SEMI COMMON BDY WALL TO BE DETERMINED ACCURATELY.

REFER TO AND COORDINATE INFORMATION CONTAINED IN THE ARCHITECTURAL DRAWINGS AND THE DOCUMENTATION OF OTHER CONSULTANTS. REPORT DISCREPANCIES BETWEEN THE DOCUMENTS AND/OR WITH CONDITIONS ON SITE TO THE ARCHITECT FOR DIRECTION PRIOR TO PROCEEDING WITH THE WORKS

UNLESS NOTED OTHERWISE REFER TO DETAIL DRAWINGS FOR SET-OUT INFORMATION. DETAIL DRAWINGS AT LARGER SCALES TAKE PRECEDENCE OVER GENERAL ARRANGEMENT DRAWINGS AT SMALLER SCALES. IF IN DOUBT NOTIFY ARCHITECT FOR DIRECTION PRIOR TO PROCEEDING WITH THE WORKS.

EXECUTE THE WORKS IN COMPLIANCE WITH THE CURRENT EDITION OF THE NCC NATIONAL CONSTRUCTION CODE, CURRENT EDITIONS OF RELEVENT AUSTRALIAN AND OTHER PUBLISHED STANDARDS (AS AMENDED) AND THE REQUIREMENTS OF OTHER AUTHORITIES RELEVENT TO THE EXECUTION OF THE

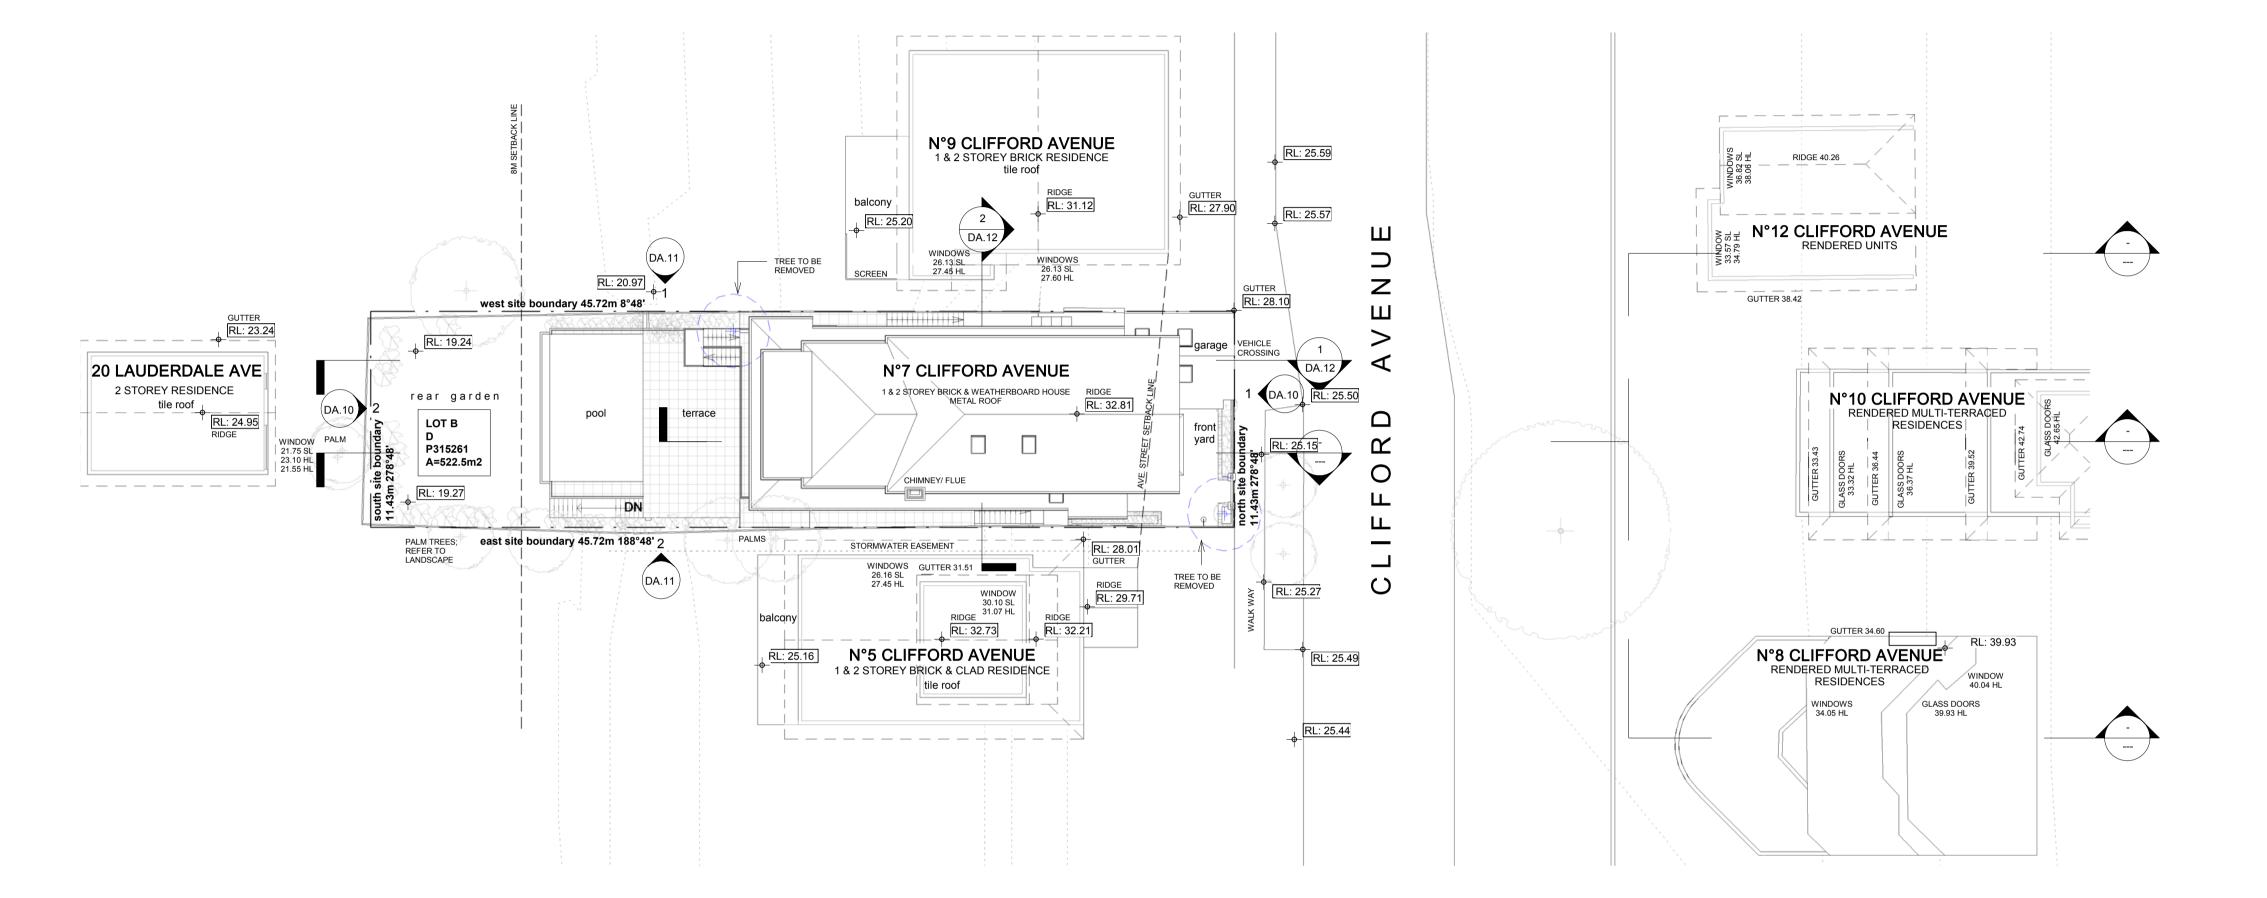

AC AIR CONDITIONED AHD AUSTRALIAN HEIGHT DATUM FFL FINISHED FLOOR LEVEL **ADH ADHESIVE** AG AGGREGATE AL ALUMINIUM AW AWNING B BALUSTRADE **BK BRICK WALL** BIT BITUMEN BHD BULKHEAD BOW BOTTOM OF WALL BM BENCHMARK BW BLOCKWORK WALL C CONCRETE **CANT CANTILEVER** CJ CONSTRUCTION JOINT CL CENTRE LINE CW CONCRETE WALL

CLMN COLUMN

DIM DIMENSION

ENG ENGINEER

**EX EXISTING** 

**EXH EXHAUST** 

F FALL TO SCREED

FG FIXED GLAZING

DP DOWNPIPE

DR DRAIN

CPT CARPET

**ABBREVIATIONS** 

FR FIRE RESISTANT FW FLOOR WASTE G GLASS GALV GALVANIZED GP GAS POINT H HYDRANT HWS HOT WATER SYSTEM HYD HYDRAULIC LS LANDSCAPING LV LOUVRE MECH MECHANICAL MDF MEDIUM DENSITY FIBRO BOARD MOD MODIFICATION MR METAL ROOFING MS MILD STEEL MV MECHANICAL VENTILATION NGL NATURAL GROUND LEVEL NTS NOT TO SCALE OFC OFF FORM CONCRETE OG OBSCURE GLAZING EJ EXPANSION JOINT OH OVER HEAD P SELECTED PAVING EWS EXTERNAL WALL SYSTEM PB PLASTERBOARD

PL PLANTER

PP POWER POLE

PS PRIVACY SCREEN

FIG FIGURE

FE FIRE EXTINGUISHER

PFC PARALLEL FLANCE CHANNEL

RWH RAIN WATER HEAD RWP RAIN WATER PIPE RL REDUCED LEVEL RC REINFORCED CONCRETE SB MAIN ELECTRICAL SWITCH BOARD SC STEEL COLUMN SHR SHOWER SLD SLIDING DOOR SPEC SPECIFICATION SS STAINLESS STEEL SSL STRUCTURAL SLAB LEVEL SW STONE WALL STD STANDARD SWP STORM WATER PIT T TILE TD TIMBER DECKING TOW TOP OF WALL TYP TYPICAL UR UNIVERSAL BEAM US UNDERSIDE **V VENTILATION** W WINDOW WC WATER CLOSET WM WATER MAIN WPM WATER PROOFING MEMBRANE


PW PLASTERBOARD WALL


RW RENDERED & PAINTED WALL

QTY QUANTITY

REF REFERENCE

Residential Alterations & Additions CLASS 1a Building 7 CLIFFORD AVENUE, FAIRLIGHT LOT B; SEC 1 - D.P. 315261 EXISTING SITE AREA 522.5m<sup>2</sup>

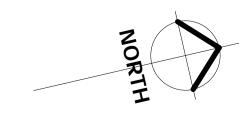

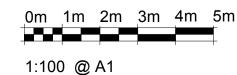

NOTES

+ SITE SURVEY INFORMATION:
THE SITE INFORMATION HEREIN HAS BEEN TRANSPOSED FROM THE C.M.S. SURVEYORS PIJ LID SURVEY PLAN NO.6373A. REFER TO THIS DRAWING TO CONFIRM BOUNDARIES, EXISTING FEATURES, LEVELS & DATUM. EXISTING HOUSE WALL MEASUREMENTS (INTERNAL) BY V MARK SURVEYS AND ACCURACY T.B.C ON SITE. + COORDINATION:
REFER TO AND COORDINATE INFORMATION CONTAINED IN THE ARCHITECTURAL DRAWINGS AND THE DOCUMENTATION OF OTHER CONSULTANTS WITH THE 'SPECIFICATION FOR BUILDING WORKS'. REPORT DISCREPANCIES BETWEEN THE DOCUMENTS AND/OR WITH CONDITIONS ON SITE TO THE ARCHITECT FOR DIRECTION PRIOR TO PROCEEDING WITH

+ DETAIL DRAWINGS:
UNLESS NOTED OTHERWISE REFER TO DETAIL DRAWINGS
FOR SET-OUT INFORMATION. DETAIL DRAWINGS AT LARGER SCALES TAKE PRECEDENCE OVER GENERAL ARRANGEMENT DRAWINGS AT SMALLER SCALES. IF IN DOUBT NOTIFY ARCHITECTS FOR DIRECTION PRIOR TO PROCEEDING WITH

+ EXECUTION OF THE WORKS:

EXECUTE THE WORKS IN COMPLIANCE WITH THE CURRENT EDITION OF THE BUILDING CODE OF AUSTRALIA (AS AMENDED), CURRENT EDITIONS OF RELEVANT AUSTRALIAN AND OTHER PUBLISHED STANDARDS (AS AMENDED) AND THE REQUIREMENTS OF OTHER AUTHORITIES RELEVANT TO THE EXECUTION OF THE WORKS.

issue	date	description
Α	02/07/2018	Preliminary DA Issue for Review
В	19/10/2018	DA Issue for Review
С	05/11/2018	DEVELOPMENT APPLICATION

CONTRACTORS TO VERIFY ALL DIMENSIONS ON SITE FIGURED DIMENSIONS ARE TO BE TAKEN IN PREFERENCE - ALL DIMENSIONS IN MILLIMETRES. - ALL DIMENSIONS IN MILLIME I RES.
- PLEASE NOTIFY DU PRESSIS + DU PRESSIS ARCHITECTS
IMMEDIATELY SHOULD ANY DISCREPANCIES BE FOUND.
- COPYRIGHT APPLIES TO THIS DOCUMENT.
- THE DESIGN IS THE PROPRETY OF DU PLESSIS +
DUE ESIS ARCHITECTS. DUPLESSIS ARCHITECTS - REPRODUCTION OF ANY KIND IS NOT PERMITTED WITHOUT CONSENT.
- ALL WORKS TO BE IN ACCORDANCE WITH THE RELEVANT AS, BCA AND COUNCIL BUILDING REQUIREMENTS.

# **DU PLESSIS**

h@droom.com.au 0433408368 www.droom.com.au

NSW REGISTERED ARCHITECT #7435 NOMINATED ARCHITECT: EUGENE DU PLESSIS

PROJECT TITLE: OPADCHY House Alterations & Additions

CLIENT NAME: GEORGE + TATIANA OPADCHY

ADDRESS: 7 Clifford Avenue Fairlight NSW 2094

DRAWING TITLE: Cover Sheet + Site Plan

DRAWN **EDUP** AΗ

SCALE:

1:200@A1 DRAWING NO:

05/11/2018

### BASIX COMMITMENTS READ DRAWINGS IN CONJUNCTION WITH THE ATTACHED BASIX CERTIFICATE #A329994 SUBMITTED WITH THE DEVELOPMENT - THE OUTDOOR SWIMMING POOL MUST NOT HAVE A CAPACITY GREATER THAN 36 KILOLITRES. INSTALL A POOL PUMP & HEATING SYSTEM FOR THE SWIMMING POOL TO BE SOLAR ONLY. - THE APPLICANT MUST INSTALL A RAINWATER TANK OF AT LEAST 1575 LITRES ON THE SITE. THE RAINWATER TANK TO COLLECT RAINWATER RUNOFF FROM AT LEAST 90 SQUARE METRES OF ROOF AREA. CONNECT THE RAINWATER TANK TO A TAP LOCATED WITHIN 10 METRES OF THE EDGE OF THE POOL. - PROVIDE A HEATING/COOLING SYSTEM TO ACHIEVE THE REQUIRED STAR ENERGY RATING. - A NEW 'GAS INSTANTANEOUS 'HOT WATER SYSTEM TO BE INSTALLED [POSITION T.B.C] - A MINIMUM OF 40% OF NEW OR ALTERED LIGHT FIXTURES ARE TO BE FITTED WITH FLUORESCENT, COMPACT FLUORESCENT, OR LIGHT-EMITTING-DIODE (LED) LAMPS. - ALL NEW or ALTERED SHOWERHEAD, TOILET & TAP FIXTURES TO ACHIEVE THE REQUIRED STAR WATER RATING. - ADDITIONAL NEW FLOOR, WALL & ROOF CEILING INSULATION TO HAVE THE MINIMUM R-VALUES AS SPECIFIED IN THE CERTIFICATE - ALL NEW WINDOWS & SKYLIGHTS TO HAVE U-VALUE AND A SOLAR HEAT GAIN COEFFICIENT NO GREATER THAN THAT LISTED IN THE - THE NEW ROOF COLOUR TO BE OF MEDIUM SOLAR ABSORPTANCE. LEGEND **EXISTING HOUSE WALLS:** HOUE WALLS AS IS AND PER SURVEY PROPOSED NEW BLD WALLS EXTERNAL WALLS BRICK AND/OR WEATHERBOARD WALLS INTERNAL FRAMED LIGHT WEIGHT PLASTERBOARD WALLS PROPOSED ADDITION: HOUSE EXTENSION EXTRA GFA DEMOLITION, EXISITING SEMI WALLS & FIXTURES TO BE DEMOLISHED ADJOINING NEIGHBOURING PROPERTIES AS PER SITE SURVEY PLAN CONCRETE REINFORCED CONCRETE TO ENGINEER DETAILS TIMBER FLOOR: SELECTED HARDWOOD FLOOR WET AREA TILING SELECTED FLOOR TILES TO FALLS & SET-OUT TO DETAIL COLOURBOND METAL ROOFING TO FALLS


SYMBOLS


WINDOW LABEL

DOOR LABEL

DCP/LEP WALL

HEIGHT LINE

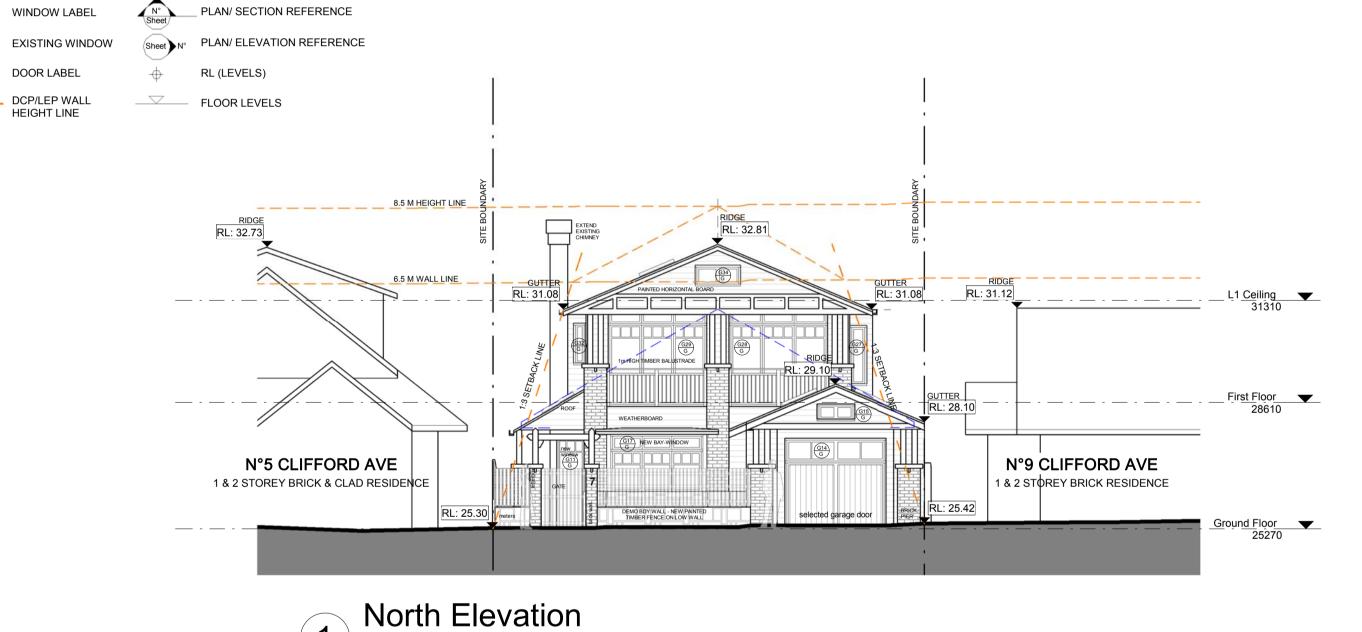

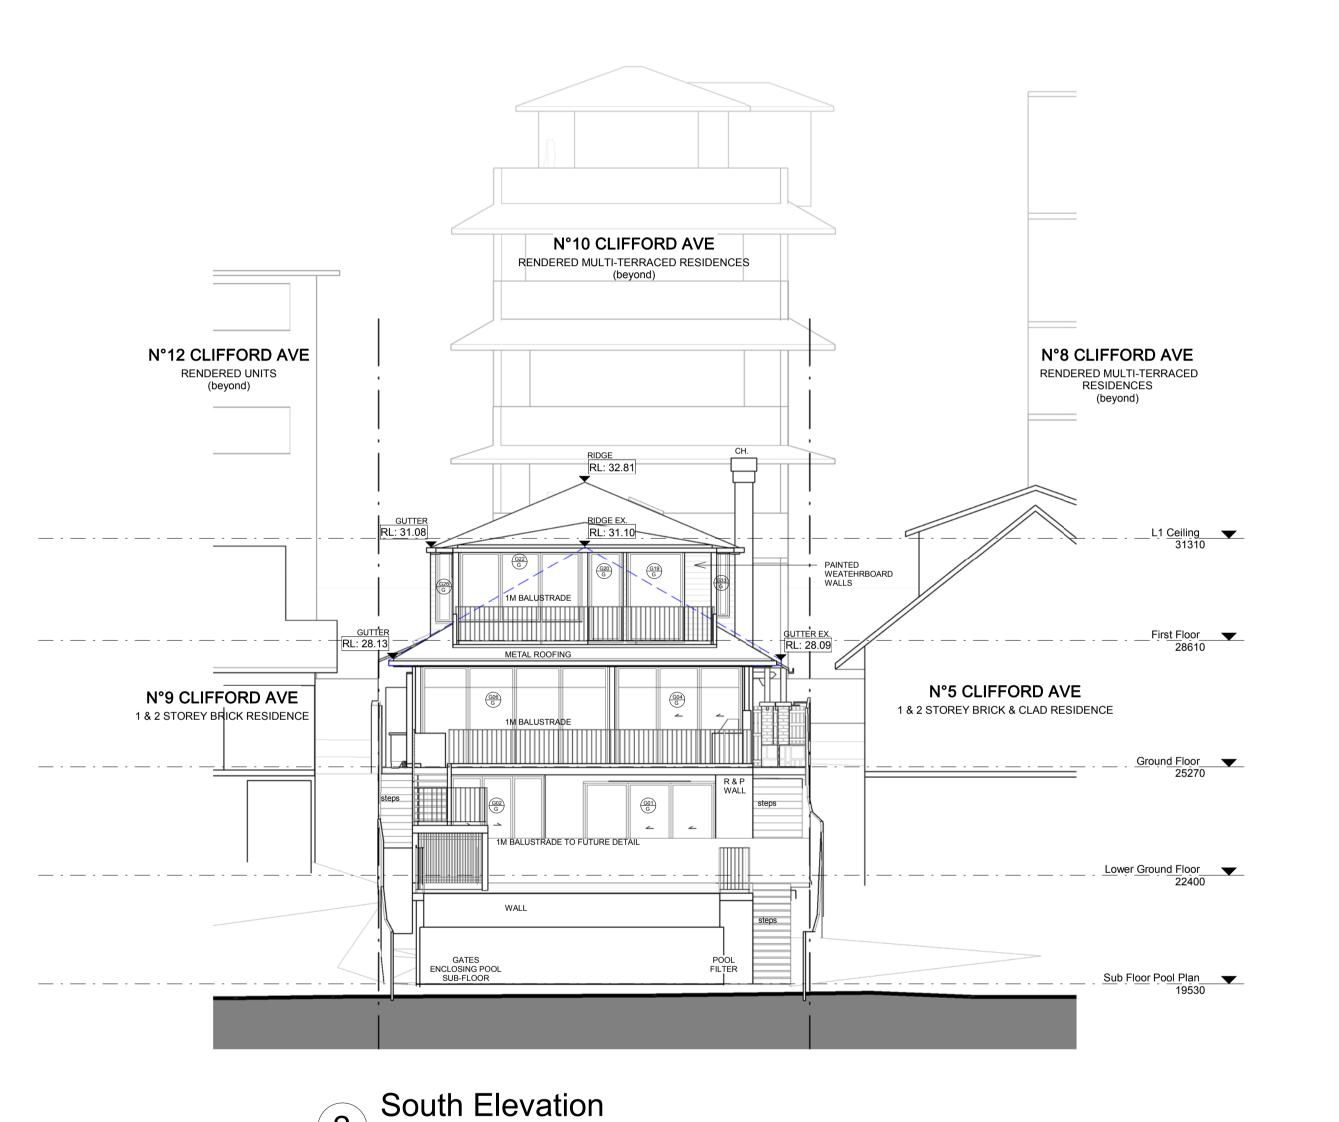

0m 1m 2m 3m 4m 5m 1:100 @ A1

NOTES

+ SITE SURVEY INFORMATION:
THE SITE INFORMATION HEREIN HAS BEEN TRANSPOSED FROM THE C.M.S. SURVEYORS Pty Ltd SURVEY PLAN No.6373A. REFER TO THIS DRAWING TO CONFIRM BOUNDARIES, EXISTING FEATURES, LEVELS & DATUM. EXISTING HOUSE WALL MEASUREMENTS (INTERNAL) BY V-MARK SURVEYS AND ACCURACY T.B.C ON SITE.

+ COORDINATION:
REFER TO AND COORDINATE INFORMATION CONTAINED IN REFER TO AND COORDINATE INFORMATION CONTAINED IN THE ARCHITECTURAL DRAWINGS AND THE DOCUMENTATION OF OTHER CONSULTANTS WITH THE 'SPECIFICATION FOR BUILDING WORKS'. REPORT DISCREPANCIES BETWEEN THE DOCUMENTS AND/OR WITH CONDITIONS ON SITE TO THE ARCHITECT FOR DIRECTION PRIOR TO PROCEEDING WITH THE WORKS.

+ DETAIL DRAWINGS:
UNLESS NOTED OTHERWISE REFER TO DETAIL DRAWINGS FOR SET-OUT INFORMATION. DETAIL DRAWINGS AT LARGER SCALES TAKE PRECEDENCE OVER GENERAL ARRANGEMENT DRAWINGS AT SMALLER SCALES. IF IN DOUBT NOTIFY ARCHITECTS FOR DIRECTION PRIOR TO PROCEEDING WITH THE WORKS.

THE WORKS.

+ EXECUTION OF THE WORKS:

EXECUTE THE WORKS IN COMPLIANCE WITH THE CURRENT EDITION OF THE BUILDING CODE OF AUSTRALIA (AS AMENDED), CURRENT EDITIONS OF RELEVANT AUSTRALIAN AND OTHER PUBLISHED STANDARDS (AS AMENDED) AND THE REQUIREMENTS OF OTHER AUTHORITIES RELEVANT TO THE EXECUTION OF THE WORKS.

issue date description 02/07/2018 Preliminary DA Issue for Review 19/10/2018 DA Issue for Review 05/11/2018 DEVELOPMENT APPLICATION

- CONTRACTORS TO VERIFY ALL DIMENSIONS ON SITE - CONTRACTORS TO VERIFY ALL DIMENSIONS ON SITE BEFORE COMMENCING WORK.
- FIGURED DIMENSIONS ARE TO BE TAKEN IN PREFERENCE TO SCALING.
- ALL DIMENSIONS IN MILLIMETRES.
- PLEASE NOTIFY DU PRESSIS + DU PRESSIS ARCHITECTS IMMEDIATELY SHOULD ANY DISCREPANCIES BE FOUND.
- COPYRIGHT APPLIES TO THIS DOCUMENT.
- THE DESIGN IS THE PROPRETY OF DU PLESSIS + DUPLESSIS ARCHITECTS - REPRODUCTION OF ANY KIND IS NOT PERMITTED WITHOUT CONSENT.
- ALL WORKS TO BE IN ACCORDANCE WITH THE RELEVANT AS, BCA AND COUNCIL BUILDING REQUIREMENTS.

DU PLESSIS DU PLESSIS ARCHITECTS

h@droom.com.au 0433408368 www.droom.com.au

NSW REGISTERED ARCHITECT #7435 NOMINATED ARCHITECT: EUGENE DU PLESSIS

PROJECT TITLE: OPADCHY House Alterations & Additions

CLIENT NAME: GEORGE + TATIANA OPADCHY

ADDRESS: 7 Clifford Avenue

Fairlight NSW 2094 DRAWING TITLE:

Elevations North/South

EDUP  $\mathsf{AH}$ SCALE:

CHECKED:

1:100@A1

DRAWING NO:

DRAWN:

DA.10

DATE: 05/11/2018

# BASIX COMMITMENTS

WITHIN 10 METRES OF THE EDGE OF THE POOL.

READ DRAWINGS IN CONJUNCTION WITH THE ATTACHED BASIX CERTIFICATE #A329994 SUBMITTED WITH THE DEVELOPMENT

- THE OUTDOOR SWIMMING POOL MUST NOT HAVE A CAPACITY GREATER THAN 36 KILOLITRES. INSTALL A POOL PUMP & HEATING SYSTEM FOR THE SWIMMING POOL TO BE SOLAR ONLY.

- THE APPLICANT MUST INSTALL A RAINWATER TANK OF AT LEAST 1575 LITRES ON THE SITE. THE RAINWATER TANK TO COLLECT RAINWATER RUNOFF FROM AT LEAST 90 SQUARE METRES OF ROOF AREA. CONNECT THE RAINWATER TANK TO A TAP LOCATED

- PROVIDE A HEATING/COOLING SYSTEM TO ACHIEVE THE REQUIRED STAR ENERGY RATING.
- A NEW 'GAS INSTANTANEOUS 'HOT WATER SYSTEM TO BE INSTALLED [POSITION T.B.C]
- A MINIMUM OF 40% OF NEW OR ALTERED LIGHT FIXTURES ARE TO BE FITTED WITH FLUORESCENT, COMPACT FLUORESCENT, OR
- ALL NEW or ALTERED SHOWERHEAD, TOILET & TAP FIXTURES TO ACHIEVE THE REQUIRED STAR WATER RATING.
- ADDITIONAL NEW FLOOR, WALL & ROOF CEILING INSULATION TO HAVE THE MINIMUM R-VALUES AS SPECIFIED IN THE CERTIFICATE

- ALL NEW WINDOWS & SKYLIGHTS TO HAVE U-VALUE AND A SOLAR HEAT GAIN COEFFICIENT NO GREATER THAN THAT LISTED IN THE BASIX TABLE REQUIREMENTS.

- THE NEW ROOF COLOUR TO BE OF MEDIUM SOLAR ABSORPTANCE.



# SYMBOLS



\_\_ \_ DCP/LEP WALL


HEIGHT LINE


FLOOR LEVELS

RL (LEVELS)


PLAN/ SECTION REFERENCE

Sheet N° PLAN/ ELEVATION REFERENCE

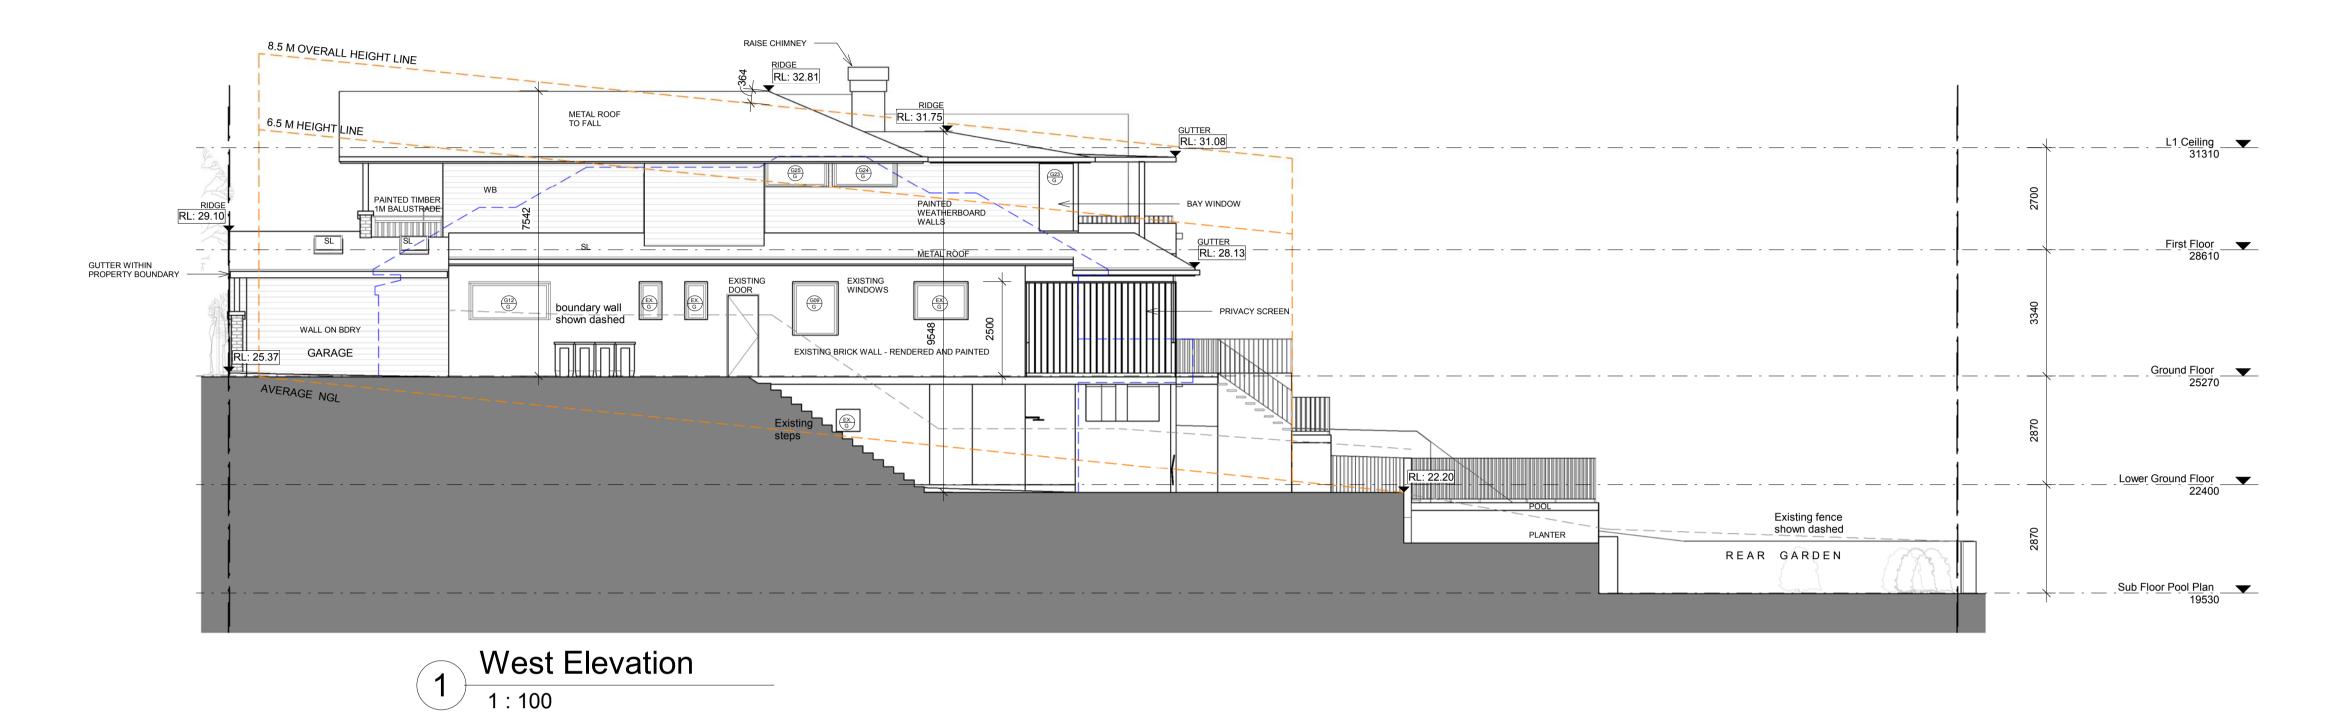

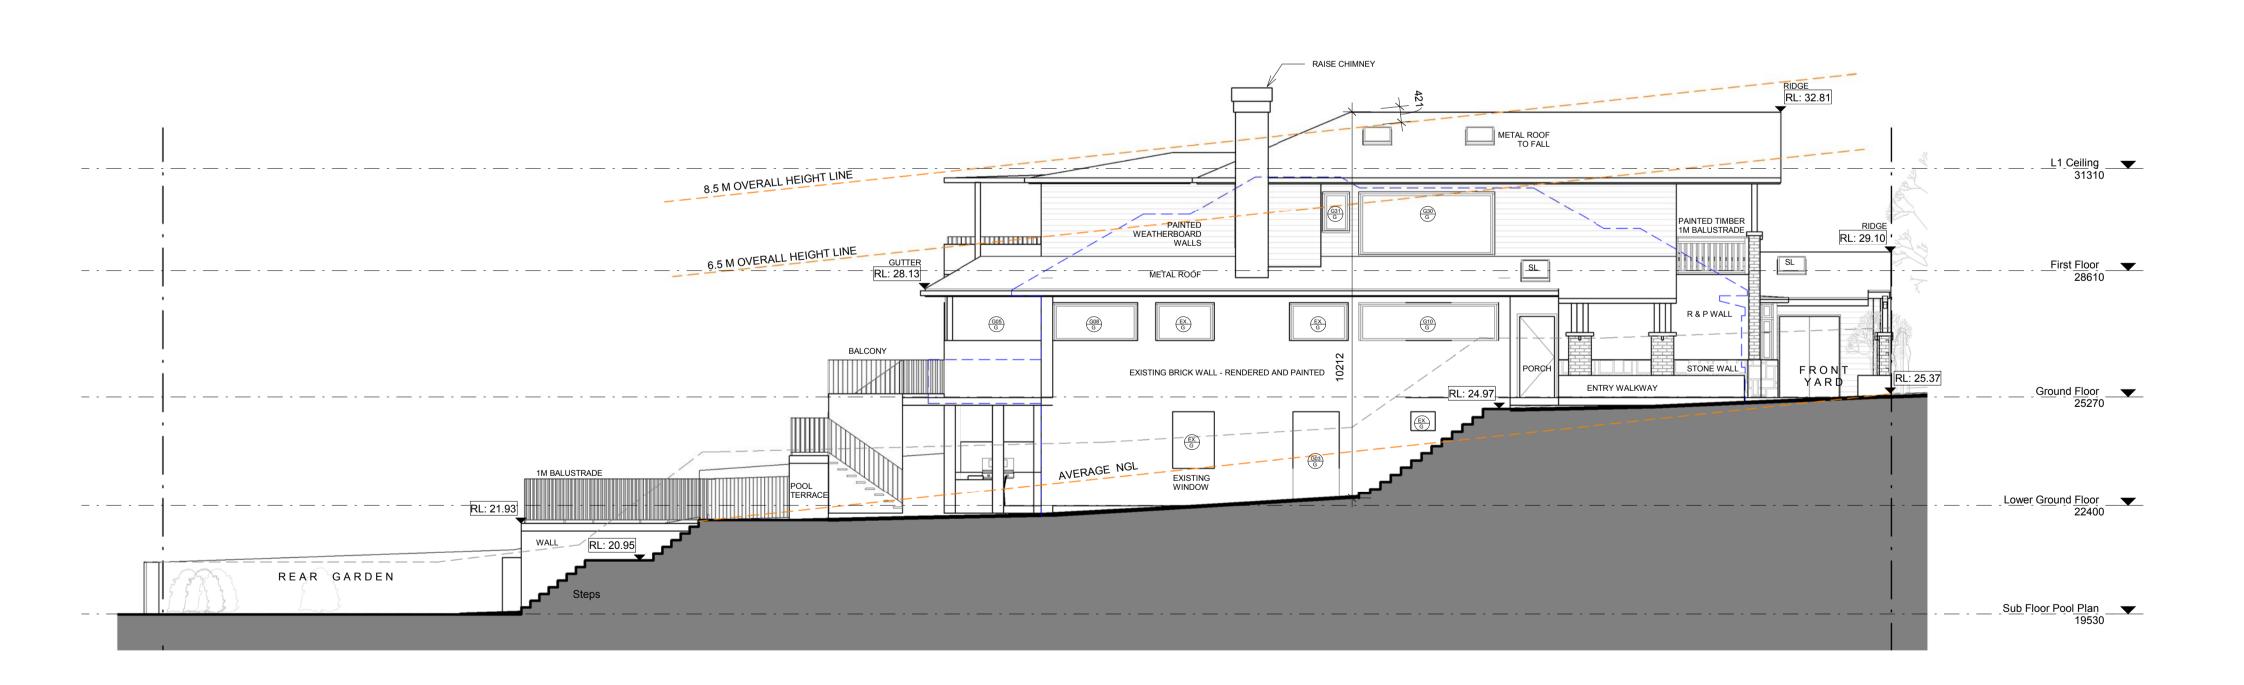



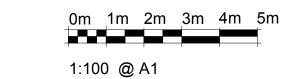

NOTES

+ SITE SURVEY INFORMATION:
THE SITE INFORMATION HEREIN HAS BEEN TRANSPOSED FROM THE C.M.S. SURVEYORS Pty Ltd SURVEY PLAN No.6373A. REFER TO THIS DRAWING TO CONFIRM BOUNDARIES, EXISTING FEATURES, LEVELS & DATUM.

EXISTING HOUSE WALL MEASUREMENTS (INTERNAL) BY V-MARK SURVEYS AND ACCURACY T.B.C ON SITE.

+ COORDINATION:
REFER TO AND COORDINATE INFORMATION CONTAINED IN REFER TO AND COORDINATE INFORMATION CONTAINED IN THE ARCHITECTURAL DRAWINGS AND THE DOCUMENTATION OF OTHER CONSULTANTS WITH THE 'SPECIFICATION FOR BUILDING WORKS'. REPORT DISCREPANCIES BETWEEN THE DOCUMENTS AND/OR WITH CONDITIONS ON SITE TO THE ARCHITECT FOR DIRECTION PRIOR TO PROCEEDING WITH THE WORKS.

+ DETAIL DRAWINGS:
UNLESS NOTED OTHERWISE REFER TO DETAIL DRAWINGS FOR SET-OUT INFORMATION. DETAIL DRAWINGS AT LARGER SCALES TAKE PRECEDENCE OVER GENERAL ARRANGEMENT DRAWINGS AT SMALLER SCALES. IF IN DOUBT NOTIFY ARCHITECTS FOR DIRECTION PRIOR TO PROCEEDING WITH THE WORKS:

+ EXECUTION OF THE WORKS:

THE WORKS.

+ EXECUTION OF THE WORKS:

EXECUTE THE WORKS IN COMPLIANCE WITH THE CURRENT EDITION OF THE BUILDING CODE OF AUSTRALIA (AS AMENDED), CURRENT EDITIONS OF RELEVANT AUSTRALIAN AND OTHER PUBLISHED STANDARDS (AS AMENDED) AND THE REQUIREMENTS OF OTHER AUTHORITIES RELEVANT TO THE EXECUTION OF THE WORKS.

issue	date	description
А	02/07/2018	Preliminary DA Issue for Review
В	19/10/2018	DA Issue for Review
С	05/11/2018	DEVELOPMENT APPLICATION

- CONTRACTORS TO VERIFY ALL DIMENSIONS ON SITE - CONTRACTORS TO VERIFY ALL DIMENSIONS ON SITE BEFORE COMMENCING WORK.
- FIGURED DIMENSIONS ARE TO BE TAKEN IN PREFERENCE TO SCALING.
- ALL DIMENSIONS IN MILLIMETRES.
- PLEASE NOTIFY DU PRESSIS + DU PRESSIS ARCHITECTS IMMEDIATELY SHOULD ANY DISCREPANCIES BE FOUND.
- COPYRIGHT APPLIES TO THIS DOCUMENT.
- THE DESIGN IS THE PROPRETY OF DU PLESSIS + DUPLESSIS ARCHITECTS - REPRODUCTION OF ANY KIND IS NOT PERMITTED WITHOUT CONSENT.
- ALL WORKS TO BE IN ACCORDANCE WITH THE RELEVANT AS, BCA AND COUNCIL BUILDING REQUIREMENTS.

# DU PLESSIS DU PLESSIS ARCHITECTS

NOMINATED ARCHITECT: EUGENE DU PLESSIS

0433408368 www.droom.com.au NSW REGISTERED ARCHITECT #7435

h@droom.com.au

PROJECT TITLE:

OPADCHY House Alterations & Additions

GEORGE + TATIANA OPADCHY

7 Clifford Avenue Fairlight NSW 2094

CLIENT NAME:

ADDRESS:

DRAWING TITLE: Elevations East/West

DRAWN: CHECKED: EDUP  $\mathsf{AH}$ 

SCALE: 1:100@A1


DRAWING NO:

DA.11

DATE: 05/11/2018





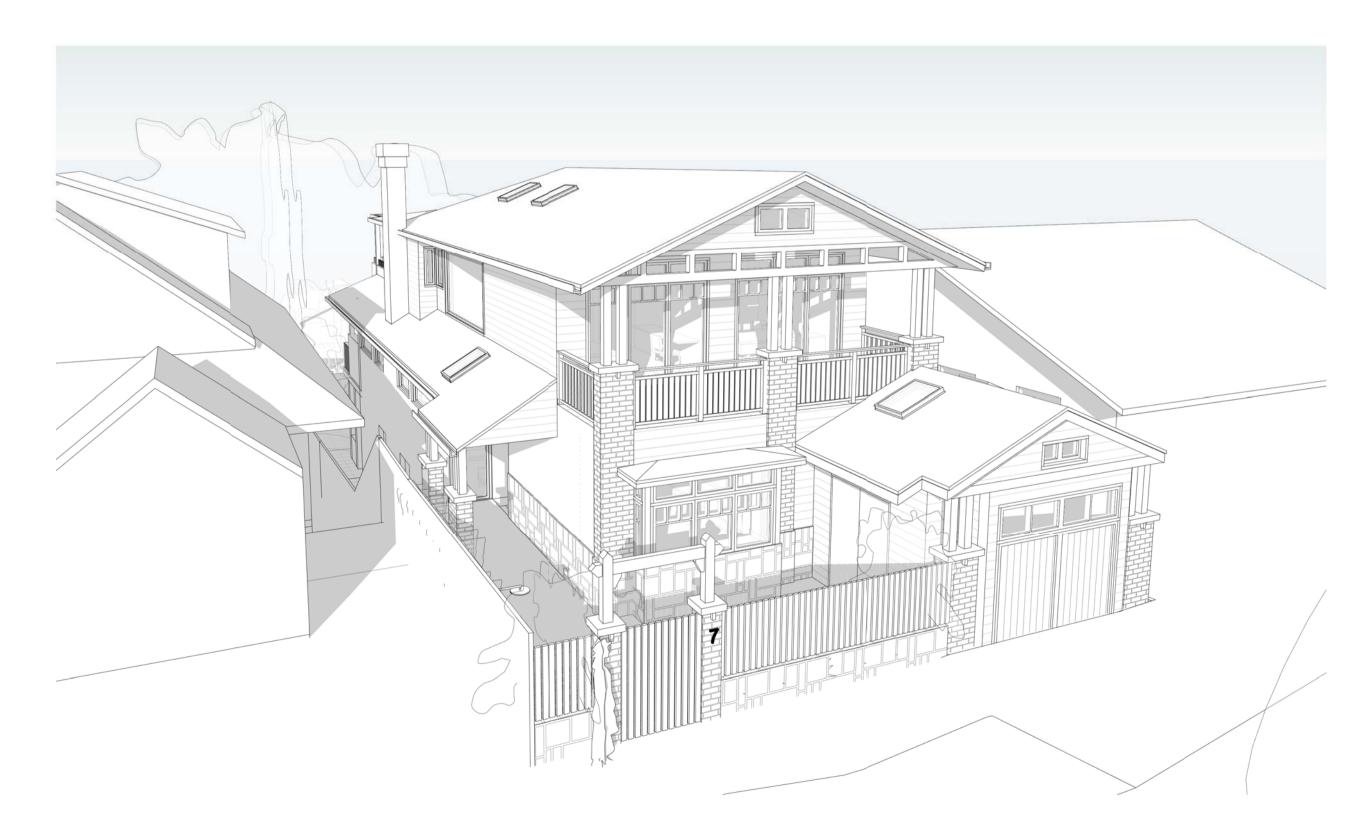

Perspective Northeast





Perspective Northwest

NOTES

+ SITE SURVEY INFORMATION:
THE SITE INFORMATION HEREIN HAS BEEN TRANSPOSED FROM THE C.M.S. SURVEYORS PIY LIG SURVEY PLAN No.6373A. REFER TO THIS DRAWING TO CONFIRM BOUNDARIES, EXISTING FEATURES, LEVELS & DATUM. EXISTING HOUSE WALL MEASUREMENTS (INTERNAL) BY V-MARK SURVEYS AND ACCURACY T.B.C ON SITE.

+ COORDINATION:
REFER TO AND COORDINATE INFORMATION CONTAINED IN THE ARCHITECTURAL DRAWINGS AND THE DOCUMENTATION OF OTHER CONSULTANTS WITH THE 'SPECIFICATION FOR BUILDING WORKS'. REPORT DISCREPANCIES BETWEEN THE DOCUMENTS AND/OR WITH CONDITIONS ON SITE TO THE ARCHITECT FOR DIRECTION PRIOR TO PROCEEDING WITH THE WORKS.

+ DETAIL DRAWINGS:
UNLESS NOTED OTHERWISE REFER TO DETAIL DRAWINGS FOR SET-OUT INFORMATION. DETAIL DRAWINGS AT LARGER SCALES TAKE PRECEDENCE OVER GENERAL ARRANGEMENT DRAWINGS AT SMALLER SCALES. IF IN DOUBT NOTIFY ARCHITECTS FOR DIRECTION PRIOR TO PROCEEDING WITH THE WORKS.

+ EXECUTE THE WORKS:
EXECUTE THE WORKS IN COMPLIANCE WITH THE CURRENT EDITION OF THE BUILDING CODE OF AUSTRALIA (AS AMENDED), CURRENT EDITIONS OF RELEVANT AUSTRALIAN AND OTHER PUBBLISHED STANDARDS (AS AMENDED) AND THE EXECUTION OF THE WORKS.

issue date description 02/07/2018 Preliminary DA Issue for Review 19/10/2018 DA Issue for Review 05/11/2018 DEVELOPMENT APPLICATION

- CONTRACTORS TO VERIFY ALL DIMENSIONS ON SITE BEFORE COMMENCING WORK.
- FIGURED DIMENSIONS ARE TO BE TAKEN IN PREFERENCE TO SCALING.
- ALL DIMENSIONS IN MILLIMETRES.
- PLEASE NOTIFY DU PRESSIS + DU PRESSIS ARCHITECTS IMMEDIATELY SHOULD ANY DISCREPANCIES BE FOUND.
- COPYRIGHT APPLIES TO THIS DOCUMENT.
- THE DESIGN IS THE PROPRETY OF DU PLESSIS + DUPLESSIS ARCHITECTS - REPRODUCTION OF ANY KIND IS NOT PERMITTED WITHOUT CONSENT.
- ALL WORKS TO BE IN ACCORDANCE WITH THE RELEVANT AS, BCA AND COUNCIL BUILDING REQUIREMENTS.

DU PLESSIS DU PLESSIS ARCHITECTS

h@droom.com.au 0433408368 www.droom.com.au NSW REGISTERED ARCHITECT #7435 NOMINATED ARCHITECT: EUGENE DU PLESSIS

PROJECT TITLE: OPADCHY House Alterations & Additions

CLIENT NAME: GEORGE + TATIANA OPADCHY

ADDRESS: 7 Clifford Avenue Fairlight NSW 2094

DRAWING TITLE:

Perspectives

CHECKED: EDUP  $\mathsf{AH}$ 

SCALE:

DRAWING NO:

DA.13

05/11/2018