

Ceneral Notes
 NEVER scale off drawings, use figured dimensions only.
 Verify all dimensions on site prior to commencement & report discrepancies to the architect.
 Drawings describe scope of works and general set out. These drawings are not shop drawings. Set out to to be undertaken by surveyor on site. Shop drawings should be prepared where required or necessary

Refer to the notes page for legend that includes further notes and explanation of abbreviation

SITE PLAN - LANDSCAPE WORKS

DA SUBMISSION

REV - 26/03/2021 STAGE


Bower Street Manly

84 Bower Street Manly

CLIENT Michael & Jenny Bushell

ARCHITECTURE URBAN PLANNING M1/147 McEvoy St Alexandria NSW 2015 P 02 9516 2022 E email@smithtzannes.com.au smithtzannes.com.au Nominated Architect: Peter Smith (Reg 7024)



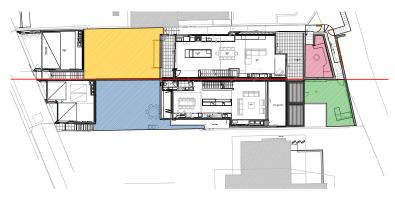

PLANTING KEY PLAN SCALE 1:200 @ A1

LEGEND

ZONE 1
ZONE 2
ZONE 3 ZONE 4

northern beaches

THIS PLAN IS TO BE READ IN **CONJUNCTION WITH** THE CONDITIONS OF DEVELOPMENT CONSENT

DA2021/0868

PLANT SCHEDULE

TREES										
CODE	BOTANIC NAME	COMMON NAME	ZONE 1	ZONE 2	ZONE 3	ZONE 4	TOTAL	POTSIZE	MATURE HEIGHT	NOTES
CA	Cupaniopsis anacardioides	Tuckeroo		1			1	400L	4-6m	
СН	Chamaerops humilis	European Fan Palm			1		1	300L	1.5-2.5m	Multi Trunk
CL	Citrus x limon	Lemon Tree		2		1	3	300L	3m	
DD	Dracaena draco	Dragon Tree	1				1	1000L	3m	
GF	Glochidion ferdinandii	Cheese Tree	1				1	100L	4-6m	
LN	Lagerstroemia 'Natchez'	Crepe Myrtle		1			1	1000L	6-8m	
OE	Olea europaea	Europen Olive	2	2		1	5	300L	2-3m	
SP	Syzygium pinnacle	Pinnacle Lilly Pilly		11			11	100L	4m	Hedge
TL	Tristaniopsis laurina	Water Gum		1			1	300L	4-6m	
SHRUBS		•	'	•					'	
CODE	BOTANIC NAME	COMMON NAME	ZONE 1	ZONE 2	ZONE 3	ZONE 4	TOTAL	POT SIZE	MATURE HEIGHT	NOTES
Bm	Buxus microphylla 'Ball'	Buxus Balls	201121	9	201100	4	13	400mm	0.6m	1.0.100
Cr	Cycas revoluta	King Sago Palm	1		3	-	4	500mm	1.2m	
	Doryanthes excelsa	Gymea Lily		<u> </u>	3					
De				1		2	3	300mm	2-4m	1 Des Carales I
Ep	Elaeagnus pungens	Spiny Oleaster	3	10		5	18	300mm	4m	1 Per Symbol
Lc	Lomandra confertifolia 'Little Con'	Matt Rush				20	20	140mm	0.3m	5 Per Symbol
Pt	Pittosporum tobira	Pittosporum	14		8		22	200mm	0.5m	2 Per Symbol
Rs	Rhaphiolepis 'Snow Maiden'	India Hawthorn		10		10	20	200mm	1.4m	1 Per Symbol
Vs	Viburnum suspensum	Sandankwa Viburnum		5			5	300mm	2m	1 Per Symbol
Wf	Westringia fruticosa	Coastal Rosemary	10		6		16	200mm	1m	2 Per Symbol
GROUNDC	OVERS & CLIMBERS									
CODE	BOTANIC NAME	COMMON NAME	ZONE 1	ZONE 2	ZONE 3	ZONE 4	TOTAL	POT SIZE	MATURE HEIGHT	<u>NOTES</u>
Dr	Dichondra repens	Kidney Weed		36		27	63	100mm	Groundcover	9 Per m2
Fp	Ficus pumila	Creeping Fig	5	10	5	5	25	100mm	Climber	
Gt	Gazania tomentosa	Silver Gazania		12			12	140mm	Groundcover	6 Per m2
Мр	Myoporum parvifolium	Creeping Boobialla		12			12	140mm	Groundcover	6 Per m2
Ro	Rosmarinus officinalis 'Prostratus'	Creeping Rosemary		25	5	5	35	140mm	Groundcover	5 Per m2
Vh	Viola hederacea	Native Violet			27	Ť	27	100mm	Groundcover	9 Per m2
VIII	Viola nederaced	Indive videi			Z/		21	10011111	Ciodilacovei	71611112
SUCCULEN	TC									
			70.151	701150	70.150	70.15		0.01.035		
CODE	BOTANIC NAME	COMMON NAME	ZONE 1	ZONE 2	ZONE 3	ZONE 4	TOTAL	POT SIZE	MATURE HEIGHT	NOTES
Aa	Agave americana	Century Plant	+	2		-	2	500mm	1-2m	
Aan	Agave angustifolia	Variegated Caribbean Agave	1			-	1	400mm	400mm	
Ap	Aloe plicatilis	Fan Aloe	4			-	4	500mm	4m	
Kh	Kalanchoe hildebradtii	Silver Spoons	+	15		5	20	200mm	0.6-1m	
Ss	Senecio serpens	Blue Chalk Sticks	27	27	9		63	140mm	0.3-0.45mm	9 Per m2

NOTES

- ALL MATURE TREES TO BE SOURCED AND SUPPLIED BY MYLES BALDWIN DESIGN
- THE PLANT SCHEDULE IS CALCULATED BASED OFF THE LANDSCAPE PLANS PROVIDED BY MBD. ADDITIONAL PLANTS
- OUTSIDE OF THIS SCHEDULE MAY BE REQUIRED TO REACH THE DESIRED PLANT DENSITIES ONSITE
- ALL PLANT MATERIAL TO BE SETOUT ONSITE BY MYLES BALDWIN DESIGN PRIOR TO INSTALLATION



PROJECT: 84/82 BOWER STREET, MANLY


BUSHELL AND LAKE






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CONCRETE PAVING

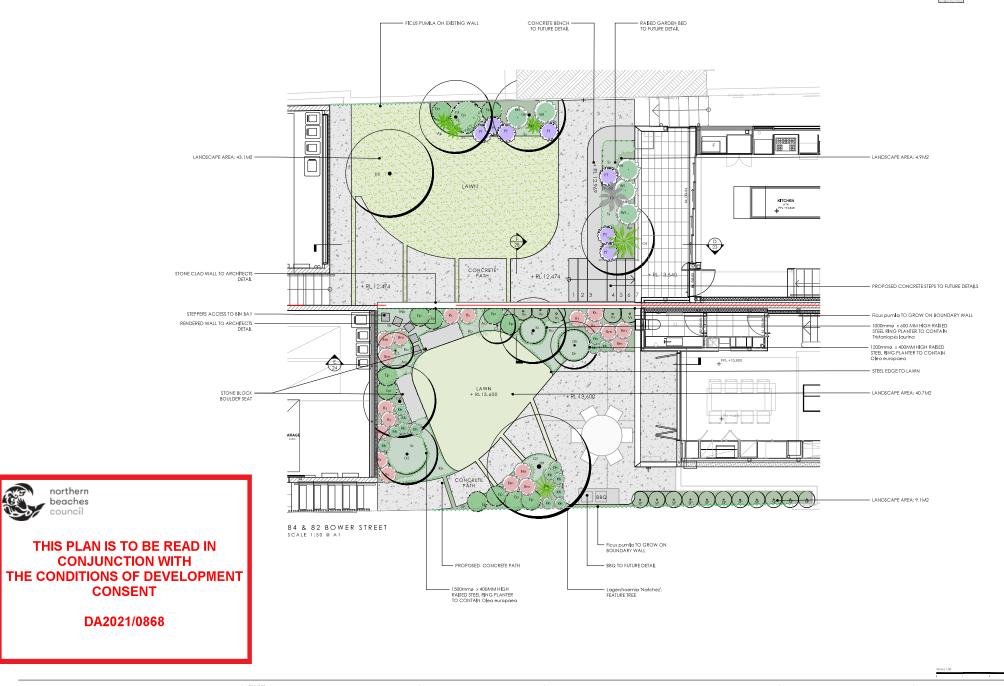

CONCRETE PAVING


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CLIENT:
BUSHELL AND LAKE

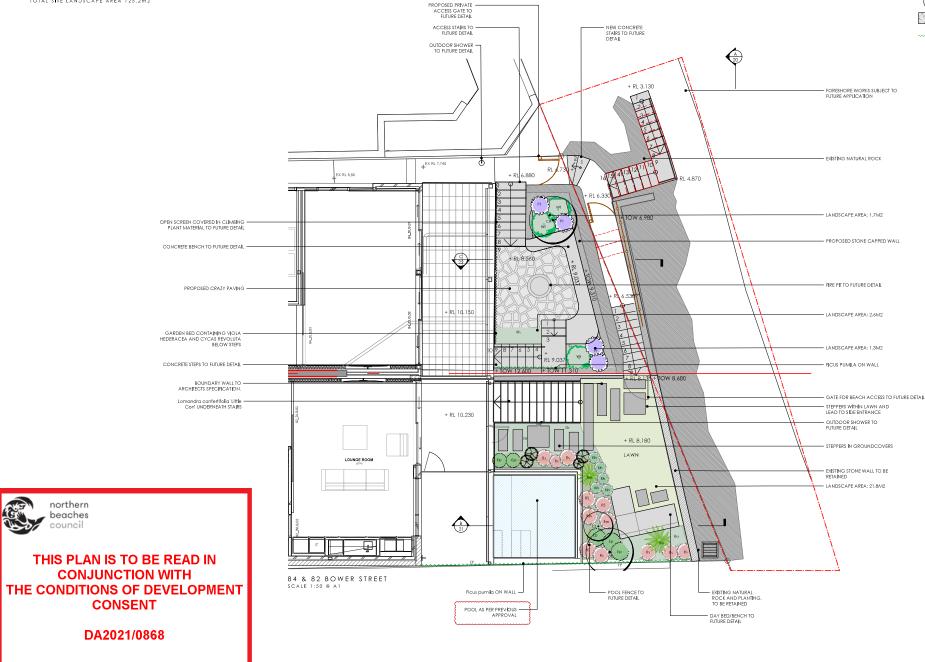


MBD MLST BE PRESENT ON-SITE FOR THE POSITIONING OF ALL PLANTS.


CONTACT MBD IF DISCREPANCIES OCCUR BETWEEN LANDSCAPE AND CONSULTANTS DOCUMENTS.
BUILDER TO CHECK AND VERIFY ALL DIMENSIONS ON SITE PRIOR TO CONSTRUCTION.

SOUTHERN ELEVATION

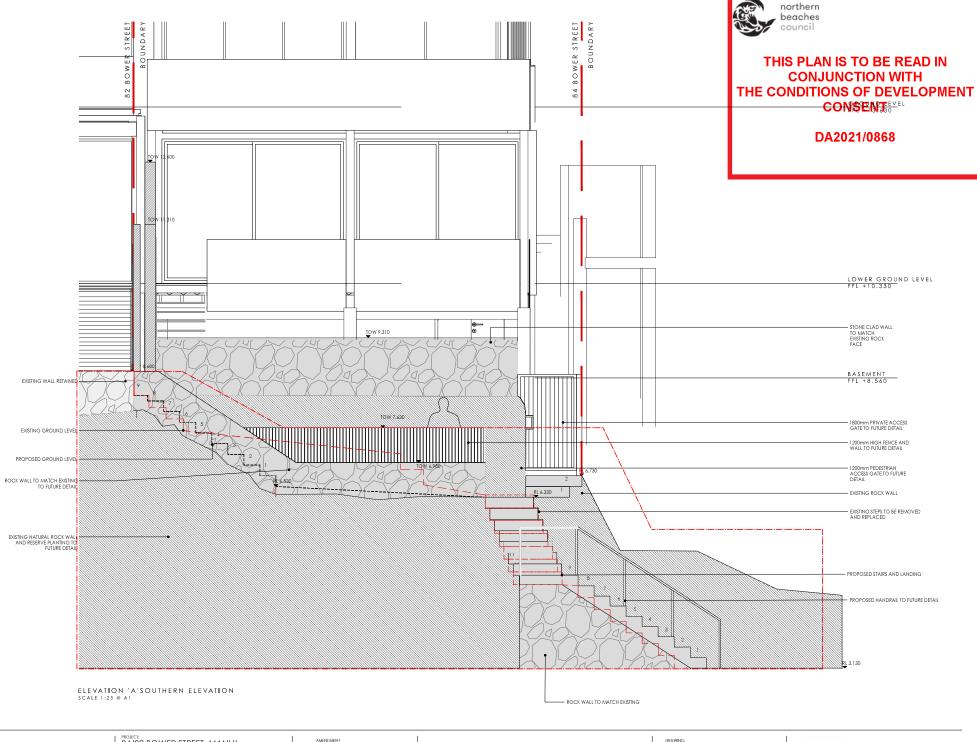DWG No: 428_DA_20 SCALE: AS NOTED DRAWN: SMM CHECKED: LMC ISSUE: A

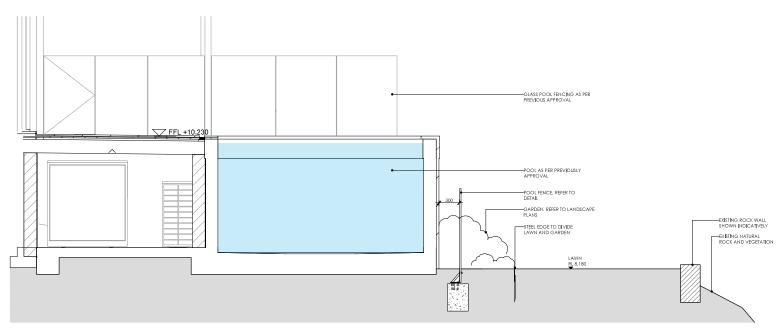

SECTION 'B' SCALE 1:20 @ A1

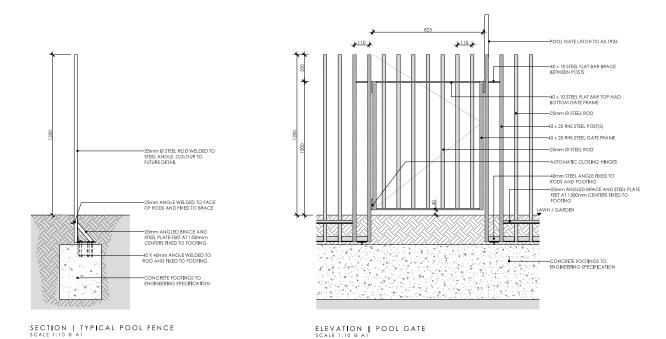



84/82 BOWER STREET, MANLY
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BUSHELL AND LAKE



MBD. MUST BE PRESENT ON-SITE FOR THE POSITIONING OF <u>ALL PLANTS.</u>
CONTACT WBD IF DISCREPANCES OCCUR BETWEEN LANDSCAPE AND CONSULTANTS DOCUMENTS.
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SECTIONS 1


DWG No: 428_DA_21 SCALE: AS NOTED DRAWN: CHECKED: LIMC BSUE: A THE GRAWING B COPYRIGHT

CONJUNCTION WITH
THE CONDITIONS OF DEVELOPMENT
CONSENT

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SECTION 'C' SCALE 1:25 @ A1



84/82 BOWER STREET, MANLY BUSHELL AND LAKE

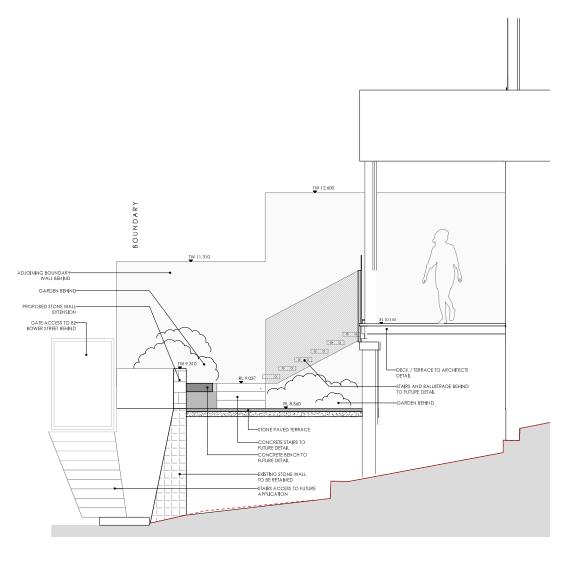MBD MUST BE PRESENT OH-SITE FOR THE POSITIONING OF <u>ALL PLANTS</u>.

CONTACT MBD IF DISCREPANCES OCCUR BETWEEN LANDSCAPE AND CONSULTANTS DOCUMENTS,
BUILDER TO CHECK AND VERIFY ALL DIMENSIONS ON SITE PRIOR TO CONSTRUCTION.

DRAWING: SECTIONS 2



THIS PLAN IS TO BE READ IN **CONJUNCTION WITH** THE CONDITIONS OF DEVELOPMENT CONSENT


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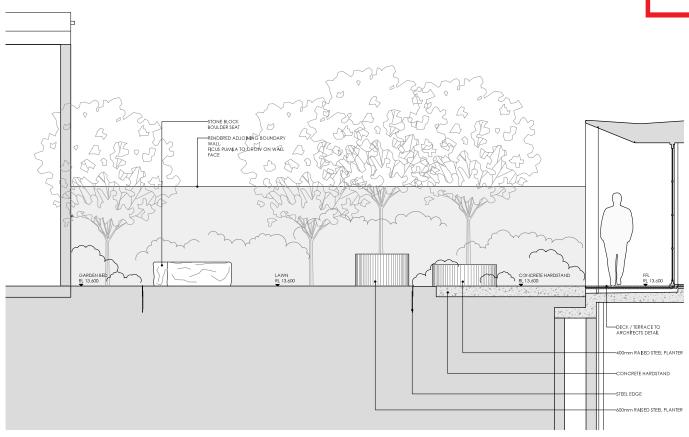


SECTION D SCALE 1:25 @ A1





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SECTION E SCALE 1:25 @ A1



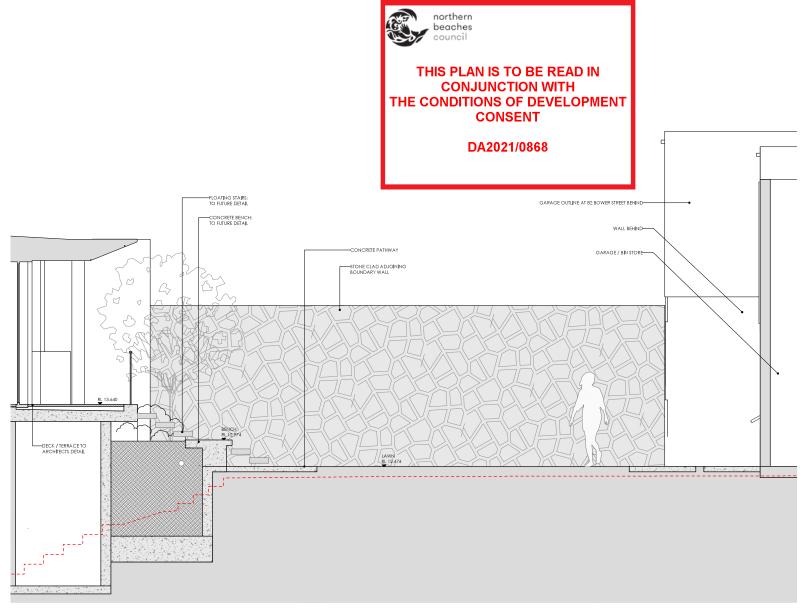

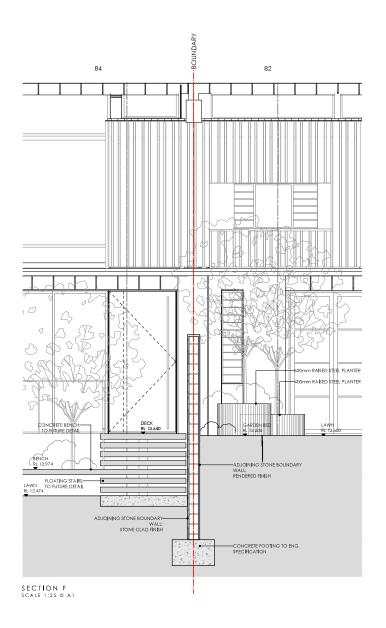


84/82 BOWER STREET, MANLY
CLENT:
BUSHELL AND LAKE

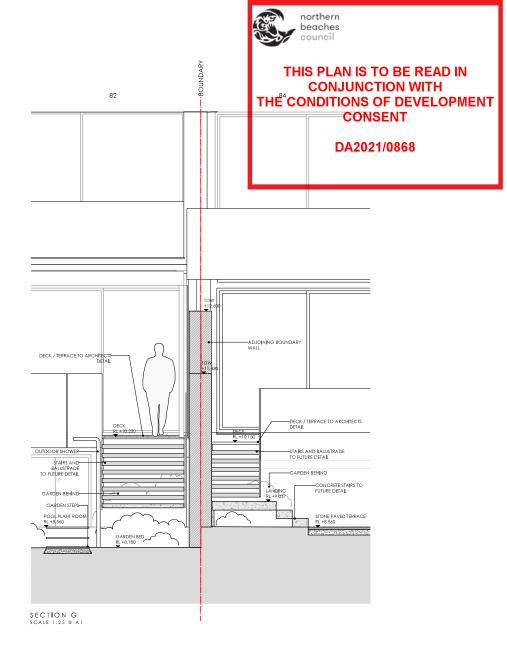




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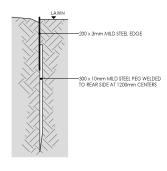
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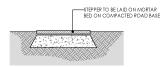
TYPICAL GARDEN SOIL PROFILE SCALE: 1:5 @ A1

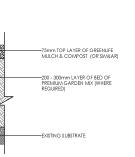


TYPICAL PLANTER SOIL PROFILE SCALE: 1:5 @ A1

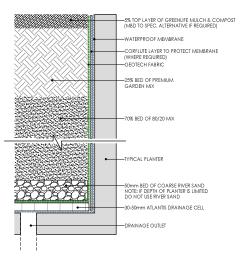


TYPICAL STEEL EDGE SCALE 1:5 @ A1




TYPICAL GARDEN STEPPER SCALE: 1:10 @ A1

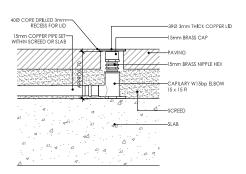

TYPICAL PAVING IRRIGATION CLOSED SCALE 1:2 @ A1

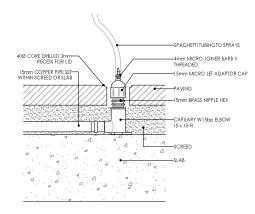

TYPICAL PAVING IRRIGATION OPEN SCALE 1:2 @ A1

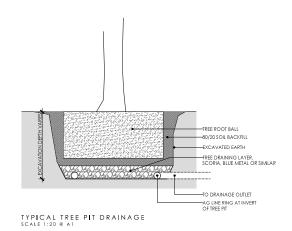

BUSHELL AND LAKE



GENERAL SPECIFICATION NOTES

1.0 Standards

- 1.1 Soils
- Site and imported topsoil: To AS 4419.
- Potting mixes: To AS 3743.
- Composts, soil conditioners and mulches: To AS 4454.

2.0 Products

2.1 Material

- Source: Provide topsoil, which contains organic matter, will support plant life and is free from stones, contaminants and weeds.
- Site: If available, provide material recovered from the site

- Supplier: Obtain turf from a specialist grower of cultivated turf.
- Quality: Provide turf of even thickness, free from weeds and other foreign matter.

General: Provide proprietary fertilisers, delivered to the site in sealed bags marked to show manufacturer or vendor, weight, fertiliser type, N:P:K ratio,

Plants

- · Health: Supply plants with foliage size, texture and colour at time of delivery consistent with the size, texture and colour shown in healthy specimens of the
- Vigour: Supply plants with extension growth consistent with that exhibited in vigorous specimens of the species nominated.
- Damage: Supply plants free from damage and from restricted habit due to growth in nursery rows.
- Pests and disease: Supply plants with foliage free from attack by pests or disease.

3.0 Execution

3.1 Preparation

Weed eradication

Herbicide: Eradicate weeds with a non-residual glyphosate herbicide in any of its registered formulae, at the recommended maximum rate.

Earth mounds

Placing: Place clean filling in layers approximately 150 mm thick compacted to 85% of the dry density ratio of the surrounding soil as determined by AS 1289.5.4.1. Minimise slumping and further internal packing down.

Construct changes in grade over a minimum width of 500 mm to smooth, gradual and rounded profiles with no distinct joint.

Maintain the natural ground level under the canopy.

Planting beds

- Excavated: Excavate to bring the subsoil to at least 300 mm below finished design levels. Shape the subsoil to fall to subsoil drains where applicable. Break up the subsoil to a further depth of 100 mm.
- Unexcayated: Remove weeds, roots, building rubbish and other debris, Bring the planting bed to 75 mm below finished design levels
- Services and roots: Do not disturb services or tree roots; if necessary cultivate these areas by hand.

Placing topsoil

- General: Spread the topsoil on the prepared subsoil and grade evenly, making the necessary allowances to permit the following:
- Required finished levels and contours may be achieved after light compaction
- Grassed areas may be finished flush with adjacent hard surfaces such as kerbs, paths and mowing strips.

Topsoil depths

- General: Spread topsoil to the following typical depths:
- Excavated planting areas: If using organic soil, 300 mm. Refer to typical soil profile detail.
- Irrigated grassed areas generally: 150 mm
- Irrigated grassed areas, heavy use (e.g. playing fields, playgrounds, and public parks): 200 mm.
- 3.2 Turfing

- Supply: Deliver the turf within 24 hours of cutting, and lay it within 36 hours of cutting. Prevent the turf from drying out between cutting and laying. If it is no laid within 36 hours of cutting, roll it out on a flat surface with the grass up, and water as necessary to maintain a good condition
- .. In stretcher pattern with the joints staggered and close butted.
- Parallel with the long sides of level areas, and with contours on slopes.
- To finish flush, after tamping, with adjacent finished surfaces of ground, paving edging, or grass seeded areas.
- Tampina: Lightly tamp to an even surface immediately after laving. Do not use a roller.
- Fertilising: Mix the fertiliser thoroughly into the topsoil before placing the turf. Apply lawn fertiliser at the completion of the first and last mowings, and at
- other times as required to maintain healthy grass cover.
- Watering: Water immediately after laying until the topsoil is moistened to its full depth. Continue watering to maintain moisture to this depth.
- Levels: Where levels have deviated from the design levels after placing and watering, lift turf and re-grade topsoil to achieve design levels.



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3.3 Plantina

- Individual plantings in grassed areas: Excavate a hole to twice the diameter of the root ball and at least 100 mm deeper than the root ball. Break up the base of the hole to a further depth of 100 mm, and loosen compacted sides of the hole to prevent confinement of root growth
- Watering: Thoroughly water the plants before planting, immediately after planting, and as required to maintain growth rates free of stress
- Placing: Remove the plant from the container with minimum disturbance to the root ball, ensure that the root ball is most and place it in its final position in the center of the hole and plumb, and with the top soil level of the plant root ball level with the finished surface of the surrounding soil.
- Fertilising plants: In planting beds and individual plantings, place fertiliser pellets around the plants at the time of planting.
- Backfilling: Backfill with topsoil mixture. Lightly tamp and water to eliminate air pockets.
- 3.4 Mulching

- General: Place mulch to the required depth, clear of plant stems, and rake to an even surface flush with the surrounding finished levels. Spread and roll mulch so that after settling, or after rolling, it is smooth and evenly graded between design surface levels sloped towards the base of plant stems in plantation beds, and not closer to the stem than 50 mm in the case of gravel mulches
- · Depths: Spread organic mulch to a depth of 75 mm, and gravel mulch to a depth of 50 mm
- 3.5 Stakes and ties

- Material: Hardwood, straight, free from knots or twists, pointed at one end.
- Installation: Drive stakes into the ground at least one third of their length, avoiding damage to the root system.

- General: Provide 50 mm hessian webbing ties fixed securely to the stakes, one tie at half the height of the main stem, others as necessary to stabilise the
- 3.6 Watering

Establishment

- Extent: Available soil moisture content of grass areas and garden beds to be monitored on a weekly basis using an approved moisture probe and water
 applied on a demand basis. Readings should be taken at a depth of 200-300mm.
- All grass areas and garden beds should be maintained within a range of 50-80% available soil moisture. Under no circumstance should areas under irrigation fall below a level of 30% available soil moisture.
- No visible signs of wilting of leaves or stems, with all plants fully turgid at all times.
- No sign of over-watering such as constantly wet soil, brown leaf margins, stem rot or brown spots on foliage.
- 3.7 Completion

Cleaning

- Stakes and ties: Remove those no longer required at the end of the planting establishment period.
- Temporary fences: Remove temporary protective fences at the end of the planting establishment period.

4.0 Establishment & defects liability

4.1 Establishment

All landscaping works will have an establishment period of 26 weeks in which the subcontractor will be responsible for the maintenance and upkeep of the contracted scope, unless otherwise noted in the project documentation. If applicable refer to the project manager / builder for confirmation.

4.2 Defects Liability Period

All landscaping works will be subject to a defects liability period of 52 weeks, commencing from the date of Practical Completion, unless otherwise noted in the project documentation. If applicable refer to the project manager / builder for confirmation



84/82 BOWER STREET, MANLY

BUSHELL AND LAKE

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GENERAL SPECIFICATION

DWG No: 428 DA 50 DRAWN: SMM

CHECKED: LMC