PROPOSED ALTERATIONS AND ADDITIONS

(Extend existing Deck,insert Glass Sliding Doors where current Window exists,New Roof over proposed Deck and Privacy Screens)

AT 10 GRANDVIEW DRIVE NEWPORT

LOT 96 DP. 16029

BASIX[°]Certificate

Building Sustainability Index www.basix.nsw.gov.au


Alterations and Additions

Certificate number: A236622_02

This certificate confirms that the proposed development will meet the NSW government's requirements for sustainability, if it is built in accordance with the commitments set out below. Terms used in this certificate, or in the commitments, have the meaning given by the document entitled "BASIX Alterations and Additions Definitions" dated 06/10/2017 published by the Department. This document is available at www.basix.nsw.gov.au

Secretary Date of issue: Wednesday, 27, March 2019 To be valid, this certificate must be lodged within 3 months of the date of issue.



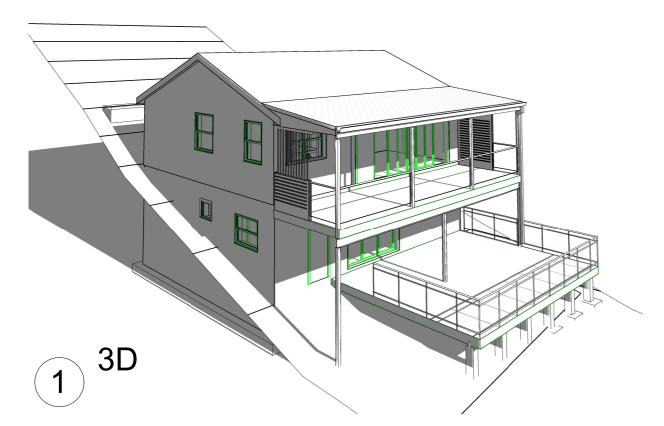

A3 A10TS A10SPA A100 A101 A102 A103 A104 **A4**

project

of

escription

0

A1NP

ROBERT PAUL Dip.Arch.Tech	BUILDING DESIGNERS AUSTRALIA	No.	Description	Date	PROPOSED ALTERATIONS 10 GRANDVIEW DRIVE NEWPORT 2106	Title
					LOT: 96 DP: 16029	Project numb
				_	GRAHAME AND KIM WALLING	Date
						Drawn by
ABN16 932 894 631						Checked by
				1		I

Project address				
Project name	Proposed Alterations and Additions_02			
Street address	10 Grandview Drive Newport 2106			
Local Government Area	Pittwater Council			
Plan type and number	Deposited Plan 16029			
Lot number	96			
Section number	0			
Project type				
Dwelling type	Separate dwelling house			
Type of alteration and addition	My renovation work is valued at \$50,000 or more, and does not include a pool (and/or spa).			

Certificate Prepared by (please complete before submitting to Council or PCA)

Name / Company Name: Robert Paul T/A open plan designz

ABN (if applicable): 16932894631

DRAWING LIST


- TS Title Sheet
- A10SPA Site Plan & Analysis
 - 0 Floorplans
 - 1 Elevations North & South 2 Elevations East & West
 - 3 Sections
 - A Roof Plan

NP Notification Plans Statement of Environmental Effects Basix Statement Development Application and Docs

Sheet


		iew NP	oer 10 G	nber
	A10TS	ue Date		
		RP		
		hecker		у
1				

24/05/2019 2:59:01 PM

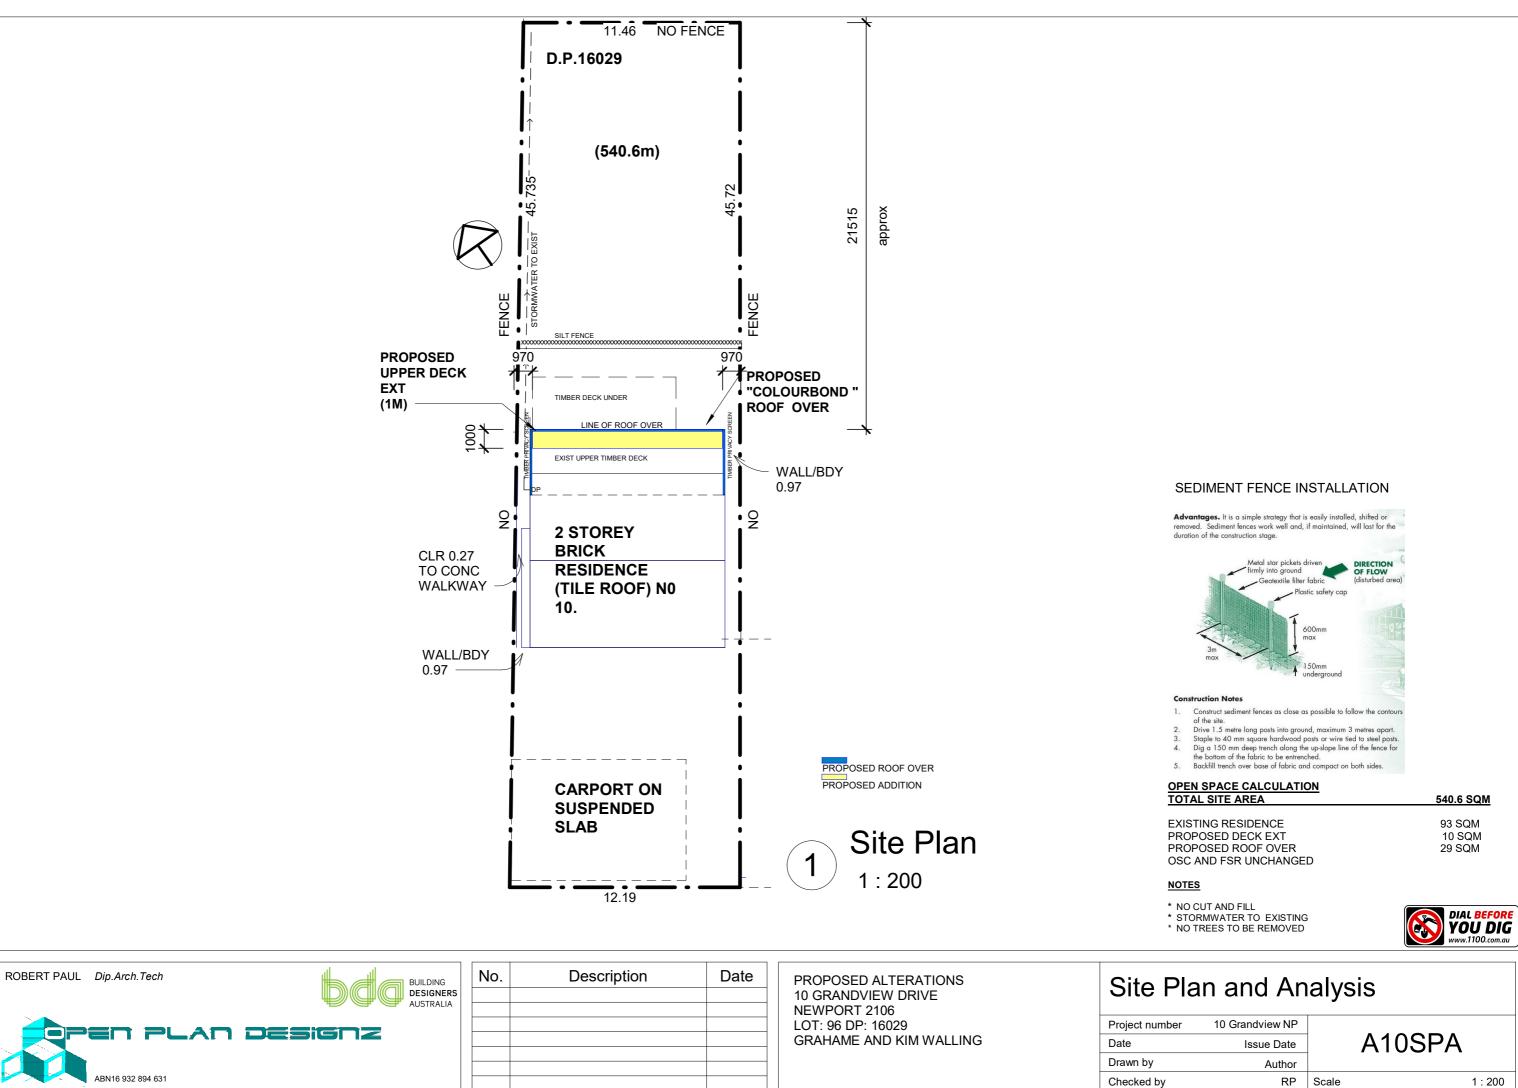

nber	10 Grandview NP	
	Issue Date	
	Author	
у	RP	Scale

24/05/2019 2:51:58 PM

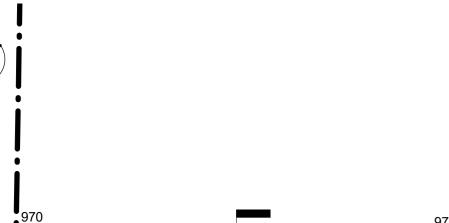

970 970 10060 "COLOURBOND" ROOF OVER FLUSH WITH DECK EDGE SCREEN . POSTS/BEAMS TO ENG DETAIL PRIVACY . REPLACE EXISTING DECK ABER TIMBER AND ADD 1M EXT . REMOVE EXISTING WINDOW AND REPLACE WITH SLIDING GLASS DOORS IP 970 \mathcal{A} A103 PROPOSED ROOF OVER E....Eave PROPOSED ADDITION

1000

1800

Fixtures and systems

Lighting

The applicant must ensure a minimum of 40% of new or altered light fixtures are fitted with fluorescent, compact fluorescent, light-emitting-diode (LED) lamps.

Glazing requirements

Windows and glazed doors

The applicant must install the windows, glazed doors and shading devices, in accordance with the specifications listed in the t Relevant overshadowing specifications must be satisfied for each window and glazed door.

The following requirements must also be satisfied in relation to each window and glazed door:

Each window or glazed door with standard aluminium or timber frames and single clear or toned glass may either match the de have a U-value and a Solar Heat Gain Coefficient (SHGC) no greater than that listed in the table below. Total system U-values must be calculated in accordance with National Fenestration Rating Council (NFRC) conditions.

For projections described in millimetres, the leading edge of each eave, pergola, verandah, balcony or awning must be no mor above the head of the window or glazed door and no more than 2400 mm above the sill.

Windows and glazed doors glazing requirements

Window / door Orientation Orientatio	Orientation	Area of	Oversha	dowing	Shading device	Frame and glass type
		glass inc. frame (m2)	Height (m)	Distance (m)		
W1	NW	9	0	0	awning (fixed) >=900 mm	standard aluminium, single o U-value: 7.63, SHGC: 0.75)

Legend

1

In these commitments, "applicant" means the person carrying out the development.

Commitments identified with a "</" in the "Show on DA plans" column must be shown on the plans accompanying the development application for the proposed development (if a development application is to be lodged for the proposed development).

Commitments identified with a "" in the "Show on CC/CDC plans & specs" column must be shown in the plans and specifications accompanying the application for a construction certificate / complying development certificate for the proposed development.

Commitments identified with a "" in the "Certifier check" column must be certified by a certifying authority as having been fulfilled, before a final occupation certificate for the development may be issued.

SHEDULE OF FINISHES:

Posts and Beams	Steel Finish to owners spec
Rail	Glass SS Posts and top rail
Ceiling	Fibreboard, "Weathertex" or similar(Painted finish)
Rofing	"Colourbond" Medium density to owners spec
Guttering and Downpipes	"Colourbond" to match Roofing
Timber decking	Stained and protct coating,"Cabots"," Intergrain" or similar

Ground Floor Level


ROBERT PAUL Dip.Arch.Tech	BOILDING		D) (C) (C) DESIGNERS		1	PROPOSED ALTERATIONS 10 GRANDVIEW DRIVE NEWPORT 2106	Floorplans				
					LOT: 96 DP: 16029	Project number	10 Grandview NP				
					GRAHAME AND KIM WALLING	Date	Issue Date		A100		
						Drawn by	RP				
ABN16 932 894 631						Checked by	RP	Scale		1 : 100	

	Show on DA Plans	Show on CC/CDC Plans & specs	Certifier Check	
t, or		~	V	


	Show on DA Plans	Show on CC/CDC Plans & specs	Certifier Check
table below.	~	~	~
		~	1
description, or, es and SHGCs		~	~
ore than 500 mm	~	~	~
clear, (or			

OPEN SPACE CALCULATION

TOTAL SITE AREA FRONT YARD REAR YARD SIDE YARD WEST TOTAL arPERCENTAGE OPEN SPACE 539.6 SQM 130 SQM 185 SQM 36 SQM 351 SQM 65.04%

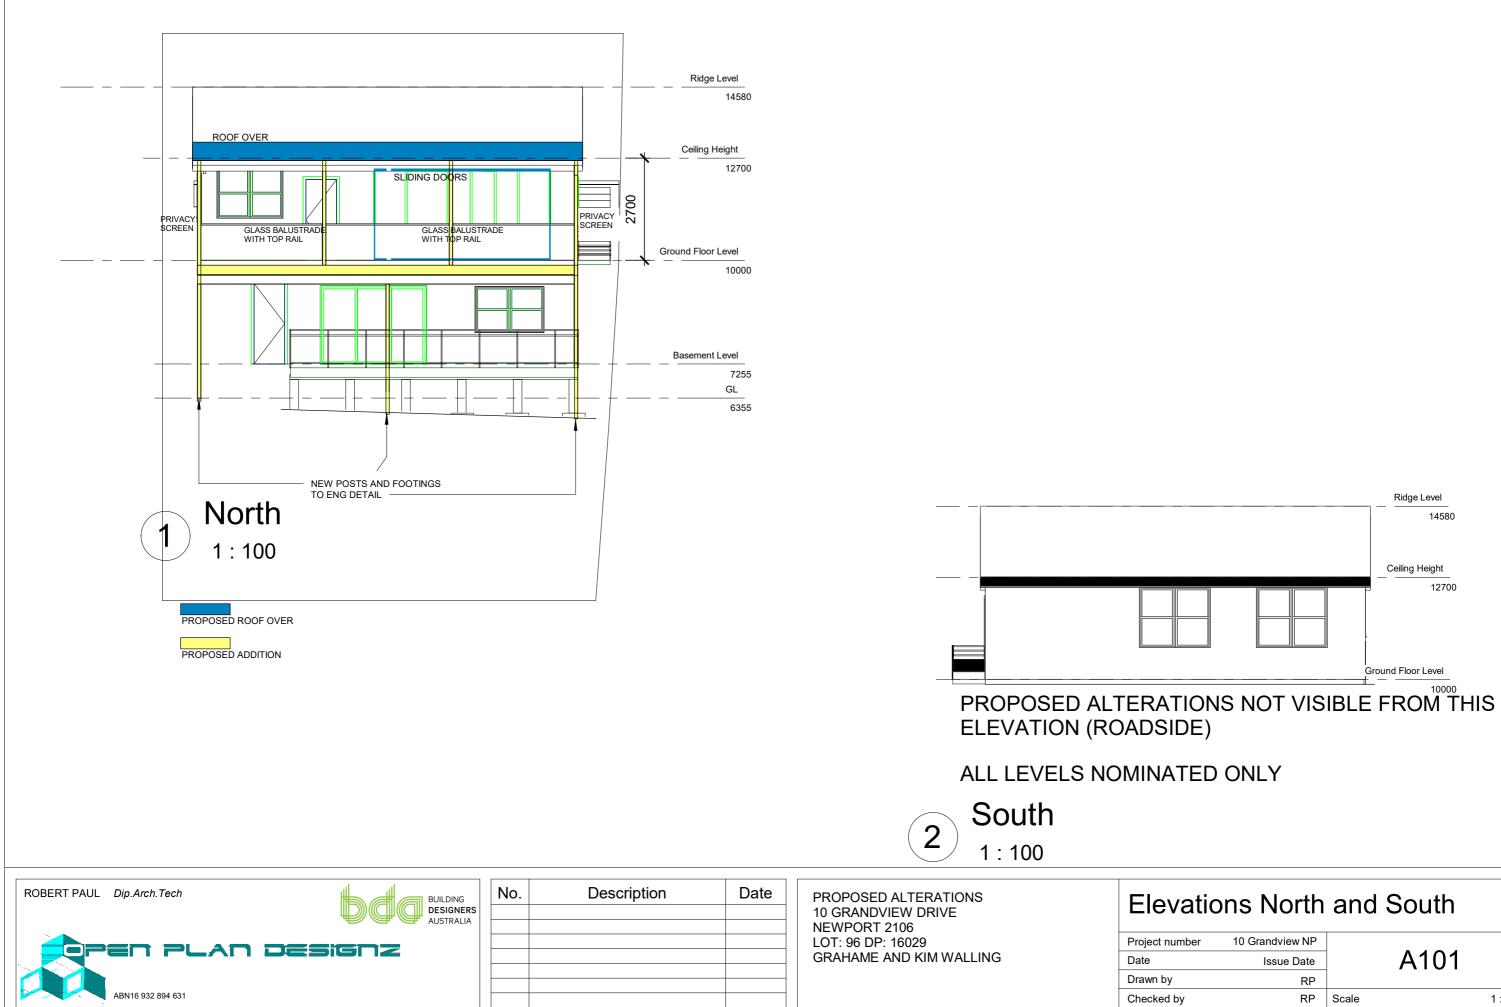

ations North and South										
nber	10 Grandview NP									
	Issue Date	A101								
	RP									
y	RP	Scale	1 : 100							

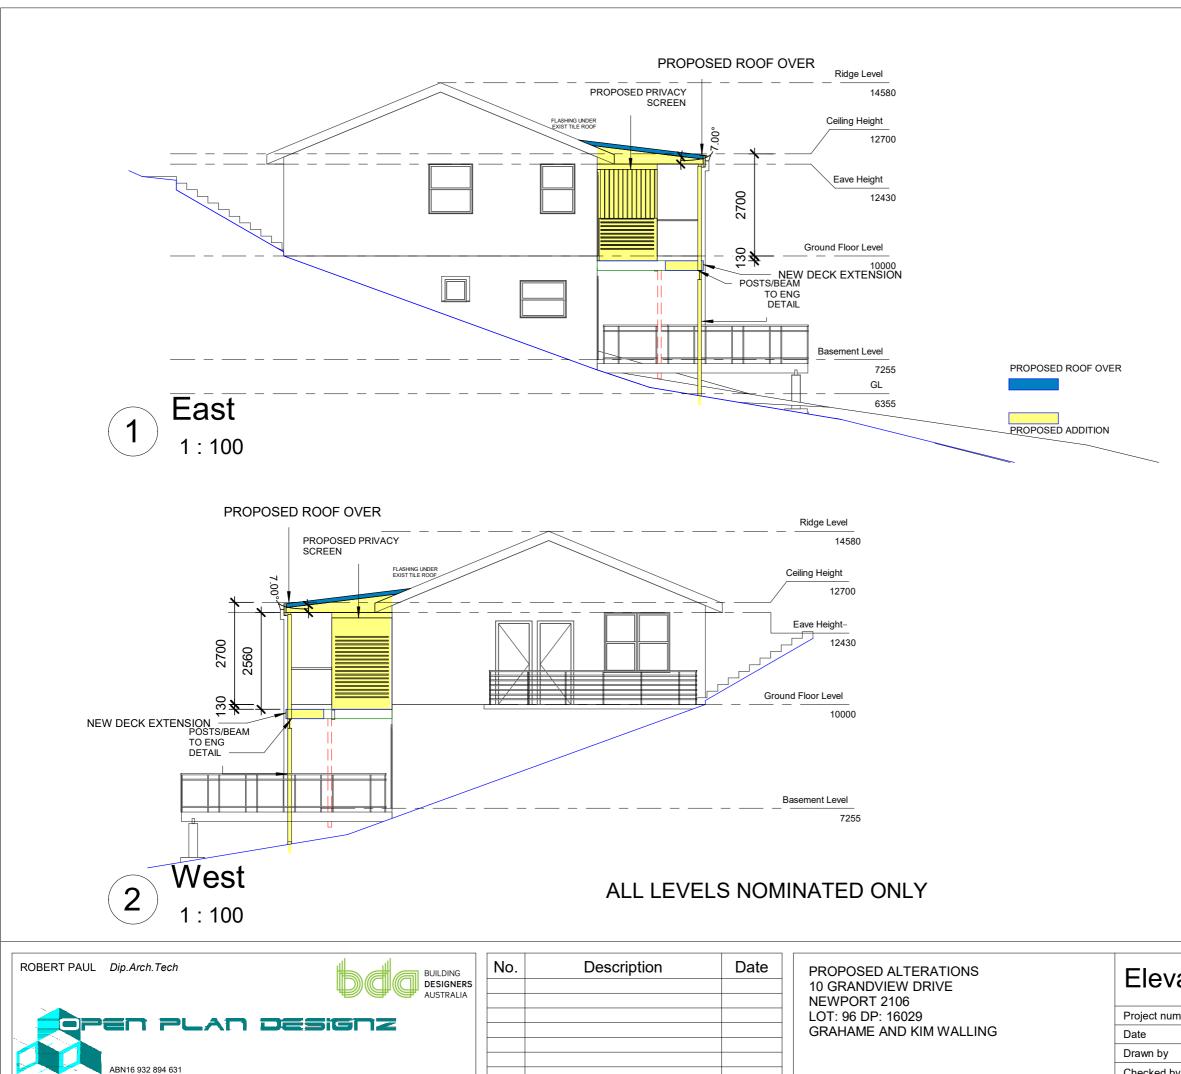


Elevations East and West

Project number	10 Grandview NP	
Date	Issue Date	
Drawn by	RP	
Checked by	RP	Scale



1 : 100

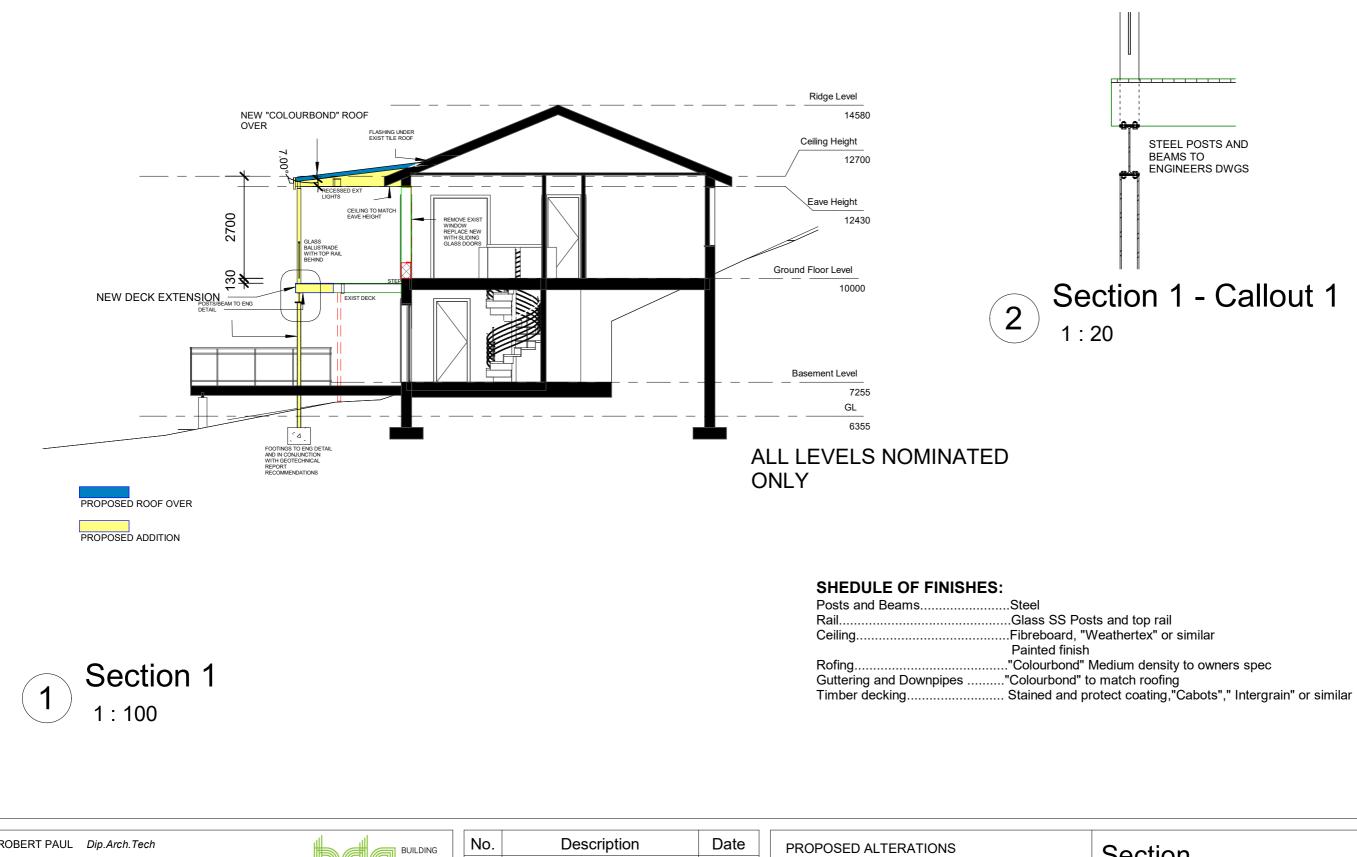


ROBERT PAUL Dip.Arch.Tech	BUILDING DESIGNERS AUSTRALIA	No.	Description	Date	PROPOSED ALTERATIONS 10 GRANDVIEW DRIVE NEWPORT 2106	Section	1		
	SIGNZ				LOT: 96 DP: 16029	Project number	10 Grandview NP		A 4 0 0
					GRAHAME AND KIM WALLING	Date	Issue Date		A103
						Drawn by	RP		
ABN16 932 894 631						Checked by	RP	Scale	As indicated

STEEL POSTS AND BEAMS TO ENGINEERS DWGS

Section 1 - Callout 1


24/05/2019 3:13:28 PM

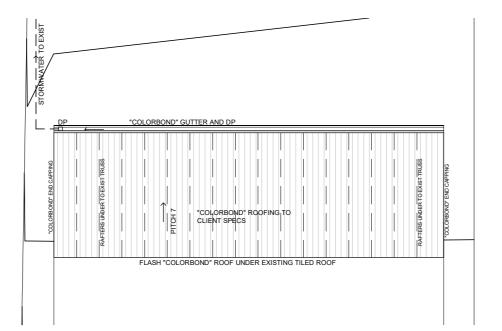

ROOF NOTES

WIND CLASSIFICATION **REGION A** CATAGORY 3-TC SHEILDING FACTOR PS* TOPOGRAPHY EFFECT T2* WIND CLASSIFICATION N2*

*SUBJECTIVE

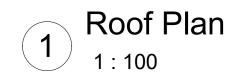

ROBERT PAUL Dip.Arch.Tech	DOILDING	No.	Description Date	Roof Plan
	AUSTRALIA			
				Project number 10 Grandview NP
				Date Issue Date A104
				Drawn by Author
ABN16 932 894 631				Checked by Checker Scale 1:10

NOTE: EXTRA FIXINGS MAY BE REQUIRED ON METAL AND TIE DOWNS ON RAFTERS TO EXISTING TRUSS, AS ROOF IS ON EXPOSED TOPOGRAPHY AND MAY BE TO SUBJECT TO SIGNIFICANT UPDRAFT ON OCCASION.

"COLORBOND" CUSTOM ORB OR PROFILE TO CLIENTS SPEC FIX AT NOMINAL PITCH. "COLORBOND" GUTTER AND DOWNPIPES AND SIDE FLASHING AT SAME COLOUR AS ROOF. FLASH "COLORBOND" ROOF UNDER EXISTING TILED ROOF. CONNECT ROOFING TO RAFTERS WITH APPROPRIATE FIXINGS AND SPACING TO SPECIFICATIONS.*

24/05/2019 3:16:03 PM

3D West	

ROBERT PAUL Dip.Arch.Tech	No.	Description	Date	PROPOSED ALTERATIONS 10 GRANDVIEW DRIVE NEWPORT 2106 LOT: 96 DP: 16029 GRAHAME AND KIM WALLING	30	3D	
AUSTRALIA					50		
					Project number	10 Grandview NP	
					Date	Issue Date	
					Drawn by	RP	
ABN16 932 894 631					Checked by	Checker	Scale

≥
E B
3:19:58
24/05/2019 :
24/0

