

e: operations@actionplans.com.au

w: www.actionplans.com.au

DEVELOPEMENT APPLICATION

_		
SHEET NUMBER	SHEET NAME	DATE PUBLISHED
DA00	COVER	17-Jul-19
DA01	SITE ANALYSIS	17-Jul-19
DA02	SITE / ROOF / SEDIMENT EROSION / WASTE MANA	17-Jul-19
DA03	EXISTING GROUND FLOOR PLAN	17-Jul-19
DA04	PROPOSED GROUND FLOOR PLAN	17-Jul-19
DA05	FIRST FLOOR PLAN	17-Jul-19
DA06	NORTH / EAST ELEVATION	17-Jul-19
DA07	SOUTH / WEST ELEVATION	17-Jul-19
DA08	LONG / CROSS SECTION	17-Jul-19
DA09	AREA CALCULATIONS / SAMPLE BOARD	17-Jul-19
DA10	WINTER SOLSTICE 9 AM	17-Jul-19
DA11	WINTER SOLSTICE 12 PM	17-Jul-19
DA12	WINTER SOLSTICE 3 PM	17-Jul-19
DA13	BASIX COMMITMENTS	17-Jul-19

ITEM DETAILS	DEVELOPMENT APPLICATION			
ADDRESS	5 MULAWA PLACE, FRENCHS FOREST NSW 2086			
LOT & DP/SP	LOT 6 DP 224872			
COUNCIL	NORTHERN BEACHS COUNCIL (WARRINGAH)			
SITE AREA	695.553m²			
FRONTAGE	6.945m			
CONTROLS	PERMISSIBLE / REQUIRED	EXISTING	PROPOSED	COMPLIANCE
150	m / m² / %	m / m² / %	m / m² / %	
LEP	DO LOW DENCITY DECIDENTIAL	Do	DO.	1/50
LAND ZONING	R2 – LOW DENSITY RESIDENTIAL	R2	R2	YES
MINIMUM LOT SIZE	600m²	695.553m²	UNCHANGED	YES
FLOOR SPACE RATIO	NOT IDENTIFIED	N/A	N/A	N/A
MAXIMUM BUILDING HEIGHT	8.5m	8.4m	UNCHANGED	YES
HAZARDS	NOT IDENTIFIED			
ACID SULFATE SOILS	NOT IDENTIFIED	N/A	N/A	N/A
FLOOD PLANNING	NOT IDENTIFIED	N/A	N/A	N/A
DEVELOPMENT ON SLOPING LAND	LAND SLIP AREA B – FLANKING SLOPES 5° TO 25°	N/A	N/A	YES
COASTAL HAZARDS	NOT IDENTIFIED	N/A	N/A	N/A
HIGH/MED/LOW FLOOD RISK PRECINCT	NOT IDENTIFIED	N/A	N/A	N/A
NATIVE VEGETATION	IDENTIFIED	N/A	N/A	YES
WILDLIFRE CORRIDORS	IDENTIFIED	N/A	N/A	YES
WATERWAYS AND RIPARIAN LAND	IDENTIFIED	N/A	N/A	YES
THREATEND HIGH CONSERVATION HABITAT	IDENTIFIED	N/A	N/A	YES
LAND ADJOINING PUBLIC OPEN SPACE	NOT IDENTIFIED	N/A	N/A	N/A
DCP				
WALL HEIGHT	7.2m	6.1m	UNCHANGED	YES
NUMBER OF STOREYS	NOT IDENTIFIED	N/A	N/A	N/A
SIDE BOUNDARY ENVELOPE	4m @ 45°	N/A	UNCHANGED	YES
SIDE BOUNDARY SETBACKS	0.9m	N: 2.480m S:0.150m	UNCHANGED	YES NO
FRONT BOUNDARY SETBACK	6.5m	9.84m	UNCHANGED	YES
REAR BOUNDARY SETBACK	6.0m	8.1m	UNCHANGED	YES
LANDSCAPE OPEN SPACE	40% (278.22m²)	278.86m²	UNCHANGED	YES
PRIVATE OPEN SPACE	60m²	120m²	UNCHANGED	YES

5 MULAWA PLACE, FRENCHS FOREST NSW 2086

LOCATION VIEW



NCC & AS COMPLIANCES SPECIFICATIONS

- EARTHWORKS - PART 3.1.1 OF NCC

- EARTH RETAINING STRUCTURES - PART 3.1.2 OF NCC

 DRAINAGE - PART 3.1.3 OF NCC - TERMITE-RISK MANAGEMENT - PART 3.1.4 OF NCC

- FOOTINGS & SLAB - PART 3.2 OF NCC INCLUDING AS2870

- MASONRY - PART 3.3 OF NCC INCLUDING AS3700

- FRAMING - PART 3.4 OF NCC

- SUB FLOOR VENTILATION - PART 3.4.1 OF NCC

- ROOF CLADDING AND WALL-CLADDING - PART 3.5 OF NCC

- GLAZING - PART 3.6 OF NCC INCLUDING AS1288

- FIRE SAFETY - PART 3.7 OF NCC

- FIRE SEPERATION - PART 3.7.2 OF NCC

- FIRE PROTECTION OF SEPERATING WALLS AND FLOORS- PART 3.7.3 OF NCC

- SMOKE ALARMS - PART 3.7.5 OF NCC

- WET AREAS AND EXTERNAL WATERPROOFING - PART 3.8.1 OF NCC

- ROOM HEIGHTS - PART 3.8.2 OF NCC

- FACILITIES - PART 3.8.3 OF NCC

- LIGHT - PART 3.8.4 OF NCC

- VENTILATION - PART 3.8.5 OF NCC

- SOUND INSULATION - PART 3.8.6 OF NCC

- STAIRWAYAND RAMP CONSTRUCTION - PART 3.9.1 OF NCC

- BARRIERS AND HANDRAILS - PART 3.9.2 OF NCC

- SWIMMING POOLS - PART 3.10.1 OF NCC

- CONSTRUCTION IN BUSHFIRE PRONE AREAS - PART 3.10.5 OF NCC

- FENCING & OTHER PROVISIONS - REGS & AS1926

- DEMOLITION WORKS - AS2601-1991 THE DEMOLITION OF STRUCTURES - ALL WATERPROOF MEMBRANES TO COMPLY WITH WITH AS 3740-2010

- ALL PLUMBING & DRAINAGE WORK TO COMPLY WITH AS 3500

- SITE CLASSIFICATION AS TO AS 2870

- ALL PLASTERBOARD WORK TO COMPLY WITH AS 2588-1998

- ALL STRUCTURAL STEEL WORK TO COMPLY WITH AS 4100 & AS 1554

- ALL CONCRETE WORK TO COMPLY WITH AS 3600

- ALL ROOF SHEETING WORK TO COMPLY WITH AS 1562-1992


- ALL SKYLIGHTS TO COMPLY WITH WITH AS 4285-2007 - ALL CERAMIC TILING TO COMPLY WITH AS 3958.1-2007 & 3958.2-1992

- ALL GLAZING ASSEMBLIES TO COMPLY WITH AS2047 & 1288

- ALL TIMBER RETAINING WALLS ARE TO COMPLY WITH AS 1720.1-2010,

AS 1720.2-2006, AS 1720.4-2006, AS 1170.1-1989 & AS 1170.4-2007 - ALL RETAINING WALLS ARE TO COMPLY WITH 3700 - 2011 & AS 3600 -2009

- ALL CONSTRUCTION TO COMPLY TO AS3959- 2009

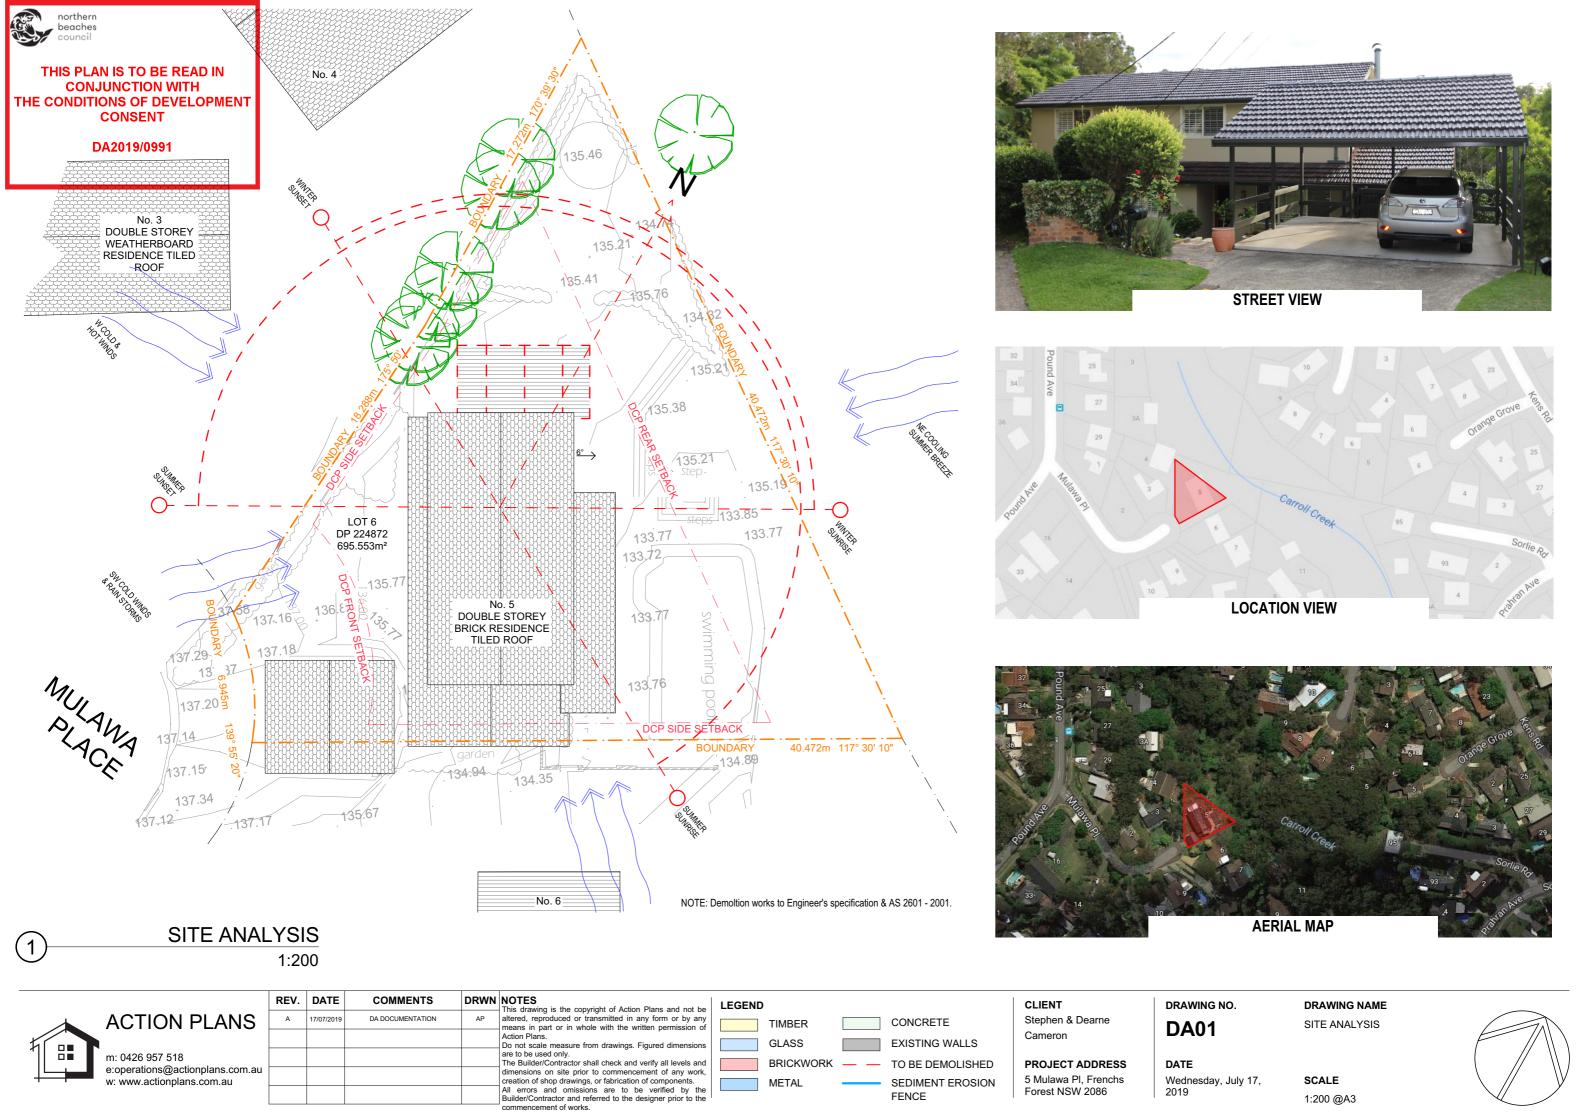

northern beaches THIS PLAN IS TO BE READ IN No. 4 **CONJUNCTION WITH** THE CONDITIONS OF DEVELOPMENT **CONSENT** DA2019/0991 **DOUBLE STOREY** WEATHERBOARD 135.21 RESIDENCE TILED ROOF 435,7 $\stackrel{6^{\circ}}{\longrightarrow}$ 135.21 LOT 6 DP 224872 133. 133.77 695.553m² 133,72 .135.77 DOUBLE STOREY 133.77 BRICK RESIDENCE TILED ROOF 133.76 137.20 DCP SIDE SETBACK 40.472m 117° 30' 10" 134.89 134.94 134.35 137.34 NOTE: Proposed stormwater to connect into the existing stormwater system. SITE / ROOF / SEDIMENT EROSION / WASTE MANAGEMENT / STORMWATER CONCEPT PLAN

1:200

DATE COMMENTS DRWN NOTES This drawing is the copyright of Action Plans and not altered, reproduced or transmitted in any form or by a **ACTION PLANS** DA DOCUMENTATION means in part or in whole with the written permission Do not scale measure from drawings. Figured dimensi are to be used only.

The Builder/Contractor shall check and verify all levels m: 0426 957 518 e:operations@actionplans.com.au dimensions on site prior to commencement of any w creation of shop drawings, or fabrication of components. All errors and omissions are to be verified by Builder/Contractor and referred to the designer prior to w: www.actionplans.com.au

t be	LEGEND		
any n of		TIMBER	CONCRETE
ions		GLASS	EXISTING WALLS
and ork,		BRICKWORK	 TO BE DEMOLISHED
the		METAL	SEDIMENT EROSION FENCE

CLIENT

Stephen & Dearne Cameron

PROJECT ADDRESS

5 Mulawa Pl. Frenchs Forest NSW 2086

DRAWING NO.

DA02

DATE

Wednesday, July 17, 2019

DISTURBED AREA

DRAWING NAME

SITE / ROOF / SEDIMENT EROSION / WASTE MANAGEMENT / STORMWATER CONCEPT PLAN

SCALE

DUST CONTROL :

SEDIMENT NOTE:

SEDIMENT FENCE AREA.

SYSTEM OR WATERWAYS.

STOCKPILES:

PERMISSION.

OVER STOCKPILES.

AROUND STOCKPILES.

GUTTER PROTECTION:

SITE FOR DISPOSAL.

 $_{3m}MAX$

DETAIL OF

SEDIMENT FENCE

TO REDUCE DUST GENERATED BY WIND ACTION, THE REMOVAL OF THE TOP SOIL IS TO BE MINIMISED. TO PREVENT DUST GENERATION, WATERING DOWN OF

THE SITE, ESPECIALLY DURING THE MOVEMENT OF

METAL AND RESTRICT ALL VEHICLE MOVEMENTS WITHIN THE SITE TO A MINIMUM. ENSURE WIND

MACHINERY IS REQUIRED. WHERE EXCAVATING INTO ROCK, KEEP THE SURFACE MOIST TO MINIMISE DUST.

CONSTRUCT A GRAVEL ENTRY/EXIT POINT USING BLUE

BREAKS, SUCH AS EXISTING FENCES ARE MAINTAINED DURING THE CONSTRUCTION PHASE UNTIL NEW LANDSCAPING IS PROVIDED OR REINSTATED. PREVENT DUST BY COVERING STOCKPILES

1. ALL EROSION AND SEDIMENT CONTROL MEASURES

TO BE INSPECTED AND MAINTAINED DAILY BY THE SITE

2. MINIMISE DISTURBED AREAS, REMOVE EXCESS SOIL FROM EXCAVATEDAREA AS SOON AS POSSIBLE.

4. DRAINAGE TO BE CONNECTED TO STORMWATER AS SOON AS POSSIBLE. IF STORED ON SITE, IT MUST BE FILTERED BEFORE RELEASING INTO STORMWATER

3. ALL MATERIAL STOCKPILE TO BE CLEAR FROM DRAINS, GUTTERS AND FOOTPATHS, OR WITHIN

5. ROADS AND FOOTPATHS TO BE SWEPT DAILY.

ALL STOCKPILES ARE TO BE KEPT ON-SITE WHERE POSSIBLE. ANY MATERIALS PLACED ON THE

FOOTPATHS OR NATURE STRIPS REQUIRE COUNCIL'S

ALL STOCKPILES ARE TO BE PLACED AWAY FROM THE DRAINAGE LINES AND STREET GUTTERS. IT IS BEST TO LOCATE THESE ON THE HIGHEST PART OF THE SITE IF POSSIBLE. PLACE WATERPROOF COVERING

IF REQUIRED PROVIDE DIVERSION DRAIN & BANK

PROVIDE PROTECTION TO DOWNHILL GRATE IN

GUTTER BY MEANS OF SAND BAGS OR BLUE METAL WRAPPED IN GEOTEXTILE FABRIC. WHEN SOIL OR

SAND BUILDS UP AROUND THIS SEDIMENT BARRIER.

THE MATERIAL SHOULD BE RELOCATED BACK TO THE

POSTS DRIVEN 0.6m INTO


GROUND


UNDISTURBED


WIRE OR STEEL MESH (WHERE REQUIRED)

1:200 @A3



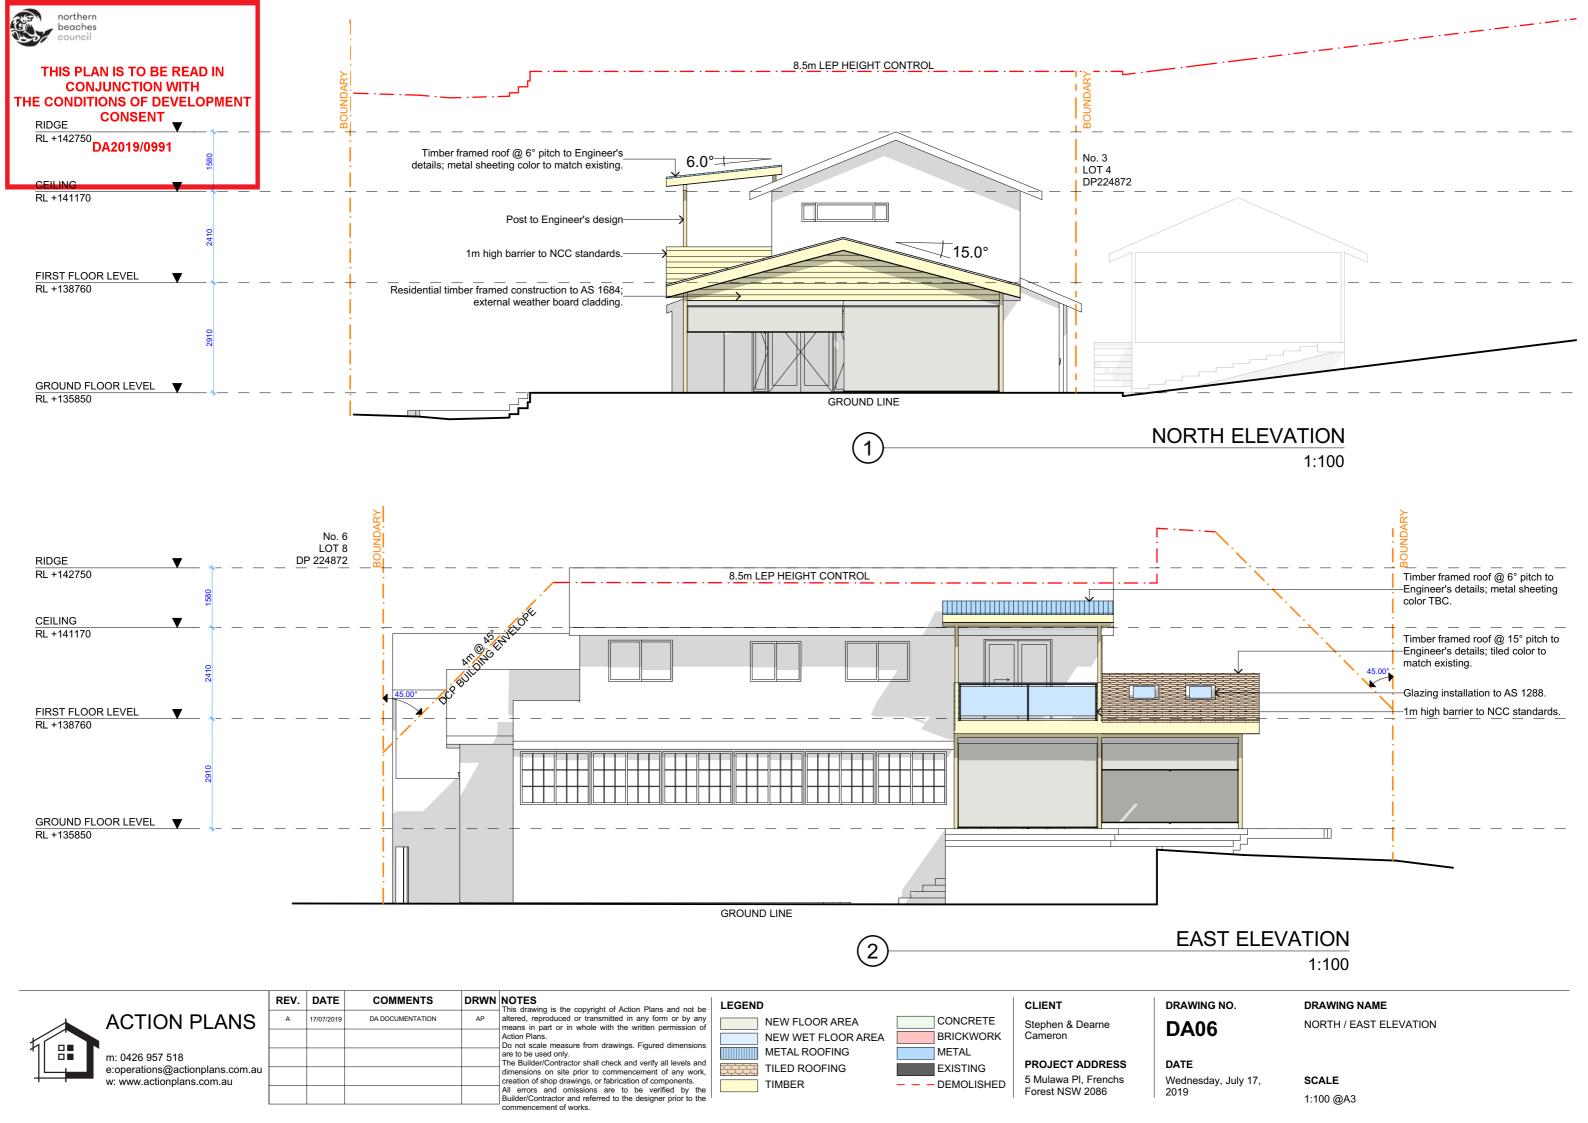

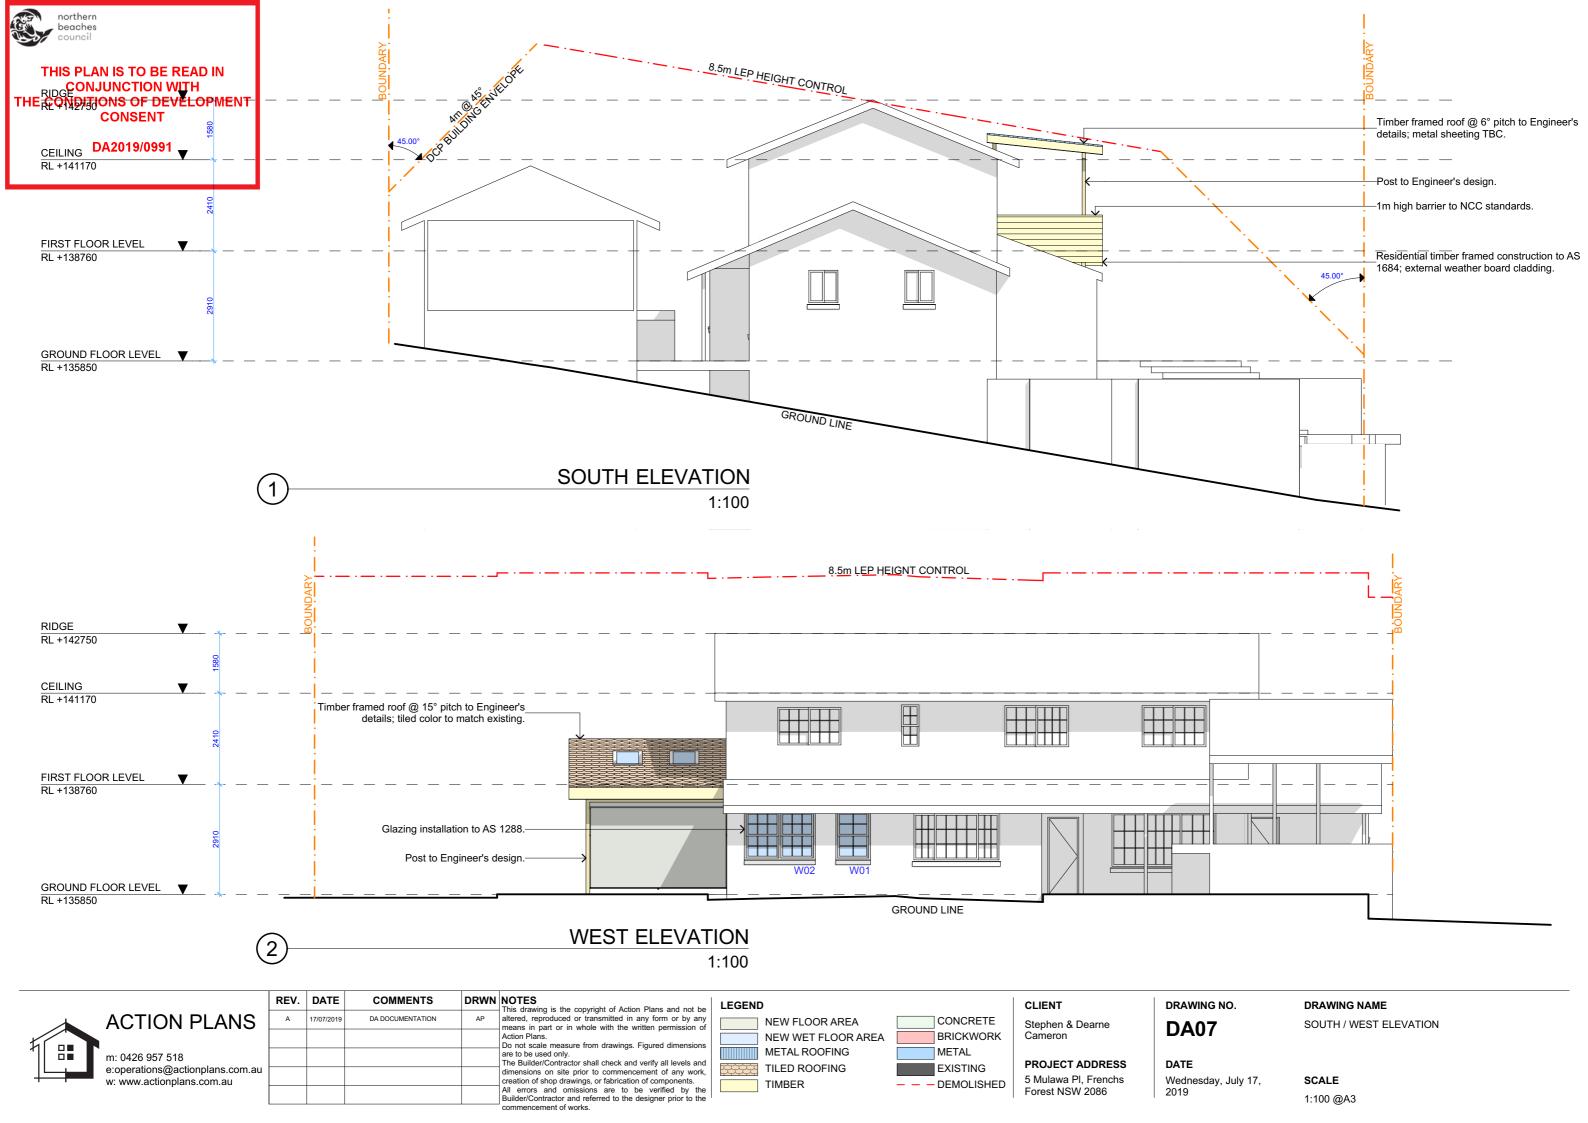

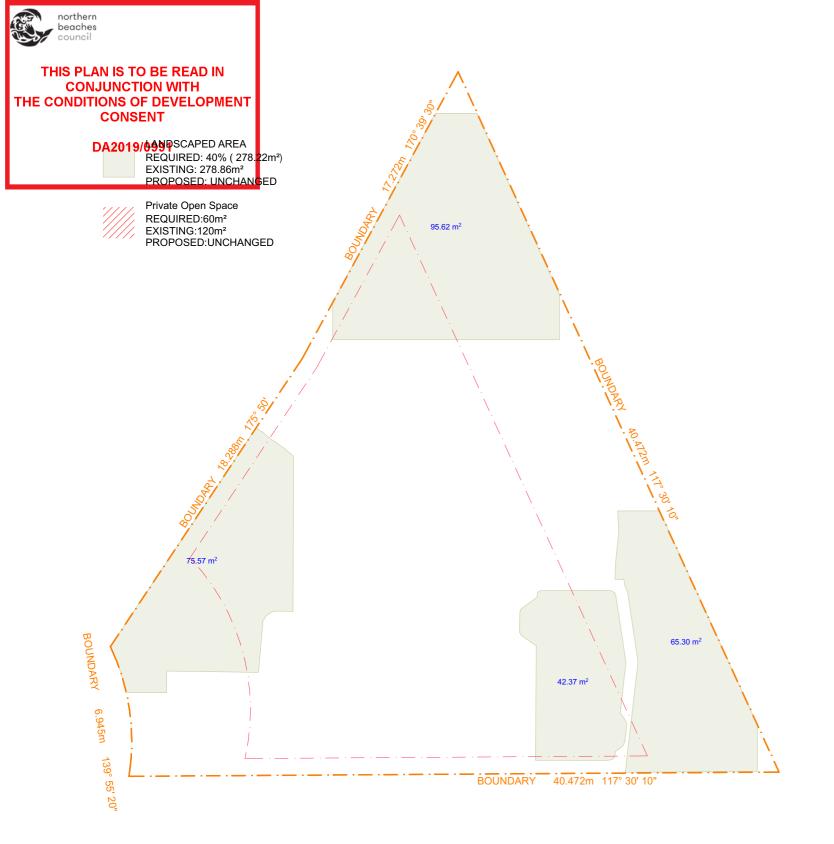



KLIP-LOK ROOFING - COLOUR TO BE CONFIRMED BY CLIENT



ALUMINIUN FRAMED WINDOWS BY STEGBAR



FIXED SKYLIGHT WINDOWS BY VELUX



TILED ROOF & GABLE TO MATCH EXISTING

AREA CALCULATIONS
1:200

REV. DATE

COMMENTS

2 SAMPLE BOARD



l	
	m: 0426 957 518
	e:operations@actionplans.com.au
	w: www.actionplans.com.au

					I inis drawing is the copyright of action plans and not be	
u	Α	17/07/2019	DA DOCUMENTATION	AP	altered, reproduced or transmitted in any form or by means in part or in whole with the written permission	
					Action Plans. Do not scale measure from drawings. Figured dimensions	
					are to be used only. The Builder/Contractor shall check and verify all levels and	2
					dimensions on site prior to commencement of any work, creation of shop drawings, or fabrication of components.	12
					All errors and omissions are to be verified by the Builder/Contractor and referred to the designer prior to the	//
					commencement of works.	

DRWN NOTES



LANDSCAPED AREA

PRIVATE OPEN SPACE

CLIENT

Stephen & Dearne Cameron

PROJECT ADDRESS 5 Mulawa Pl, Frenchs

Forest NSW 2086

DA09

DATE
Wednesday, July 17, 2019

DRAWING NO.

DRAWING NAME

AREA CALCULATIONS / SAMPLE BOARD

SCALE 1:200 @A3

