
GENERAL NOTES

- 1. THE PLUMBER/ DRAINER SHALL INSPECT THE SITE AND CONFIRM THE EXISTING SITE STRUCTURES, SERVICES AND CONDITIONS PRIOR TO PROCEEDING, IF ANY DISCREPANCIES FOUND, CONTACT THE ENGINEER FOR DISCUSSION.
- 2. ALL WORKS TO BE CARRIED OUT IN ACCORDANCE WITH RELEVANT AUSTRALIAN STANDARDS, BUILDING CODE OF AUSTRALIA AND LOCAL GOVERNMENT'S REQUIREMENTS. IT IS THE RESPONSIBILITY OF THE PLUMBER/ DRAINER TO OBTAIN ANY APPROVALS/ PERMITS/ LICENSES ISSUED BY THE AUTHORITIES PRIOR TO PROCEEDING WITH STORMWATER WORKS.
- 3. UNLESS NOTED AS OTHERWISE, ALL DOWNPIPES TO BE \$\phi\$100 ROUND (OR 100x75) RECTANGULAR) AND FULLY SEALED: ALL STORMWATER PIPES TO BE \$\phi\$100 SEWER GRADE AND LAID AT 1% MIN. FALL. ALL MATERIALS USED IN THE WORK SHALL BE NEW AND CONFORM WITH RELEVANT AUSTRALIAN STANDARDS AND BEAR THE REQUIRED STANDARDS MARK.
- 4. LOCATION OF STORMWATER SYSTEMS, INCLUDING DOWNPIPES, PIPES, PITS AND RAINWATER TANK ARE INDICATIVE ONLY. EXACT LOCATION SHALL BE DETERMINED ON SITE TO SUIT SITE CONDITIONS.
- 5. SUB-SOIL DRAINS FOR RETAINING WALL SHALL BE INSTALLED BY THE BUILDER AND CONNECTED TO STORMWATER LINES. ALL AGG. LINES SHALL BE 100mm DIA., UNLESS NOTED OTHERWISE.
- 6. NATURAL GROUND LEVELS ALONG ALL BOUNDARIES MUST BE MAINTAINED UNALTERED. ALL RETAINING WALLS TO BE SETBACK FROM BOUNDARIES TO AVOID CONCENTRATION OF STORMWATER FLOWS.
- 7. LEVELS ARE APPROXIMATE ONLY. THE PLUMBER/ DRAINER SHALL CONFIRM THE LEVELS PRIOR TO PROCEEDING. IF ANY DISCREPANCIES FOUND, CONTACT THE ENGINEER FOR DISCUSSION.
- 8. INSPECTION AND CERTIFICATION, IF REQUIRED, SHALL BE DONE PRIOR TO BACKFILLING. ALLOW 24 HOUR NOTICE FOR THE ENGINEER TO CARRY OUT INSPECTION.
- 9. ANY DAMAGE TO SERVICES DURING CONSTRUCTION SHALL BE REPAIRED IMMEDIATELY AT THE PLUMBER/ DRAINER'S OWN EXPENSE.
- 10. THESE DRAWINGS ARE TO BE READ IN CONJUNCTION WITH:
- ARCHITECTURAL PLAN BY NORTHERN BEACH DESIGNS, JOB No. 2004, DATED 14 FEBRUARY 2020.

THIS DEVELOPMENT HAS NO COMMITMENT ON RAINWATER REUSE UNDER BASIX CERTIFICATE


OSD REQUIREMENTS

THIS DEVELOPMENT IS AN ALTERATION AND ADDITION TO EXISTING DWELLING, OSD IS NOT REQUIRED.

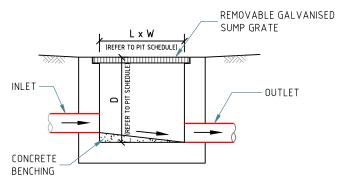

GRATED PIT DETAILS

SCALE 1:20

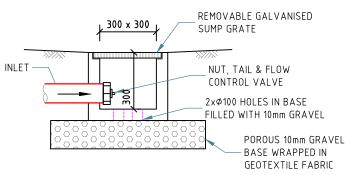

CLEAN-OUT/FIRST FLUSH PIT DETAILS

SCALE 1:20

MINIMUM PIPE COVER (FROM FINISHED SURFACE TO TOP OF PIPE)				
	MINIMUM COVER (mm)			
LOCATION	CAST/DUCTILE IRON GAL STEEL	OTHER AUTHORISED PRODUCTS (~)		
1. NOT SUBJECT TO VEHICULAR LOADING: A. WITHOUT PAVEMENT		40.0		
i. FOR SINGLE DWELLING ii. OTHER THAN SINGLE DWELLING B. WITH PAVEMENT OF	0	100 300		
BRICK/UNREINFORCED CONCRETE	0(~~)	50(~~)		
2. SUBJECT TO VEHICULAR LOADING: A. OTHER THAN ROAD:				
i. WITHOUT PAVEMENT ii. WITH PAVEMENT OF:	300	450		
- REIFORCED CONC. FOR HEAVY VEHICLE - BRICK/UNREINF. CONC. LIGHT VEHICLE B. ROAD	0(~~#) 0(~~#)	100(~~#) 75(~~#)		
i. SEALED ii. UNSEALED	300 300	500(#) 500(#)		
3. SUBJECT TO CONSTRUCTION VEHICLE OR IN ENBANKMENT CONDITION	300	500(#)		
(~) INCLUDES OVERLAY ABOVE THE TOP OF THE PIPE OF NOT LESS THAN 50mm THICK				


- (~~) BELOW THE UNDERSIDE OF THE PAVEMENT
- (#) SUBJECT TO COMPLIANCE WITH AS1762, AS2033, AS/NZS2566.1, AS3725 OR AS4060

Approved:

Quoc Huy Nguyen

PhD (Eng), MIEAust, CPEng,

NER Reg. No. 208 2513

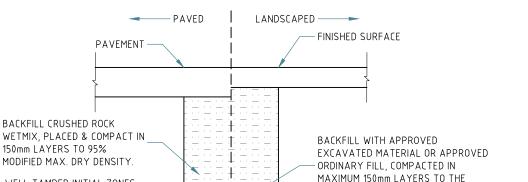


·			•	
PE DIA "D"	W	X MIN	Υ	
00-150	300	75	75	
25 300	600	75	75	

MOISTURE CONTENT.

WELL TAMPED INITIAL ZONES

SHALL BE 10mm CRUSHED ROCK

WELL TAMPED & AT OPTIMUM

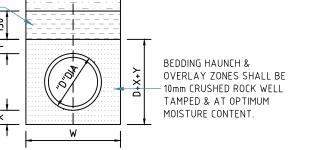


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DENSITY OF THE ADJACENT SOIL

BEFORE YOU DIG

UPVC PIPE TRENCH BACKFILL TYP. DETAILS

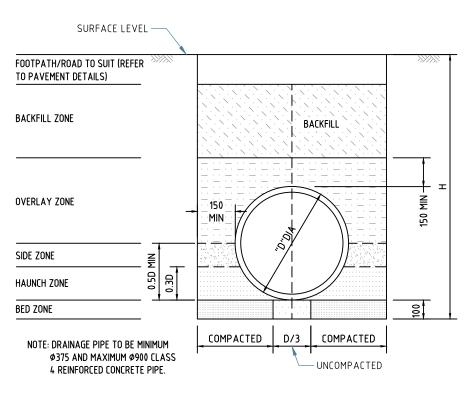

CONCRETE PIPE TRENCH BACKFILL TYP. DETAILS

SCALE 1:20

PROJECT: PROPOSED ALTERATIONS AND ADDITIONS

All dimensions are in millimetres. Do not 1 scale the drawing. Use written dimensions. Dimensions must be confirmed prior to commencement. Location of services are approximate only. Dial 1100 before any excavation or demolition.

Revisions Original issue Designed: HL Checked: .

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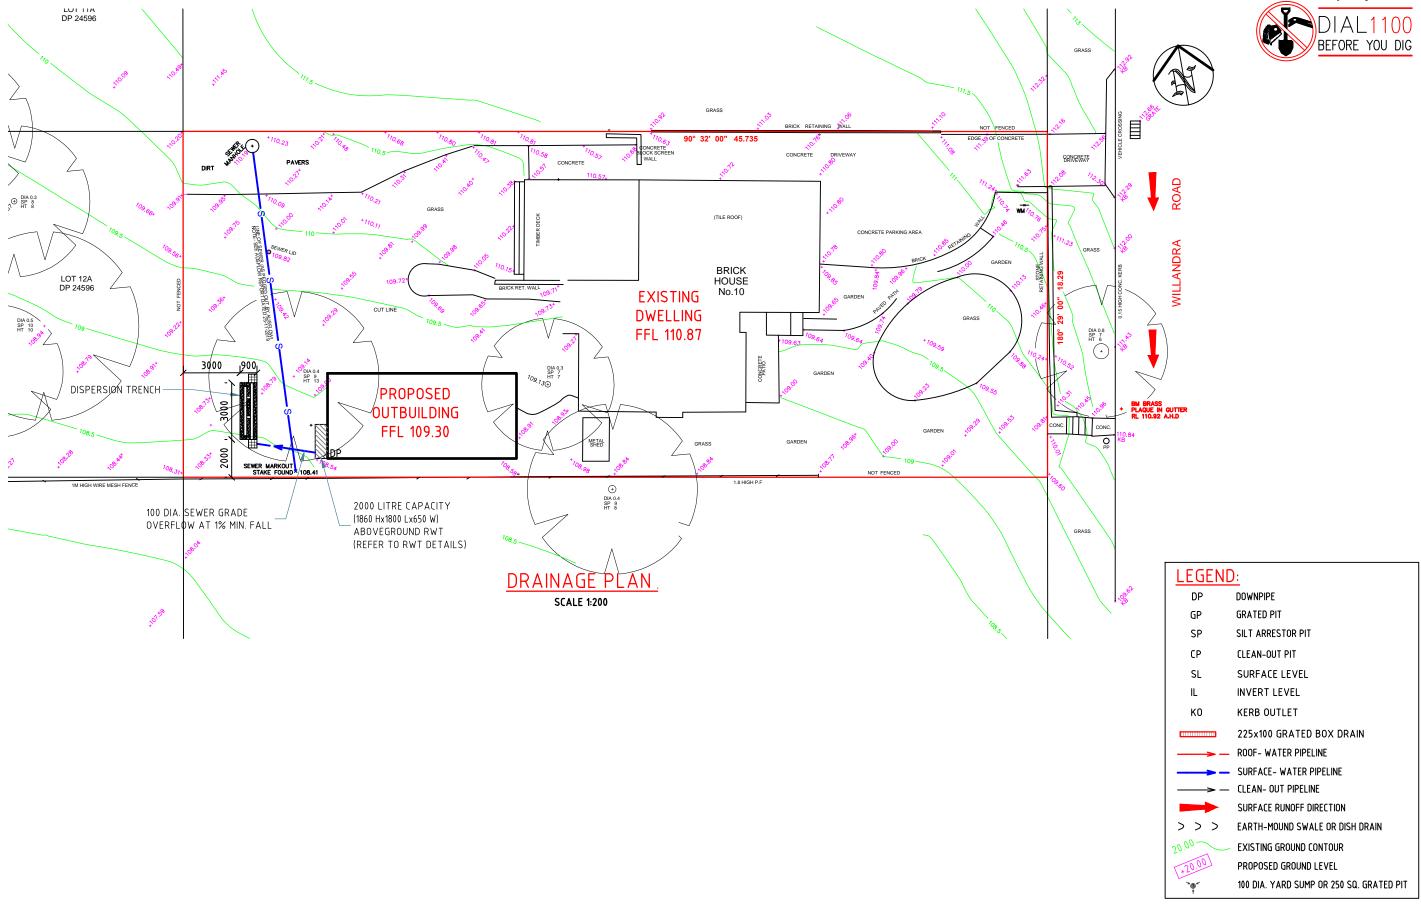
E: admin@nitma.com.au W: nitma.com.au

ADDRESS: 10 WILLANDRA ROAD, BEACON HILL LGA: NORTHERN BEACHES COUNCIL

NOTES & STANDARD DETAILS

Project No: 4209H Issue: A Date: 25.02.2020 Sheet No:

1 of 3



Revisions		
Original issue		
Designed: HL	Checked:	

Approved:

Quoc Huy Nguyen PhD (Eng), MIEAust, CPEng, NER Reg. No. 208 2513



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PROJECT: PROPOSED ALTERATIONS AND ADDITIONS ADDRESS: 10 WILLANDRA ROAD, BEACON HILL LGA: NORTHERN BEACHES COUNCIL

DRAINAGE PLAN


Project No: 4209H Issue: A Date: 25.02.2020 Sheet No:

2 of 3


RAINWATER TANK NOTES:


- 1. RAINWATER TANKS BY TANKWORKS AUSTRALIA (TEL: 1300 736 562) OR SIMILAR (MUST BE STEEL OR CONCRETE).
- 2. DIMENSIONS ARE INDICATIVE ONLY. EXACT DETAILS TO MANUFACTURER'S SPECIFICATIONS.
- 3. A FIRST FLUSH DEVICE IN ACCORDANCE WITH MANUFACTURER'S SPECIFICATIONS SHALL BE FITTED TO RAINWATER TANK SYSTEM TO FLUSH OUT THE FIRST 0.5mm OF RUN-OFF FROM THE ROOF AREA THAT DRAINED INTO THE TANK (E.G. 0.5L/m2).

 4. RAINWATER OUTLET CONNECTIONS AS PER BASIX CERTIFICATE.

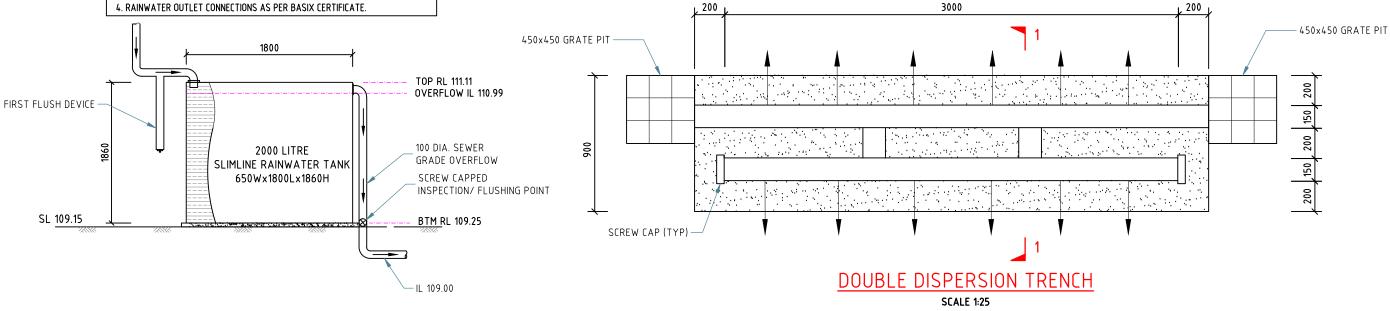

RAINWATER TANK DETAILS. NOT TO SCALE

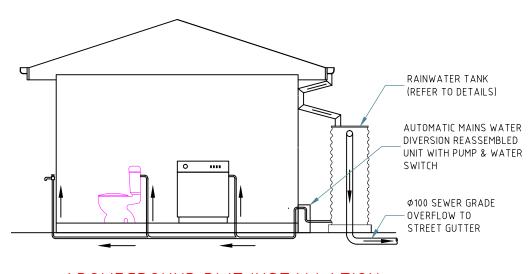

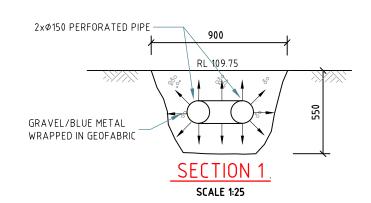

ABOVEGROUND RWT INSTALLATION

All dimensions are in millimetres. Do not scale the drawing. Use written dimensions. Dimensions must be confirmed prior to commencement. Location of services are approximate only. Dial 1100 before any excavation or demolition.

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Revisions Original issue Designed: HL Checked: ..

Approved:

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PROJECT: PROPOSED ALTERATIONS AND ADDITIONS ADDRESS: 10 WILLANDRA ROAD, BEACON HILL LGA: NORTHERN BEACHES COUNCIL

RWT AND DISPERSION DETAILS

Project No: 4209H Issue: A Date: 25.02.2020 Sheet No:

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