
3 OCEAN GROVE COLLAROY, NSW 2097

DEVELOPMENT APPLICATION

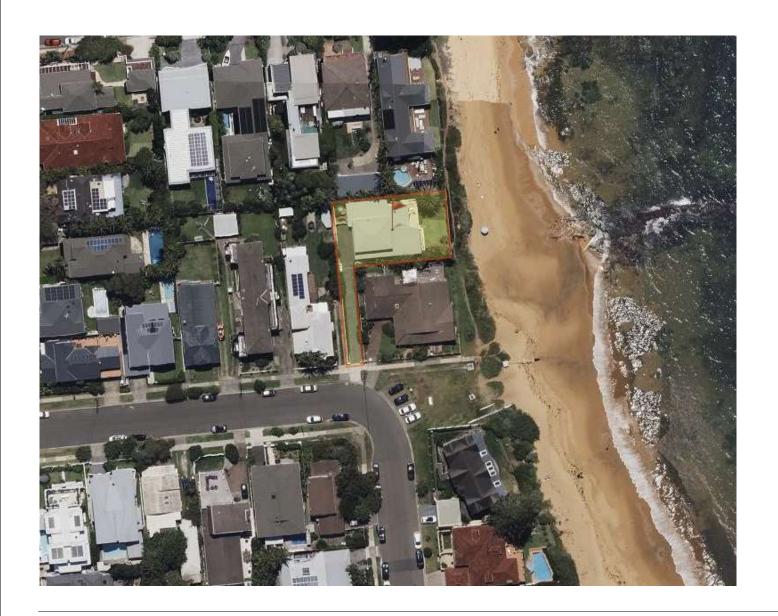

DRAWING LIST

A001	COVER SHEET	19.08.25
A002	BASIX COMMITMENTS	19.08.25
A007	SITE ANALYSIS PLAN	19.08.25
800A	SITE PLAN	19.08.25
A100	EXISTING / DEMOLITION PLAN - GF	19.08.25
A101	EXISTING / DEMOLITION PLAN - FF	19.08.25
A102	LOWER GROUND PLAN	19.08.25
A103	GROUND FLOOR PLAN	19.08.25
A104	FIRST FLOOR PLAN	19.08.25
A105	ROOF PLAN	19.08.25
A106	CONCEPT STOMWATER DESIGN	19.08.25
A200	ELEVATIONS	19.08.25
A201	ELEVATIONS	19.08.25
A202	ELEVATIONS	19.08.25
A203	ELEVATIONS	19.08.25
A300	SECTIONS	19.08.25
A400	FINISHES SCHEDULE	19.08.25

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2405 3 OCEAN GROVE

GRAHAM DICKSON

3 OCEAN GROVE COLLAROY NSW 2097

COVER SHEET NOT FOR CONSTRUCTION Scale @A3 Date: 19.08.25 2405 DA A001

DEVELOPMENT APPLICATION

Project name	3 Ocean Grove, Collaroy
Street address	3 OCEAN - COLLAROY 2097
Local Government Area	Northern Beaches Council
Plan type and number	Deposited Plan DP211132
Lot number	1
Section number	
Project type	
Dwelling type	Dwelling house (detached)
Type of alteration and addition	The estimated development cost for my renovation work is \$50,000 or more, and doe not include a pool (and/or spa).
N/A	N/A
Certificate Prepared by	ease complete before submitting to Council or PCA)

Fixtures and systems

Lighting

The applicant must ensure a minimum of 40% of new or altered light fixtures are fitted with fluorescent, compact fluorescent, or light-emitting-diode (LED) lamps.

Construction

Insulation requirements

The applicant must construct the new or altered construction (floor(s), walls, and ceilings/roofs) in accordance with the specifications listed in the table below, except that a) additional insulation is not required where the area of new construction is less than 2m2, b) insulation specified is not required for parts of altered construction where insulation already exists.

Construction	Additional insulation required (R-value)	Other specifications
suspended floor above garage: framed (R0.7).	nil	N/A
external wall: framed (weatherboard, fibro, metal clad)	R1.30 (or R1.70 including construction)	
flat ceiling, flat roof: framed	ceiling: R2.50 (up), roof: foil/sarking	medium (solar absorptance 0.475 - 0.70)

Glazing requirements

Windows and glazed doors

The applicant must install the windows, glazed doors and shading devices, in accordance with the specifications listed in the table below. Relevant overshadowing specifications must be satisfied for each window and glazed door.

The following requirements must also be satisfied in relation to each window and glazed door:

Each window or glazed door with standard aluminium or timber frames and single clear or toned glass may either match the description, or, have a U-value and a Solar Heat Gain Coefficient (SHGC) no greater than that listed in the table below. Total system U-values and SHGCs must be calculated in accordance with National Fenestration Rating Council (NFRC) conditions.

For projections described in millimetres, the leading edge of each eave, pergola, verandah, balcony or awning must be no more than 500 mm above the head of the window or glazed door and no more than 2400 mm above the sill.

Pergolas with polycarbonate roof or similar translucent material must have a shading coefficient of less than 0.35.

Pergolas with fixed battens must have battens parallel to the window or glazed door above which they are situated, unless the pergola also shades a perpendicular window. The spacing between battens must not be more than 50 mm.

Windows and glazed doors glazing requirements

Window/door number	Orientation	Area of glass including frame (m2)	Overshadowing height (m)	Overshadowing distance (m)	Shading device	Frame and glass type
D1	N	2	0	0	eave/ verandah/ pergola/balcony >=900 mm	timber or uPVC, single clear, (or U- value: 5.71, SHGC: 0.66)
D2	W	2	0	0	eave/ verandah/ pergola/balcony >=600 mm	timber or uPVC, single clear, (or U- value: 5.71, SHGC: 0.66)

DEVELOPMENT APPLICATION

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2405 3 OCEAN GROVE

GRAHAM DICKSON

3 OCEAN GROVE COLLAROY NSW 2097 BASIX COMMITMENTS

NOT FOR CONSTRUCTION

Scale @A3 Date: 19.08.25

2405 DA A002
Project no. Drawing Phase. Drawing No. Rev

SITE SUMMARY NORTHERN BEACHES COUNCIL 710m² SITE AREA **GROSS FLOOR AREA** EXISTING PROPOSED LOWER GROUND FLOOR 127m² GROUND FLOOR 127m² FIRST FLOOR GARAGE 45m² 45m² TOTAL 188.5m² 188.5m²


MIN. REQUIRED 40% / 284m²

UNCHANGED

LANDSCAPING

EXISTING

PROPOSED

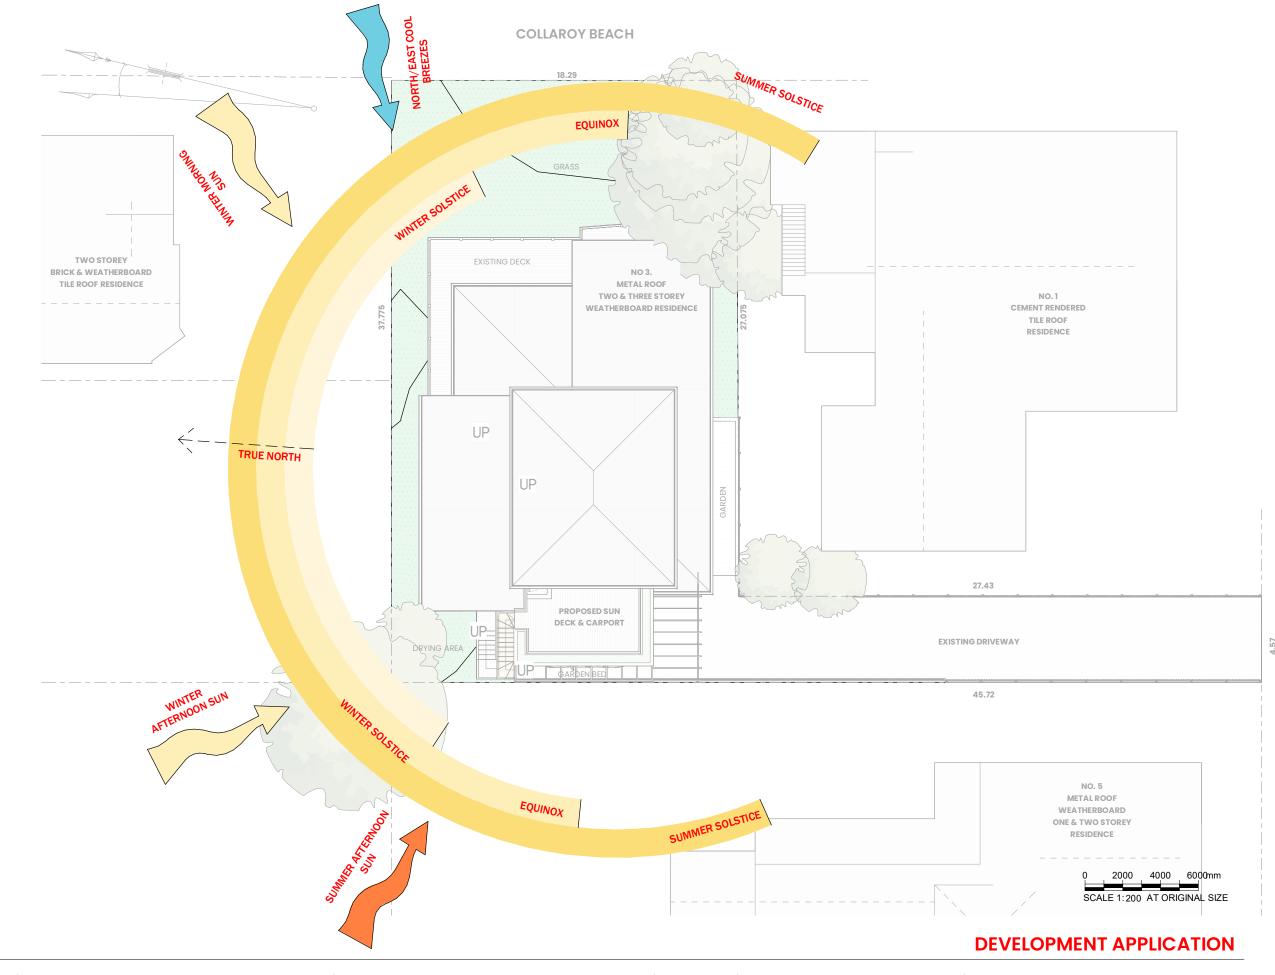

SITE ANALYSIS PLAN

scale 1:200

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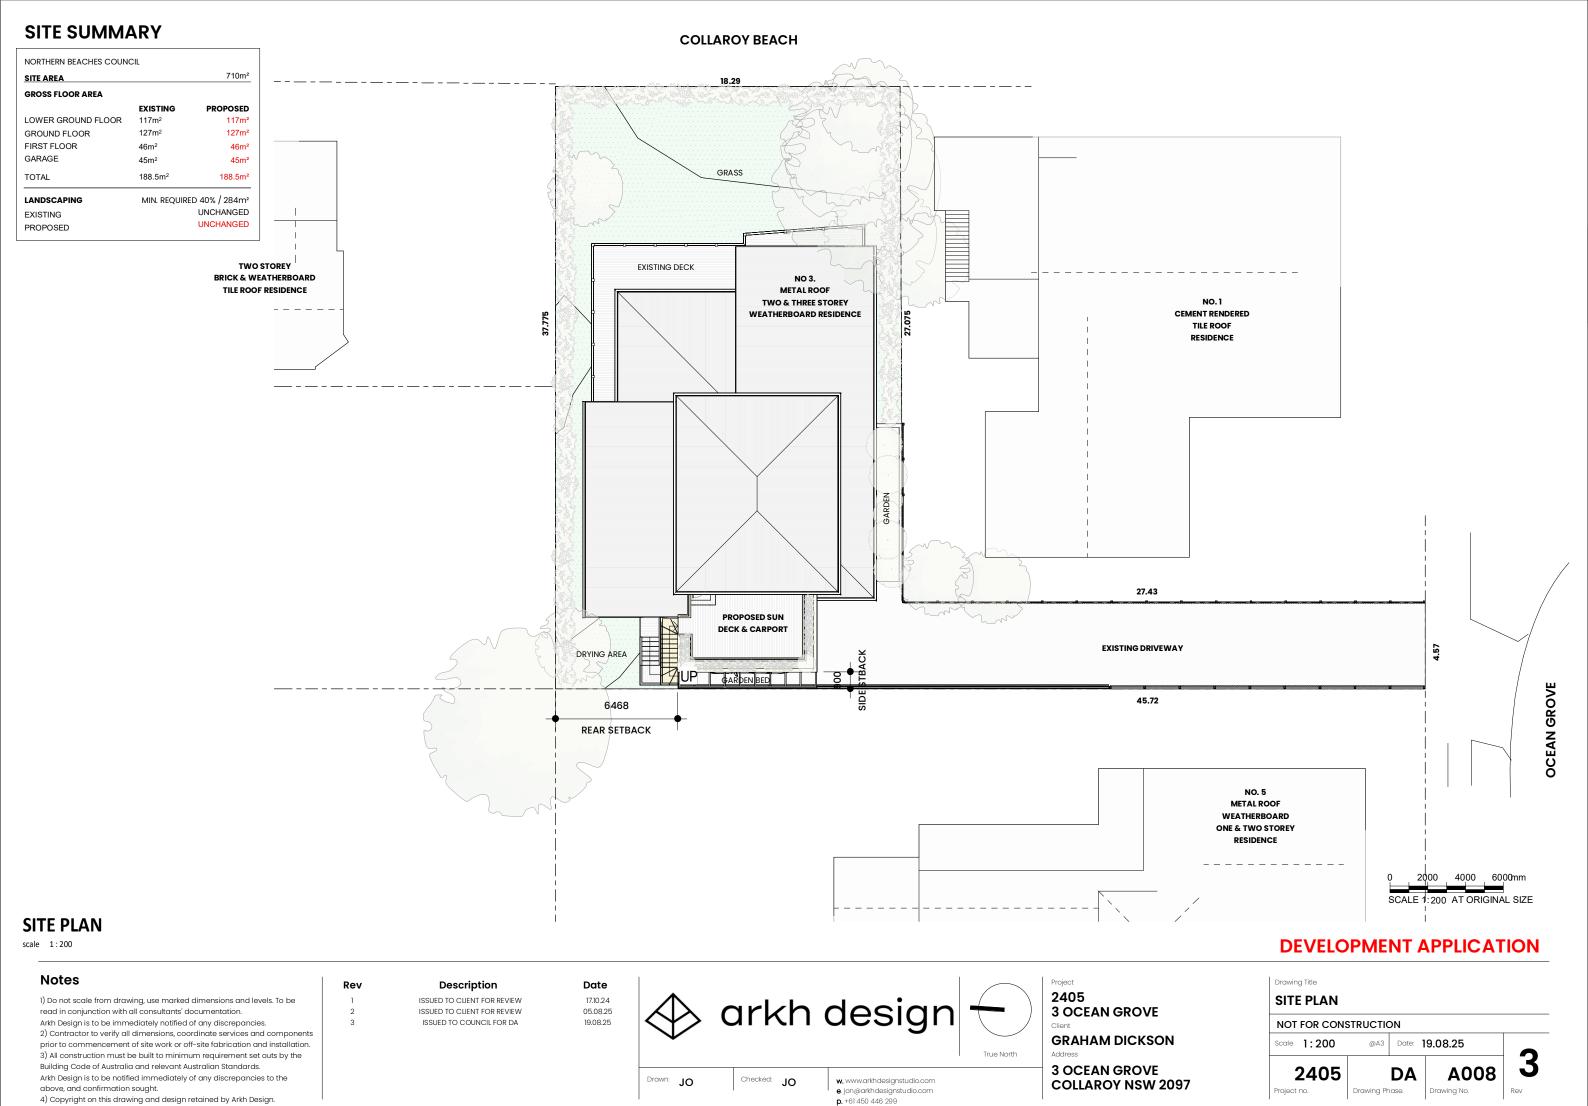
SITE ANALYSIS PLAN

NOT FOR CONSTRUCTION

Scale 1: 200 @A3 Date: 19.08.25

2405 DA A007

Project to Drawing Phase Drawing No. Rev.



LEGEND



Existing walls removed Existing walls to remain

EXISTING DAMAGE REPORT

Prior to commencement of any works on site, the

applicant shall notify Council in

repair such damages.

writing with digital photographs of any existing damages to Council's assets fronting the property and the immediate adjoining properties. Failure to do so will result in the applicant being liable for any construction related damages to these assets. In this respect, the damage deposit lodged by the applicant may be used by Council to

DEMOLITION

Carry out demolition and/or removal in accordance with AS 2601 & Conditions set out in councils notice of determination.

TREE PROTECTION

Protect all tree's to remain in accordance with councils notice of determination

HAZARDOUS MATERIALS

Remove hazardous materials in accordance with Australian Standards and councils requirements. Refer to councils notice of determination

BUILDING PROTECTION

Provide adequate and proper protection to weatherproof the adjoining and remaining existing buildings and to protect persons and existing private and public property from injury

and/or damage

COLLAROY BEACH

Reduce dust to a minimum. Any dust created is to be properly controlled and prevented from being a nuisance to the public and/or occupiers of adjoining and remaining existing buildings.

Take all practicable steps to minimize noise resulting from the works.

0 1000 2000 3000mm SCALE 1:100 AT ORIGINAL SIZE

DEVELOPMENT APPLICATION

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Client
GRAHAM DICKSON
Address
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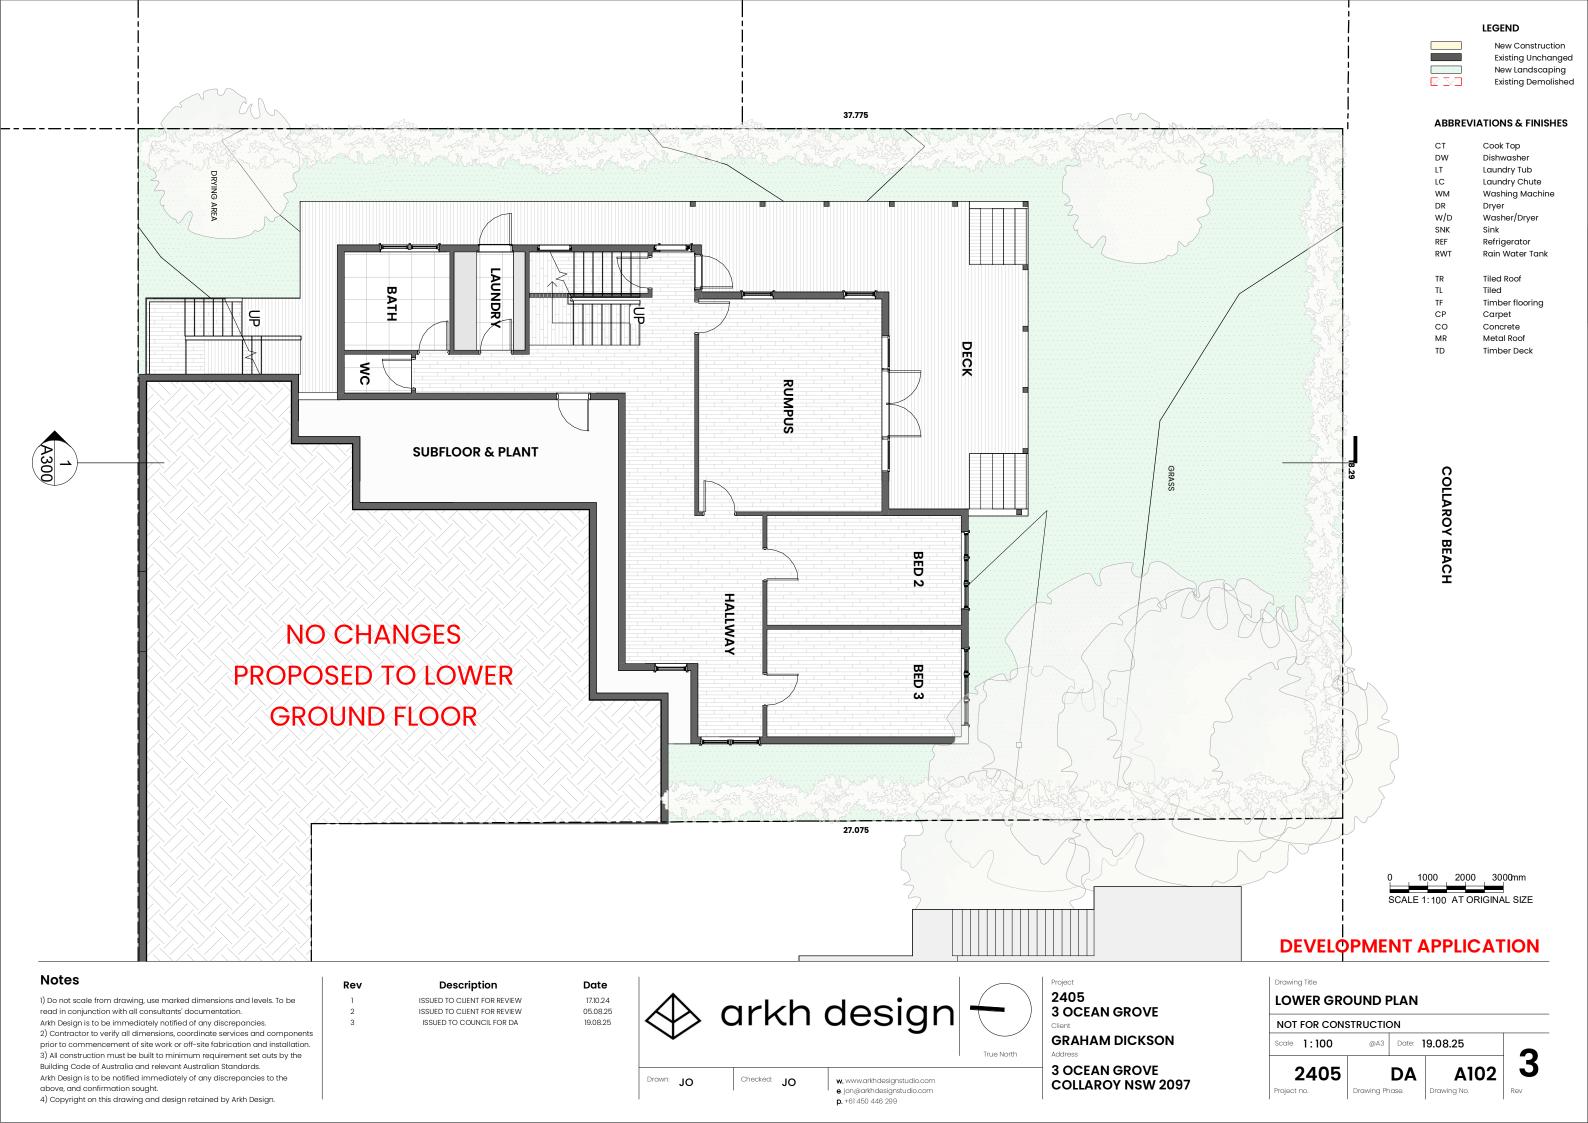
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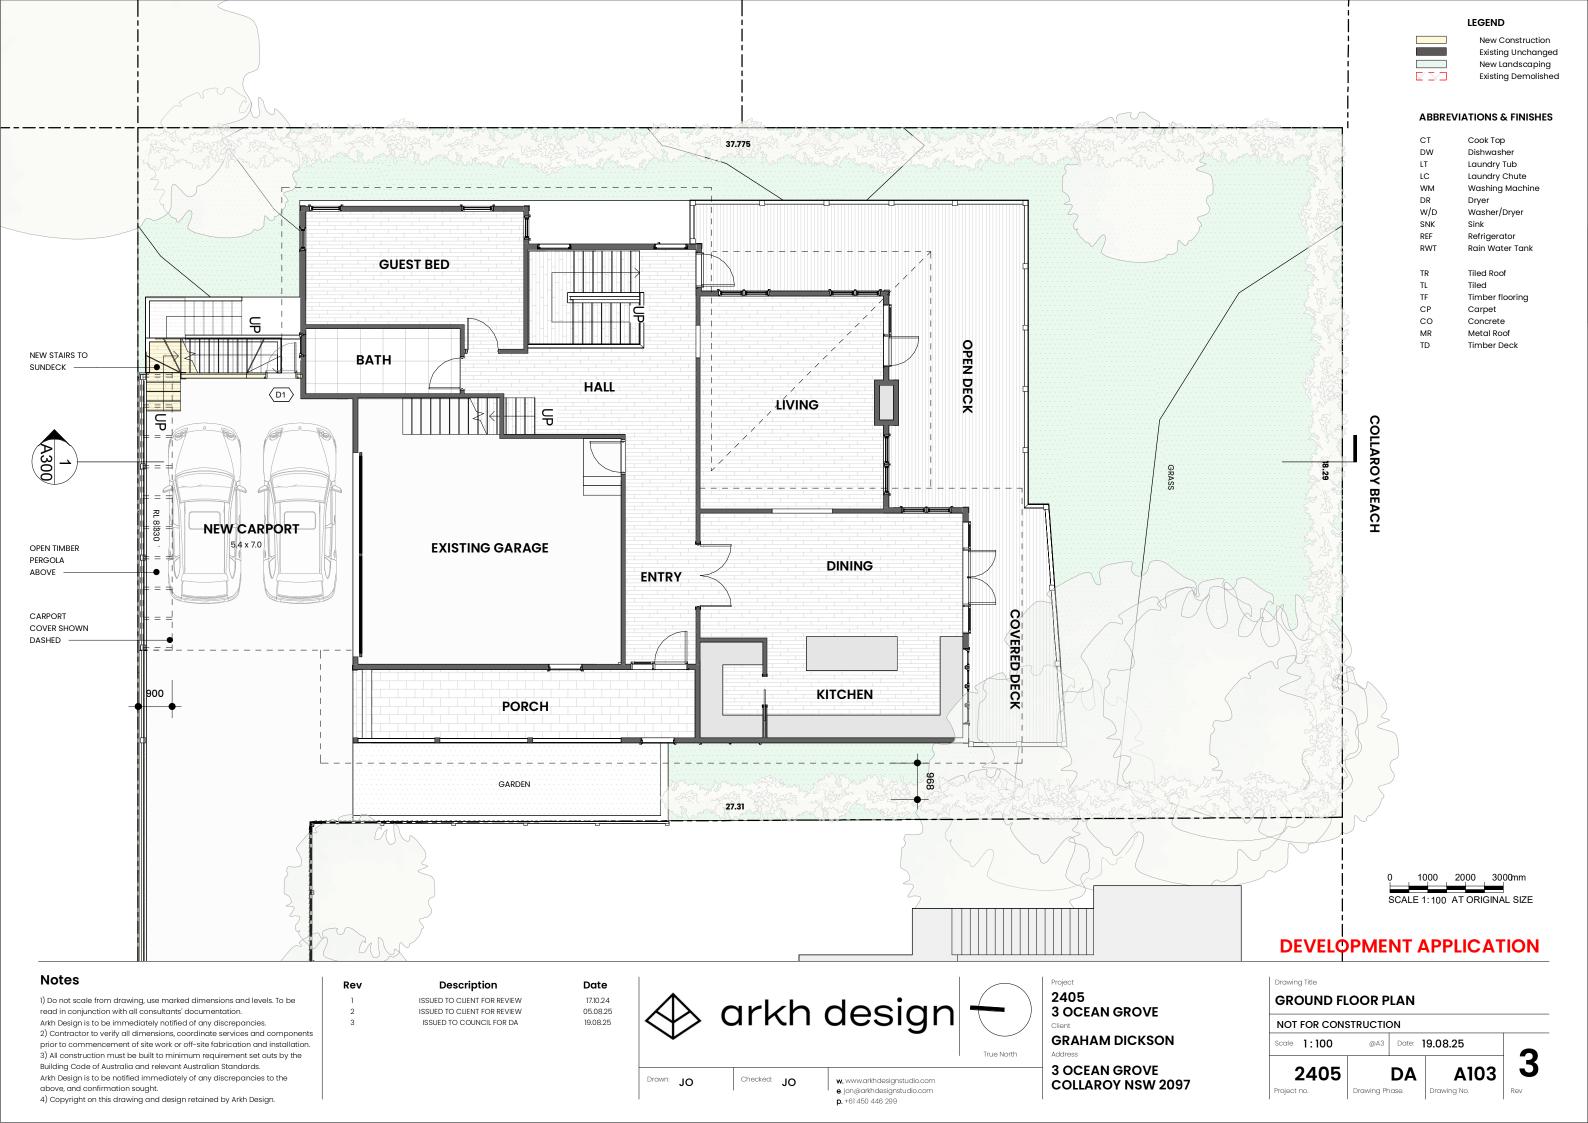
 EXISTING / DEMOLITION PLAN - FF


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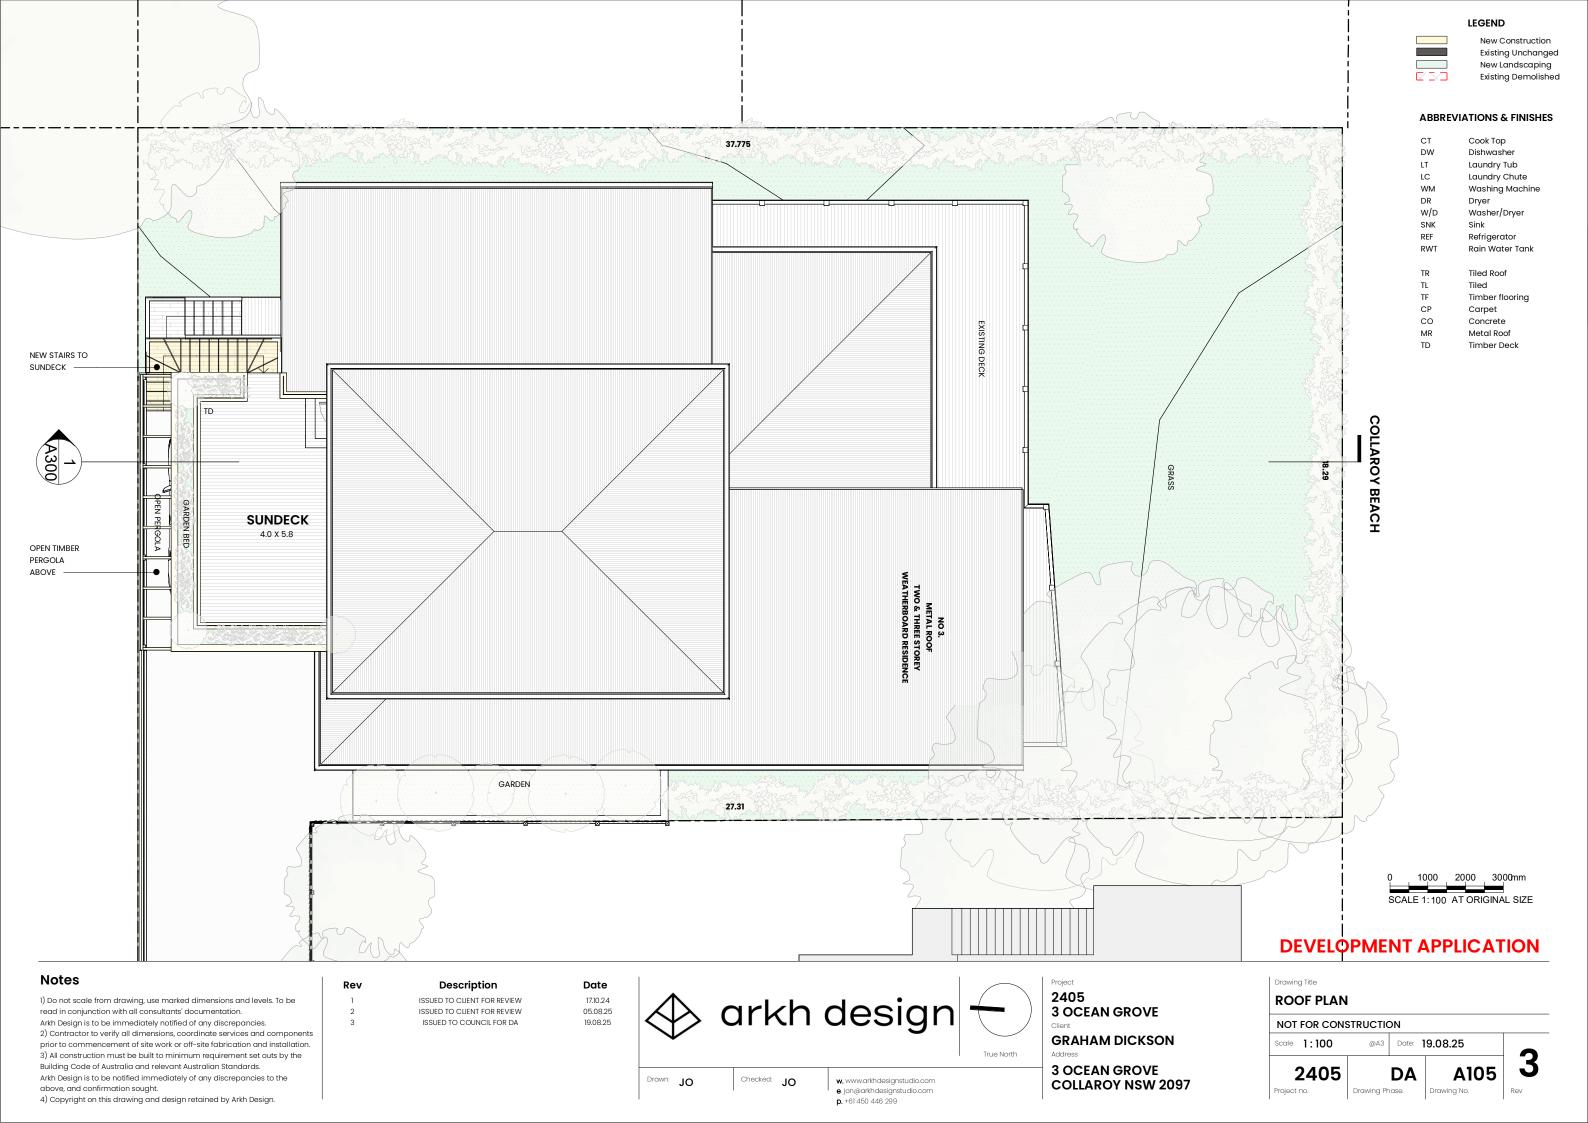
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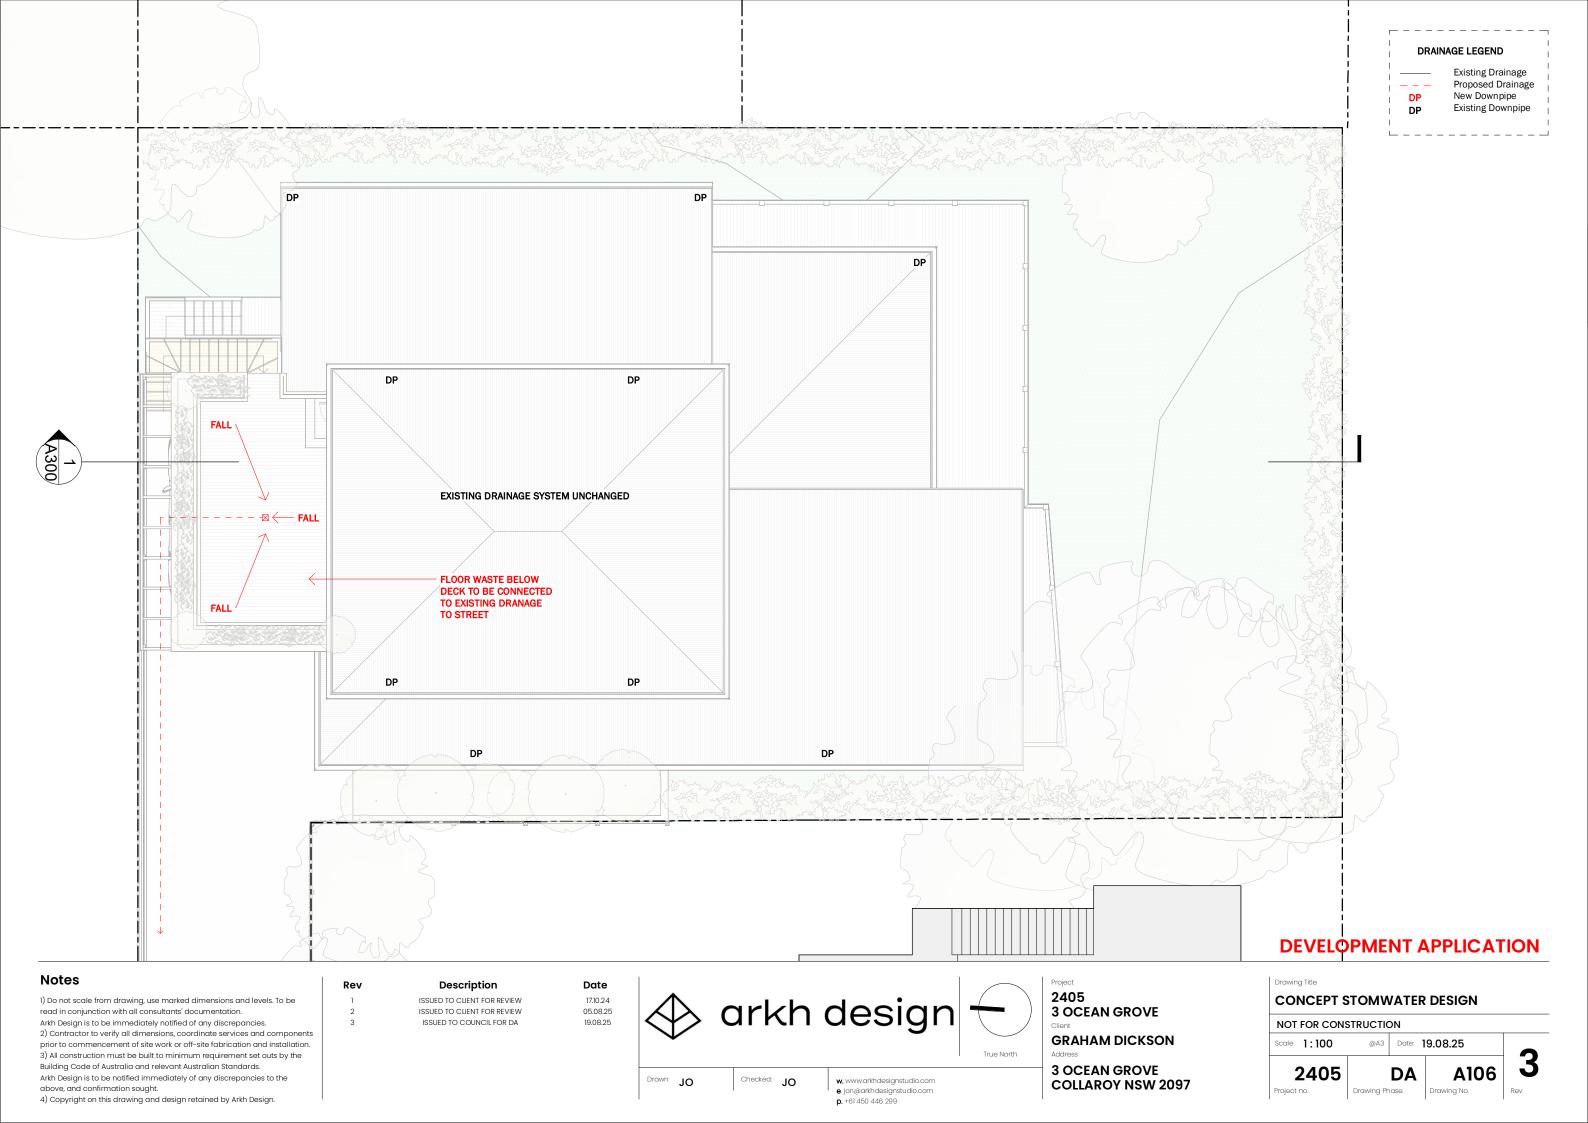
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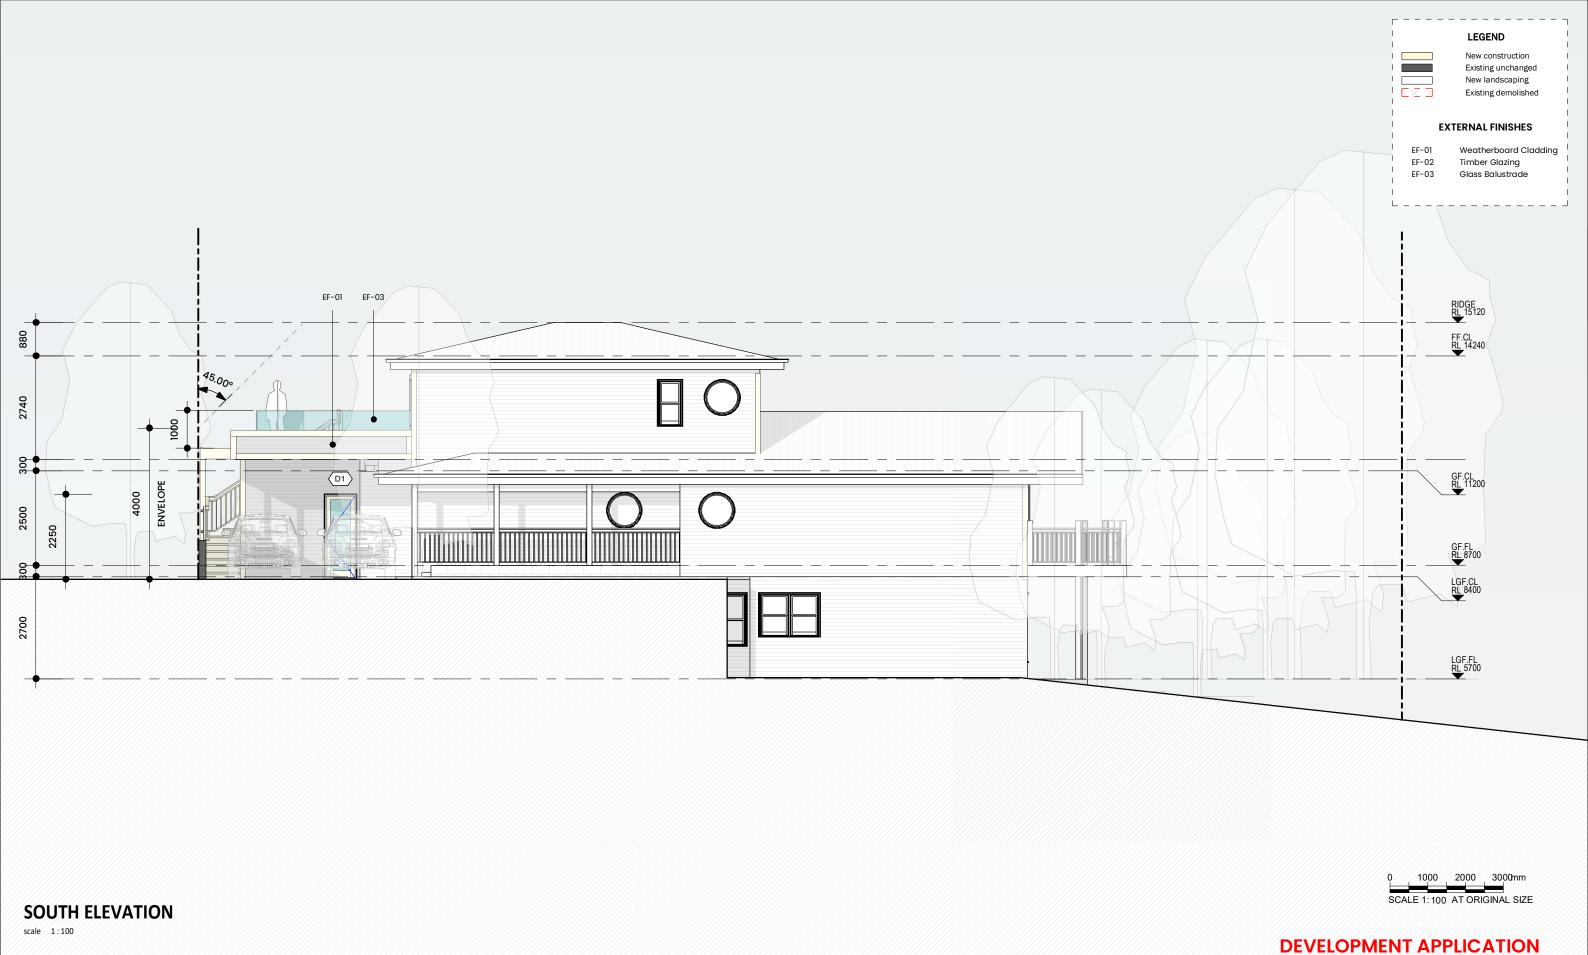










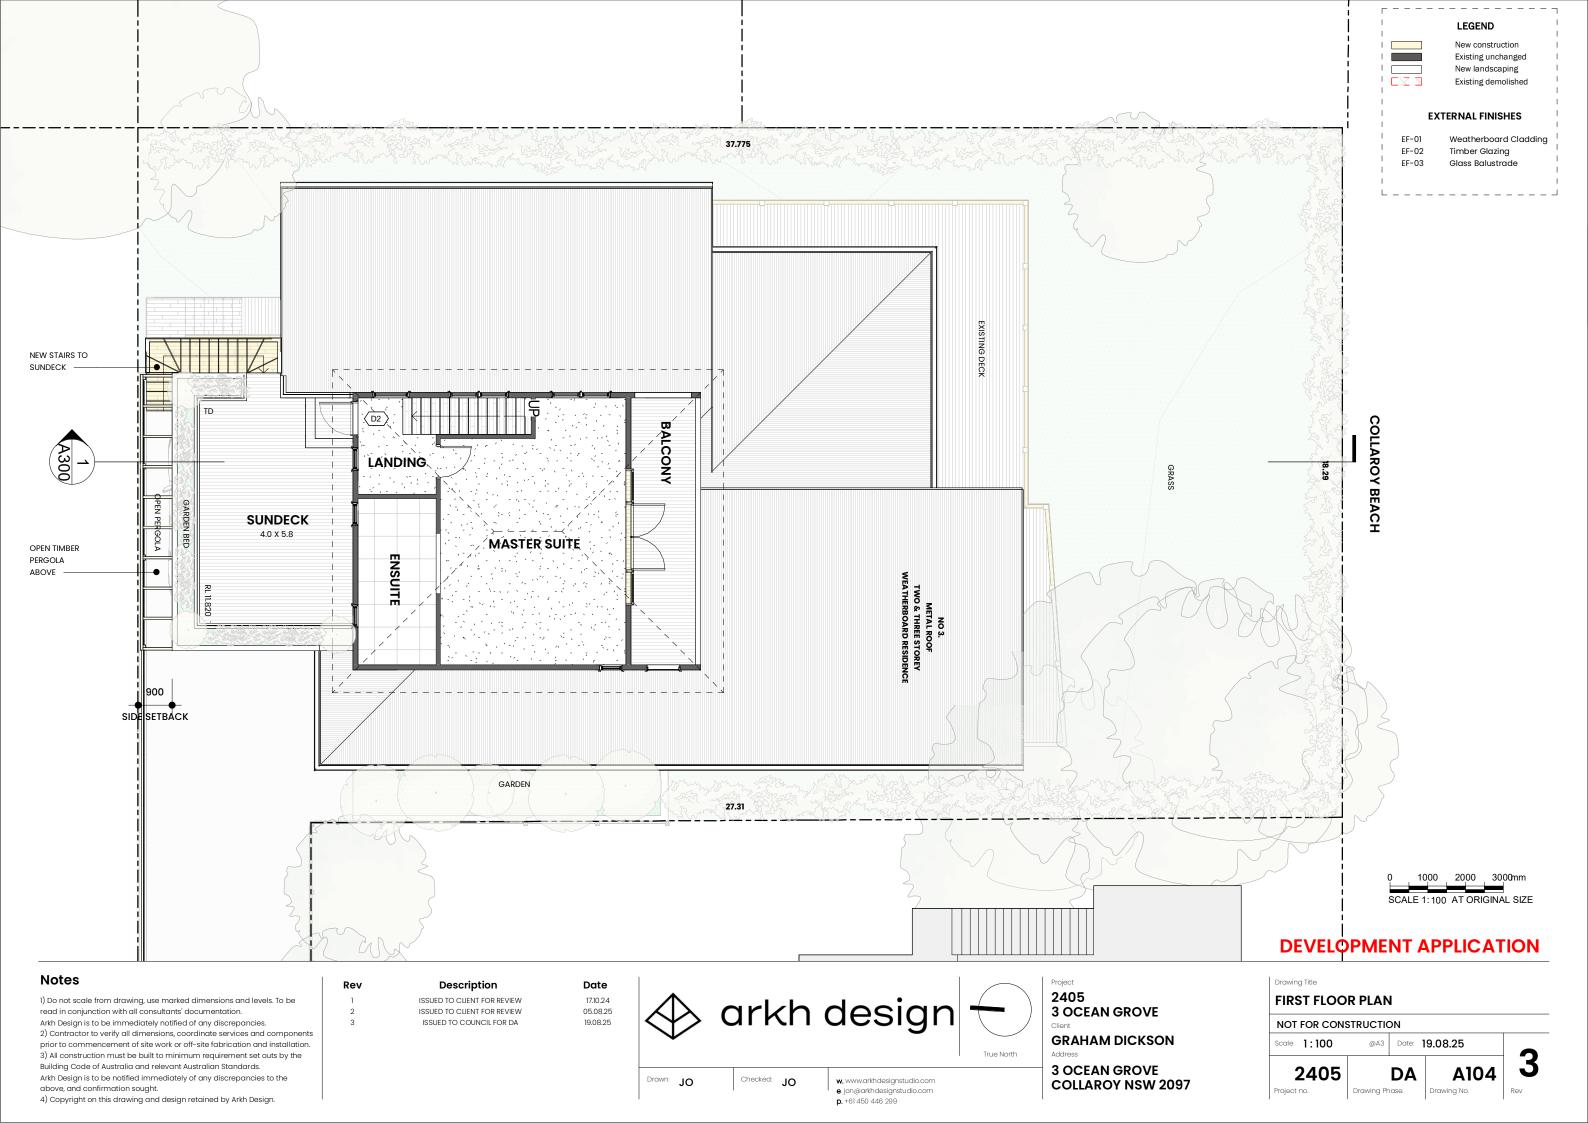

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3 OCEAN GROVE COLLAROY NSW 2097

Drawing Title ELEVATIONS

NOT FOR CONSTRUCTION
Scale 1:100 @A3 Date: 19.08.25

2405 DA A200



NORTH ELEVATION

scale 1:100

Notes

DEVELOPMENT APPLICATION

0 1000 2000 3000mm SCALE 1:100 AT ORIGINAL SIZE

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Drawing Title						
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NOT FOR CONSTRUCTION						
Scale 1:100	@A3	Date:	9.08.25			
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EAST ELEVATION

scale 1:100

DEVELOPMENT APPLICATION

0 1000 2000 3000mm SCALE 1:100 AT ORIGINAL SIZE

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3 OCEAN GROVE



1000 2000 3000mm SCALE 1: 100 AT ORIGINAL SIZE

SECTION AA

scale 1:100

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2405 **3 OCEAN GROVE**

GRAHAM DICKSON

3 OCEAN GROVE COLLAROY NSW 2097

Drawing Title **SECTIONS** NOT FOR CONSTRUCTION Scale 1:100 @A3 Date: 19.08.25 A300 2405 DA

DEVELOPMENT APPLICATION



EF-01 - Weatherboard Cladding **COLOUR** - Matching existing cladding

EF-02 - Timber Glazing **COLOUR** - Painted to match existing home

EF-03 - Glass Balustrade **COLOUR** - Clear

DEVELOPMENT APPLICATION

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