PROPOSED ALTERATIONS AND ADDITIONS TO AN EXISTING RESIDENCE


44 HILMA ROAD - COLLAROY PLATEAU 2097



J/ 1.0 I	
DA.02	EXISTING GROUND FLOOR PLAN
DA.03	EXISTING FIRST FLOOR PLAN
DA.04	EXISTING NORTH AND SOUTH ELEVATIONS
DA.05	EXISTING WEST AND EAST ELEVATIONS
DA.06	DEMOLITION PLAN
DA.07	GROUND FLOOR PLAN
30.AC	FIRST FLOOR PLAN
DA.09	NORTHERN AND SOUTHERN ELEVATIONS
DA.10	WESTERN AND EASTERN ELEVATIONS
DA.11	SECTION A
DA.12	SECTION B, DRIVEWAY PROFILE AND BASIX
DA.13	LANDSCAPED AREA CALCULATION PLAN
DA.14	ROOF & STORMWATER CONCEPT PLAN
DA.15	EROSION & SEDIMENT CONTROL / WASTE MANAGEMENT PLAN
DA.16	SHADOW DIAGRAM JUNE 21 9am
DA.17	SHADOW DIAGRAM JUNE 21 12noon
DA.18	SHADOW DIAGRAM JUNE 21 3pm
DA.19	BUILDING HEIGHT PLANE
DA.20	WINDOW SCHEDULE

SITE ANALYSIS PLAN

DOOR SCHEDULE

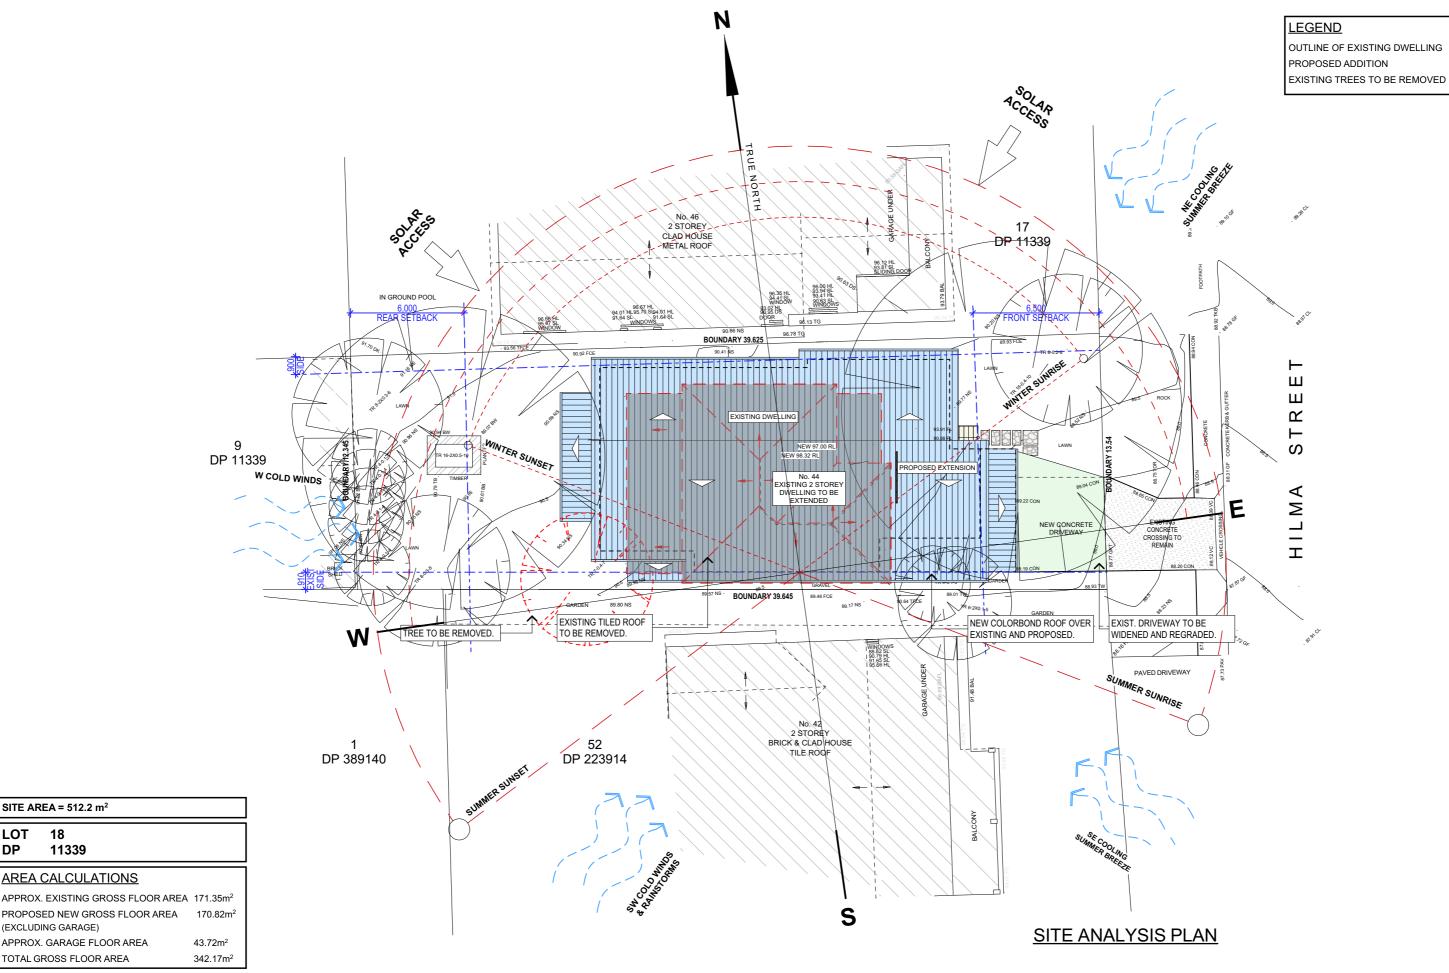

TRUE NORTH:

SITE AREA = 512.2 m²

18

(EXCLUDING GARAGE)

11339

AREA CALCULATIONS

APPROX. GARAGE FLOOR AREA

TOTAL GROSS FLOOR AREA

LOT

DP

NOTES (E & OE)

All structures including stormwater & drainage to engineer's details.

Do not obtain dimensions by scaling drawings.

All dimensions are to be checked on site prior to starting work.

 New materials are to be used throughout unless otherwise noted.
 Concrete footings, slab, structural beams or any other structural members are to be designed. by a practicing engineer.


JJ Drafting ^{Australia} P/L.

26/90 Mona Vale Road, Mona Vale, NSW, 2103 PO Box 687, Dee Why, NSW, 2099 Mob. 0414 717 541 | Email. jjdraft@tpg.com.au www.jjdrafting.com.au ACN 651 693 346

-	REV:	DATE:	DESCRIPTION:
	Α	2/09/22	PLANS TO BE REVISED BY CLIENT
	В	8/09/22	DA DRAWINGS
.	С	13/09/22	AMENDED PLANS PER CLIENTS REQUEST
	D	23/09/22	CHANGES TO WINDOWS
اي			
-1			

PROPOSED ALTERATIONS AND ADDITIONS 44 HILMA STREET COLLAROY PLATEAU NSW 2097	
CLIENT: SIMONNE HUNT & DAVID DI BONA	
DRAWING TITLE: SITE ANALYSIS PLAN	

DATE: SEP/22	DRAWN BY:	SCALE: 1:200 @ A3
JOB No: 1064/22	CHECKED BY:	DRAWING No: DA.01

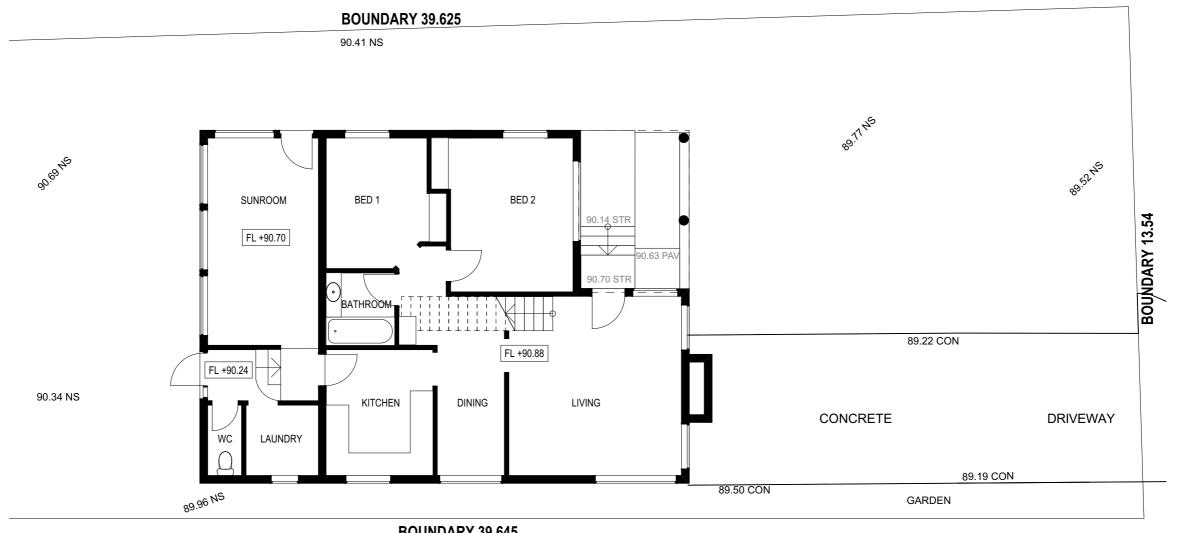

BOUNDARY 39.645

89.17 NS

EXISTING GROUND FLOOR PLAN

TRUE NORTH:



NOTES (E & OE)

All structures including stormwater & drainage to engineer's details.

Do not obtain dimensions by scaling drawings.

All dimensions are to be checked on site prior to starting work.

These drawings are to be read in conjunction with all other consultant's drawings and specifications.

All workmanship & materials shall be in accordance with the requirements of current editions including amendments of the National Construction Code relevant Australian Standards & local

All workmanship & materials shall be in accordance with the requirements of current editions including amendments of the National Construction Code, relevant Australian Standards & local council requirements.

New materials are to be used throughout unless otherwise noted.

Concrete footings, slab, structural beams or any other structural members are to be designed by a practicing engineer.

JJ Drafting Australia P/L.

26/90 Mona Vale Road, Mona Vale, NSW, 2103 PO Box 687, Dee Why, NSW, 2099 Mob. 0414 717 541 | Email. jjdraft@tpg.com.a www.jjdrafting.com.au ACN 651 693 346

	REV:	DATE:	DESCRIPTION:
	Α	2/09/22	PLANS TO BE REVISED BY CLIENT
	В	8/09/22	DA DRAWINGS
)3	С	13/09/22	AMENDED PLANS PER CLIENTS REQUEST
	D	23/09/22	CHANGES TO WINDOWS
au			

PROPOSED ALTERATIONS AND ADDITIONS 44 HILMA STREET COLLAROY PLATEAU NSW 2097 CLIENT: SIMONNE HUNT & DAVID DI BONA
DRAWING TITLE: EXISTING GROUND FLOOR PLAN

DATE:	DRAWN BY:	SCALE:
SEP/22	HR	1:100 @ A3
IOB No:	CHECKED BY:	DRAWING No:
1064/22	JJ	DA.02

Ш

Ш


 \mathcal{L}

S

 \triangleleft

≥

工

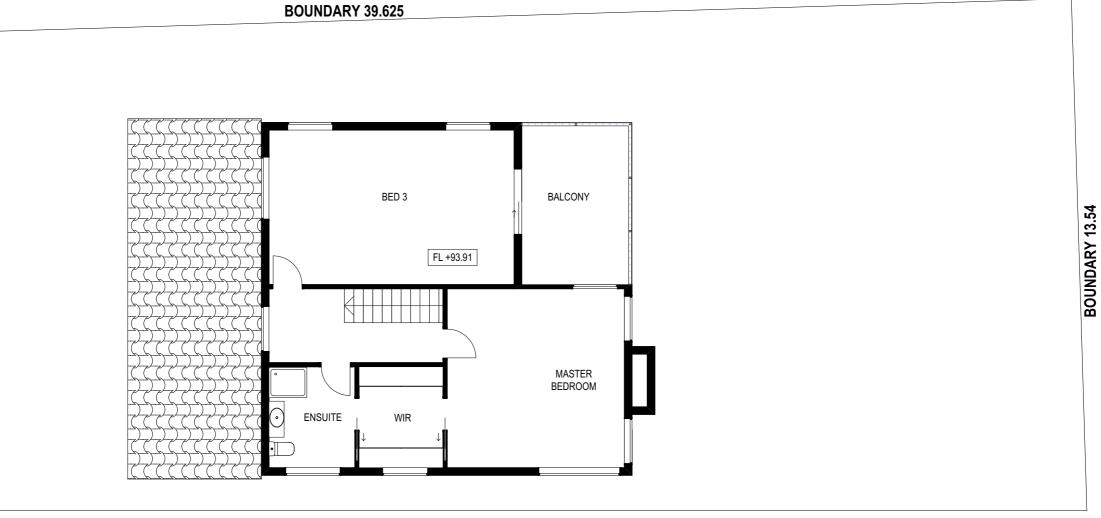

BOUNDARY 39.645

EXISTING FIRST FLOOR PLAN

TRUE NORTH:



NOTES (E & OE)

• All structures including stormwater & drainage to engineer's details.

• Do not obtain dimensions by scaling drawings.

• All dimensions are to be checked on site prior to starting work.

• These drawings are to be read in conjunction with all other consultant's drawings and specifications.

• All workmanship & materials shall be in accordance with the requirements of current editions including amendments of the National Construction Code, relevant Australian Standards & local council requirements.

• New materials are to be used throughout unless otherwise noted.

• Concrete footings, slab, structural beams or any other structural members are to be designed by a practicing engineer.

JJ Drafting Australia P/L.

26/90 Mona Vale Road, Mona Vale, NSW, 2103 PO Box 687, Dee Why, NSW, 2099 Mob. 0414 717 541 | Email. jjdraft@tpg.com.au www.jjdrafting.com.au ACN 651 693 346

	REV:	DATE:	DESCRIPTION:
	Α	2/09/22	PLANS TO BE REVISED BY CLIENT
	В	8/09/22	DA DRAWINGS
)3	С	13/09/22	AMENDED PLANS PER CLIENTS REQUEST
	D	23/09/22	CHANGES TO WINDOWS
au			

PROPOSED ALTERATIONS AND ADDITIONS 44 HILMA STREET COLLAROY PLATEAU NSW 2097
CLIENT: SIMONNE HUNT & DAVID DI BONA
DRAWING TITLE: EXISTING FIRST FLOOR PLAN

DATE:	DRAWN BY:	SCALE:
SEP/22	HR	1:100 @ A3
JOB No:	CHECKED BY:	DRAWING No:
1064/22	JJ	DA.03

Ш

Ш


 \mathcal{L}

ഗ

 \triangleleft

≥


I

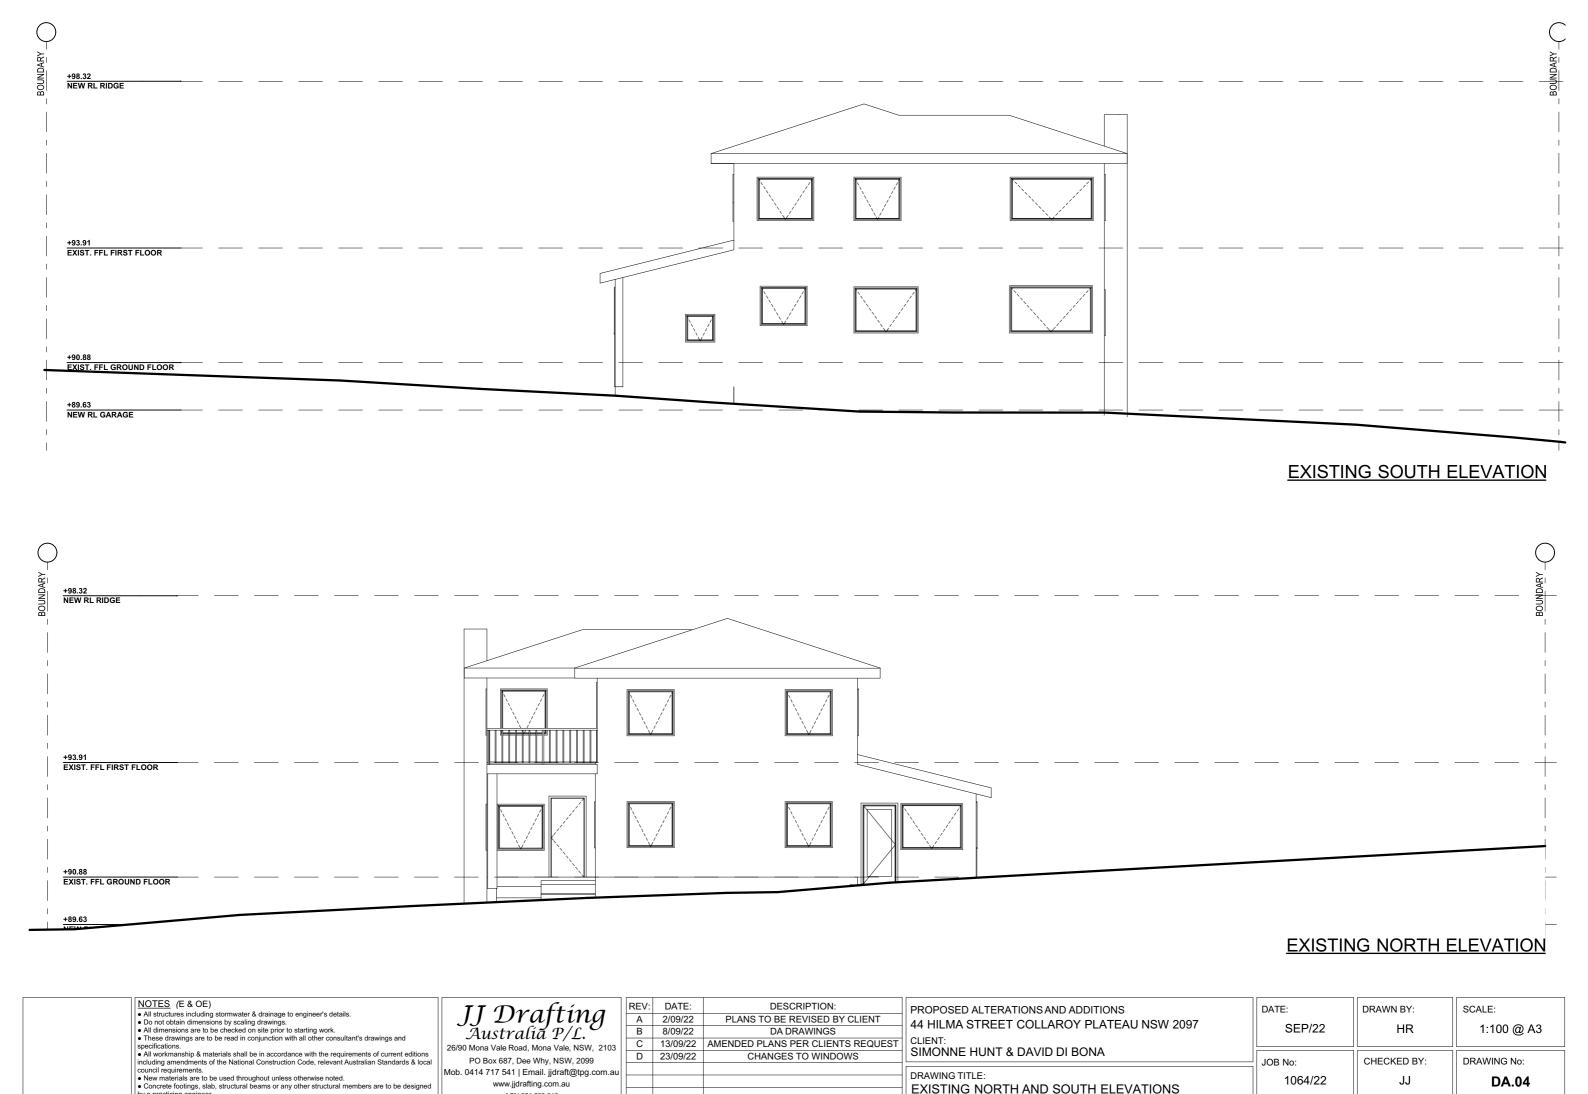

ACN 651 693 346

EXISTING NORTH AND SOUTH ELEVATIONS



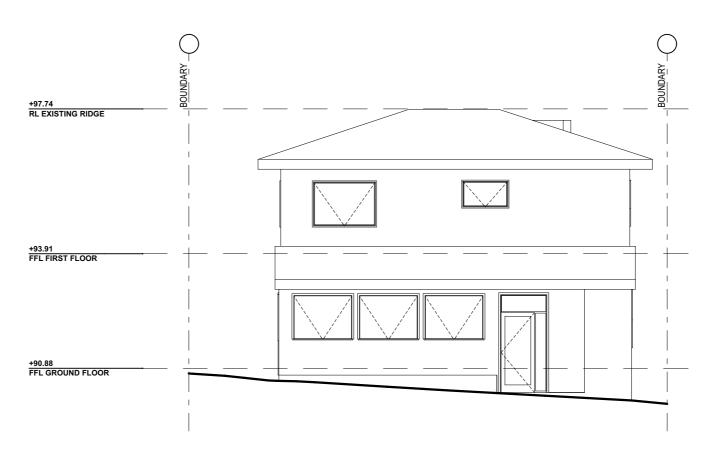

EXISTING WEST ELEVATION

- NOTES (E & OE)

 All structures including stormwater & drainage to engineer's details.

 Do not obtain dimensions by scaling drawings.

 All dimensions are to be checked on site prior to starting work.

 These drawings are to be read in conjunction with all other consultant's drawings and specifications.

 All workmanship & materials shall be in accordance with the requirements of current editions including amendments of the National Construction Code, relevant Australian Standards & local council requirements.

 New materials are to be used throughout unless otherwise noted.


 Concrete footings, slab, structural beams or any other structural members are to be designed by a practicing engineer.

- JJ Drafting Australia P/L. 26/90 Mona Vale Road, Mona Vale, NSW, 2103 PO Box 687, Dee Why, NSW, 2099 Mob. 0414 717 541 | Email. jjdraft@tpg.com.au www.jjdrafting.com.au ACN 651 693 346


	REV:	DATE:	DESCRIPTION:
	Α	2/09/22	PLANS TO BE REVISED BY CLIENT
	В	8/09/22	DA DRAWINGS
	С	13/09/22	AMENDED PLANS PER CLIENTS REQUEST
	D	23/09/22	CHANGES TO WINDOWS
ار			

PROPOSED ALTERATIONS AND ADDITIONS 44 HILMA STREET COLLAROY PLATEAU NSW 2097
CLIENT: SIMONNE HUNT & DAVID DI BONA
DRAWING TITLE: EXISTING WEST AND EAST ELEVATIONS

DATE:	DRAWN BY:	SCALE:
SEP/22	HR	1:100 @ A3
JOB No:	CHECKED BY:	DRAWING No:
1064/22	JJ	DA.05

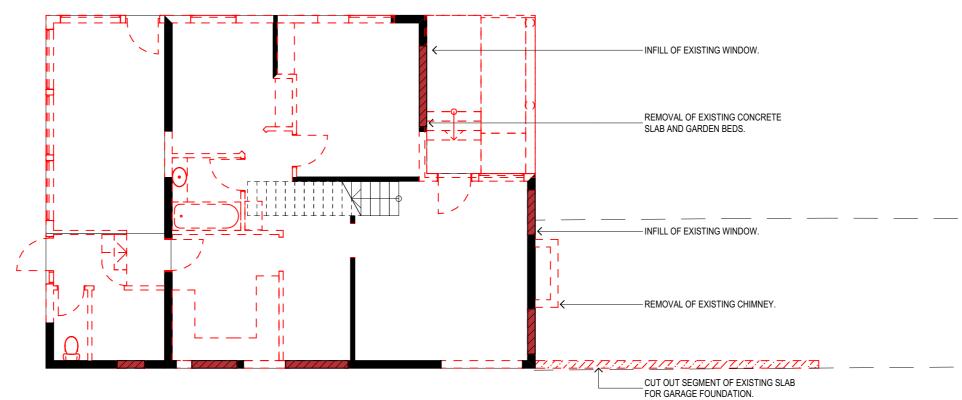

DEMOLITION GROUND FLOOR PLAN

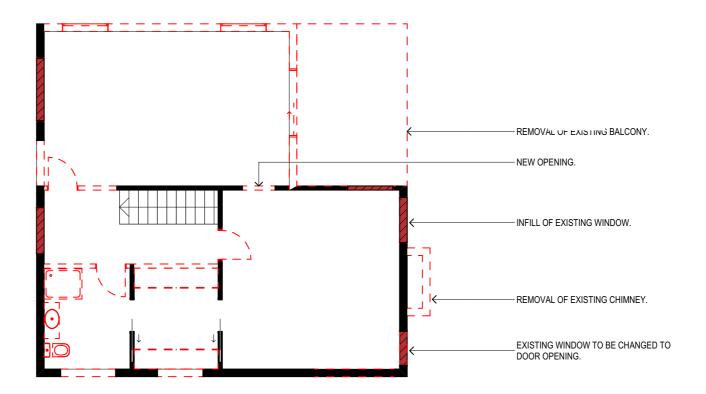

DEMOLITION FIRST FLOOR PLAN

<u>NOTES</u>

ALL DEMOLITION WORK TO COMPLY WITH AS 2601 & SAFE WORK AUSTRALIA CODE OF PRACTICE.

TRUE NORTH:

- NOTES (E & OE)

 All structures including stormwater & drainage to engineer's details.

 Do not obtain dimensions by scaling drawings.

 All dimensions are to be checked on site prior to starting work.

 These drawings are to be read in conjunction with all other consultant's drawings and specifications.


 All workmanship & materials shall be in accordance with the requirements of current editions including amendments of the National Construction Code relevant Australian Standards & local
- All working amendments of the National Construction Code, relevant Australian Standards & local council requirements.
 New materials are to be used throughout unless otherwise noted.
 Concrete footings, slab, structural beams or any other structural members are to be designed by a precision construction. by a practicing engineer.
- JJ Drafting Australia P/L.

26/90 Mona Vale Road, Mona Vale, NSW, 2103 PO Box 687, Dee Why, NSW, 2099 Mob. 0414 717 541 | Email. jjdraft@tpg.com.au www.jjdrafting.com.au ACN 651 693 346

	REV:	DATE:	DESCRIPTION:
	Α	2/09/22	PLANS TO BE REVISED BY CLIENT
	В	8/09/22	DA DRAWINGS
	С	13/09/22	AMENDED PLANS PER CLIENTS REQUEST
	D	23/09/22	CHANGES TO WINDOWS
u			
- 1			

PROPOSED ALTERATIONS AND ADDITIONS 44 HILMA STREET COLLAROY PLATEAU NSW 2097
CLIENT: SIMONNE HUNT & DAVID DI BONA
DRAWING TITLE: DEMOLITION PLAN

DATE:	DRAWN BY:	SCALE:
SEP/22	HR	1:100 @ A3
JOB No:	CHECKED BY:	DRAWING No:
1064/22	JJ	DA.06

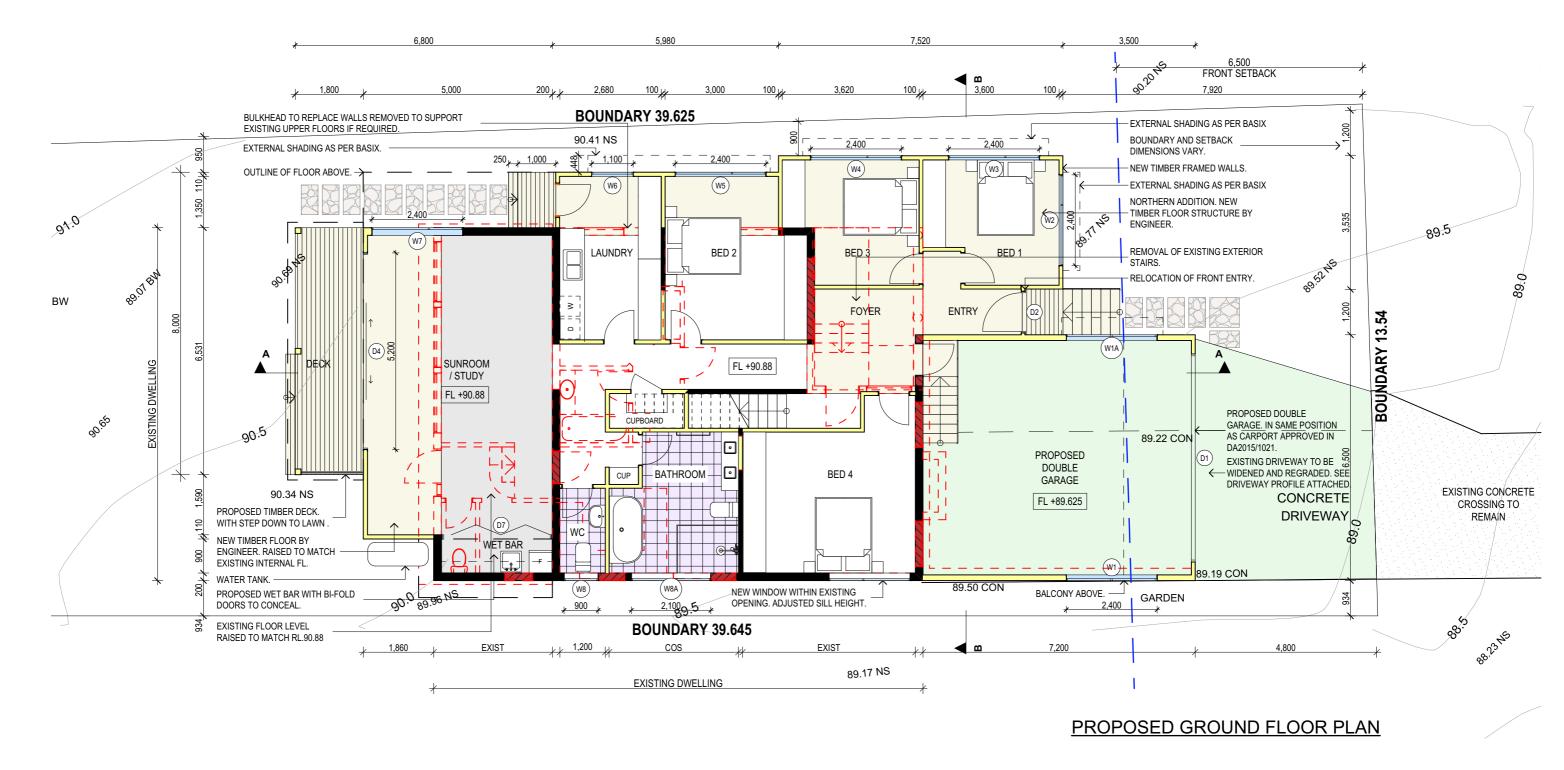

GROUND FLOOR AREA - EXISTING 99.97m² GROUND FLOOR AREA - WITH PROPOSED 156.04m²

TRUE NORTH:

NOTES (E & OE)

All structures including stormwater & drainage to engineer's details
 Do not obtain dimensions by scaling drawings.
 All dimensions are to be checked on site prior to starting work.

. These drawings are to be read in conjunction with all other consultant's drawings and

 New materials are to be used throughout unless otherwise noted.
 Remarks are to be used throughout unless otherwise noted.
 Concrete footings, slab, structural beams or any other structural members are to be designed. by a practicing engineer.

JJ Draftíng ^{Australia} P/L.

26/90 Mona Vale Road, Mona Vale, NSW, 2103 PO Box 687, Dee Why, NSW, 2099 Mob. 0414 717 541 | Email. jjdraft@tpg.com.au www.jjdrafting.com.au ACN 651 693 346

	REV:	DATE:	DESCRIPTION:
	Α	2/09/22	PLANS TO BE REVISED BY CLIENT
	В	8/09/22	DA DRAWINGS
	С	13/09/22	AMENDED PLANS PER CLIENTS REQUEST
	D	23/09/22	CHANGES TO WINDOWS
ار			
-1			


1	PROPOSED ALTERATIONS AND ADDITIONS 44 HILMA STREET COLLAROY PLATEAU NSW 2097	DATE:	DRAWN BY:
1	CLIENT:	SEP/22	HR
1	SIMONNE HUNT & DAVID DI BONA DRAWING TITLE:	JOB No:	CHECKED BY:
ı	GROUND FLOOR PLAN	1064/22	JJ

SCALE:

DRAWING No:

1:100 @ A3

DA.07

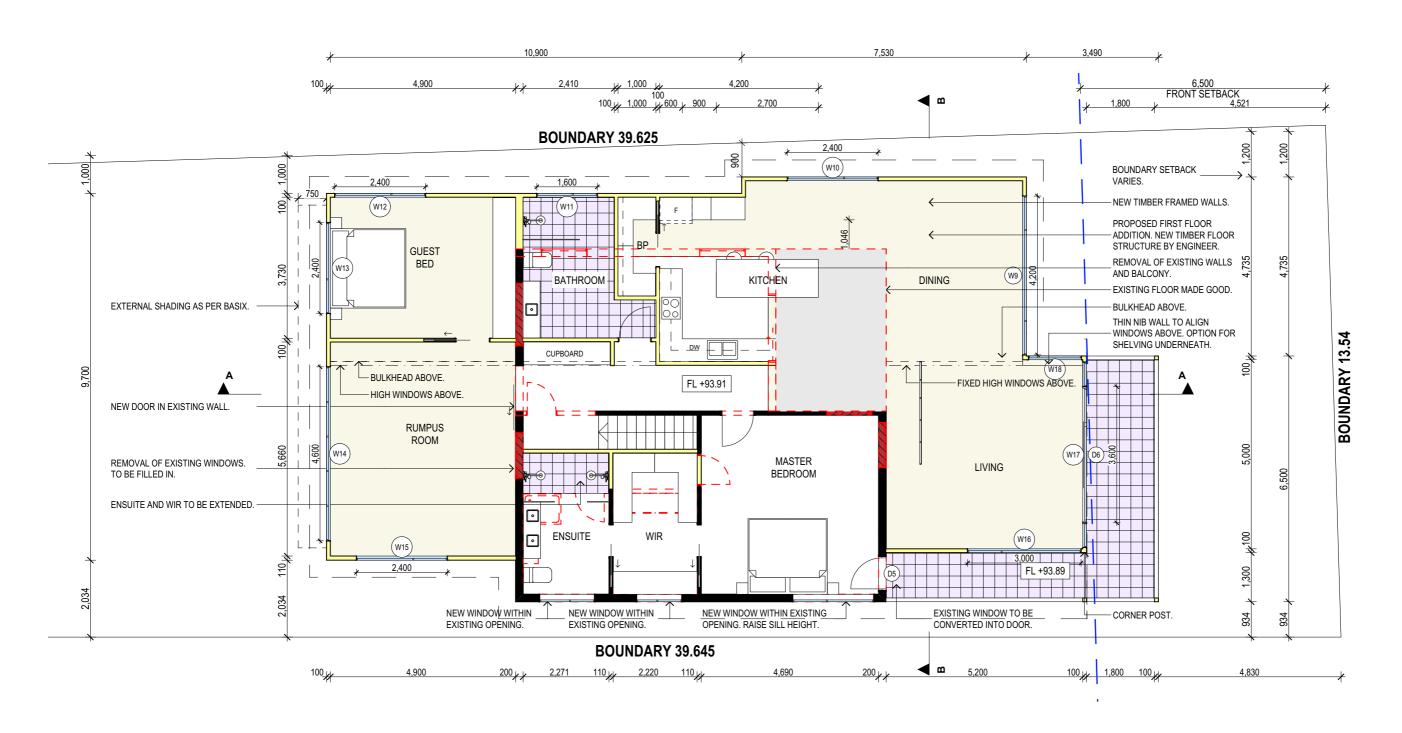

PROPOSED FIRST FLOOR PLAN

FIRST FLOOR AREA - EXISTING 71.38m² FIRST FLOOR AREA - WITH PROPOSED 186.13m²

TRUE NORTH:

NOTES (E & OE)

All structures including stormwater & drainage to engineer's details
 Do not obtain dimensions by scaling drawings.
 All dimensions are to be checked on site prior to starting work.

. These drawings are to be read in conjunction with all other consultant's drawings and All workmanship & materials shall be in accordance with the requirements of current editions


 New materials are to be used throughout unless otherwise noted.
 Concrete footings, slab, structural beams or any other structural members are to be designed. by a practicing engineer.


ACN 651 693 346

l	II Decaftina	REV:	DATE:	DESCRIPTION:
l	JJ Drajing	Α	2/09/22	PLANS TO BE REVISED BY CLIENT
l	JJ Drafting Australia P/L.	В	8/09/22	DA DRAWINGS
l	26/90 Mona Vale Road, Mona Vale, NSW, 2103	С	13/09/22	AMENDED PLANS PER CLIENTS REQUEST
l	PO Box 687, Dee Why, NSW, 2099	D	23/09/22	CHANGES TO WINDOWS
l	Mob. 0414 717 541 Email. jjdraft@tpg.com.au			
I	www.jjdrafting.com.au			
ı	1011054 000 040			

	PROPOSED ALTERATIONS AND ADDITIONS 44 HILMA STREET COLLAROY PLATEAU NSW 2097
ST	CLIENT: SIMONNE HUNT & DAVID DI BONA
_	DRAWING TITLE: FIRST FLOOR PLAN

DATE: DRAWN BY: SCALE: SEP/22 HR 1:100 @ A3 JOB No: CHECKED BY: DRAWING No:	1064/22	JJ	DA.08
	JOB No:	CHECKED BY:	DRAWING No:
DATE: DRAWN BY: SCALE:	SEP/22	HR	1:100 @ A3
	DATE:	DRAWN BY:	SCALE:

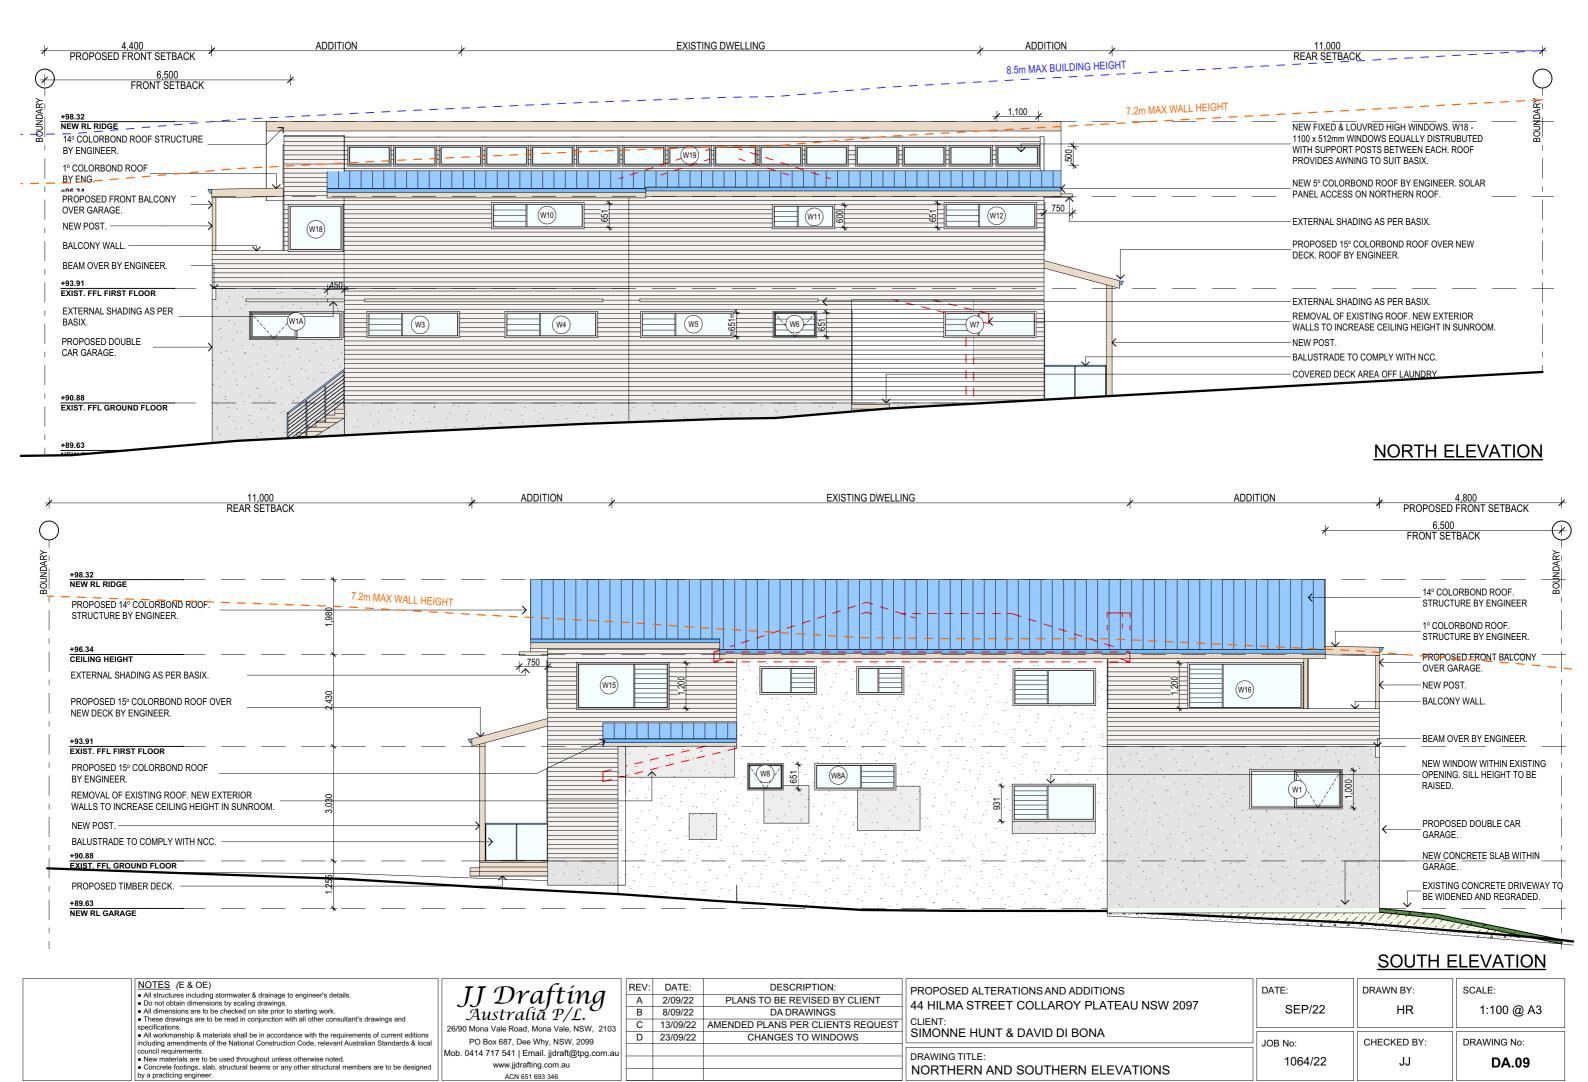

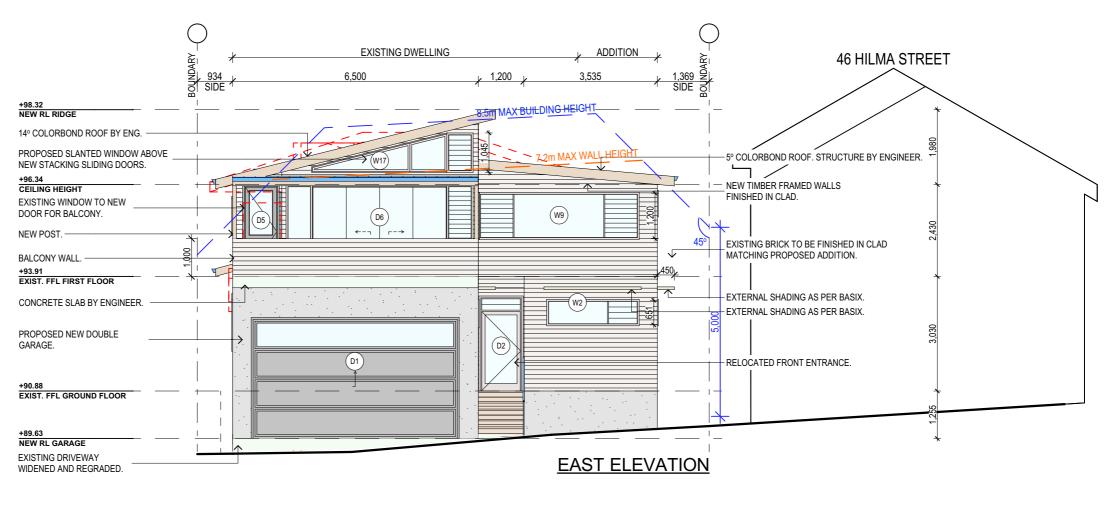



WEST ELEVATION


NOTES (E & OE)

- All structures including stormwater & drainage to engineer's details.
 Do not obtain dimensions by scaling drawings.
 All dimensions are to be checked on site prior to starting work.
- specifications.
 All workmanship & materials shall be in accordance with the requirements of current editions All working amendments of the National Construction Code, relevant Australian Standards & local council requirements.
 New materials are to be used throughout unless otherwise noted.
 Concrete footings, slab, structural beams or any other structural members are to be designed.
- by a practicing engineer.
- JJ Drafting ^{Australia} P/L. 26/90 Mona Vale Road, Mona Vale, NSW, 2103 PO Box 687, Dee Why, NSW, 2099 Mob. 0414 717 541 | Email. jjdraft@tpg.com.au www.jjdrafting.com.au ACN 651 693 346

	REV:	DATE:	DESCRIPTION:
	Α	2/09/22	PLANS TO BE REVISED BY CLIENT
	В	8/09/22	DA DRAWINGS
	С	13/09/22	AMENDED PLANS PER CLIENTS REQUES
	D	23/09/22	CHANGES TO WINDOWS
u l			

PROPOSED ALTERATIONS AND ADDITIONS 44 HILMA STREET COLLAROY PLATEAU NSW 2097	DA
CLIENT: SIMONNE HUNT & DAVID DI BONA	JOE
DRAWING TITLE: WESTERN AND EASTERN ELEVATIONS	

DATE:	DRAWN BY:	SCALE:
SEP/22	HR	1:100 @ A3
JOB No:	CHECKED BY:	DRAWING No:
1064/22	JJ	DA.10

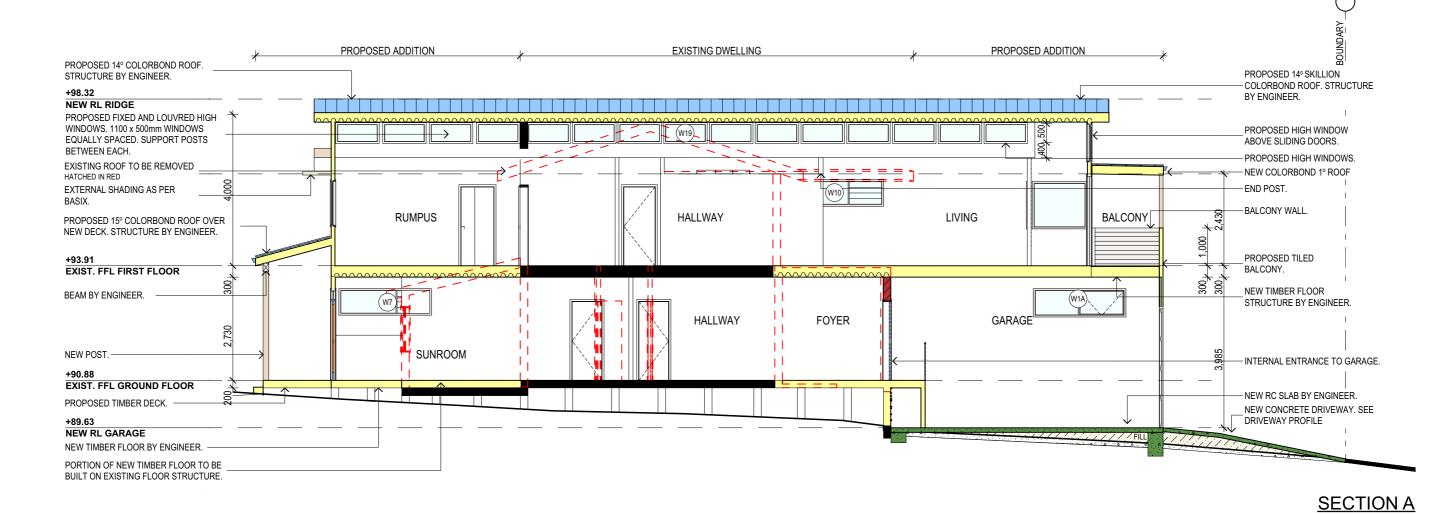

SPECIFICATION NOTES

INTERNAL LINING:

PROVIDE PLASTERBOARD LINING.

EXTERNAL WALLS:

- TIMBER FRAME WALLS FINISHED OFF WITH SELECTED CLADDING.

- TIMBER FLOOR FRAMING TO BE FINISHED WITH SELECTED FLOORING.
- COVER FLOORS OF BATHROOM, SHOWER RECESS, WC AND ES WITH SELECTED TILES, SET IN CEMENT MORTAR OR APPROVED ADHESIVE AND GRATED TO GIVE AN EVEN AND ADEQUATE FALL TO FLOOR WASTE.

- TIMBER DECKING WITH ROUNDED EDGE & 3mm GAP.

BEARERS AND JOISTS:

- SHALL BE INSTALLED TO COMPLY WITH AS1684 AS AMENDED FOR TIMBER COMPONENTS OR AS3620 FOR LIGTHWEIGHT STEEL FRAMING SECTIONS OR AS PER THE NASH ALTERNATIVES TO AS 3623.

ANT CAPS:

- SHALL BE INSTALLED IN ACCORDANCE WITH AS3660.

PREFABRICATED TIMBER WALL FRAMES AND TRUSSES:

- WHERE PREFABRICATED FRAMES AND/OR TRUSSES ARE USED FOR CONSTRUCTION OF THE BUILDING, THE MANUFACTURES CERTTIFICATION OF CONSTRUCTION ACCORDING TO AS1684.2 OR AS1684.4 FOR THE BUILDING ON THE PARTICULAR SITE MUST BE OBTAINED.

STRUCTURAL STEEL

- NCC VOL.2 PART 3.4.4 OR VOL.1 PART B1: ALL STEEL WORK IS TO BE FABRICATED TO DETAILS AS SHOWN ON ENGINEERS DRAWINGS AND IN ACCORDANCE WITH AS4100 STEEL STRUCTURES OR AS/NZS 4600 COLD-FORMED STEEL STRUCTURES.

PROFILED STEEL ROOF:

- NCC VOL.2 PART 3.5.1
- DESIGN AND INSTALLATION SHALL BE IN ACCORDANCE WITH AS/NZS 1562.

ROOFING:

- COLORBOND ROOF CLADDING

- SHALL BE IN ACCORDANCE WITH NCC VOL.1 PART B1.4 OR VOL.2 PART 3.2.3.

- ALL WORKMANSHIP AND MATERIALS SHALL BE IN ACCORDANCE WITH CURRENT EDITIONS OF THE

- FOOTINGS TO BE IN ACCORDANCE WITH AS1480. FOOTINGS TO BE IN ACCORDANCE WITH NCC VOL.2 PARTS 3.2.3, 3.2.4 AND 3.2.5
- ALL REINFORCEMENTS SHALL CONFORM TO AS1302, AS1303 AND AS1304.

BRICK AND BLOCKWORK:

- CONSTRUCTION OF MASONRY BUILDINGS SHALL BE AS PER AS3700 OR AS4773.

- CARPENTRY:
 TIMBER TO COMPLY WITH AS1170.2 OR AS4055.
- ALL WORKMANSHIP AND MATERIALS SHALL BE IN ACCORDANCE WITH AS1684 AND 1720 AS APPLICABLE.

TIMBER FRAMING:

- TO COMPLY WITH NCC VOL.2 PART 3.4
- GROUND FLOOR TIMBERS SHALL BE ONLY OF HARDWOOD, CYPRESS PINE OR PRESSURE TREATED RADIATA OR CANADA PINE BELOW A HEIGHT OF 300mm ABOVE FINISHED GROUND LEVEL AND MUST NOT BE BUILT INTO BRICKWORK
- SUBFLOOR VENTILATION SHALL CONFORM TO NCC VOL.2 PART 3.4.1.
- IN BUSHFIRE PRONE AREAS SPECIAL CONDITIONS APPLY.
- WHERE TERMITE BARRIERS NEED TO BE INSPECTED, 400mm CLEARANCE IS REQUIRED BETWEEN THE
- UNDERSIDE OF BEARER AND GROUND SURFACE. - USE TREATED TIMBER WHERE REQUIRED FOR DURABILITY
- DO NOT USE TIMBER UNSUITABLE FOR EXPOSURE TO MOISTURE IN EXPOSED LOCATION PROVIDE STRUCTURE BRACING IN ACCORDANCE WITH AS1684
- PROVIDE STRUCTURE TIEDOWN IN ACCORDANCE WITH AS1684
- USE GALVANISED FIXINGS WHERE EXPOSED TO WEATHER.

TERMITE CONTROL:

- TO BE IN ACCORDANCE WITH TO AS3660.1
- SHALL BE IN ACCORDANCE WITH NCC VOL.2 PART 3.1.4 OR VOL.1 PART B1.4.

FLASHING AND CAPPINGS:

- SELECTION AND INSTALLATION OF METAL RAINWATER GOODS REFER TO AS2180
- FLASH PROJECTIONS ABOVE THE ROOF WITH TWO PART FLASHINGS CONSISTING OF AN APRON
- FLASHING AND OVER FLASHING, WITH AT LEAST 100mm OVERLAP.
 PROVIDE FOR INDEPENDENT MOVEMENT BETWEEN ROOF AND PROJECTION.

CONCRETE BLOCKS OR BRICKS:
- TO COMPLY WITH TO AS4455 MASONRY BUILDING BLOCKS/PAVER.

LIGHTING:

- 40% OF NEW OR ALTERED LIGHT FIXTURES TO BE FITTED WITH FLUORESCENT, COMPACT FLUORESCENT, OR LIGHT-EMITTING-DIODE (LED) LAMPS

DOORS & WINDOWS:

- ALL FRAMED WINDOWS SHALL BE INSTALLED IN ACCORDANCE WITH AS2047-48 FOR ALUMINIUM
- WINDOWS AND AS2047 FOR TIMBER WINDOWS. ALUMINIUM FRAMED WINDOWS AND DOORS.
- WEATHER STRIPPING IS TO BE PROVIDED TO ALL EXTERNAL WINDOWS AND DOORS.

STAIRS, HANDRAILS AND BALUSTRADES:

- NCC VOL.2 PARTS 3.9.1 AND 3.9.2
- RELATIONSHIP OF RISER TO GOING SHALL BE BETWEEN 1:2 AND 1:1.35 UNLESS OTHERWISE DIRECTED TO GOING SHALL BE BETWEEN 1:2 AND 1:1.35 UNLESS OTHERWISE DIRECTED OR AS PERMITTED IN
- BALUSTRADES SHALL BE PROVIDED TO ALL LANDINGS, RAMPS, DECKS, ROOFS AND OTHER ELEVATED PLATFORMS WHERE THE VERTICAL DISTANCE FROM THAT LEVEL IS MORE THAN 1m ABOVE THE
- ADJOINING FLOOR OR FINISHED GROUND LEVEL.
 THE HEIGHT OF BALUSTRADE MUST BE A MINIMUM OF 1m HIGH ABOVE LANDING AND NOT LESS THAN 865mm ABOVE THE NOSINGS OF ANY STAIR TREADS OR FLOOR RAMP AND HAVE NO OPENING GREATER THAN 125mm
- THE HEIGHT OF BALUSTRADE TO THE NEW STAIRCASES IS TO BE MEASURED A MINIMUM 865mm ABOVE THE NOSING LINE AND HAVE NO OPENING GREATER NO OPENING GREATER THAN 125mm.

- MATERIALS TO BE USED FOR SURFACES OF FLOORS, STAIR LANDING, STEPS AND NOSINGS SHALL BE N ACCORDANCE WITH THE CLASSIFICATIONS FOR SLIP RESISTANCE AS APPLY IN AS4586 AND HB198.

STORMWATER:

EAVES GUTTERS, VALLEY GUTTERS AND DOWPIPES

- TO COMPLY WITH AS/NZS 2179 FOR METAL AND AS1273 FOR UPVC COMPONENTS. IN ACCORDANCE WITH NCC VOL 2 PART $3.5.3\,$
- NEW DOWNPIPES TO BE CONNECTED INTO EXISTING STORMWATER LINE
- COLORBOND GUTTERS AND DOWNPIPES
- MINIMUM SLOPE OF EAVES AND GUTTERS 1:200

WATERPROOFING FOR EXTERNAL TILED BALCONIES:

WATERPROOFING TO COMPLY WITH AS4654

GLAZING: - NCC VOL.1 PARTS B 1.4, D 3.12, F1.13 OR NCC VOL.2 PART 3.6

SMOKE DETECTORS/ALARMS:
- NCC VOL 2 PART 3.7.5. FIRE/SMOKE DETECTORS COMPLYING WITH THE REQUIREMENTS OF THE LOCAL GOVERNMENT ACT AND/OR STATE OR TERRITORY REGULATIONS MUST BE FITTED IN THE LOCATIONS REQUIRED AND APPROVED BY THE AUTHORITY AND SHALL BE INSTALLED IN ACCORDANCE WITH AS3786. - INSTALLATIONS IN BUILDINGS OTHER THAN CLASS 1 AND 10 MUST BE INSTALLED AND MANAGED TO COMPLY WITH NCC SPEC. E2.2a.

- MULTIPLE ALARMS WITHIN HOUSES AND SOLE OCCUPANCY UNITS MUST BE HARD WIRED AND INTERCONNECTED.

WASTE MANAGEMENT:

- ALL WASTE SHALL BE TAKEN AWAY BY TRUCKS TO A SUITABLE LANDFILL OR RECYCLE DEPOT.
- ALL WASTE SHALL BE COVERED DURING TRANSPORTATION. WASTE GENERATED DURING CONSTRUCTION SHALL BE PLACED IN STEEL BINS AND TAKEN AWAY BY AN APPROVED CONTRACTOR TO A APPROVED LANDFILL SITE.

SEDIMENT CONTROL:

- A FILTER CLOTH SYSTEM SHALL BE INSTALLED TO STOP ANY SEDIMENT ENTERING COUNCILS STORMWATER SYSTEM.

ALL PLANS ARE TO BE READ IN CONJUNCTION AND COMPLY WITH THE BASIX CERTIFICATE, BUSHFIRE AND GEOTECH REPORTS.

NOTES	3 (E	&	OE)	

- Do not obtain dimensions by scaling drawings.
 All dimensions are to be checked on site prior to starting work
- These drawings are to be read in conjunction with all other consultant's drawings and All workmanship & materials shall be in accordance with the requirements of current editions
- cluding amendments of the National Construction Code, relevant Australian Sta
- ouncil requirements.

 New materials are to be used throughout unless otherwise noted.

 Concrete footings, slab, structural beams or any other structural members are to be designed. by a practicing engineer.
- II Drafting
- 26/90 Mona Vale Road, Mona Vale, NSW, 2103 PO Box 687, Dee Why, NSW, 2099 Mob. 0414 717 541 | Email. jjdraft@tpg.com.au www.jjdrafting.com.au ACN 651 693 346
- REV: DATE: DESCRIPTION: A 2/09/22 PLANS TO BE REVISED BY CLIENT В 8/09/22 DA DRAWINGS C 13/09/22 AMENDED PLANS PER CLIENTS REQUEST D 23/09/22 CHANGES TO WINDOWS

PROPOSED ALTERATIONS AND ADDITIONS 44 HILMA STREET COLLAROY PLATEAU NSW 2097
CLIENT: SIMONNE HUNT & DAVID DI BONA
DRAWING TITLE: SECTION A

DATE: DRAWN BY SCALE: SEP/22 HR 1:100 @ A3 JOB No: CHECKED BY DRAWING No: 1064/22 JJ DA.11

BASIX REQUIREMENT:

BASIX Inclusions for 44 Hilma Street, Collaroy Plateau

LIGHTING REQUIREMENTS

40% OF NEW OR ALTERED LIGHT FIXTURES TO BE FITTED WITH FLUORESCENT, COMPACT FLUORESCENT, OR LIGHT-EMITTING-DIODE (LED) LAMPS

- SHOWER RATING	MINIMUM 3 STAR
- TAP RATING	MINIMUM 3 STAR
- WC'S RATING-	MINIMUM 3 STAR
- WO STATING	IVIII VIII J J I AI C

INSULATION REQUIREMENTS

CONSTRUCTION	ADDITIONAL INSULATION REQUIREMENT (R-VALUE)
CONCRETE SLAB ON GROUND FLOOR	NIL
SUSPENDED FLOOR WITH ENCLOSED SUBFLOOR: FRAMED (R0.7)	R 0.6 (DOWN) (OR R 1.30 INCLUDING CONSTRUCTION)
SUSPENDED FLOOR ABOVE GARAGE: FRAMED (R0.7)	NIL
FLOOR ABOVE EXISTING DWELLING OR BUILDING.	NIL
EXTERNAL WALL: FRAMED (WEATHERBOARD, FIBRO, METAL CLAD)	R 1.30 (OR R 1.70 INCLUDING CONSTRUCTION)
INTERNAL WALL SHARED WITH GARAGE: PLASTERBOARD (R0.36)	NIL
FLAT CEILING, FLAT ROOF: FRAMED	Ceiling: R2.08 (up), roof: foil backed blanket (55 mm) Medium (solar absorptance 0.475 - 0.7)
RAKED CEILING, PITCHED/SKILLION ROOF:FRAMED	Ceiling: R2.24 (up), roof: foil backed blanket (55 mm) Medium (solar absorptance 0.475 - 0.7)

GLAZING DOORS / WINDOWS:


- W1 Standard aluminium, SINGLE CLEAR, (U-value: 7.63, SHGC: 0.75)
- W1A Standard aluminium, SINGLE PYROLYTIC LOW-E, (U-value: 5.7, SHGC: 0.47)
- W2 Standard aluminium, SINGLE PYROLYTIC LOW-E, (U-value: 5.7, SHGC: 0.47)
- W3 Standard aluminium, SINGLE PYROLYTIC LOW-E, (U-value: 5.7, SHGC: 0.47)
- W4 Standard aluminium, SINGLE PYROLYTIC LOW-E, (U-value: 5.7, SHGC: 0.47)
- W5 Standard aluminium, SINGLE PYROLYTIC LOW-E, (U-value: 5.7, SHGC: 0.47)
- W6 Standard aluminium, SINGLE CLEAR, (U-value: 7.63, SHGC: 0.75)
- W7 Standard aluminium, SINGLE CLEAR, (U-value: 7.63, SHGC: 0.75)
- W8 Standard aluminium, SINGLE CLEAR, (U-value: 7.63, SHGC: 0.75)
- W8A Standard aluminium, SINGLE CLEAR, (U-value: 7.63, SHGC: 0.75)
- W9 Standard aluminium, SINGLE PYROLYTIC LOW-E, (U-value: 5.7, SHGC: 0.47)
- W10 Standard aluminium, SINGLE PYROLYTIC LOW-E, (U-value: 5.7, SHGC: 0.47)
- W11 Standard aluminium, SINGLE PYROLYTIC LOW-E, (U-value: 5.7, SHGC: 0.47)
- W12 Standard aluminium, SINGLE PYROLYTIC LOW-E, (U-value: 5.7, SHGC: 0.47)
- W13 Standard aluminium, SINGLE CLEAR, (U-value: 7.63, SHGC: 0.75)
- W14 Standard aluminium, SINGLE CLEAR, (U-value: 7.63, SHGC: 0.75)
- W15 Standard aluminium, SINGLE CLEAR, (U-value: 7.63, SHGC: 0.75)
- W16 Standard aluminium, SINGLE CLEAR, (U-value: 7.63, SHGC: 0.75)
- W17 Standard aluminium, SINGLE CLEAR, (U-value: 7.63, SHGC: 0.75)
- W18 Standard aluminium, SINGLE PYROLYTIC LOW-E, (U-value: 5.7, SHGC: 0.47)
- W19 Standard aluminium, SINGLE PYROLYTIC LOW-E, (U-value: 5.7, SHGC: 0.47)
- D2 Standard aluminium, SINGLE CLEAR, (U-value: 7.63, SHGC: 0.75)
- D3 Standard aluminium, SINGLE CLEAR, (U-value: 7.63, SHGC: 0.75)
- D4 Standard aluminium, SINGLE CLEAR, (U-value: 7.63, SHGC: 0.75)
- D5 Standard aluminium, SINGLE CLEAR, (U-value: 7.63, SHGC: 0.75)
- D6 Standard aluminium, SINGLE CLEAR, (U-value: 7.63, SHGC: 0.75)


TRUE NORTH:



- NOTES (E & OE)
- All structures including stormwater & drainage to engineer's details.
 Do not obtain dimensions by scaling drawings.
 All dimensions are to be checked on site prior to starting work.
- These drawings are to be read in conjunction with all other consultant's drawings and
- specifications.

 All workmanship & materials shall be in accordance with the requirements of current editions
- New materials are to be used throughout unless otherwise noted.
 Remarks are to be used throughout unless otherwise noted.
 Concrete footings, slab, structural beams or any other structural members are to be designed.
- by a practicing engineer.

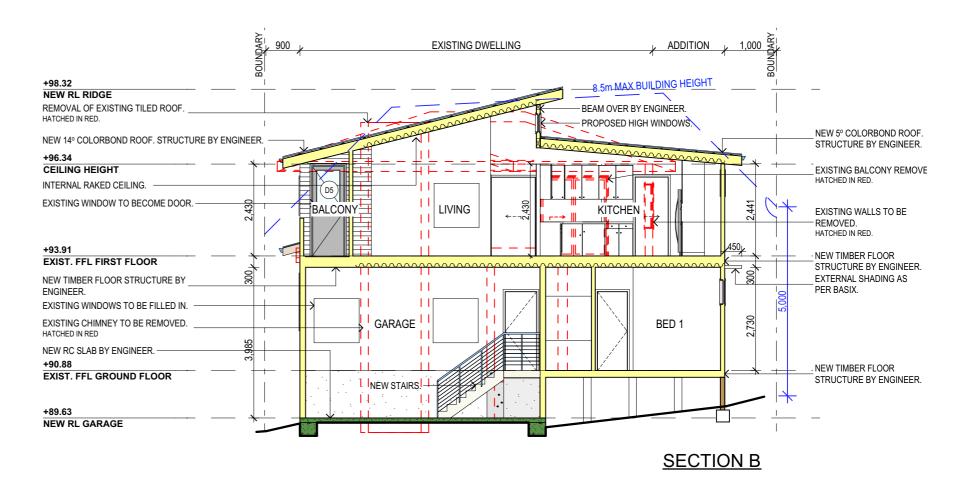

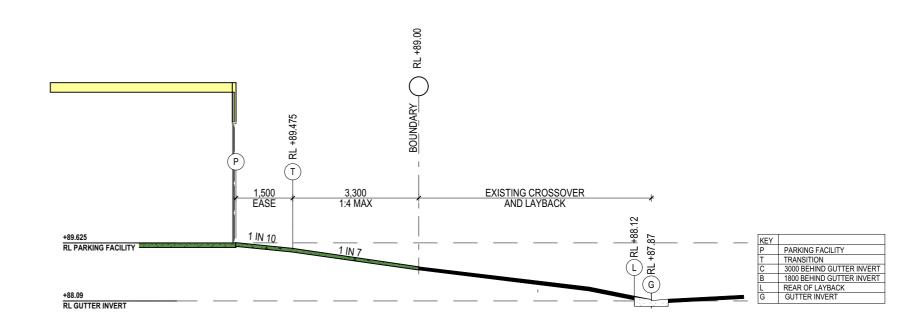

DRIVEWAY PROFILE

SCALE:

DRAWING No:

1:100 @ A3


DA.12

JJ Drafting Australia P/L.


26/90 Mona Vale Road, Mona Vale, NSW, 2103 PO Box 687, Dee Why, NSW, 2099 Mob. 0414 717 541 | Email. jjdraft@tpg.com.a www.jjdrafting.com.au ACN 651 693 346


	REV:	DATE:	DESCRIPTION:
	Α	2/09/22	PLANS TO BE REVISED BY CLIENT
	В	8/09/22	DA DRAWINGS
3	С	13/09/22	AMENDED PLANS PER CLIENTS REQUEST
1	D	23/09/22	CHANGES TO WINDOWS
au			
- 1			

	PROPOSED ALTERATIONS AND ADDITIONS 44 HILMA STREET COLLAROY PLATEAU NSW 2097 CLIENT:	DATE: SEP/22	DRAWN BY:
	SIMONNE HUNT & DAVID DI BONA	JOB No:	CHECKED BY:
ı	DRAWING TITLE: SECTION B, DRIVEWAY PROFILE AND BASIX	1064/22	JJ

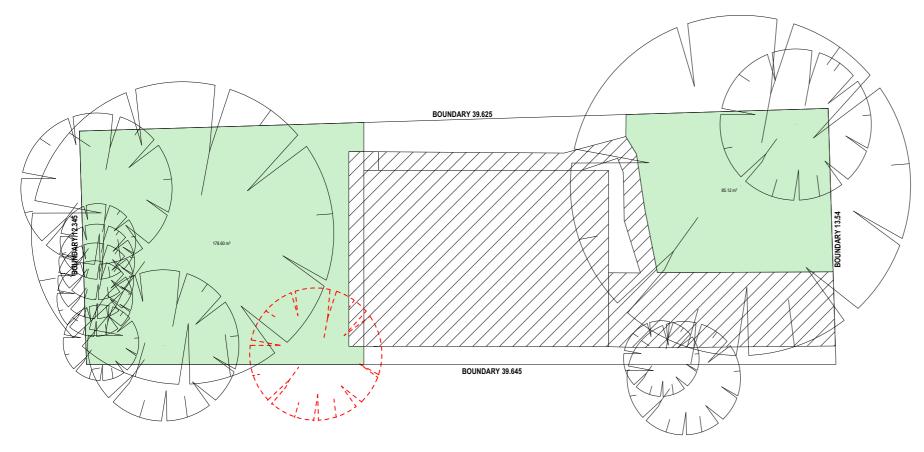

EXISTING LANDSCAPED AREA CALCULATION PLAN

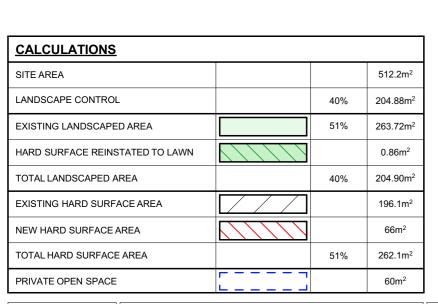

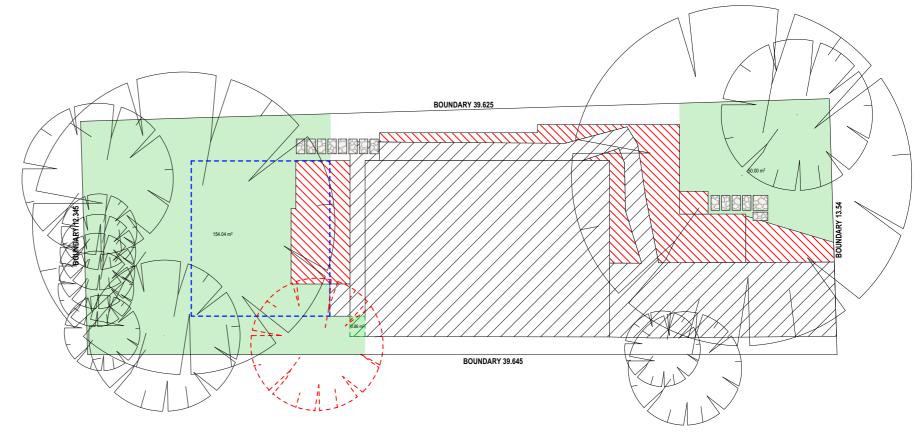

PROPOSED LANDSCAPED AREA CALCULATION PLAN

TRUE NORTH:



- NOTES (E & OE)

 All structures including stormwater & drainage to engineer's details.

 Do not obtain dimensions by scaling drawings.

 All dimensions are to be checked on site prior to starting work.

 These drawings are to be read in conjunction with all other consultant's drawings and

- All working an indefined strain be in accordance with the requirements of content editions including amendments of the National Construction Code, relevant Australian Standards & local council requirements.

 New materials are to be used throughout unless otherwise noted.

 Concrete footings, slab, structural beams or any other structural members are to be designed by a contribition analysis. by a practicing engineer.


JJ Drafting ^{Australia} P/L.

26/90 Mona Vale Road, Mona Vale, NSW, 2103 PO Box 687, Dee Why, NSW, 2099 Mob. 0414 717 541 | Email. jjdraft@tpg.com.au www.jjdrafting.com.au ACN 651 693 346


	REV:	DATE:	DESCRIPTION:
	Α	2/09/22	PLANS TO BE REVISED BY CLIENT
	В	8/09/22	DA DRAWINGS
)3	С	13/09/22	AMENDED PLANS PER CLIENTS REQUEST
	D	23/09/22	CHANGES TO WINDOWS
au			

PROPOSED ALTERATIONS AND ADDITIONS 44 HILMA STREET COLLAROY PLATEAU NSW 2097	DATE:
CLIENT: SIMONNE HUNT & DAVID DI BONA	JOB No:
DRAWING TITLE: LANDSCAPED AREA CALCULATION PLAN	1064/2

DATE:	DRAWN BY:	SCALE:
SEP/22	HR	1:1, 1:200 @ A3
OB No:	CHECKED BY:	DRAWING No:
1064/22	JJ	DA.13

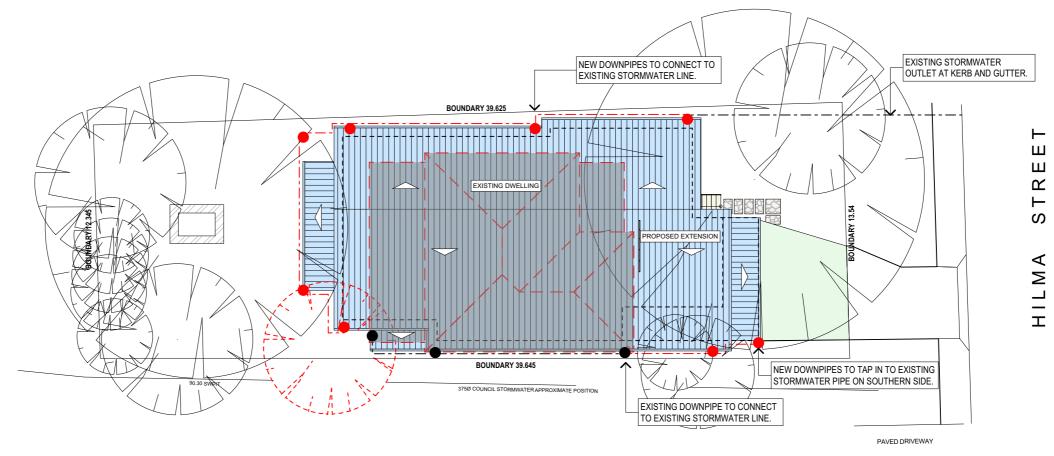

ROOF & STORMWATER CONCEPT PLAN

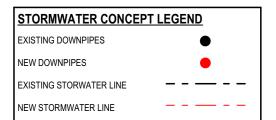

TRUE NORTH:



- NOTES (E & OE)

 All structures including stormwater & drainage to engineer's details.

 Do not obtain dimensions by scaling drawings.
 All dimensions are to be checked on site prior to starting work.

- All working amendments of the National Construction Code, relevant Australian Standards & local council requirements.
 New materials are to be used throughout unless otherwise noted.
 Concrete footings, slab, structural beams or any other structural members are to be designed by a precision construction construction. by a practicing engineer.

JJ Drafting Australia P/L.

26/90 Mona Vale Road, Mona Vale, NSW, 2103 PO Box 687, Dee Why, NSW, 2099 Mob. 0414 717 541 | Email. jjdraft@tpg.com.au www.jjdrafting.com.au ACN 651 693 346

	REV:	DATE:	DESCRIPTION:
	Α	2/09/22	PLANS TO BE REVISED BY CLIENT
	В	8/09/22	DA DRAWINGS
:	С	13/09/22	AMENDED PLANS PER CLIENTS REQUEST
	D	23/09/22	CHANGES TO WINDOWS
u l			

1	PROPOSED ALTERATIONS AND ADDITIONS	DATE:	DRAWN BY:	SCALE:
	44 HILMA STREET COLLAROY PLATEAU NSW 2097	SEP/22	HR	1:200 @ A3
1	CLIENT:	OLI 722	1111	1.200 @ 710
-	SIMONNE HUNT & DAVID DI BONA	JOB No:	CHECKED BY:	DRAWING No:
1	DRAWING TITLE: ROOF & STORMWATER CONCEPT PLAN	1064/22	JJ	DA.14

I

NOTES

DESIGNATED SITE MANAGER/BUILDER

PRIOR TO COMMENCEMENT OF WORK A SITE MANAGER OR BUILDER MUST BE NOMINATED. THE SITE MANAGER OR BUILDER WILL BE RESPONSIBLE AND LIABLE FOR ALL WORKS CARRIED OUT ON THE SITE. THIS ASSUMES THE RESPONSIBILITY FOR THE ACTIONS OF ALL SUBCONTRACTED PARTIES AS WELL AS ADVISING THEM OF COUNCIL'S REQUIREMENTS WHEN CARRYING OUT

TOPSOIL MANAGEMENT

PRIOR TO THE STRIPPING OF TOPSOIL, THE VEGETATIVE COVER MUST BE REDUCED BY EITHER SLASHING OR MOWING. ALL TOPSOIL IS TO BE RETAINED AND PROTECTED FOR REUSE ON SITE. SOIL STOCKPILES MUST NOT BE LOCATED ON NATURE STRIPS, FOOTPATHS, ROADWAYS, KERBS, ACCESSWAYS, WITHIN DRAINAGE LINES/FLOWS/PATHS OR AROUND OR AGAINST TREE SHRUBS. SEDIMENT CONTROL MEASURES MUST BE INCORPORATED WITH ANY RESULTING STOCKPILE. THE STOCKPILE CAN BE PROTECTED FROM EROSION BY COVERING IT WITH AN MPERVIOUS MATERIAL, IN CONJUNCTION WITH THE INSTALLATION OF A SEDIMENT FENCE AROUND IT. IF STOCKPILES ARE TO REMAIN FOR MORE THAN ONE MONTH THEY ARE TO BE GRASSED IMMEDIATELY AND STABILISED WITHIN FOURTEEN DAYS. SURPLUS TOPSOIL MUST BE REASONABLY REMOVED FROM SITE.

BUILDING MATERIAL STOCKPILING

SUFFICIENT AREA MUST BE ALLOCATED WITHIN THE SITE FOR SUCH STORAGE OF BUILDING MATERIALS, DEMOLITION WASTE, WASTE CONTAINERS, ETC. AS WILL BE REQUIRED.

A SEDIMENT FENCE SHOULD BE LOCATED ALONG THE DOWNSLOPE BOUNDARY(S) OF THE SITE. ON THE CONSTRUCTION SIDE OF THE TURF FILTER STRIP OR NATIVE VEGETATION, AND AROUND ALL STOCKPILES OF MATERIAL ON THE SITE.

ALL TRUCKS/UTES MUST COVER THEIR LOADS AT ALL TIMES. APPROPRIATE METHODS ARE TO BE EMPLOYED TO PREVENT BLOWING DUST CREATING AN UNACCEPTABLE HAZARD OR NUISANCE ON THE SITE OR DOWN WIND. PRODUCTION OF DUST CAN BE MINIMISED BY LIMITING AREA OF EARTHWORKS, WATERING AND PROGRESSIVE VEGETATION. WHERE DUST IS CREATED AS A RESULT WORKS AND/OR SOIL EXPOSURE, THE BARE SOIL AREAS MUST BE WATERED, DURING AND/OR AT THE END OF EACH DAY TO LAY THE DUST. EARTH MOVING ACTIVITIES SHOULD BE AVOIDED WHERE WINDS ARE SUFFICIENTLY STRONG ENOUGH TO RAISE VISIBLE

EROSION & SEDIMENT CONTROLS

APPROPRIATE EROSION AND SEDIMENT CONTROLS MUST BE IMPLEMENTED ON ALL SITES THAT INVOLVE SOIL DISTURBANCE. THE MEASURES MUST BE IN PLACE PRIOR TO THE COMMENCEMENT OF WORK. THOSE CONTROLS ARE TO BE MONITORED AND MAINTAINED IN ORDER TO SERVE THEIR INTENDED FUNCTION FOR THE DURATION OF THE WORKS OR UNTIL SUCH TIME AS THE SITE IS FULLY STABILISED. IF ANY CONTROLS ARE DAMAGED OR BECOME INEFFECTIVE DURING THE COURSE OF THE WORKS THEY ARE TO BE REINSTATED OR REPLACED IMMEDIATELY. SUFFICIENT ACCESS TO THESE CONTROLS MUST BE PROVIDED IN CASE OF THE

SEDIMENT TRAPS


WHERE A SEDIMENT FENCE IS NOT USED APPROPRIATE SEDIMENT TRAPS SHOULD BE LOCATED. AT ALL POINTS WHERE STORMWATER LEAVES THE CONSTRUCTION SITE OR LEAVES THE GUTTER AND ENTERS THE DRAINAGE SYSTEM. A COMMON TECHNIQUE IS THE GRAVEL SAUSAGE.

DIVERSION CHANNELS


A DIVERSION CHANNEL IS AN EXCAVATED EARTH DITCH OR PATH. THESE STRUCTURES ARE USED TO INTERCEPT AND DIRECT RUN-OFF TO A DESIRED LOCATION WHERE POSSIBLE. ALL STORMWATER RUN-OFF FLOWING ONTO DISTURBED AREAS, INCLUDING STOCKPILES, MUST BE INTERCEPTED, DIVERTED AND/OR SAFELY DISPOSED OF. THIS CAN BE ACHIEVED BY CONSTRUCTING A TEMPORARY EARTH BANK AROUND THE UPSLOPE EXTENT OF THE CONSTRUCTION SITE WHERE THE DIVERSION DOES NOT AFFECT THE NEIGHBOURING


VEHICLE MOVEMENTS

TO LIMIT DISTURBANCE TO THE SITE AND TRACKING OF MATERIAL ONTO THE STREET ALL VEHICLES AND PLANT EQUIPMENT ARE TO USE A SINGLE ENTRY/EXIT POINT UNLESS COUNCIL HAS APPROVED ALTERNATIVE ARRANGEMENTS. ACCESS POINTS AND PARKING AREAS ARE TO BE STABILISED WITH COMPACTED SUB-GRADE ASAP AFTER THEIR FORMATION. IF SPILLAGE DOES OCCUR IT IS TO BE CONTAINED IMMEDIATELY AND CAREFULLY REMOVED. THE AREA AFFECTED IS TO BE RESTORED TO A STANDARD EQUAL TO OR BETTER THAN ITS PREVIOUS CONDITION. ALL VEHICLES ARE TO BE WASHED PRIOR TO EXISTING THE SITE. THIS SERVES THE PURPOSE OF REMOVING SITE MATERIAL ON THE VEHICLE AND PREVENTS IT FROM BEING DEPOSITED ON THE ROAD NETWORK ADJACENT TO THE SITE AND THUS, THE STORMWATER SYSTEM. NO VEHICLE ASSOCIATED WITH THE WORK IS TO BE PARKED ON A FOOTPATH OR PUBLIC RESERVE. ALL VEHICLES VISITING THE SITE DURING DEMOLITION, EXCAVATION AND/OR CONSTRUCTION WORKS, ARE TO COMPLY WITH THE PARKING REQUIREMENTS IN THAT AREA.

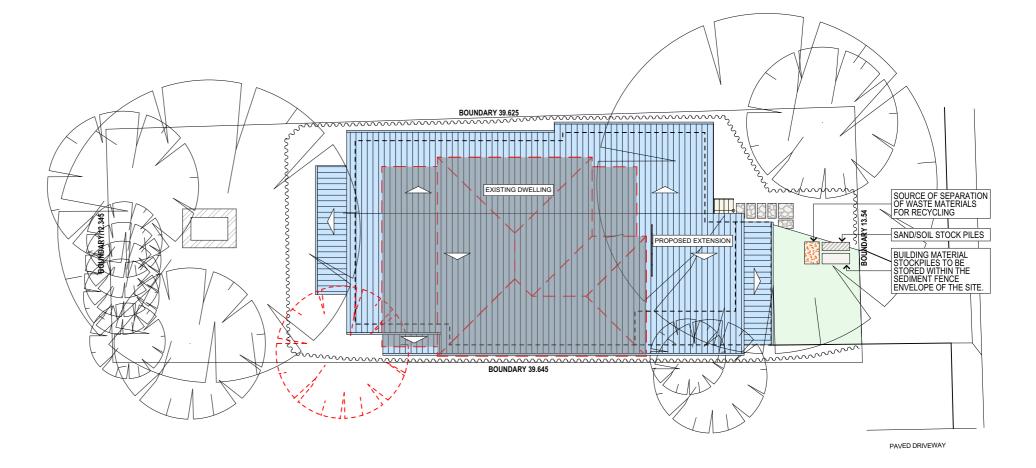

EROSION & SEDIMENT CONTROL PLAN

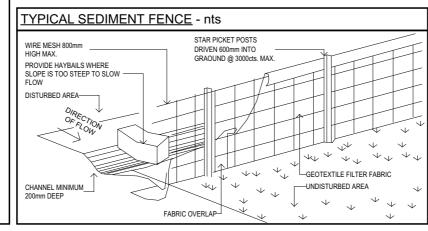

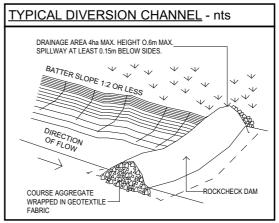

TRUE NORTH:



- NOTES (E & OE) All structures including stormwater & drainage to engineer's details
 Do not obtain dimensions by scaling drawings.
 All dimensions are to be checked on site prior to starting work.
- These drawings are to be read in conjunction with all other consultant's drawings and
- All workmanship & materials shall be in accordance with the requirements of current editions
- nts of the National Construction Code, relevant Australian Sta

- council requirements.

 New materials are to be used throughout unless otherwise noted.

 Concrete footings, slab, structural beams or any other structural members are to be designed by a practicing engineer.


.Austral 26/90 Mona Vale Road, PO Box 687, Dee Mob. 0414 717 541 | En

www.iidraft

aftina	REV:	DATE:	DESCRIPTION:
afting	Α	2/09/22	PLANS TO BE REVISED BY CLIENT
lia P/L. O	В	8/09/22	DA DRAWINGS
, Mona Vale, NSW, 2103	С	13/09/22	AMENDED PLANS PER CLIENTS REQUEST
e Why, NSW, 2099	D	23/09/22	CHANGES TO WINDOWS
mail. jjdraft@tpg.com.au			
fting.com.au			
1 603 346			

PROPOSED ALTERATIONS AND ADDITIONS 14 HILMA STREET COLLAROY PLATEAU NSW 2097	D
CLIENT: SIMONNE HUNT & DAVID DI BONA	
PRAWING TITLE: EROSION & SEDIMENT CONTROL / WASTE MANAGEMENT	
OLAN.	

DATE:	DRAWN BY:	SCALE:
SEP/22	HR	1:200 @ A3
JOB No:	CHECKED BY:	DRAWING No:
1064/22	JJ	DA.15

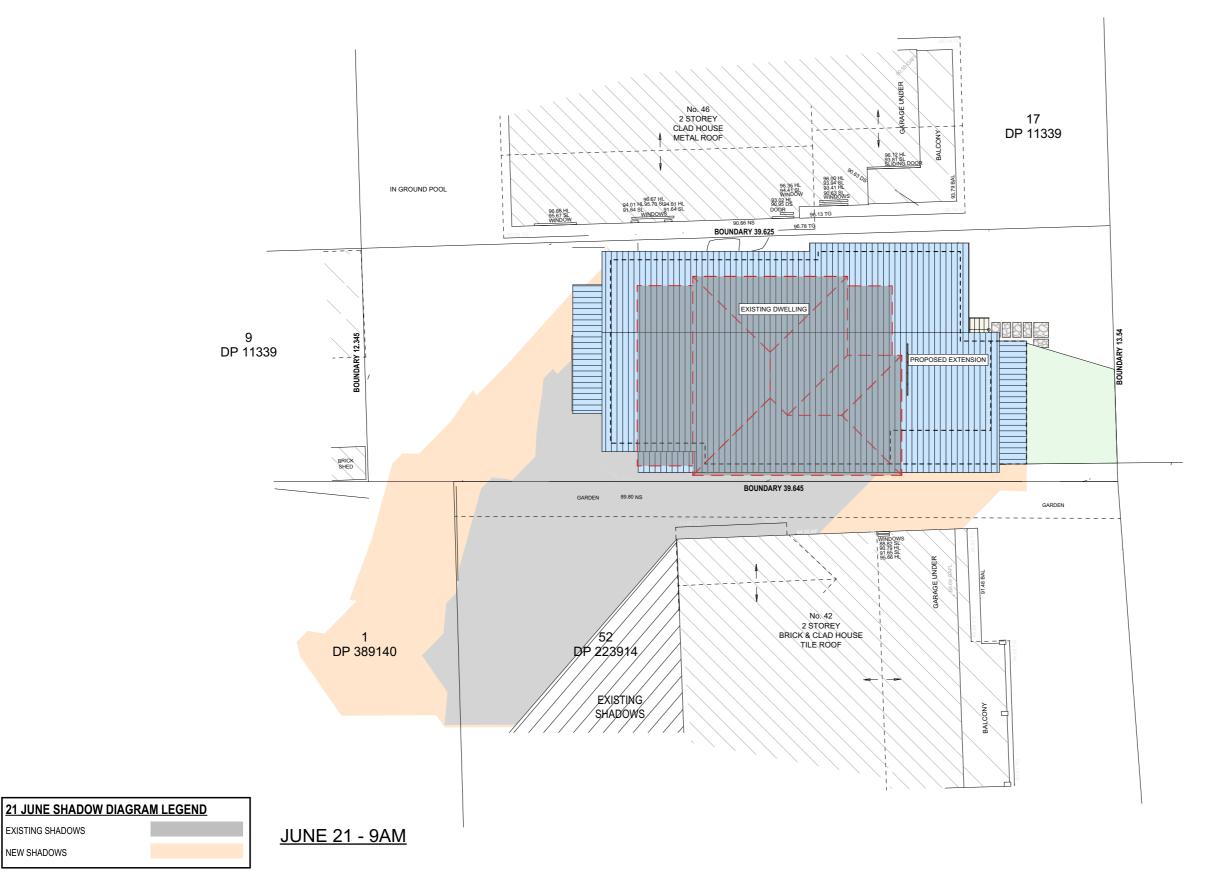

TRUE NORTH:

NEW SHADOWS

EXISTING SHADOWS

- NOTES (E & OE)

 All structures including stormwater & drainage to engineer's details.

 Do not obtain dimensions by scaling drawings.

 All dimensions are to be checked on site prior to starting work.

 These drawings are to be read in conjunction with all other consultant's drawings and specifications.

 All workmanship & materials shall be in accordance with the requirements of current editions including amendments of the National Construction Code relevant Australian Standards & local

- All workmanship & materials shall be in accordance with the requirements of current editions including amendments of the National Construction Code, relevant Australian Standards & local council requirements.

 New materials are to be used throughout unless otherwise noted.

 Concrete footings, slab, structural beams or any other structural members are to be designed by a practicing engineer.


JJ Drafting Australia P/L.

26/90 Mona Vale Road, Mona Vale, NSW, 2103 PO Box 687, Dee Why, NSW, 2099 Mob. 0414 717 541 | Email. jjdraft@tpg.com.a www.jjdrafting.com.au ACN 651 693 346

	RE	V:	DATE:	DESCRIPTION:
	1	4	2/09/22	PLANS TO BE REVISED BY CLIENT
	E	3	8/09/22	DA DRAWINGS
)3)	13/09/22	AMENDED PLANS PER CLIENTS REQUEST
)	23/09/22	CHANGES TO WINDOWS
au				

44 HILMA STREET COLLAROY PLATEAU NSW 2097 CLIENT: SIMONNE HUNT & DAVID DI BONA DRAWING TITLE:		
SIMONNE HUNT & DAVID DI BONA DRAWING TITLE:	PROPOSED ALTERATIONS AND ADDITIONS 44 HILMA STREET COLLAROY PLATEAU NSW 2097	
	CLIENT: SIMONNE HUNT & DAVID DI BONA][][_
	DRAWING TITLE: SHADOW DIAGRAM JUNE 21 9am	

DATE:	DRAWN BY:	SCALE:
SEP/22	HR	1:200 @ A3
JOB No:	CHECKED BY:	DRAWING No:
1064/22	JJ	DA.16

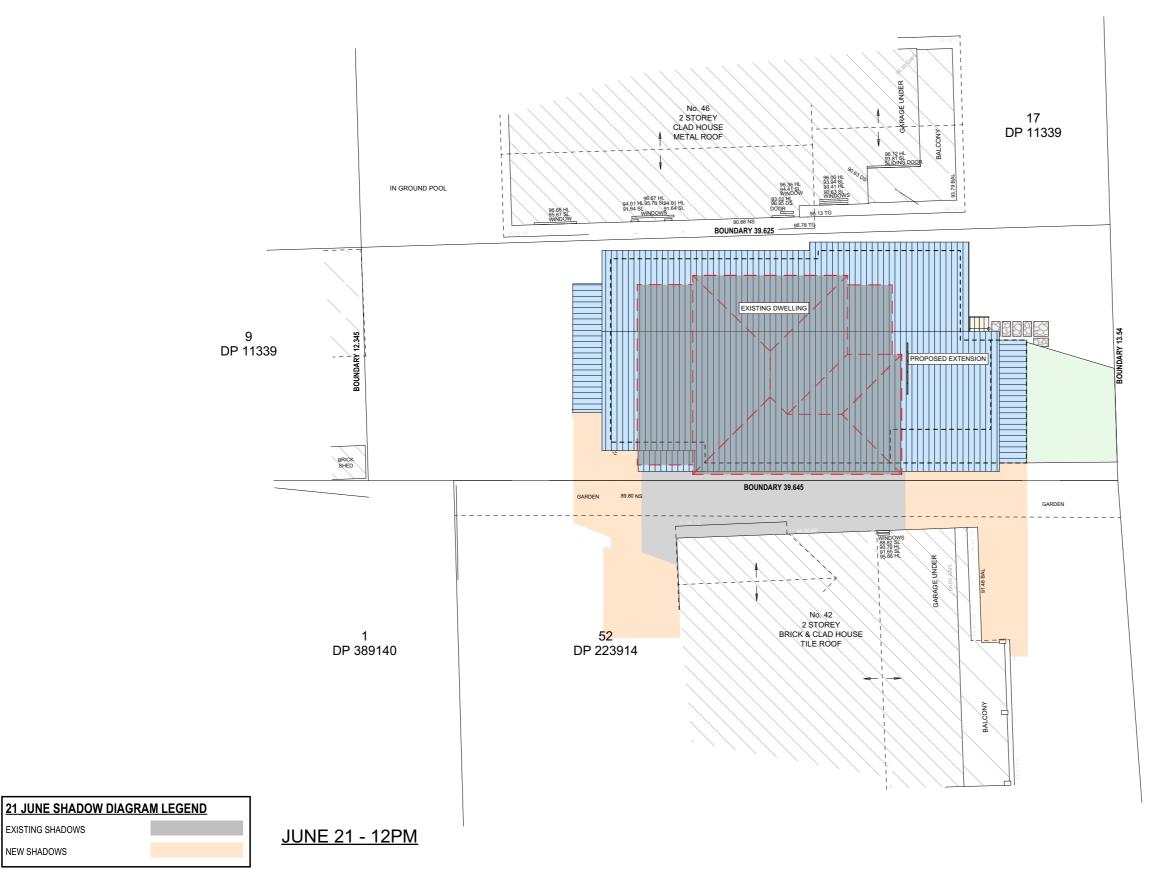

TRUE NORTH:

NEW SHADOWS

- NOTES (E & OE)

 All structures including stormwater & drainage to engineer's details.

 Do not obtain dimensions by scaling drawings.

 All dimensions are to be checked on site prior to starting work.

 These drawings are to be read in conjunction with all other consultant's drawings and specifications.

 All workmanship & materials shall be in accordance with the requirements of current editions including amendments of the National Construction Code relevant Australian Standards & local
- All workmanship & materials shall be in accordance with the requirements of current editions including amendments of the National Construction Code, relevant Australian Standards & local council requirements.

 New materials are to be used throughout unless otherwise noted.

 Concrete footings, slab, structural beams or any other structural members are to be designed by a practicing engineer.


JJ Drafting Australia P/L.

26/90 Mona Vale Road, Mona Vale, NSW, 2103 PO Box 687, Dee Why, NSW, 2099 Mob. 0414 717 541 | Email. jjdraft@tpg.com.a www.jjdrafting.com.au ACN 651 693 346

	REV:	DATE:	DESCRIPTION:
	Α	2/09/22	PLANS TO BE REVISED BY CLIENT
	В	8/09/22	DA DRAWINGS
)3	С	13/09/22	AMENDED PLANS PER CLIENTS REQUEST
	D	23/09/22	CHANGES TO WINDOWS
au			

PROPOSED ALTERATIONS AND ADDITIONS 14 HILMA STREET COLLAROY PLATEAU NSW 2097	
CLIENT: SIMONNE HUNT & DAVID DI BONA	
DRAWING TITLE: SHADOW DIAGRAM JUNE 21 12noon	

DATE:	DRAWN BY:	SCALE:
SEP/22	HR	1:200 @ A3
JOB No:	CHECKED BY:	DRAWING No:
1064/22	JJ	DA.17

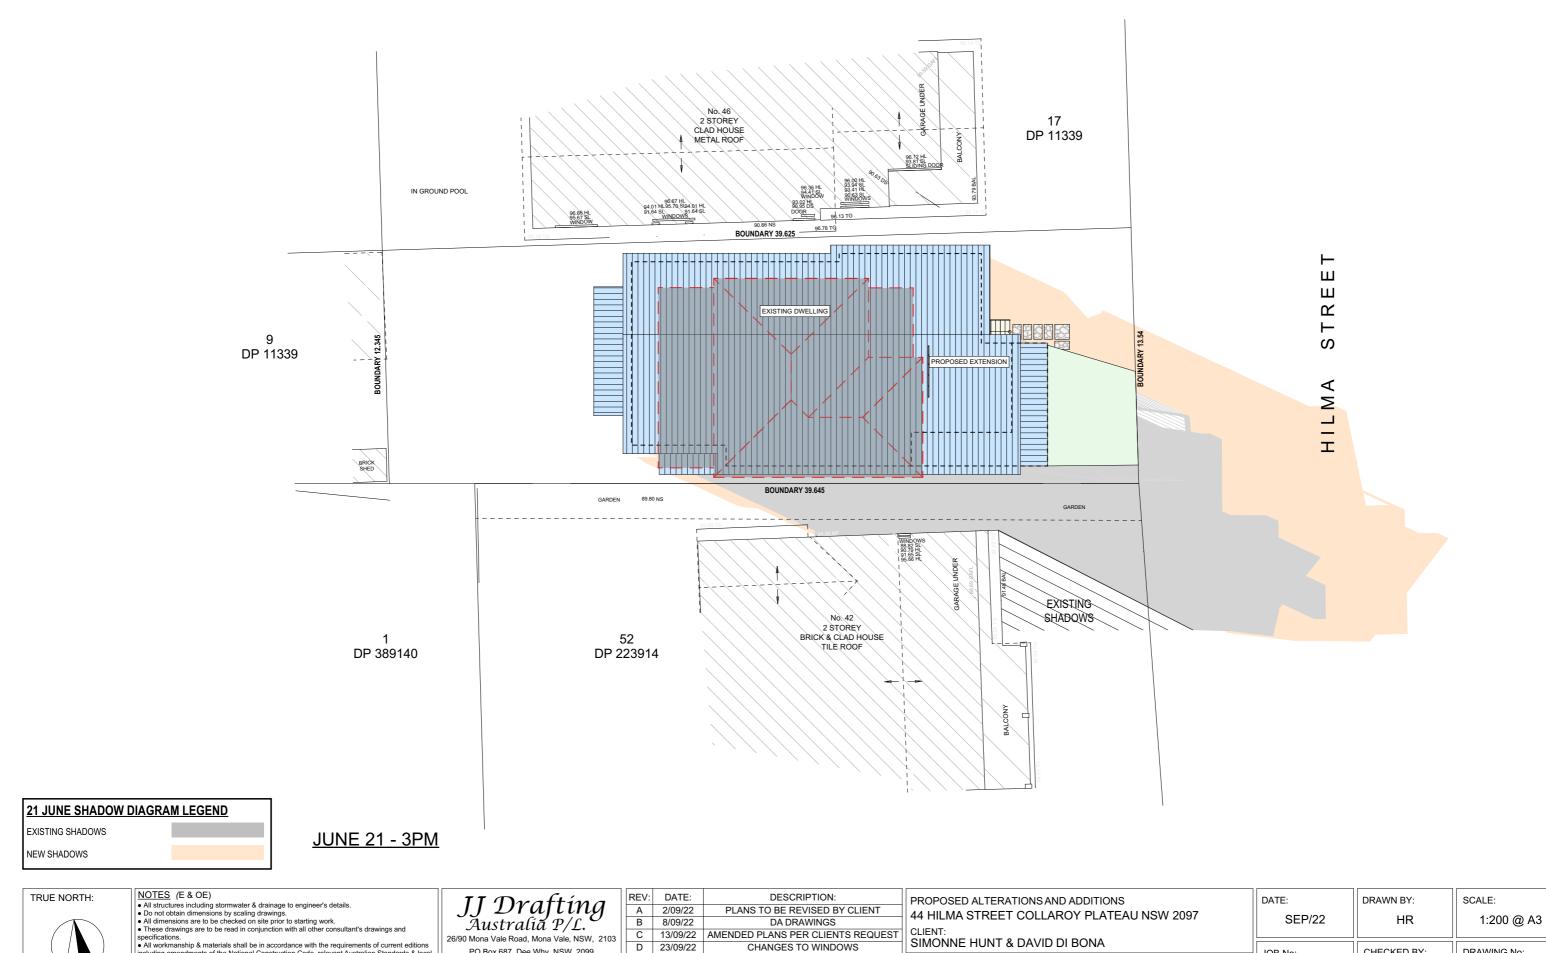

AMENDED PLANS PER CLIENTS REQUEST

CHANGES TO WINDOWS

DRAWING TITLE:

SHADOW DIAGRAM JUNE 21 3pm

CHECKED BY:

JJ

JOB No:

1064/22

DRAWING No:

DA.18

C 13/09/22

D 23/09/22

26/90 Mona Vale Road, Mona Vale, NSW, 2103

PO Box 687, Dee Why, NSW, 2099

Mob. 0414 717 541 | Email. jjdraft@tpg.com.au

www.jjdrafting.com.au

ACN 651 693 346

specifications.


• All workmanship & materials shall be in accordance with the requirements of current editions.

• All working an indefined strain be in accordance with the requirements of content editions including amendments of the National Construction Code, relevant Australian Standards & local council requirements.

• New materials are to be used throughout unless otherwise noted.

• Concrete footings, slab, structural beams or any other structural members are to be designed by a contribition analysis.

by a practicing engineer.

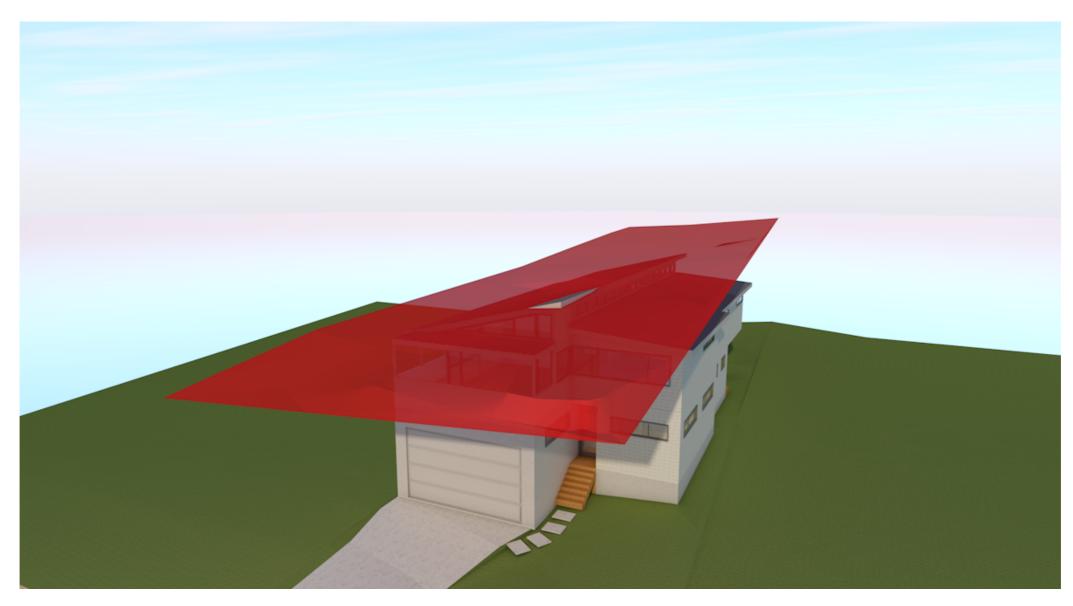

8.5m BUILDING HEIGHT PLANE

SEE CLAUSE 4.6 SMALL PORTION OF PROPOSED ROOF ABOVE THE 8.5m BUILDING HEIGHT RESTRICTION. MAX 250mm ABOVE.

NOTES (E & OE)

• All structures including stormwater & drainage to engineer's details.

• Do not obtain dimensions by scaling drawings.

• All dimensions are to be checked on site prior to starting work.

• These drawings are to be read in conjunction with all other consultant's drawings and specifications.

• All workmanship & materials shall be in accordance with the requirements of current editions including amendments of the National Construction Code, relevant Australian Standards & local council requirements.

• New materials are to be used throughout unless otherwise noted.

• Concrete footings, slab, structural beams or any other structural members are to be designed by a practicing engineer.

JJ Drafting Australia P/L.

26/90 Mona Vale Road, Mona Vale, NSW, 2103 PO Box 687, Dee Why, NSW, 2099 Mob. 0414 717 541 | Email. jjdraft@tpg.com.au www.jjdrafting.com.au ACN 651 693 346

REV:	DATE:	DESCRIPTION:	P
Α	2/09/22	PLANS TO BE REVISED BY CLIENT	4
В	8/09/22	DA DRAWINGS	ΙΙ.
С	13/09/22	AMENDED PLANS PER CLIENTS REQUEST	C
D	23/09/22	CHANGES TO WINDOWS	S
			D
			Π
			B

PROPOSED ALTERATIONS AND ADDITIONS 44 HILMA STREET COLLAROY PLATEAU NSW 2097
CLIENT: SIMONNE HUNT & DAVID DI BONA
DRAWING TITLE: BUILDING HEIGHT PLANE

DATE:	DRAWN BY:	SCALE:
SEP/22	HR	@ A3
JOB No:	CHECKED BY:	DRAWING No:
1064/22	JJ	DA.19



WINDOW SCHEDULE

NOTES (E & OE)

- All structures including stormwater & drainage to engineer's details.
 Do not obtain dimensions by scaling drawings.
 All dimensions are to be checked on site prior to starting work.
- by a practicing engineer.

Insee crawings are to be read in conjunction with all other consultants drawings and specifications. All workmanship & materials shall be in accordance with the requirements of current editions including amendments of the National Construction Code, relevant Australian Standards & local council requirements. New materials are to be used throughout unless otherwise noted. Concrete footings, slab, structural beams or any other structural members are to be designed by a practicing penipser.


Australiã P/L.
26/90 Mona Vale Road, Mona Vale, NSW, 2103
PO Box 687, Dee Why, NSW, 2099
Mob. 0414 717 541 Email. jjdraft@tpg.com.au
www.jjdrafting.com.au
ACN 664 602 246

JJ Drafting

	REV:	DATE:	DESCRIPTION:
	Α	2/09/22	PLANS TO BE REVISED BY CLIENT
	В	8/09/22	DA DRAWINGS
03	С	13/09/22	AMENDED PLANS PER CLIENTS REQUEST
00	D	23/09/22	CHANGES TO WINDOWS
.au			

PROPOSED ALTERATIONS AND ADDITIONS 44 HILMA STREET COLLAROY PLATEAU NSW 2097
CLIENT: SIMONNE HUNT & DAVID DI BONA
DRAWING TITLE: WINDOW SCHEDULE

DATE:	DRAWN BY:	SCALE:		
SEP/22	HR	1:1 @ A3		
JOB No:	CHECKED BY:	DRAWING No:		
1064/22	JJ	DA.20		

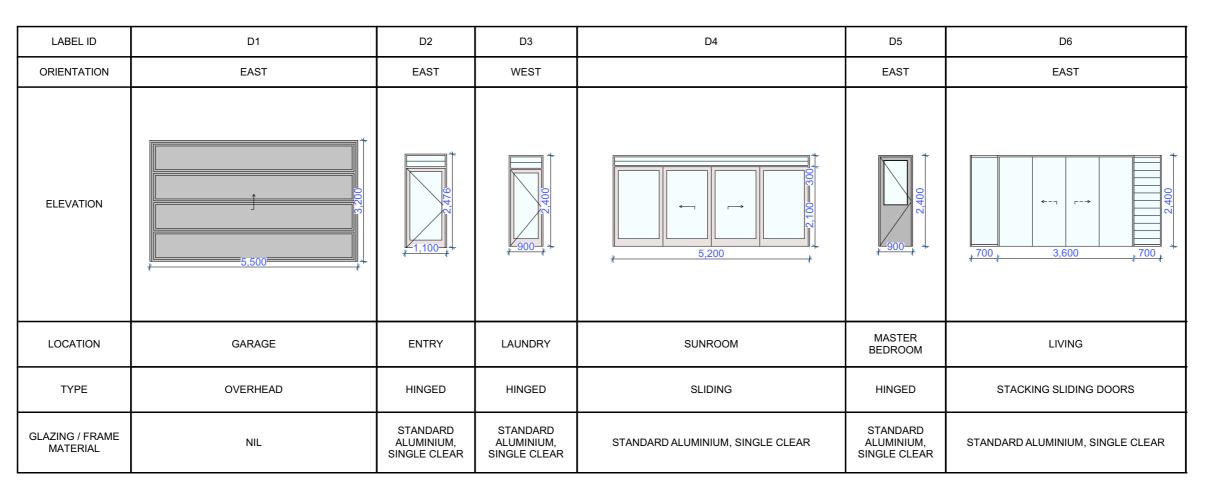

DOOR SCHEDULE

<u>NOTES</u>

FRAME OPENING DIMENSIONS FOR WINDOWS & DOORS TO BE CONFIRMED ON SITE PRIOR TO ORDERING.

- NOTES (E & OE)

 All structures including stormwater & drainage to engineer's details.

 Do not obtain dimensions by scaling drawings.

 All dimensions are to be checked on site prior to starting work.

 These drawings are to be read in conjunction with all other consultant's drawings and specifications.

 All workmanship & materials shall be in accordance with the requirements of current editions including amendments of the National Construction Code, relevant Australian Standards & local council requirements.

 New materials are to be used throughout unless otherwise noted.

 Concrete footings, slab, structural beams or any other structural members are to be designed by a practicing engineer.
- by a practicing engineer.
- JJ Drafting Australia P/L. 26/90 Mona Vale Road, Mona Vale, NSW, 2103 PO Box 687, Dee Why, NSW, 2099 Mob. 0414 717 541 | Email. jjdraft@tpg.com.au www.jjdrafting.com.au

ACN 651 693 346

	REV:	DATE:	DESCRIPTION:	
	Α	2/09/22	PLANS TO BE REVISED BY CLIENT	
1	В	8/09/22	DA DRAWINGS	
	С	13/09/22	AMENDED PLANS PER CLIENTS REQUES	
	D	23/09/22	CHANGES TO WINDOWS	
ار				
- 1				

1	PROPOSED ALTERATIONS AND ADDITIONS 44 HILMA STREET COLLAROY PLATEAU NSW 2097
	CLIENT: SIMONNE HUNT & DAVID DI BONA
ı	DRAWING TITLE: DOOR SCHEDULE

DATE:	DRAWN BY:	SCALE:
SEP/22	HR	1:1 @ A3
JOB No:	CHECKED BY:	DRAWING No:
1064/22	JJ	DA.21