

SITE CRITERIA

No.19 MORESBY PLACE ALLAMBIE HEIGHTS N.S.W. 2100 19 D.P. 28394

SITE AREA EXISTING HARDSTAND EXISTING SOFT OPEN SPACE			=	313.8	sq, sq, sq,	m.
PROPOSED DRIVEWAY AREA						m. m.
PROPOSED GROUND FLOOR AREA PROPOSED GROUND FLOOR FRONT DECK AREA PROPOSED GROUND FLOOR REAR DECK AREA PROPOSED TOTAL FIRST FLOOR AREA			=	23.6 29.2	są, są,	m. m. m.
DWELLING ROOF AREA			=	210.9	są,	m.
2 CAR PARKING SPACES PROVIDED IN GARAGE						
POST SOFT OPEN SPACE AREA = 380.1 POST HARDSTAND OPEN SPACE AREA = 54.0 POST TOTAL OPEN SPACE = 434.1 HARDSTAND POST DEVELOPEMENT = 191.7	sq, m. sq, m. sq, m. sq, m.	60.7 %				
TOTAL HARDSTAND POST DEVELOPEMENT = 245.7	są, m.	39.3 %				

REQUIRED OSD AREA = SITE AREA x 40% = 250.3 sq.m.
POST OSD AREA (ROOF + IMPERVIOUS PERVIOUS) = 249.7 sq. m. 39.9%



BASIX CERTICATE NUMBER 1374624M ROOF AREA TO TANK TO BE USED FOR TOILET FLUSHING, COLD WATER

CLOTHS WASHING AND GARDEN TAPS SUPPLY (MINIMUM)	210.9 sq.m.
WATER STORAGE TANK CAPACITY	2,000 MIN. LITRES
NEW SHOWER HEAD MINIMUM RATING	3 STAR RATING
NEW TOILET MINIMUM RATING	4 STAR RATING
ALL NEW TAP FITTINGS MINIMUM RATING	4 STAR RATING
GLAZING TO ALUMINIUM FRAMED WINDOWS AND TI NOTED ARE TO BE IN ACCORDANCE WITH THE NAT	
ROOF COLOUR	MEDIUM - SA < 0.40 < 0.60
FLOOR ABOVE ENCLOSED SUBFLOOR	R2.0 RATING
FLOOR ABOVE GARAGE	N.A.
ROOF SHEETING ON INSULATION	RI.3 RATING
EXTERNAL WALLS INSULATION	R2.5 RATING
INTERNAL WALLS INSULATION	N.A.
	, POWDER ROOM & BATHROOM)
CEILING INSULATION	
	(EXCLUDES GARAGE CEILING)
INDIGENOUS OR LOW WATER USE SPECIES OF VEG OF THE SITE TO BE PLANTED REFER LANDSCAPE	
HOT WATER SERVICE TO BE ELECTRIC HEAT PUMI	

COOLING SYSTEM TO BE IN AT LEAST I LIVING AREA \$ 1 BEDROOM TO BE A 1-PHASE AIR CONDITIONING WITH AN ENERGY RATING OF EER 3,0-3,5 OR BETTER PLUS A CEILING FAN TO BEDROOM ONLY. THE COOLING SYSTEM MUST MUST PROVIDE FOR DAT/NIGHT ZONING BETWEEN LIVING \$ BEDROOM AREAS,

HEATING SYSTEMM IN AT LEAST 1 LIVING AREA \pm 1 BEDROOM TO BE 1-PHASE AIR CONDITIONING WITH AN ENERGY RATING OF EER 3.0 - 3.5 OR BETTER.

FIXED OUTDOORS CLOTHES DRYING LINE TO BE INSTALLED

INDUCTION COOKER WITH ELECTRIC OVEN.

APPLICANT MUST ENSURE THAT THE "PRIMARY TYPE OF ARTIFICAL LIGHTING" IS FLUORESCENT OR LIGHTE ENITING DIODE (LED) LIGHTING IN EACH OF THE FOLLONING ROOMS, AND WHERE THE "DEPLOATED" APPEARS, THE FITTINGS FOR THOSE LIGHTS MUST ONLY BE CAPABLE OF ACCEPTING FLUORESCENT OR LIGHTE ENITHING DIODE (LED) LAMPS.

- THE LAUNDRY, AT LEAST 5 OF THE BEDROOMS (DEDICATED)
- STUDY, 4 LIVING/DINING ROOMS (DEDICATED)
- , ALL BATHROOMS/TOILETS, KITCHEN, HALLWAYS (DEDICATED)

NOTES:-

1. ALL GLAZING TO WINDOWS & DOORS SHALL BE IN ACCORDANCE WITH

- 1. ALL GLAZING TO WINDOWS & DOORS SHALL BE IN ACCORDANCE WITH
 THE NATHERS REPORT.
 2. EXTERNAL WALL CLADDING SHALL BE SELECTED PLANK CLADDING
 WITH A SPECIFIED PAINTED COLOUR FINISH.
 3. AN APPROVED RATED INSULATION TO ALL EXTERNAL TIMBER FRAMED
 WALLS IN ACCORDANCE WITH THE BASIX REPORT.
 4. AN APPROVED RATED INSULATION MATERIAL TO BE PLACED IN THE CEILING
 SPACE WITHIN THE PERIMETER OF ALL EXTERNAL WALLS IN ACCORDANCE
 WITH THE BASIX REPORT WITH THE BASIX REPORT
- 5. AN APPROVED RATED CONDENSATION BLANKET PLACED UNDER ROOF SHEETING THRU-OUT IN ACCORDANCE WITH THE BASIX REPORT. 6. ROOF FINISHES TO BE IN ACCORDANCE WITH THE BASIX REPORT.

EXTERNAL WALL FINISHES TO BE IN ACCORDANCE WITH THE BASIX REPORT.

8. ALL WINDOWS AND DOORS TO HAVE WEATHER STRIPPING, 9. ALL WINDOWS & DOORS AS NOTED ON PLAN WITH SPECIFIED COLOUR FINISH.

10. ALL PAINTING TO OWNERS REQUIREMENTS.

11. ALL POWER OUTLETS & SWITCHES TO OWNERS REQUIREMENTS.
12. ALL GLAZING TO CODE ASI288

- 13, ALL PEST TREATMENT TO CODE AS3660.1-2000 14, SMOKE ALARM DENOTED SA ON PLAN TO BCA 3.7.2 \$ AS3786 15, ALL WATERPROPING TO WET AREAS TO CODE AS3740

16. ALL TIMBER FRAMING TO CODE ASI684
17. ALL WORK CARRIED OUT TO BE IN ACCORDANCE WITH THE BCA

GENERAL NOTES AND BCA / NCC COMPLIANCE

EARTHWORKS METHOD OF EXCAVATION AND FILL TO COMPLY WITH PART 3.1.1 B.C.A. TERMITE RISK MANAGEMENT TO COMLPY WITH PART 3.1.3 OF THE B.C.A. AND AS3660-1 FOOTINGS AND SLABS TO COMPLT WITH PART 3.2 OF THE B.C.A. , AS2870

AND ENGINEERS DETAILS

AND ENGINEERS DETAILS

MASONARY CONSTRUCTION TO COMPLY WITH PART 3.3 OF THE B.C.A. AND AS3700

TIMBER FRAMING TO COMPLY WITH PART 3.4 OF THE B.C.A. AND AS1684

GLAZING TO COMPLY WITH PART 3.6 OF THE B.C.A. AND AS1288

SMOKE ALARMS TO COMPLY WITH PART 3.7.2 OF THE B.C.A. AND AS3786

STAIR CONSTRUCTION TO COMPLY WITH PART 3.9.1 OF THE B.C.A.

BALISTRADES AND OTHER BARRIERS TO COMPLY WITH PART 3.9.2 OF THE B.C.A.

- BALISTRADES AND OTHER BARKIERS TO COMPLY WITH PART 3.9.2 OF THE B.C.A.
- NATURAL LIGHT TO COMPLY WITH PART 3.8.4 OF THE B.C.A.
- VENTILATION TO COMPLY WITH PART 3.8.5 OF THE B.C.A.
- ALL DAMP AND MEATHERPROOFING TO COMPLY WITH PART 3.8 OF THE B.C.A.
- ROOFING TO COMPLY WITH PART 3.5.1 OF THE B.C.A. AND AS/NZI562
- FLOOR SURFACES OF WATER CLOSETS, SHOWER COMPARTMENTS AND THE A LIKE
TO BE OF MATERIALS IMPERVIOUS TO MOISTURE AND WALLS FINISHED WITH AN

APPROVED IMPERVIOUS FINISH TO COMPLY WITH THE REQUIREMENTS OF PART 3.8 OF THE B.C.A. AND AS3740

CLOTHS WASHING, DRYING AND COOKING FACILITIES TO BE PROVIDED TO COMPLY WITH PART 3.8.3 OF THE B.C.A.



OFFICE - 39 GAVENLOCK ROAD TUGGERAH 2259 P.O. BOX 5240 CHITTAWAY BAY N.S.W. 2261

Tel: (02) 4352 1189 Fax: (02) 4352 1198 Builders Lic. 158741C ABN 65 687 862 151 © This drawing and design remains the property of CLASSIC COUNTRY COTTAGES and may not be copied

in whole or in part without prior approval of CLASSIC COUNTRY COTTAGES

PROPOSED NEW DWELLING 19 MORESBY PLACE **ALLAMBIE HEIGHTS**

FOR


Mr. R. & Mrs. L. MERRY


DATE DEC. 2022 SCALE 1:200


JOB No.

DWG. No.



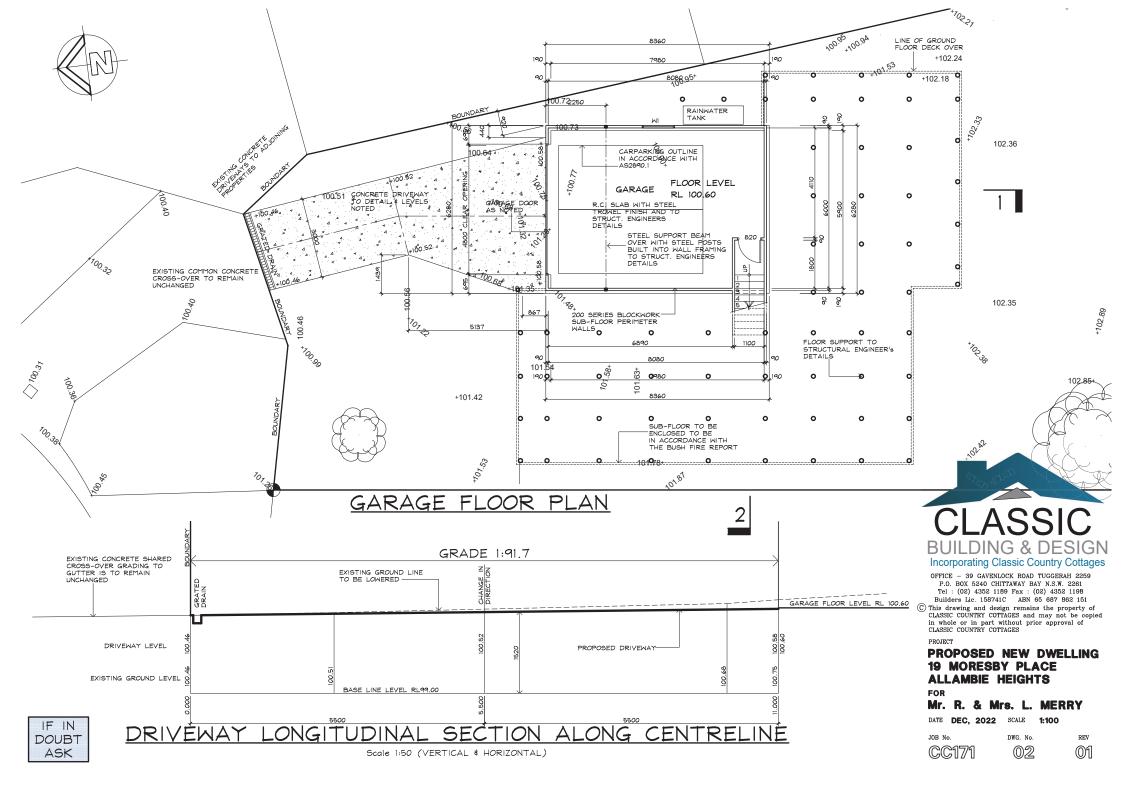

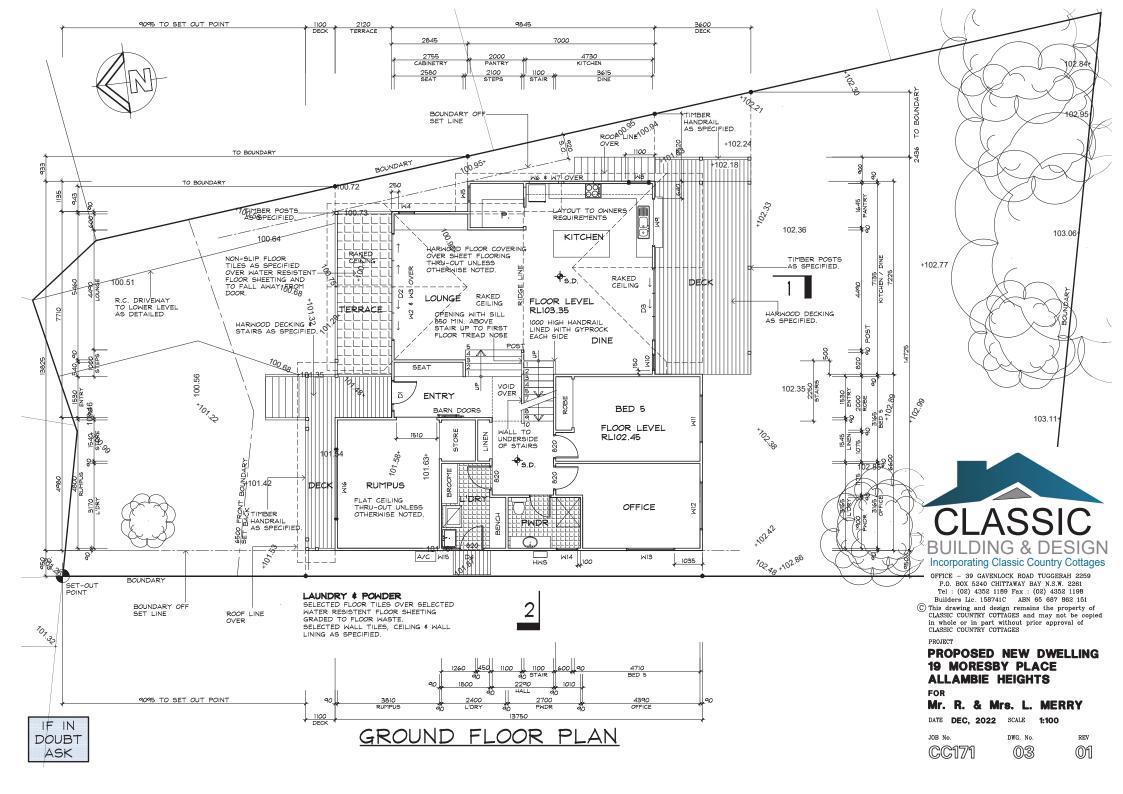

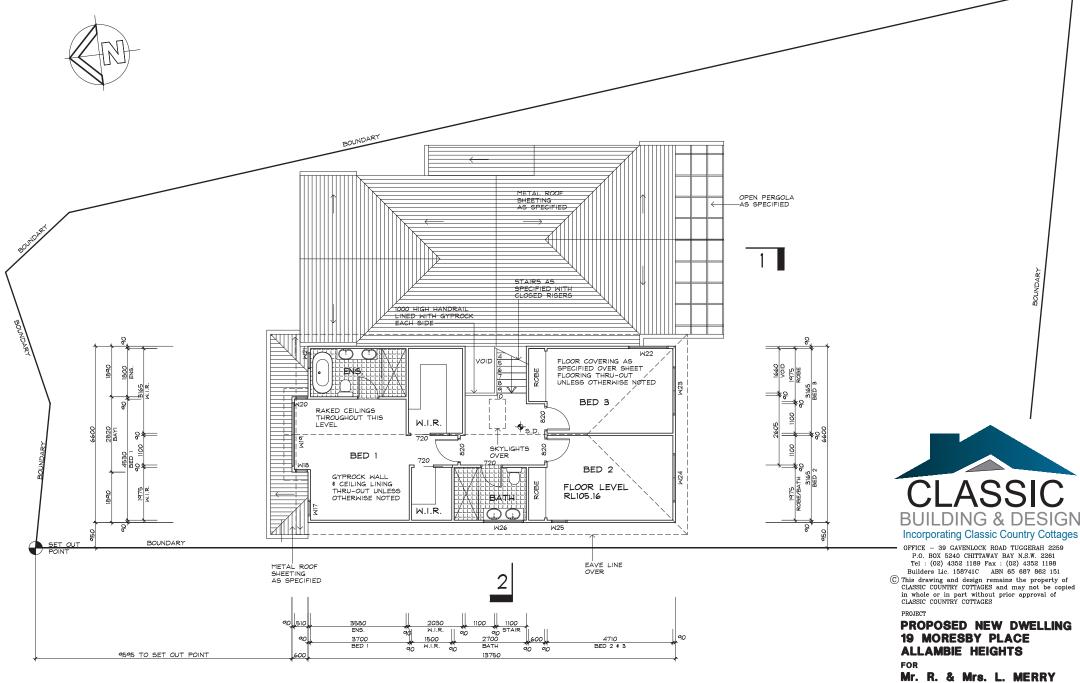





FIRST FLOOR PLAN

DATE DEC, 2022 SCALE 1:100

JOB No.

04

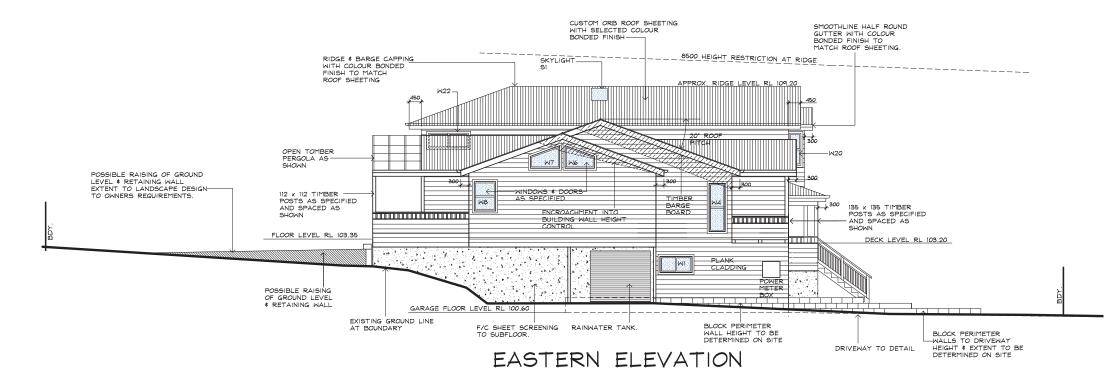

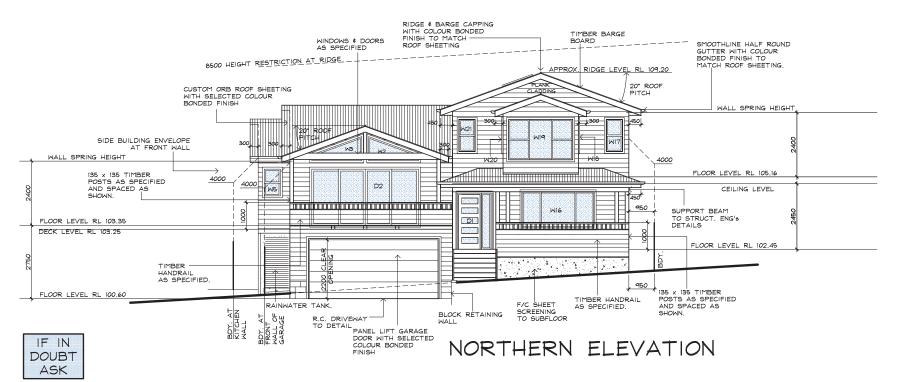



Incorporating Classic Country Cottages

OFFICE - 39 GAVENLOCK ROAD TUGGERAH 2259 P.O. BOX 5240 CHITTAWAY BAY N.S.W. 2261 Tel: (02) 4352 1189 Fax: (02) 4352 1198 Builders Lic. 158741C ABN 65 687 862 151

© This drawing and design remains the property of CLASSIC COUNTRY COTTAGES and may not be copied in whole or in part without prior approval of CLASSIC COUNTRY COTTAGES

PROJECT

PROPOSED NEW DWELLING 19 MORESBY PLACE ALLAMBIE HEIGHTS

FOR


Mr. R. & Mrs. L. MERRY


DATE DEC, 2022 SCALE 1:100

CC171

DWG. No.

rev

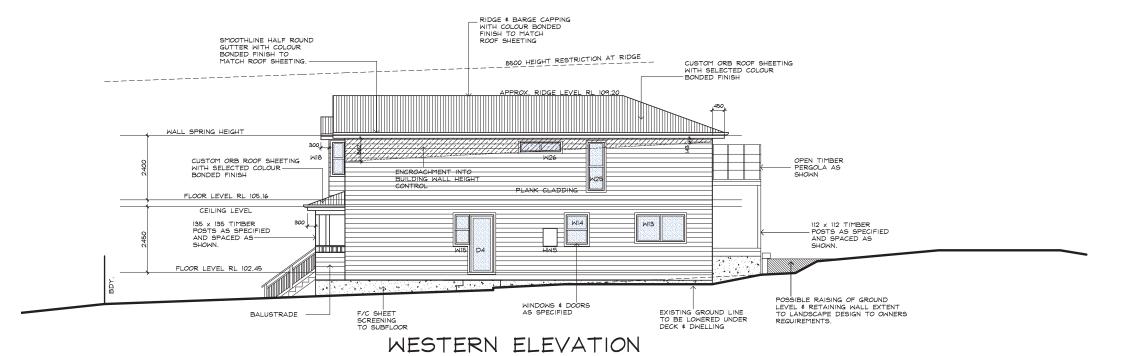

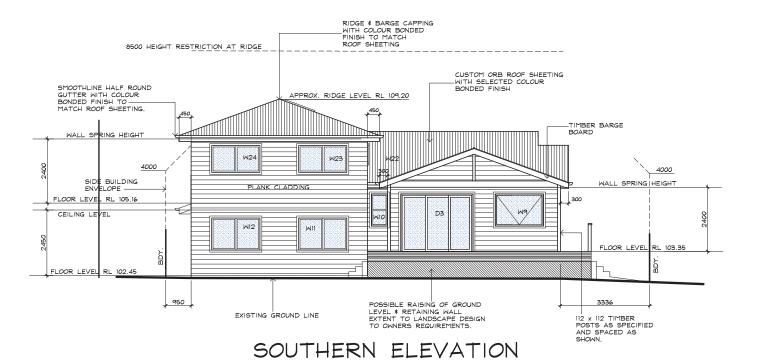



BUILDING & DESIGN

Incorporating Classic Country Cottages

OFFICE - 39 GAVENLOCK ROAD TUGGERAH 2259 P.O. BOX 5240 CHITTAWAY BAY N.S.W. 2261

Tel: (02) 4352 1189 Fax: (02) 4352 1198

Builders Lic. 158741C ABN 65 687 862 151

FOR Mr. R. & Mrs. L. MERRY


DATE DEC, 2022 SCALE 1:100


JOB No. (~) (주의 "카쉬 DWG. No.

(

REV




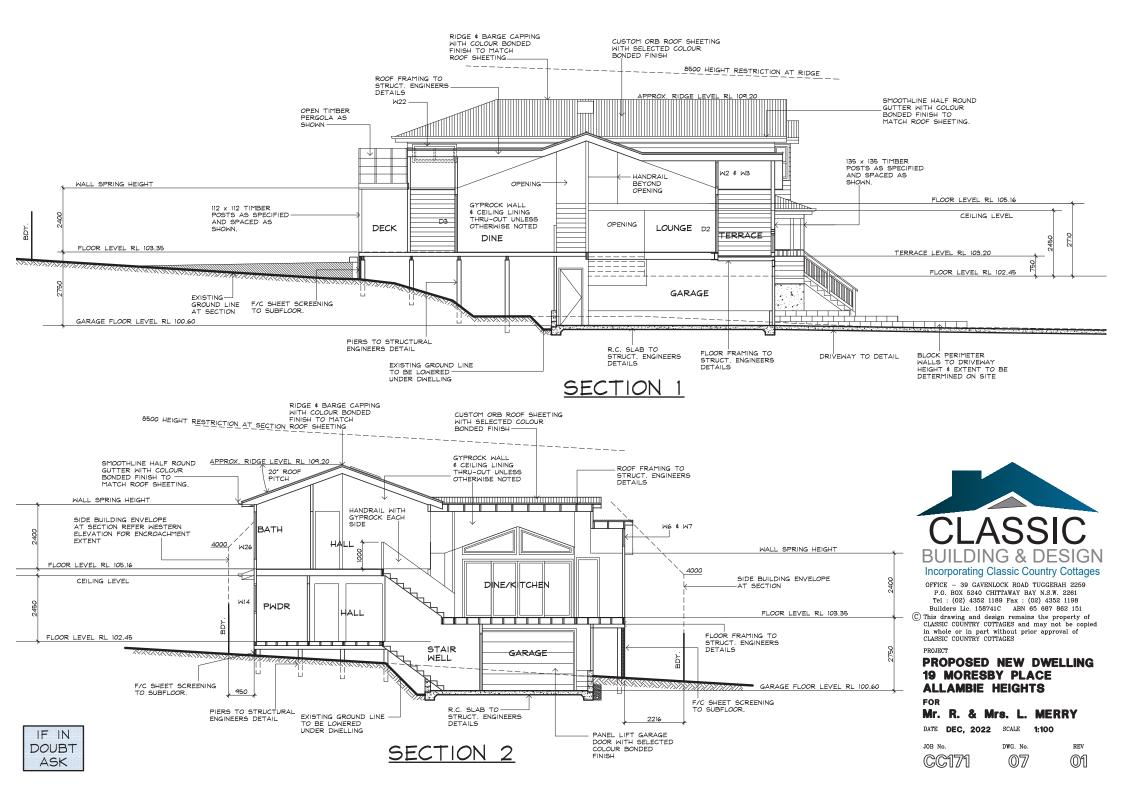

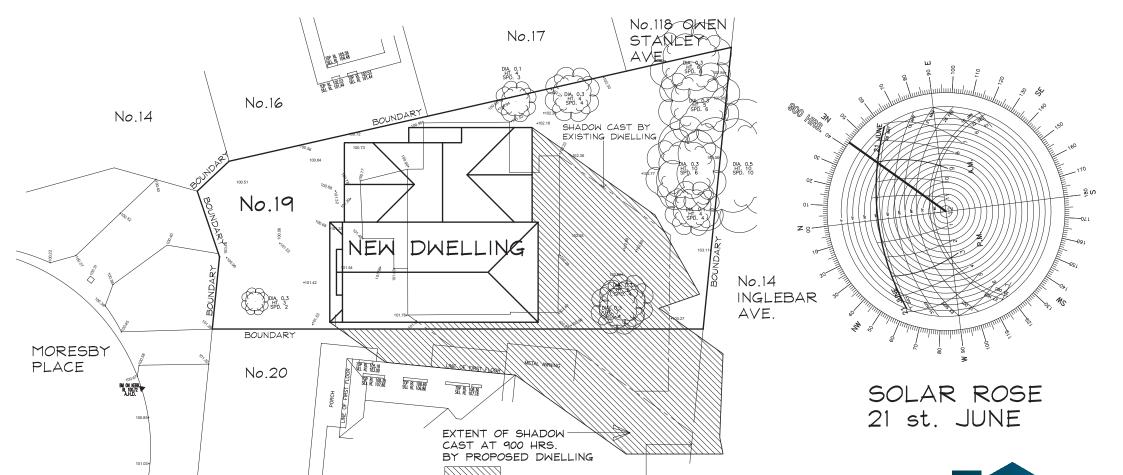

SHADOW CAST BY EXISTING No.20 DWELLING

0900 HRS. SOLAR ANALYSIS PLAN

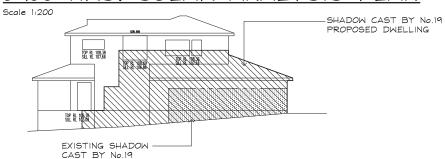

NORTH-EAST ELEVATION No.20 Scale 1:200





OFFICE - 39 GAVENLOCK ROAD TUGGERAH 2259 P.O. BOX 5240 CHITTAWAY BAY N.S.W. 2261 Tel: (02) 4352 1189 Fax: (02) 4352 1198 Builders Lic. 158741C ABN 65 687 862 151

(C) This drawing and design remains the property of CLASSIC COUNTRY COTTAGES and may not be copied in whole or in part without prior approval of CLASSIC COUNTRY COTTAGES


PROPOSED NEW DWELLING 19 MORESBY PLACE **ALLAMBIE HEIGHTS**

FOR

Mr. R. & Mrs. L. MERRY

JOB No.

DATE DEC, 2022 SCALE 1:200

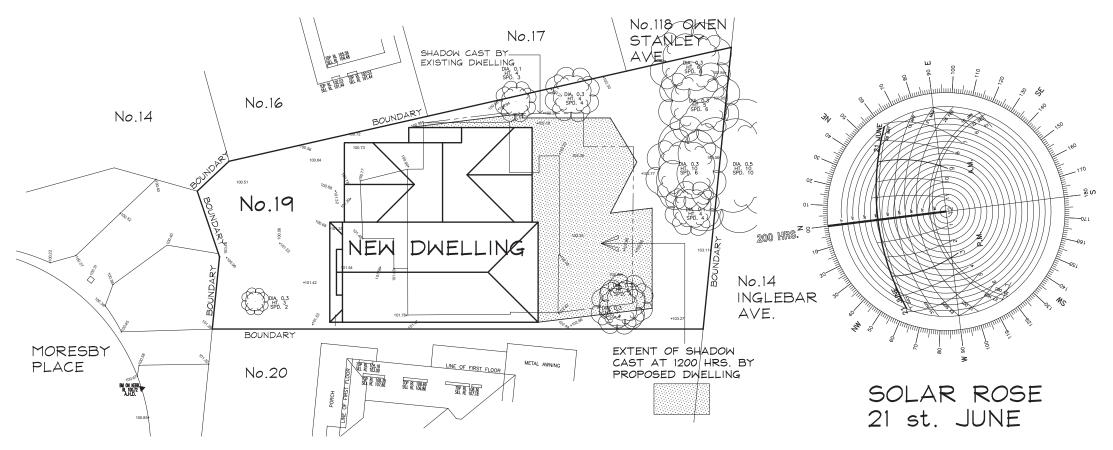

1200 HRS. SOLAR ANALYSIS PLAN
Scale 1:200

NO ADJOINING PROPERTY RESIDENCE ARE AFFECTED





OFFICE - 39 GAVENLOCK ROAD TUGGERAH 2259 P.O. BOX 5240 CHITTAWAY BAY N.S.W. 2261 Tel: (02) 4352 1189 Fax: (02) 4352 1198 Builders Lic. 158741C ABN 65 687 682 151

© This drawing and design remains the property of CLASSIC COUNTRY COTTAGES and may not be copied in whole or in part without prior approval of CLASSIC COUNTRY COTTAGES

PROJECT


PROPOSED NEW DWELLING 19 MORESBY PLACE ALLAMBIE HEIGHTS

FOR

Mr. R. & Mrs. L. MERRY

DATE DEC, 2022 SCALE 1:200


JOB No.

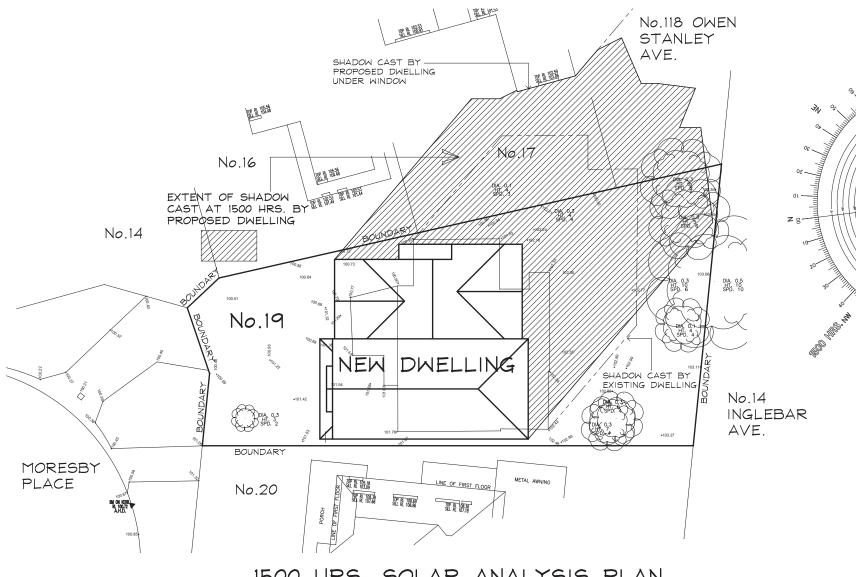

1500 HRS. SOLAR ANALYSIS PLAN
Scale 1:200

NO ADJOINING PROPERTY
RESIDENCE ARE AFFECTED



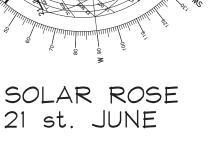



OFFICE - 39 GAVENLOCK ROAD TUGGERAH 2259
P.O. BOX 5240 CHITTAWAY BAY N.S.W. 2261
Tel: (02) 4352 1189 Fax: (02) 4352 1198
Builders Lic. 158741C ABN 65 687 862 151

© This drawing and design remains the property of CLASSIC COUNTRY COTTACES and may not be copied in whole or in part without prior approval of CLASSIC COUNTRY COTTACES

PROJECT

PROPOSED NEW DWELLING 19 MORESBY PLACE ALLAMBIE HEIGHTS

FOR


Mr. R. & Mrs. L. MERRY

DATE DEC, 2022 SCALE 1:200

job no. CC171 DWG. No.

01

REV

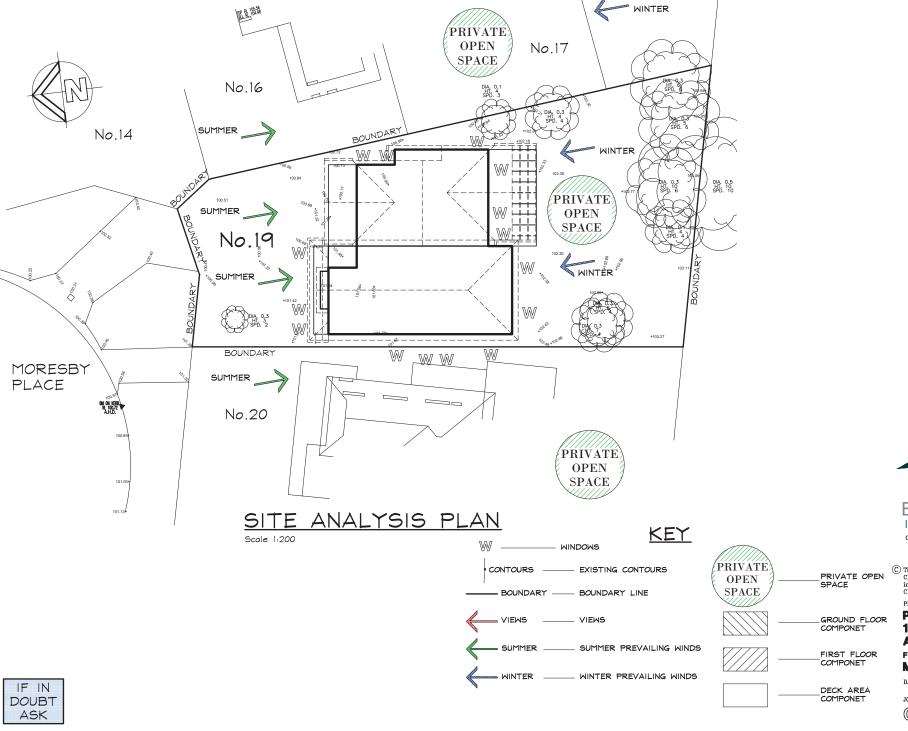



Incorporating Classic Country Cottages

OFFICE - 39 GAVENLOCK ROAD TUGGERAH 2259 P.O. BOX 5240 CHITTAWAY BAY N.S.W. 2261 Tel: (02) 4352 1189 Fax: (02) 4352 1198 Builders Lic. 158741C ABN 65 687 862 151

C This drawing and design remains the property of CLASSIC COUNTRY COTTAGES and may not be copied in whole or in part without prior approval of CLASSIC COUNTRY COTTAGES


PROPOSED NEW DWELLING 19 MORESBY PLACE **ALLAMBIE HEIGHTS**


FOR

Mr. R. & Mrs. L. MERRY

DATE DEC, 2022 SCALE 1:200

REV 01

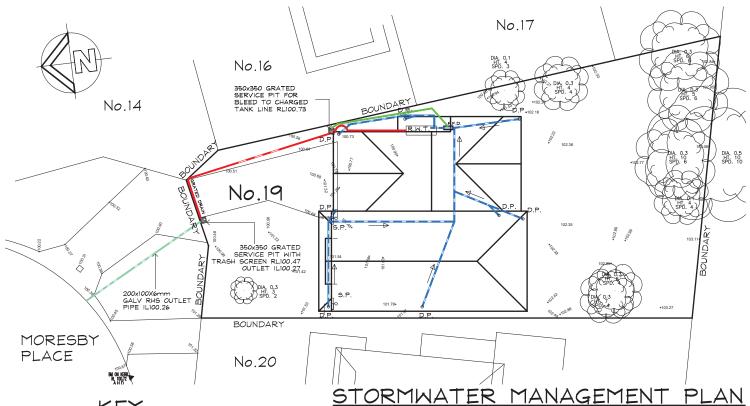

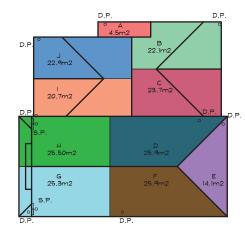

STORMWATER ROOF PLAN

DOWN PIPE (SPREADER)

---- DOWN PIPE 90mm

FIRST FLUSH DIVERTER

100mm DIA STORM WATER PIPE TO STORAGE TANK

90mm DIA STORM WATER DISCARD PIPE TO SERVICE PIT STORMWATER PIPE

60mm DIA BLEED PIPE

---- EXISTING STORMWATER PIPE

GALVANISED STEEL RHS PIPE TO KERB

DRAINAGE GRATE

GRATED PIT 150mm

RW/T ---- RAIN WATERTANK

IF IN DOUBT ASK

HYDRAULIC NOTES

- THE CONTRACTOR SHALL GIVE NOTICE TO COUNCIL'S ENGINEER IN ACCORDANCE WITH COUNCIL'S SPECIFICATIONS WHEN INSPECTIONS ARE REQUIRED
- WHERE DEPTH OF STORMWATER DRAINAGE PITS EXCEEDS 1.2m, HOT DIPPED
- GALVANISED STEEL STEP IRONS SHALL BE PROVIDED.
 ALL PITS SHALL BE PRECAST CONCRETE WITH GRATE OR APPROVED EQUIVALENT UNLESS NOTED OTHERWISE.
- 4. STORMWATER CONNECTION TO COUNCIL'S DRAINAGE SYSTEM SHALL BE DONE UNDER THE SUPERVISION OF COUNCIL'S ENGINEER.
- ALL STORMWATER PIPES BELOW AND INCLUDING 2250 SHALL BE UPVC OR APPROVED EQUIV. UNLESS NOTED OTHERWISE. ALL PIPES ABOVE 2250 SHALL BE REINFORCED CONCRETE WITH RUBBER RING JOINTS UNLESS NOTED OTHERWISE.
- MINIMUM PIPE COVER TO BE 700mm UNLESS NOTED OTHERWISE.
 ALL PIPES TO BE LAID AND COVERED WITH SAND TO A MINIMUM DEPTH
 EQUAL TO THE PIPE DIAMETER, BUT NOT LESS THAN 300mm.
 IN SANDY SOILS THE EXCAVATED SOIL MAY BE REUSED.
- ALL 100Ø SUBSOIL DRAINAGE TO BE PLACED A MINIMUM OF 650mm BELOW
- FINISHED SURFACE LEVELS AND COVERED WITH A MINIMUM OF 500mm GRAVEL. 12. PIPE BEDDING SUPPORT SHALL BE H1 UNLESS NOTED OTHERWISE.

 13. STORMWATER GRATES AND MANHOLE CLASSES SHALL BE IN ACCORDANCE
- 14 WITH AS3996 15. WHERE PIPE GRADES ARE NOT SHOWN ON DRAWINGS, MINIMUM PIPE
- GRADES SHALL BE 1% UNO.

 16. PIPE GRADES INDICATED ON DRAWINGS ARE MINIMUM GRADES, IF MINIMUM.

GRADES CANNOT BE ACHIEVED CONTACT 17. THE DESIGN ENGINEER PRIOR TO PLACEMENT

RAINWATER TANK NOTES

- 1. ALL WORK TO BE CARRIED OUT IN ACCORDANCE WITH AS. 3500.3.2.
 2.THIS PLAN TO BE READ IN CONJUNCTION WITH THE BASIX CERTIFICATE NUMBER LISTED IN BASIX/NATHERS NOTES.
- 3.A TOTAL RAINWATER TANK STORAGE CAPACITY OF 2,000 LITRES IS PROVIDED VIA ONE SLIMLINE TANK CONSISTING OF AN APPROX SIZE 685mm WIDE X 2,060mm L X 1,905mm H WATER TANK CONNECTED TO THE FOLLOWING:

 ALL TOILETS IN THE DEVELOPEMNT.
- THE COLD WATER TAP THAT SUPPLIES EACH CLOTHES WASHER IN THE DEVELOPMENT. AT LEAST ONE OUTDOOR TAP IN THE DEVELOPMENT (NOTED: NSW HEALTH DOES NOT
- RECOMMEND THAT RAINWATER BE USED FOR HUMAN CONSUMPTION.)
 4. ALL PIPE AND DOWN PIPES TO BE PRESUSSURE GRADE PIPES TO 500mm ABOVE MAXIMUM WATER LEVEL OF RAIN WATERTANKS.

GUTTER NOTES

- 1. ALL GUTTERS TO HAVE A MINIMUM CROSS SECTION AS OUTLINED IN TABLE 1.
- 2. ALL GUTTER GRADIENTS TO BE NOT LESS THAN 1:500
- 3. TOP OF FASCIA TO BE A MINIMUM OF 15mm ABOVE GUTTER SLOTTED OVERFLOW

4.	DOWNP	IPE	SIZES	TO	BE	IN	ACCORD	ANCE	WITH	TABLE	1.	

CATCHMENT AREAS FOR INDIVIDUAL DOWNPIPES AND GUTTERS						
	PLAN VIEW AREA m2	AREA INC SLOPE	GUTTER mm2 (CROSS SECTION)	DOWNPIPE SIZE	AVERAGE RECURRENCE INTERVAL 1 IN 20 YEAR	
Α	4.5	4.8	7700	90mm	200mm/hr	
В	22.1	23.5	7700	90mm	200mm/hr	
С	23.7	25.2	7700	90mm	200mm/hr	
D	25.9	27.5	7700	90mm	200mm/hr	
E	14.1	15.0	7700	90mm	200mm/hr	
F	25.9	27.5	7700	90mm	200mm/hr	
G	25.3	26.9	7700	90mm	200mm/hr	
Н	25.5	27.1	7700	90mm	200mm/hr	
I	20.7	22.0	7700	90mm	200mm/hr	
J	22.9	24.4	7700	90mm	200mm/hr	

SITE CALCULATIONS

TOTAL SITE AREA: 625.8 m2 ROOF CATCHMENT AREA 210.9 m2 OTHER PAVED AREAS (Refer to Site Plan) 34.8 m2 TOTAL IMPERVIOUS AREA 245.7 m2 (39.3%) RAIN WATER TANK STORAGE (MINIMUM) 2,000 LITRES ON-SITE DETENTION IS NOT REQUIRED AS 249.7 m2 IS < 250.3 m2 OR 40% OF SITE AREA.



OFFICE - 39 GAVENLOCK ROAD TUGGERAH 2259 P.O. BOX 5240 CHITTAWAY BAY N.S.W. 2261 Tel: (02) 4352 1189 Fax: (02) 4352 1198 Builders Lic. 158741C ABN 65 687 862 151


C This drawing and design remains the property of CLASSIC COUNTRY COTTAGES and may not be copied in whole or in part without prior approval of CLASSIC COUNTRY COTTAGES

PROPOSED NEW DWELLING 19 MORESBY PLACE **ALLAMBIE HEIGHTS**

FOR

Mr. R. & Mrs. L. MERRY

DATE DEC, 2022 SCALE 1:200

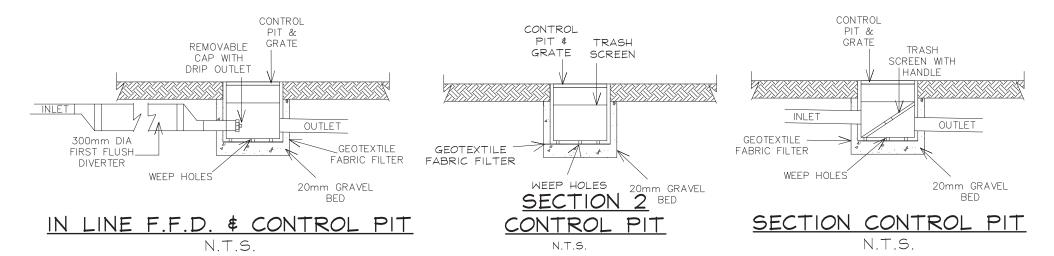

100mm & UPVC RAINWATER FIRST OVERFLOW FROM OUTLET TO FLUSH RAINWATER STORAGE HOUSE FOR DIVERTER RE-USE 100mm & UPVC INLET TOP RL102.90 RAINWATER INV RL101.90 PUMP WITH BACK FLOW 2,000 LITRE RAIN WATER PREVENTION STORAGE FOR RE-USE. BASE RLI01.00 TANK BASE TO MANUFACTURES SPECIFICATIONS



SECTION 1 RAINWATER TANK

N.T.S

HYDRAULIC NOTES

- THE CONTRACTOR SHALL GIVE NOTICE TO COUNCIL'S ENGINEER IN ACCORDANCE WITH COUNCIL'S SPECIFICATIONS WHEN INSPECTIONS ARE
- WHERE DEPTH OF STORMWATER DRAINAGE PITS EXCEEDS 1.2m, HOT DIPPED GALVANISED STEEL STEP IRONS SHALL BE PROVIDED.
- ALL PITS SHALL BE PRECAST CONCRETE WITH GRATE OR APPROVED
- EQUIVALENT UNLESS NOTED OTHERWISE. STORMWATER CONNECTION TO COUNCIL'S DRAINAGE SYSTEM SHALL BE DONE UNDER THE SUPERVISION OF COUNCIL'S ENGINEER.
- ALL STORMWATER PIPES BELOW AND INCLUDING 2250 SHALL BE UPVC OR APPROVED EQUIV. UNLESS NOTED OTHERWISE.
- ALL PIPES ABOVE 225¢ SHALL BE REINFORCED CONCRETE WITH RUBBER RING JOINTS UNLESS NOTED OTHERWISE.
- MINIMUM PIPE COVER TO BE 700mm UNLESS NOTED OTHERWISE.
- ALL PIPES TO BE LAID AND COVERED WITH SAND TO A MINIMUM DEPTH EQUAL TO THE PIPE DIAMETER, BUT NOT LESS THAN 300mm.
- IN SANDY SOILS THE EXCAVATED SOIL MAY BE REUSED.
- 10. ALL 100Ø SUBSOIL DRAINAGE TO BE PLACED A MINIMUM OF 650mm BELOW FINISHED SURFACE LEVELS AND COVERED WITH A
- MINIMUM OF 500mm GRAVEL.
- 12. PIPE BEDDING SUPPORT SHALL BE H1 UNLESS NOTED OTHERWISE.
- 13. STORMWATER GRATES AND MANHOLE CLASSES SHALL BE IN ACCORDANCE
- 14. WITH AS3996.
- 15. WHERE PIPE GRADES ARE NOT SHOWN ON DRAWINGS, MINIMUM PIPE GRADES SHALL BE 1% UNO.
- 16. PIPE GRADES INDICATED ON DRAWINGS ARE MINIMUM GRADES. IF MINIMUM. GRADES CANNOT BE ACHIEVED CONTACT
- 17. THE DESIGN ENGINEER PRIOR TO PLACEMENT

RAINWATER TANK NOTES

- 1. ALL WORK TO BE CARRIED OUT IN ACCORDANCE WITH AS. 3500.3.2. 2. THIS PLAN TO BE READ IN CONJUNCTION WITH THE BASIX CERTIFICATE NUMBER LISTED IN BASIX/NATHERS NOTES.
- 3.A TOTAL RAINWATER TANK STORAGE CAPACITY OF 2,000 LITRES IS PROVIDED VIA ONE SLIMLINE TANK CONSISTING OF AN APPROX SIZE 685mm WIDE X 2,060mm L X 1,905mm H WATER TANK CONNECTED TO THE FOLLOWING:
- ALL TOILETS IN THE DEVELOPEMNT.
- THE COLD WATER TAP THAT SUPPLIES EACH CLOTHES WASHER IN THE DEVELOPMENT. - AT LEAST ONE OUTDOOR TAP IN THE DEVELOPMENT (NOTED: NSW HEALTH DOES NOT RECOMMEND THAT RAINWATER BE USED FOR HUMAN CONSUMPTION.)
- 4. ALL PIPE AND DOWN PIPES TO BE PRESUSSURE GRADE PIPES TO 500mm ABOVE MAXIMUM WATER LEVEL OF RAIN WATERTANKS.

GUTTER NOTES

- 1. ALL GUTTERS TO HAVE A MINIMUM CROSS SECTION AS OUTLINED IN TABLE 1.
- 2. ALL GUTTER GRADIENTS TO BE NOT LESS THAN 1:500
- 3. TOP OF FASCIA TO BE A MINIMUM OF 15mm ABOVE GUTTER SLOTTED OVERFLOW
- 4. DOWNPIPE SIZES TO BE IN ACCORDANCE WITH TABLE 1.



OFFICE - 39 GAVENLOCK ROAD TUGGERAH 2259 P.O. BOX 5240 CHITTAWAY BAY N.S.W. 2261 Tel: (02) 4352 1189 Fax: (02) 4352 1198 Builders Lic. 158741C ABN 65 687 862 151


(C) This drawing and design remains the property of CLASSIC COUNTRY COTTAGES and may not be copied in whole or in part without prior approval of CLASSIC COUNTRY COTTAGES

PROPOSED NEW DWELLING 19 MORESBY PLACE **ALLAMBIE HEIGHTS**

FOR


Mr. R. & Mrs. L. MERRY

DATE DEC, 2022 SCALE N.T.S.

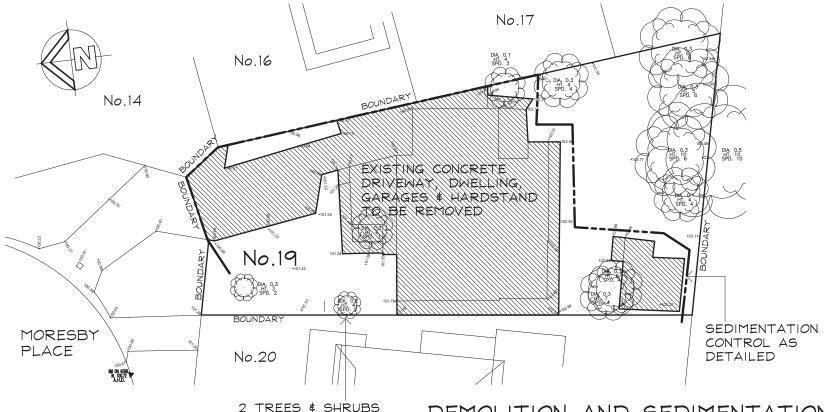

DEMOLITION AND SEDIMENTATION CONTROL FENCE PLAN

Scale 1:200

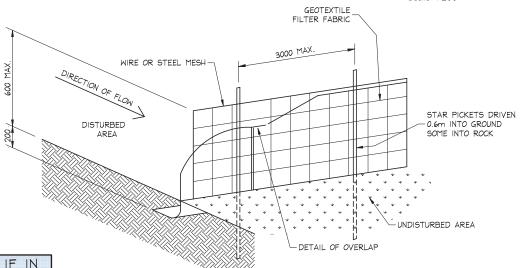

DOUBT ASK SEDIMENTATION CONTROL FENCE DETAIL

SCALE = N.T.S.

TO BE REMOVED

SEDIMENT CONTROL:

- INSTALL SEDIMENT CONTROL STRUCTURES IN LOCATIONS INDICATED ON DRAWINGS AND AS OTHERWISE REQUIRED TO CONTROL SEDIMENT DURING ALL EXCAVATIONS AND WHILST AREAS OF THE SITE ARE EXPOSED TO EROSION.
- 2. CONTROL STRUCTURES TO BE AS DETAILED OR AS OTHERWISE REQUIRED
- 3. REVIEW CONTROL MEASURES AND MAINTAIN STRUCTURES DURING CONSTRUCTION.
- 4. IF ADDITIONAL MEASURES ARE REQUIRED FOR EROSION CONTROL OR BY COUNCIL REQUIREMENTS REFER TO "URBAN EROSION AND SEDIMENT CONTROL" GUIDELINES PREPARED BY THE DEPARTMENT OF CONSERVATION AND LAND MANAGEMENT.



Incorporating Classic Country Cottages OFFICE - 39 GAVENLOCK ROAD TUGGERAH 2259

P.O. BOX 5240 CHITTAWAY BAY N.S.W. 2261
Tel: (02) 4352 1189 Fax: (02) 4352 1198
Builders Lic. 158741C ABN 65 687 862 151

© This drawing and design remains the property of CLASSIC COUNTRY COTTAGES and may not be copied in whole or in part without prior approval of CLASSIC COUNTRY COTTAGES

PROJECT

PROPOSED NEW DWELLING 19 MORESBY PLACE ALLAMBIE HEIGHTS

FOR

Mr. R. & Mrs. L. MERRY

DATE DEC, 2022 SCALE 1:200

~~105 No.

มพ.G. No. 41.⁄Л

Colour & Material Schedule

for

9-03-2023 **19 Moresby Place, Allambie Heights NSW 2100**

The owners have expressed a desire for the design and character of the home to be apathetic to the locality and to improve the visual quality and identity of the streetscape, the colours and materials chosen are warm earthy tones and natural timber to help the home harmonise with the natural surrounding environment and ensure minimum visual eminence.

Roof	Colorbond Steel	Woodlands Grey	Chains Convent Resolut Duyli Co
Cladding	Dulux Snowy Mou	ntains	Date: Statement of the
Decks	Natural Timber	Natural Timber stain	