

m: 0426 957 518

e: operations@actionplans.com.au w: www.actionplans.com.au

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DEVELOPMENT APPLICATION

These plans are for Council Approval only.

NO.	DRAWING NAME
DA00	COVER
DA01	NOTATION
DA02	SAFETY NOTES
DA03	SITE ANALYSIS
DA04	SITE / ROOF / SEDIMENT EROSION / WASTE MANAGEMENT / STORMWATER CONCEPT PLAN
DA05	EXISTING GROUND FLOOR PLAN
DA06	PROPOSED GROUND FLOOR PLAN
DA07	PROPOSED FIRST FLOOR PLAN
DA08	NORTH ELEVATION - PRIMARY ROAD
DA09	EAST ELEVATION - SIDE
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DA14	AREA CALCULATIONS
DA15	SHADOW DIAGRAM - 21 JUNE - 9AM
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DA17	SHADOW DIAGRAM - 21 JUNE - 3PM
DA18	SAMPLE BOARD
DA19	BASIX COMMITMENTS

ITEM DETAILS	DEVELOPMENT APPLICATION				
ADDRESS	19 MORESBY PLACE, ALLAMBIE HEIGHTS 2100				
LOT & DP/SP	LOT 19 DP 28394				
COUNCIL	NORTHERN BEACHES COUNCIL (WARRI	NGAH)			
SITE AREA	625.9m²				
FRONTAGE	13.89m (IRREGULAR)				
CONTROLS	PERMISSIBLE / REQUIRED	EXISTING	PROPOSED	COMPLIANCE	
	m / m² / %	m / m² / %	m / m² / %		
<u>LEP</u>					
LAND ZONING	R2 – LOW DENSITY RESIDENTIAL	R2	R2	YES	
MINIMUM LOT SIZE	600m²	625.9m²	UNCHANGED	YES	
MAXIMUM BUILDING HEIGHT	8.5m	3.908m	8.355m	YES	
HAZARDS					
LANDSLIP RISK	Area A - Slope less than 5 degrees	N/A	N/A	N/A	
BUSHFIRE PRONE LAND	Bush Fire Prone Land: Buffer-100m & 30m	N/A	N/A	N/A	
DCP					
WALL HEIGHT	7.2m	4.458m	7.493m	NO	
NUMBER OF STOREYS	2	1	2	YES	
SIDE BOUNDARY ENVELOPE	4m	-	-	YES	
SIDE BOUNDARY SETBACKS	0.9m	E: 0.565m W: 0.875m	UNCHANGED	YES	
FRONT BOUNDARY SETBACK	6.5m	14.315m	12.942m	YES	
REAR BOUNDARY SETBACK	6m	11.056m	10.994	YES	
LANDSCAPE OPEN SPACE	40% (250.36m²)	44% (274.28m²)	38% (240.71m²)	NO	
PRIVATE OPEN SPACE 60m ² 60m ² UNCHANGED			UNCHANGED	YES	

19 Moresby Place Allambie Heights, NSW 2100



NCC 2022 & AS COMPLIANCES SPECIFICATIONS

- STRUCTURE PART H1 & SECTION 2 OF NCC
- STRUCTURAL PROVISIONS PART H1D2 & PART 2.2 OF NCC SITE PREPARATION PART H1D3 & SECTION 3 OF NCC
- EARTHWORKS PART 3.2 OF NCC DRAINAGE PART 3.3 OF NCC
- TERMITE RISK MANAGEMENT PART 3.4 OF NCC FOOTINGS & SLABS PART H1D4 & SECTION 4 OF NCC
- FOOTINGS, SLABS & ASSOCIATED ELEMENTS PART 4.2 OF NCC - MASONRY - PART H1D5 & SECTION 5 OF NCC
- MASONRY VENEER PART 5.2 OF NCC
- CAVITY MASONRY PART 5.3 OF NCC
- UNREINFORCED SINGLE LEAF MASONRY PART 5.4 OF NCC - ISOLATED PIERS - PART 5.5 OF NCC
- MASONRY COMPONENTS & ACCESSORIES PART 5.6 OF NCC
- WEATHERPROOFING OF MASONRY PART 5.7 OF NCC FRAMING PART H1D6 & SECTION 6 OF NCC
- SUB FLOOR VENTILATION PART 6.2 OF NCC STRUCTURAL STEEL MEMBERS PART 6.3 OF NCC
- ROOF AND WALL CLADDING PART H1D7 & SECTION 7 OF NCC SHEET ROOFING PART 7.2 OF NCC
- ROOF TILES & SHINGLES PART 7.3 OF NCC GUTTERS & DOWNPIPES PART 7.4 OF NCC
- TIMBER & COMPOSITE WALL CLADDING PART 7.5 OF NCC - GLAZING - PART H1D8 & SECTION 8 OF NCC
- WINDOWS & EXTERNAL GLAZED DOORS PART 8.2 OF NCC
- GLASS PART 8.3 OF NCC
- GLAZING HUMAN IMPACT PART 8.4 OF NCC
- DAMP & WEATHERPROOFING PART H2 OF NCC FIRE SAFETY PART H3 & SECTION 9 OF NCC
- FIRE SEPARATION OF EXTERNAL WALLS PART 9.2 OF NCC FIRE PROTECTION OF SEPARATING WALLS & FLOORS PART 9.3 OF NCC
- FIRE PROTECTION OF GARAGE TOP DWELLINGS PART 9.4 OF NCC SMOKE ALARMS & EVACUATION LIGHTING PART 9.5 OF NCC
- HEALTH & AMENITY PART H4 & SECTION 10 OF NCC WET AREA WATERPROOFING PART 10.2 OF NCC

- ROOM HEIGHTS PART 10.3 OF NCC
- FACILITIES PART 10.4 OF NCC - LIGHT - PART 10.5 OF NCC
- VENTILATION PART 10 6 OF NCC
- SOUND INSULATION PART 10.7 OF NCC
- CONDENSATION MANAGEMENT PART 10.8 OF NCC
- SAFE MOVEMENT & ACCESS PART H5 & SECTION 11 0F NCC
- STAIRWAY & RAMP CONSTRUCTION PART 11.2 OF NCC BARRIERS & HANDRAILS PART 11.3 OF NCC

- ANCILLARY PROVISIONS PART H7 & SECTION 12 OF NCC
 ATTACHMENT OF FRAMED DECKS & BALCONIES TO EXTERNAL WALLS OF BUILDINGS USING A WALING PLATE PART 12.3 OF NCC
- HEATING APPLIANCES, FIREPLACES, CHIMNEYS & FLUES PART 12.4 OF NCC - ENERGY EFFICIENCY - PART H6 & SECTION 13 OF NCC
- BUILDING FABRIC PART 13.2 OF NCC
- EXTERNAL GLAZING PART 13.3 OF NCC
- BUILDING SEALING PART 13.4 OF NCC
- CEILING FANS PART 13.5 OF NCC
- WHOLE OF HOME ENERGY USAGE PART 13.6 OF NCC - SERVICES - PART 13.7 OF NCC
- DEMOLITION WORKS TO COMPLY WITH AS 2601-2001 THE DEMOLITION OF STRUCTURES. - WATERPROOFING OF WET AREAS TO COMPLY WITH AS 3740:2021

- ALL PLUMBING & DRAINAGE WORK TO COMPLY WITH AS 3500:2021 ALL PLASTERBOARD WORK TO COMPLY WITH AS 2588:2018
- ALL STRUCTURAL STEEL WORK TO COMPLY WITH AS 4100:2020 & AS 1554.1:2014 ALL CONCRETE WORK TO COMPLY WITH AS 3600:2018
- ALL ROOF SHEETING WORK TO COMPLY WITH AS 1562.1:2018 ALL SKYLIGHTS TO COMPLY WITH AS 4285:2019
- ALL CERAMIC TILING TO COMPLY WITH AS 3958.1-2007 & 3958.2-1992 ALL GLAZING ASSEMBLIES TO COMPLY WITH AS 2047-2014 & AS 1288:2021
- ALL TIMBER RETAINING WALLS ARE TO COMPLY WITH AS 1720, AS 1170
- ALL RETAINING WALLS ARE TO COMPLY WITH AS 3700:2018 & AS 3600:2018

IMPORTANT NOTATION FOR BUILDERS

- All dimensions are to be confirmed on-site by the builder/subcontractor, any incongruencies must be reported to the Designer in writing before the commencement of any work.
- No Survey has been made on the boundaries. All bearings, distances, and areas have been taken from the contour survey plan. A Survey must be carried out to confirm the exact boundary locations.
- No construction work shall commence until a site survey confirming the site boundaries has been completed. The contractor is to ensure that the approved boundary setbacks are confirmed and used, the boundary setbacks take precedence over all other dimensions. The Survey work must be performed by a registered Surveyor.
- In the event of encountering any discrepancies on these drawings, specification, or subsequent instructions issued, the Builder/Subcontractor shall contact the designer in writing before proceeding further with any work. The builder/subcontractor is responsible to ensure that all materials installed on-site are fit for purpose and comply with the NCC and relevant Australian Standards. The builder is to obtain written confirmation of material selection by the
- Client prior to ordering. - All construction, control joints, and expansion joints in the walls, floors, and other locations shall be in strict accordance with the structural engineering details. No joints or breaks other than specified are allowed without written
- permission from the Engineer - Measurements for the fabrication of secondary components such as windows, doors, internal frames, structural steel components, and the like, are not to be taken from these documents. Measurements must be taken on-site to suit the
- All structural components shall be in strict accordance with details and specifications as prepared by a suitably qualified structural engineer.
- All existing structures need to be examined for structural adequacy, and it is the Contractor's responsibility to ensure that a certificate of structural adequacy is available prior to the start of any work.

SPECIFICATION

work as constructed

- "Approval" obtained by either an 'Accredited Certifying Authority' or 'Local Council'.
- The Owner will directly pay all fees associated with the following:
- Building approval from council or accredited certifier, any footpath and kerb deposits with the local council, insurance fees to Building Services Corporation, Long Service Leave levy fees and approval fees by water and sewerage authority. All other fees are to be paid by the builder. The amount of any local authority deposits which are forfeited due to damage or other causes, will be deducted from payments due to the builder.
- -The Builder is to provide at his/her own expense adequate Public Risk Insurance and arrange indemnification under the Workers Compensation Act. Works insurance to be as stated in the contract conditions
- All tenderers are to visit the site to satisfy themselves as to the nature and extent of the Works, facilities available and difficulties entailed in the works as Variations will not be allowed due to work arising owing to neglect of this clause.
- These drawings shall be read in conjunction with all structural and other consultant's drawings and specifications and with any such written instructions as may be issued during the course of the contract.
- Set out dimensions shown on this drawing shall be verified by the builder on site before commencement of any work.
- Dimensions shall not be obtained by scaling the drawings, use figured dimensions. All dimensions are in millimetres. - The Builder is to ensure all construction, levels and other items comply with the conditions of the Building Approval.
- Any detailing additional to that which is supplied shall be resolved between the Owner and the Builder, to the Owner's approval. Except for any structural details or design, which is to be supplied by the Engineer. - All work to be carried out in a tradesman like manner and in accordance with the standards, codes and regulations of
- Standards Australia, the National Construction Code and any statutory authority having jurisdiction over the works. - All structural work is to be in accordance with the structural details prepared by a suitably qualified structural engineer, including but not limited to all piers, footings, concrete slabs, retaining walls, steelworks, formwork, underpinning additional structural loads, timber framing, wind bracing and associated connections. Builder to obtain prior to finalising the tender, unless previously obtained by owners.
- All brickwork is to be selected by the Owner, and is to comply with AS 1640.
- All masonry is to comply with AS 3700.
- Provide all metalwork and flashings necessary to satisfactorily complete the works.
- All timber construction to be in accordance with AS 1684 Residential timber-framed construction. Level and grade where necessary under timber floors to provide a minimum clearance of 300mm under bearers or 400mm under joists. Adequate precautions shall be taken to ensure that the surface and/or seepage water does not collect or remain under
- Sustainable timbers, and not rainforest or old growth timber will be used. Recycled timber or second hand timbers are to be sourced and used in preference to plantation timbers, if available and suitable
- All glazing installation is to comply with AS 1288, AS 2047 and in accordance with manufacturers recommendations. - All wall and ceiling linings in wet areas to be plasterboard and villaboard, or equal. A breathable wall wrap is to be provided to all external walls. Timber cladding is to be battened out from timber frame to provide an 'air' gap to prevent condensation. Workmanship is to comply with the relevant Australian Standards or installed in accordance with manufacturer's specifications. All bathrooms and wet areas to be waterproofed with a flexible membrane to manufacturer's specifications and to AS 3740, Part H4D2 and Section 10; Part 10.2 of the 2022 NCC.
- All Architraves and skirtings to the profile as selected by owner, and painted or stain finish as selected
- All plumbing and drainage work to be installed and completed by a licensed tradesman and in accordance with the statutory body having authority over the works. Connect all waste to Sydney Water sewer line
- Connect all stormwater to existing system or street drainage system in accordance with AS 3500, Part H2D2 and Section 3: Part 3.3 of the 2022 NCC.
- Smoke detector alarms are to be installed in accordance with AS 3786, Part H3D6 and Section 9; Part 9.5 of the 2022
- If a member which provides structural support to the works is subject to termite attack, management measures are to comply with AS 3660 and Section 3; Part 3.4 of the 2022 NCC. Termite management system to be installed to manufacturer's specifications
- Stairs and Balustrades to comply with Part H5D2, H5D3 and Section 11; Part 11.2 and 11.3 of the 2022 NCC. Provide a handrail along the full length of the flight and a slip resistant finish to the edge of the nosings to comply with 3.9.1 and 3.9.2 of the NCC. No horizontal elements to facilitate climbing between 150mm and 760mm where floor to level below is more than 4m
- Electrical works to be in accordance with SAA wiring rules and be done by a licenced tradesperson. Obtain electrical layout prior to proceeding. All electrical power (GPO's) and light outlets to be determined by the Owner
- Painting: All paints or other coatings shall be of the best quality materials & of approved manufacture. All priming materials shall be of an approved brand acceptable to the manufacturer of the finishing coats to be used. External iginery intended to be painted shall be primed on all faces at the place of assembly. Where new work or alteration work adjoins existing painted surfaces allow for repainting existing surfaces to provide uniform appearance.
- ZERO-VOC or LOW-VOC paints and primers only are to be used.
- Any work indicated on the plans but not specified and any item not shown on the plans which is obviously necessary as part of proper construction and/or finish, is to be considered as shown and specified and is to be undertaken as part of the contract. Variations will not be permitted without prior written approval by the owners
- The Builder shall provide sediment and siltration control measures as required by Council, and maintain them throughout the duration of the works
- A legible copy of the plans bearing approval stamps, must be maintained on the job site at all times. Hours of construction shall be restricted to the times as required by the building approval.
- The Builder is to arrange for all inspections required by the relevant authorities and/or lending institutions, to their

- The Builder is to obtain approval for interruptions to existing services and minimise the duration and number of interruptions. Any interruptions to existing services and equipment is to be undertaken by appropriately qualified tradespersons
- The Builder shall restore, reinstate or replace any damage to existing structures or landscaping caused by the
- Provide protection to existing trees to remain, or as required by the Approval Conditions.

GENERAL NOTATION

- Approved means by the 'relevant local authority' or council?
- All work and materials to comply with the current Australian standards at the time of commencement, where
- The builder is to comply with all ordinances, local authority regulations and the requirements of all services supply authorities having jurisdiction over the works.
- All new downpipes are to be connected to the existing stormwater system.
- All timber sizes and concrete details to be confirmed by the builder prior to commencement of any work
- All gutters, downpipes to be colorbond.
- All wall and ceiling linings to be plasterboard or cement render as selected, and villa board in wet areas. To comply with relevant Australian standards, and installed in accordance with manufacturers specification

NCC 2022 & AS COMPLIANCES SPECIFICATIONS

- Structure Part H1 & Section 2 of NCC
- Structural Provisions PART H1D2 & PART 2.2 of NCC
- Site Preparation Part H1D3 & Section 3 of NCC
- Earthworks Part 3.2 of NCC
- Drainage Part 3.3 of NCC
- Termite Risk Management Part 3.4 of NCC
- Footings & Slabs Part H1D4 & Section 4 of NCC
- Footings, Slabs & Associated Elements Part 4.2 of NCC
- Masonry Part H1D5 & Section 5 of NCC
- Masonry Veneer Part 5.2 of NCC
- Cavity Masonry Part 5.3 of NCC Unreinforced Single Leaf Masonry - Part 5 4 of NCC
- Isolated Piers Part 5.5 of NCC
- Masonry Components & Accessories Part 5.6 of NCC
- Waetherproofing of Masonry Part 5.7 of NCC
- Framing Part H1D6 & Section 6 of NCC
- Sub Floor Ventilation Part 6.2 of NCC
- Structural Steel Members Part 6.3 of NCC
- Roof & Wall Cladding Part H1D7 & Section 7 of NCC
- Sheet Roofing Part 7.2 of NCC
- Roof Tiles & Shingles Part 7.3 of NCC
- Gutters & Downpipes Part 7.4 of NCC - Timber & Composite Wall Cladding - Part 7.5 of NCC
- Glazing Part H1D8 & Section 8 of NCC
- Windows & External Glazed Doors Part 8.2 of NCC - Glass - Part 8.3 of NCC
- Glazing Human Impact Part 8.4 of NCC
- Damp & Weatherproofing Part H2 of NCC
- Fire Safety Part H3 & Section 9 of NCC
- Fire Separation of External Walls Part 9.2 of NCC - Fire Protection of Separating Walls & Floors - Part 9.3 of NCC
- Fire Protection of Garage Top Dwellings Part 9.4 of NCC
- Smoke Alarms & Evacuation Lighting Part 9.5 of NCC
- Health & Amenity Part H4 & Section 10 of NCC
- Wet Area Waterproofing Part 10.2 of NCC
- Room Heights Part 10.3 of NCC
- Facilities Part 10.4 of NCC
- Light Part 10.5 of NCC Ventilation - Part 10.6 of NCC
- Sound Insulation Part 10.7 of NCC
- Condensation Management Part 10.8 of NCC
- Safe Movement & Access Part H5 & Section 11 of NCC Stairway & Ramp Construction - Part 11.2 of NCC
- Barriers & Handrails Part 11.3 of NCC
- Ancillary Provisions Part H7 & Section 12 of NCC
- Construction in Alpine Areas Part 12.2 of NCC
- Attachment of Framed Decks & Balconies to External Walls of Buildings Using a Waling Plate Part 12.3 of NCC
- Heating Appliances, Fireplaces, Chimneys & Flues Part 12.4 of NCC
- Swimming Pools Part H7P1 & NSW H7D2 of NCC
- Construction in Bushfire Prone Areas Part NSW H7D4 of NCC
- Energy Efficiency Part H6 & Section 13 of NCC - Building Fabric - Part 13.2 of NCC
- External Glazing Part 13.3 of NCC
- Building Sealing Part 13.4 of NCC
- Ceiling Fans Part 13.5 of NCC
- Whole of Home Energy Usage Part 13.6 of NCC

- Services - Part 13.7 of NCC

- Pool Fencing & other provisions Regulations & AS 1926
- Demolition Works to comply with AS 2601-2001 The Demolition of Structures.
- Waterproofing of Wet Areas to comply with AS 3740:2021
- All plumbing & drainage work to comply with AS 3500:2021
- All plasterboard work to comply with AS 2588:2018
- All structural steel work to comply with AS 4100:2020 & AS 1554.1:2014
- All concrete work to comply with AS 3600:2018 - All roof sheeting work to comply with AS 1562.1:2018
- All skylights to comply with AS 4285:2019
- All ceramic tiling to comply with AS 3958.1-2007 & 3958.2-1992 - All glazing assemblies to comply with AS 2047-2014 & AS 1288:2021
- All timber retaining walls to comply with AS 1720, AS 1170
- All retaining walls to comply with AS 3700:2018 & AS 3600:2018
- All construction in bushfire-prone areas to comply with AS 3959:2018

THIS SET OF DRAWING SHOULD BE READ & KEPT IN ITS ENTIRETY. NO INDIVIDUAL PAGE SHOULD BE SEPARATED FROM THE REST OF THE SET. EACH NOTATION LISTED ON THIS PAGE APPLY TO ALL PAGES OF THIS SET.

SAFTEY NOTES

THESE NOTES MUST BE READ AND UNDERSTOOD BY ALL INVOLVED IN THE PROJECT. THIS INCLUDES (but is not excluded to): OWNER, BUILDER, SUB-CONTRACTORS, CONSULTANTS, RENOVATORS, OPERATORS, MAINTENORS, DEMOLISHERS.

1. FALLS, SLIPS, TRIPS

a) WORKING AT HEIGHTS

DURING CONSTRUCTION

Wherever possible, components for this building should be prefabricated off-site or at ground level to minimise the risk of workers falling more than two metres. However, construction of this building will require workers to be working at heights where a fall in excess of two metres is possible and injury is likely to result from such a fall. The builder should provide a suitable barrier wherever a person is required to work in a situation where falling more than two metres is a nossibility

DURING OPERATION OR MAINTENANCE

For houses or other low-rise buildings where scaffolding is appropriate: Cleaning and maintenance of windows, walls, roof or other components of this building will require persons to be situated where a fall from a height in excess of two metres is possible. Where this type of activity is required, scaffolding, ladders or trestles should be used in accordance with relevant codes of practice, regulations or legislation. For buildings where scaffold, ladders, trestles are not appropriate: Cleaning and maintenance of windows, walls, roof or other components of this building will require persons to be situated where a fall from a height in excess of two metres is possible. Where this type of activity is required, scaffolding, fall barriers or Personal Protective Equipment (PPE) should be used in accordance with relevant codes of practice, regulations or legislation.

b) SLIPPERY OR UNEVEN SURFACES

FLOOR FINISHES Specified

If finishes have been specified by designer, these have been selected to minimise the risk of floors and paved areas becoming slippery when wet or when walked on with wet shoes/ feet. Any changes to the specified finish should be made in consultation with the designer or, if this is not practical, surfaces with an equivalent or better slip resistance should be chosen.

FLOOR FINISHES By Owner

If designer has not been involved in the selection of surface finishes. the owner is responsible for the selection of surface finishes in the pedestrian trafficable areas of this building. Surfaces should be selected in accordance with AS HB 197:1999 and AS/ NZ 4586:2004.

STEPS, LOOSE OBJECTS AND UNEVEN SURFACES

Due to design restrictions for this building, steps and/ or ramps are included in the building which may be a hazard to workers carrying objects or otherwise occupied. Steps should be clearly marked with both visual and tactile warning during construction, maintenance, demolition and at all times when the building operates as a workplace. Building owners and occupiers should monitor the pedestrian access ways and in particular access to areas where maintenance is routinely carried out to ensure that surfaces have not moved or cracked so that they become uneven and present a trip hazard. Spills, loose material, stray objects or any other matter that may cause a slip or trip hazard should be cleaned or removed from access ways. Contractors should be required to maintain a tidy work site during construction, maintenance or demolition to reduce the risk of trips and falls in the workplace. Materials for construction or maintenance should be stored in designated areas away from access ways and work areas.

2. FALLING OBJECTS

LOOSE MATERIALS OR SMALL OBJECTS

Construction, maintenance or demolition work on or around this building is likely to involve persons working above ground level or above floor levels. Where this occurs one or more of the following measures should be token to ovoid objects falling from the area where the work is being carried out onto persons below.

- 1. Prevent or restrict access to areas below where the work is
- being carried out.
- 2. Provide toeboards to scaffolding or work platforms
- 3. Provide protective structure below the work area.
- 4. Ensure that all persons below the work area have Personal

Protective Equipment (PPE).

BUILDING COMPONENTS

During construction, renovation or demolition of this building, parts of the structure including fabricated steelwork, heavy panels and many other components will remain standing prior to or after supporting parts are in place. Contractors should ensure that temporary bracing or other required support is in place at all times when collapse which may injure persons in the area is a possibility. Mechanical lifting of materials and components during construction, maintenance or demolition presents a risk of falling objects. Contractors should ensure that appropriate lifting devices are used, that loads are properly secured and that access to areas below the load is prevented or restricted.

3. TRAFFIC MANAGEMENT

For building on a major road, narrow road or steeply sloping road: Parking of vehicles or loading/ unloading of vehicles on this roadway may cause a traffic hazard. During construction, maintenance or demolition of this building designated parking for workers and loading areas should be provided. Trained traffic management personnel should be responsible for the supervision of these areas. For building where on-site loading/ unloading is restricted: Construction of this building will require loading and unloading of materials on the roadway. Deliveries should be well planned to ovoid congestion of loading areas and trained traffic management personnel should be used to supervise loading/ unloading areas. For all buildings: Busy construction and demolition sites present a risk of collision where deliveries and other traffic are moving within the site. A traffic management plan supervised by trained traffic management personnel should be adopted for the work site.

4. SERVICES

GENERAL

Rupture of services during excavation or other activity creates a variety of risks including release of hazardous material. Existing services are located on or around this site. Where known, these ore identified on the plans but the excel location and extent of services may vary from that indicated. Services should be located using on appropriate service (such as Dial Before You Dig), appropriate excavation practice should be used and, where necessary, specialist contractors should be used. Locations with underground power: Underground power lines MAY be located in or around this site. All underground power lines must be disconnected or carefully located and adequate warning signs used prior to any construction, maintenance or demolition commencing. Locations with overhead power lines: Overhead power lines MAY be near or on this site. These pose a risk of electrocution if struck or approached by lifting devices or other plant and persons working above ground level. Where there is a danger of this occurring, power lines should be, where practical, disconnected or relocated. Where this is not practical adequate warning in the form of bright coloured tape or signage should be used or a protective barrier provided.

5. MANUAL TASKS

Components within this design with a moss in excess of 25kg should be lifted by two or more workers or by mechanical lifting device. Where this is not practical, suppliers or fabricators should be required to limit the component mass. All material packaging, building and maintenance components should clearly show the total moss of packages and where practical all items should be stored on site in a way which minimises bending before lifting. Advice should be provided on safe lifting methods in all areas where lifting may occur. Construction, maintenance and demolition of this building will require the use of portable tools and equipment. These should be fully maintained in accordance with manufacturer's specifications and not used where faulty or (in the case of electrical equipment) not carrying a current electrical safety tag. All safety guards or devices should be regularly checked and Personal Protective Equipment should be used in accordance with manufacturer's specification.

6. HAZARDOUS SUBSTANCES

ASBESTOS

For alterations to a building constructed prior to 1990: If this existing building was constructed prior to:

1990 - it therefore may contain asbestos

1986 - it therefore is likely to contain asbestos

either in cladding material or in fire retardant insulation material. In either case, the builder should check and, if necessary, take appropriate action before demolishing, culling, sanding, drilling or otherwise disturbing the existing structure

POWDERED MATERIALS

Many materials used in the construction of this building con cause harm if inhaled in powdered form. Persons working on or in the building during construction, operational maintenance or demolition should ensure good ventilation and wear Personal Protective Equipment including protection against inhalation while using powdered material or when sanding, drilling, cutting or otherwise disturbing or creating powdered material.

TREATED TIMBER

The design of this building may include provision for the inclusion of treated limber within the structure. Dust or furnes from this material can be harmful. Persons working on or in the building during construction, operational maintenance or demolition should ensure good ventilation and wear Personal Protective Equipment including protection against inhalation of harmful material when sanding, drilling, cutting or using treated timber in any way that may cause harmful material to be released. Do not burn treated timber.

VOLATILE ORGANIC COMPOUNDS

Many types of glue, solvents, spray packs, paints, varnishes and some cleaning materials and disinfectants have dangerous emissions. Areas where these are used should be kept well ventilated while the material is being used and for a period after installation. Personal Protective Equipment may also be required. The manufacturer's recommendations for use must be carefully considered at all times.

SYNTHETIC MINERAL FIBRE

Fibreglass, rockwool, ceramic and other material used for thermal or sound insulation may contain synthetic mineral fibre which may be harmful if inhaled or if it comes in contact with the skin, eyes or other sensitive parts or the body. Personal Protective Equipment including protection against inhalation of harmful material should be used when installing, removing or working near bulk insulation material.

TIMBER FLOORS

This building may contain timber floors which have an applied finish. Areas where finishes are applied should be kept well ventilated during sanding and application and for a period after installation. Personal Protective Equipment may also be required. The manufacturer's recommendations for use must be carefully considered at all times.

7. CONFINED SPACES

EXCAVATION

Construction of this building and some maintenance on the building will require excavation and installation of items within excavations. Where practical, installation should be carried out using methods which do not require workers to enter the excavation. Where this is not practical, adequate support for the excavated area should be provided to prevent collapse. Warning signs and barriers to prevent accidental or unauthorised access to all excavations should be provided.

ENCLOSED SPACES

For buildings with enclosed spaces where maintenance or other access may be required: Enclosed spaces within this building may present a risk to persons

entering for construction, maintenance or any other purpose. The design documentation calls for warning signs and barriers to unauthorised access. These should be maintained throughout the life of the building. Where workers are required to enter enclosed spaces, air testing equipment and Personal Protective Equipment should be provided.

SMALL SPACES

For buildings with small spaces where maintenance or other access may be required: Some small spaces within this building will require access by construction or maintenance workers. The design documentation calls for warning signs and barriers to unauthorised access. These should be maintained throughout the life of the building. Where workers are required to enter small spaces they should be scheduled so that access is for short periods. Manual lifting and other manual activity should be restricted in small spaces.

8. PUBLIC ACCESS

Public access to construction and demolition sites and lo areas under maintenance causes risk to workers and public. Warning signs and secure barriers to unauthorised access should be provided. Where electrical installations, excavations, plant or loose materials are present they should be secured when not fully supervised.

9. OPERATIONAL USE OF BUILDING RESIDENTIAL BUILDINGS


This building has been designed as a residential building. If it, at a later date, it is used or intended to be used as a workplace, the provisions of the Work Health and Safely Act 2011 or subsequent replacement Act should be applied to the new use.


NON-RESIDENTIAL BUILDINGS

For non-residential buildings where the end-use has not been identified: This building has been designed to requirements of the classification identified on the drawings. The specific, use of the building is not known at the time of the design and a further assessment of the workplace health and safety issues should be undertaken at the time of fit-out for the end-user. For non-residential buildings where the end-use is known: This building has been designed for the specific use as identified on the drawings. Where a change of use occurs at a later dale a further assessment of the workplace health and safety issues should be undertaken.

10. OTHER HIGH RISK ACTIVITY

All electrical work should be carried out in accordance with Code of Practice: Managing Electrical Risks at the Workplace, AS/ NZ 3012 and all licensing requirements. All work using Plant should be carried out in accordance with Code of Practice: Managing Risks of Plant at the Workplace. All work should be carried out in accordance with Code of Practice: Managing Noise and Preventing Hearing Loss at Work. Due to the history of serious incidents it is recommended that particular care be exercised when undertaking work involving steel construction and concrete placement. All the above applies.

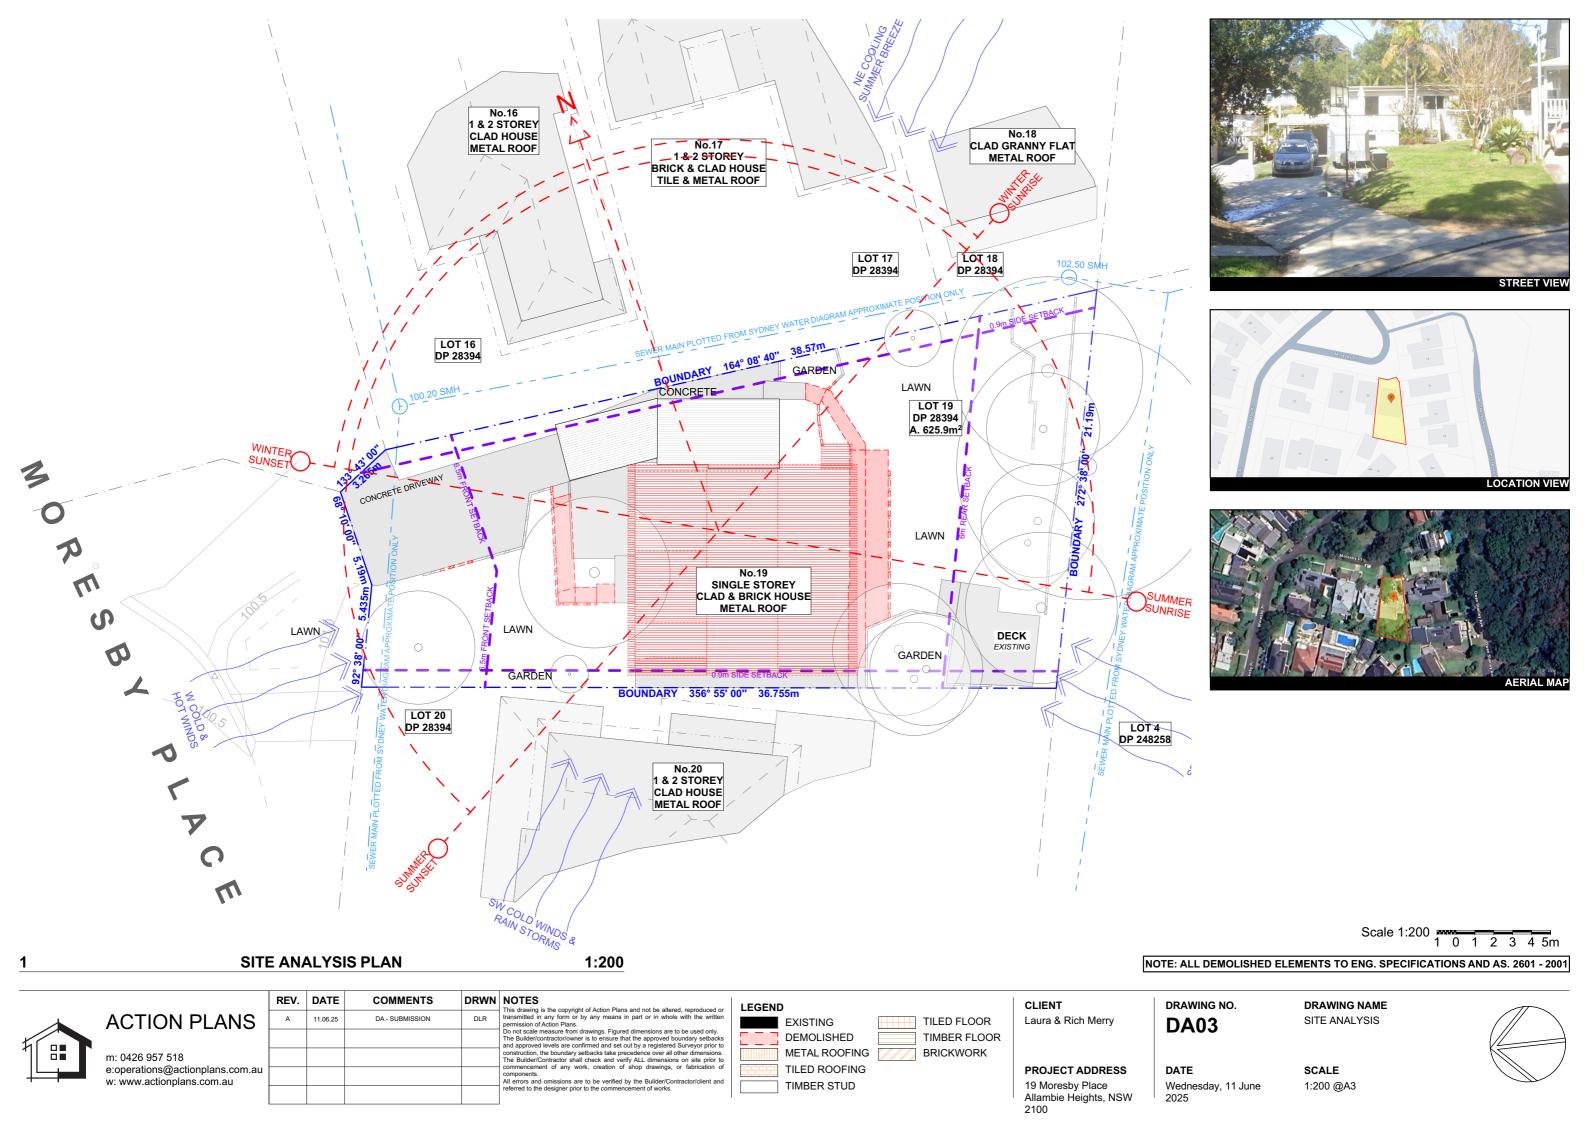

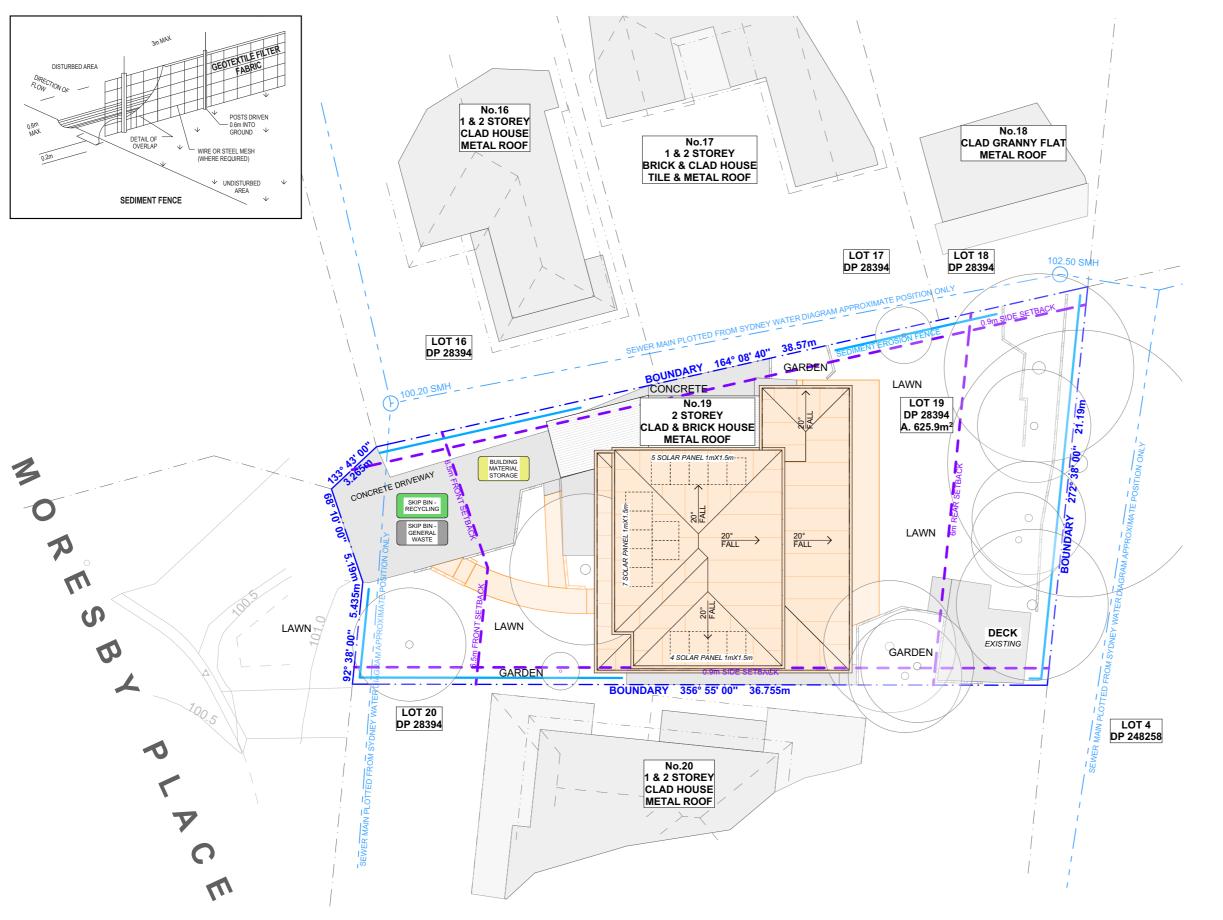

NOTE: SITE BOUNDARY IS TO BE IDENTIFIED BY A REGISTERED SURVEYOR AND CLEARLY MARKED ON SITE PRIOR TO COMMENCEMENT OF ANY CONSTRUCTION WORKS.

NOTES REGARDING BOUNDARY

THE INFORMATION SHOWN ON THIS PLAN IS FOR DESIGN PURPOSES ONLY. THE POSITION OF BOUNDARY LINES HAVE BEEN ESTABLISHED BY A SURVEY TO MEET THE IDENTIFICATION REQUIREMENTS FOR COUNCIL AND NOT FOR REGISTRATION WITH THE LAND REGISTRATION SERVICES NSW NOR MAY THIS PLAN BE USED FOR ANY OTHER PURPOSE. SUBSEQUENT REGISTERED OR OTHER SURVEYS MAY AFFECT THE DEFINED BOUNDARY POSITIONS IN THIS AREA. ANY DIFFERENCES OF THIS NATURE ARE BEYOND THE PURPOSES OF THIS PLAN. THIS PLAN IS FOR THE ABOVE STATED PURPOSES ONLY. RESTRICTIONS ON THE TITLE HAVE NOT BEEN INVESTIGATED. IF FURTHER DEVELOPMENT IS CONTEMPLATED OR CONSTRUCTION INTENDED THEN IT IS IMPORTANT THAT A SURVEY SET OUT IS CARRIED OUT.

DUST CONTROL:

TO REDUCE DUST GENERATED BY WIND ACTION, THE REMOVAL OF THE TOP SOIL IS TO BE MINIMISED. TO PREVENT DUST GENERATION, WATERING DOWN OF THE SITE, ESPECIALLY DURING THE MOVEMENT OF MACHINERY IS REQUIRED. WHERE EXCAVATING INTO ROCK, KEEP THE SURFACE MOIST TO MINIMISE DUST. CONSTRUCT A GRAVEL ENTRY/EXIT POINT USING BLUE METAL AND RESTRICT ALL VEHICLE MOVEMENTS WITHIN THE SITE TO A MINIMUM. ENSURE WIND BREAKS, SUCH AS EXISTING FENCES ARE MAINTAINED DURING THE CONSTRUCTION PHASE UNTIL NEW LANDSCAPING IS PROVIDED OR REINSTATED. PREVENT DUST BY COVERING STOCKPILES

SEDIMENT NOTE:

1. ALL EROSION AND SEDIMENT CONTROL MEASURES TO BE INSPECTED AND MAINTAINED DAILY BY THE SITE MANAGER.

2. MINIMISE DISTURBED AREAS, REMOVE EXCESS SOIL FROM EXCAVATED AREA AS SOON AS POSSIBLE.
3. ALL MATERIAL STOCKPILE TO BE CLEAR FROM DRAINS, GUTTERS AND FOOTPATHS, OR WITHIN SEDIMENT FENCE AREA.

4. DRAINAGE TO BE CONNECTED TO STORMWATER AS SOON AS POSSIBLE. IF STORED ON SITE, IT MUST BE FILTERED BEFORE RELEASING INTO STORMWATER SYSTEM OR WATERWAYS.

5. ROADS AND FOOTPATHS TO BE SWEPT DAILY.

STOCKPILES:

ALL STOCKPILES ARE TO BE KEPT ON-SITE WHERE POSSIBLE. ANY MATERIALS PLACED ON THE FOOTPATHS OR NATURE STRIPS REQUIRE COUNCIL'S PERMISSION.

ALL STOCKPILES ARE TO BE PLACED AWAY FROM THE DRAINAGE LINES AND STREET GUTTERS. IT IS BEST TO LOCATE THESE ON THE HIGHEST PART OF THE SITE IF POSSIBLE. PLACE WATERPROOF COVERING OVER STOCKPILES.

IF REQUIRED PROVIDE DIVERSION DRAIN & BANK AROUND STOCKPILES.

GUTTER PROTECTION:

PROVIDE PROTECTION TO DOWNHILL GRATE IN GUTTER BY MEANS OF SAND BAGS OR BLUE METAL WRAPPED IN GEOTEXTILE FABRIC. WHEN SOIL OR SAND BUILDS UP AROUND THIS SEDIMENT BARRIER, THE MATERIAL SHOULD BE RELOCATED BACK TO THE SITE FOR DISPOSAL.

NOTE: ALL PROPOSED STORMWATER TO CONNECT WITH EXISTING

Scale 1:200 1 2 3 4 5m

SITE / ROOF / SEDIMENT EROSION / WASTE MANAGEMENT / STORMWATER CONCEPT PLAN 1:200



ACTION PLANS

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					construction, the boundary setbacks take precedence over all other dimensions. The Builder/Contractor shall check and verify ALL dimensions on site prior to commencement of any work, creation of shop drawings, or fabrication of
' [components. All errors and omissions are to be verified by the Builder/Contractor/client and
					referred to the designer prior to the commencement of works.



CLIENT Laura & Rich Merry

2100

PROJECT ADDRESS

19 Moresby Place
Allambie Heights, NSW

DATE
Wednesday, 11 June
2025


DA04 DRAWING NO. DRAWING NAME SITE / ROOF / SEI EDOSION / WAST


SITE / ROOF / SEDIMENT EROSION / WASTE MANAGEMENT / STORMWATER CONCEPT PLAN


SCALE

1:200 @A3



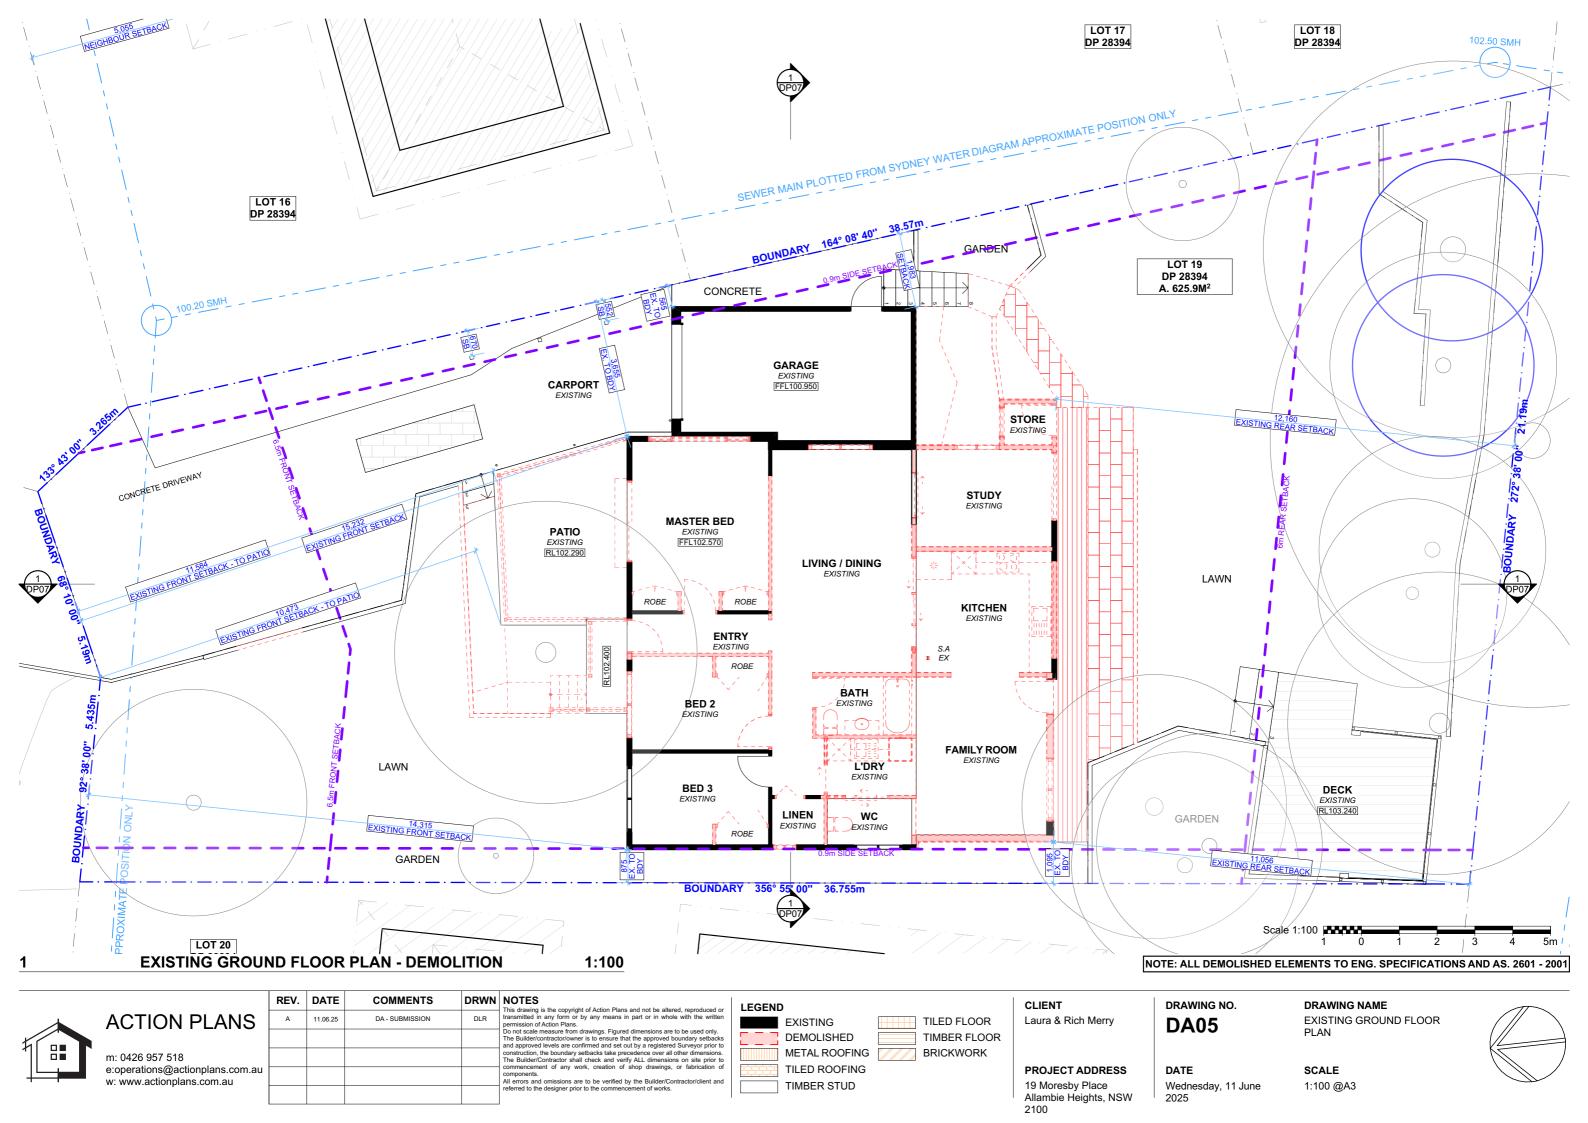

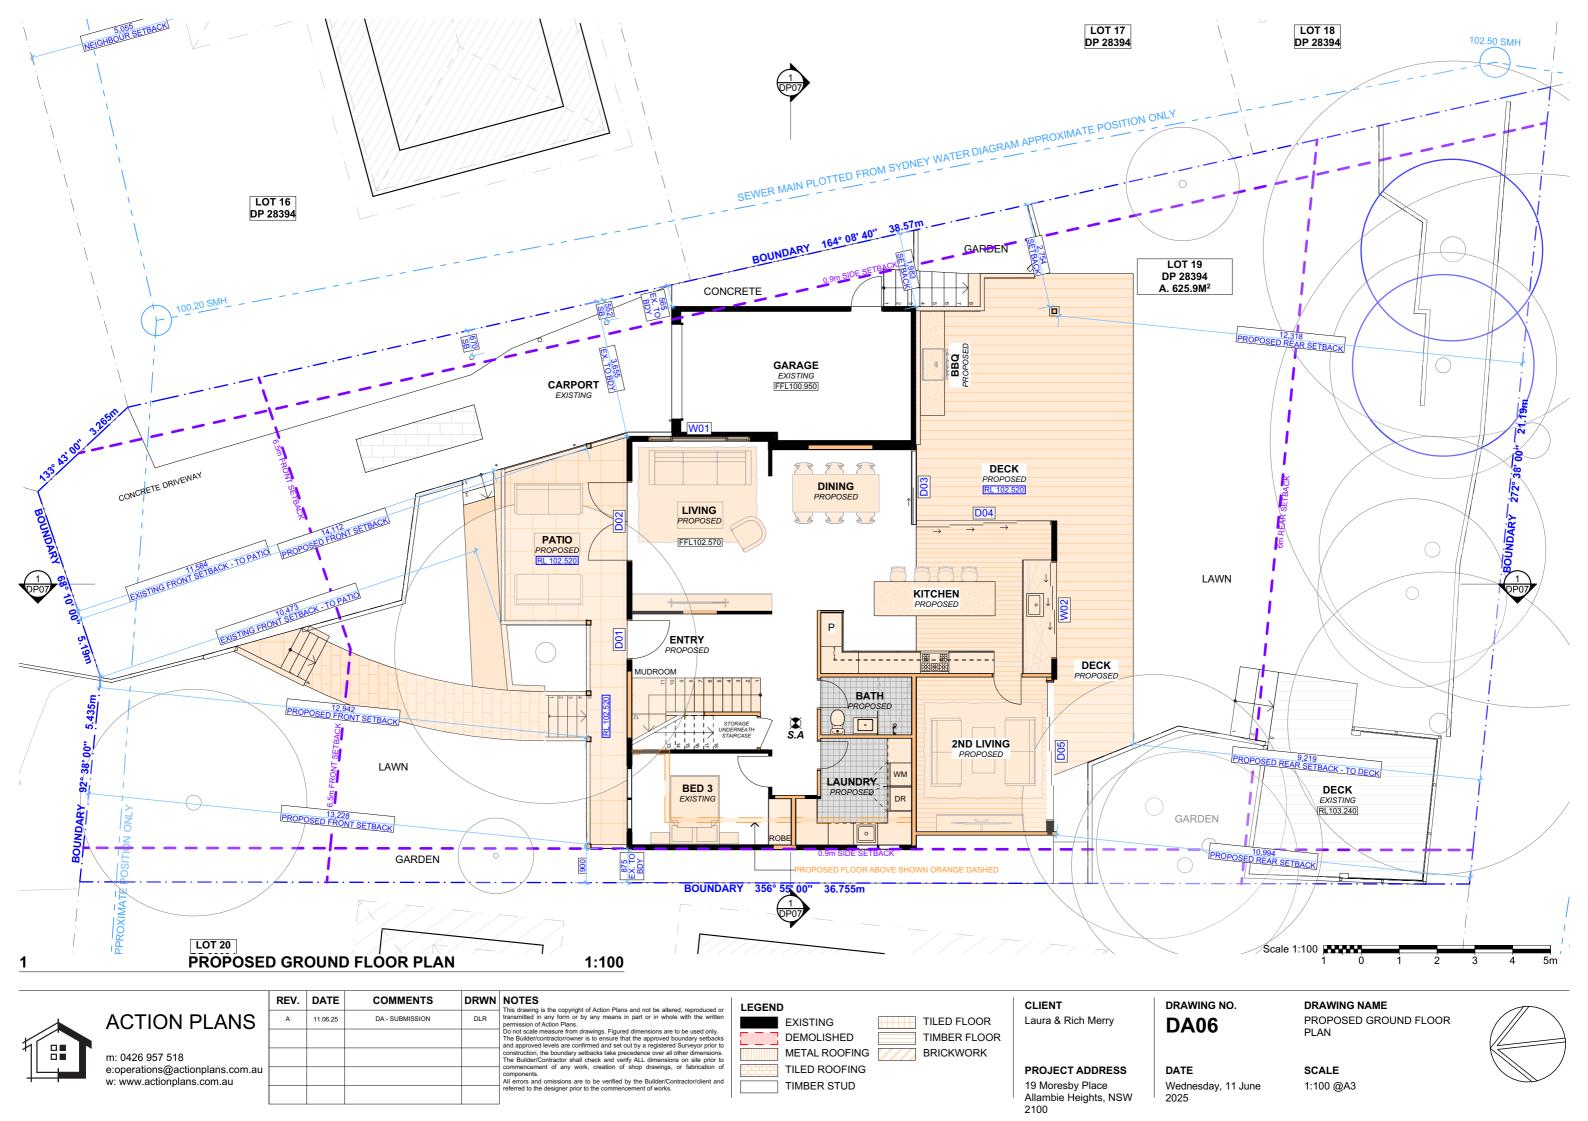

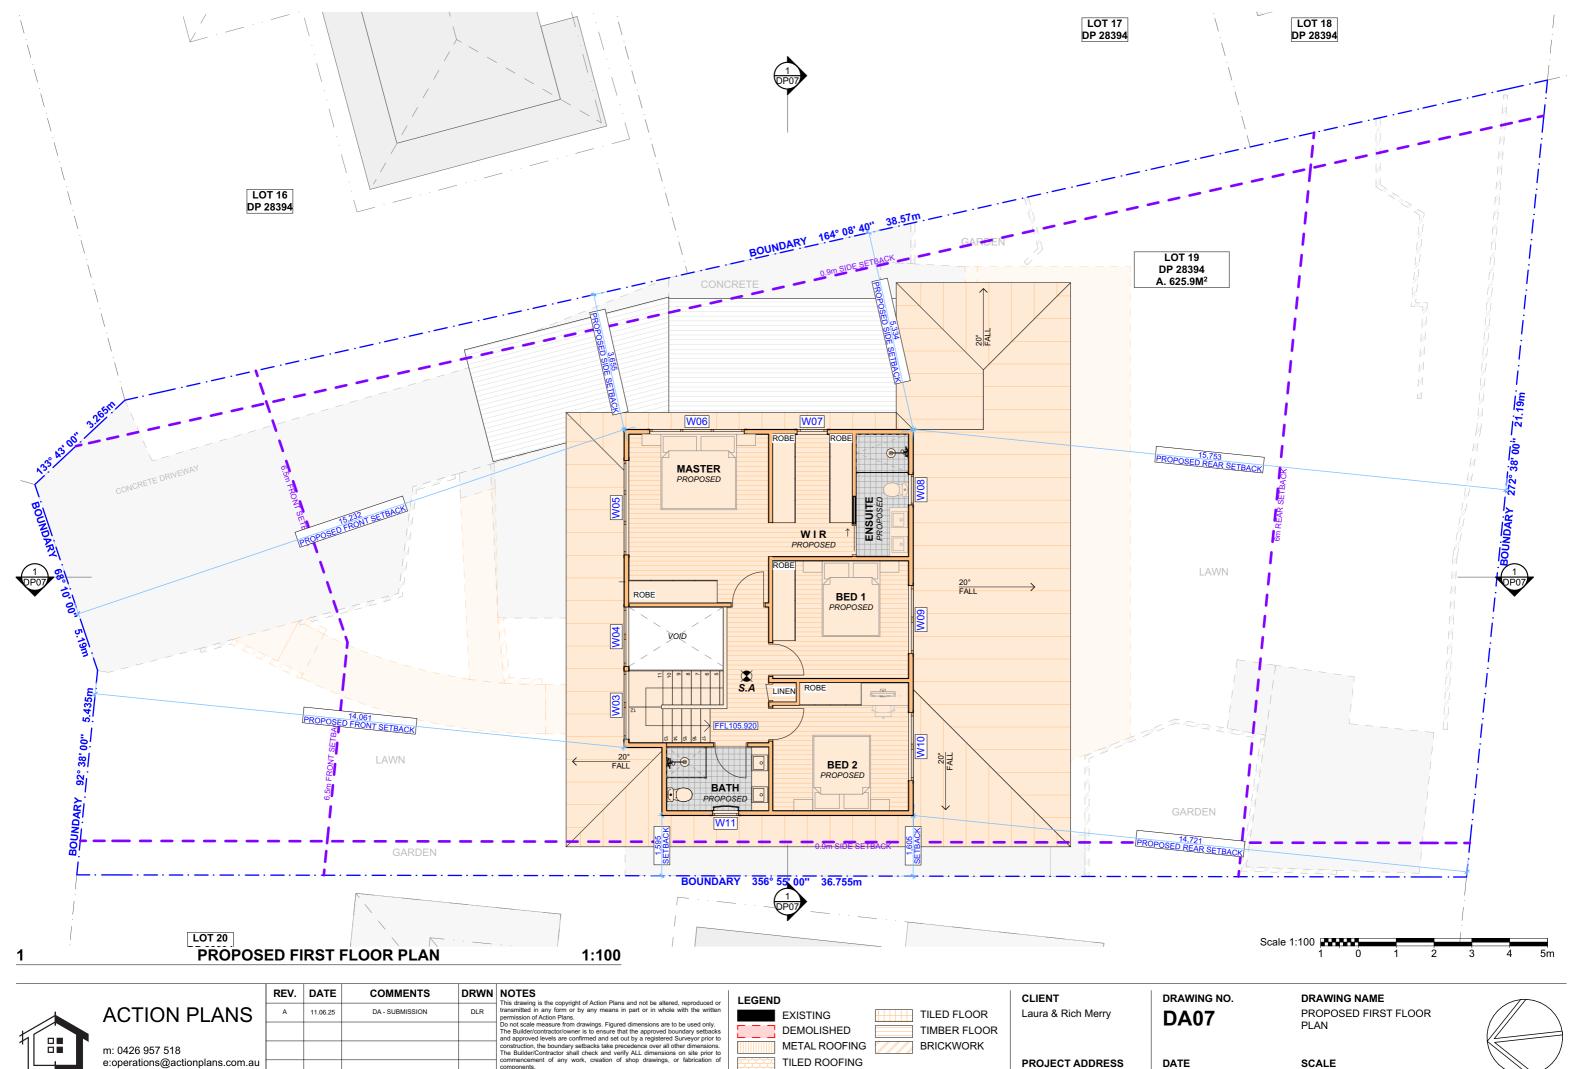



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				I




PROJECT ADDRESS 19 Moresby Place Allambie Heights, NSW 2100

SCALE 1:100 @A3

Wednesday, 11 June

2025



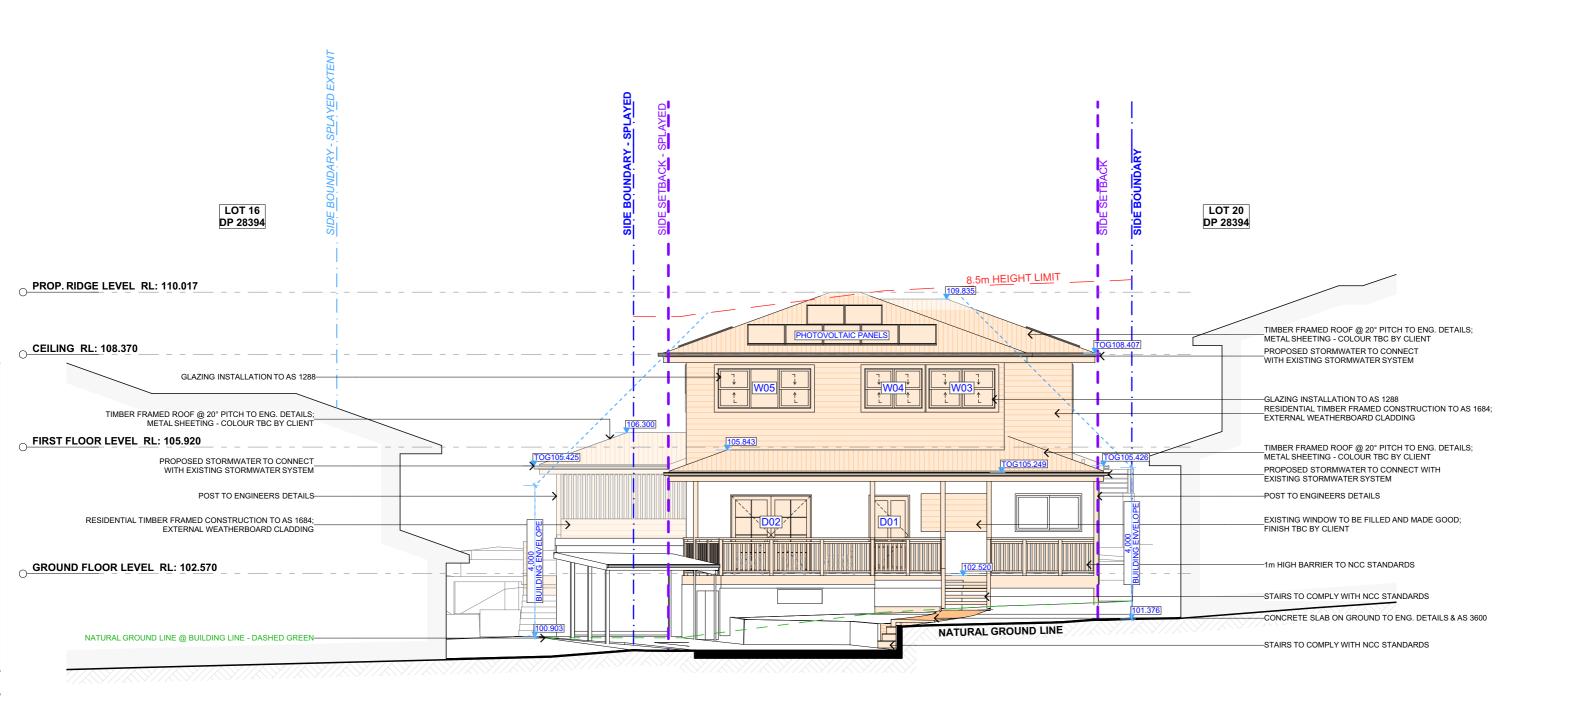

NORTH ELEVATION - PRIMARY ROAD


1:100

DRAWING NO. DRAWING NAME NORTH ELEVATION - PRIMARY **DA08** ROAD SCALE 1:100 @A3

Scale 1:100

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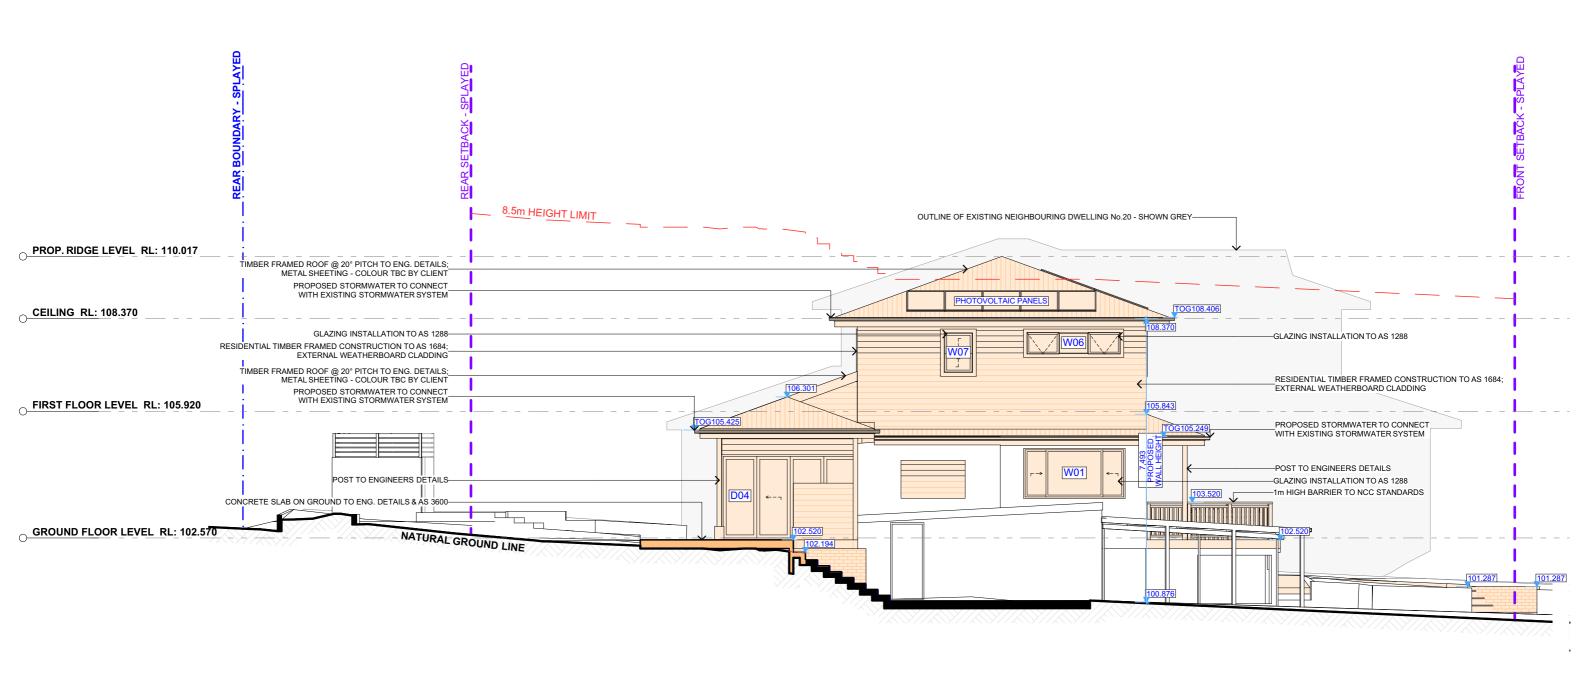
PROJECT ADDRESS	
9 Moresby Place	
Allambie Heights, NSW	

Laura & Rich Merry

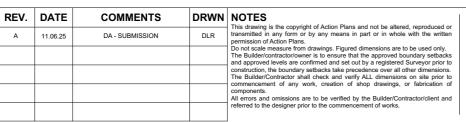CLIENT

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Wednesday, 11 June 2025








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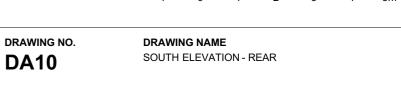
METAL ROOFING	EXISTING
TILED ROOFING	
TIMBER CLAD	
BRICKWORK	
CONCRETE	

2100

CLIENT Laura & Rich Merry	DA09	DRAWING NAME EAST ELEVATION - SIDE
PROJECT ADDRESS 19 Moresby Place Allambie Heights, NSW	DATE Wednesday, 11 June 2025	SCALE 1:100 @A3






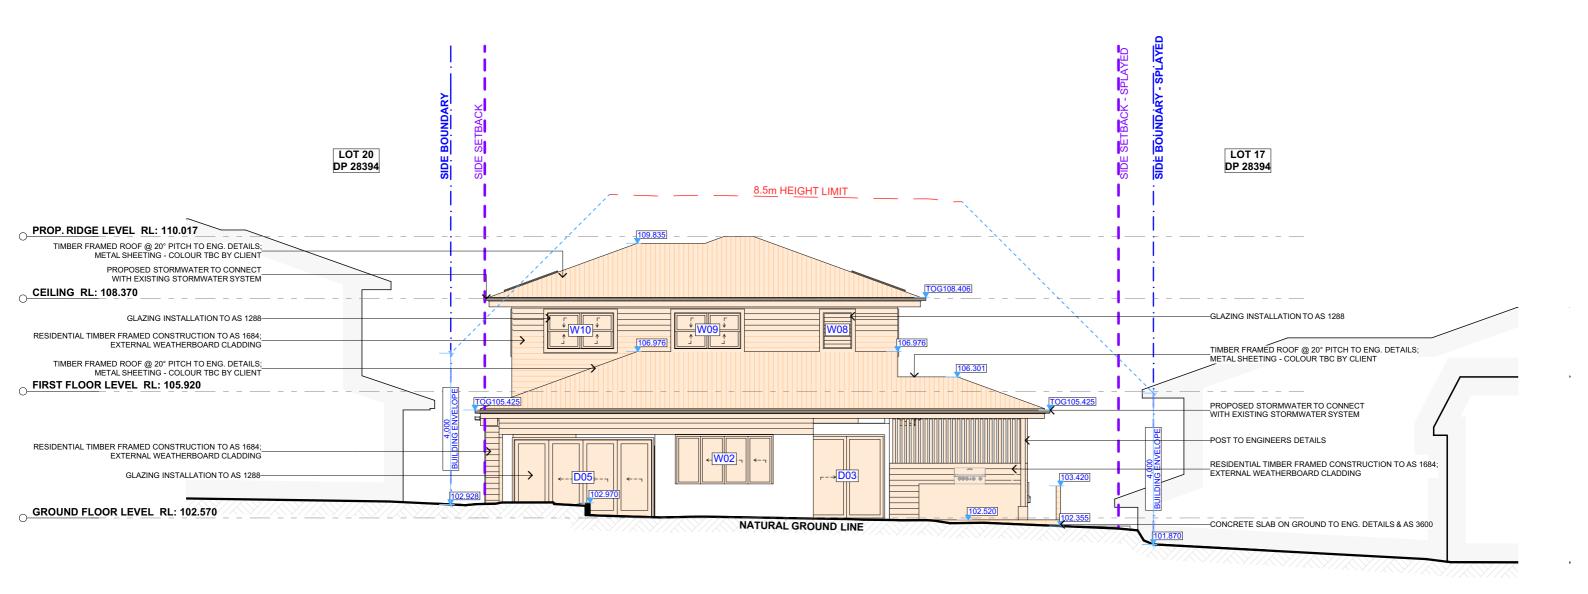



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Allambie Heights, NSW
2100

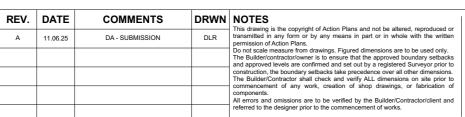Laura & Rich Merry

CLIENT

DA10

SOUTH ELEVATION - RE


SCALE

Wednesday, 11 June 2025


SOUTH ELEVATION - RE

1:100 @A3


Scale 1:100

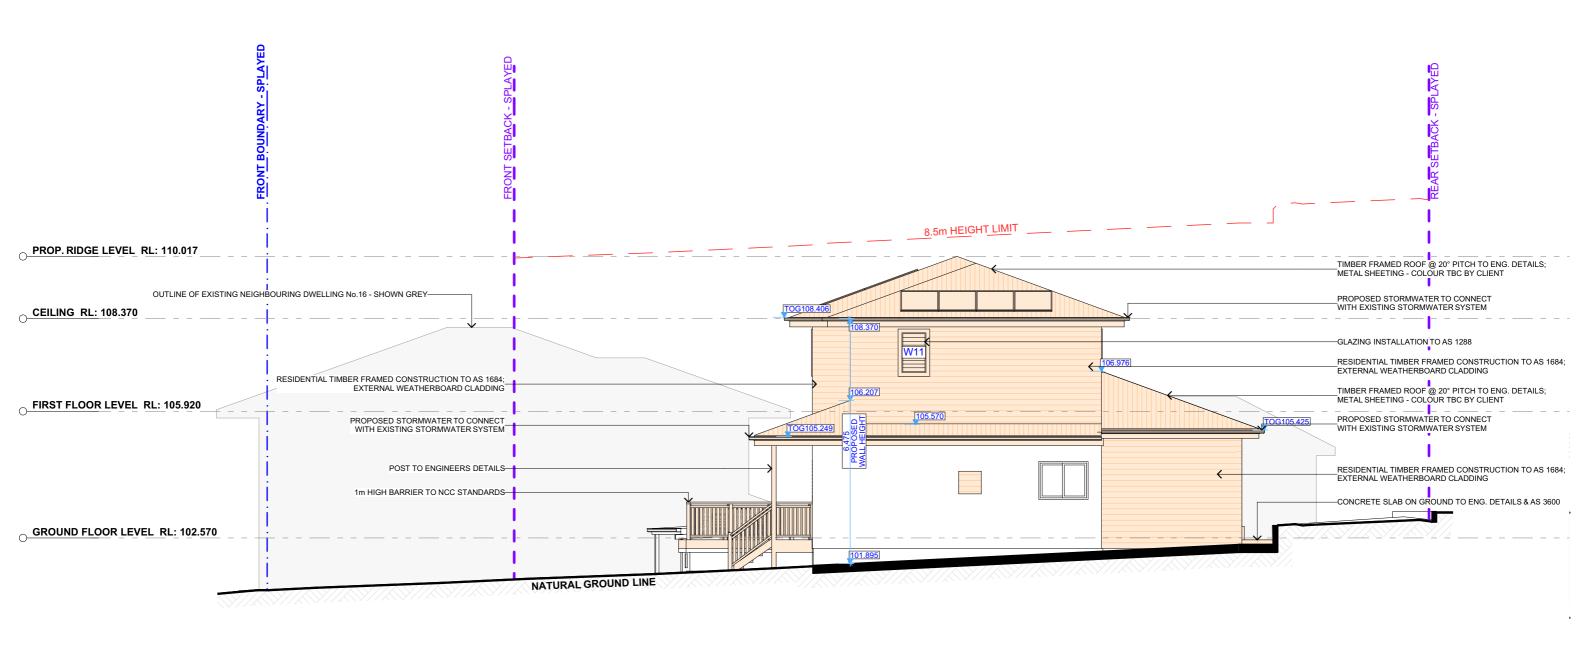




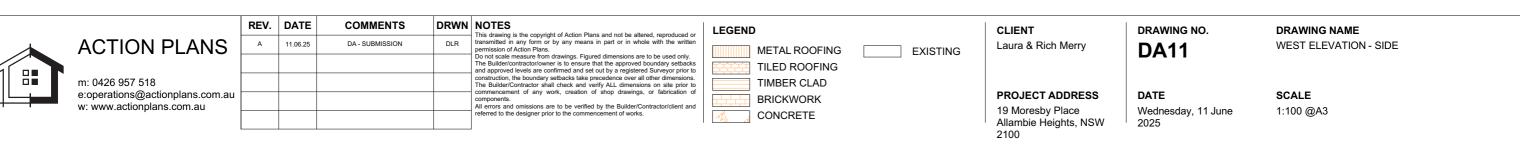


Scale 1:100

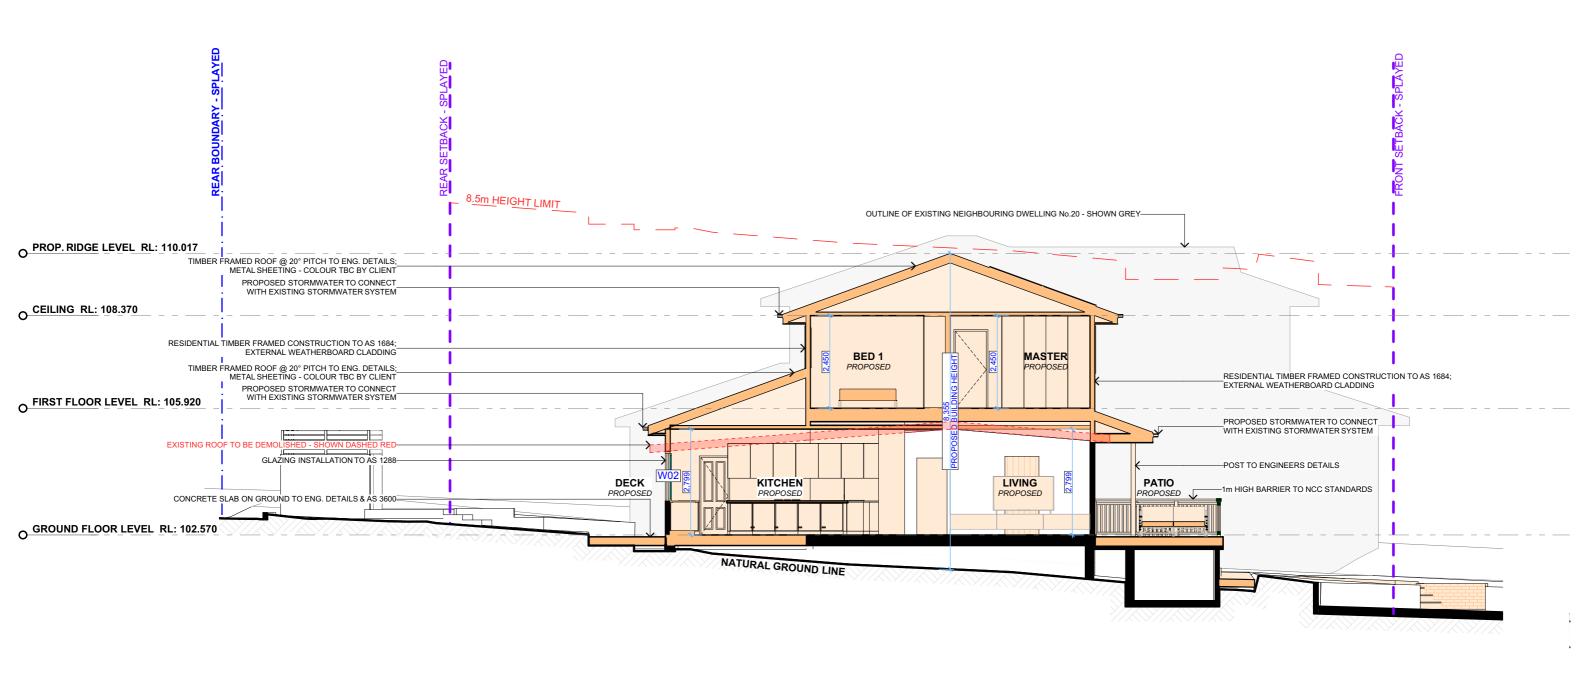

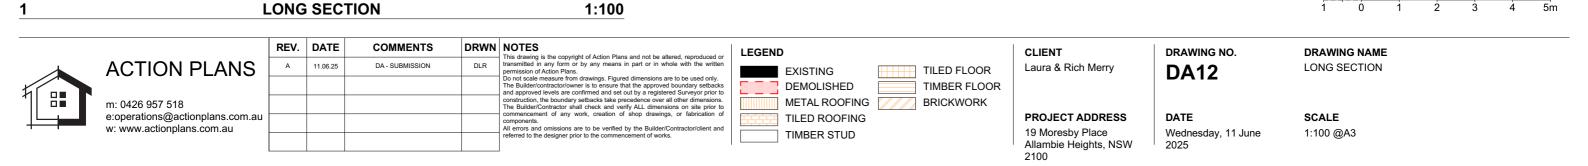

Scale 1:100

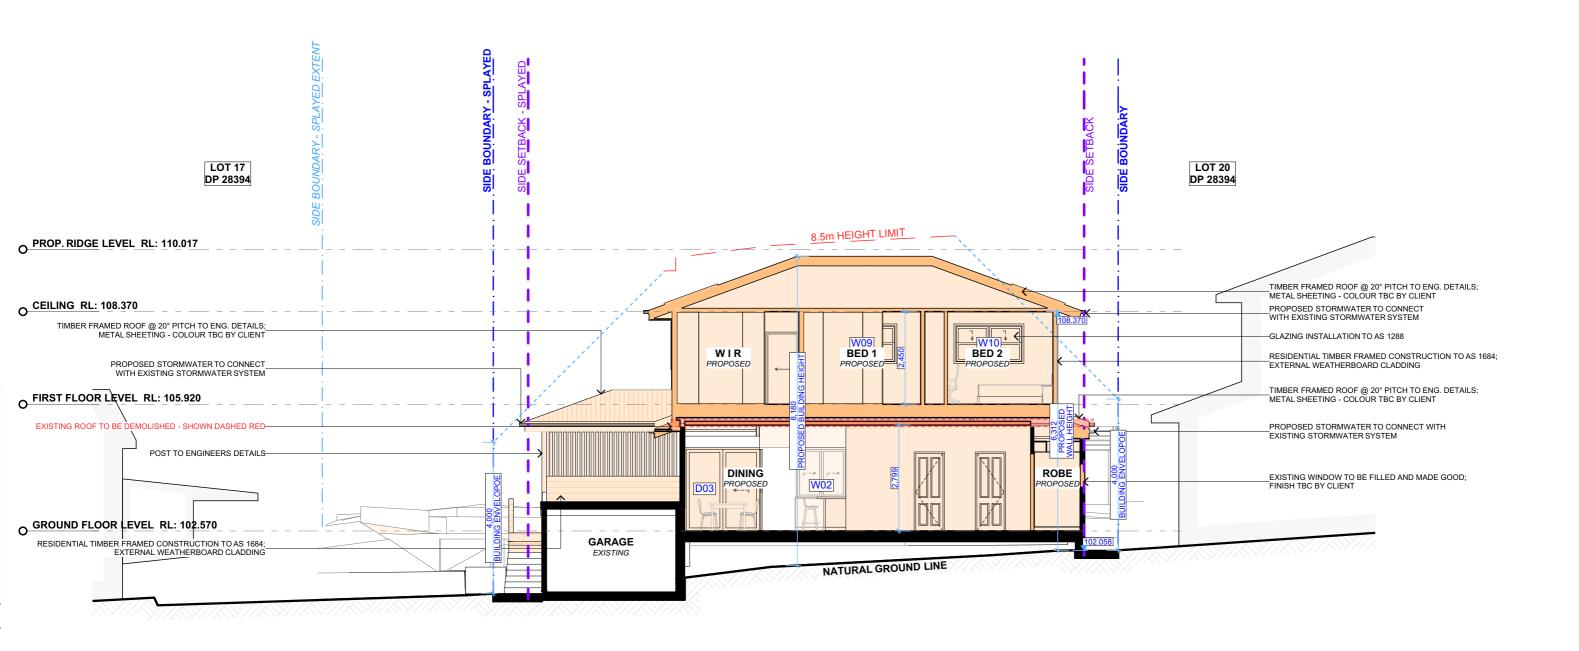

CROSS SECTION 1:100 Scale 1:100

~	
71	

ACTION PLANS

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CLIENT Laura & Rich Merry

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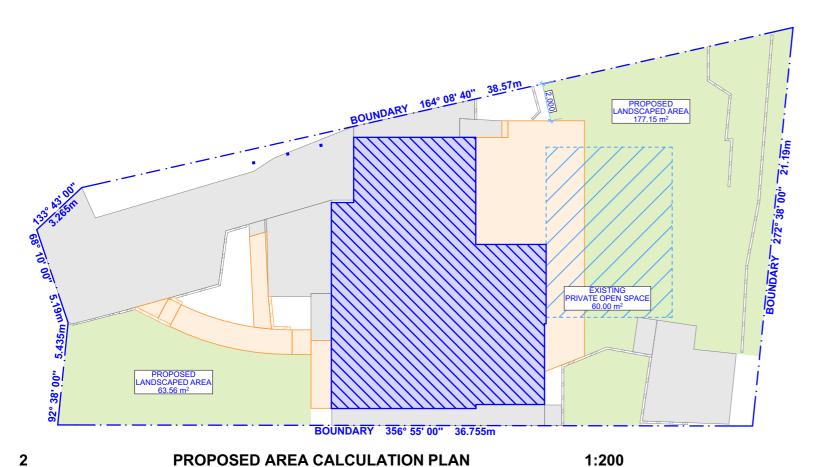
2100


DRAWING NO. **DA13**

DRAWING NAME **CROSS SECTION**

Wednesday, 11 June 2025

SCALE 1:100 @A3



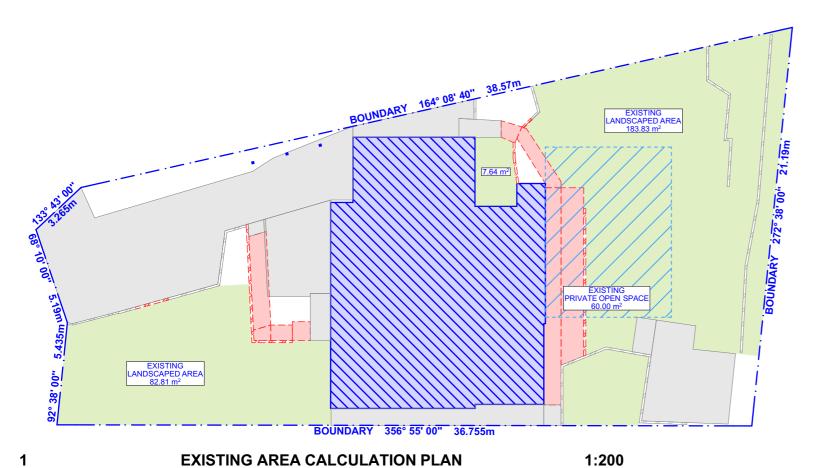

CONTROL TABLE

SITE AREA 625.9m²

CONTROL **EXISTING PROPOSED**

LANDSCAPED AREA 40% (250.36m²) 44% (274.28m²) 38% (240.71m²)

PRIVATE OPEN SPACE AREA 60m² 60m² 60m²

LEGEND

LANDSCAPED AREA

EXISTING BUILDING FOOTPRINT

EXISTING HARD SURFACE

PROPOSED BUILDING FOOTPRINT

PROPOSED HARD SURFACE

PRIVATE OPEN SPACE AREA

Scale 1:200 1 2 3 4 5m

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LEGEND

Laura & Rich Merry

CLIENT

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PROJECT ADDRESS

Allambie Heights, NSW

19 Moresby Place


DA14


DRAWING NO.

DRAWING NAME AREA CALCULATIONS

DATE Wednesday, 11 June 2025

SCALE 1:200 @A3

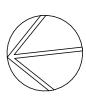

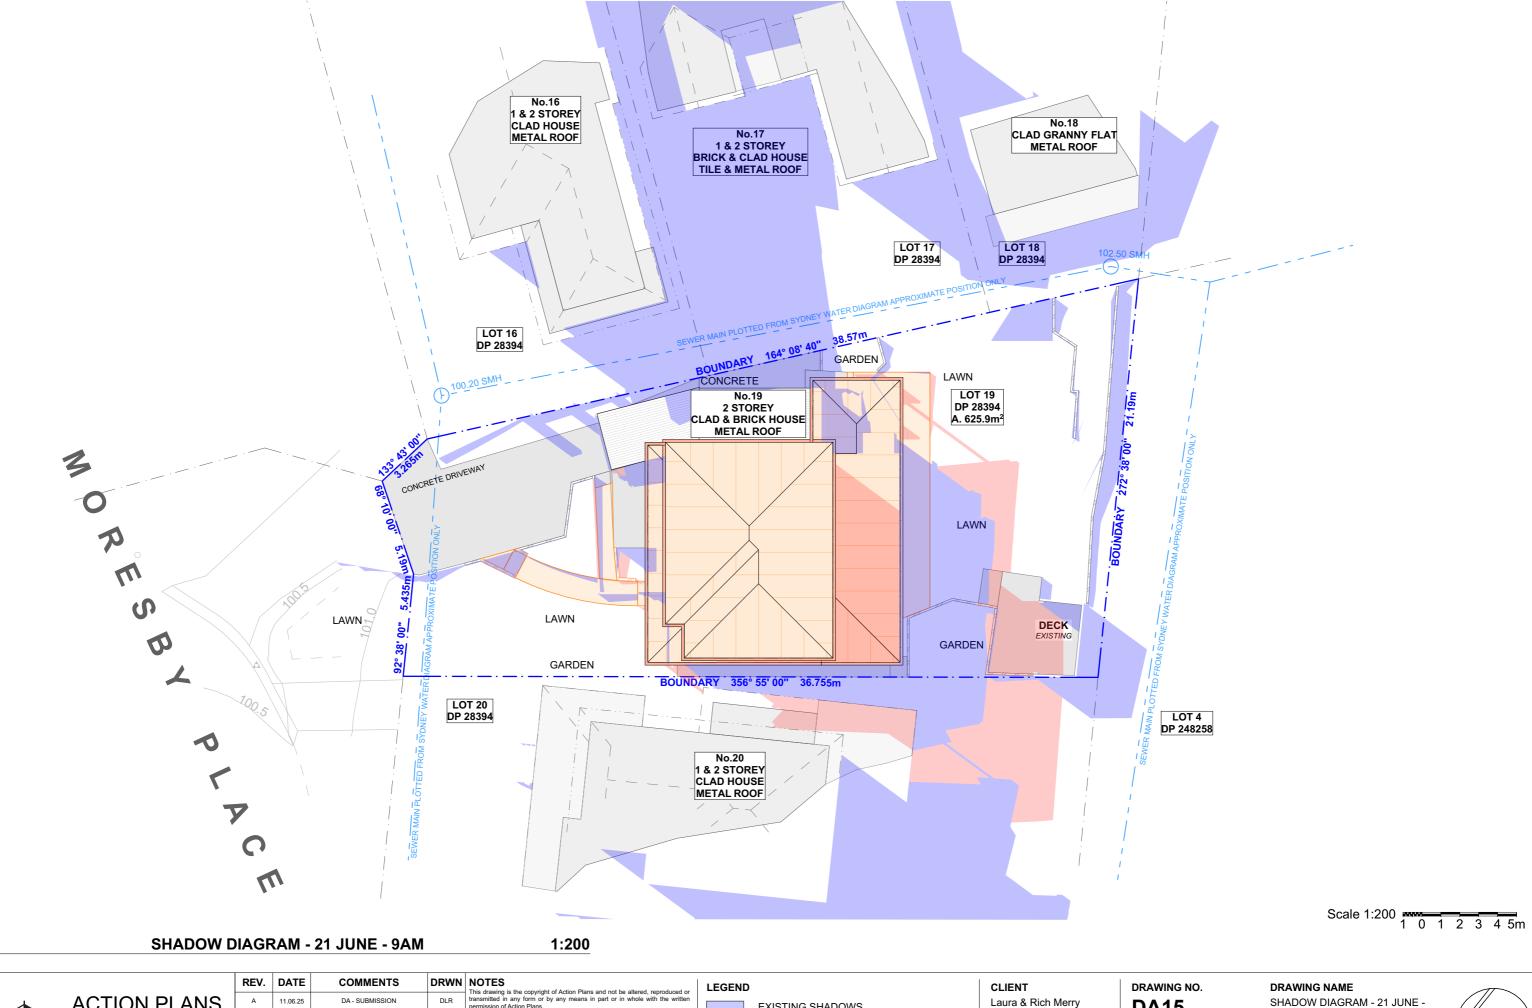



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All errors and omissions are to be verified by the Builder/Contrareferred to the designer prior to the commencement of works.

EXISTING SHADOWS PROPOSED SHADOWS Laura & Rich Merry

19 Moresby Place

PROJECT ADDRESS Allambie Heights, NSW 2100

2025

DA15


Wednesday, 11 June

DATE SCALE

9AM

1:200 @A3



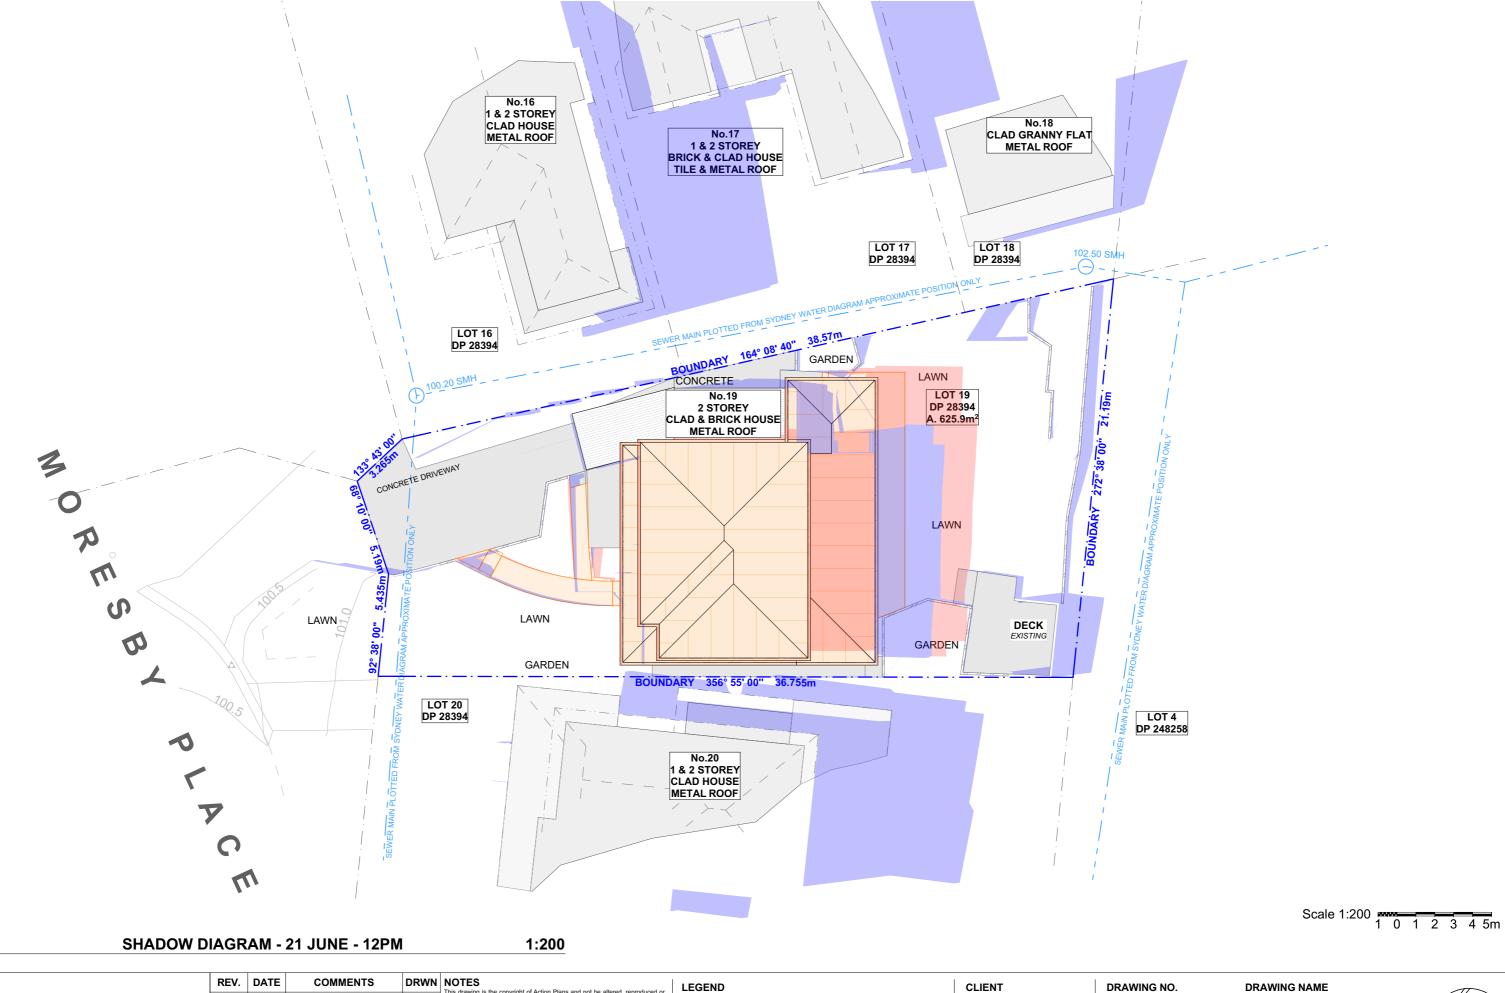




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LEGEND



CLIENT Laura & Rich Merry

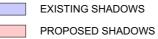PROJECT ADDRESS 19 Moresby Place

Allambie Heights, NSW 2100

DRAWING NO.


DATE

2025

SHADOW DIAGRAM - 21 JUNE -12PM **DA16**

SCALE Wednesday, 11 June 1:200 @A3



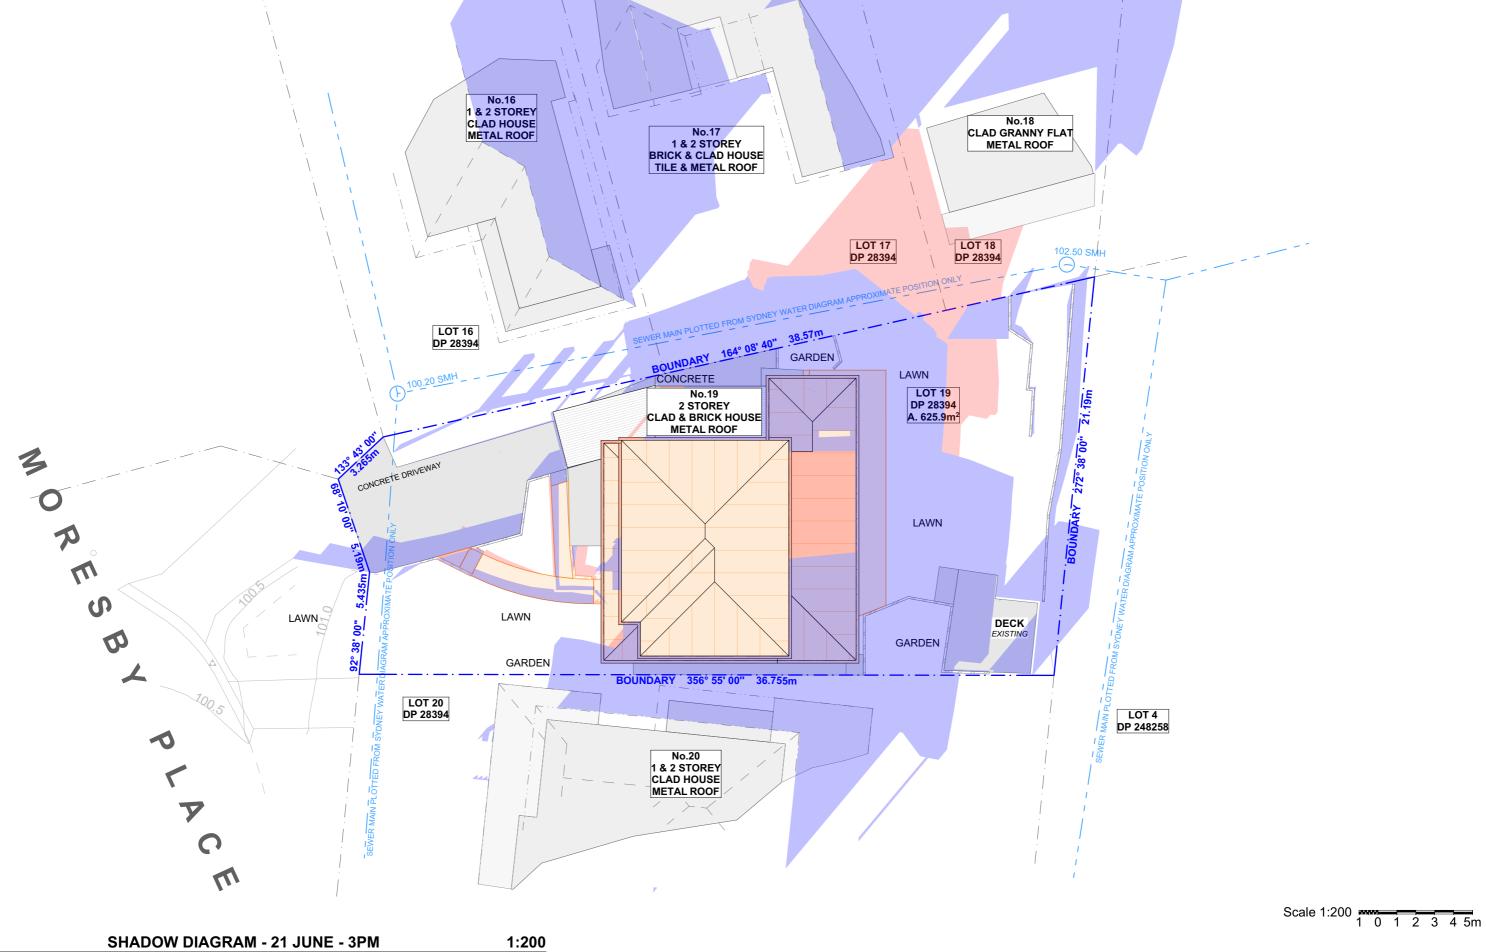




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				construction, the boundary setbacks take precedence over all other dimensi The Builder/Contractor shall check and verify ALL dimensions on site pri commencement of any work, creation of shop drawings, or fabricatio
				components. All errors and omissions are to be verified by the Builder/Contractor/client
				referred to the designer prior to the commencement of works.

LEGEND

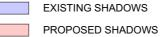

CLIENT

Laura & Rich Merry

PROJECT ADDRESS

19 Moresby Place Allambie Heights, NSW 2100

DRAWING NO.

DATE

2025

DA17

SCALE

1:200 @A3

Wednesday, 11 June

SHADOW DIAGRAM - 21 JUNE - 3PM

DRAWING NAME







01 - EXTERNAL WEATHERBOARD CLADDING; COLOUR TO BE CONFIRMED BY CLIENT

REV. DATE



02 - EXTERNAL TIMBER DETAIL HANDRAIL; COLOUR TO BE CONFIRMED BY CLIENT



03 - COLOURBOND METAL ROOF SHEETING; COLOUR TO BE CONFIRMED BY CLIENT



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А	11.06.25	DA - SUBMISSION	DLR	transmitted in any form or by any permission of Action Plans.
				Do not scale measure from drawings The Builder/contractor/owner is to e and approved levels are confirmed a
				construction, the boundary setbacks The Builder/Contractor shall check commencement of any work, cre
				components. All errors and omissions are to be
				referred to the designer prior to the

DRWN NOTES

COMMENTS

LEGEND

CLIENT Laura & Rich Merry

PROJECT ADDRESS

19 Moresby Place Allambie Heights, NSW

2100

DRAWING NO. **DA18**

Wednesday, 11 June

DATE

2025

SCALE 1:1.84, 1:1 @A3

DRAWING NAME

SAMPLE BOARD



BASIX™Certificate

Building Sustainability Index www.planningportal.nsw.gov.au/development-and-assessment/basix

Alterations and Additions

Certificate number: A1799007

This certificate confirms that the proposed development will meet the NSW government's requirements for sustainability, if it is built in accordance with the commitments set out below. Terms used in this certificate, or in the commitments, have the meaning given by the document entitled "BASIX Definitions" dated 10/09/2020 published by the Department. This document is available at www.planningportal.nsw.gov.au/definitions

Secretary
Date of issue: Monday, 09 June 2025
To be valid, this certificate must be lodged within 3 months of the date of issue.



Project address	
Project address	DA - 19 MORESBY PL, ALLAMBIE HEIGHTS
Street address	19 MORESBY Place ALLAMBIE HEIGHTS 2100
Local Government Area	Northern Beaches Council
Plan type and number	Deposited Plan DP28394
Lot number	19
Section number	-
Project type	
Dwelling type	Dwelling house (detached)
Type of alteration and addition	The estimated development cost for my renovation work is \$50,000 or more, and does not include a pool (and/or spa).
N/A	N/A
Certificate Prepared by (pleas	se complete before submitting to Council or PCA)
Certificate Prepared by (pleas Name / Company Name: ACTION PLA	

Fixtures and systems	Show on DA Plans	Show on CC/CDC Plans & specs	Certifier Check
Lighting			
The applicant must ensure a minimum of 40% of new or altered light fixtures are fitted with fluorescent, compact fluorescent, or light-emitting-diode (LED) lamps.		~	~
Fixtures			
The applicant must ensure new or altered showerheads have a flow rate no greater than 9 litres per minute or a 3 star water rating.		~	~
The applicant must ensure new or altered toilets have a flow rate no greater than 4 litres per average flush or a minimum 3 star water rating.		~	~
The applicant must ensure new or altered taps have a flow rate no greater than 9 litres per minute or minimum 3 star water rating.		~	

onstruction	Show on DA Plans	Show on CC/CDC Plans & specs	Certifie Check		
sulation requirements					
ne applicant must construct the new or alte sted in the table below, except that a) addit issulation specified is not required for parts	~	~	~		
Construction	Additional insulation required (R-value)	Other specifications			
concrete slab on ground floor.	nil	N/A			
suspended floor with enclosed subfloor: framed (R0.7).	R0.60 (down) (or R1.30 including construction)	N/A			
floor above existing dwelling or building.	nil	N/A			
external wall: framed (weatherboard, fibro, metal clad)	R1.30 (or R1.70 including construction)				
flat ceiling, pitched roof	ceiling: R1.45 (up), roof: foil backed blanket (75 mm)	medium (solar absorptance 0.475 - 0.70)			

Glazing requirements	Show on DA Plans	Show on CC/CDC Plans & specs	Certifier Check
Windows and glazed doors			
The applicant must install the windows, glazed doors and shading devices, in accordance with the specifications listed in the table below. Relevant overshadowing specifications must be satisfied for each window and glazed door.	~	~	~
The following requirements must also be satisfied in relation to each window and glazed door:		~	~
Each window or glazed door with standard aluminium or timber frames and single clear or toned glass may either match the description, or, have a U-value and a Solar Heat Gain Coefficient (SHGC) no greater than that listed in the table below. Total system U-values and SHGCs must be calculated in accordance with National Fenestration Rating Council (NFRC) conditions.		~	~
Each window or glazed door with improved frames, or pyrolytic low-e glass, or clear/air gap/clear glazing, or toned/air gap/clear glazing must have a U-value and a Solar Heat Gain Coefficient (SHGC) no greater than that listed in the table below. Total system U-values and SHGCs must be calculated in accordance with National Fenestration Rating Council (NFRC) conditions. The description is provided for information only. Alternative systems with complying U-value and SHGC may be substituted.		~	~
For projections described in millimetres, the leading edge of each eave, pergola, verandah, balcony or awning must be no more than 500 mm above the head of the window or glazed door and no more than 2400 mm above the sill.	~	~	~
Pergolas with polycarbonate roof or similar translucent material must have a shading coefficient of less than 0.35.		~	~
Pergolas with fixed battens must have battens parallel to the window or glazed door above which they are situated, unless the pergola also shades a perpendicular window. The spacing between battens must not be more than 50 mm.		~	~

DA - SUBMISSION	DLR	the written po The Builder/o Surveyor prio The Builder/	ermission contracto or to cons /Contracto	opyright of Action Plans. Do n of Action Plans. Do or/owner is to ensure struction, the bounda or shall check and nents. All errors and	not scale me that the appeary setbacks to verify ALL di
COMMENTS	DRWN	NOTES This drawing	n ie the c	operight of Astion Cl	one and not b
door above which they are situa e more than 50 mm.	ted, unless the	pergola		~	•
ading coefficient of less than 0.3				~	~
erandah, balcony or awning above the sill.	must be no mor	re than	<u> </u>	~	~
ear/air gap/clear glazing, or too that listed in the table below. Council (NFRC) conditions. T HGC may be substituted.	ned/air gap/clea Fotal system U-	-values		~	~
gle clear or toned glass may eith reater than that listed in the tab tion Rating Council (NFRC) cor	e below. Total	system		Ž	-
w and glazed door. d glazed door:			-		, , , , , , , , , , , , , , , , , , ,
lance with the specification	s listed in the ta	able		J.	
				Show on CC/CDC Plans & specs	Certifier Check
medium (solar abs	orptance 0.475	5 -			
N/A)					
N/A N/A					
Other specification	ons				
gs/roofs) in accordance value of new construction eady exists.			•	~	~
				Show on CC/CDC Plans & specs	Certifier Check
es per minute or minimum	3 star water rat	ting.		Ĵ	
than 9 litres per minute or a			\dashv		V
on O litron nor minute or	2 otor water w	otion			
ted with fluorescent, compac	t fluorescent, o		Plans	Plans & specs	Check
				Show on CC/CDC	

Glazing requirements

W02

W03

Windows and glazed doors glazing requirements

3.37

1.98



	REV.	DATE	COMMENTS	DRWN
	А	11.06.25	DA - SUBMISSION	DLR
ı				

The Builder/Contractor snail check and verify ALL dimensions on site prior to commencement or any work, creation of snop grawings, or fabrication of components. All errors and omissions are to be verified by the Builder/Contractor/client and referred to the designer prior to the commencement of works. All window & door dimensions, orientation, glazing materials, opening types, frame types are to be confirmed by a suitably qualified person prior to the ordering of any such materials are to take place. U value takes precedence over glazing type/colour in all cases. all new glazing must meet the BASIX specified frame and glass type, <u>OR</u> meet the ecified U value and SHGC value.

PROJECT ADDRESS 19 Moresby Place Allambie Heights, NSW

2100

DATE Wednesday, 11 June 2025

eave/ verandah/

eave/ verandah/

pergola/balo >=600 mm

verandah/ pergola/balco >=750 mm

aluminium, single pyrolytic low-e, (U-value: 5.7, SHGC: 0.47)

standard

aluminium,

standard

single clear, (or U-value: 7.63, SHGC: 0.75)

aluminium, single clear, (or U-value: 7.63, SHGC: 0.75)