

ACTION PLANS

8 STINSON PLACE, FORESTVILLE NSW 2087

m: 0426 957 518

e: operations@actionplans.com.au

w: www.actionplans.com.au

DEVELOPMENT APPLICATION

These plans are for Development Approval only.


SHEET NUMBER	SHEET NAME	DATE PUBLISHED
DA00	COVER	01/06/2020
DA01	SITE ANALYSIS	01/06/2020
DA02	SITE / ROOF / SEDIMENT EROSION / WASTE MANAGEMENT / STORMWATER CONCEPT PLAN	01/06/2020
DA03	EXISTING LOWER GROUND FLOOR PLAN	01/06/2020
DA04	EXISTING GROUND FLOOR PLAN	01/06/2020
DA05	EXISTING FIRST FLOOR PLAN	01/06/2020
DA06	PROPOSED LOWER GROUND FLOOR PLAN	01/06/2020
DA07	PROPOSED GROUND FLOOR PLAN	01/06/2020
DA08	PROPOSED FIRST FLOOR PLAN	01/06/2020
DA09	NORTH / EAST ELEVATION	01/06/2020
DA10	SOUTH ELEVATION	01/06/2020
DA11	WEST ELEVATION	01/06/2020
DA12	LONG SECTION	01/06/2020
DA13	CROSS SECTION	01/06/2020
DA14	DRIVEWAY PLAN / SECTION	01/06/2020
DA15	AREA CALCULATIONS	01/06/2020
DA16	SAMPLE BOARD	01/06/2020
DA17	WINTER SOLSTICE 9 AM	01/06/2020
DA18	WINTER SOLSTICE 12 PM	01/06/2020
DA19	WINTER SOLSTICE 3 PM	01/06/2020
DA20	BASIX COMMITMENTS	01/06/2020

ITEM DETAILS	DEVELOPMENT APPLICATION					
ADDRESS	8 STINSON PLACE, FORESTVILLE NSW 2087					
LOT & DP/SP	LOT 4 DP 202494					
COUNCIL	NORTHERN BEACHES COUNCIL (WARRINGAH)					
SITE AREA	648.8m²					
FRONTAGE	IRREGULAR					
CONTROLS	PERMISSIBLE / REQUIRED	EXISTING	PROPOSED	COMPLIANCE		
	m / m² / %	m / m² / %	m / m² / %			
<u>LEP</u>						
LAND ZONING	R2 – LOW DENSITY RESIDENTIAL	R2	R2	YES		
MINIMUM LOT SIZE	600m²	648.8m²	UNCHANGED	YES		
FLOOR SPACE RATIO	NOT IDENTIFEID	N/A	N/A	N/A		
MAXIMUM BUILDING HEIGHT	8.5m	9.313m	9.485m	NO (EXISTING)		
HAZARDS						
DEVELOPMENT ON SLOPING LAND	LANDSLIP RISK MAP: AREA A – SLOPES LESS THAN 5 DEGREES AREA B – FLANKING SLOPES FROM 5 TO 25 DEGREES			PLEASE READ IN CONJUCNTION WITH STATEMENT OF ENVIRONMENTAL EFFECTS		
DCP						
WALL HEIGHT	7.2m	6.776m	8.083m	NO		
NUMBER OF STOREYS	NOT IDENTIFEID	N/A	N/A	N/A		
SIDE BOUNDARY ENVELOPE	4m					
SIDE BOUNDARY SETBACKS	0.9m	N: 1.465m S: 2.572m	N CARPORT: 0.65m N / S: UNCHANGED	YES		
FRONT BOUNDARY SETBACK	6.5m	6.737m	5.230m CARPORT: 1.843m	YES		
REAR BOUNDARY SETBACK	6.0m	10.031m	UNCHANGED	YES		
LANDSCAPE OPEN SPACE	40% (259.52m²)	39% (256.13m²)	39% (250.15m²)	NO (EXISTING)		
PRIVATE OPEN SPACE	60m²	82.5m²	UNCHANGED	YES		



NCC & AS COMPLIANCES SPECIFICATIONS

- EARTHWORKS PART 3.1.1 OF NCC
- EARTH RETAINING STRUCTURES PART 3.1.2 OF NCC
- DRAINAGE PART 3.1.3 OF NCC
- TERMITE-RISK MANAGEMENT PART 3.1.4 OF NCC
- FOOTINGS & SLAB PART 3.2 OF NCC INCLUDING AS2870
- MASONRY PART 3.3 OF NCC INCLUDING AS3700
- FRAMING PART 3.4 OF NCC
- SUB FLOOR VENTILATION PART 3.4.1 OF NCC
- ROOF CLADDING AND WALL-CLADDING PART 3.5 OF NCC
- GLAZING PART 3.6 OF NCC INCLUDING AS1288
- FIRE SAFETY PART 3.7 OF NCC
- FIRE SEPERATION PART 3.7.2 OF NCC
- FIRE PROTECTION OF SEPERATING WALLS AND FLOORS- PART 3.7.3 OF NCC
- SMOKE ALARMS PART 3.7.5 OF NCC
- WET AREAS AND EXTERNAL WATERPROOFING PART 3.8.1 OF NCC
- ROOM HEIGHTS PART 3.8.2 OF NCC
- FACILITIES PART 3.8.3 OF NCC
- LIGHT PART 3.8.4 OF NCC
- VENTILATION PART 3.8.5 OF NCC
- SOUND INSULATION PART 3.8.6 OF NCC
- STAIRWAYAND RAMP CONSTRUCTION PART 3.9.1 OF NCC
- BARRIERS AND HANDRAILS PART 3.9.2 OF NCC
- SWIMMING POOLS PART 3.10.1 OF NCC
- CONSTRUCTION IN BUSHFIRE PRONE AREAS PART 3.10.5 OF NCC
- FENCING & OTHER PROVISIONS REGS & AS1926
- DEMOLITION WORKS AS2601-1991 THE DEMOLITION OF STRUCTURES.
- ALL WATERPROOF MEMBRANES TO COMPLY WITH WITH AS 3740-2010
- ALL PLUMBING & DRAINAGE WORK TO COMPLY WITH AS 3500
- SITE CLASSIFICATION AS TO AS 2870
- ALL PLASTERBOARD WORK TO COMPLY WITH AS 2588-1998
- ALL STRUCTURAL STEEL WORK TO COMPLY WITH AS 4100 & AS 1554
- ALL CONCRETE WORK TO COMPLY WITH AS 3600
- ALL ROOF SHEETING WORK TO COMPLY WITH AS 1562-1992
- ALL SKYLIGHTS TO COMPLY WITH WITH AS 4285-2007
- ALL CERAMIC TILING TO COMPLY WITH AS 3958.1-2007 & 3958.2-1992
- ALL GLAZING ASSEMBLIES TO COMPLY WITH AS2047 & 1288
- ALL TIMBER RETAINING WALLS ARE TO COMPLY WITH AS 1720.1-2010, AS 1720.2-2006, AS 1720.4-2006, AS 1170.1-1989 & AS 1170.4-2007
- ALL RETAINING WALLS ARE TO COMPLY WITH 3700 2011 & AS 3600 -2009
- ALL CONSTRUCTION TO COMPLY TO AS3959- 2009

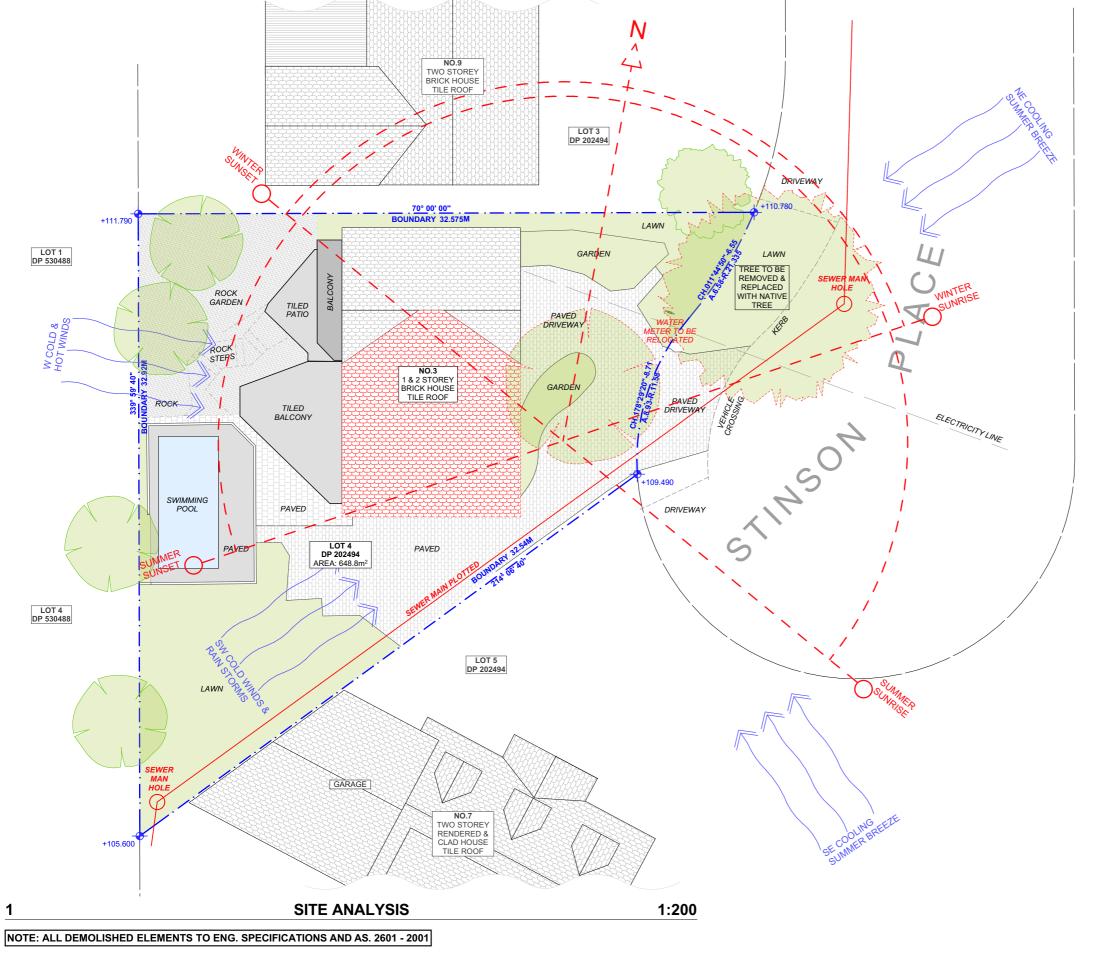








DRAWING NAME



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EXISTING EX. DOWNPIPE DP. PROPOSED PROP. DP. DOWNPIPE

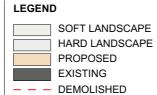CLIENT ROB & TASHA SMITHIES


PROJECT ADDRESS 8 STINSON PLACE, FORESTVILLE NSW 2087

DRAWING NO. **DA01**

01 June 2020

SITE ANALYSIS DATE **SCALE**

1:200 @A3

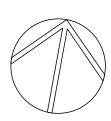



 $\chi_{\rm AM\, mE}$ DISTURBED AREA POSTS DRIVEN 0.6m INTO GROUND DETAIL OF OVERLAP WIRE OR STEEL MESH (WHERE REQUIRED) ↓ UNDISTURBED AREA **SEDIMENT FENCE**

DUST CONTROL:

TO REDUCE DUST GENERATED BY WIND ACTION, THE REMOVAL OF THE TOP SOIL IS TO BE MINIMISED. TO PREVENT DUST GENERATION, WATERING DOWN OF THE SITE, ESPECIALLY DURING THE MOVEMENT OF MACHINERY IS REQUIRED. WHERE EXCAVATING INTO ROCK, KEEP THE SURFACE MOIST TO MINIMISE DUST. CONSTRUCT A GRAVEL ENTRY/EXIT POINT USING BLUE METAL AND RESTRICT ALL VEHICLE MOVEMENTS WITHIN THE SITE TO A MINIMUM. ENSURE WIND BREAKS, SUCH AS EXISTING FENCES ARE MAINTAINED DURING THE CONSTRUCTION PHASE UNTIL NEW LANDSCAPING IS PROVIDED OR REINSTATED. PREVENT DUST BY COVERING STOCKPILES

SEDIMENT NOTE:

1. ALL EROSION AND SEDIMENT CONTROL MEASURES TO BE INSPECTED AND MAINTAINED DAILY BY THE SITE MANAGER.

2. MINIMISE DISTURBED AREAS, REMOVE EXCESS SOIL FROM EXCAVATEDAREA AS SOON AS POSSIBLE. 3. ALL MATERIAL STOCKPILE TO BE CLEAR FROM DRAINS, GUTTERS AND FOOTPATHS, OR WITHIN SEDIMENT FENCE AREA.

4. DRAINAGE TO BE CONNECTED TO STORMWATER AS SOON AS POSSIBLE. IF STORED ON SITE, IT MUST BE FILTERED BEFORE RELEASING INTO STORMWATER SYSTEM OR WATERWAYS

5. ROADS AND FOOTPATHS TO BE SWEPT DAILY.

STOCKPILES:

ALL STOCKPILES ARE TO BE KEPT ON-SITE WHERE POSSIBLE. ANY MATERIALS PLACED ON THE FOOTPATHS OR NATURE STRIPS REQUIRE COUNCIL'S PERMISSION.

ALL STOCKPILES ARE TO BE PLACED AWAY FROM THE DRAINAGE LINES AND STREET GUTTERS. IT IS BEST TO LOCATE THESE ON THE HIGHEST PART OF THE SITE IF POSSIBLE. PLACE WATERPROOF COVERING OVER STOCKPILES.

IF REQUIRED PROVIDE DIVERSION DRAIN & BANK AROUND STOCKPILES.

GUTTER PROTECTION:

PROVIDE PROTECTION TO DOWNHILL GRATE IN GUTTER BY MEANS OF SAND BAGS OR BLUE METAL WRAPPED IN GEOTEXTILE FABRIC. WHEN SOIL OR SAND BUILDS UP AROUND THIS SEDIMENT BARRIER, THE MATERIAL SHOULD BE RELOCATED BACK TO THE SITE FOR DISPOSAL

NOTE: ALL PROPOSED STORMWATER TO CONNECT WITH EXISTING

SITE / ROOF / SEDIMENT EROSION / WASTE MANAGEMENT / STORMWATER CONCEPT PLAN

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REV. DATE

COMMENTS

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DRWN NOTES



EX. **EXISTING** DP. DOWNPIPE PROP. PROPOSED DP. DOWNPIPE

ROB & TASHA SMITHIES

CLIENT

1:200

PROJECT ADDRESS 8 STINSON PLACE. FORESTVILLE NSW 2087 DRAWING NO.

DA02

DATE


01 June 2020


DRAWING NAME

SITE / ROOF / SEDIMENT EROSION / WASTE MANAGEMENT / STORMWATER CONCEPT PLAN

SCALE


1:200 @A3

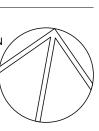

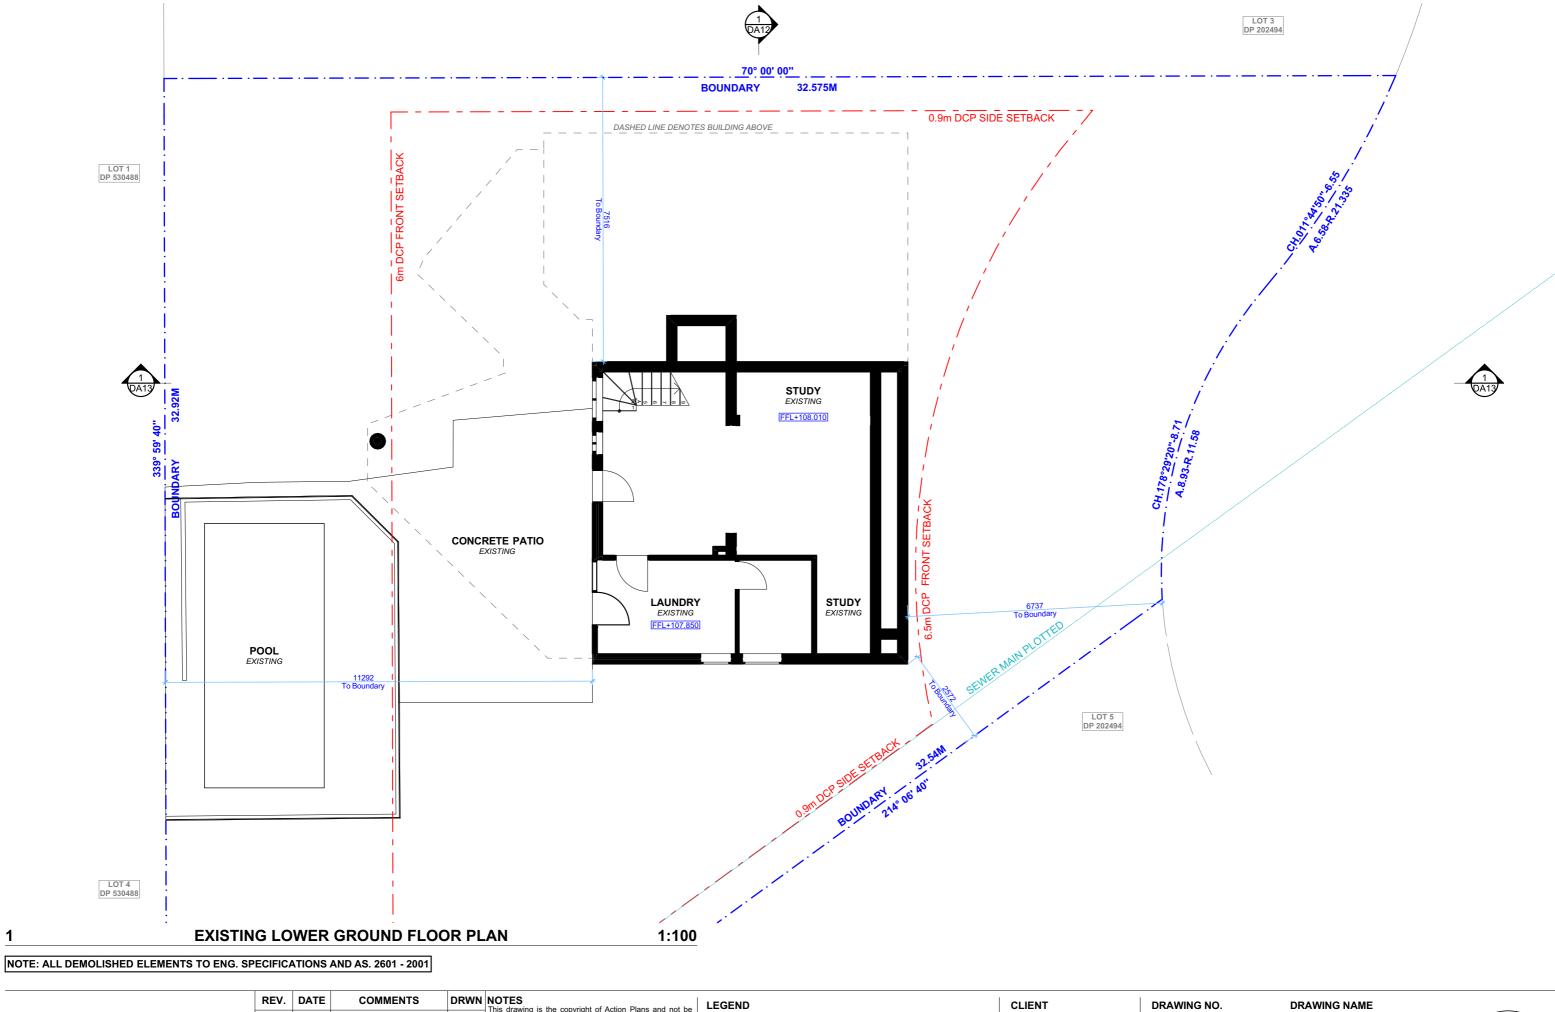



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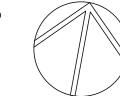
PROJECT ADDRESS 8 STINSON PLACE, FORESTVILLE NSW 2087 **DA03**

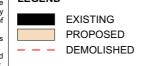
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EXISTING LOWER GROUND FLOOR PLAN SCALE

1:100 @A3





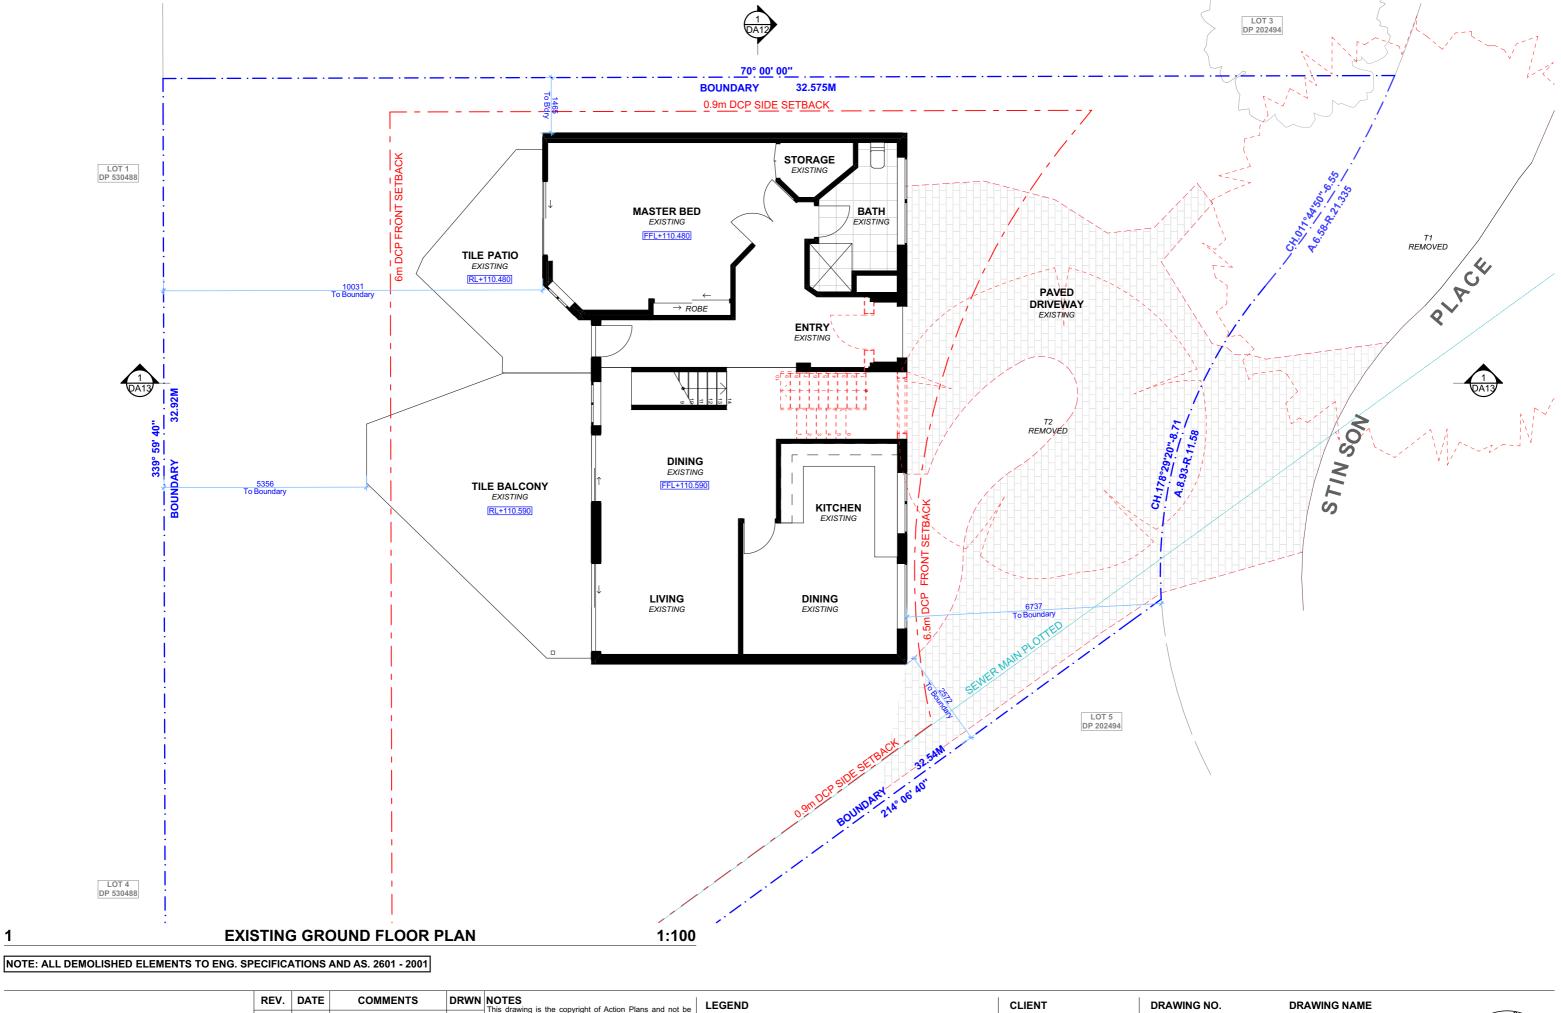

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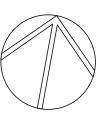
PROJECT ADDRESS 8 STINSON PLACE, FORESTVILLE NSW 2087 **DA04**


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DATE

SCALE 1:100 @A3

EXISTING GROUND FLOOR PLAN





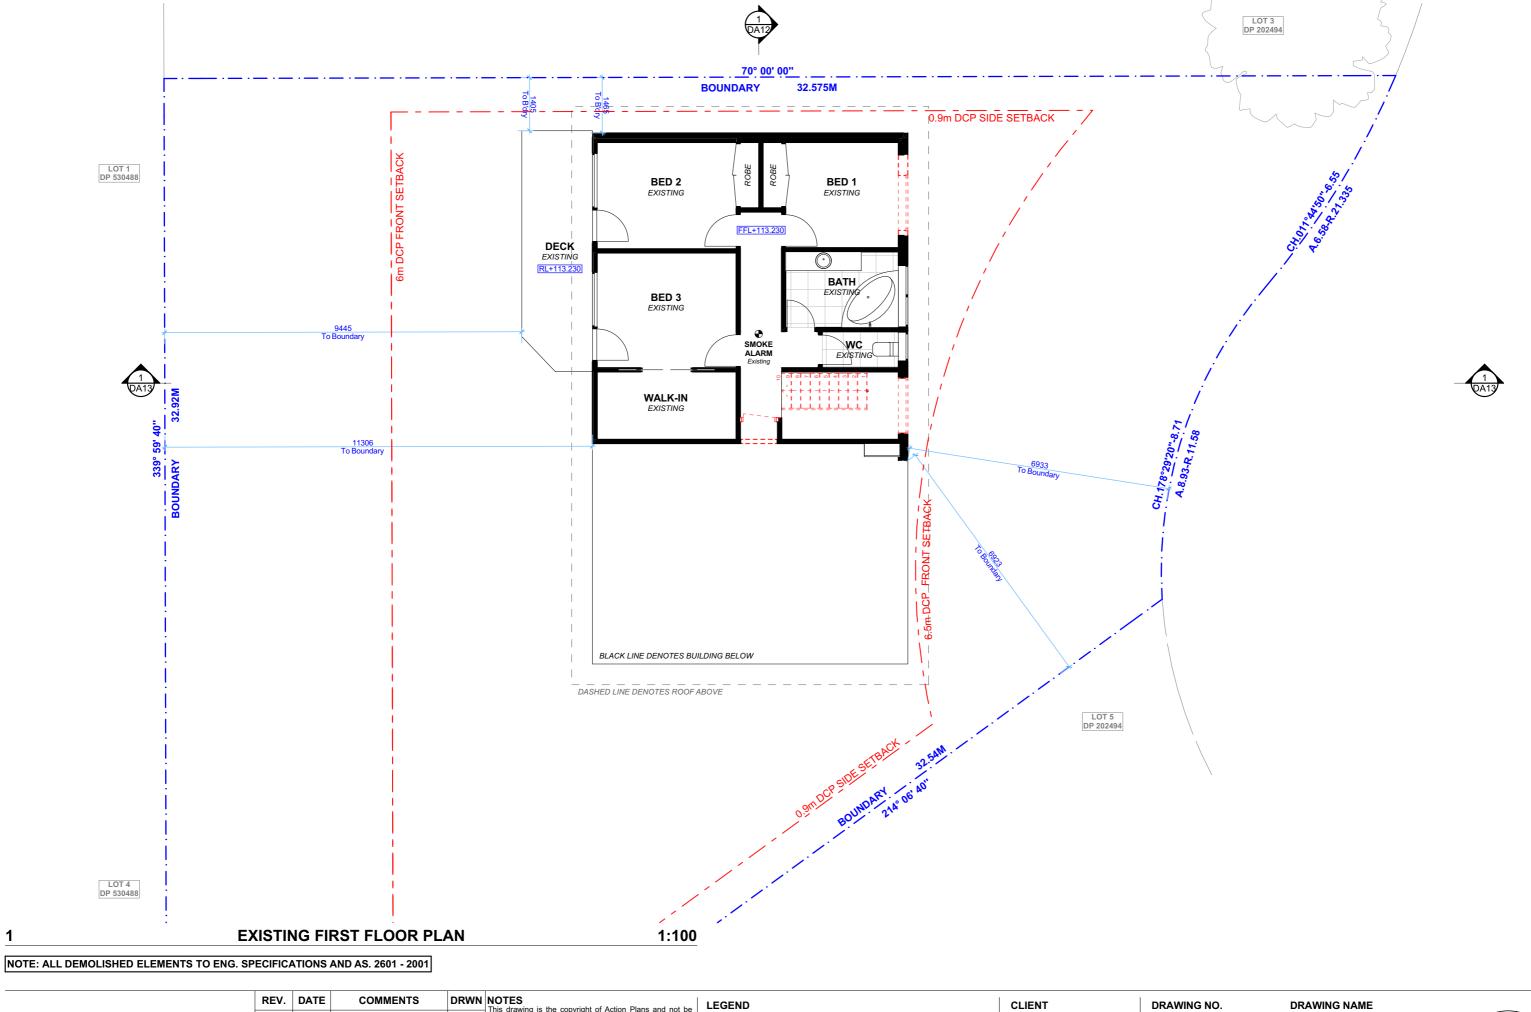

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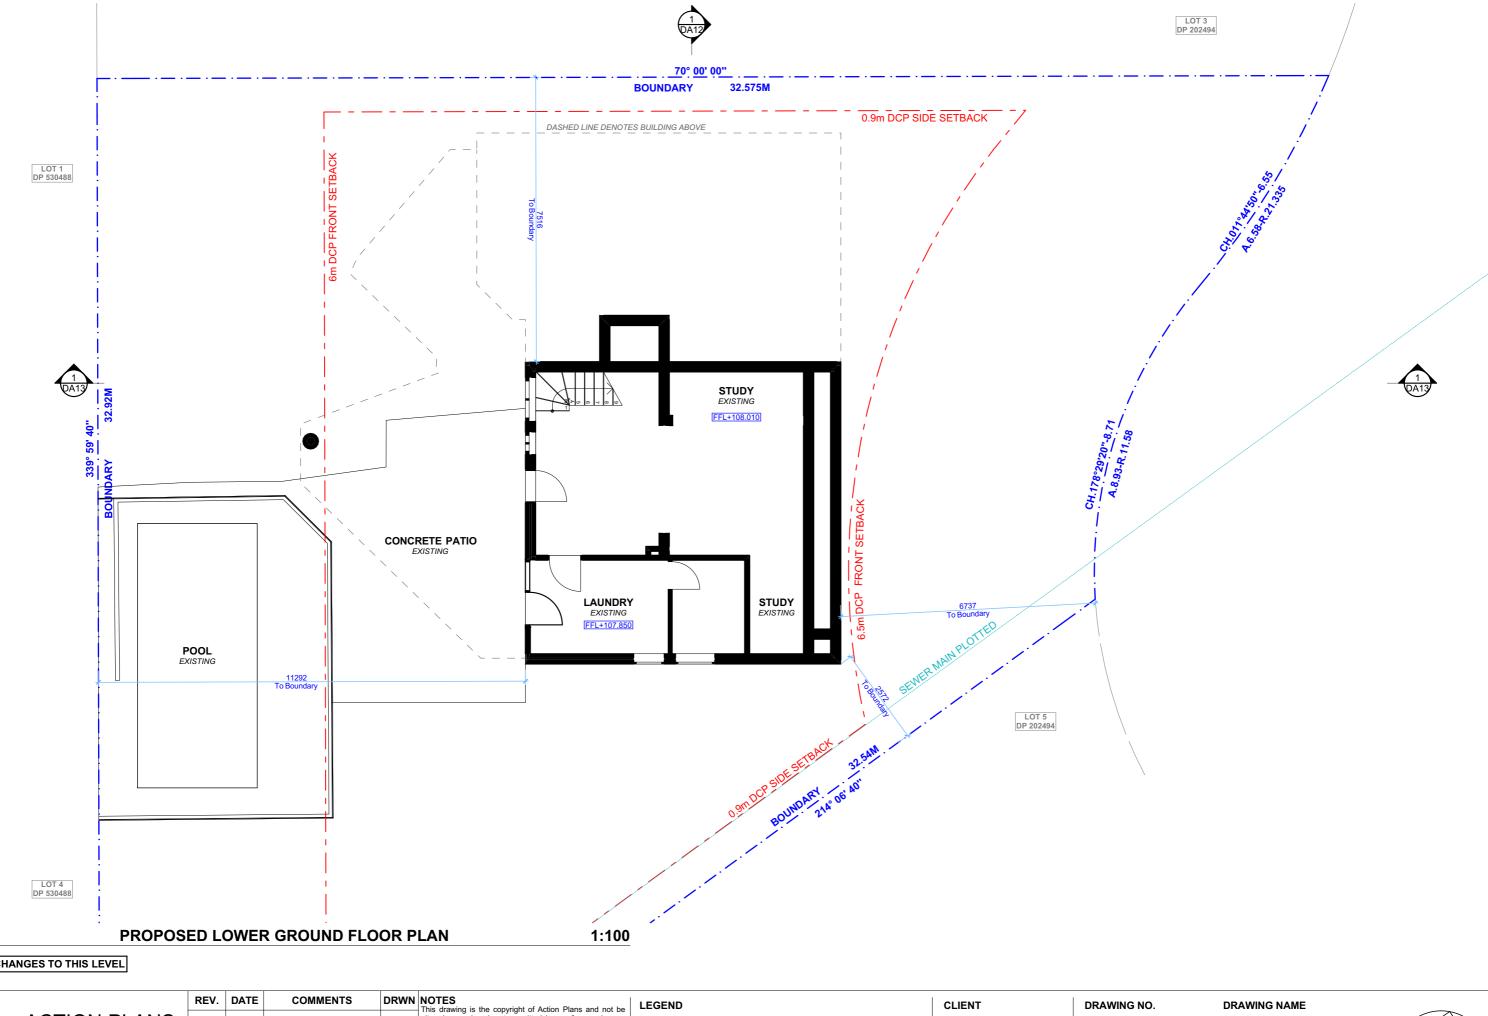
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DRAWING NO. **DA05**

DATE 01 June 2020

DRAWING NAME EXISTING FIRST FLOOR PLAN






NOTE: NO CHANGES TO THIS LEVEL



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ROB & TASHA
SMITHIES

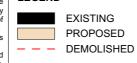PROJECT ADDRESS
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FORESTVILLE NSW 2087


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DA06	

01 June 2020

DATE


PROPOSED LOWER GROUND FLOOR PLAN SCALE 1:100 @A3



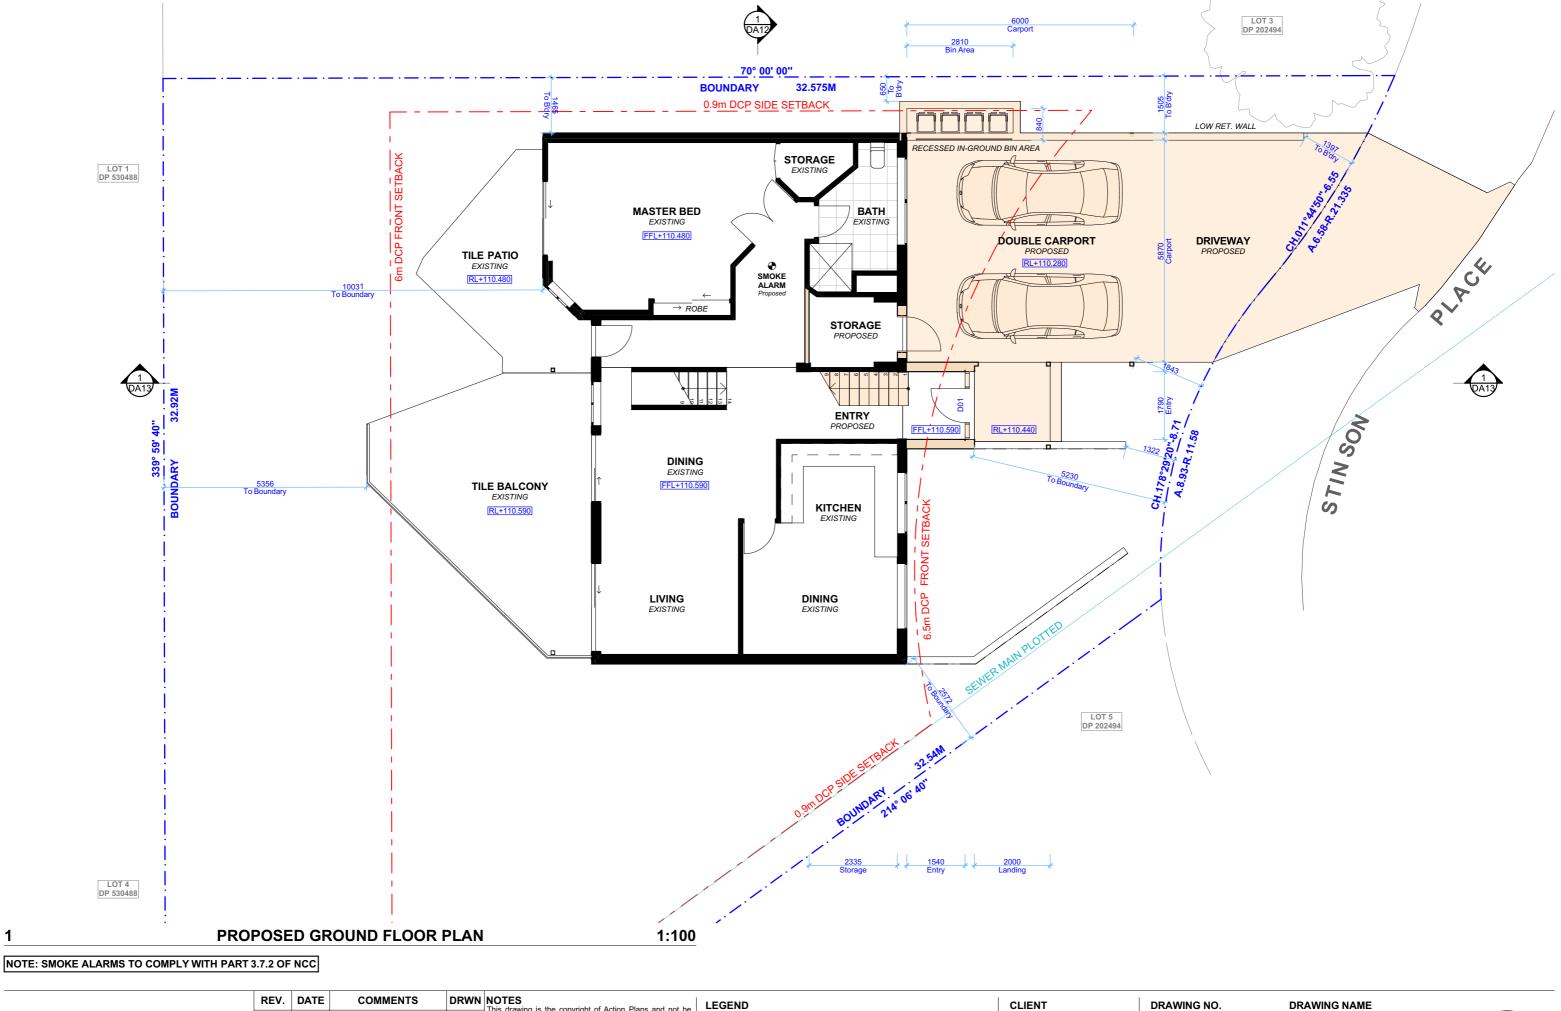




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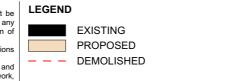
ROB & TASHA SMITHIES	DA07
PROJECT ADDRESS	DATE
8 STINSON PLACE, FORESTVILLE NSW 2087	01 June 202

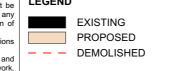PROPOSED GROUND FLOOR PLAN





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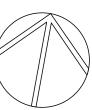
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DA08	

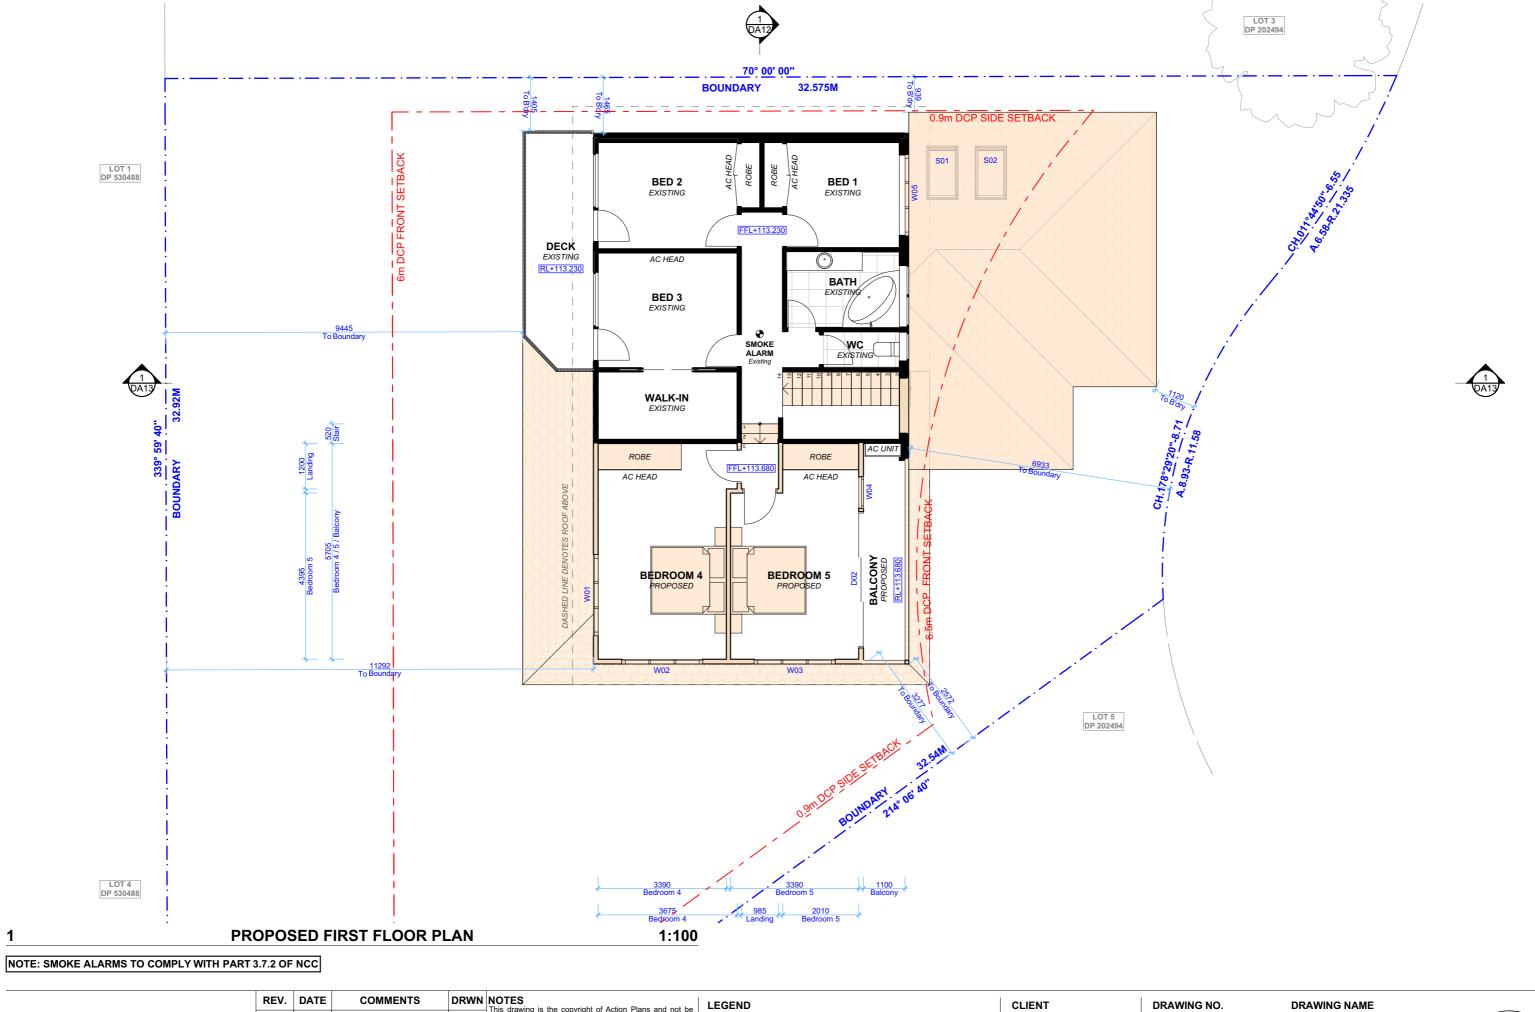
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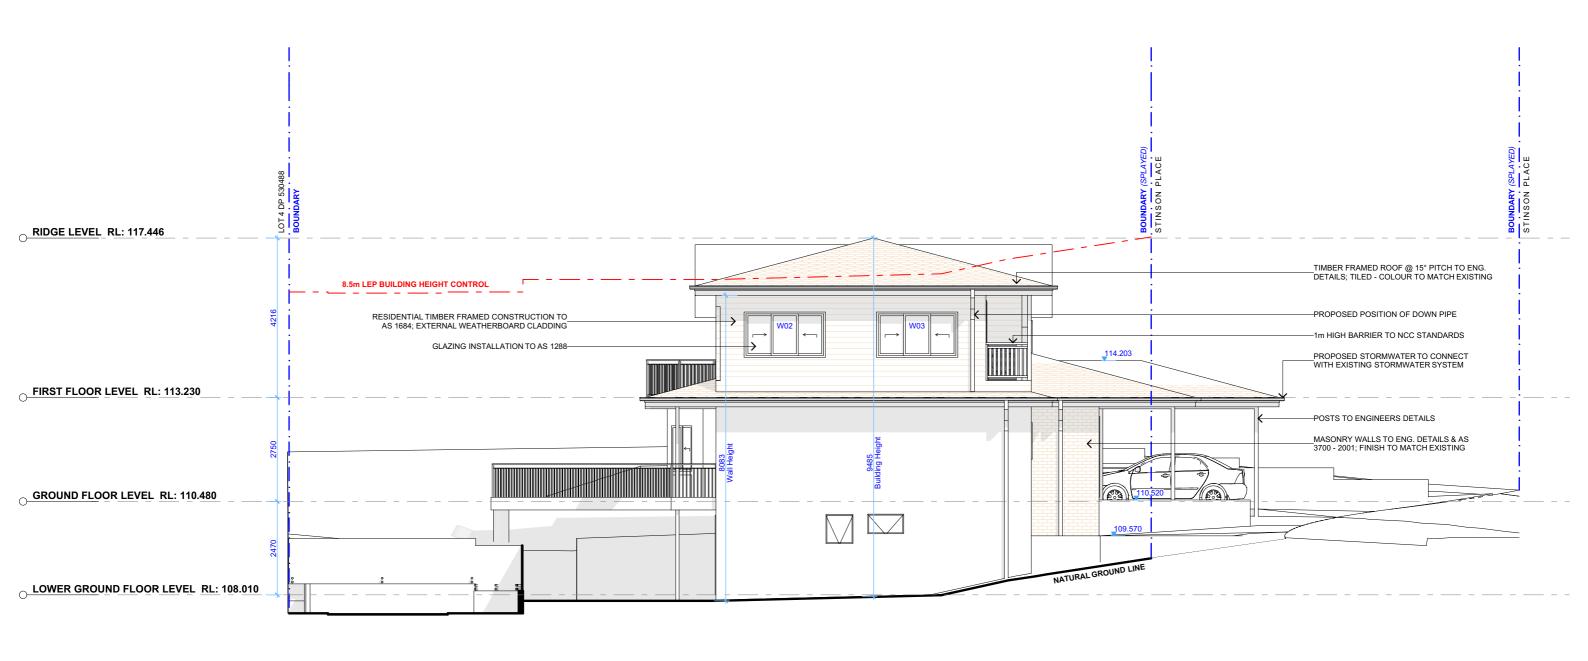
DATE

PROPOSED FIRST FLOOR PLAN







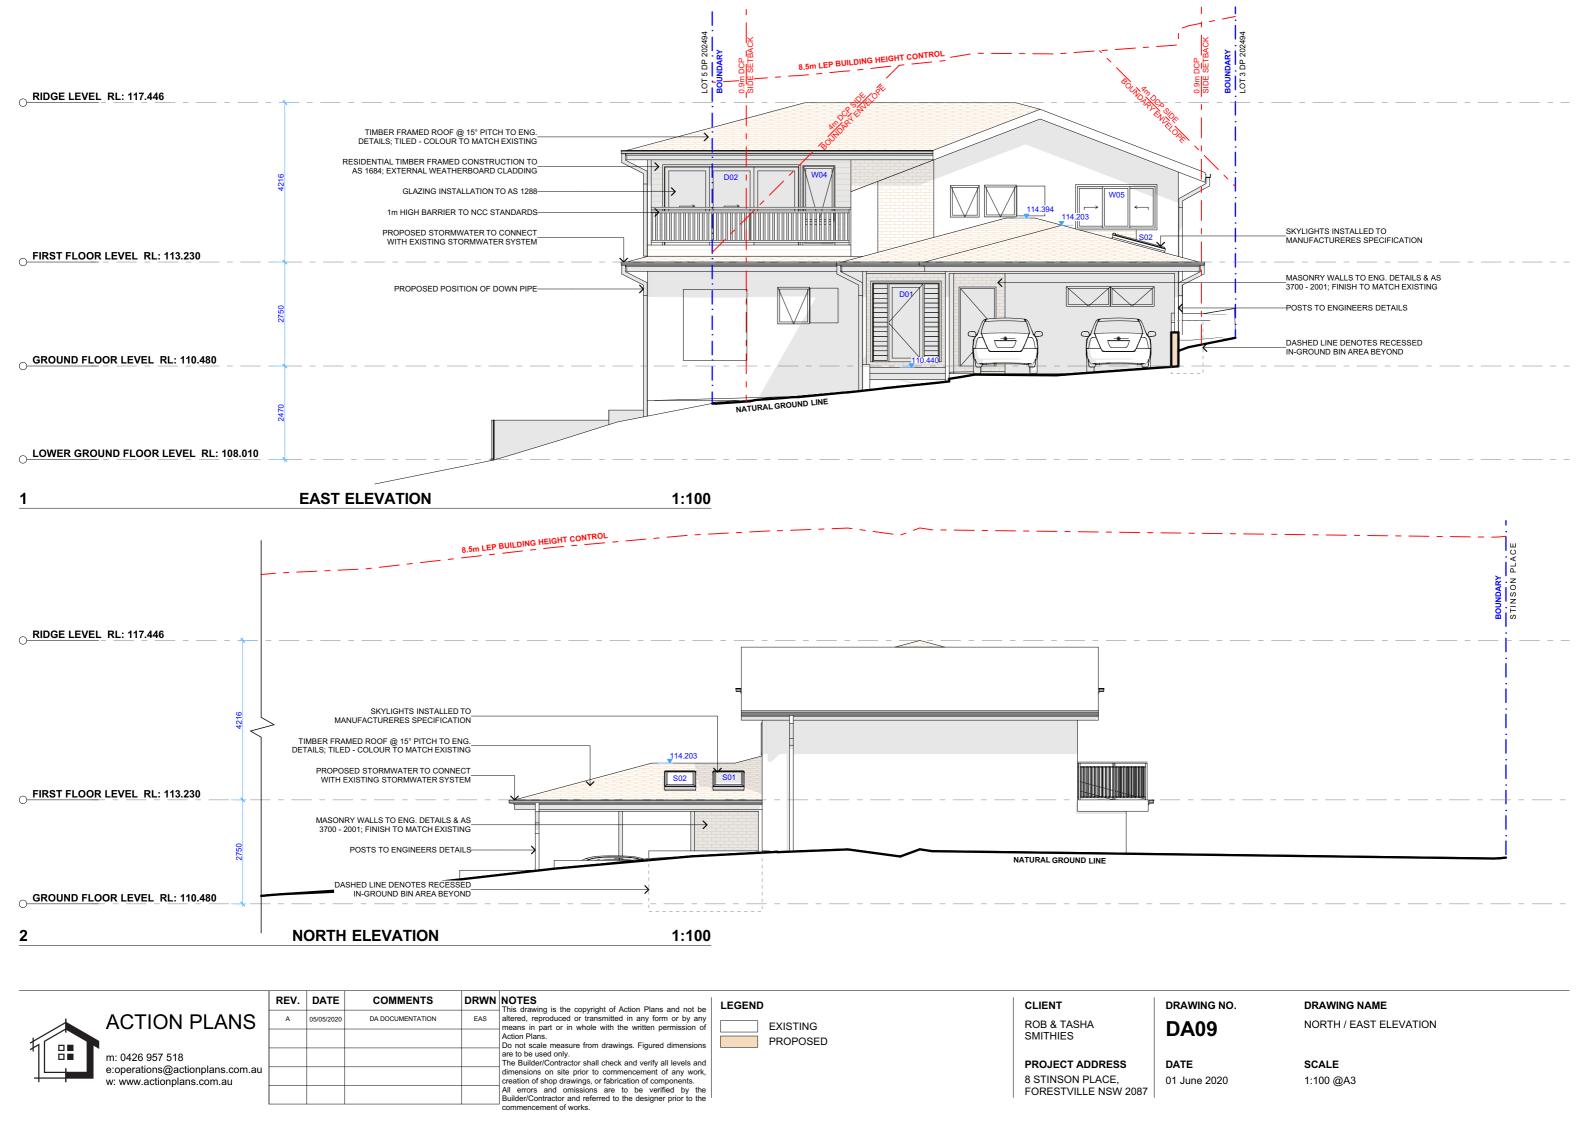

SOUTH ELEVATION 1:100



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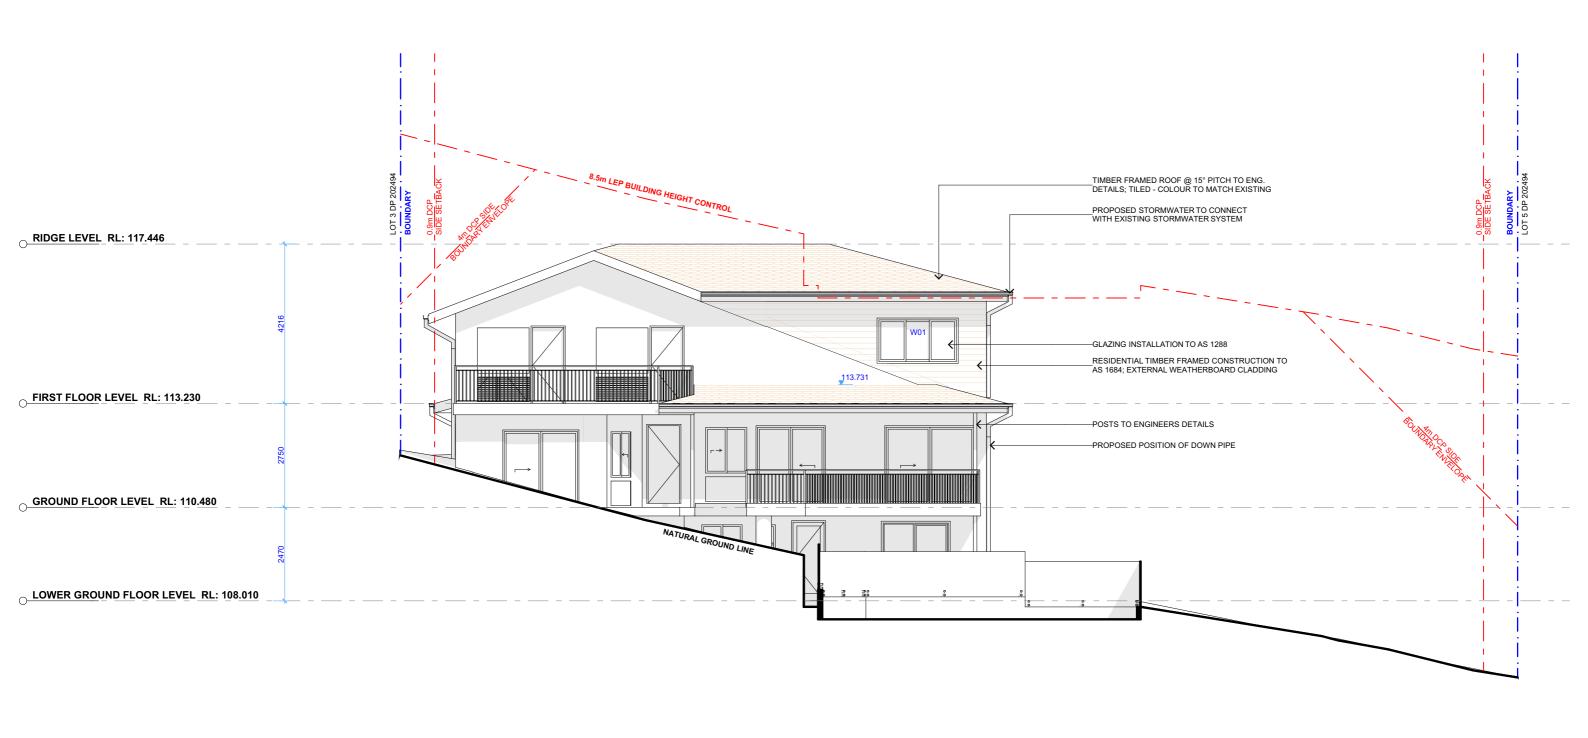
CLIENT	DRAWING NO.
ROB & TASHA SMITHIES	DA10
PROJECT ADDRESS	DATE

8 STINSON PLACE, FORESTVILLE NSW 2087

DA10	
DATE	

01 June 2020

DRAWING NAME SOUTH ELEVATION



WEST ELEVATION 1:100



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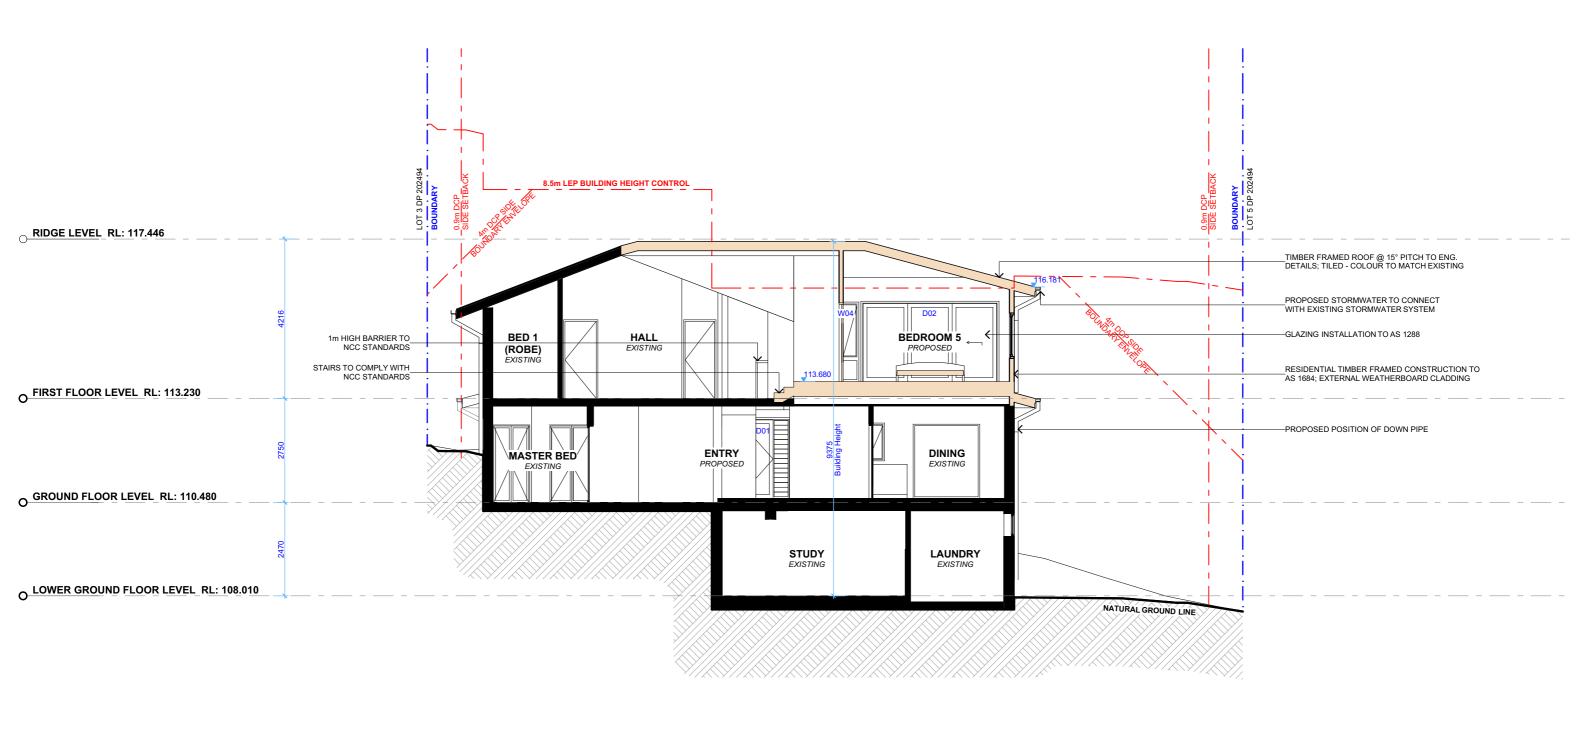
CLIENT	DRAWING NO.
ROB & TASHA SMITHIES	DA11

DA11	

DRAWING NAME WEST ELEVATION

PROJECT ADDRESS
8 STINSON PLACE,
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DATE 01 June 2020



1 LONG SECTION 1:100



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CLIENT	DRAWING NO.
ROB & TASHA SMITHIES	DA12
PROJECT ADDRESS	DATE


01 June 2020

8 STINSON PLACE, FORESTVILLE NSW 2087

12	LONG SECTION	
E	SCALE	

DRAWING NAME


1:100 @A3

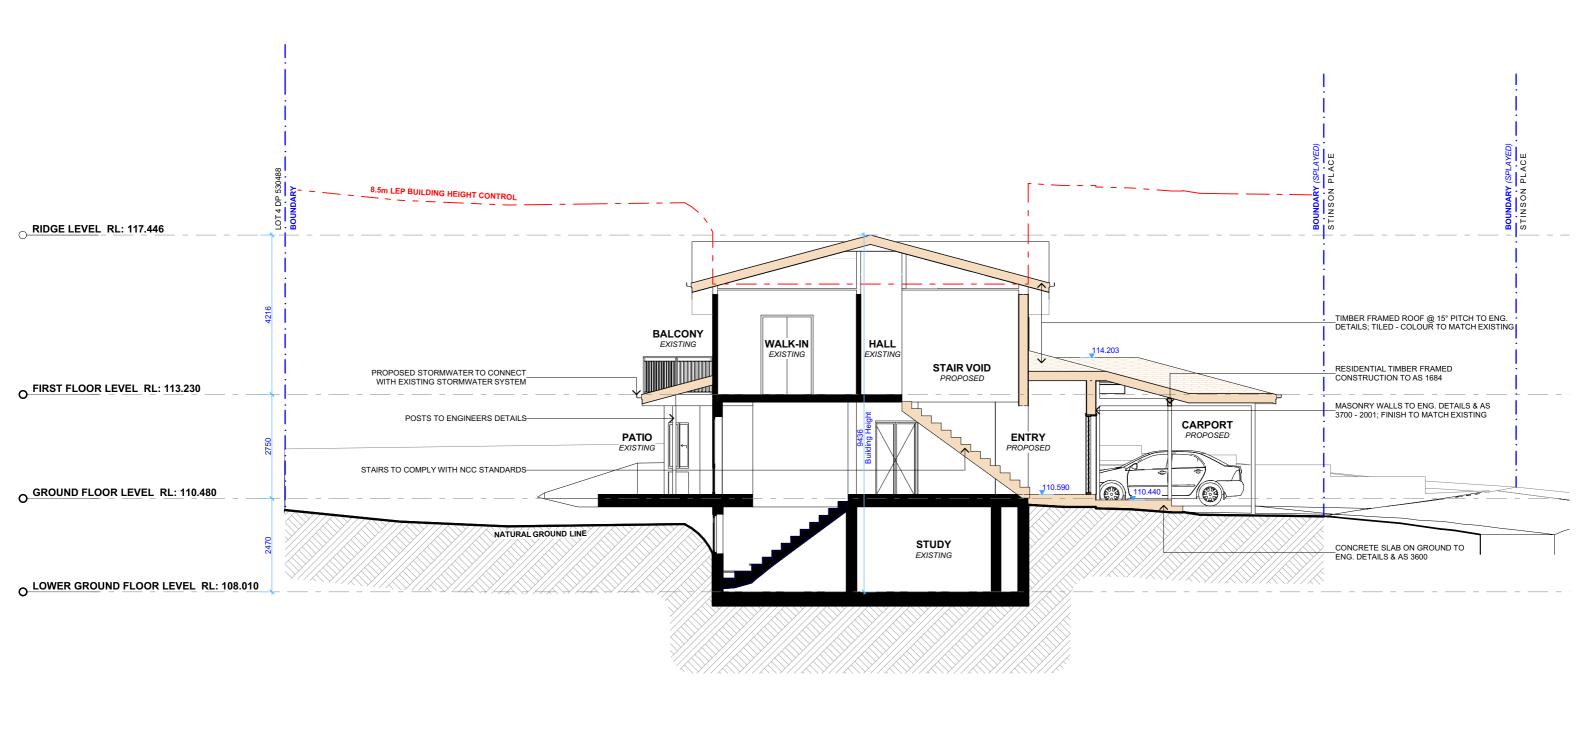

CROSS SECTION 1:100



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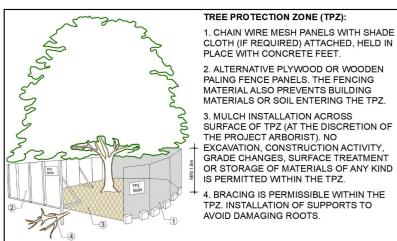


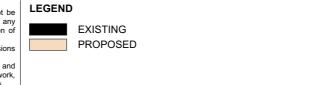CLIENT	DRAWING NO.
ROB & TASHA SMITHIES	DA13
PROJECT ADDRESS	DATE

8 STINSON PLACE, FORESTVILLE NSW 2087


AWING NO.	DRAWING NAME
A13	CROSS SECTION


DA13	CROSS SECTION
DATE	SCALE
01 June 2020	1:100 @A3



MATERIALS OR SOIL ENTERING THE TPZ. 3. MULCH INSTALLATION ACROSS 3. MULCH INSTALLATION ACROSS SURFACE OF TPZ (AT THE DISCRETION OF THE PROJECT ARBORIST). NO - EXCAVATION, CONSTRUCTION ACTIVITY, GRADE CHANGES, SURFACE TREATMENT OR STORAGE OF MATERIALS OF ANY KIND

4. BRACING IS PERMISSIBLE WITHIN THE TPZ. INSTALLATION OF SUPPORTS TO AVOID DAMAGING ROOTS.

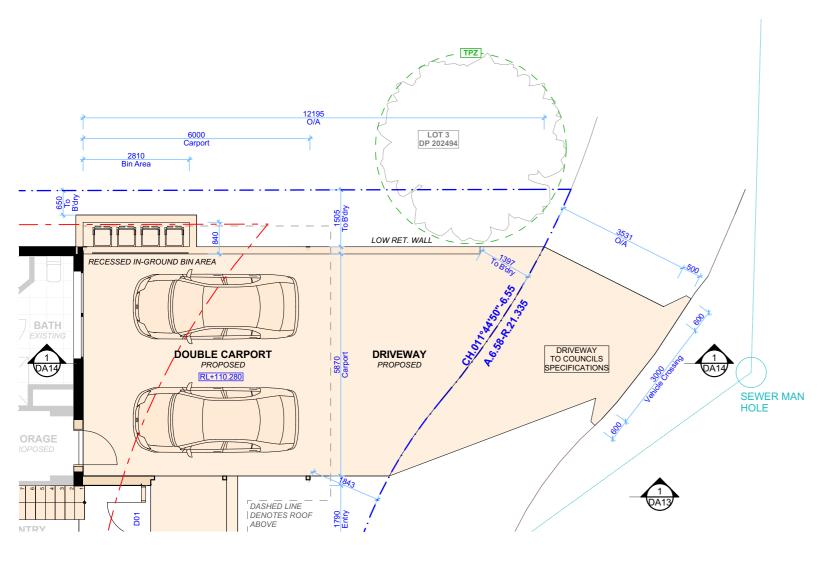


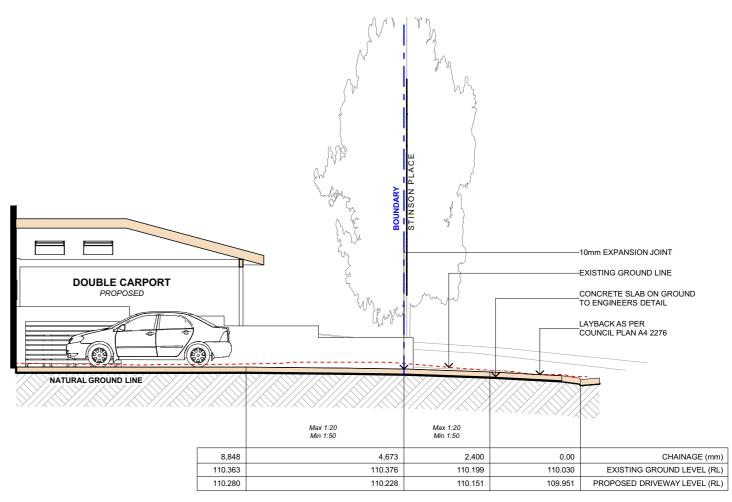

PROPOSED DRIVEWAY PLAN **DRIVEWAY LONG SECTION** 1:100 1:100




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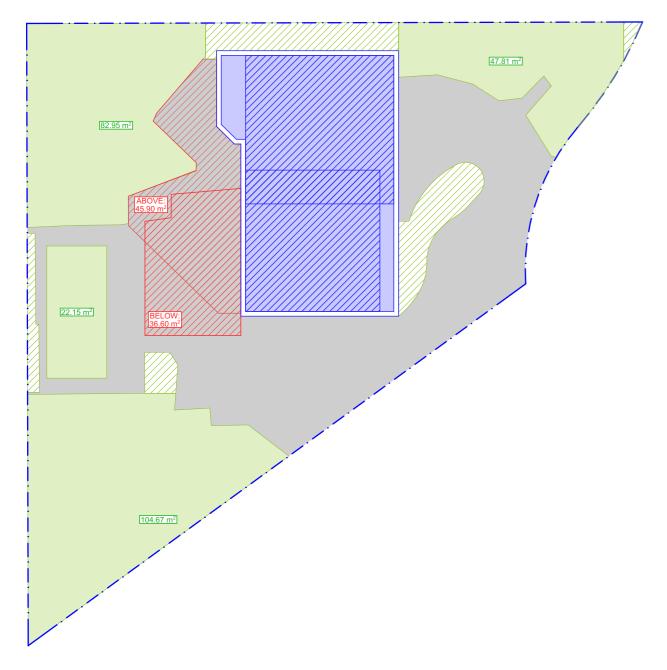


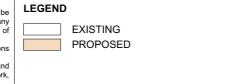
CLIENT ROB & TASHA **DA14 SMITHIES**

PROJECT ADDRESS DATE 8 STINSON PLACE, 01 June 2020 FORESTVILLE NSW 2087

DRAWING NO. DRAWING NAME DRIVEWAY PLAN / SECTION



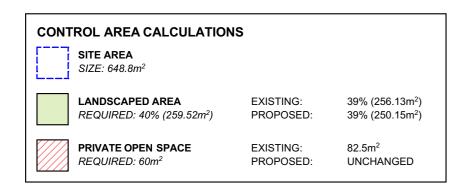

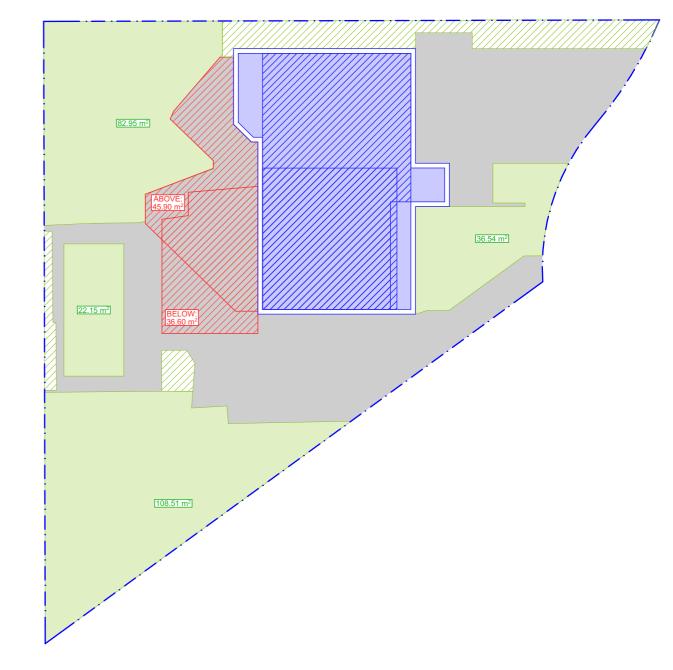

1 EXISTING AREA CALCULATIONS 1:200 2 PROPOSED AREA CALCULATIONS



	REV.	DATE	COMMENTS	DRWN	NOTES
	Α	05/05/2020	DA DOCUMENTATION	EAS	This drawing is the copyright of Action Plans and not be altered, reproduced or transmitted in any form or by an means in part or in whole with the written permission of
					Action Plans.
ł					Do not scale measure from drawings. Figured dimensions are to be used only.
			The Builder/Co	The Builder/Contractor shall check and verify all levels and	
					dimensions on site prior to commencement of any work creation of shop drawings, or fabrication of components.
İ				All errors and omission	All errors and omissions are to be verified by the
Į					Builder/Contractor and referred to the designer prior to the commencement of works.

LEGEND

CLIENT ROB & TASHA SMITHIES

PROJECT ADDRESS 8 STINSON PLACE, FORESTVILLE NSW 2087 DRAWING NO.

01 June 2020


DATE

DA15

SCALE 1:200 @A3

DRAWING NAME

AREA CALCULATIONS

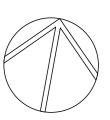

1:200





ALUMINIUM FRAMED WINDOW BY STEGBAR OR OTHER



GLAZED DOOR WITH SIDE LOUVERS STYLE TO BE CONFIRMED BY CLIENT

SAMPLE BOARD

ACTION PLANS
m: 0426 957 518 e:operations@actionplans.com.au w: www.actionplans.com.au

	REV.	DATE	COMMENTS	DRWN	NOTES This drawing is the copyright of Action Plans and not be
	А	05/05/2020	DA DOCUMENTATION	EAS	altered, reproduced or transmitted in any form or by any means in part or in whole with the written permission of
					Action Plans. Do not scale measure from drawings. Figured dimensions are to be used only.
u					The Builder/Contractor shall check and verify all levels and dimensions on site prior to commencement of any work, creation of shop drawings, or fabrication of components.
					All errors and omissions are to be verified by the Builder/Contractor and referred to the designer prior to the commencement of works.

LEGEND


CLIENT ROB & TASHA SMITHIES

PROJECT ADDRESS 8 STINSON PLACE, FORESTVILLE NSW 2087 DRAWING NO.

DA16


DATE 01 June 2020 **DRAWING NAME**SAMPLE BOARD

SCALE @A3

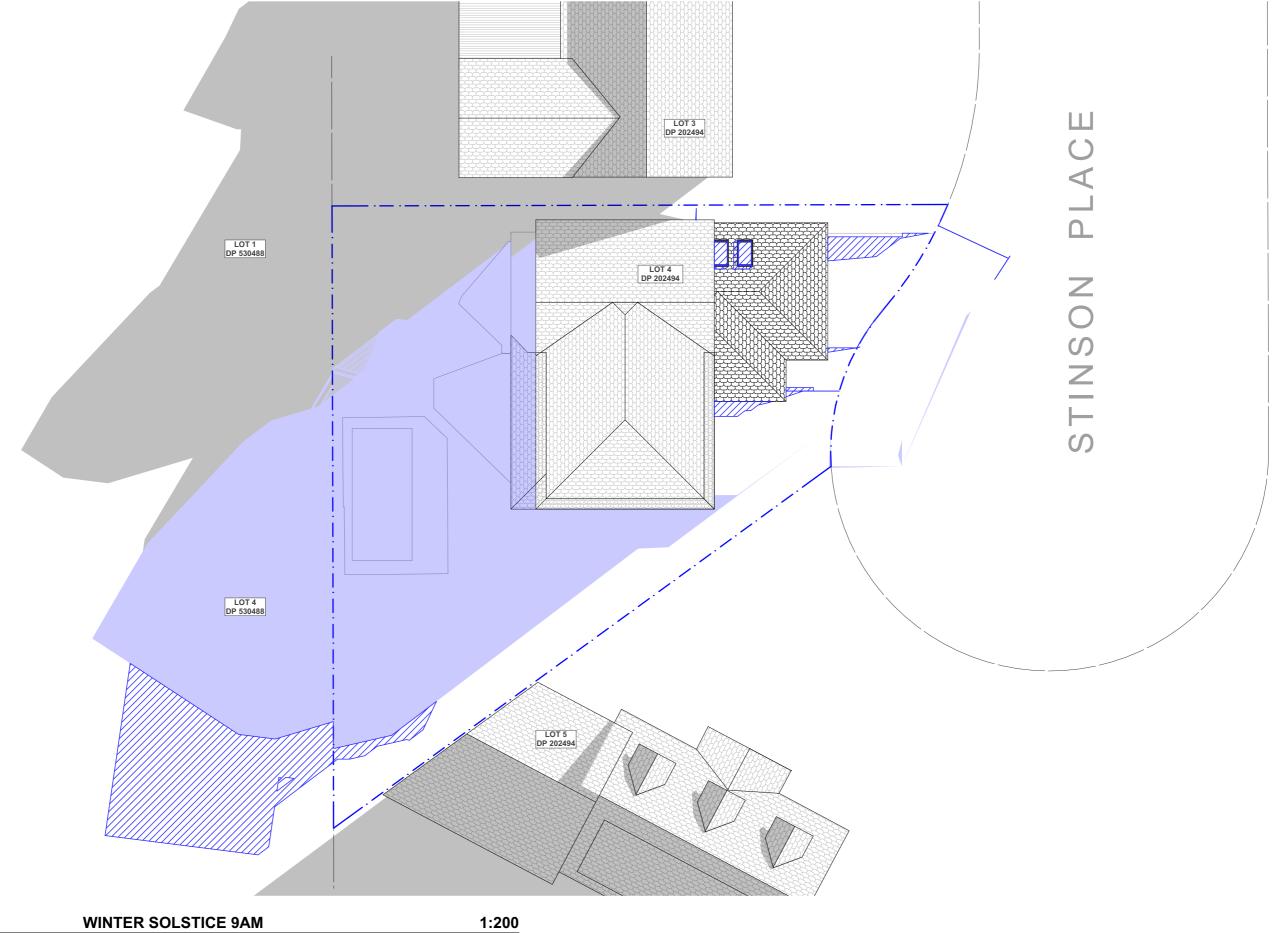




REV.	DATE	COMMENTS	DRWN	NOTES
Α	05/05/2020	DA DOCUMENTATION	EAS	This drawing is the copyright of Action Plans and not be altered, reproduced or transmitted in any form or by any means in part or in whole with the written permission of
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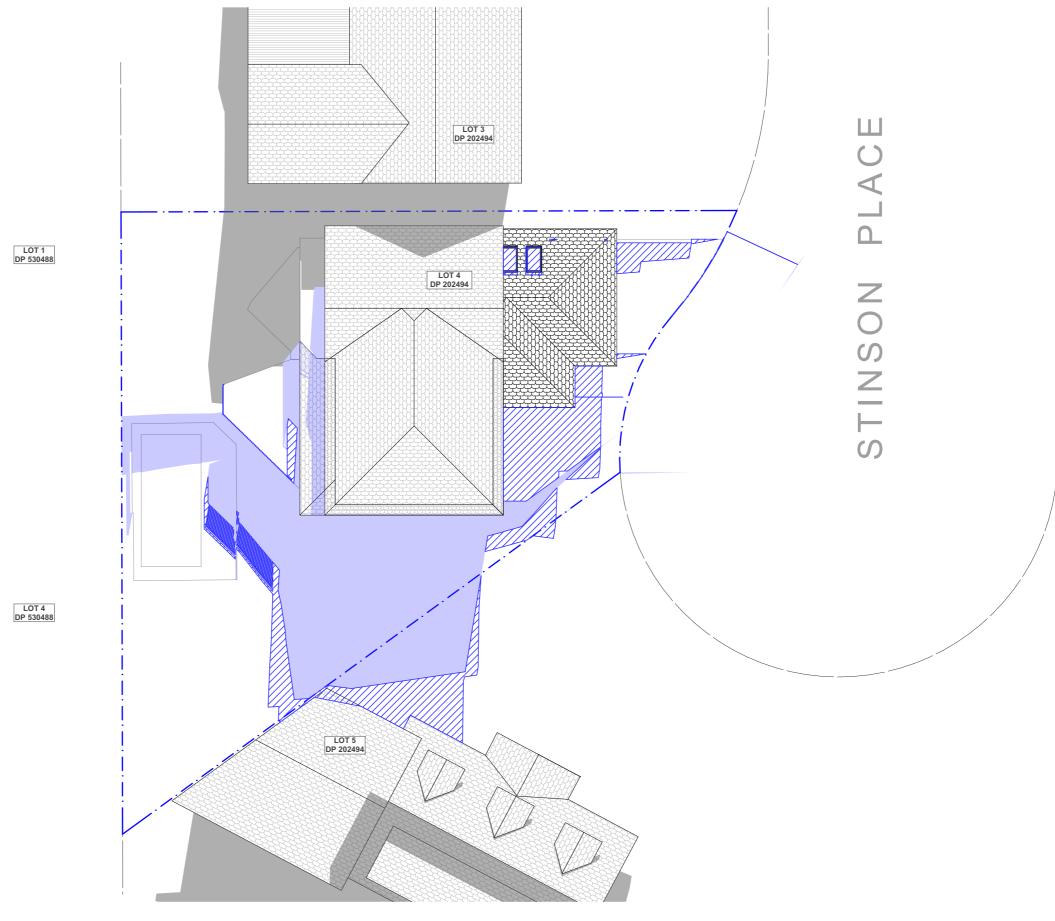


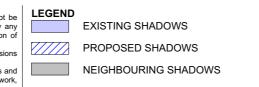CLIENT	DRAWING NO.
ROB & TASHA SMITHIES	DA17

SWITTILS	
PROJECT ADDRESS	DATE
8 STINSON PLACE, FORESTVILLE NSW 2087	01 June 2020

DRAWING NAME WINTER SOLSTICE 9 AM




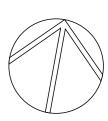

1 WINTER SOLSTICE 12PM 1:200

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				commencement of works.

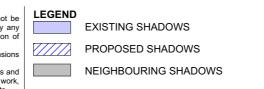


CLIENT	
ROB & TASHA SMITHIES	
PROJECT ADDRESS	


PROJECT ADDRESS	[
8 STINSON PLACE,	C
FORESTVILLE NSW 2087	

DRAWING NO.

DATE01 June 2020

DRAWING NAME
WINTER SOLSTICE 12 PM

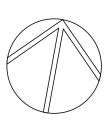


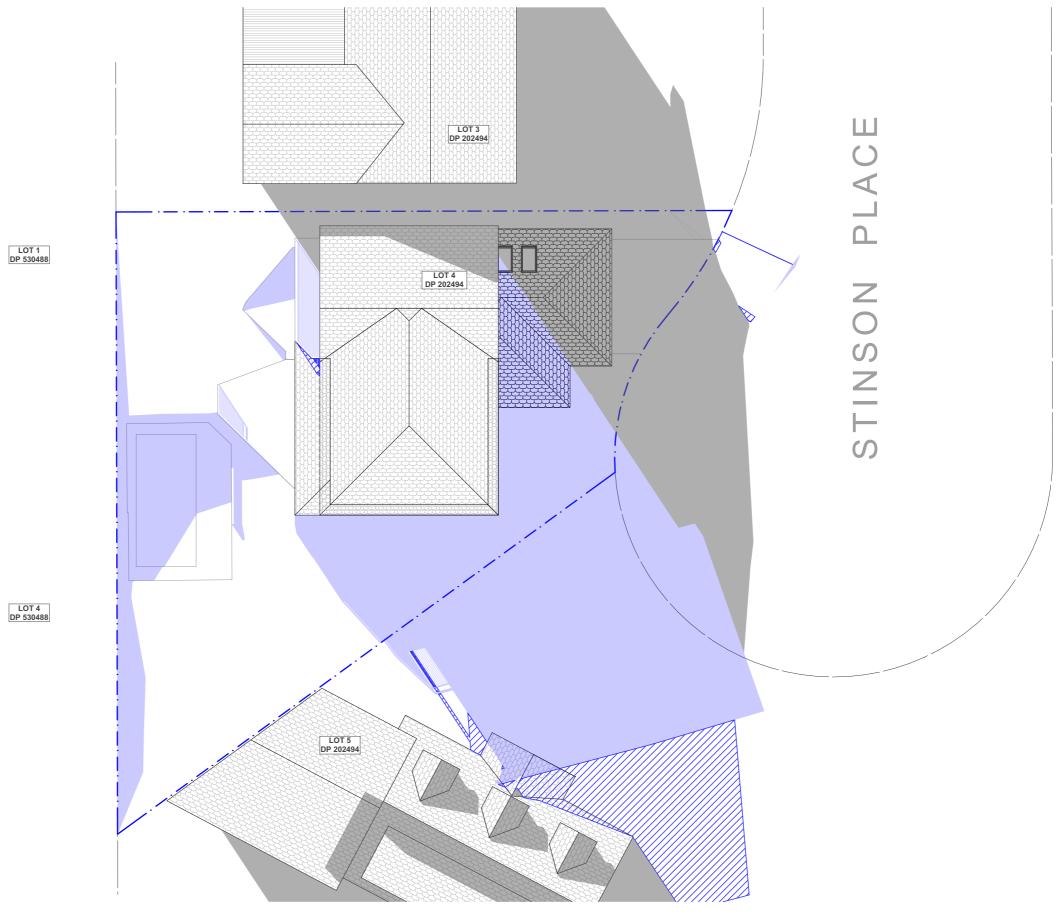

1 WINTER SOLSTICE 3PM 1:200



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					Builder/Contractor and referred to the designer prior to the commencement of works.

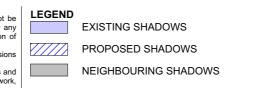


CLIENT DR
ROB & TASHA
SMITHIES D

PROJECT ADDRESS 8 STINSON PLACE, FORESTVILLE NSW 2087 DRAWING NO.

DATE01 June 2020

DRAWING NAMEWINTER SOLSTICE 3 PM

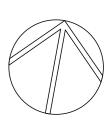



Building Sustainability Index www.basix.nsw.gov.au

Alterations and Additions

Certificate number: A376106

This certificate confirms that the proposed development will meet the NSW government's requirements for sustainability, if it is built in accordance with the commitments set out below. Terms used in this certificate, or in the commitments, have the meaning given by the document entitled "BASIX Alterations and Additions Definitions" dated 06/10/2017 published by the Department. This document is available at www.basix.nsw.gov.au

Secretary
Date of issue: Wednesday, 29, April 2020
To be valid, this certificate must be lodged within 3 months of the date of issue.



C	Project address					
O	Project name	8 Stinson Place Forestville				
O	Street address	8 Stinson Place Forestville 2087				
ĭ	Local Government Area	Northern Beaches Council				
d	Plan type and number	Deposited Plan 202494				
4-	Lot number	4				
0	Section number					
	Project type					
ptio	Dwelling type	Separate dwelling house				
rip	Type of alteration and addition	My renovation work is valued at \$50,000 or more, and does not include a pool (and/or spa).				
esci						

Certificate Prepared by (please complete before submitting to Council or PCA)
Name / Company Name: Action Plans
ABN (if applicable): 17118297587

Fixtures and systems	Show on CC/CDC Plans & specs	Certifier Check
Lighting		
The applicant must ensure a minimum of 40% of new or altered light fixtures are fitted with fluorescent, compact fluorescent, or light-emitting-diode (LED) lamps.	~	✓

Ŏ

Construction			Show on DA Plans	Show on CC/CDC Plans & specs	Certifier Check
nsulation requirements					•
The applicant must construct the new or altered the table below, except that a) additional insulates not required for parts of altered construction to	✓	✓	~		
Construction	Additional insulation required (R-value)	Other specifications			
suspended floor with open subfloor: framed (R0.7).	R0.8 (down) (or R1.50 including construction)				
suspended floor with enclosed subfloor: framed (R0.7).	R0.60 (down) (or R1.30 including construction)				
floor above existing dwelling or building.	nil				
external wall: brick veneer	R1.16 (or R1.70 including construction)				
external wall: framed (weatherboard, fibro, metal clad)	R1.30 (or R1.70 including construction)				
flat ceiling, pitched roof	ceiling: R3.00 (up), roof: foil/sarking	medium (solar absorptance 0.475 - 0.70)			
raked ceiling, pitched/skillion roof: framed	ceiling: R3.00 (up), roof: foil/sarking	medium (solar absorptance 0.475 - 0.70)			

Glazing r	requirements						Show on DA Plans	Show on CC/CDC Plans & specs	Certifier Check
Windows	and glazed d	loors							
					nading devices, in accordance with reach window and glazed door.	the specifications listed in the table below.	✓	✓	✓
The followi	ing requirement	s must also	be satisfi	ed in relation	n to each window and glazed door:			✓	~
have a U-v	value and a Sola	ar Heat Gai	n Coefficie	ent (SHGC) r		d glass may either match the description, or, le below. Total system U-values and SHGCs i.		✓	✓
have a U-v must be ca	Each window or glazed door with improved frames, or pyrolytic low-e glass, or clear/air gap/clear glazing, or toned/air gap/clear glazing must have a U-value and a Solar Heat Gain Coefficient (SHGC) no greater than that listed in the table below. Total system U-values and SHGCs must be calculated in accordance with National Fenestration Rating Council (NFRC) conditions. The description is provided for information only. Alternative systems with complying U-value and SHGC may be substituted.								~
					each eave, pergola, verandah, bal than 2400 mm above the sill.	cony or awning must be no more than 500 mm	✓	✓	✓
Pergolas w	vith polycarbona	ate roof or s	imilar tran	slucent mate	erial must have a shading coefficien	t of less than 0.35.		✓	~
					e window or glazed door above whi ens must not be more than 50 mm.	ch they are situated, unless the pergola also		✓	✓
Windows	s and glazed	l doors g	lazing r	equireme	nts		-		
Window / o	door Orientatio	n Area of glass inc. frame (m2)	Oversha Height (m)	Distance (m)	Shading device	Frame and glass type			
W1	W	2.58	0	0	eave/verandah/pergola/balcony >=900 mm	standard aluminium, single clear, (or U-value: 7.63, SHGC: 0.75)			
W2	S	2.58	0	0	eave/verandah/pergola/balcony >=600 mm	standard aluminium, single clear, (or U-value: 7.63, SHGC: 0.75)			
W3	S	2.58	0	0	eave/verandah/pergola/balcony >=600 mm	standard aluminium, single clear, (or U-value: 7.63, SHGC: 0.75)			

Glazing requ	irements						Show on DA Plans	Show on CC/CDC Plans & specs	Certifier Check
Window / door	Orientation	Area of	Overshadowing		Shading device	Frame and glass type			
no.		glass inc. frame (m2)	Height (m)	Distance (m)					
W4	E	1.78	0	0	eave/verandah/pergola/balcony >=900 mm	standard aluminium, single clear, (or U-value: 7.63, SHGC: 0.75)			
W5	E	2.58	0	0	eave/verandah/pergola/balcony >=450 mm	standard aluminium, single pyrolytic low-e, (U-value: 5.7, SHGC: 0.47)			
D1	Е	3.76	0	0	eave/verandah/pergola/balcony >=900 mm	standard aluminium, single clear, (or U-value: 7.63, SHGC: 0.75)			
D2	E	7.58	0	0	eave/verandah/pergola/balcony >=900 mm	standard aluminium, single clear, (or U-value: 7.63, SHGC: 0.75)			

In these commitments, "applicant" means the person carrying out the development.

Commitments identified with a "
in the "Show on DA plans" column must be shown on the plans accompanying the development application for the proposed development (if a development application is to be lodged for the proposed development).

Commitments identified with a "\"" in the "Show on CC/CDC plans & specs" column must be shown in the plans and specifications accompanying the application for a construction certificate / complying development certificate for the proposed development.

Commitments identified with a "v" in the "Certifier check" column must be certified by a certifying authority as having been fulfilled, before a final occupation certificate for the development may be issued.



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				The Builder/Contractor shall check and verify all levels and dimensions on site prior to commencement of any work, creation of drawings. or fabrication of components.
				All errors and omissions are to be verified by the Builder/Contractor and referred to the designer prior to the commencement of work All window & door dimensions, orientation, glazing materials, opening types, frame types are to be confirmed by a suitably qualified
				person prior to the ordering of any such materials are to take place. U value takes precedence over glazing type/colour in all cases. all new glazing must meet the BASIX specified frame and glass type, <i>QR</i> meet the certified U value and SHGC value.

CLIENT **ROB & TASHA** SMITHIES

PROJECT ADDRESS 8 STINSON PLACE. FORESTVILLE NSW 2087

DRAWING NO.

DATE

01 June 2020

DRAWING NAME BASIX COMMITMENTS

DA20