

ACTION PLANS

m: 0403957518 e:design@actionplans.com.au w: www.actionplans.com.au

SECTION 96

| ITEM DETAILS | DEVELOPMENT APPLICATION | | | |
|-------------------------------------|-----------------------------------|------------------------|------------------------|------------|
| ADDRESS | 31 ROBERT STREET, FRESHWATER, NSW | 2096 | | |
| LOT & DP/SP | LOT 29 DP 12072 | | | |
| COUNCIL | NORTHERN BEACHS COUNCIL | | | |
| SITE AREA | 687.4m² | | | |
| FRONTAGE | 15.24m | | | |
| CONTROLS | PERMISSIBLE / REQUIRED | EXISTING | PROPOSED | COMPLIANCE |
| | m / m² / % | m / m² / % | m / m² / % | |
| <u>LEP</u> | | | | |
| LAND ZONING | R2 – LOW DENSITY RESIDENTIAL | R2 | R2 | YES |
| MINIMUM LOT SIZE | 450m² | 687.4m² | UNCHANGED | YES |
| FLOOR SPACE RATIO | NOT IDENTIFEID | N/A | N/A | N/A |
| MAXIMUM BUILDING HEIGHT | 8.5m | 6.93m | 8.5m | YES |
| <u>HAZARDS</u> | | | | |
| ACID SULFATE SOILS | NOT IDENTIFEID | N/A | N/A | N/A |
| FLOOD PLANNING | NOT IDENTIFEID | N/A | N/A | N/A |
| DEVELOPMENT ON SLOPING LAND | SLIP-RISK A & B | N/A | N/A | N/A |
| COASTAL HAZARDS | NOT IDENTIFEID | N/A | N/A | N/A |
| HIGH/MED/LOW FLOOD RISK PRECINCT | NOT IDENTIFEID | N/A | N/A | N/A |
| NATIVE VEGETATION | NOT IDENTIFEID | N/A | N/A | N/A |
| WILDLIFRE CORRIDORS | NOT IDENTIFEID | N/A | N/A | N/A |
| WATERWAYS AND RIPARIAN LAND | NOT IDENTIFEID | N/A | N/A | N/A |
| THREATEND HIGH CONSERVATION HABITAT | NOT IDENTIFEID | N/A | N/A | N/A |
| LAND ADJOINING PUBLIC OPEN SPACE | NOT IDENTIFEID | N/A | N/A | N/A |
| <u>DCP</u> | | | | |
| WALL HEIGHT | 7.2m | 4.53m | 7.584m | NO |
| NUMBER OF STOREYS | 2 | 2 | UNCHANGED | YES |
| SIDE BOUNDARY ENVELOPE | 5m | | UNCHANGED | NO |
| SIDE BOUNDARY SETBACKS | 0.9m | E: 0.619m W: 1.397m | E: 4.364m W: 1.383m | YES |
| FRONT BOUNDARY SETBACK | 6.5m | 15.153m | UNCHANGED | YES |
| REAR BOUNDARY SETBACK | 6.0m | 8.388m | 10.222m | YES |
| LANDSCAPE OPEN SPACE | 40% (289.36m²) | 30% (206.21m²) | 35% (242.56m²) | YES |
| PRIVATE OPEN SPACE | 60m² | 147m² | 154m² | YES |


| SHEET NUMBER | SHEET NAME | DATE PUBLISHED |
|--------------|---|----------------|
| S96-00 | COVER | 26/02/2018 |
| S96-01 | SITE / ROOF / SEDIMENT EROSION / WASTE MANAGEMENT / STORMWATER CONCEPT PLAN | 26/02/2018 |
| S96-02 | EXISTING LOWER GROUND FLOOR PLAN | 26/02/2018 |
| S96-03 | PROPOSED LOWER GROUND FLOOR PLAN | 26/02/2018 |
| S96-04 | EXISTING GROUND FLOOR PLAN | 26/02/2018 |
| S96-05 | PROPOSED GROUND FLOOR PLAN | 26/02/2018 |
| S96-06 | PROPOSED FIRST FLOOR PLAN | 26/02/2018 |
| S96-07 | NORTH / EAST ELEVATION | 26/02/2018 |
| S96-08 | SOUTH / WEST ELEVATION | 26/02/2018 |
| S96-09 | LONG / CROSS SECTION | 26/02/2018 |
| S96-10 | AREA CALCULATIONS / SAMPLE BOARD | 26/02/2018 |
| S96-11 | WINTER SOLSTICE 09:00 | 26/02/2018 |
| S96-12 | WINTER SOLSTICE 12:00 | 26/02/2018 |
| S96-13 | WINTER SOLSTICE 15:00 | 26/02/2018 |
| S96-14 | BASIX COMMITMENTS | 26/02/2018 |


31 ROBERT ST, FRESHWATER NSW 2096



NCC & AS COMPLIANCES SPECIFICATIONS

- EARTHWORKS: METHOD OF EXCAVATION AND FILL - PART 3.1.1 OF NCC - SURFACE SUBSOIL-STORMWATER DRAINAGE - PART 3.1.2 OF NCC - TERMITE-RISK MANAGEMENT - PART 3.1.3 OF NCC - FOOTINGS & SLAB - PART 3.2 OF NCC INCLUDING AS2870 - MASONRY CONSTRUCTION - PART 3.3 OF NCC INCLUDING AS3700 - SUB FLOOR VENTILATION - PART 3.4.1 OF NCC - FRAMING - PART 3.4 OF NCC - ROOF, WALL-CLADDING, GUTTERS & DOWNPIPES - PART 3.5 OF NCC - GLAZING - PART 3.6 OF NCC INCLUDING AS1288 - FIRE SEPARATION - PART 3.7.1 OF NCC - SMOKE ALARMS - PART 3.7.2 OF NCC - HEATING APPLIANCES - PART 3.7.3 OF NCC - WET AREAS-PROTECTION OF WALLS & FLOORS - PART 3.8.1 OF NCC - MINIMUM ROOF HEIGHTS - PART 3.8.3 OF NCC - FACILITIES REQUIRRED & SANITARY DOOR CONSTRUCTION - PART 3.8.3 OF NCC - LIGHT: NATURAL AND ARTIFICIAL - PART 3.8.4 OF NCC - VENTILATION & LOCATION OF TOILETS - PART 3.8.5 OF NCC - SOUND INSULATION - PART 3.8.6 OF NCC - STAIR CONSTRUCTION INCLUDING DIMENSIONS - PART 3.9.1 OF NCC - BALUSTRADES & OTHER BARRIERS - PART 3.9.2 OF NCC - FENCING & OTHER PROVISIONS - REGS & AS1926 - DEMOLITION WORKS - AS2601-1991 THE DEMOLITION OF STRUCTURES. - ALL WATERPROOF MEMBRANES TO COMPLY WITH WITH AS 3740-2004 - ALL PLUMBING & DRAINAGE WORK TO COMPLY WITH AS 3500 - SITE CLASSIFICATION AS TO AS 2870 - ALL PLASTERBOARD WORK TO COMPLY WITH AS 2588-1998 - ALL STRUCTURAL STEEL WORK TO COMPLY WITH AS 4100 & AS 1554 - ALL CONCRETE WORK TO COMPLY WITH AS 3600 - ALL ROOF SHEETING WORK TO COMPLY WITH AS 1562-1992 - ALL SKYLIGHTS TO COMPLY WITH WITH AS 4285-2007 - ALL CERAMIC TILING TO COMPLY WITH AS 3958.1-2007 & 3958.2-1992 - ALL GLAZING ASSEMBLIES TO COMPLY WITH AS2047 & 1288 - ALL TIMBER RETAINING WALLS ARE TO COMPLY WITH AS 1720.1-2010, AS 1720.2-2006, AS 1720.4-2006, AS 1170.1-1989 & AS 1170.4-1993 - ALL RETAINING WALLS ARE TO COMPLY WITH 3700 - 2011 & AS 3600 -2001 - ALL CONSTRUCTION TO COMPLY TO AS3959- 1991

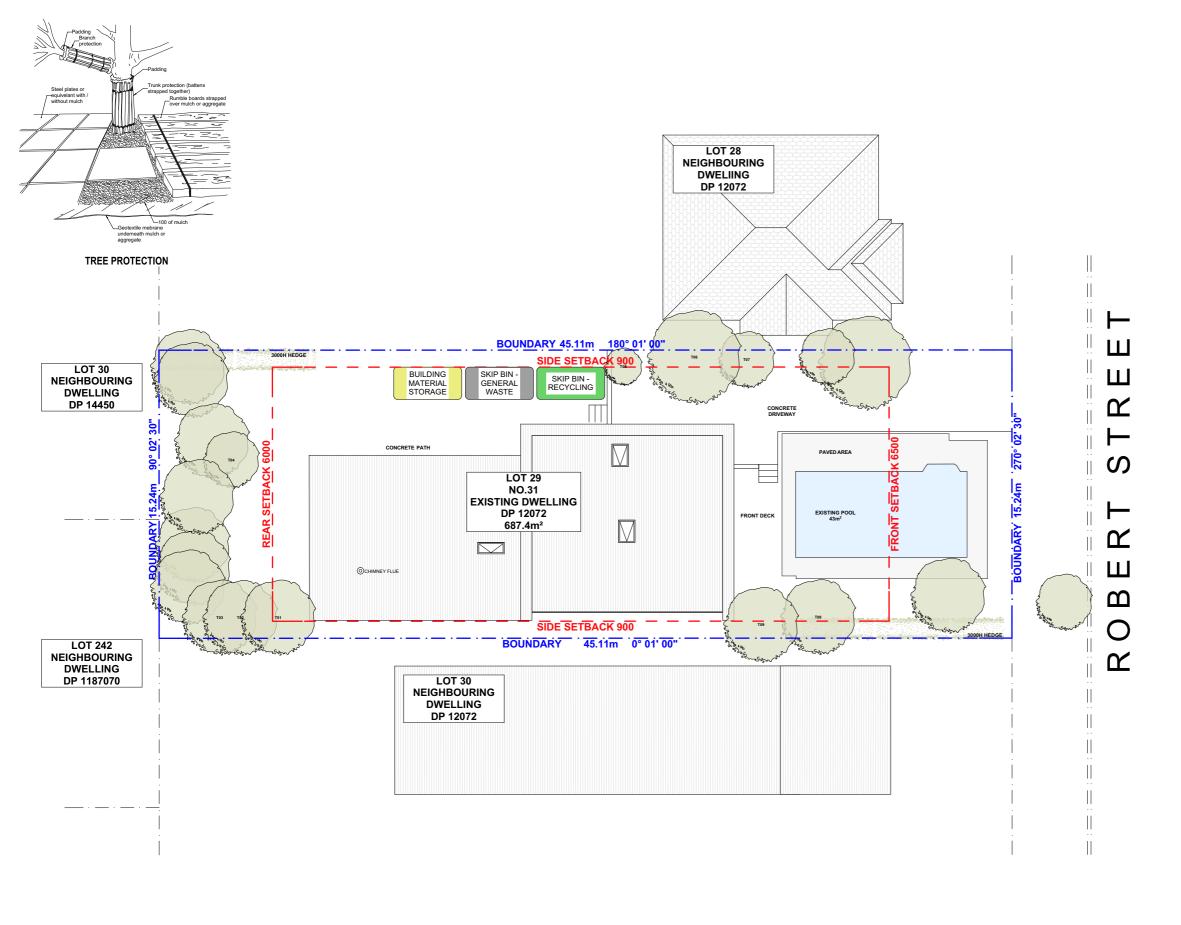

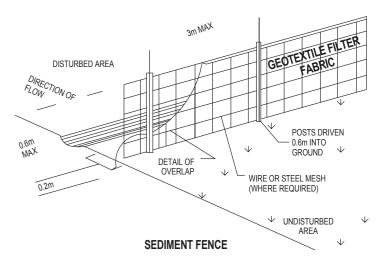

DUST CONTROL:

TO REDUCE DUST GENERATED BY WIND ACTION, THE REMOVAL OF THE TOP SOIL IS TO BE MINIMISED. TO PREVENT DUST GENERATION, WATERING DOWN OF THE SITE, ESPECIALLY DURING THE MOVEMENT OF MACHINERY IS REQUIRED. WHERE EXCAVATING INTO ROCK, KEEP THE SURFACE MOIST TO MINIMISE DUST. CONSTRUCT A GRAVEL ENTRY/EXIT POINT USING BLUE METAL AND RESTRICT ALL VEHICLE MOVEMENTS WITHIN THE SITE TO A MINIMUM. ENSURE WIND BREAKS, SUCH AS EXISTING FENCES ARE MAINTAINED DURING THE CONSTRUCTION PHASE UNTIL NEW LANDSCAPING IS PROVIDED OR REINSTATED. PREVENT DUST BY COVERING STOCKPILES

SEDIMENT NOTE:

1. ALL EROSION AND SEDIMENT CONTROL MEASURES TO BE INSPECTED AND MAINTAINED DAILY BY THE SITE MANAGER.

2. MINIMISE DISTURBED AREAS, REMOVE EXCESS SOIL FROM EXCAVATED AREA AS SOON AS POSSIBLE.
3. ALL MATERIAL STOCKPILE TO BE CLEAR FROM DRAINS, GUTTERS AND FOOTPATHS, OR WITHIN SEDIMENT FENCE AREA.

4. DRAINAGE TO BE CONNECTED TO STORMWATER AS SOON AS POSSIBLE. IF STORED ON SITE, IT MUST BE FILTERED BEFORE RELEASING INTO STORMWATER SYSTEM OR WATERWAYS

5. ROADS AND FOOTPATHS TO BE SWEPT DAILY.

STOCKPILES

ALL STOCKPILES ARE TO BE KEPT ON-SITE WHERE POSSIBLE. ANY MATERIALS PLACED ON THE FOOTPATHS OR NATURE STRIPS REQUIRE COUNCIL'S PERMISSION.

ALL STOCKPILES ARE TO BE PLACED AWAY FROM THE DRAINAGE LINES AND STREET GUTTERS. IT IS BEST TO LOCATE THESE ON THE HIGHEST PART OF THE SITE IF POSSIBLE. PLACE WATERPROOF COVERING OVER STOCKPILES.

IF REQUIRED PROVIDE DIVERSION DRAIN & BANK AROUND STOCKPILES.

GUTTER PROTECTION:

PROVIDE PROTECTION TO DOWNHILL GRATE IN GUTTER BY MEANS OF SAND BAGS OR BLUE METAL WRAPPED IN GEOTEXTILE FABRIC. WHEN SOIL OR SAND BUILDS UP AROUND THIS SEDIMENT BARRIER, THE MATERIAL SHOULD BE RELOCATED BACK TO THE SITE FOR DISPOSAL.

NOTE: ALL PROPOSED STORMWATER TO CONNECT WITH EXISTING

NOTE: DESIGNATED TREES FROM T01 - T09 ARE WITHIN 5m OF THE PROPOSED BUIDLING (SHOWED IN DASHED RED), THEREFORE THEY MUST HAVE A TREE PROTECTION SYSTEM INSTALLED AS PER THE TREE PROTECTION DIAGRAM ON THIS PAGE.

DRAWING NAME



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| | REV. | DATE | COMMENTS | DRWN |
|---|------|----------|--------------|------|
| S | А | 06/02/18 | S96 - DRAFTS | AL |
| | В | 22/02/18 | SUBMISSION | AL |
| | | | | |
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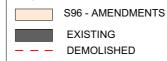
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LEGEND

CLIENT

ANDREW & ANNA McDONALD

PROJECT ADDRESS

31 ROBERT ST, FRESHWATER NSW 2096

DRAWING NO.


S96-01


DATE26 February 2018

SITE / ROOF / SEDIMENT EROSION / WASTE MANAGEMENT / STORMWATER CONCEPT PLAN

SCALE

1:200 @A3

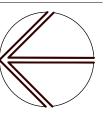

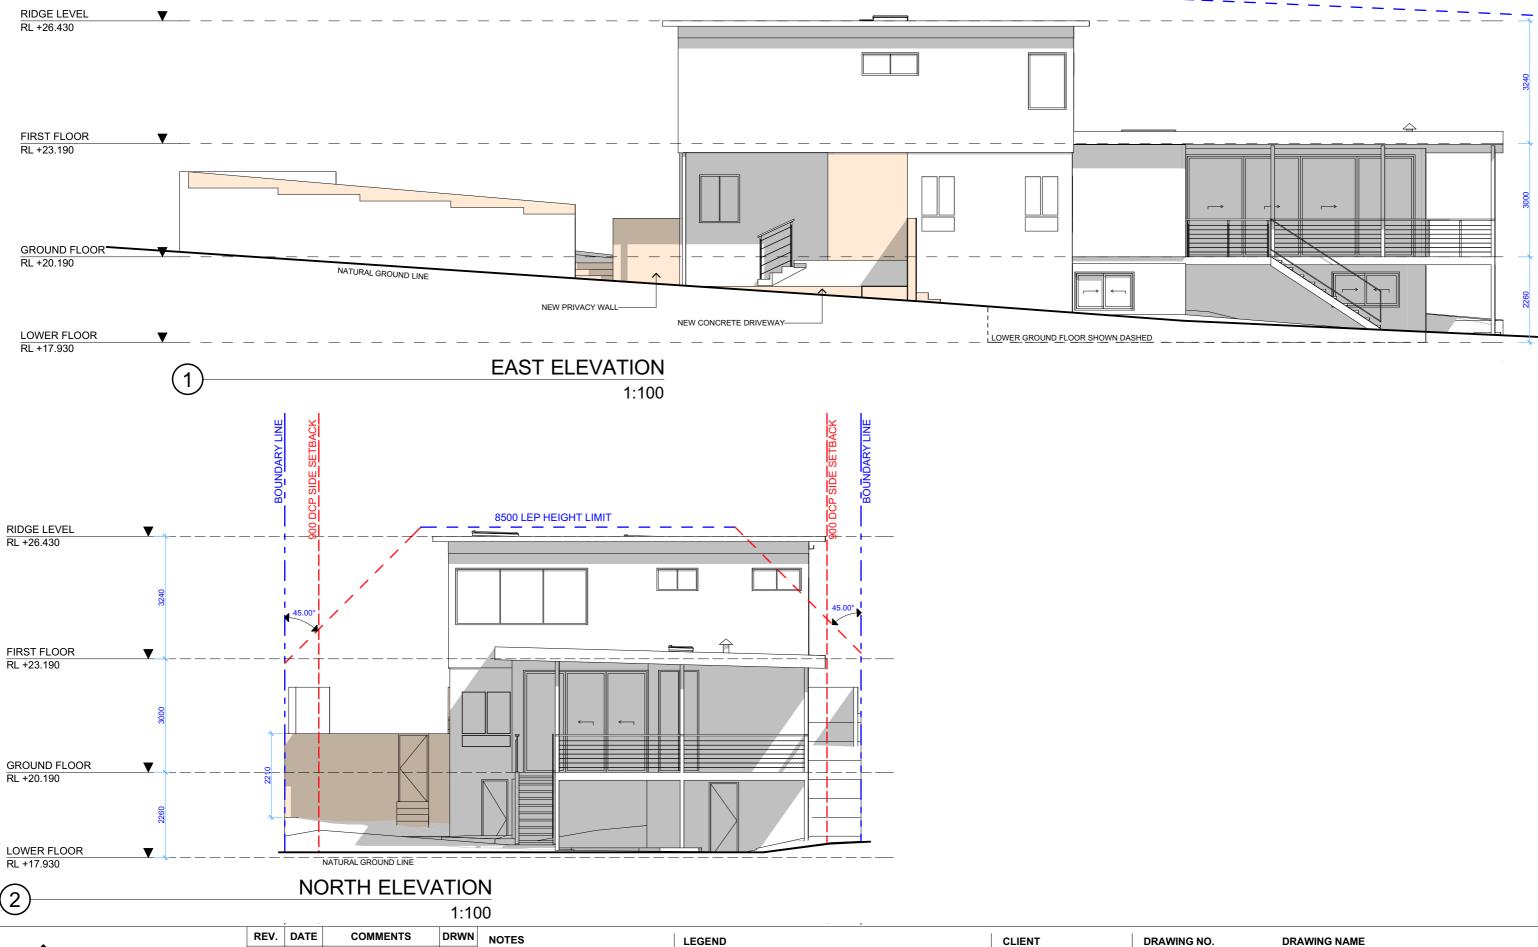

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S96 - DRAFTS 06/02/18 22/02/18

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| | S96 - AMENDMENTS | |
|----------|------------------|--|
| | EXISTING | |
| - | DEMOLISHED | |

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2096


S96-07

DATE

NORTH / EAST ELEVATION

26 February 2018

SCALE 1:100 @A3

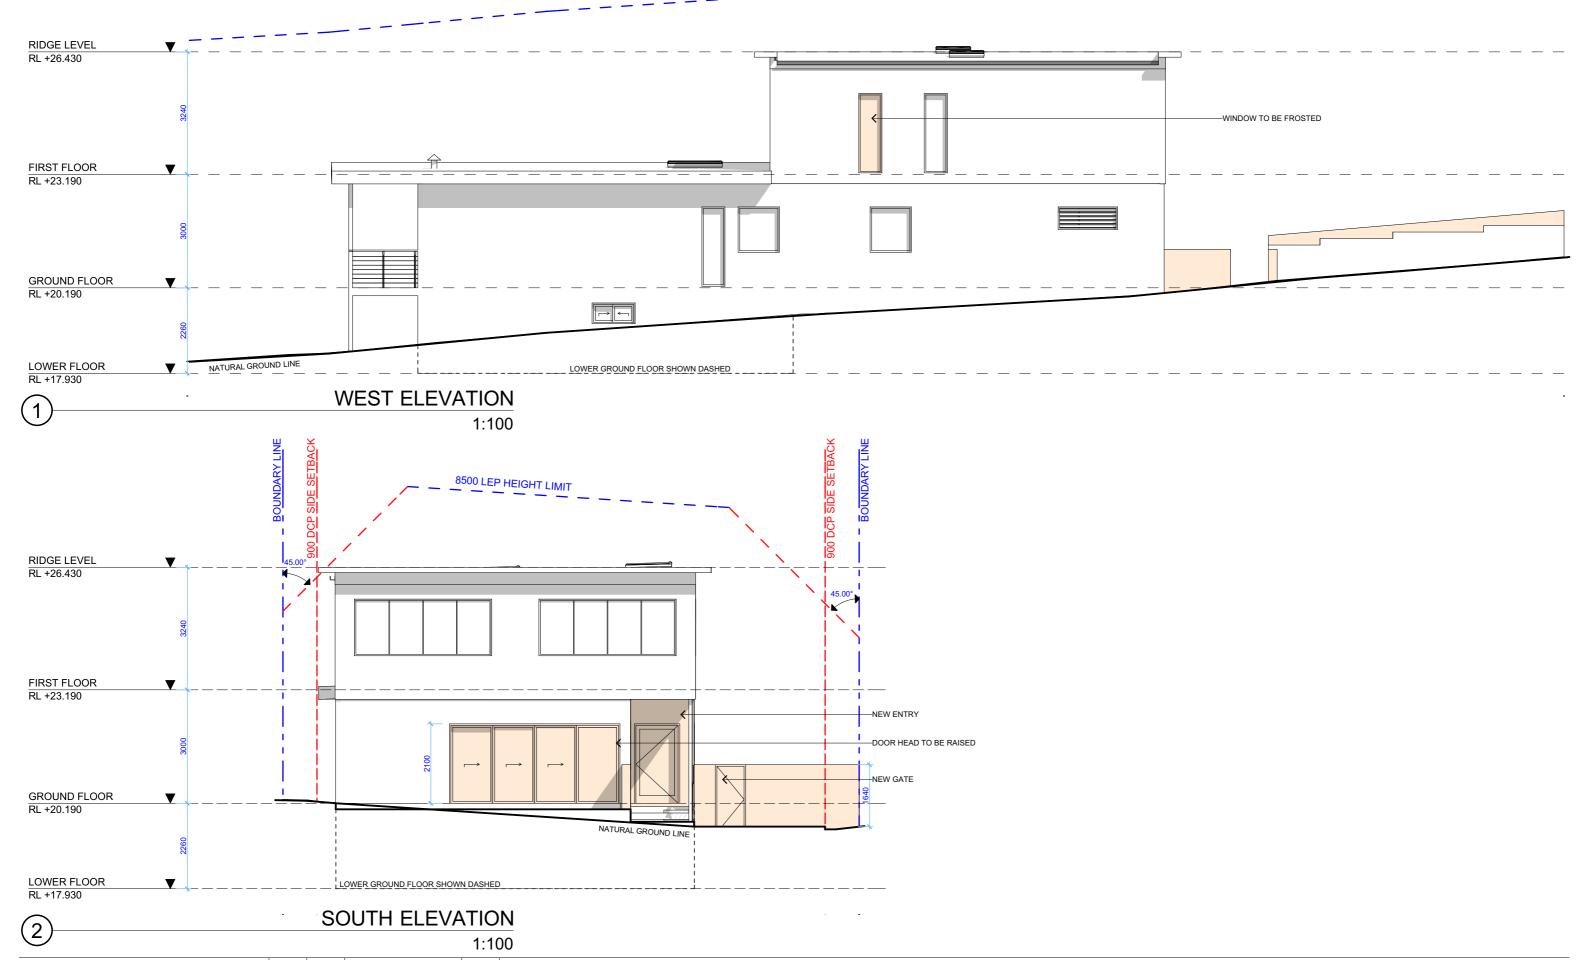



| | REV. | DATE | COMMENTS | DRWN |
|---|------|----------|--------------|------|
| S | А | 06/02/18 | S96 - DRAFTS | AL |
| | В | 22/02/18 | SUBMISSION | AL |
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| LEGEND | |
|--------|------------------|
| | S96 - AMENDMENTS |
| | EXISTING |
| | DEMOLISHED |
| | |

| CLIENT |
|---------------------------|
| ANDREW & ANNA McDONALD |

FRESHWATER NSW

2096

S96-08 PROJECT ADDRESS 31 ROBERT ST,

| DATE |
|------------------|
| 26 February 2018 |

DRAWING NO.

DRAWING NAME SOUTH / WEST ELEVATION


SCALE 1:100 @A3

2.40 m² 0.92 m² CONCRETE SURFACE 215.18 m² 9.89 m² LANDSCAPED AREA 154.24 m² POOL 42.31 m² LANDSCAPED AREA 33.89 m² 4.17 m² AREA CALCULATIONS PROPOSED

1:200

AREA CALCULATIONS

| ZONE | REQUIRED | % | AREA (m²) |
|---------------------|----------|--------|----------------------|
| SITE AREA | - | - | 687.5m ² |
| BUILDING FOOT PRINT | - | 21.17% | 145.58m² |
| HARD SURFACE | - | 34.4% | 236.54m² |
| PERMEABLE SURFACE | % | 42% | 289.48m² |
| LANDSCAPED AREA | 40% | 35% | 242.56m ² |
| | | | |

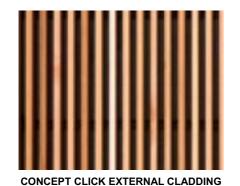







ALUMINIUN FRAMED WINDOWS BY STEGBAR

FIXED SKYLIGHT WINDOWS **BY VELUX**

KLIP-LOK ROOFING -COLOUR TO BE CONFIRMED BY CLIENT

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|--|
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| S | А | 06/02/18 | S96 - DRAFTS | AL |
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LEGEND

CLIENT

ANDREW & ANNA McDONALD

PROJECT ADDRESS

31 ROBERT ST, FRESHWATER NSW 2096

DRAWING NO.

S96-10

DATE

26 February 2018

AREA CALCULATIONS / SAMPLE BOARD

DRAWING NAME

SCALE 1:200, 1:1 @A3





Building Sustainability Index www.basix.nsw.gov.au

Alterations and Additions

Certificate number: A298115_03

This certificate confirms that the proposed development will meet the NSW government's requirements for sustainability, if it is built in accordance with the commitments set out below. Terms used in this certificate, or in the commitments, have the meaning given by the document entitled "BASIX Alterations and Additions Definitions" dated 06/10/2017 published by Planning & Infrastructure. This document is available at www.basix.nsw.gov.au

Director-General
Date of issue: Monday, 26, February 2018
To be valid, this certificate must be lodged within 3 months of the date of issue.



| Project name | 278_ANDREW & ANNA McDONALD _03 |
|---------------------------------|--|
| Street address | 31 Robert Street Freshwater 2096 |
| Local Government Area | Warringah Council |
| Plan type and number | Deposited Plan 12072 |
| Lot number | 29 |
| Section number | 0 |
| Project type | |
| Dwelling type | Separate dwelling house |
| Type of alteration and addition | My renovation work is valued at \$50,000 or mor and does not include a pool (and/or spa). |

| Certificate Prepared by (please complete before submitting to Council or PCA) |
|---|
| Name / Company Name: Action Plans |
| ABN (if applicable): 17118297587 |

| Fixtures and systems | Show on DA Plans | Show on CC/CDC Plans & specs | Certifier Check |
|--|---------------------|---------------------------------------|--------------------|
| Lighting | | | |
| The applicant must ensure a minimum of 40% of new or altered light fixtures are fitted with fluorescent, compact fluorescent, or light-emitting-diode (LED) lamps. | | V | ✓ |
| Fixtures | • | | • |
| The applicant must ensure new or altered showerheads have a flow rate no greater than 9 litres per minute or a 3 star water rating. | | V | ✓ |
| The applicant must ensure new or altered toilets have a flow rate no greater than 4 litres per average flush or a minimum 3 star water rating. | | ✓ | ✓ |
| The applicant must ensure new or altered taps have a flow rate no greater than 9 litres per minute or minimum 3 star water rating. | | ~ | |

| | g | | | * | |
|---|---|--|---------------------|---------------------------------------|--------------------|
| | | | | | |
| Construction | | | Show on DA Plans | Show on CC/CDC Plans & specs | Certifier Check |
| nsulation requirements | | | | | |
| | ation is not required where the area of new con | s) in accordance with the specifications listed in struction is less than 2m2, b) insulation specified | · | V | ✓ |
| Construction | Additional insulation required (R-value) | Other specifications | | | |
| suspended floor with enclosed subfloor: framed (R0.7). | R0.60 (down) (or R1.30 including construction) | | | | |
| floor above existing dwelling or building. | nil | | | | |
| external wall: framed (weatherboard, fibro, metal clad) | R1.30 (or R1.70 including construction) | | | | |
| external wall: framed (weatherboard, fibro, metal clad) | R1.30 (or R1.70 including construction) | | | | |
| | | | | 1 | |

| Glazing red | quirements | | | | | | Show on DA Plans | Show on CC/CDC Plans & specs | Certifier Check |
|--------------------------------|------------------------------------|-------------------------|--------------------------|----------------------------|--|--|---------------------|---------------------------------------|--------------------|
| Vindows a | nd glazed do | ors | | | | | | | |
| | | | | | hading devices, in accordance with r each window and glazed door. | the specifications listed in the table below. | ~ | ✓ | ~ |
| The following | requirements | must also | be satisfi | ed in relatio | n to each window and glazed door: | | | ✓ | ✓ |
| have a U-vali | ue and a Solar | Heat Gair | Coefficie | ent (SHGC) | | d glass may either match the description, or, le below. Total system U-values and SHGCs | | ~ | ~ |
| have a U-vali must be calci | ue and a Solar ulated in accord | Heat Gair dance with | n Coefficie n Nationa | ent (SHGC) Fenestration | no greater than that listed in the tab | ar glazing, or toned/air gap/clear glazing must le below. Total system U-values and SHGCs s. The description is provided for information | | ~ | ~ |
| | | | | | of each eave, pergola, verandah, bal than 2400 mm above the sill. | cony or awning must be no more than 500 mm | ✓ | ✓ | ✓ |
| Pergolas with | polycarbonate | e roof or s | imilar trar | slucent mat | erial must have a shading coefficier | t of less than 0.35. | | ✓ | V |
| | | | | | e window or glazed door above whi ens must not be more than 50 mm. | ch they are situated, unless the pergola also | | ✓ | ✓ |
| | adjustable shi in plan view. | ading may | have ad | ustable blad | des or removable shade cloth (not le | ess than 80% shading ratio). Adjustable blades | | ✓ | ✓ |
| Windows | and glazed | doors g | lazing r | equireme | ents | | 1 | | |
| | or Orientation | | | | Shading device | Frame and glass type | | | |
| W01 | N | 2.86 | 0 | 0 | eave/verandah/pergola/balcony >=450 mm | standard aluminium, single pyrolytic low-e, (U-value: 5.7, SHGC: 0.47) | | | |
| W02 | N | 2.1 | 0 | 0 | eave/verandah/pergola/balcony >=450 mm | standard aluminium, single pyrolytic low-e, (U-value: 5.7, SHGC: 0.47) | | | |

| Glazing requi | irements | | | | | | Show on DA Plans | Show on CC/CDC Plans & specs | Certifier Check |
|----------------------|-------------|-----------------------|---------------|-----------------|---|---|---------------------|---------------------------------------|--------------------|
| Window / door no. | Orientation | Area of glass | Oversha | <u> </u> | Shading device | Frame and glass type | | | |
| | | inc. frame (m2) | Height (m) | Distance (m) | | | | | |
| W03 | E | 1.34 | 0 | 0 | eave/verandah/pergola/balcony >=450 mm | standard aluminium, single pyrolytic low-e, (U-value: 5.7, SHGC: 0.47) | | | |
| W04 | S | 0.94 | 0 | 0 | eave/verandah/pergola/balcony >=450 mm | standard aluminium, single pyrolytic low-e, (U-value: 5.7, SHGC: 0.47) | | | |
| W05 | S | 1.3 | 0 | 0 | eave/verandah/pergola/balcony >=450 mm | standard aluminium, single pyrolytic low-e, (U-value: 5.7, SHGC: 0.47) | | | |
| W06 | S | 1.3 | 0 | 0 | eave/verandah/pergola/balcony >=450 mm | standard aluminium, single pyrolytic low-e, (U-value: 5.7, SHGC: 0.47) | | | |
| W07 | S | 1.28 | 0 | 0 | eave/verandah/pergola/balcony >=450 mm | standard aluminium, single pyrolytic low-e, (U-value: 5.7, SHGC: 0.47) | | | |
| W08 | N | 0.78 | 0 | 0 | eave/verandah/pergola/balcony >=450 mm | standard aluminium, single pyrolytic low-e, (U-value: 5.7, SHGC: 0.47) | | | |
| W09 | N | 0.65 | 0 | 0 | eave/verandah/pergola/balcony >=450 mm | standard aluminium, single pyrolytic low-e, (U-value: 5.7, SHGC: 0.47) | | | |
| W10 | N | 5.23 | 0 | 0 | eave/verandah/pergola/balcony >=450 mm | standard aluminium, single pyrolytic low-e, (U-value: 5.7, SHGC: 0.47) | | | |
| W11 | E | 1.5 | 0 | 0 | eave/verandah/pergola/balcony >=450 mm | standard aluminium, single pyrolytic low-e, (U-value: 5.7, SHGC: 0.47) | | | |
| W12 | E | 0.9 | 0 | 0 | eave/verandah/pergola/balcony >=450 mm | standard aluminium, single pyrolytic low-e, (U-value: 5.7, SHGC: 0.47) | | | |
| W13 | S | 5.44 | 0 | 0 | eave/verandah/pergola/balcony >=450 mm | standard aluminium, single pyrolytic low-e, (U-value: 5.7, SHGC: 0.47) | | | |
| W14 | S | 5.44 | 0 | 0 | eave/verandah/pergola/balcony >=450 mm | standard aluminium, single pyrolytic low-e, (U-value: 5.7, SHGC: 0.47) | | | |
| W15 | w | 1.28 | 0 | 0 | eave/verandah/pergola/balcony >=450 mm | standard aluminium, single pyrolytic low-e, (U-value: 5.7, SHGC: 0.47) | | | |

| Glazing re | equirements | | | | | | | Show on DA Plans | Show on CC/CDC Plans & specs | Certifier Check |
|------------------------------|------------------------|---|--------------------------|-----------------|----------------------------------|----------------------------|---|---------------------|---------------------------------------|--------------------|
| Window / do | oor Orientation | Area of glass inc. frame (m2) | Oversha Height (m) | Distance (m) | Shading device | | Frame and glass type | | | |
| D01 | E | 16.39 | 0 | 0 | awning (fixed) >=900 | mm | standard aluminium, single pyrolytic low-e, (U-value: 5.7, SHGC: 0.47) | | | |
| D02 | N | 8.91 | 0 | 0 | awning (fixed) >=900 | mm | standard aluminium, single pyrolytic low-e, (U-value: 5.7, SHGC: 0.47) | | | |
| D03 | S | 9.47 | 0 | 0 | pergola (adjustable sh mm | nade) >=900 | standard aluminium, single pyrolytic low-e, (U-value: 5.7, SHGC: 0.47) | | | |
| D04 | S | 2.52 | 0 | 0 | eave/verandah/pergol >=450 mm | | standard aluminium, single clear, (or U-value: 7.63, SHGC: 0.75) | | | |
| W16 | W | 1.281 | 0 | 0 | eave/verandah/pergol >=450 mm | | standard aluminium, single toned, (or U-value: 7.57, SHGC: 0.57) | | | |
| Skylights | | | | | | | | | | |
| The applicar | nt must install th | ne skylight | s in accor | dance with t | he specifications listed in | n the table be | elow. | ✓ | ✓ | ✓ |
| The followin | g requirements | must also | be satisfi | ed in relation | n to each skylight: | | | | ✓ | ✓ |
| Each skyligh the table be | | atch the de | escription, | or, have a l | U-value and a Solar Hea | t Gain Coeffi | cient (SHGC) no greater than that listed in | | ✓ | ✓ |
| External aw | nings and louvr | es must fu | lly shade | the skylight | above which they are sit | tuated when | fully drawn or closed. | | ✓ | ✓ |
| Skylights | glazing req | uiremen | ts | | | | | 1 | | |
| Skylight nur | mber Area of inc. fran | | Shading | device | | Frame and | glass type | | | |
| S1 | 1.02 | | external | adjustable a | awning or blind | aluminium, r 6.21, SHGC | noulded plastic single clear, (or U-value: : 0.808) | | | |
| S2 | 0.84 | | external | adjustable a | awning or blind | aluminium, r | noulded plastic single clear, (or U-value: | | | |

| Glazing require | ements | | | Show on DA Plans | Show on CC/CDC Plans & specs | Certifier Check |
|-----------------|---------------------------------|-------------------------------------|--|---------------------|---------------------------------------|--------------------|
| Skylight number | Area of glazing inc. frame (m2) | Shading device | Frame and glass type | | | |
| S3 | 1.02 | external adjustable awning or blind | aluminium, moulded plastic single clear, (or U-value: 6.21, SHGC: 0.808) | | | |

| Legend |
|---|
| In these commitments, "applicant" means the person carrying out the development. |
| Commitments identified with a "\sigma" in the "Show on DA plans" column must be shown on the plans accompanying the development application for the proposed development (if a development application is to be lodged for the proposed development). |
| Commitments identified with a "\"" in the "Show on CC/CDC plans & specs" column must be shown in the plans and specifications accompanying the application for a construction certificate / complying development certificate for the proposed development. |
| Commitments identified with a "\sqrt^" in the "Certifier check" column must be certified by a certifying authority as having been fulfilled, before a final occupation certificate for the development may be issued. |

| ACTION PLANS |
|---|
| m: 0403957518 e:design@actionplans.com.au w: www.actionplans.com.au |

| REV. | DATE | COMMENTS | DRWN |
|------|----------|--------------|------|
| А | 06/02/18 | S96 - DRAFTS | AL |
| В | 22/02/18 | SUBMISSION | AL |
| | | | |
| | | | |
| | | | |

NOTES

LEGEND

This drawing is the copyright of Action Plans and not be altered, reproduced or transmitted in any form or by any means in part or in whole with the written permission of Action Plans.

All levels and dimensions are to be checked and verified on site prior to commencement of any work, making of shop drawings or fabrication of components.

Do no scale on drawings. Use figured dimensions.

CLIENT ANDREW & ANNA McDONALD

> PROJECT ADDRESS 31 ROBERT ST, FRESHWATER NSW

2096

DRAWING NO.

S96-14

DATE 26 February 2018 DRAWING NAME BASIX COMMITMENTS

SCALE 1:2.04 @A3