


private residence

21 dresden ave, beacon hill


alterations & additions development application architectural perspectives

WINDOWS WHITE or similar to match existing

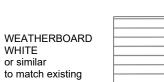








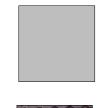



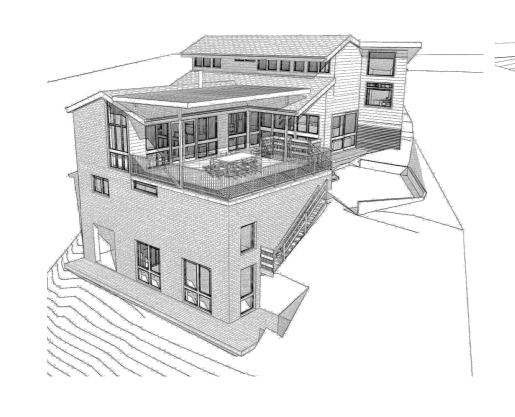

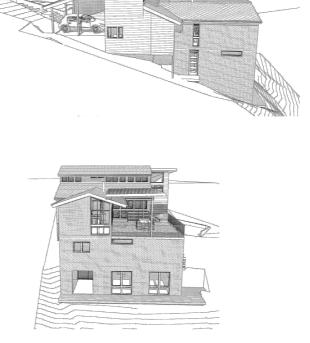

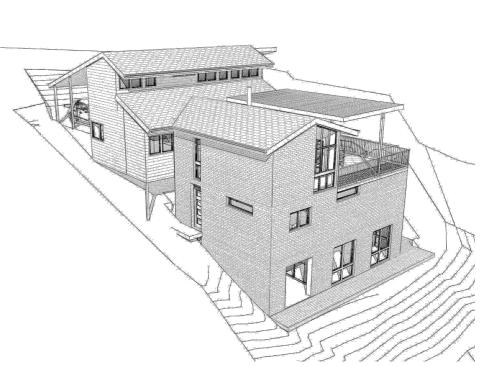

NOTE:

BOUNDARIES HAVE BEEN DETERMINED BY SURVEY ON $05/06/20\,$.

PRIOR TO ANY CONSTRUCTION WORK, SURVEY MARKS SHOULD BE PLACE TO DEFINE THE PROPERTY BOUNDARIES.

SERVICES SHOWN ARE INDICATIVE ONLY. POSITIONS ARE BASED ON SURFACE INDICATOR(S) LOCATED DURING FIELD SURVEY. CONFIRMATION OF THE EXACT POSITION SHOULD BE MADE PRIOR TO ANY EXCAVATION WORK. OTHER SERVICES MAY EXIST WHICH ARE NOT SHOWN.

LEVELS ARE BASED ON AUSTRALIAN HEIGHT DATUM (AHD) USING SSM 701 WITH RL 116.124 (AHD).

RIDGE & GUTTER HEIGHTS HAVE BEEN OBTAINED BY INDIRECT METHOD AND ARE ACCURATE TO ± 0.05m.

CONTOURS SHOWN DEPICT THE TOPOGRAPHY. EXCEPT AT SPOT LEVELS SHOWN THEY DO NOT REPRESENT THE EXACT LEVEL AT ANY PARTICULAR POINT. THE SPOT LEVELS ARE TRUE FOR THEIR POSITION, AND ARE INTENDED TO BE USEFUL TO REPRESENT THE GENERAL TERRAIN. CARE SHOULD BE TAKEN IF EXTRAPOLATING.

J722525 COVENANT





LEGEND

SEWER INSPECTION PIT SIP

P PP

 \oplus SEWER

MH

(S) SMH

X SV

■ HYD

₩ WM

[6]

BENCH MARK

TELSTRA PIT ELECTRIC LIGHT POLE POWER POLE

MANHOLE

STOP VALVE

SEWER MANHOLE

WATER HYDRANT

WATER METER

GAS METER

TSS TOTAL SURVEYING SOLUTIONS


LANE COVE | CAMDEN | MANLY VALE | CENTRAL COAST

INFORMATION CONTAINED IN THIS PLAN
IS THE COPYRIGHT OF TOTAL SURVEYING
SOLUTIONS. THE USE OR DUPLICATION
WITHOUT THE WRITTEN CONSENT OF TOTAL
SURVEYING SOLUTIONS CONSTITUTES AN
INFRINGEMENT OF COPYRIGHT


	REVISION No.	REVISION DATE:	COMMENT:	LEGEND:
S PLAN RVFYING				EB - EDGE OF BITUMEN FC - EDGE OF CONCRETE
ATION				TB - TOP OF BANK
T OF TOTAL TUTES AN				BB - BOTTOM OF BANK TW - TOP OF WINDOW
.0.207.11				BW - BOTTOM OF WINDOW

REVISION No. | REVISION DATE: | COMMENT


TG - TOP OF GUTTER
RR - ROOF RIDGE
FL - FLOOR LEVEL
INV - INVERT LEVEL
ELEC - ELECTRICAL PIT
ØAIS10/H16 - DIAMETER/SPREAD/HEIGHT

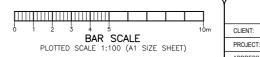



		PLAN SHOWING DETAIL & LEVELS	JOB No.:	200871	LGA:NORTHERN BEACHE
		OVER LOT 16 IN DP 217849	PLAN No	.: 200871-1	DATUM: AHD
	CLIENT:	LOUISE HANSON	DATE:	09/06/2020	SCALE: 1:100@A1
	PROJECT:	BEACON HILL	DRAWN:	FS	CONT. INTERVAL: 0.25m
_	ADDRESS:	21 DRESDEN AVENUE, BEACON HILL	CHK:	MR	SHEET 1 OF 1

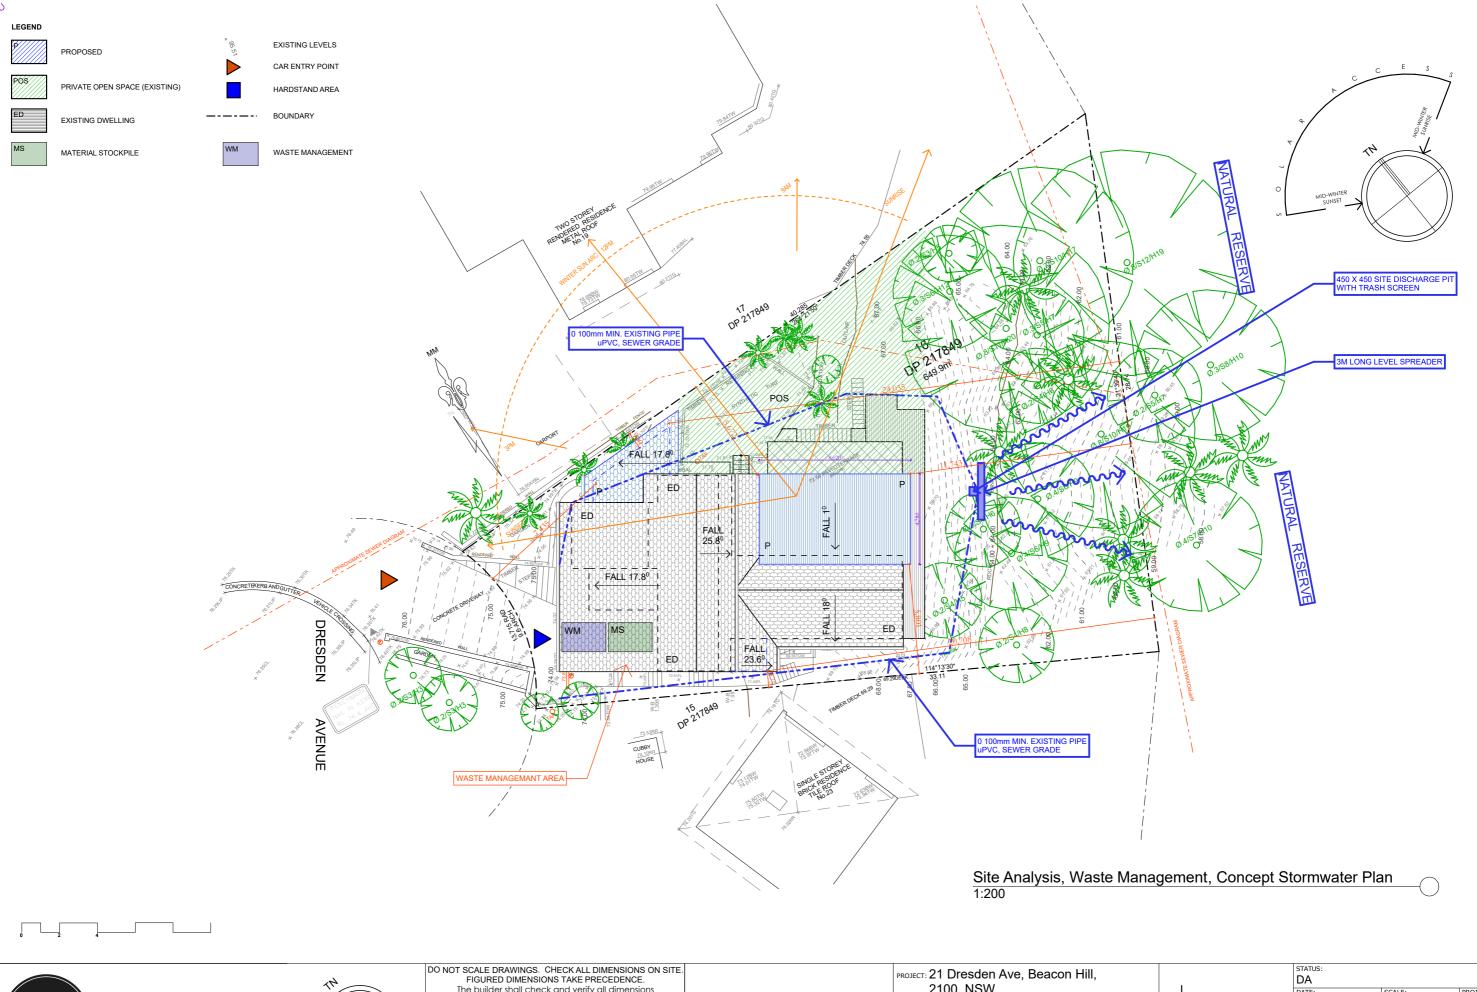





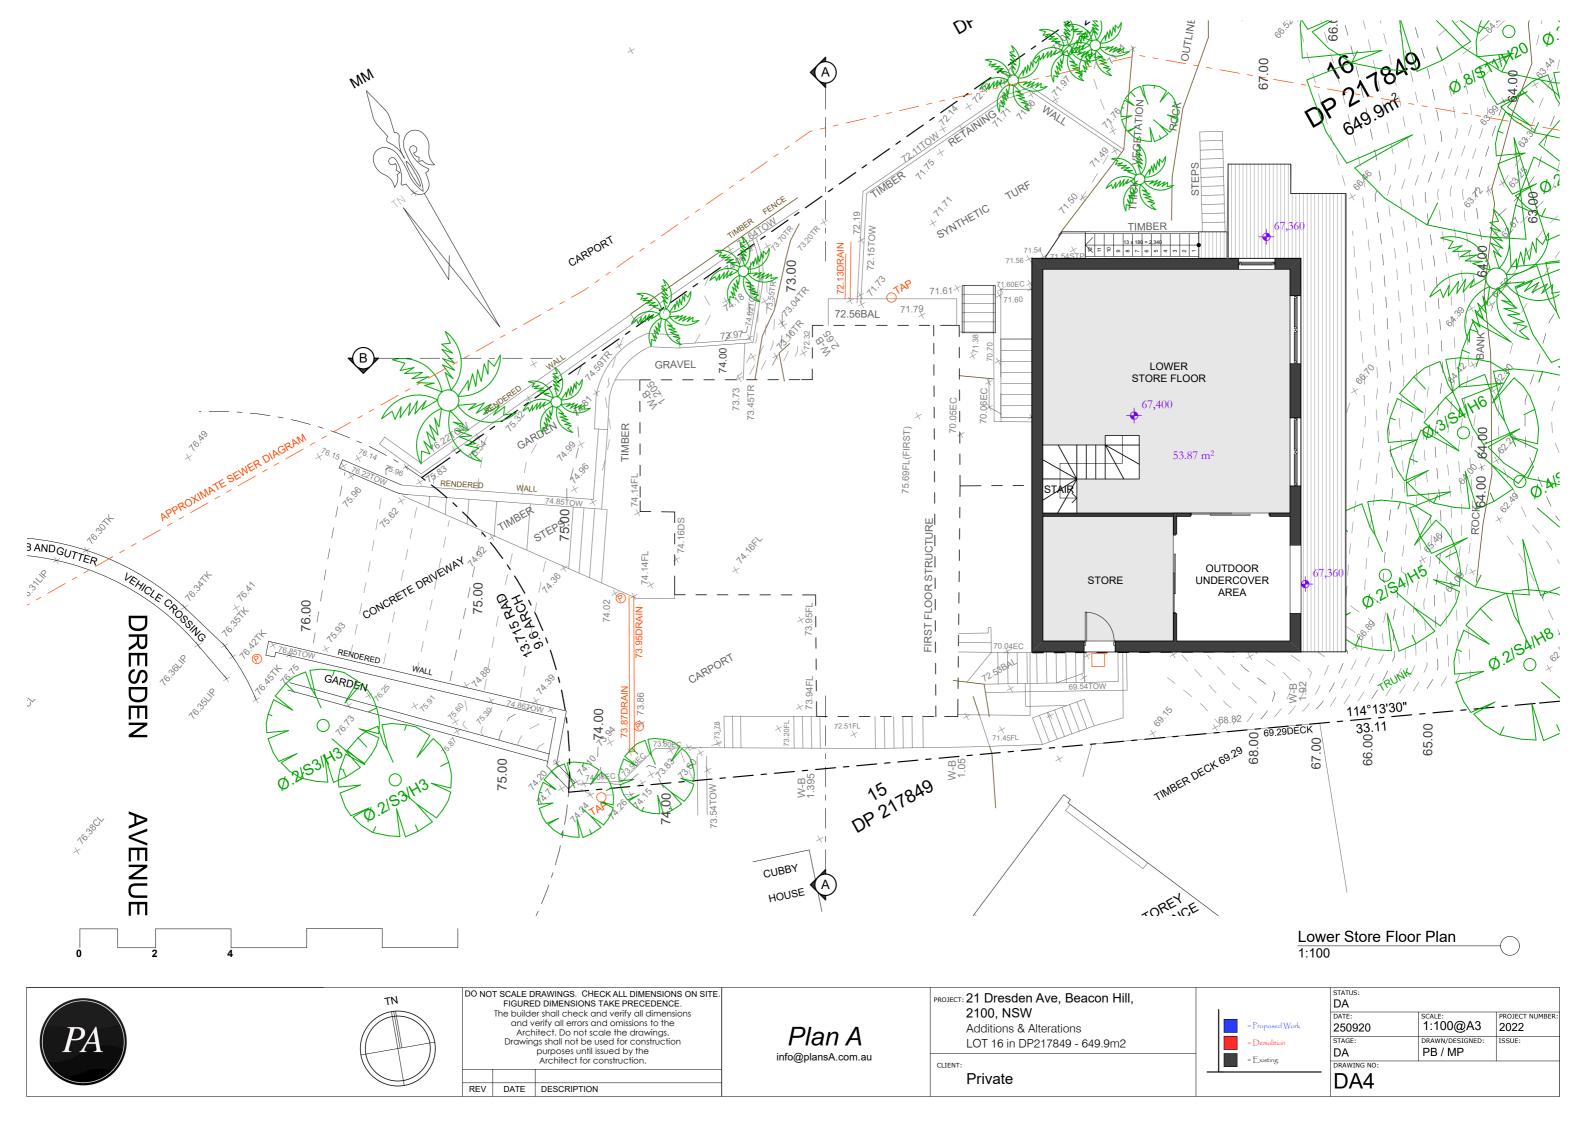


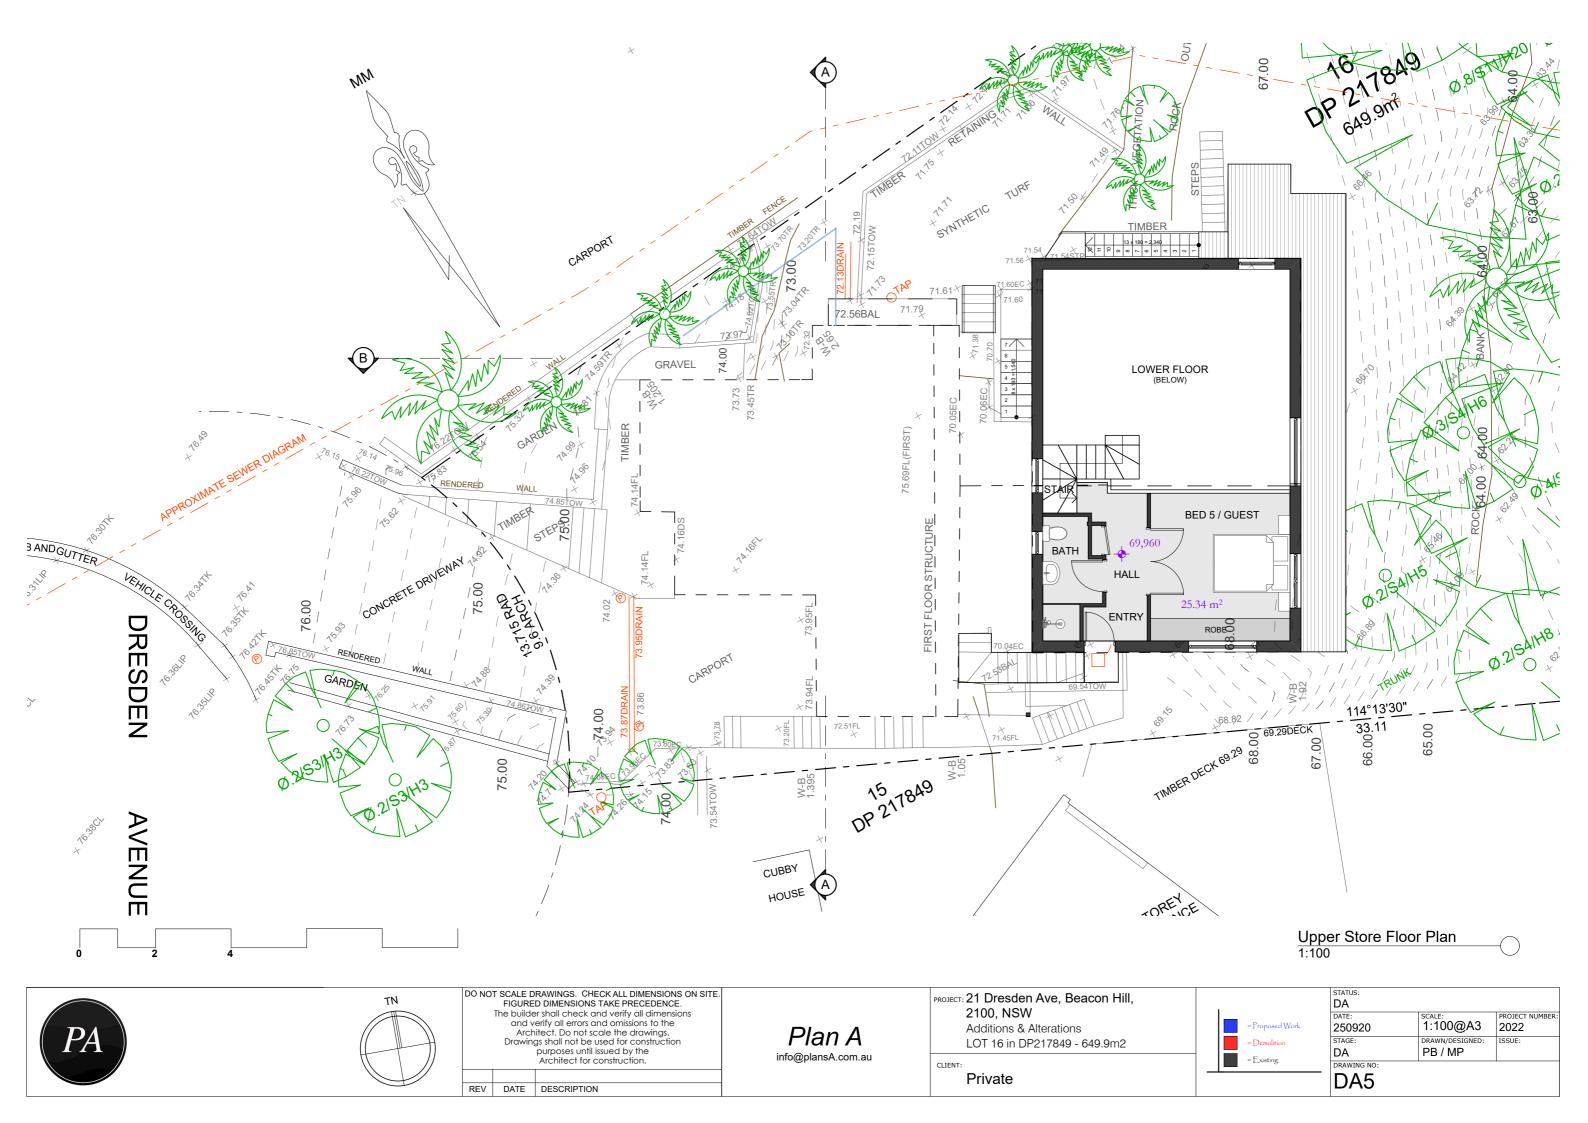

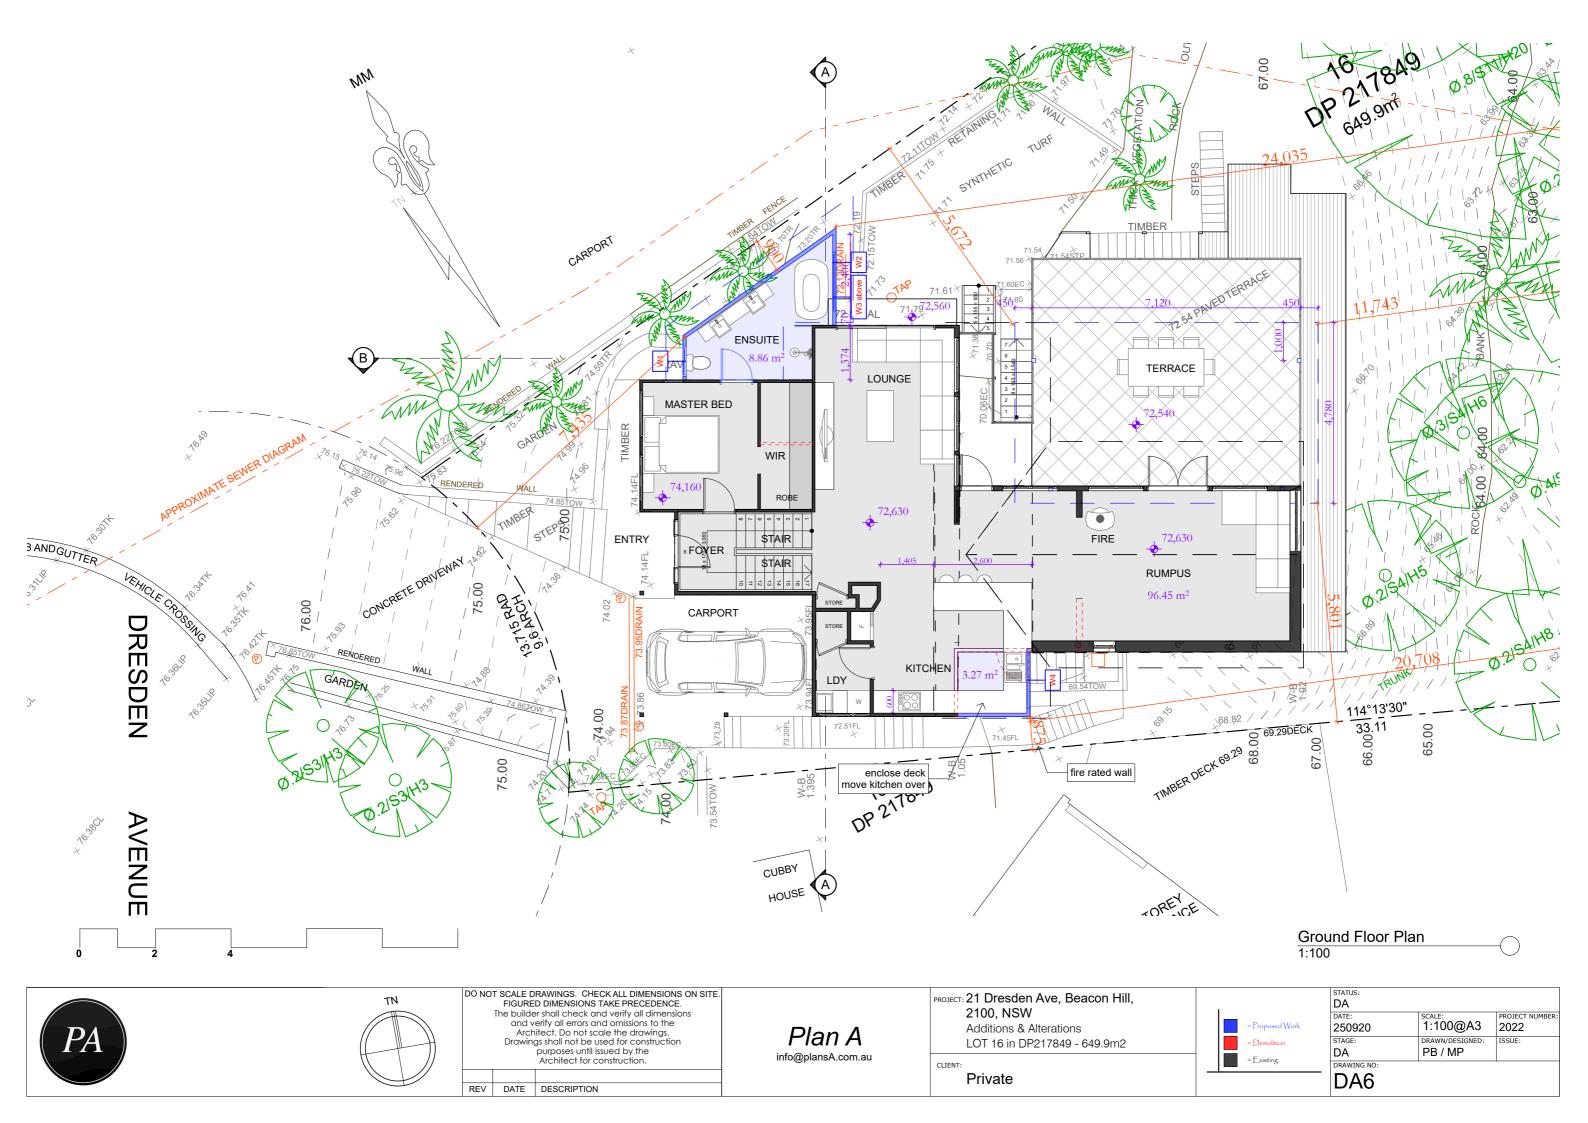

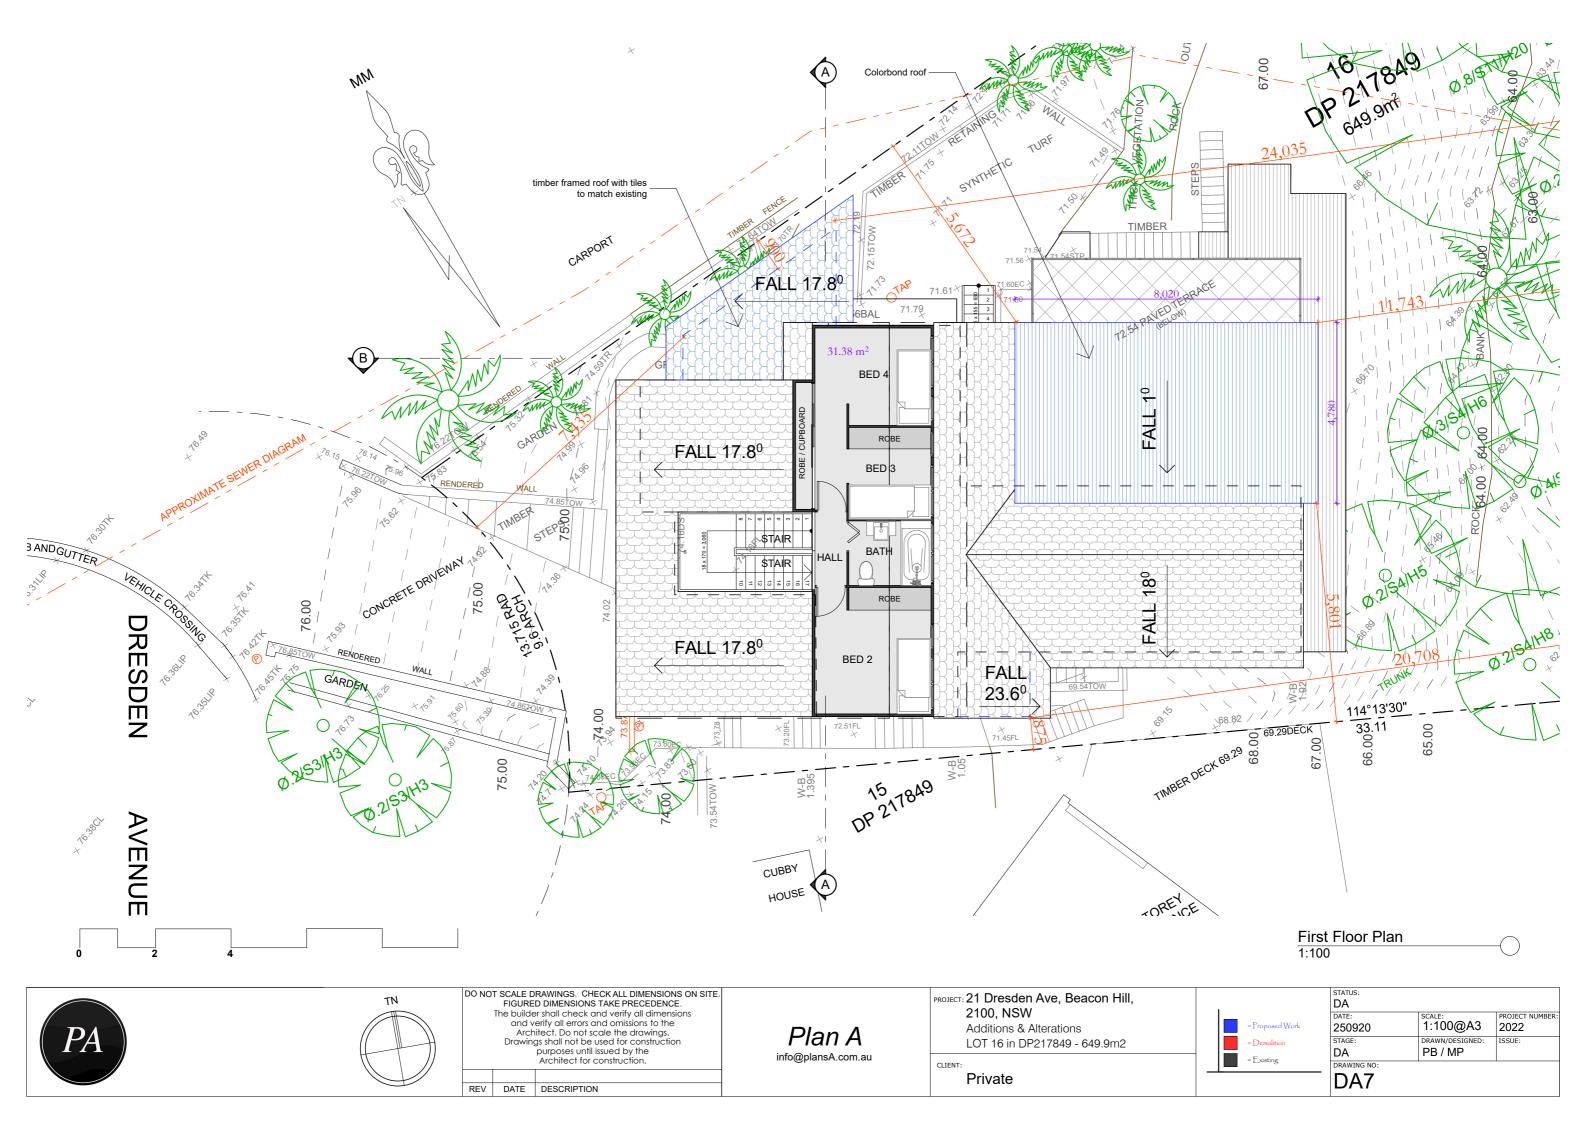

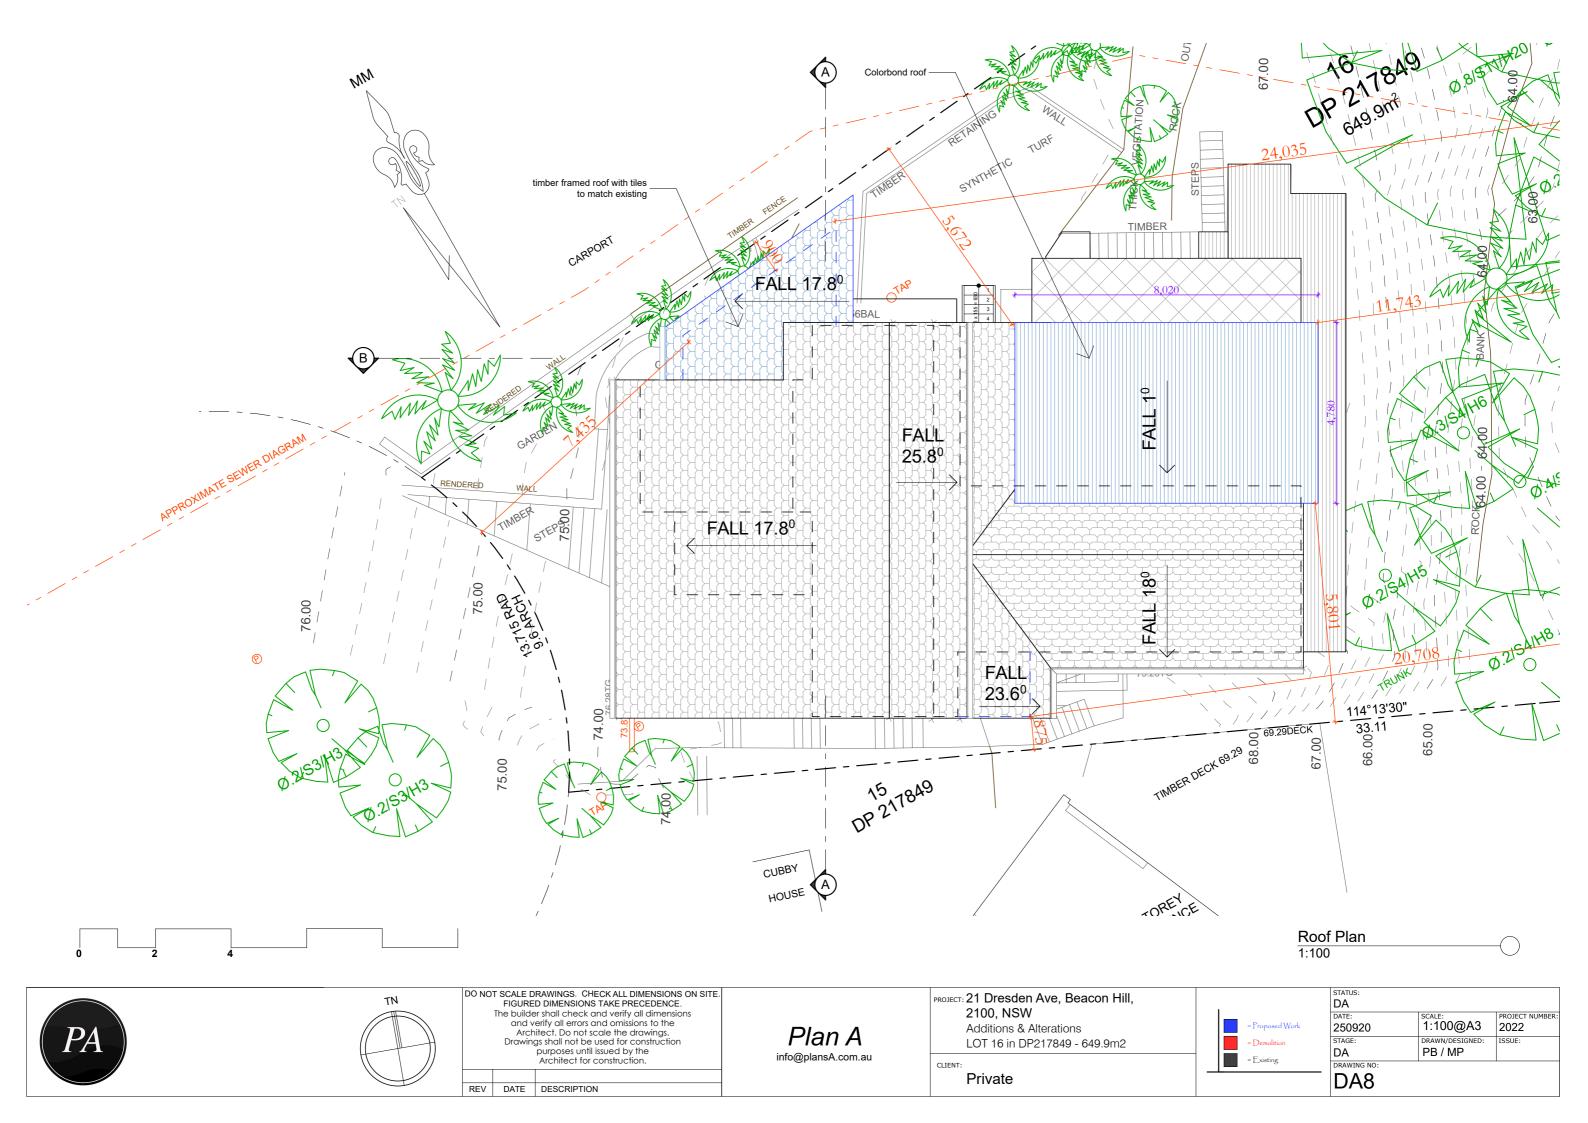

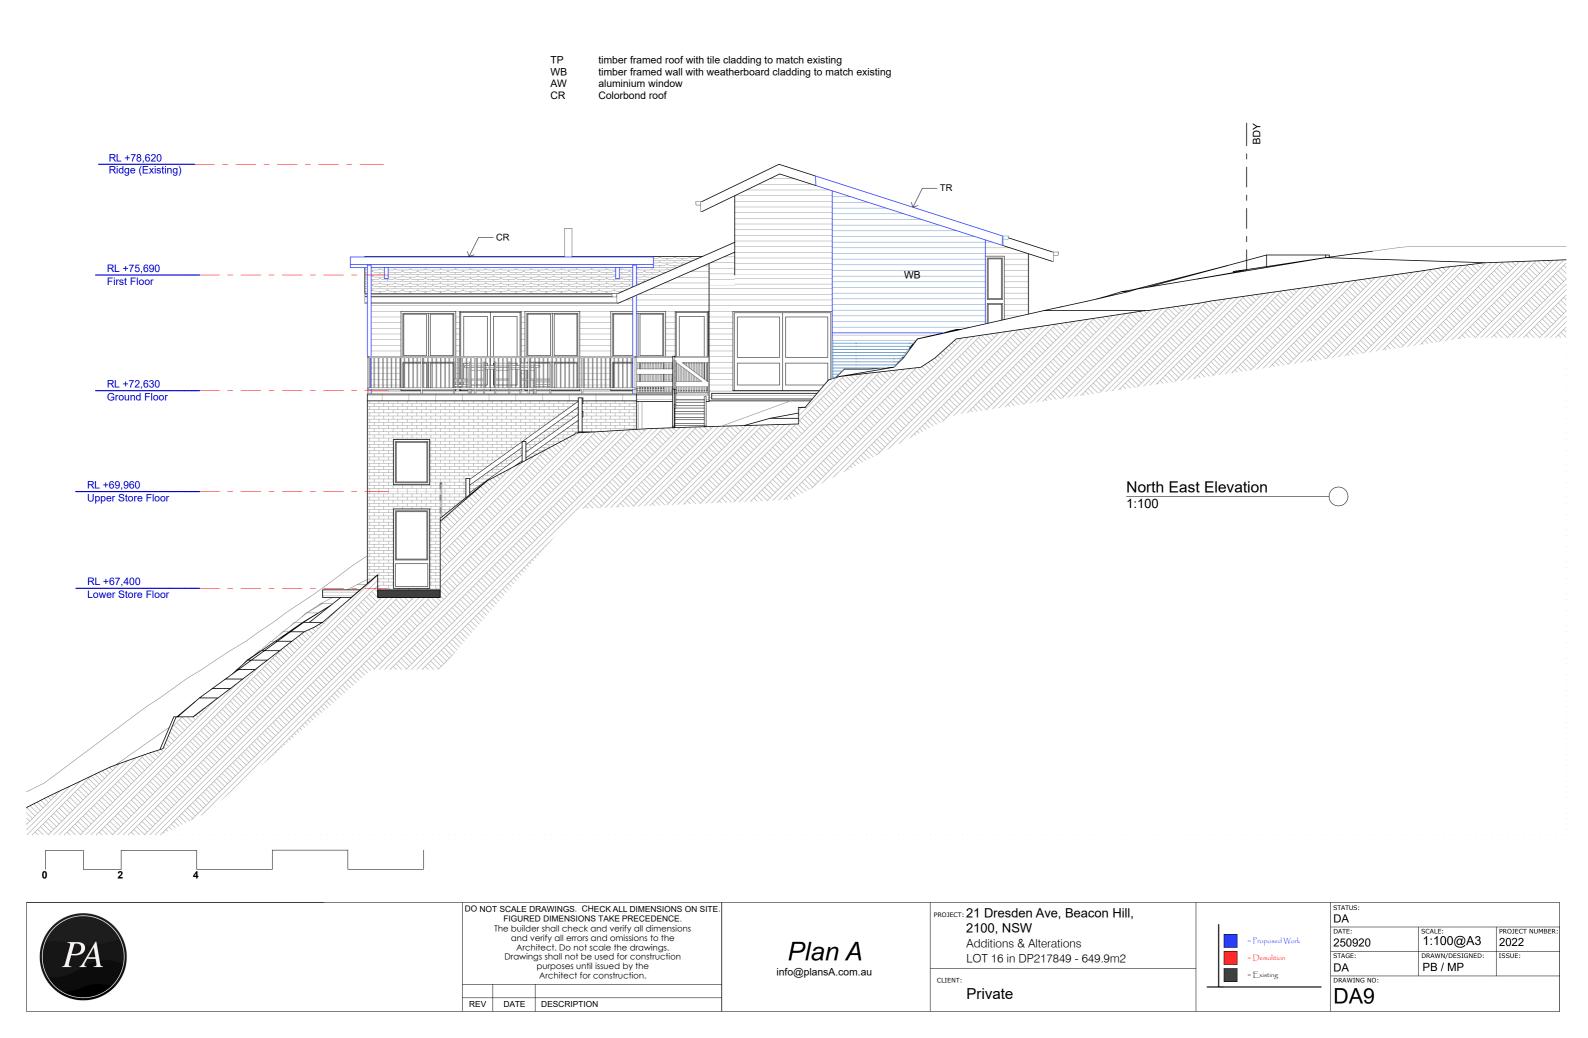

AW CR Colorbond roof RL +78,620 Ridge (Existing) RL +75,690 First Floor WB (fire rated wall) RL +72,630 Ground Floor RL +69,960 Upper Store Floor RL +67,400 Lower Store Floor South West Elevation 1:100 DO NOT SCALE DRAWINGS. CHECK ALL DIMENSIONS ON SITE.
FIGURED DIMENSIONS TAKE PRECEDENCE.
The builder shall check and verify all dimensions
and verify all errors and omissions to the
Architect. Do not scale the drawings.
Drawings shall not be used for construction
purposes until issued by the
Architect for construction. STATUS: PROJECT: 21 Dresden Ave, Beacon Hill, 2100, NSW SCALE: PROJECT NUMBER: 2022 Additions & Alterations 250920 Plan A DRAWN/DESIGNED: = Demolition LOT 16 in DP217849 - 649.9m2 DA info@plansA.com.au DRAWING NO:


DA10 CLIENT: Private REV DATE DESCRIPTION

timber framed roof with tile cladding to match existing

timber framed wall with weatherboard cladding to match existing

WB

TP timber framed roof with tile cladding to match existing
WB timber framed wall with weatherboard cladding to match existing
AW aluminium window
CR Colorbond roof

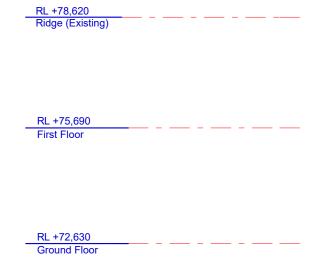







timber framed roof with tile cladding to match existing timber framed wall with weatherboard cladding to match existing aluminium window WB AW CR Colorbond roof RL +78,620 Ridge (Existing) RL +75,690 First Floor AW WB AW WB (fire rated wall) RL +72,630 Ground Floor RL +69,960 Upper Store Floor BDY RL +67,400 Lower Store Floor South East Elevation 1:100 DO NOT SCALE DRAWINGS. CHECK ALL DIMENSIONS ON SITE.
FIGURED DIMENSIONS TAKE PRECEDENCE.
The builder shall check and verify all dimensions
and verify all errors and omissions to the
Architect. Do not scale the drawings.
Drawings shall not be used for construction
purposes until issued by the
Architect for construction. PROJECT: 21 Dresden Ave, Beacon Hill, DA 2100, NSW SCALE: PROJECT NUMBER: 2022 Additions & Alterations 250920 Plan A DRAWN/DESIGNED: LOT 16 in DP217849 - 649.9m2 = Demolition STAGE: DA info@plansA.com.au DRAWING NO:
DA12 CLIENT: Private REV DATE DESCRIPTION





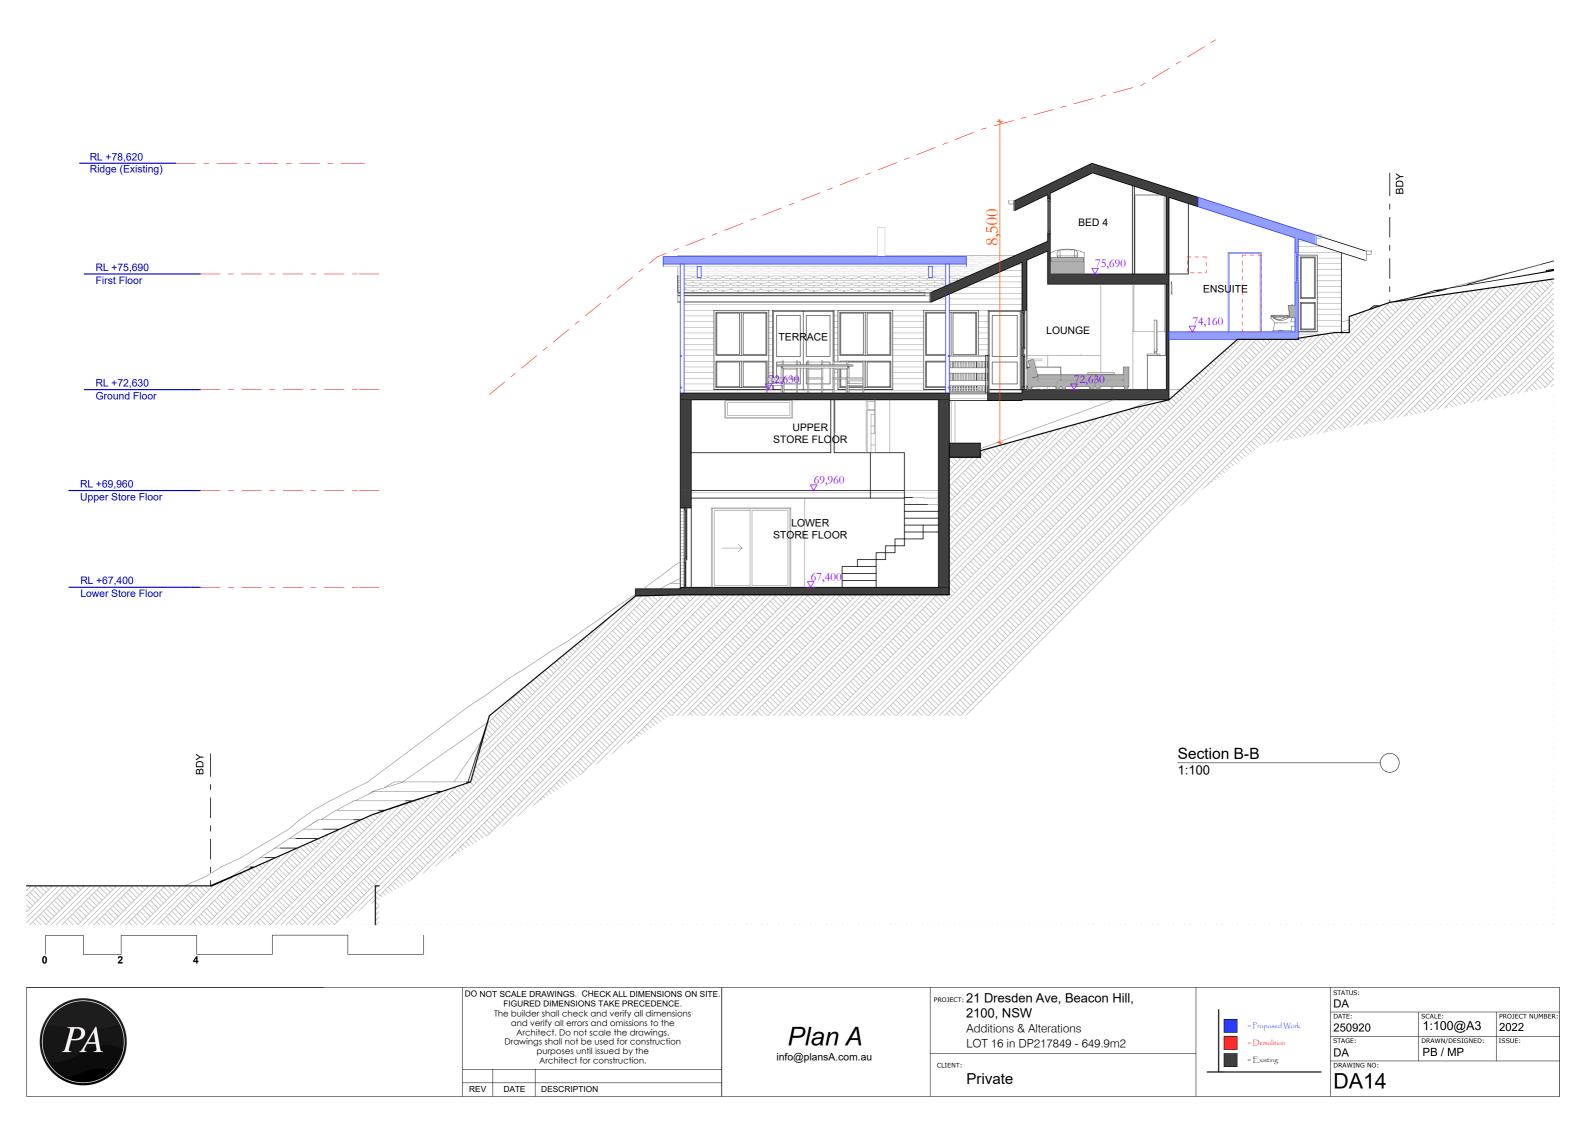

SITE AREA = 649.9m²

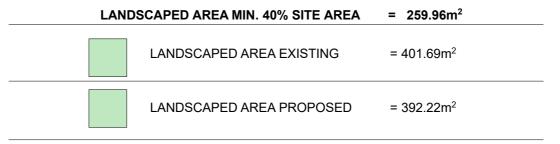

LANDSCAPE AREA COMPLIES







DO NOT SCALE DRAWINGS. CHECK ALL DIMENSIONS ON SITE. FIGURED DIMENSIONS TAKE PRECEDENCE. The builder shall check and verify all dimensions and verify all errors and omissions to the Architect. Do not scale the drawings. Drawings shall not be used for construction purposes until issued by the Architect for construction.

REV DATE DESCRIPTION

Plan A info@plansA.com.au

PROJECT: 21 Dresden Ave, Beacon Hi	ill
2100, NSW	

Additions & Alterations LOT 16 in DP217849 - 649.9m2

CLIENT:	
	О.

Private

l	
	= Proposed Work
	= Demolition
	= Existing

STATUS:		
DATE: 250920	1:250@A3	PROJECT NUMBER
STAGE:	DRAWN/DESIGNED: PB / MP	ISSUE:
DA15		







DO NOT SCALE DRAWINGS. CHECK ALL DIMENSIONS ON SITE.
FIGURED DIMENSIONS TAKE PRECEDENCE.
The builder shall check and verify all dimensions
and verify all errors and omissions to the
Architect. Do not scale the drawings.
Drawings shall not be used for construction
purposes until issued by the
Architect for construction.


REV DATE DESCRIPTION

Plan A info@plansA.com.au 2100, NSW

Additions & Alterations LOT 16 in DP217849 - 649.9m2

CLIENT:

Private

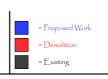

STATUS: DA		
DATE:	SCALE:	PROJECT NUMBER
250920	1:200@A3	2022
STAGE:	DRAWN/DESIGNED:	ISSUE:
DA	PB / MP	
DRAWING NO:		
DA16		







DO NOT SCALE DRAWINGS. CHECK ALL DIMENSIONS ON SITE.
FIGURED DIMENSIONS TAKE PRECEDENCE.
The builder shall check and verify all dimensions
and verify all errors and omissions to the
Architect. Do not scale the drawings.
Drawings shall not be used for construction
purposes until issued by the
Architect for construction.

REV DATE DESCRIPTION

Plan A info@plansA.com.au 2100, NSW


Additions & Alterations LOT 16 in DP217849 - 649.9m2

CLIENT:

Private



STATUS:		
DA		
DATE:	SCALE:	PROJECT NUMBER
250920	1:200@A3	2022
STAGE:	DRAWN/DESIGNED:	ISSUE:
DA	PB / MP	
DRAWING NO:		
DA17		

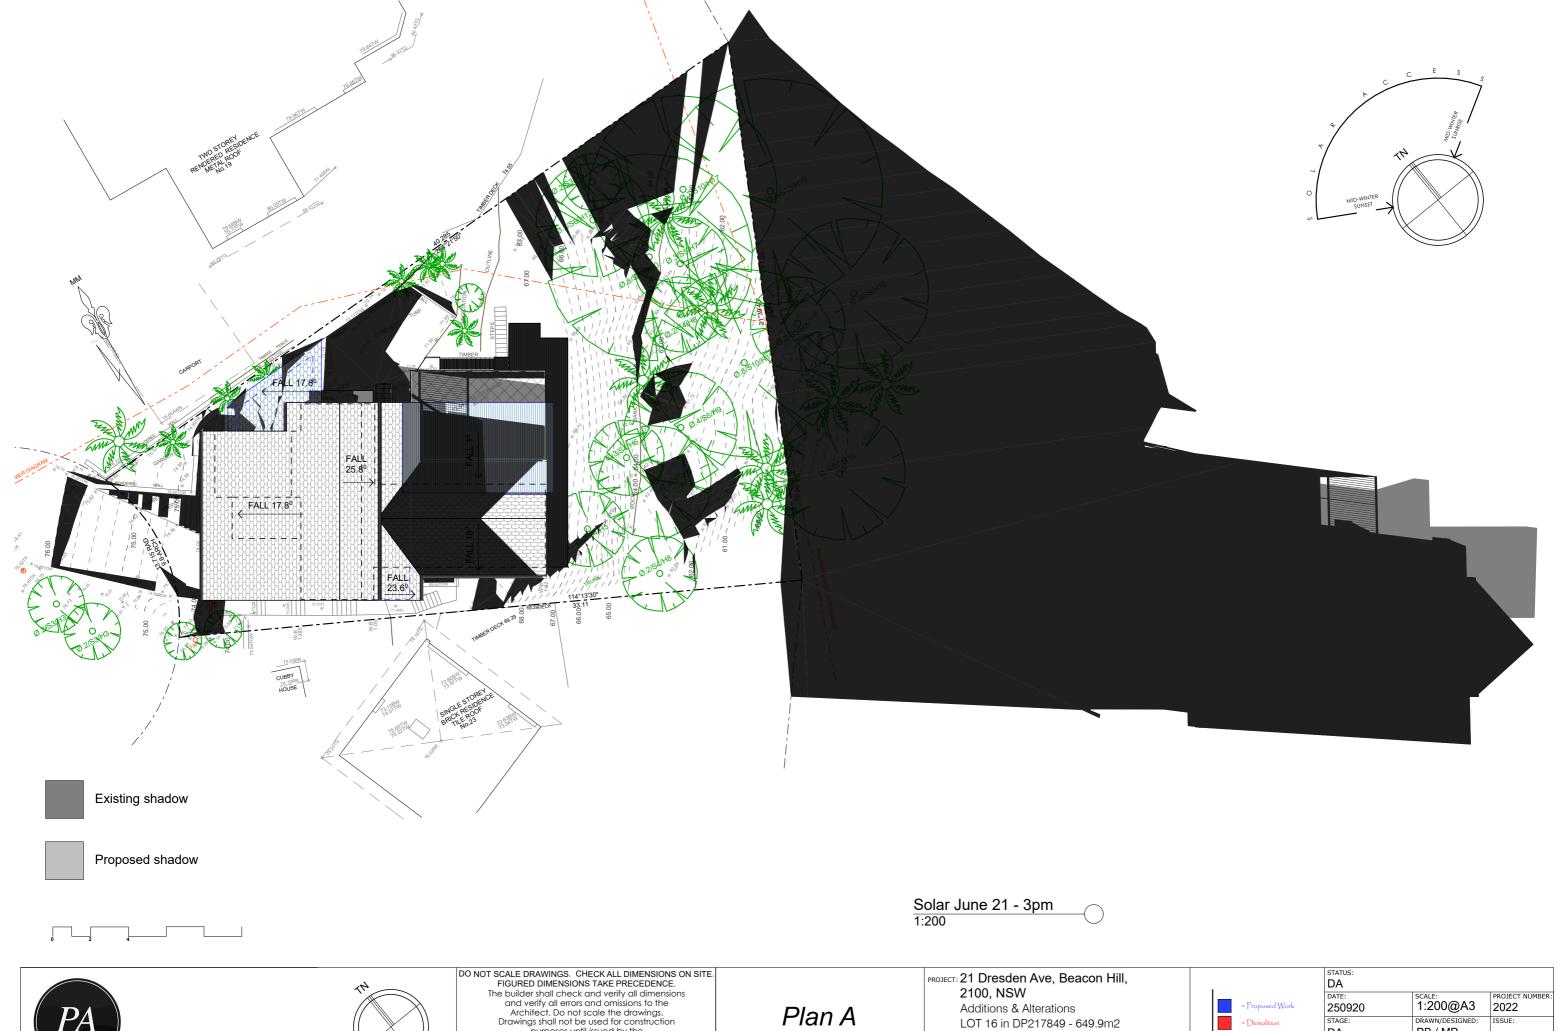

DO NOT SCALE DRAWINGS. CHECK ALL DIMENSIONS ON SITE.
FIGURED DIMENSIONS TAKE PRECEDENCE.
The builder shall check and verify all dimensions
and verify all errors and omissions to the
Architect. Do not scale the drawings.
Drawings shall not be used for construction
purposes until issued by the
Architect for construction. = Proposed W
= Demolition STAGE:
DA
DRAWING NO:
DA18 DRAWN/DESIGNED: info@plansA.com.au CLIENT: Private REV DATE DESCRIPTION



Building Sustainability Index www.basix.nsw.gov.au

Alterations and Additions

Certificate number: A391617

Planning,

This certificate confirms that the proposed development will meet the NSW government's requirements for sustainability, if it is built in accordance with the commitments set out below. Terms used in this certificate, or in the commitments, have the meaning given by the document entitled "BASIX Alterations and Additions Definitions" dated 06/10/2017 published by the Department. This document is available at www.basix.nsw.gov.au

Secretary
Date of issue: Friday, 25, September 2020
To be valid, this certificate must be lodged within 3 months of the date of issue.

21 Dresden DA			
21 Dresden Avenue Beacon Hill 2100			
Northern Beaches Council			
Deposited Plan 217849			
16			
Section number Project type			
Separate dwelling house			
My renovation work is valued at \$50,000 or more, and does not include a pool (and/or spa).			

NSW Industry a			
Fixtures and systems	Show on DA Plans	Show on CC/CDC Plans & specs	Certifier Check
Lighting			
The applicant must ensure a minimum of 40% of new or altered light fixtures are fitted with fluorescent, compact fluorescent, or light-emitting-diode (LED) lamps.		✓	~
Fixtures			
The applicant must ensure new or altered showerheads have a flow rate no greater than 9 litres per minute or a 3 star water rating.		✓	✓
The applicant must ensure new or altered toilets have a flow rate no greater than 4 litres per average flush or a minimum 3 star water rating.		✓	✓
The applicant must ensure new or altered taps have a flow rate no greater than 9 litres per minute or minimum 3 star water rating.		✓	

Ŏ

Construction			Show on DA Plans	Show on CC/CDC Plans & specs	Certifier Check
Insulation requirements					
	d construction (floor(s), walls, and ceilings/roofs) ation is not required where the area of new const where insulation already exists.		~	~	~
Construction	Additional insulation required (R-value)	Other specifications			
suspended floor with enclosed subfloor: framed (R0.7).	R0.60 (down) (or R1.30 including construction)				
external wall: framed (weatherboard, fibro, metal clad)	R1.30 (or R1.70 including construction)				
raked ceiling, pitched/skillion roof: framed	ceiling: R2.24 (up), roof: foil backed blanket (55 mm)	medium (solar absorptance 0.475 - 0.70)			

P_{Λ}	
(PA)	

DO NOT SCALE DRAWINGS. CHECK ALL DIMENSIONS ON SITE. FIGURED DIMENSIONS TAKE PRECEDENCE. The builder shall check and verify all dimensions and verify all errors and omissions to the Architect. Do not scale the drawings.

Drawings shall not be used for construction purposes until issued by the Architect for construction. REV DATE DESCRIPTION



PROJECT: 21 Dresden Ave, Beacon Hill, 2100, NSW Additions & Alterations LOT 16 in DP217849 - 649.9m2 CLIENT: Private

	= Proposed Work
	= Demolition
	= Existing
_	

	STATUS:		
	DA		
	DATE:	SCALE:	PROJECT NUMBER:
	250920	1:100@A3	2022
	STAGE:	DRAWN/DESIGNEL.	
	DA	PB / MP	
	DRAWING NO:		
_	DA19		

Glazing r	equirements						Show on DA Plans	Show on CC/CDC Plans & specs	Certifier Check
Windows	and glazed	doors						'	
The applicant must install the windows, glazed doors and shading devices, in accordance with the specifications listed in the table below. Relevant overshadowing specifications must be satisfied for each window and glazed door.						✓	✓	~	
The following requirements must also be satisfied in relation to each window and glazed door:						~	~		
have a U-v must be ca	alue and a Solution a	ar Heat Gai ordance wit	n Coefficie h National	ent (SHGC) r Fenestration	no greater than that listed in the table	ar glazing, or toned/air gap/clear glazing must le below. Total system U-values and SHGCs s. The description is provided for information		~	~
For projections described in millimetres, the leading edge of each eave, pergola, verandah, balcony or awning must be no more than 500 mm above the head of the window or glazed door and no more than 2400 mm above the sill.						✓	✓	~	
Pergolas with polycarbonate roof or similar translucent material must have a shading coefficient of less than 0.35.							~	~	
Pergolas with fixed battens must have battens parallel to the window or glazed door above which they are situated, unless the pergola also shades a perpendicular window. The spacing between battens must not be more than 50 mm.							✓	~	
Windows	s and glazed	d doors g	lazing r	equireme	nts				
Window / o	door Orientation	on Area of glass inc. frame (m2)	Oversha Height (m)	Distance (m)	Shading device	Frame and glass type			
W1	NW	0.6	0	0	eave/verandah/pergola/balcony >=600 mm	improved aluminium, single clear, (U-value: 6.44, SHGC: 0.75)			
W2	SE	2	0	0	eave/verandah/pergola/balcony >=450 mm	improved aluminium, single clear, (U-value: 6.44, SHGC: 0.75)			
W3	SE	2	0	0	eave/verandah/pergola/balcony >=450 mm	improved aluminium, single clear, (U-value: 6.44, SHGC: 0.75)			
W4	SE	1.4	0	0	eave/verandah/pergola/balcony	improved aluminium, single clear, (U-value: 6.44, SHGC: 0.75)			

In these commitments, "applicant" means the person carrying out the development.

Commitments identified with a "\sqrt{"} in the "Show on DA plans" column must be shown on the plans accompanying the development application for the proposed development (if a development application is to be lodged for the proposed development).

Commitments identified with a "v" in the "Show on CC/CDC plans & specs" column must be shown in the plans and specifications accompanying the application for a construction certificate / complying development certificate for the proposed development.

Commitments identified with a "v" in the "Certifier check" column must be certified by a certifying authority as having been fulfilled, before a final occupation certificate for the development may be issued.