



LOWER GROUND FLOOR DEMOLITION PLAN
1:100


						Client	Project Name	Drawing Title:		
	DATE	REV	COMMENTS	DRWN	,	LUKE GOODWIN & KARA GARRETT	PROPOSED ALTERATIONS AND	LOWER GROU	ND FLOOR	
	02/08/2023	A .	ISSUED FOR DEVELOPMENT APPLICATION	EP	7			DEMOLITION F	PLAN	
designbuild					(X)		17 KANANOOK AVENUE			
PROJECT SERVICES					REVOVATION STATUS	Site Description	BAYVIEW	SCALE: AS SHOWN	STAGE: DA	DATE: 2/8/2023
Unit 9, 2-8 Campbell Street, Arlarmon, NSW, 2064					NO. PEN STATUS [1:200]	LOT 4	14044 Z 104		DRAWING NUMBER &	
p (02) 9437 0056 e info@designbuildps.com www.designbuildps.com					2 NEW 0 A3 0 2 4 6 8 10metres	DP23847				
ABN 72 615 066 736 Nominated Architect: Eliza Patterson NSWARB #11016					10 SE DEMOCRED			632	DA 1.03	(A)
					a serious with a seri					

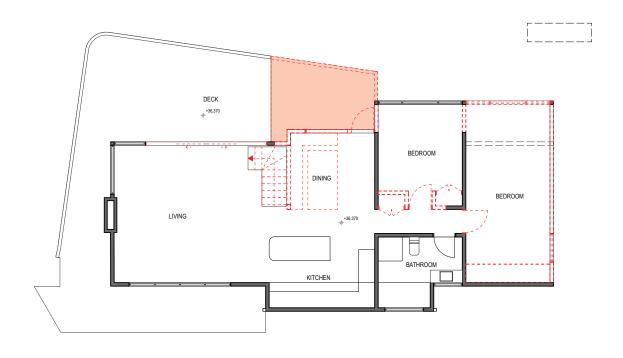


GROUND FLOOR DEMOLITION PLAN
1:100

						Client	Project Name	Drawing Title:		
	DATE	REV	COMMENTS	DRWN	,	LUKE GOODWIN & KARA GARRETT	PROPOSED ALTERATIONS AND	GROUND FLOO	OR DEMOLITION	N
	02/08/202	3 A	ISSUED FOR DEVELOPMENT APPLICATION	EP	4		ADDITIONS TO	PLAN		
designbuild					(X)		17 KANANOOK AVENUE			
PROJECT SERVICES					REVOVATION STATUS	Site Description	BAYVIEW NSW 2104	SCALE: AS SHOWN	STAGE: DA	DATE: 2/8/2023
Unit 9, 2-8 Campbell Street, Artarmon, NSW, 2064					NO. PEN STATUS [1:200]	LOT 4	NSW 2104		DRAWING NUMBER & R	
p (02) 9437 0056 e info@designbuildps.com www.designbuildps.com					2 NEW @ A3 0 2 4 6 8 10metres	DP23847				
ABN 72 615 066 736 Nominated Architect: Eliza Patterson NSWARB #11016					4 LANDSCAPE [1:100] 5 SETBACKS (Q.A3 0 1 2 3 4 5metres			632	DA 1.04 (	(A)
NUMBERO ACTION COLOR PRINCIPAL PRINC					5 SETBACKS @ A3 0 1 2 3 4 5metres			002	DA 1.04 (	(^)

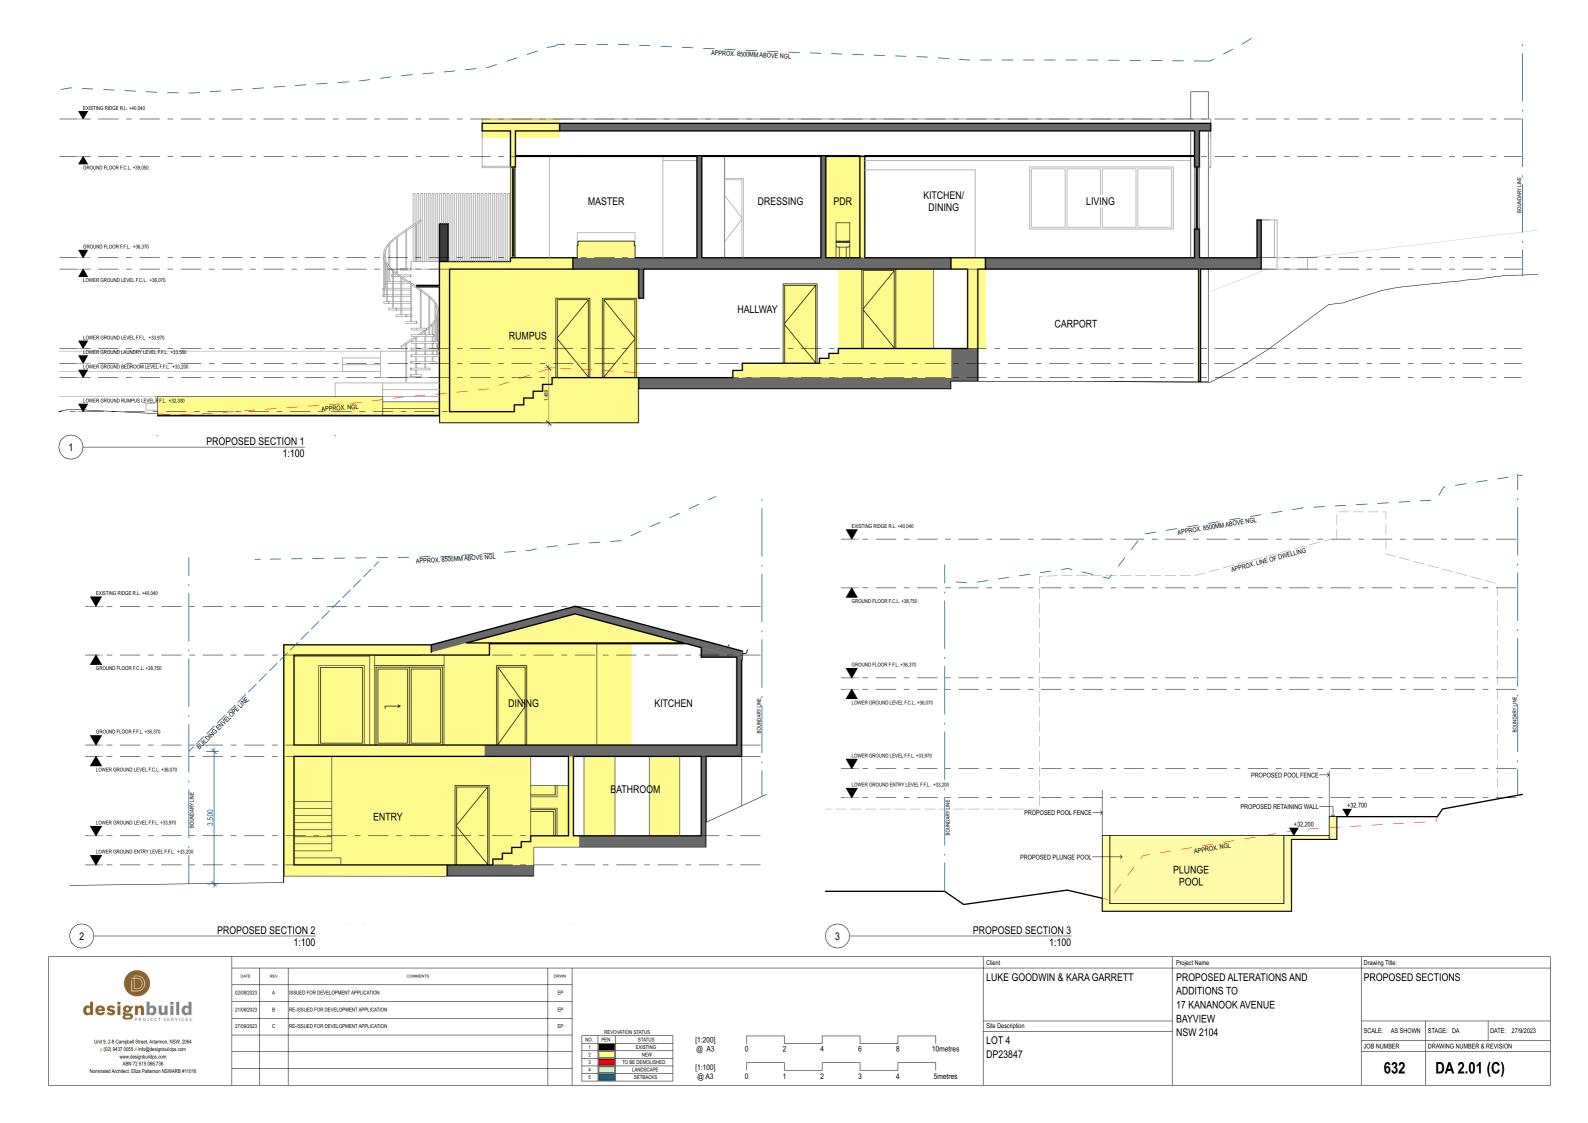

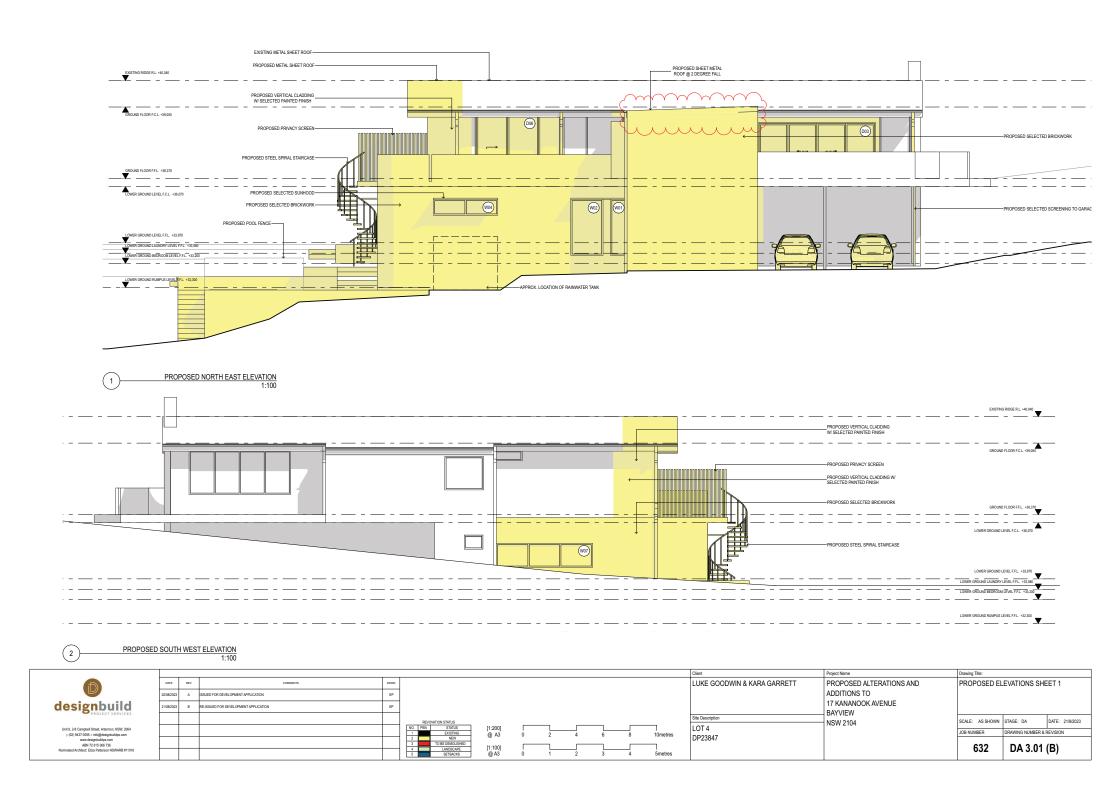


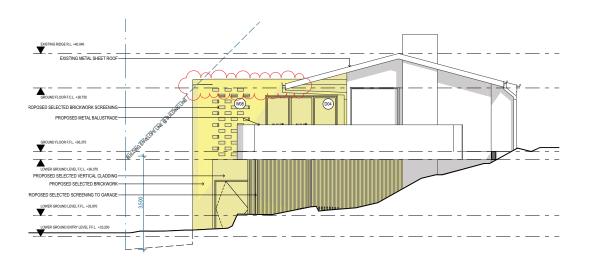


1 PROPOSED NORTH WEST ELEVATION 1:100



PROPOSED SOUTH EAST ELEVATION
1:100

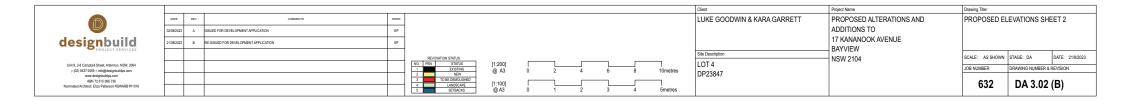

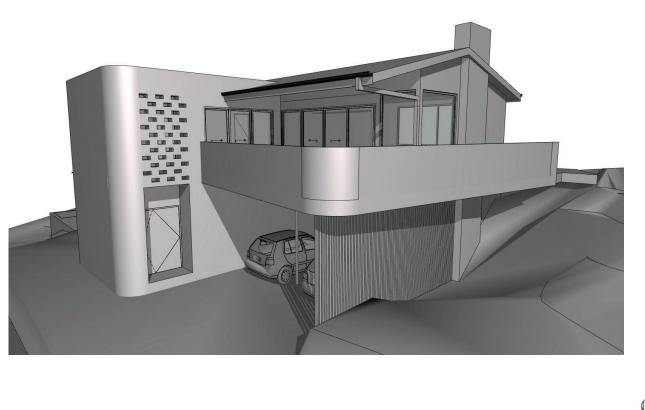





Unit 9, 2-8 Campbell Street, Artamon, NSW, 2064 p (K2) 9437 0055 e info@designbullops.com www.designbullops.com www.designbullops.com maN 2 615 066 736 Nominated Architect: Eliza Patterson NSWARB #11016

DATE	REV	COMMENTS	DRWN	
02/08/2023	A	ISSUED FOR DEVELOPMENT APPLICATION	EP	

	REVO	DVATION STATUS							
NO.	PEN	STATUS	[1:200]						
- 1		EXISTING	@ A3	Ó	2	4	6	8	10metres
2		NEW	@ /10		-				1011101100
3		TO BE DEMOLISHED	74 4000		_		_		
4		LANDSCAPE	[1:100]	- 1					1
5		SETBACKS	@ A3	0	1	2	3	4	5metres
_									

			/
l	Client	Project Name	Drawing T
	LUKE GOODWIN & KARA GARRETT	PROPOSED ALTERATIONS AND ADDITIONS TO 17 KANANOOK AVENUE BAYVIEW	3D PE
	Site Description	NSW 2104	SCALE:
	LOT 4	1007 2104	JOB NUM
	DP23847		(

Drawing Title:					
3D PERSPECT	IVES				
SCALE: AS SHOWN	STAGE: DA	DATE: 2/8/2023			
JOB NUMBER	DRAWING NUMBER & F	REVISION			
632	DA 10.01 (A)				







DARK EXTERNAL DOORS & WINDOW FRAMES

SOFT WHITE LIGHTWEIGHT CLADDING & ROOF

SOFT WHITE BRICKS









CURVED BRICKWORK WALLS

TIMBER EAVE LININGS

NATURAL LOOK CLADDING

EXTERNAL SPIRAL STAIR



						Client	Project Name	Drawing Title:		
	ATE	REV	COMMENTS	DRWN		LUKE GOODWIN & KARA GARRETT		PROPOSED M	ATERIALS BOAF	RD
02/1	8/2023	A E	SSUED FOR DEVELOPMENT APPLICATION	EP			ADDITIONS TO			
							17 KANANOOK AVENUE			
-						Site Description	BAYVIEW			
					REVOVATION STATUS		NSW 2104	SCALE: AS SHOWN	STAGE: DA	DATE: 2/8/2023
					NO. PEN STATUS [1:200]  1 EXISTING @ A3 0 2 4 6 8 10metres	LOT 4 DP23847		JOB NUMBER	DRAWING NUMBER & F	REVISION
					3 TO BE DEMOLISHED [1:100]	DF2304/		632	DA 10.01	I /A\
					4 JUNISCAPE [1:100] 5 SETBACKS @ A3 0 1 2 3 4 5metres			032	DA 10.01	(A)

page 2 / 7 BASIX Certificate number: A497684

**BASIX** Certificate

Building Sustainability Index www.basix.nsw.gov.au

## Alterations and Additions

This certificate confirms that the proposed development will meet the NSW powerments requirements for sustainable), if it is hold in accordance with the commitments set out below. Terms used in this certificate, or in the commitments, where the meaning lipse to by the document entitled "SASIX Alterations and Additions Definitions" dated 6/81/02/07 published by the Department, This document is available at www.basic.nsw.gov.u.

Secretary
Date of Issue: Wednesday, 02, August 2023
To be valid, this certificate must be lodged within 3 months of the date of Issue.

Planning, Industry &

flat ceiling, pitched roof

flat ceiling, flat roof: framed

Project name	632 - Bayview, 17 Kananook Avenue
Street address	17 Kananook Avenue Bayview 2104
Local Government Area	Northern Beaches Council
Plan type and number	Deposited Plan DP23847
Lot number	4
Section number	
Project type	
Dwelling type	Separate dwelling house
Type of alteration and addition	My renovation work is valued at \$50,000 or more and includes a pool (and/or spa).

Pool and Spa	Show on DA Plans	Show on CC/CDC Plans & specs	Certifie Check
Rainwater tank			
The applicant must install a rainwater tank of at least 844 litres on the site. This rainwater tank must meet, and be installed in accordance with, the requirements of all applicable regulatory authorities.	V	<b>V</b>	~
The applicant must configure the rainwater tank to collect rainwater runoff from at least 50 square metres of roof area.		V	V
The applicant must connect the rainwater tank to a tap located within 10 metres of the edge of the pool.		1	1
Outdoor swimming pool			
The swimming pool must be outdoors.	V	V	V
The swimming pool must not have a capacity greater than 20.7 kilolitres.	V	~	V
The swimming pool must have a pool cover.		1	~
The applicant must install a pool pump timer for the swimming pool.		~	V
The applicant must install the following heating system for the swimming pool that is part of this development: solar (gas boosted).		1	1

Fixtures and systems	Show on DA Plans	Show on CC/CDC Plans & specs	Certifier Check
Hot water			
The applicant must install the following hot water system in the development: solar (gas-boosted) system that is eligible to create Renewable Energy Certificates under the (Commonwealth) Renewable Energy (Electricity) Regulations 2001 (incorporating Amendment Regulations 2005 (No. 2).	<b>~</b>	<b>~</b>	~
Lighting			
The applicant must ensure a minimum of 40% of new or altered light fixtures are fitted with fluorescent, compact fluorescent, or light-emitting-diode (LED) lamps.		~	~
Fixtures			
The applicant must ensure new or altered showerheads have a flow rate no greater than 9 litres per minute or a 3 star water rating.		V	~
The applicant must ensure new or altered toilets have a flow rate no greater than 4 litres per average flush or a minimum 3 star water rating.		V	1
The applicant must ensure new or altered taps have a flow rate no greater than 9 litres per minute or minimum 3 star water rating.		1	

Certificate Prepared by (please complete before submitting to Council or PCA) Name / Company Name: DesignBuild Project Services ABN (if applicable): 72615066736

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> > page 5 / 7 BASIX Certificate number: A497684

light (solar absorptance < 0.475)

Construction Insulation requirements The applicant must construct the new or altered construction (floor(s), walls, and ceilings/roofs) in accordance with the specifications listed in the table below, except that a) additional insulation is not required where he area of new construction is less than 2m2, b) insulation specified is not required for parts of altered construction where insulation already exists. concrete slab on ground floor. R0.60 (down) (or R1.30 including construction) suspended floor with enclosed subfloor: framed (R0.7). floor above existing dwelling or building. external wall: brick veneer R1.16 (or R1.70 including construction) external wall: framed (weatherboard, fibro, metal clad) R1.30 (or R1.70 including construction)

ceiling: R2.25 (up), roof: foil/sarking

ceiling: R2.32 (up), roof: foil/sarking

Glazing requ	irements						Show on DA Plans	Show on CC/CDC Plans & specs	Certifier Check
Vindows and	glazed do	ors							
					hading devices, in accordance with r each window and glazed door.	the specifications listed in the table below.	~	~	~
he following n	equirements	must also	be satisfi	ed in relatio	n to each window and glazed door:			~	~
ave a U-value	and a Solar	Heat Gair	Coefficie	ent (SHGC)		d glass may either match the description, or, le below. Total system U-values and SHGCs i.		<b>✓</b>	~
nave a U-value nust be calcula	and a Solar	Heat Gair tance with	Coefficie National	ent (SHGC) Fenestratio	no greater than that listed in the tabl	ar glazing, or toned/air gap/clear glazing must le below. Total system U-values and SHGCs . The description is provided for information		~	~
or projections east that show			he ratio of	the projecti	on from the wall to the height above	the window or glazed door sill must be at	✓	✓	<b>✓</b>
xternal louvre	s and blinds	must fully	shade the	e window or	glazed door beside which they are	situated when fully drawn or closed.		V	~
Vindows ar	nd glazed	doors g	lazing r	equireme	nts				
Window / door no.	Orientation	Area of glass inc. frame (m2)	Oversha Height (m)	Distance (m)	Shading device	Frame and glass type			
W1	NE	1.302	0	0	projection/height above sill ratio >=0.29	standard aluminium, single pyrolytic low-e, (U-value: 5.7, SHGC: 0.47)			
W2	NE	2.541	0	0	projection/height above sill ratio >=0.29	standard aluminium, single pyrolytic low-e, (U-value: 5.7, SHGC: 0.47)			
W4	NE	1.446	0	0	projection/height above sill ratio >=0.43	standard aluminium, single clear, (or U-value: 7.63, SHGC: 0.75)			

Glazing requ	zing requirements									
Window / door	Orientation		Oversha	dowing	Shading device	Frame and glass type				
		glass inc. frame (m2)	Height (m)	Distance (m)						
					>=0.29	U-value: 7.63, SHGC: 0.75)				
W7	sw	3.249	0	0	none	standard aluminium, single clear, (or U-value: 7.63, SHGC: 0.75)				
W8	NW	2.541	0	0	external louvre/blind (fixed)	standard aluminium, single clear, (or U-value: 7.63, SHGC: 0.75)				
W9	SE	2.541	0	0	projection/height above sill ratio >=0.29	standard aluminium, single clear, (or U-value: 7.63, SHGC: 0.75)				
W10	SE	2.904	0	0	projection/height above sill ratio >=0.29	standard aluminium, single clear, (or U-value: 7.63, SHGC: 0.75)				
D02	SE	5.784	0	0	projection/height above sill ratio >=0.23	standard aluminium, single clear, (or U-value: 7.63, SHGC: 0.75)				
D03	NE	9.24	0	0	projection/height above sill ratio >=0.43	standard aluminium, single clear, (or U-value: 7.63, SHGC: 0.75)				
D04	NW	5.691	0	0	projection/height above sill ratio >=0.43	standard aluminium, single clear, (or U-value: 7.63, SHGC: 0.75)				
D05	SE	3.864	0	0	projection/height above sill ratio >=0.36	standard aluminium, single clear, (or U-value: 7.63, SHGC: 0.75)				
D06	NE	5.784	0	0	projection/height above sill ratio >=0.29	standard aluminium, single pyrolytic low-e, (U-value: 5.7, SHGC: 0.47)				
D07	SE	5.784	0	0	projection/height above sill ratio >=0.29	standard aluminium, single clear, (or U-value: 7.63, SHGC: 0.75)				

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projection/height above sill ratio standard aluminium, single clear, (or >=0.43 U-value: 7.63, SHGC: 0.75)

1.446 0 0

PROPOSED ALTERATIONS AND BASIX CERTIFICATE LUKE GOODWIN & KARA GARRETT ADDITIONS TO ISSUED FOR DEVELOPMENT APPLICATION designbuild 17 KANANOOK AVENUE BAYVIEW Site Description SCALE: AS SHOWN STAGE: DA NSW 2104 Unit 9, 2-8 Campbell Street, Artarmon, NSW, 2064 p (02) 9437 0056 - infol@designbuildps.com www.designbuildps.com ABN 97 615 066 736 Nominated Architect: Eliza Patterson NSWARB #11016 LOT 4 [1:200] @ A3 DRAWING NUMBER & REVISION JOB NUMBER DP23847 DA 10.02 (A)

