



View 1 From ROW

A. Holt B(Arch)	Project: Alterations & Additions, 187	73 Pittwater Rd, Bayview	Client : Hermsen		Scale: As Shown @ (A3)
	Cover Page		Drawing No.: DA-00 @A3	ssue :	Date: Aug 2022

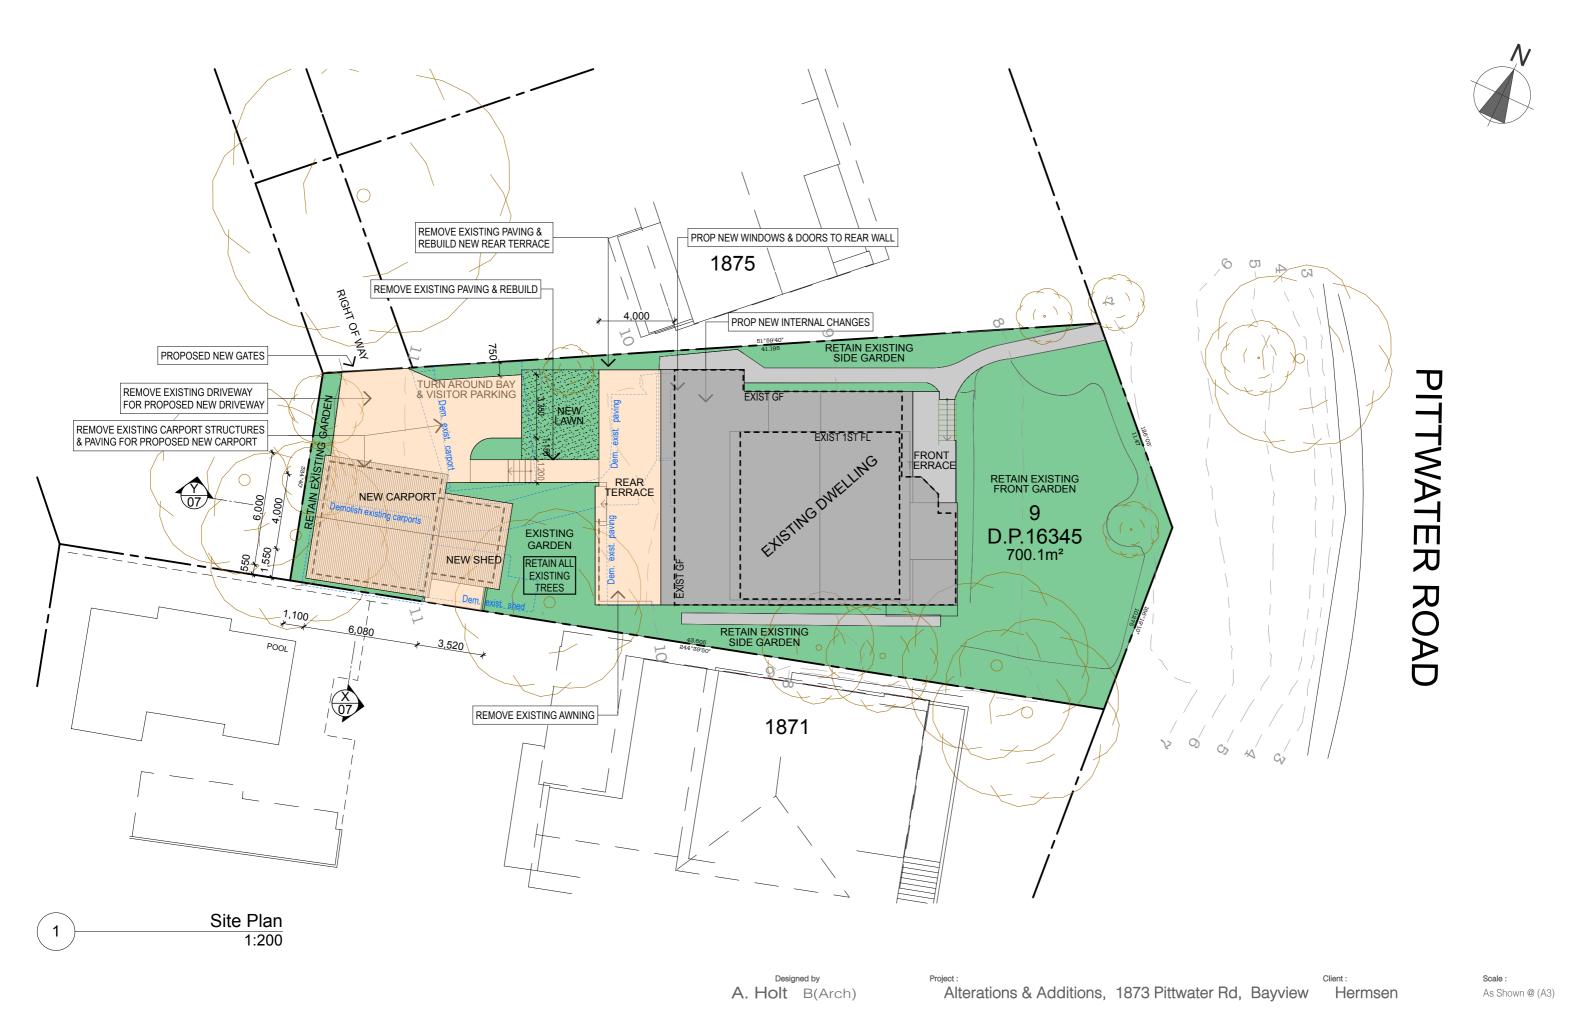



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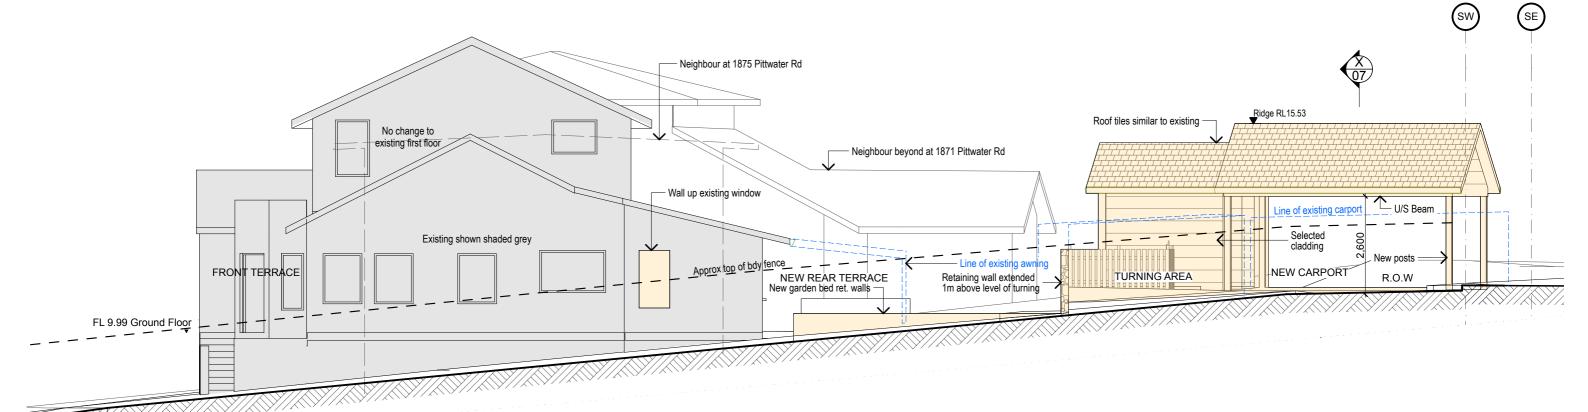
Site Plan



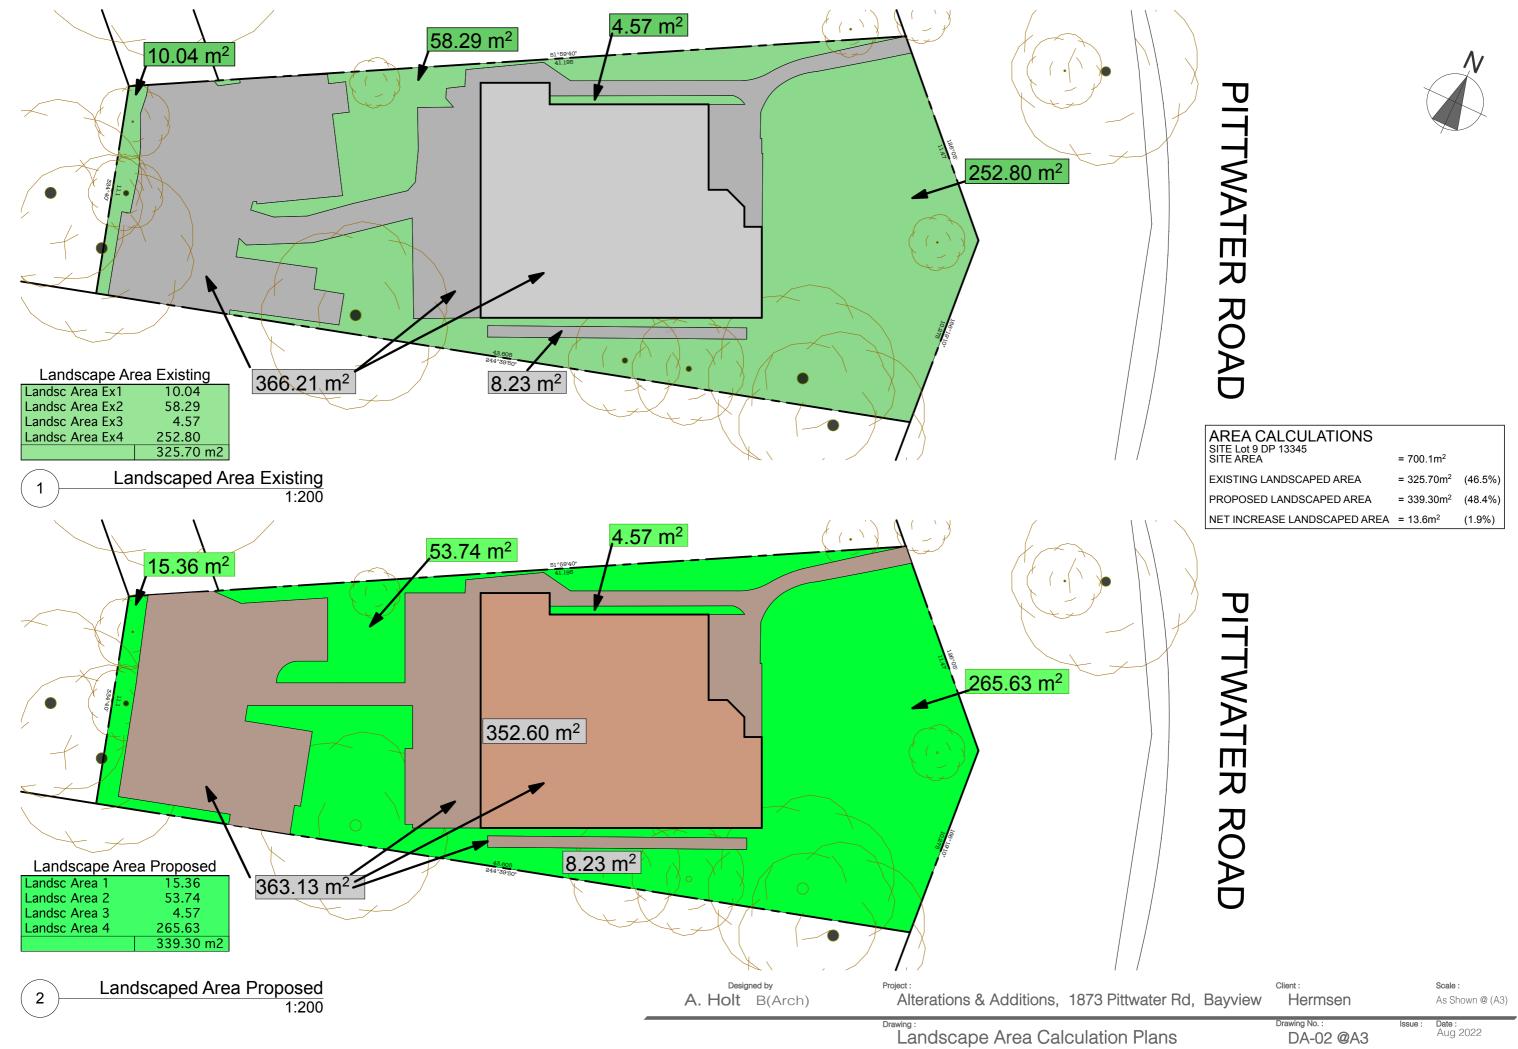Drawing No.:
DA-03 @A3



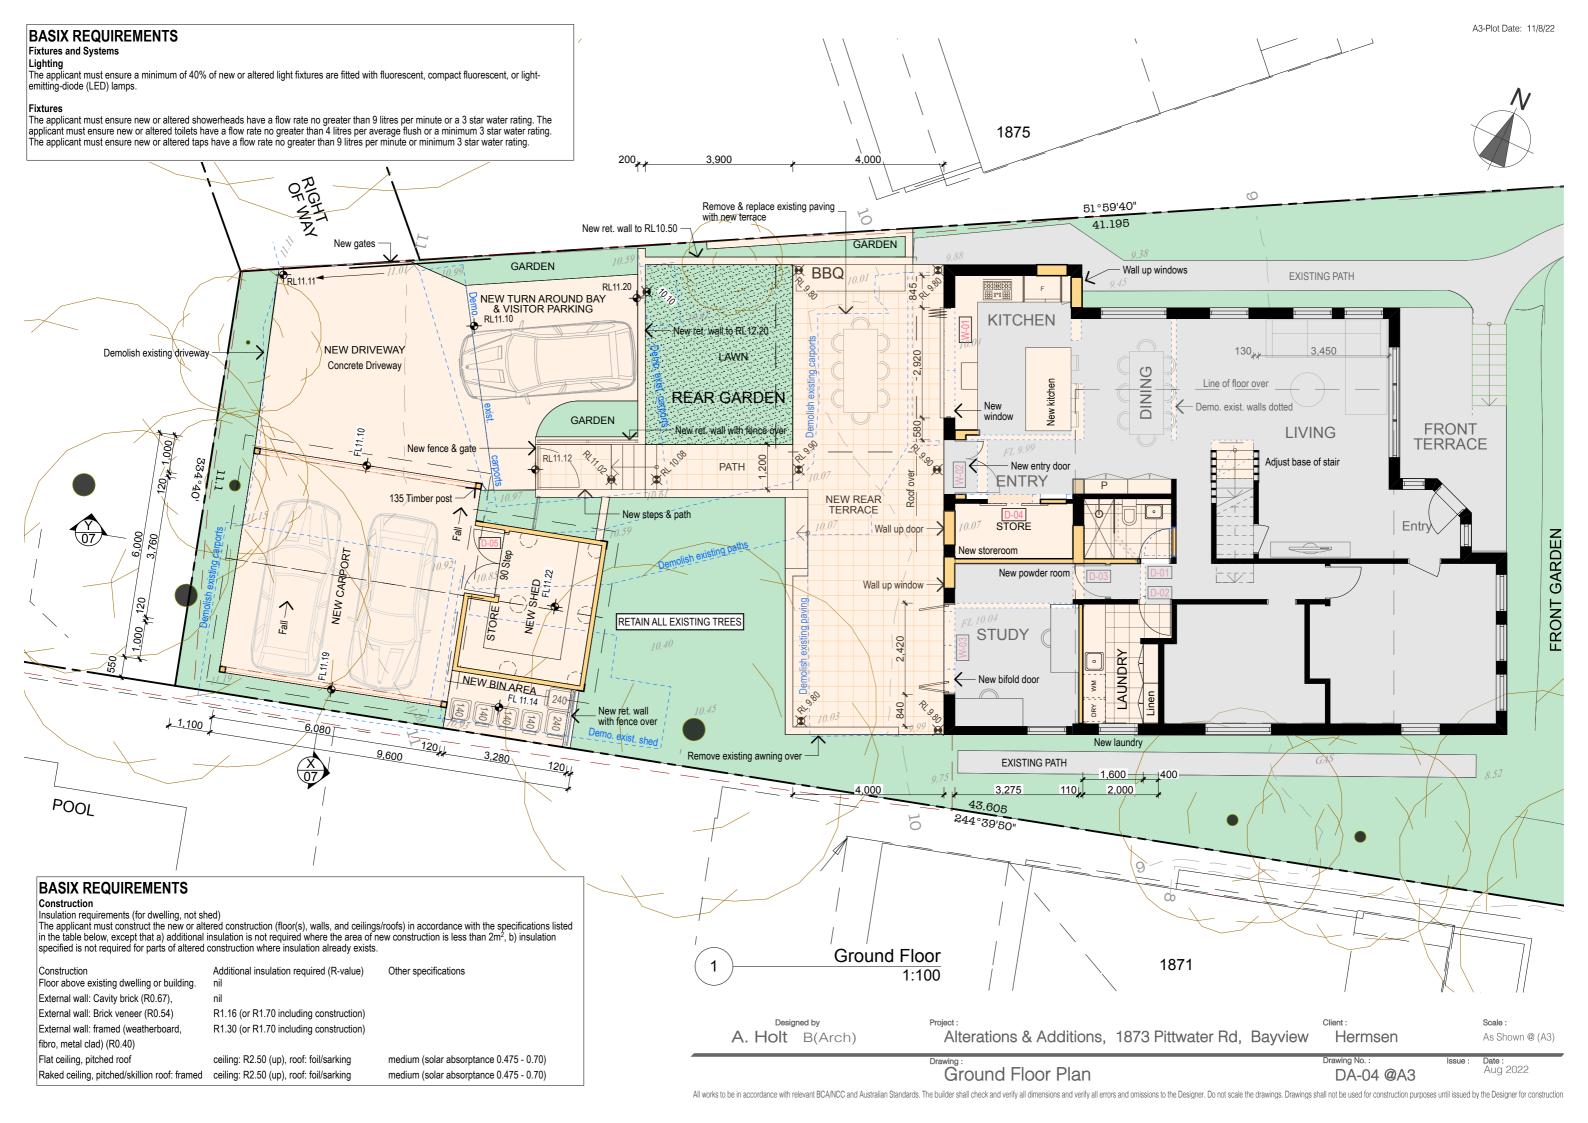

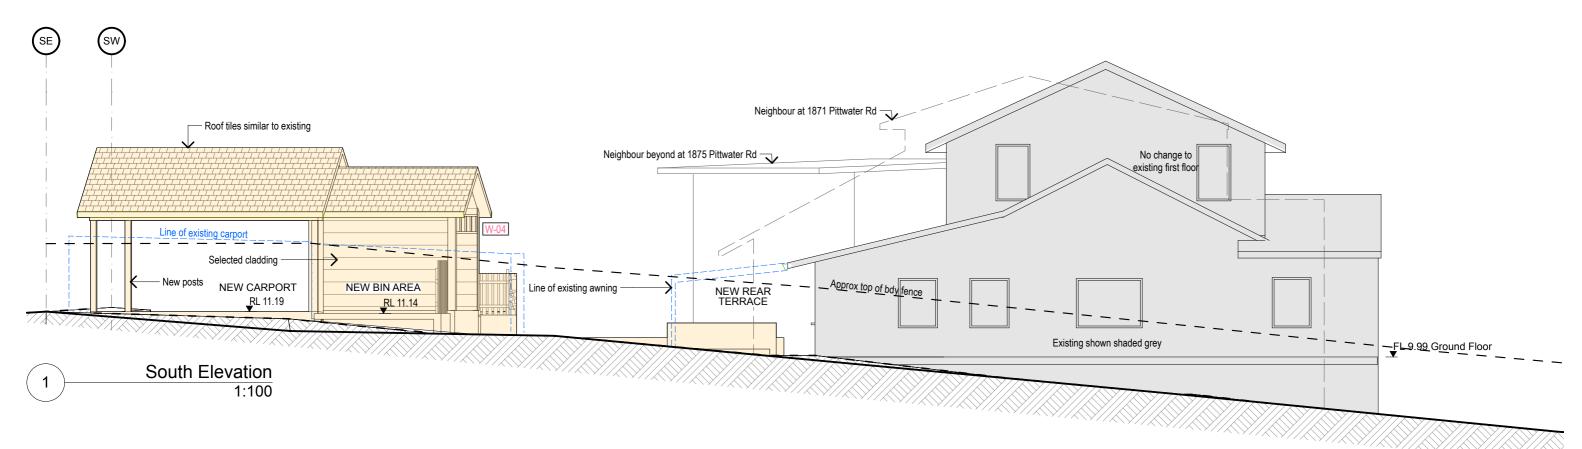

North Elevation 1:100

A. Holt B(Arch)


Project:
Alterations & Additions, 1873 Pittwater Rd, Bayview


Project:
Alterations & Additions, 1873 Pittwater Rd, Bayview

Project:
As Shown @ (A3)

Drawing:
Elevations N & S

Drawing No.:
Bute:
Aug 2022

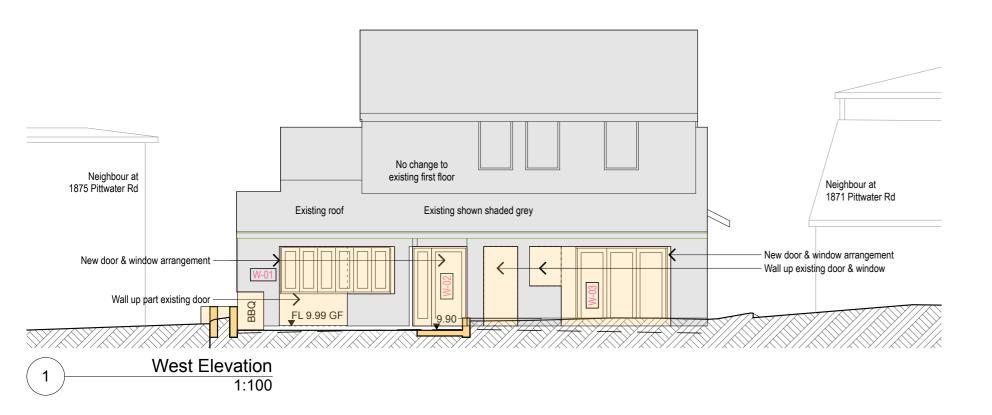

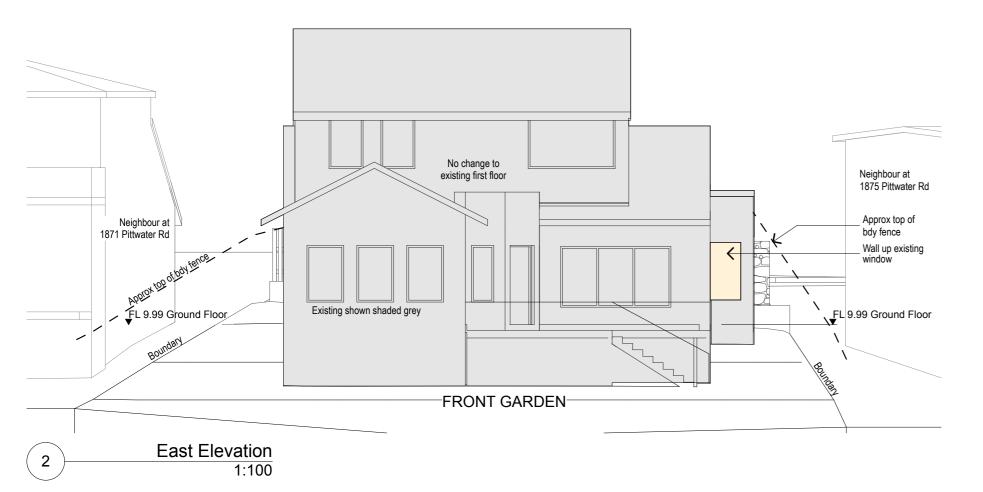

BASIX REQUIREMENTS

BASIX REQUIREMENTS

Windows and glazed doors
The applicant must install the windows, glazed doors and shading devices, in accordance with the specifications listed in the table below. Relevant overshadowing specifications must be satisfied for each window and glazed door. The following requirements must also be satisfied in relation to each window and glazed door:

Each window or glazed door with standard aluminium or timber frames and single clear or toned glass may either match the description, or, have a U-value and a Solar Heat Gain Coefficient (SHGC) no greater than that listed in the table below. Total system U-values and SHGCs must be calculated in accordance with National Fenestration Rating Council (INFRC) conditions. For projections described in millimetres, the leading edge of each eave, pergola, verandah, balcony or awning must be no more than 500 mm above the head of the window or glazed door and no more than 2400 mm above the sill.

Perrolas with polycarbonate roof or similar translucent material must have a shading coefficient of less than 0.35.

Pergolas with polycarbonate roof or similar translucent material must have a shading coefficient of less than 0.35.
Pergolas with fixed battens must have battens parallel to the window or glazed door above which they are situated, unless the pergola also shades a perpendicular window. The spacing between battens must not be more than 50 mm.

Window/ door no.	Orientation	Area of glass inc.	Overshad Hght (m)	Ū	Shading device	Frame and glass type
W1	W	frame (m ²) 3.66	0	Dist. (m) 0	eave/verandah/pergola/	timber, single clear,
			-	-	balcony >=750 mm	(or U-value: 5.71, SHGC: 0.66)
W2	W	3.02	0	0	eave/verandah/pergola/ balcony >=750 mm	timber, single clear, (or U-value: 5.71, SHGC: 0.66)
W3	W	5.08	0	0	eave/verandah/pergola/ balcony >=750 mm	timber, single clear, (or U-value: 5.71, SHGC: 0.66)
W4	Window in sh	ned				Nil requirement

Window #	W-01	W-02		
Room	Kitchen	Entry		
Area m2	3.50	3.02		
Elevation	2,920 No sill TBC Servery bench below Viewed from outside	1,440 900 460 Viewed from inside		
Basix	timber or uPVC, single clear, (or U-value: 5.71, SHGC: 0.66)	timber or uPVC, single clear, (or U-value: 5.71, SHGC: 0.66)		
Window #	W-03	W-04		
Room	Study	Shed		
Area m2	5.08	1.80		
Elevation	2,420 Viewed from outside	3,600 FFFFF		
Basix	timber or uPVC, single clear, (or U-value: 5.71, SHGC: 0.66)	timber or uPVC, single clear, (or U-value: 5.71, SHGC: 0.66)		

Window Schedule

WINDOW SCHEDULE NOTES ALL WINDOWS VIEWED FROM THE OUTSIDE (U.N.O) ALL DIMENSIONS TO BE CHECKED & CONFIRMED ON SITE PRIOR TO MANUFACTURE. REFER ALSO TO DOOR SCHEDULE. LEGEND Fixed glass GENERAL All Windows, Doors & Frames must be in Accordance with the latest Glazing req'mts of the Basix Report for the project. WINDOW & DOOR FRAMES Painted - White to match existing Timber architraves & moldings to match existing Additional matching trims & cover plates as shown. Timber reveals to all window frames.

Alterations & Additions, 1873 Pittwater Rd, Bayview


Designed by

A. Holt B(Arch)


Hermsen


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DA-06 @A3

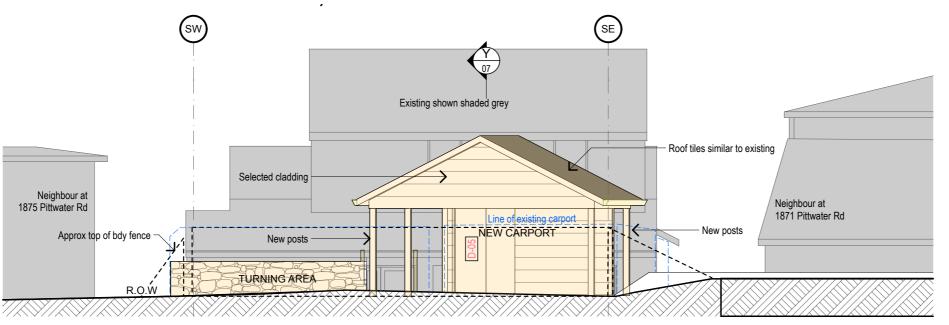

West Elevation Carport 1:100



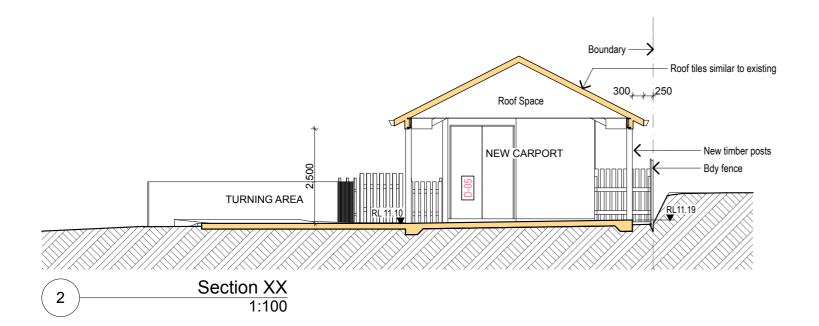

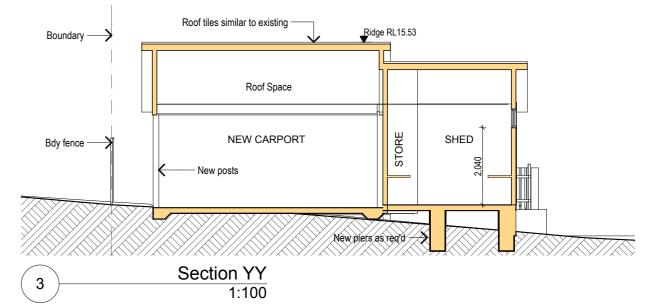Designed by Scale: Alterations & Additions, 1873 Pittwater Rd, Bayview Hermsen A. Holt B(Arch) As Shown @ (A3) Carport Elevation & Sections DA-07 @A3

