

ACTION PLANS

4A Orana Rd, Mona Vale NSW 2103

m: 0403957518 e:design@actionplans.com.au w: www.actionplans.com.au

ITEM DETAILS

LOT SEC E LOT 30 DP 6195 SITE AREA: 954.8m² FRONTAGE: 15.24m

LEP	CONTROL	EXISTING	PROPOSED	COMPLIANCE
LAND ZONING MIN. LOT SIZE MAX. BUILDING HEIGHT ACID SULFATE WITHIN OVERLAND FLOW PATH	R2 700m ² 8.5m CLASS 5 MAJOR	954.8m² 7.5m	unchanged	YES
DCP				
LANDSCAPED AREA: PRIVATE OPEN SPACE: FRONT BUILDING LINE: REAR BUILDING LINE: SIDE BUILDING LINE:	50% (477.4m²) 80m² 6.5m 6.5m S: 1m N: 2.5m	46% (440.17m²) 98.1m² 5.95m 17.9m S: 1m N: 2.36m	unchanged unchanged unchanged unchanged unchanged unchanged	YES YES YES YES YES YES
HARD SURFACE AREA		466.44m²		


SHEET NUMBER	SHEET NAME	DATE PUBLISHED
S96.00	COVER	22/11/2018
S96.01	SITE ANALYSIS	22/11/2018
S96.02	SITE / ROOF / SEDIMENT EROSION PLAN	22/11/2018
S96.03	EXISTING DA GROUND FLOOR PLAN	22/11/2018
S96.04	EXISTING DA FIRST FLOOR PLAN	22/11/2018
S96.05	PROPOSED S96 GROUND FLOOR	22/11/2018
S96.06	PROPOSED S96 FIRST FLOOR PLAN	22/11/2018
S96.07	NORTH ELEVATION	22/11/2018
S96.08	SOUTH ELEVATION	22/11/2018
S96.09	WEST ELEVATION	22/11/2018
S96.10	EAST ELEVATION	22/11/2018
S96.11	LONG SECTION	22/11/2018
S96.12	CROSS SECTION	22/11/2018
S96.13	AREA CALCULATIONS / SAMPLE BOARD	22/11/2018
S96.14	WINTER SOLSTICE 9 AM	22/11/2018
S96.15	WINTER SOLSTICE 12 PM	22/11/2018
S96.16	WINTER SOLSTICE 3 PM	22/11/2018
S96.17	BASIX COMMITMENTS	22/11/2018



NCC & AS COMPLIANCES SPECIFICATIONS

- ALL CONSTRUCTION TO COMPLY TO AS3959- 1991

- EARTHWORKS: METHOD OF EXCAVATIONAND FILL - PART 3.1.1 OF NCC - SURFACE SUBSOIL-STORMWATER DRAINAGE - PART 3.1.2 OF NCC - TERMITE-RISK MANAGEMENT - PART 3.1.3 OF NCC - FOOTINGS & SLAB - PART 3.2 OF NCC INCLUDING AS2870 - MASONRY CONSTRUCTION - PART 3.3 OF NCC INCLUDING AS3700 - SUB FLOOR VENTILATION - PART 3.4.1 OF NCC - FRAMING - PART 3.4 OF NCC - ROOF, WALL-CLADDING, GUTTERS & DOWNPIPES - PART 3.5 OF NCC - GLAZING - PART 3.6 OF NCC INCLUDING AS1288 - FIRE SEPARATION - PART 3.7.1 OF NCC - SMOKE ALARMS - PART 3.7.2 OF NCC - HEATING APPLIANCES - PART 3.7.3 OF NCC - WET AREAS-PROTECTION OF WALLS & FLOORS - PART 3.8.1 OF NCC - MINIMUM ROOF HEIGHTS - PART 3.8.3 OF NCC - FACILITIES REQUIRRED & SANITARY DOOR CONSTRUCTION - PART 3.8.3 OF NCC - LIGHT: NATURAL AND ARTIFICIAL - PART 3.8.4 OF NCC - VENTILATION & LOCATION OF TOILETS - PART 3.8.5 OF NCC - SOUND INSULATION - PART 3.8.6 OF NCC - STAIR CONSTRUCTION INCLUDING DIMENSIONS - PART 3.9.1 OF NCC - BALUSTRADES & OTHER BARRIERS - PART 3.9.2 OF NCC - FENCING & OTHER PROVISIONS - REGS & AS1926 - DEMOLITION WORKS - AS2601-1991 THE DEMOLITION OF STRUCTURES. - ALL WATERPROOF MEMBRANES TO COMPLY WITH WITH AS 3740-2004 - ALL PLUMBING & DRAINAGE WORK TO COMPLY WITH AS 3500 - SITE CLASSIFICATION AS TO AS 2870 - ALL PLASTERBOARD WORK TO COMPLY WITH AS 2588-1998 - ALL STRUCTURAL STEEL WORK TO COMPLY WITH AS 4100 & AS 1554 - ALL CONCRETE WORK TO COMPLY WITH AS 3600 - ALL ROOF SHEETING WORK TO COMPLY WITH AS 1562-1992 - ALL SKYLIGHTS TO COMPLY WITH WITH AS 4285-2007 - ALL CERAMIC TILING TO COMPLY WITH AS 3958.1-2007 & 3958.2-1992 - ALL GLAZING ASSEMBLIES TO COMPLY WITH AS2047 & 1288 - ALL TIMBER RETAINING WALLS ARE TO COMPLY WITH AS 1720.1-2010, AS 1720.2-2006, AS 1720.4-2006, AS 1170.1-1989 & AS 1170.4-1993 - ALL RETAINING WALLS ARE TO COMPLY WITH 3700 - 2011 & AS 3600 -2001

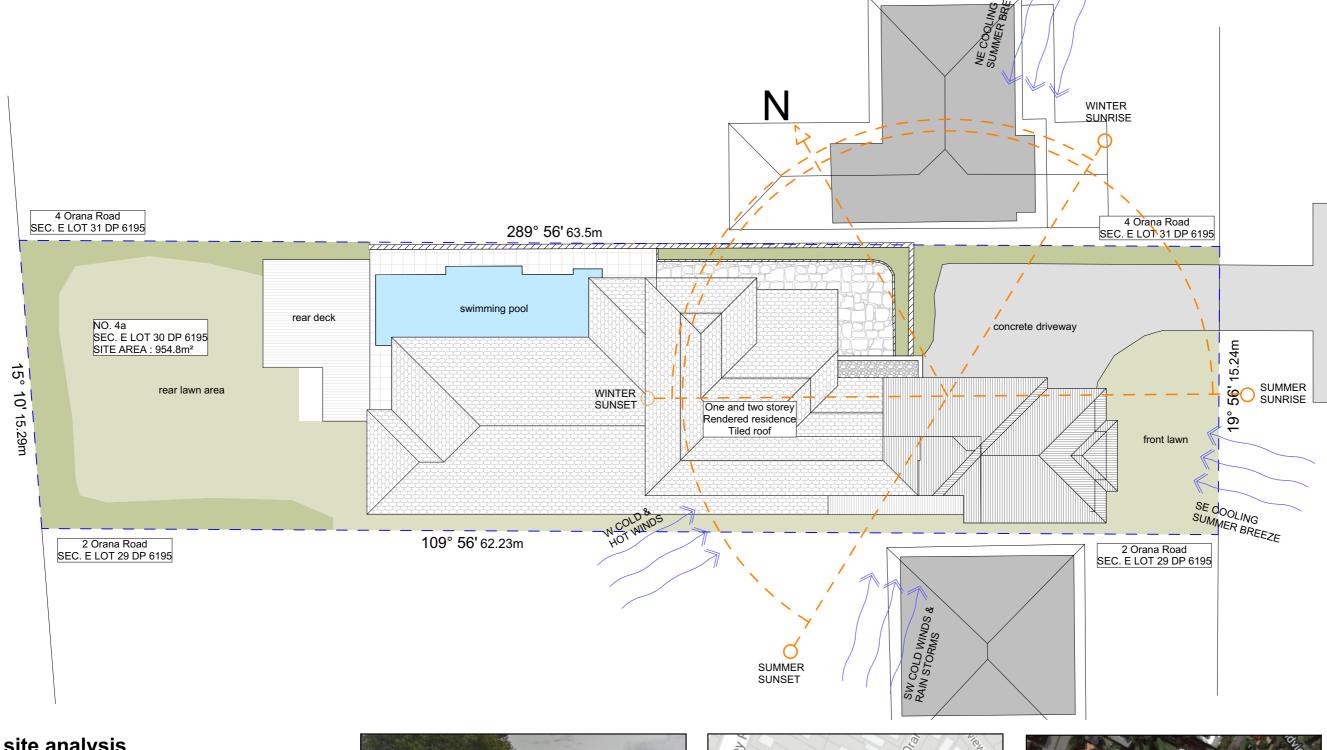

site analysis 1:100 @ A3







DRAWING NAME

1:200 @A3

AERIAL VIEW

ACTION PLANS

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Do no scale on drawings. Use figured dimensions.

LEGEND

NEW FLOOR AREA NEW WET FLOOR AREA TIMBER

BRICKWORK

METAL

-- DEMOLISHED

CONCRETE EXISTING WALLS

PROJECT ADDRESS

CLIENT

Annie Pogson & Wayne

4A Orana Rd, Mona Vale NSW 2103

DRAWING NO.

S96.01


Thursday, 22

November 2018

SITE ANALYSIS

DATE **SCALE**



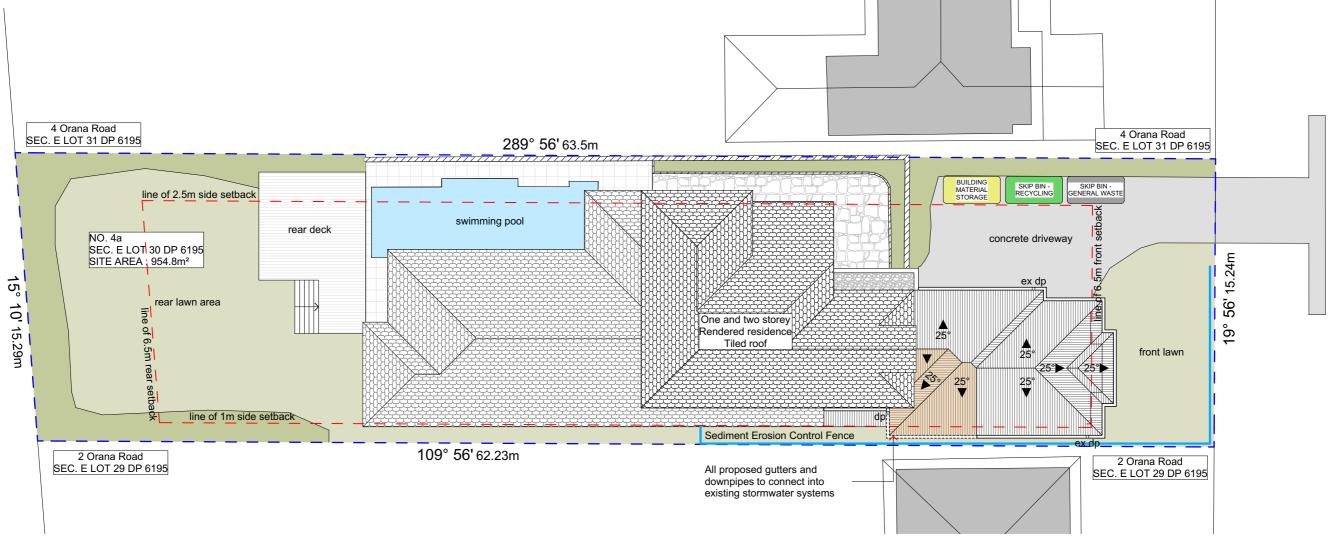

site / roof / sediment erosion / waste management / stormwater concept plan

1:200 @ A3

DUST CONTROL:

TO REDUCE DUST GENERATED BY WIND ACTION, THE 1. ALL EROSION AND SEDIMENT CONTROL MEASURES ALL STOCKPILES ARE TO BE KEPT ON-SITE WHERE REMOVAL OF THE TOP SOIL IS TO BE MINIMISED. TO PREVENT DUST GENERATION, WATERING DOWN OF THE SITE, ESPECIALLY DURING THE MOVEMENT OF MACHINERY IS REQUIRED. WHERE EXCAVATING INTO ROCK, KEEP THE SURFACE MOIST TO MINIMISE DUST. CONSTRUCT A GRAVEL ENTRY/EXIT POINT USING BLUE DRAINS, GUTTERS AND FOOTPATHS, OR WITHIN METAL AND RESTRICT ALL VEHICLE MOVEMENTS WITHIN THE SITE TO A MINIMUM. ENSURE WIND BREAKS, SUCH AS EXISTING FENCES ARE MAINTAINED SOON AS POSSIBLE, IF STORED ON SITE, IT MUST BE IF REQUIRED PROVIDE DIVERSION DRAIN & BANK DURING THE CONSTRUCTION PHASE UNTIL NEW LANDSCAPING IS PROVIDED OR REINSTATED. PREVENT DUST BY COVERING STOCKPILES

SEDIMENT NOTE:

TO BE INSPECTED AND MAINTAINED DAILY BY THE SITE POSSIBLE. ANY MATERIALS PLACED ON THE MANAGER.

2. MINIMISE DISTURBED AREAS, REMOVE EXCESS SOIL PERMISSION. FROM EXCAVATEDAREA AS SOON AS POSSIBLE. 3. ALL MATERIAL STOCKPILE TO BE CLEAR FROM SEDIMENT FENCE AREA.

4. DRAINAGE TO BE CONNECTED TO STORMWATER AS OVER STOCKPILES. FILTERED BEFORE RELEASING INTO STORMWATER SYSTEM OR WATERWAYS.

5. ROADS AND FOOTPATHS TO BE SWEPT DAILY.

STOCKPILES:


FOOTPATHS OR NATURE STRIPS REQUIRE COUNCIL'S

ALL STOCKPILES ARE TO BE PLACED AWAY FROM THE DRAINAGE LINES AND STREET GUTTERS. IT IS BEST TO LOCATE THESE ON THE HIGHEST PART OF THE SITE IF POSSIBLE. PLACE WATERPROOF COVERING

AROUND STOCKPILES.

GUTTER PROTECTION:

PROVIDE PROTECTION TO DOWNHILL GRATE IN GUTTER BY MEANS OF SAND BAGS OR BLUE METAL WRAPPED IN GEOTEXTILE FABRIC. WHEN SOIL OR SAND BUILDS UP AROUND THIS SEDIMENT BARRIER, THE MATERIAL SHOULD BE RELOCATED BACK TO THE SITE FOR DISPOSAL.

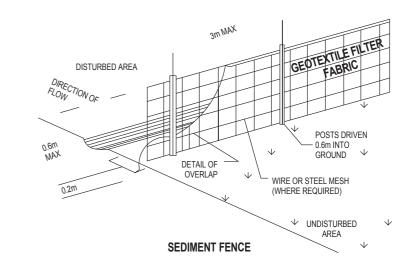


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CLIENT

Annie Pogson & Wayne

PROJECT ADDRESS

4A Orana Rd. Mona Vale NSW 2103

DRAWING NO.

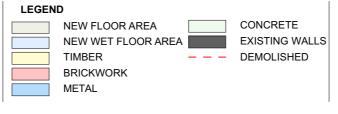S96.02

DATE

Thursday, 22 November 2018

DRAWING NAME

SITE / ROOF / SEDIMENT EROSION PLAN

SCALE


1:200 @A3





existing DA north elevation

1:100 @A3

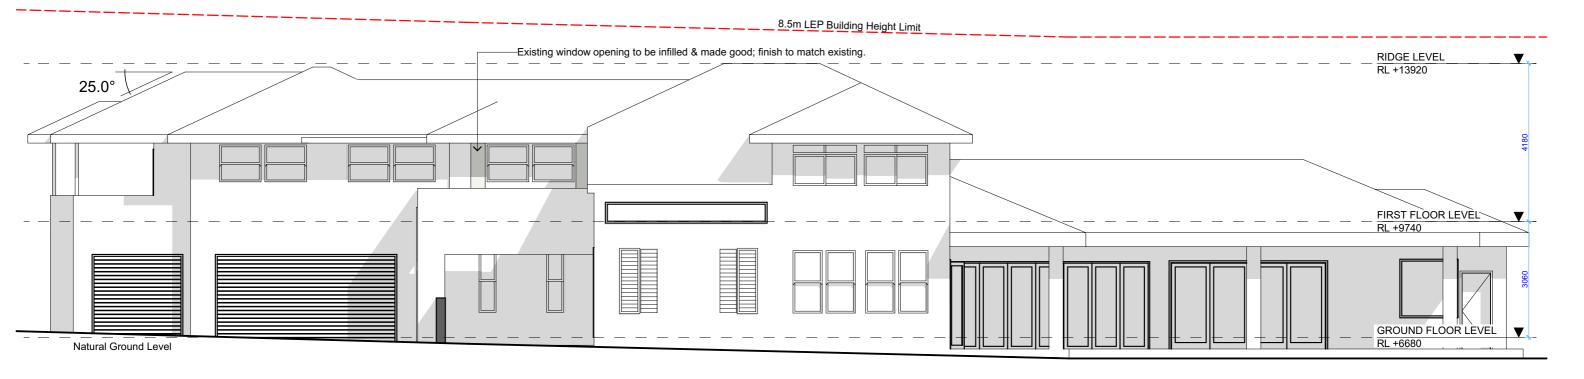

proposed S96 north elevation

1:100 @A3



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TIMBER TERRACOTTA ROOF TILES GLASS CONCRETE BRICKWORK EXISTING WALLS

LEGEND

CLIENT

Annie Pogson & Wayne

PROJECT ADDRESS

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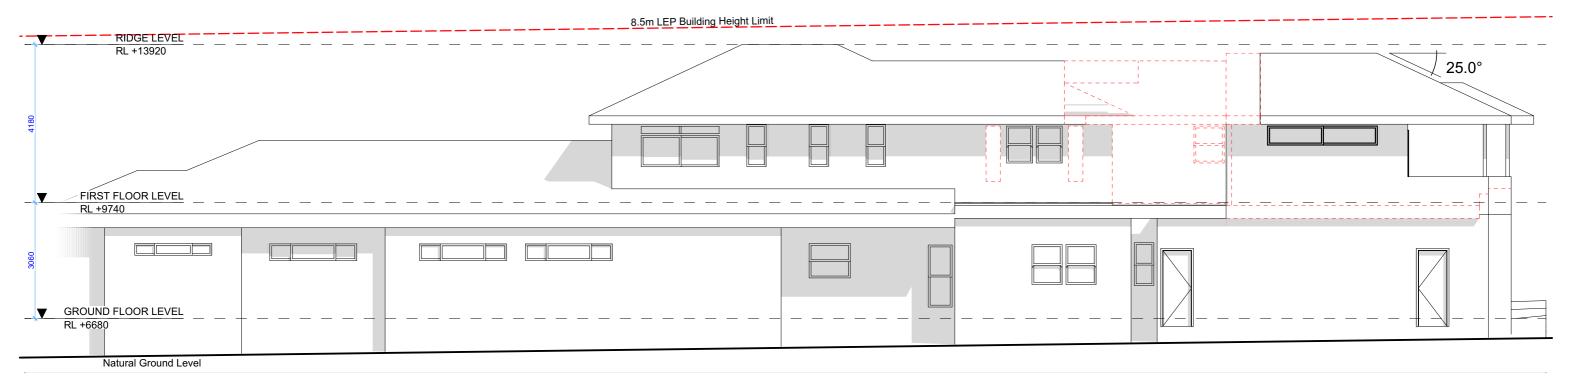
DRAWING NO.

S96.07

DATE Thursday, 22 November 2018


DRAWING NAME NORTH ELEVATION

SCALE 1:100 @A3



existing DA south elevation

1:100 @A3

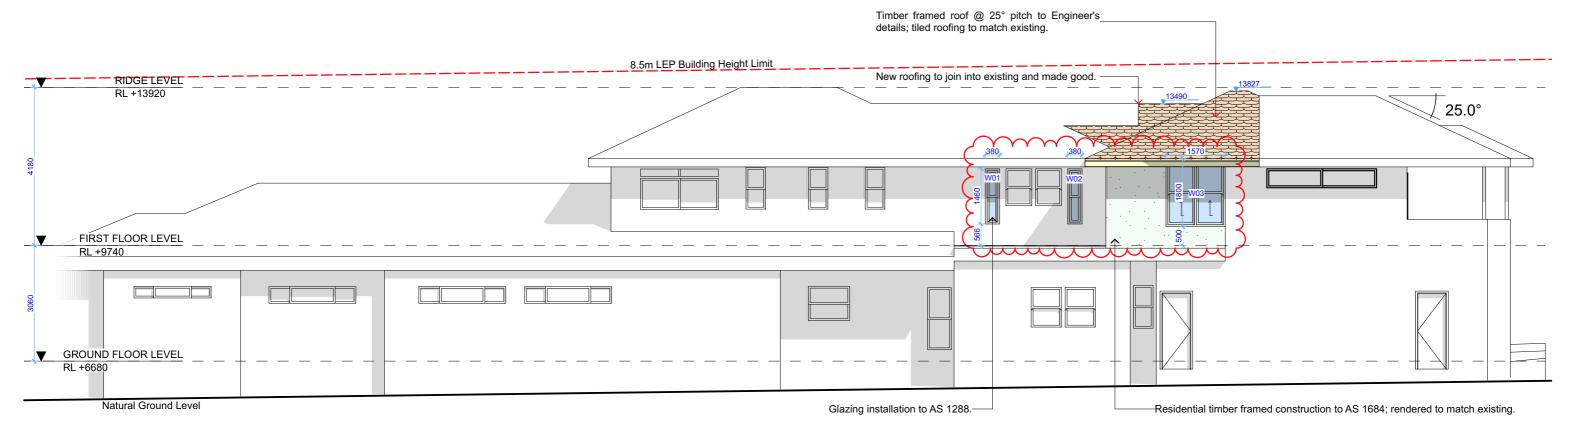

proposd S96 south elevation

1:100 @A3



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TIMBER TERRACOTTA ROOF TILES GLASS CONCRETE BRICKWORK **EXISTING WALLS**

LEGEND

CLIENT

Annie Pogson & Wayne

PROJECT ADDRESS

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DRAWING NO.


S96.08

DATE

Thursday, 22 November 2018 DRAWING NAME SOUTH ELEVATION

SCALE

1:100 @A3

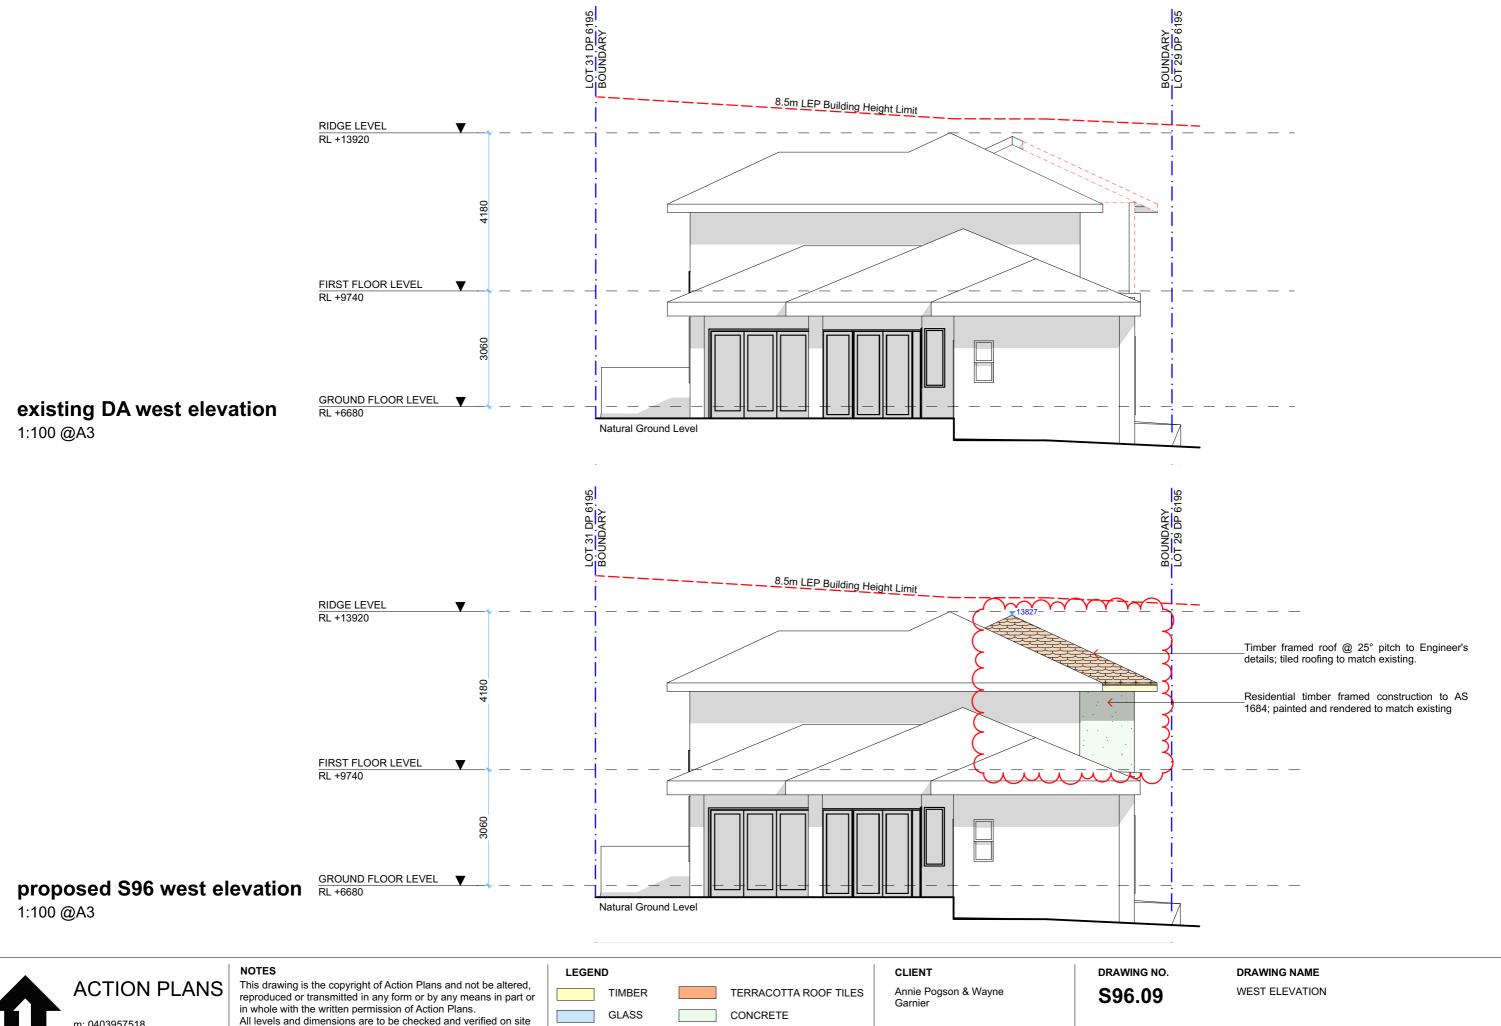


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PROJECT ADDRESS 4A Orana Rd, Mona Vale NSW 2103 DATE

Thursday, 22 November 2018 **SCALE** 1:100 @A3



proposed S96 east elevation

existing DA east elevation

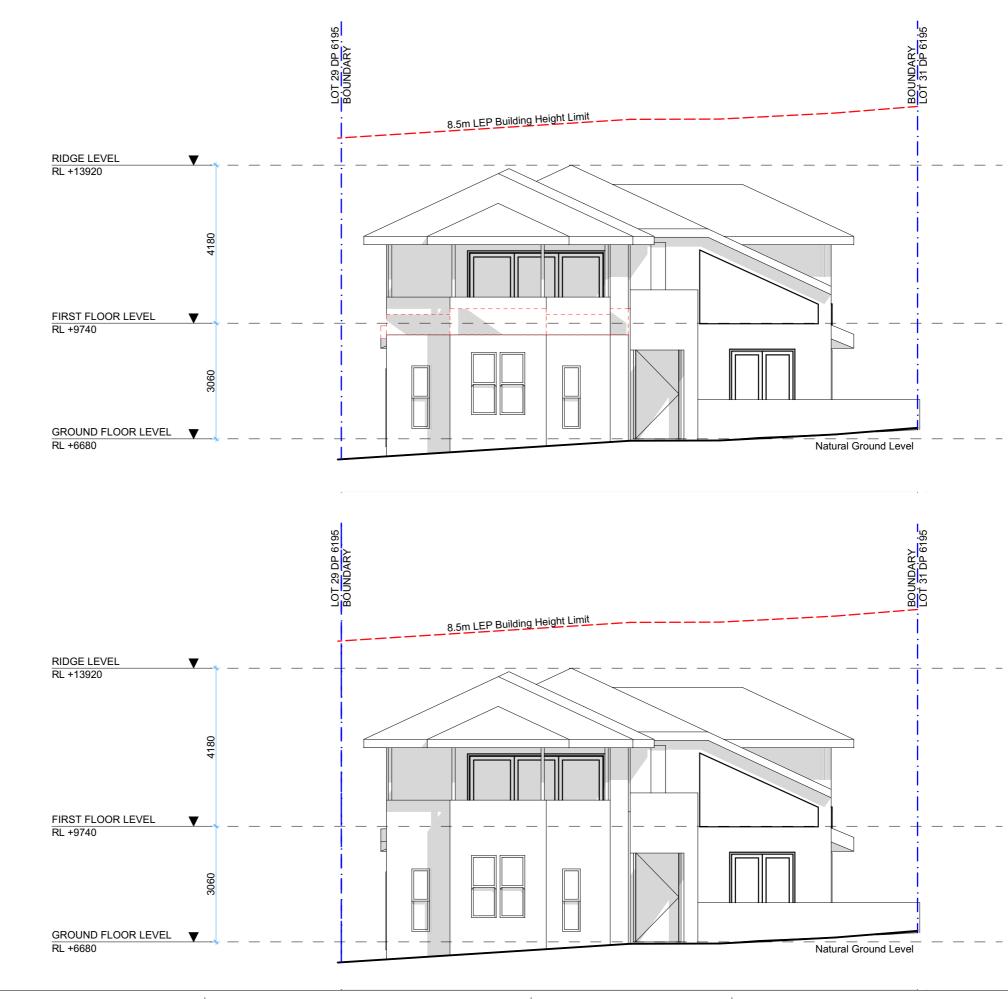1:100 @A3

1:100 @A3




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Annie Pogson & Wayne Garnier

PROJECT ADDRESS

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DRAWING NO.

S96.10

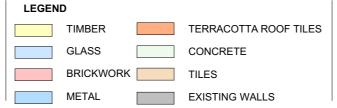
DATE

Thursday, 22 November 2018 DRAWING NAME

EAST ELEVATION

SCALE

1:100 @A3

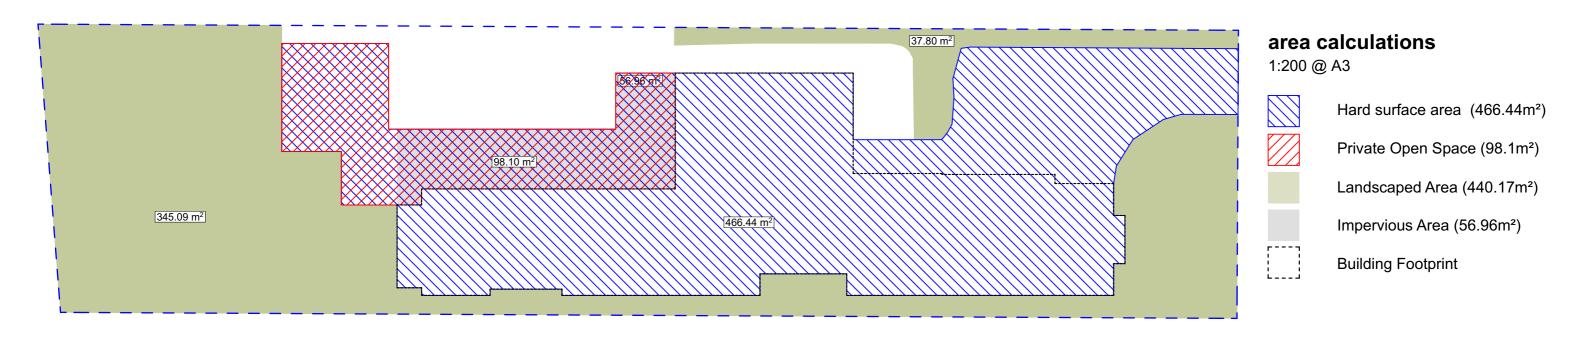

Note: No changes to area calculation from original DA application.

schedule of external finishes and colours







external cladding to be painted and rendered to match existing

new roofing to match existing

aluminium framed windows



OTES

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ID

CLIENTAnnie Pogson & Wayne

Garnier

PROJECT ADDRESS

4A Orana Rd, Mona Vale NSW 2103

DRAWING NO.

S96.13

DATE


Thursday, 22 November 2018

DRAWING NAME

AREA CALCULATIONS / SAMPLE BOARD

SCALE

1:200, 1:5.17, 1:7.29

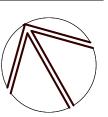



Building Sustainability Index www.basix.nsw.gov.au

Alterations and Additions

Certificate number: A287131_03

This certificate confirms that the proposed development will meet the NSW government's requirements for sustainability, if it is built in accordance with the commitments set out below. Terms used in this certificate, or in the commitments, have the meaning given by the document entitled "BASIX Alterations and Additions Definitions" dated 06/10/2017 published by the Department. This document is available at www.basix.nsw.gov.au

Secretary

Date of issue: Wednesday, 21, November 2018



Project address	
Project name	4a Orana Road_03
Street address	4a Orana Road Mona Vale 2103
Local Government Area	Pittwater Council
Plan type and number	Deposited Plan 6195
Lot number	30
Section number	F
Occilor Hamber	L
Project type	L
	Separate dwelling house

Certificate Prepared by (please complete before submitting to Council or PCA)
Name / Company Name: Action Plans
ABN (if applicable): 17118297587

Fixtures and systems	Show on DA Plans	Show on CC/CDC Plans & specs	Certifier Check
Lighting			
The applicant must ensure a minimum of 40% of new or altered light fixtures are fitted with fluorescent, compact fluorescent, or light-emitting-diode (LED) lamps.		~	✓
Fixtures	1	'	•
The applicant must ensure new or altered showerheads have a flow rate no greater than 9 litres per minute or a 3 star water rating.		✓	✓
The applicant must ensure new or altered toilets have a flow rate no greater than 4 litres per average flush or a minimum 3 star water rating.		✓	✓
The applicant must ensure new or altered taps have a flow rate no greater than 9 litres per minute or minimum 3 star water rating.		✓	

Construction			Show on DA Plans	Show on CC/CDC Plans & specs	Certifier Check
Insulation requirements					
The applicant must construct the new or altere the table below, except that a) additional insula is not required for parts of altered construction	√	√	√		
Construction	Additional insulation required (R-value)	Other specifications			
suspended floor above garage: framed (R0.7).	nil				
external wall: framed (weatherboard, fibro, metal clad)	R1.30 (or R1.70 including construction)				
flat ceiling, pitched roof	ceiling: R2.50 (up), roof: foil/sarking	medium (solar absorptance 0.475 - 0.70)			

Glazing requirements					Show on DA Plans	Show on CC/CDC Plans & specs	Certifier Check		
Windows an	d glazed d	loors							
	The applicant must install the windows, glazed doors and shading devices, in accordance with the specifications listed in the table below. Relevant overshadowing specifications must be satisfied for each window and glazed door.					~	~	~	
The following	requirements	s must also	be satisfie	ed in relation	n to each window and glazed door:			✓	✓
have a U-valu	e and a Sola	r Heat Gair	n Coefficie	nt (SHGC)		d glass may either match the description, or, le below. Total system U-values and SHGCs		✓	✓
	For projections described in millimetres, the leading edge of each eave, pergola, verandah, balcony or awning must be no more than 500 mm above the head of the window or glazed door and no more than 2400 mm above the sill.					✓	✓	✓	
Pergolas with	Pergolas with polycarbonate roof or similar translucent material must have a shading coefficient of less than 0.35.					✓	✓		
Pergolas with fixed battens must have battens parallel to the window or glazed door above which they are situated, unless the pergola also shades a perpendicular window. The spacing between battens must not be more than 50 mm.					✓	✓			
Windows a	nd glazed	l doors g	lazing re	equireme	nts				
	Window / door Orientation Area of Overshadowing Shading device Frame and glass type								
no.		glass inc. frame (m2)	Height (m)	Distance (m)					
W01	S	0.55	0	0	eave/verandah/pergola/balcony >=600 mm	standard aluminium, single clear, (or U-value: 7.63, SHGC: 0.75)			
W02	S	0.55	0	0	eave/verandah/pergola/balcony >=600 mm	standard aluminium, single clear, (or U-value: 7.63, SHGC: 0.75)			
W03	S	2.82	0	0	eave/verandah/pergola/balcony >=600 mm	standard aluminium, single clear, (or U-value: 7.63, SHGC: 0.75)			

In these commitments, "applicant" means the person carrying out the development.

Commitments identified with a "\"" in the "Show on DA plans" column must be shown on the plans accompanying the development application for the proposed development (if a development application is to be lodged for the proposed development).

Commitments identified with a "\rightarrow" in the "Show on CC/CDC plans & specs" column must be shown in the plans and specifications accompanying the application for a construction certificate / complying development certificate for the proposed development.

Commitments identified with a "\"" in the "Certifier check" column must be certified by a certifying authority as having been fulfilled, before a final occupation certificate for the development may be issued.

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CLIENT

Annie Pogson & Wayne Garnier

PROJECT ADDRESS

4A Orana Rd. Mona Vale NSW 2103

DRAWING NO.

DRAWING NAME

S96.17

BASIX COMMITMENTS

DATE Thursday, 22 November 2018 SCALE

1:1.43 @A3