# DEVELOPMENT APPLICATION

## 13 ILYA AVENUE - BAYVIEW



ARTIST IMPRESSION

## **INDEX OF DRAWINGS:**

DA.01 SITE PLAN (SCALE1:500)

DA.02 SITE ANALYSIS PLAN

DA.03 TOP TERRACE FLOOR PLAN

DA.04 LOWER GROUND FLOOR PLAN

DA.05 GROUND FLOOR PLAN

DA.06 NORTH ELEVATION

DA.07 EAST ELEVATION

DA.08 WEST ELEVATION

DA.09 SOUTH ELEVATION / BASIX NOTES

DA.10 SECTION AA / SPECIFICATION NOTES

DA.11 ROOF PLAN AND STORMWATER CONCEPT PLAN

DA.12 LANDSCAPE AREA CALCULATION PLAN

DA.13 LANDSCAPE CONCEPT PLAN

DA.14 EROSION & SEDIMENT CONTROL / WASTE

MANAGEMENT PLAN

DA.15 SHADOW DIAGRAM JUNE21 @ 9AM

DA.16 SHADOW DIAGRAM JUNE21 @ 12NOON

DA.17 SHADOW DIAGRAM JUNE21 @ 3PM










JJ DRAFTING PTY LTD 1300977804 www.jjdrafting.com.au

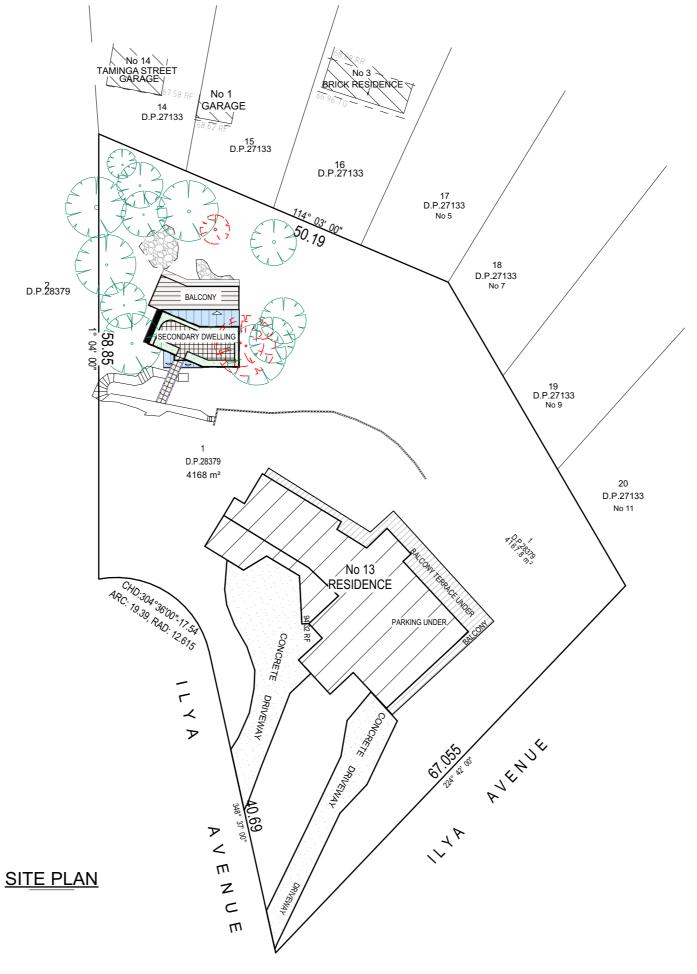



TRUE NORTH:



- NOTES (E & OE)

  All structures including stormwater & drainage to engineer's details.

  Do not obtain dimensions by scaling drawings.

  All dimensions are to be checked on site prior to starting work.

  These drawings are to be read in conjunction with all other consultant's drawings and specifications.

  All workmanship & materials shall be in accordance with the requirements of current editions including amendments of the National Construction Code, relevant Australian Standards & local
- Au workmanship & materials shall be in accordance with the requirements of current editions including amendments of the National Construction Code, relevant Australian Standards & local council requirements.
   New materials are to be used throughout unless otherwise noted.
   Concrete footings, slab, structural beams or any other structural members are to be designed by a contribution orderior and of the contribution of the cont
- by a practicing engineer.


JJ Drafting
Division of JJ DRAFTING AUSTRALIA PTY LTD
6/90 Mona Vale Road, Mona Vale, NSW, 2103


PO Box 687, Dee Why, NSW, 2099 Mob. 0414 717 541 | Email. jjdraft@tpg.com.au www.jjdrafting.com.au ACN 651 693 346


	REV:	DATE:	DESCRIPTION:	ı
	Α	01/09/22	PRELIM. DRAWINGS UPDATED	
	В	06/09/22	PRELIM. DRAWINGS UPDATED	
13				
				L
au				Γ
				L


PROPOSED NEW SECONDARY DWELLING 13 ILYAAVENUE - BAYVIEW NSW 2104 CLIENT: Rex Pemberton	
DRAWING TITLE: SITE PLAN	

DATE: April/22	DRAWN BY:	SCALE: 1:500 @ A3
JOB No: 1021/22	CHECKED BY:	DRAWING No:  DA.01

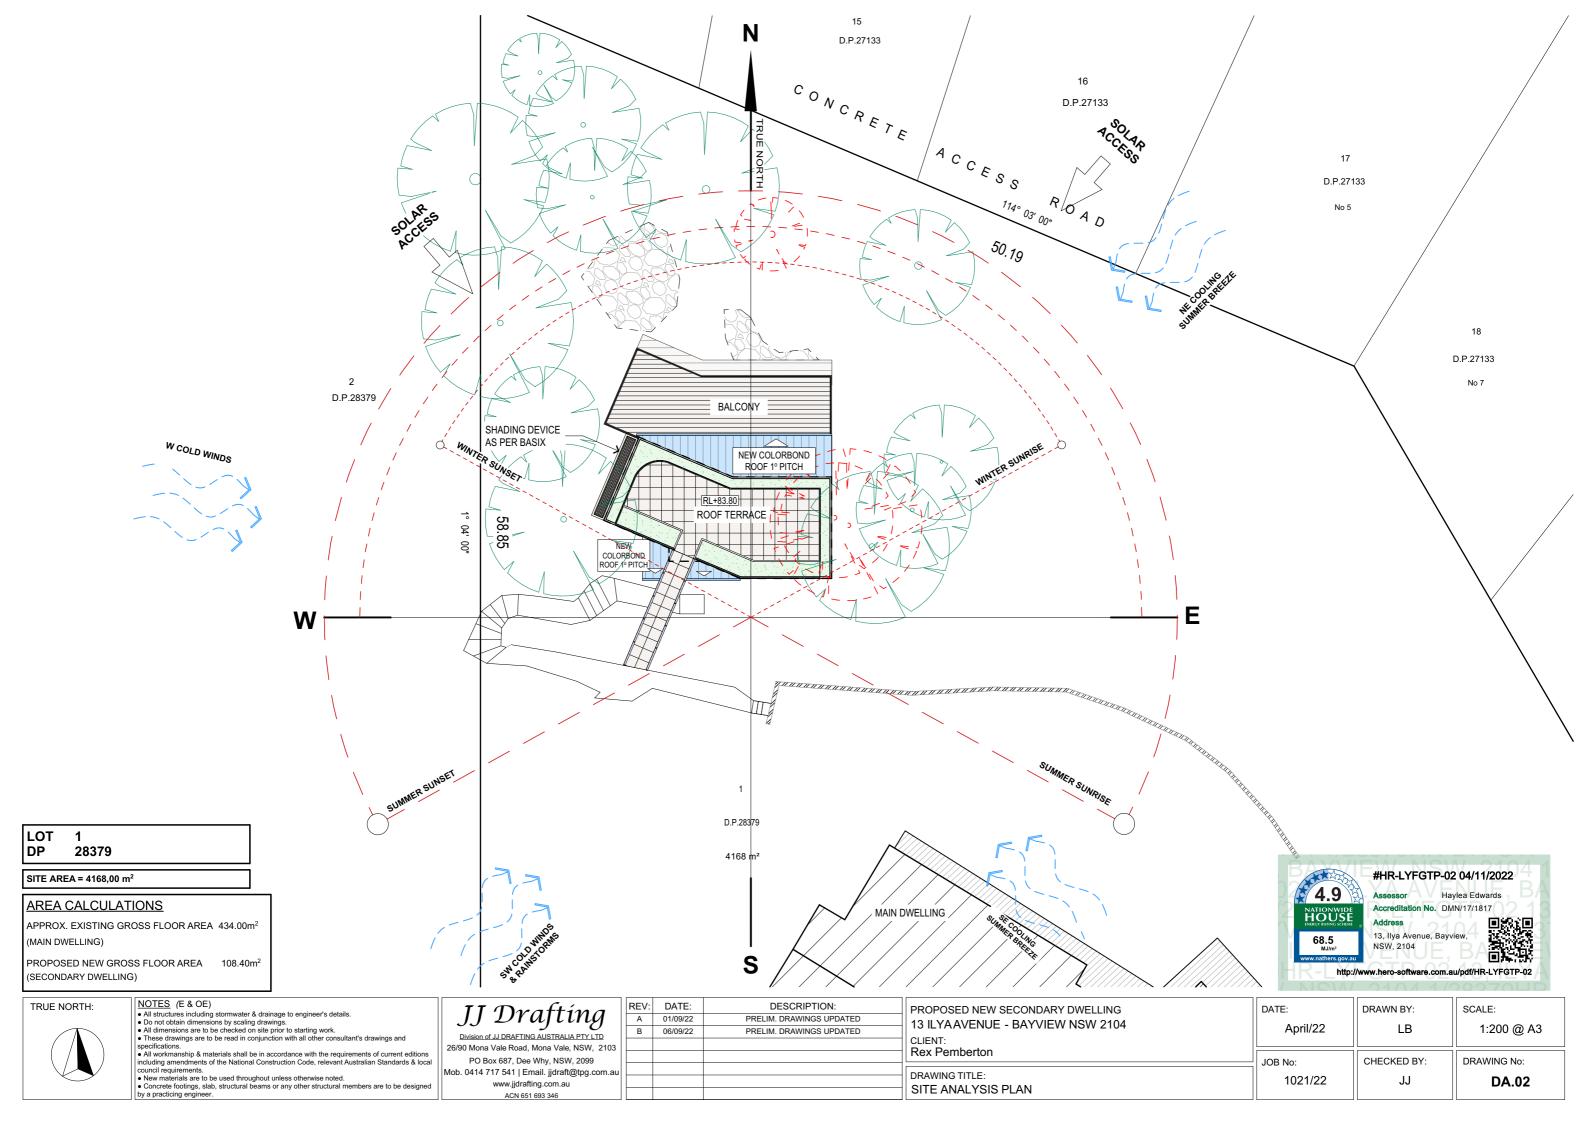

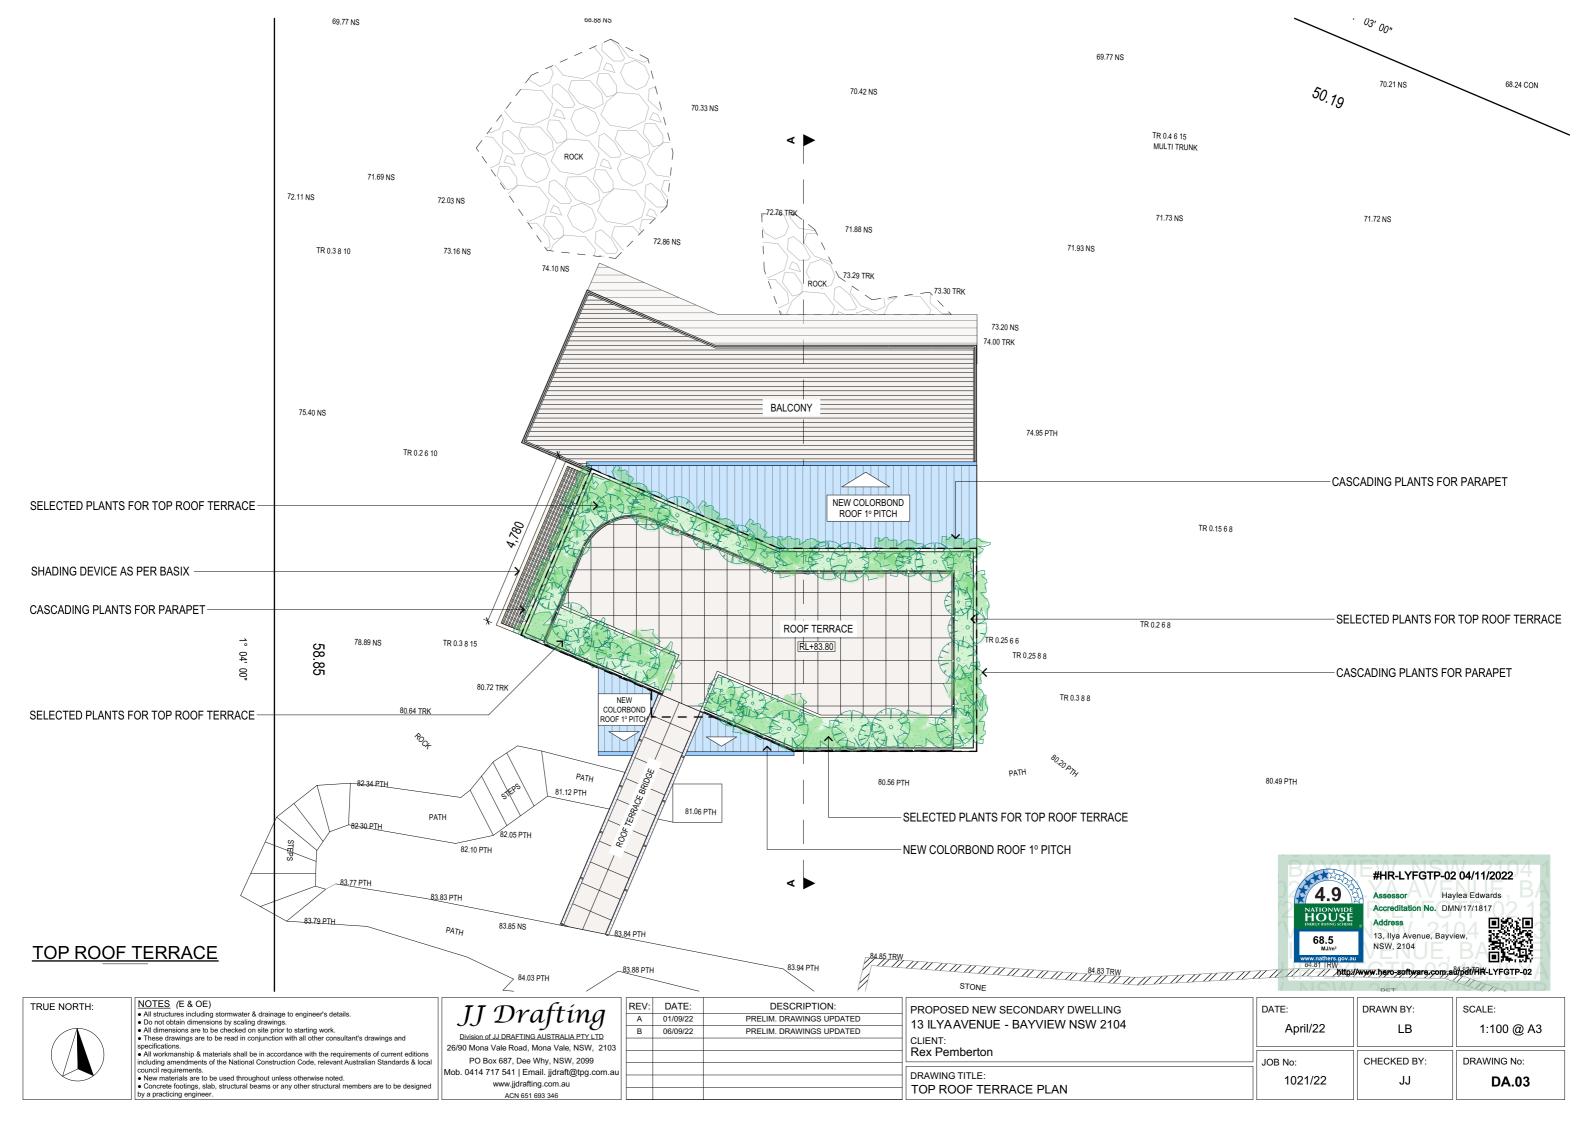

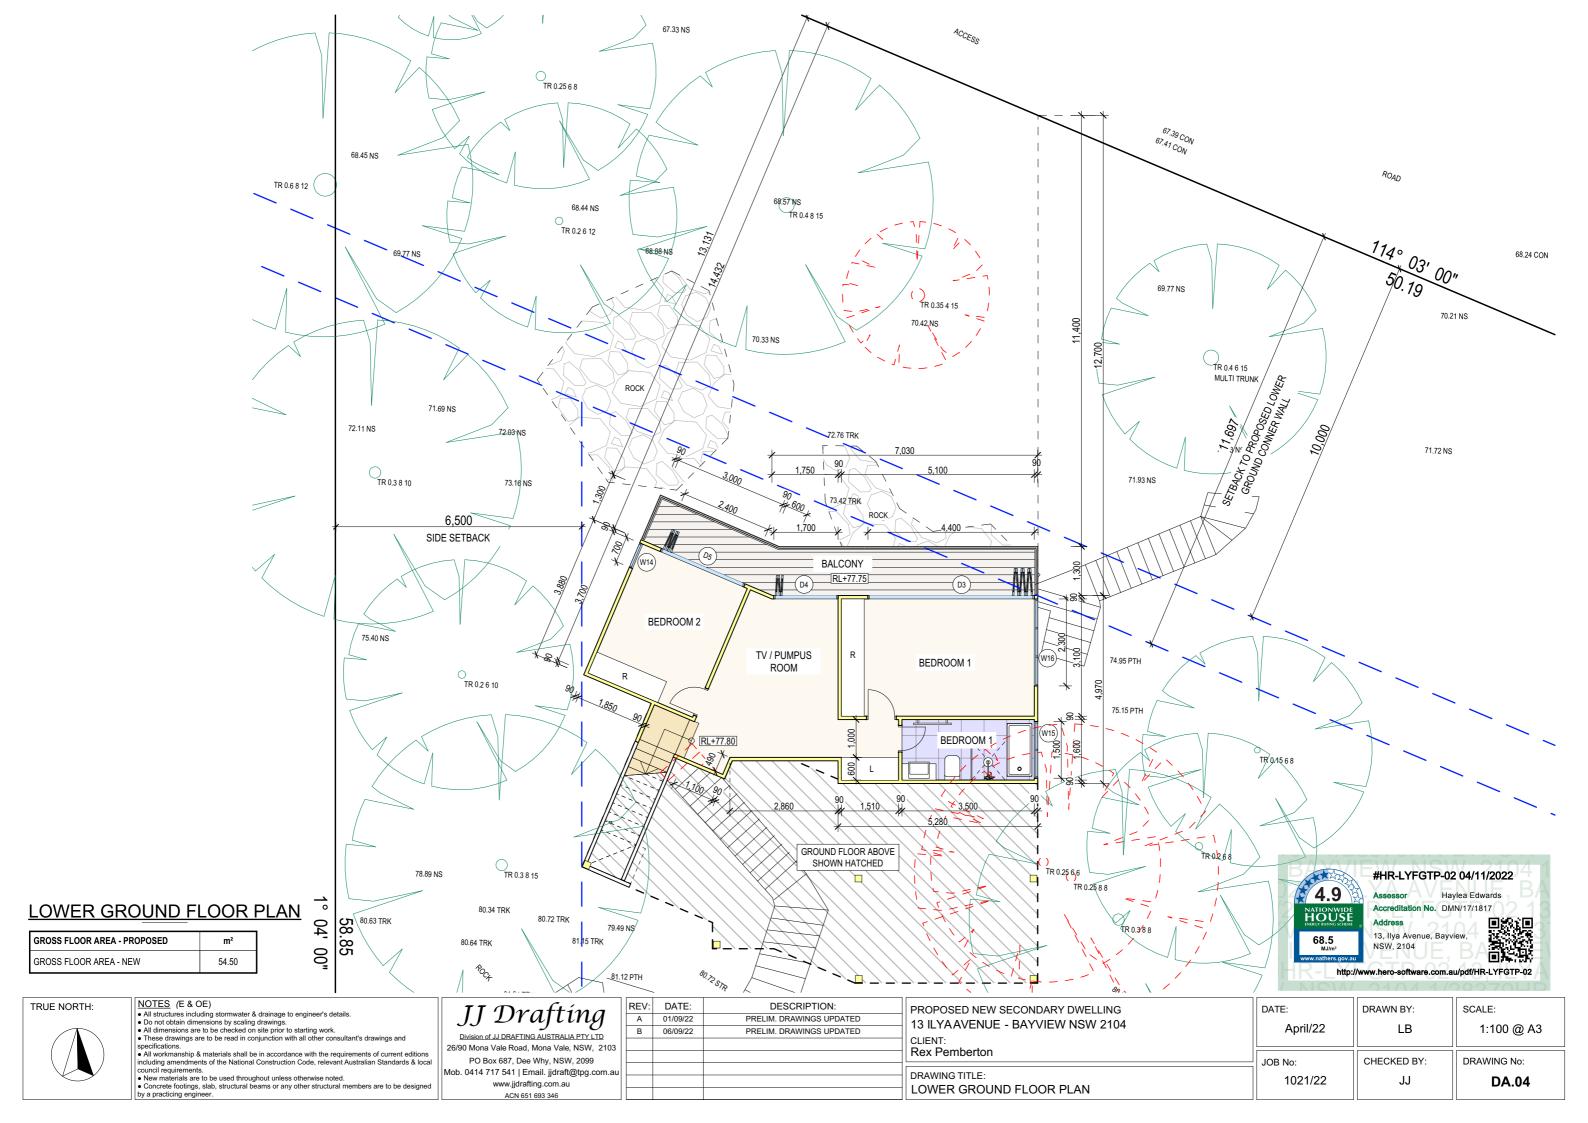

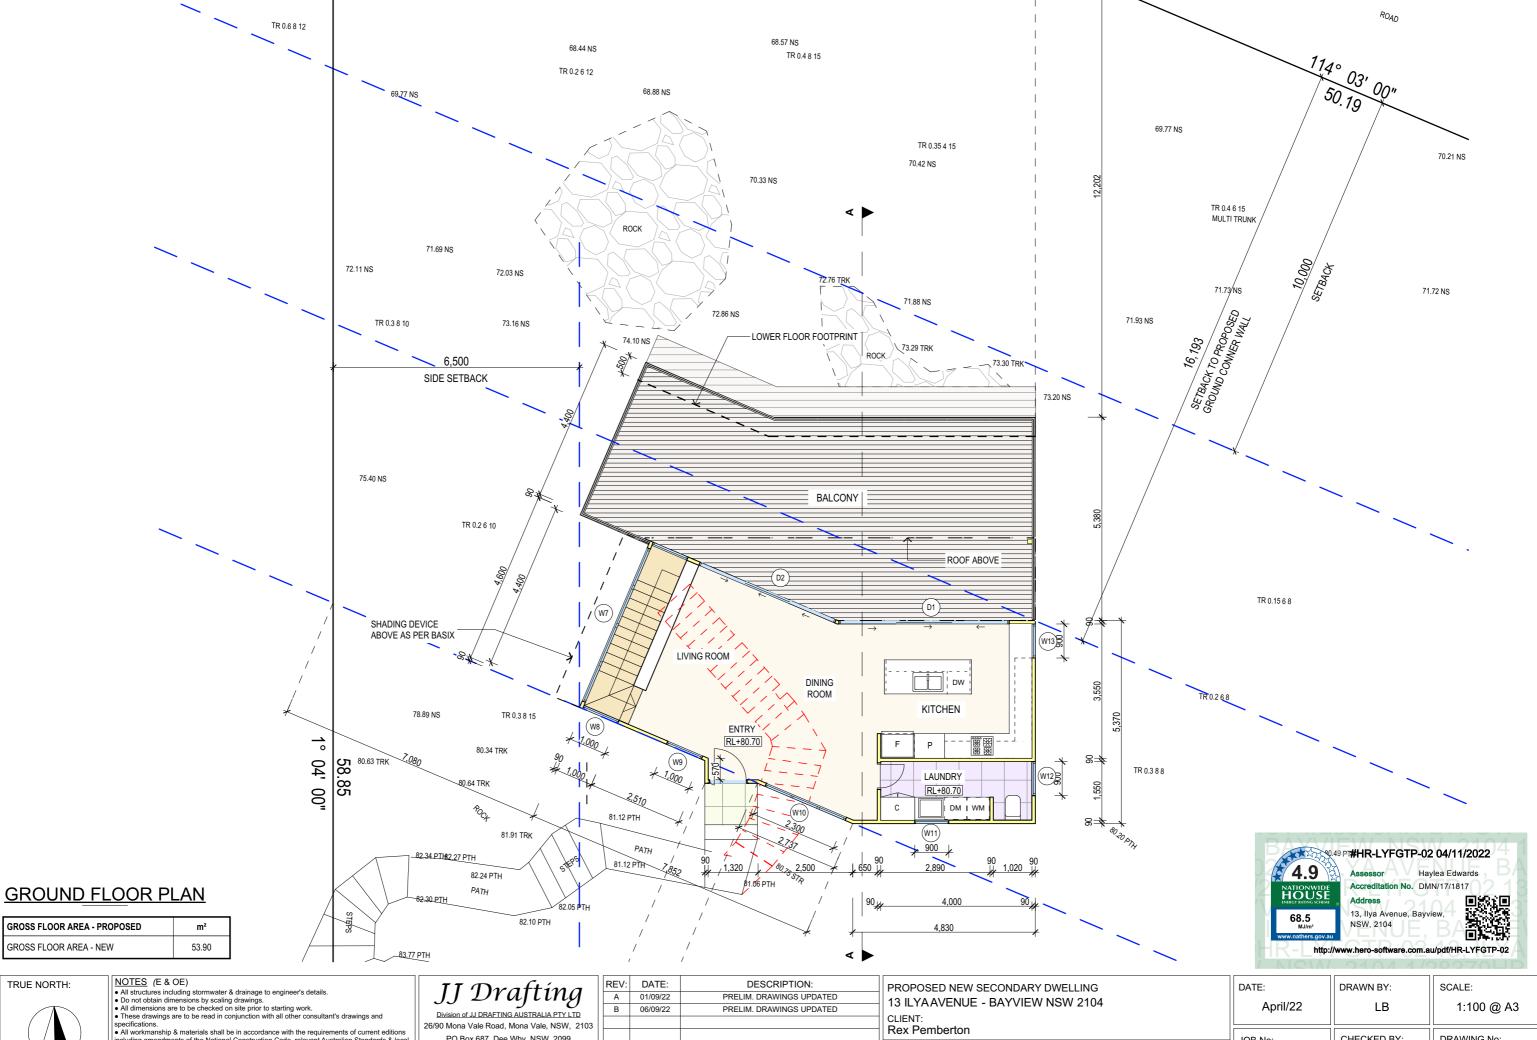



New materials are to be used throughout unless otherwise noted.
 Concrete footings, slab, structural beams or any other structural members are to be designed.


by a practicing engineer.

PO Box 687, Dee Why, NSW, 2099 Mob. 0414 717 541 | Email. jjdraft@tpg.com.au www.jjdrafting.com.au ACN 651 693 346

	REV:	DATE:	DESCRIPTION:
	Α	01/09/22	PRELIM. DRAWINGS UPDATED
	В	06/09/22	PRELIM. DRAWINGS UPDATED
3			
au			


PROPOSED NEW SECONDARY DWELLING 13 ILYAAVENUE - BAYVIEW NSW 2104	
CLIENT: Rex Pemberton	L
DRAWING TITLE: GROLIND FLOOR PLAN	ľ

DATE:	DRAWN BY:	SCALE:
April/22	LB	1:100 @ A3
JOB No:	CHECKED BY:	DRAWING No:
1021/22	JJ	DA.05

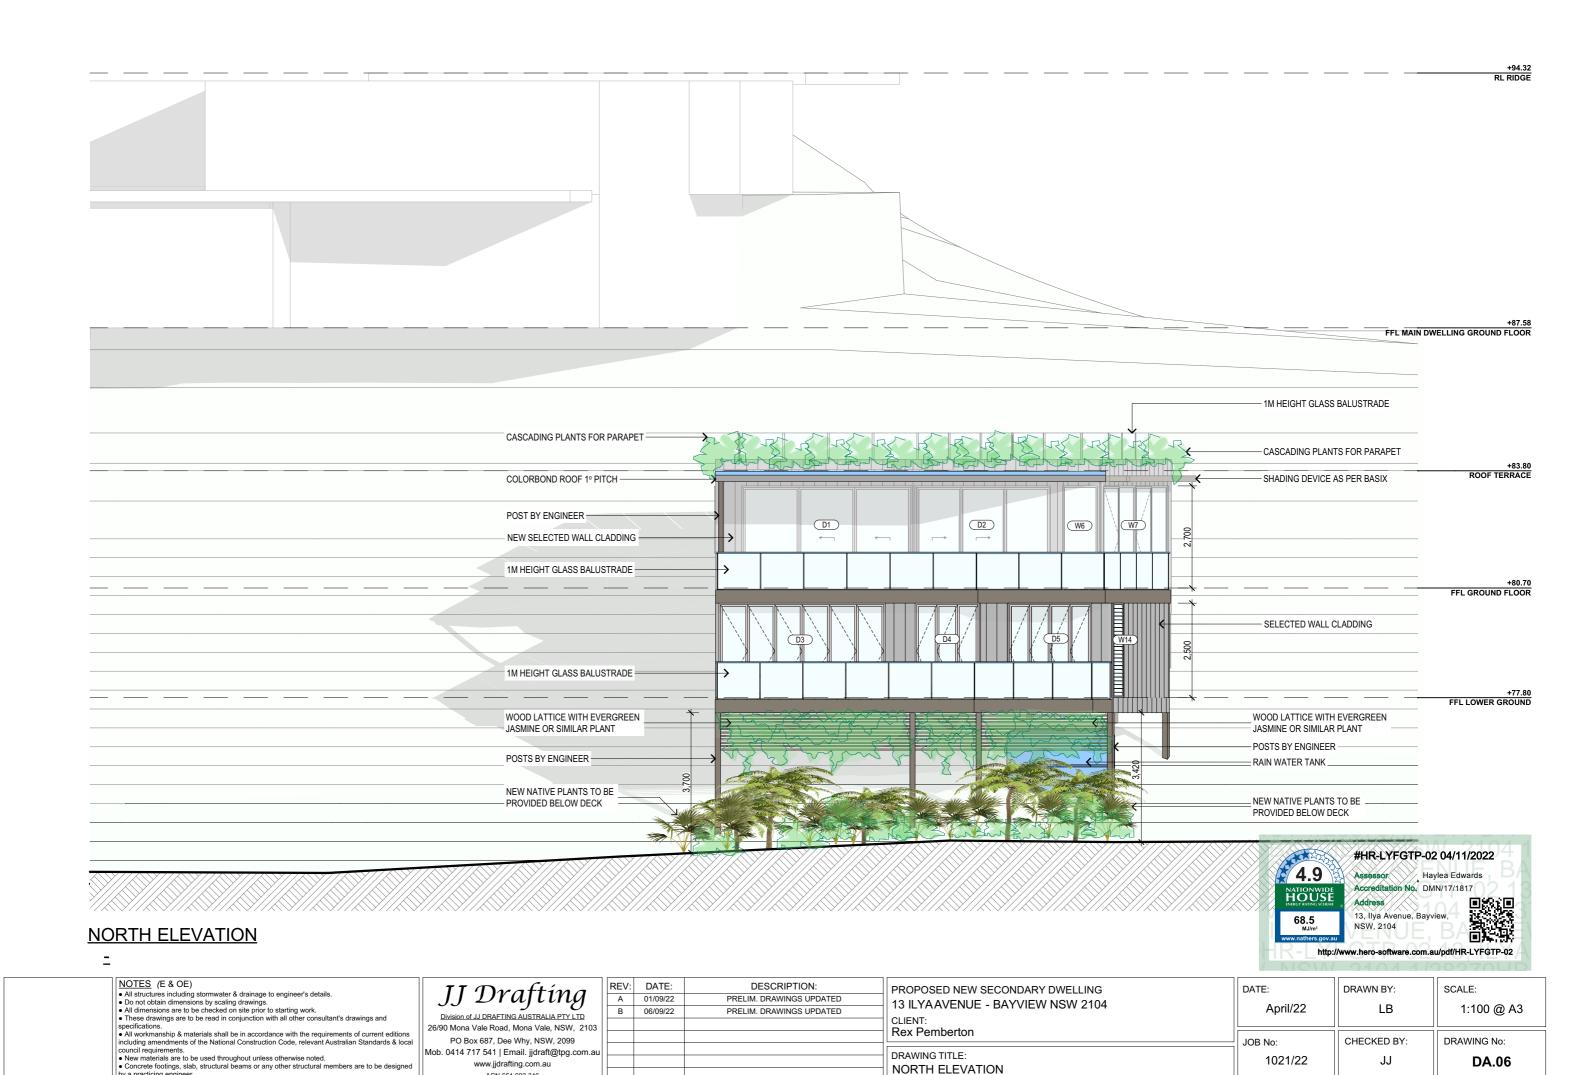

by a practicing engineer.

ACN 651 693 346

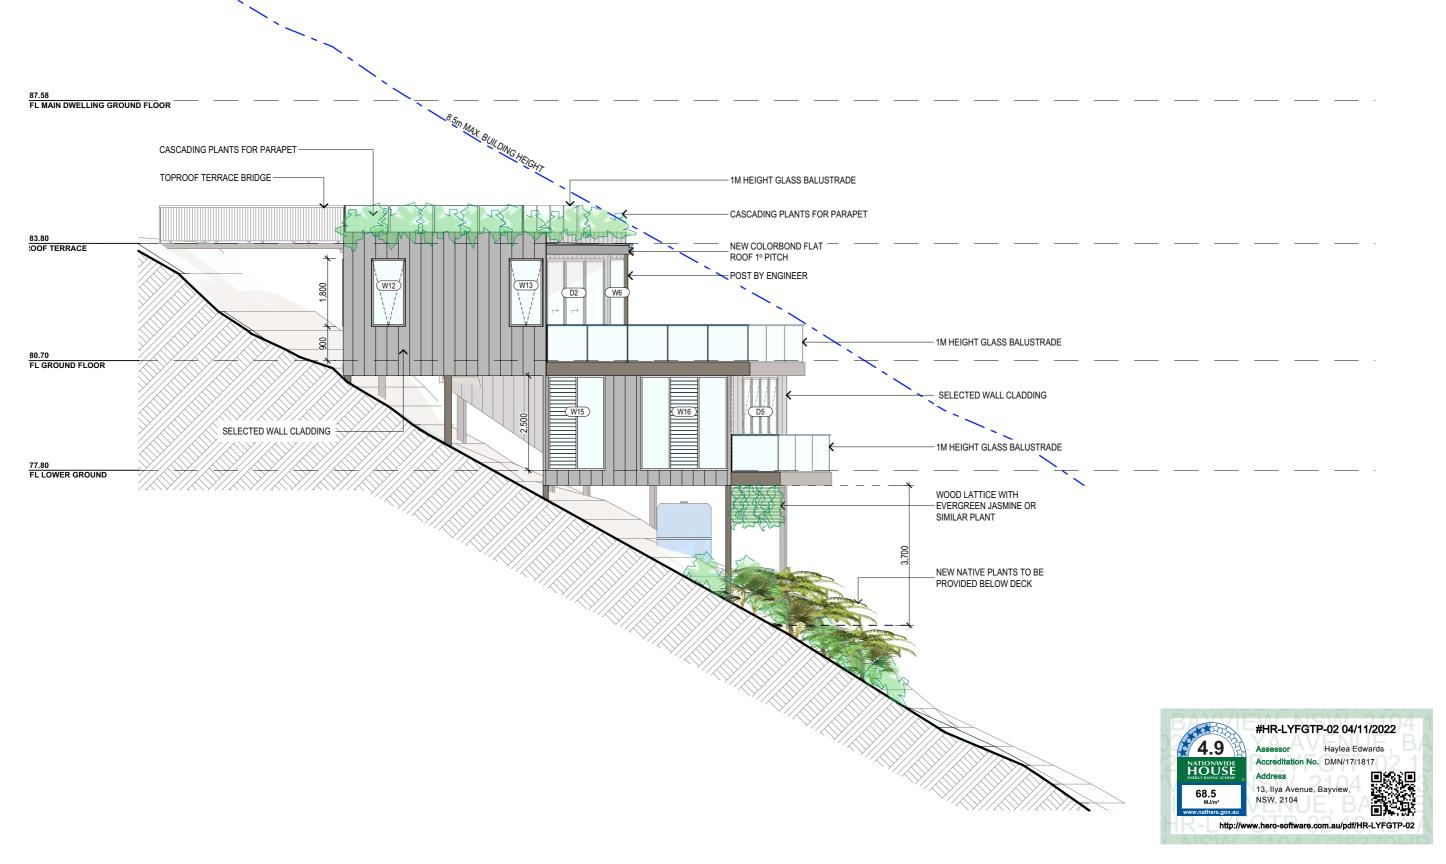

# **EAST ELEVATION**

- NOTES (E & OE)

  All structures including stormwater & drainage to engineer's details.

  Do not obtain dimensions by scaling drawings.

  All dimensions are to be checked on site prior to starting work.

  These drawings are to be read in conjunction with all other consultant's drawings and specifications.
- These drawings are to be read in conjunction with all other consultant's drawings and specifications.
   All workmanship & materials shall be in accordance with the requirements of current editions including amendments of the National Construction Code, relevant Australian Standards & local council requirements.
   New materials are to be used throughout unless otherwise noted.
   Concrete footings, slab, structural beams or any other structural members are to be designed by a practicing engineer.


# II Draftina

REV: DATE: A 01/09/22 06/09/22

33 2 reg coreg
Division of JJ DRAFTING AUSTRALIA PTY LTD
26/90 Mona Vale Road, Mona Vale, NSW, 2103
PO Box 687, Dee Why, NSW, 2099
Mob. 0414 717 541   Email. jjdraft@tpg.com.au
www.jjdrafting.com.au
ACN 651 693 346


DESCRIPTION: PRELIM. DRAWINGS UPDATED PRELIM. DRAWINGS UPDATED	PROPOSED NEW SECONDARY DWELLING 13 ILYA AVENUE - BAYVIEW NSW 2104 CLIENT: Rex Pemberton	D.
	DRAWING TITLE: EAST ELEVATION	

DATE:	DRAWN BY:	SCALE:
April/22	LB	1:100 @ A3
JOB No:	CHECKED BY:	DRAWING No:
1021/22	JJ	DA.07

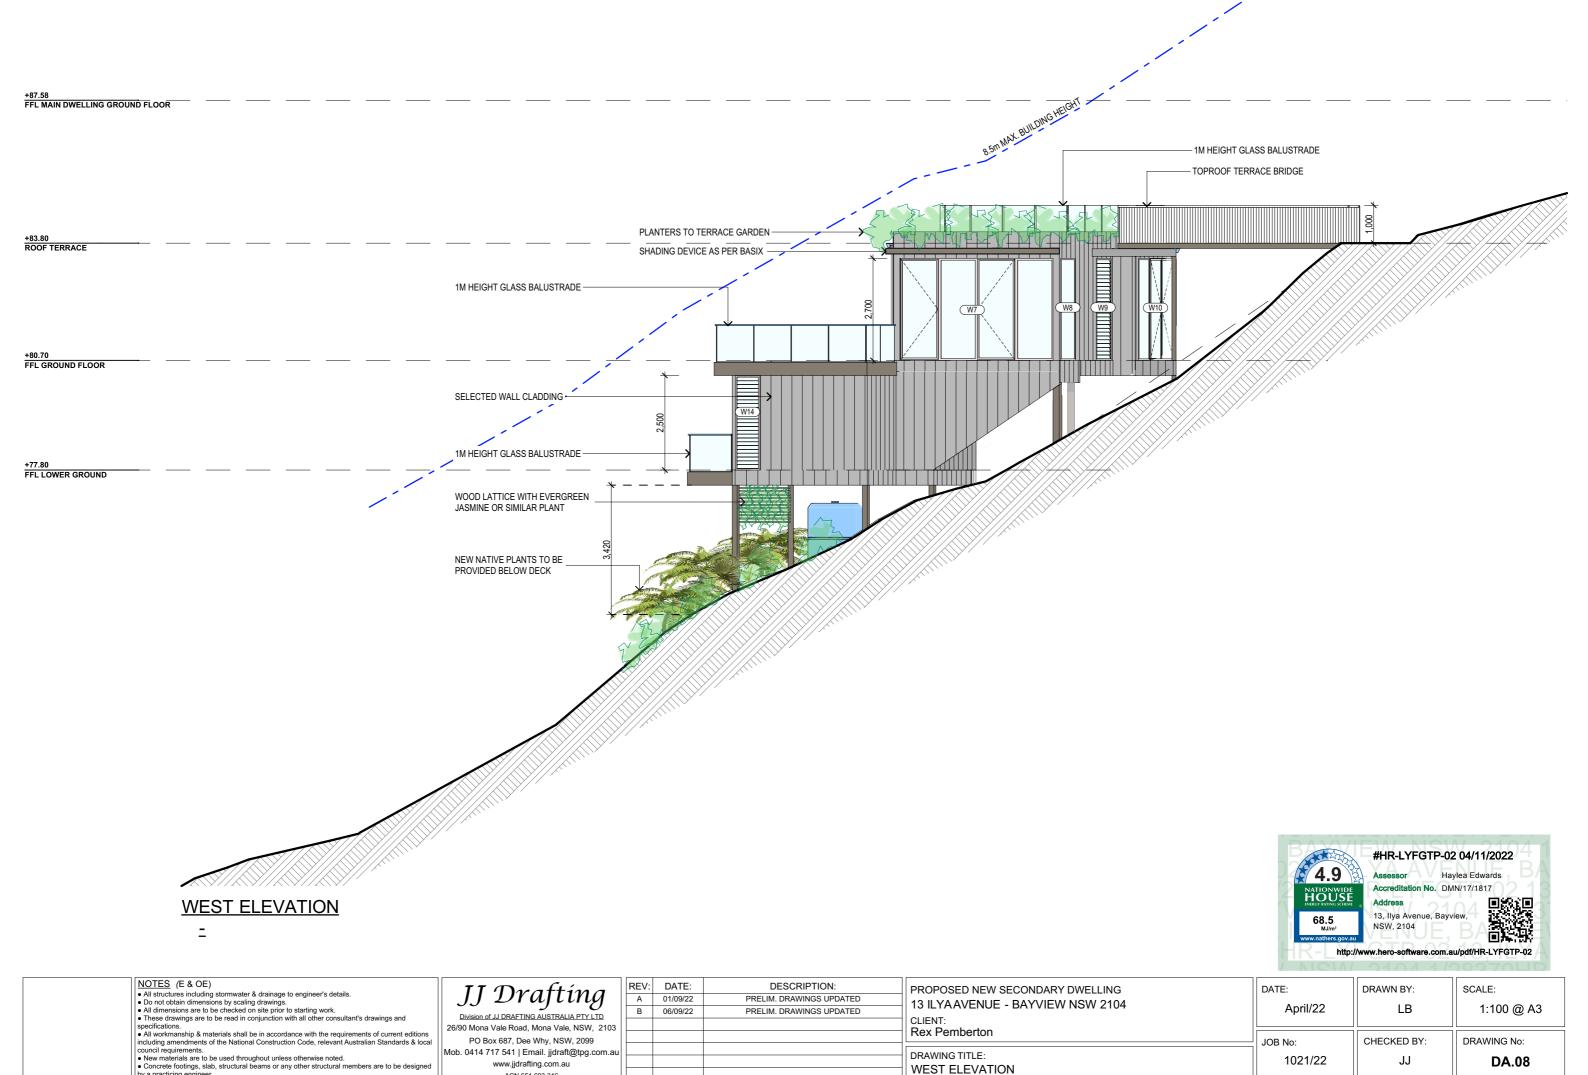

by a practicing engineer.

ACN 651 693 346

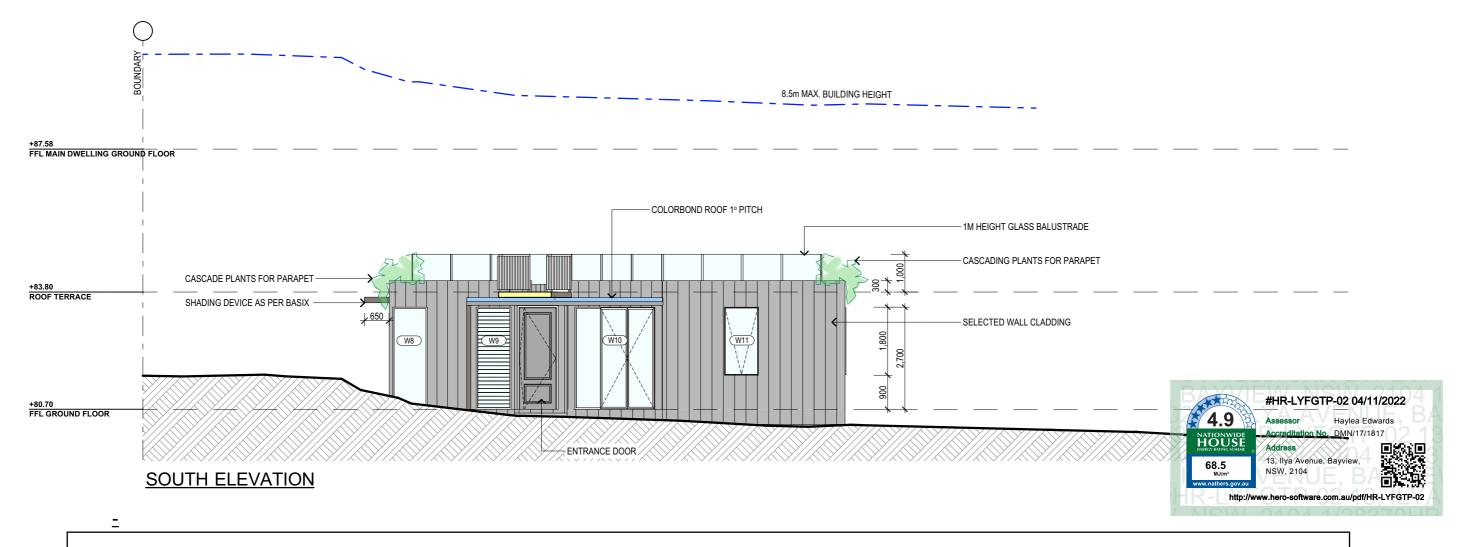

## **BASIX REQUIREMENT:**

BASIX INCLUSIONS FOR 13 ILYAAVENUE - BAYVIEW

#### **External walls**

Lightweight cladding on framed walls with R2.5 insulation (insulation only value) External colour:

Medium (0.475 < SA < 0.7)

#### Walls within dwellings

Plasterboard on studs, no insulation required

Plasterboard on studs with R2.5 insulation on the internal walls of bathroom and laundry and habitable areas

#### Glazing doors/windows

Glazed windows and doors:

Group A - awning + bifold + casement windows + hinged glazed doors

U-value: 6.70 (equal to or lower than) SHGC: 0.57 (±10%)

Group B - sliding doors/windows + fixed glazing + louvred windows

U-value: 6.70 (equal to or lower than) SHGC: 0.70 (±10%)

## Upgrades as per NatHERS certificate:

Group A - awning + bifold + casement windows + hinged glazed doors

U-value: 2.20 (equal to or lower than) SHGC: 0.32 (±10%)

Group B - sliding doors/windows

U-value: 3.60 (equal to or lower than) SHGC: 0.54 (±10%)

Group B - Fixed glazing

U-value: 3.40 (equal to or lower than) SHGC: 0.33 (±10%)

Group B - Louvred windows

U-value: 4.90 (equal to or lower than) SHGC: 0.33 (±10%) Given values are AFRC total window system values (glass and frame)

External colour:

Medium (0.475 < SA < 0.7)

#### **Floors**

Suspended timber floor with R4.0 insulation (insulation only value) to open and enclosed suspended areas

#### Roof and ceilings

Plasterboard ceiling with R4.0 insulation (insulation only value) where metal roof above

External colour

Medium (0.475 < SA < 0.7)

Ceiling penetrations

Sealed LED downlights, as per electrical plan, modelled as 150mm diameter

Sealed externally ducted exhaust fans, modelled as 200mm diameter Ceiling fans 1300mm diameter to bedrooms, living room and rumpus Penetrations not to exceed NatHERS certificate

#### Floor coverings

Tiles to wet areas; carpet with rubber underlay to bedrooms and rumpus; timber elsewhere

## External shading

Shading as per stamped drawings

#### **Ventilation**

All external doors have weather seals, all exhaust fans and chimneys have dampers, and down lights will be sealed.

## **BASIX Water Commitments**

#### Fixtures

Install showerheads minimum rating of 3 stars - High flow (>7.5 and <= 9 litres/min) Install toilet flushing system with a minimum rating of 4 stars in each toilet Install tap with a minimum rating of 3 stars in the kitchen Install taps with a minimum rating of 3 stars in each bathroom

## Alternative water

Install rainwater tank, minimum 3,000L capacity collected from min. 150m² roof area. Tank connected to - at least one outdoor tap, and all toilets

## **BASIX Energy Commitments**

Hot water system

Gas instantaneous - 6 Stars

## Cooling system

1-phase air-conditioning to living areas and bedrooms: EER 3.0-3.5 Day-night zoned

#### Heating system

1-phase air-conditioning to living areas and bedrooms: EER 3.0-3.5 Day-night zoned

Bathrooms - individual fan, externally ducted to roof or façade, manual on/off switch Kitchen - individual fan. not ducted, manual on/off switch

Laundry - individual fan, externally ducted to roof or façade, manual on/off switch

## Other

Electric cooktop & electric oven Outdoor clothes drying line

## **Alternative Energy**

1kW PV System

## NOTES (E & OE)

- All structures including stormwater & drainage to engineer's details.
  Do not obtain dimensions by scaling drawings.
  All dimensions are to be checked on site prior to starting work.
  These drawings are to be read in conjunction with all other consultant's drawings and
- specifications.

   All workmanship & materials shall be in accordance with the requirements of current editions
- New materials are to be used throughout unless otherwise noted.
   New materials are to be used throughout unless otherwise noted.
   Concrete footings, slab, structural beams or any other structural members are to be designed. by a practicing engineer.

# II Draftina

Division of JJ DRAFTING AUSTRALIA PTY LTD
26/90 Mona Vale Road, Mona Vale, NSW, 2103
PO Box 687, Dee Why, NSW, 2099
Mob. 0414 717 541   Email. jjdraft@tpg.com.au
www.jjdrafting.com.au
ACN 651 693 346

_				
1	REV:	DATE:	DESCRIPTION:	PROPOSED NEW SECO
ı	Α	01/09/22	PRELIM. DRAWINGS UPDATED	13 ILYAAVENUE - BAY
l	В	06/09/22	PRELIM. DRAWINGS UPDATED	
ı				CLIENT:
ı				Rex Pemberton
ı				DRAWING TITLE:
				SOUTH ELEVATION /

PROPOSED NEW SECONDARY DWELLING 13 ILYAAVENUE - BAYVIEW NSW 2104	
CLIENT: Rex Pemberton	
DRAWING TITLE: SOUTH ELEVATION / BASIX NOTES	

DATE:	DRAWN BY:	SCALE:
April/22	LB	1:100 @ A3
IOB No:	CHECKED BY:	DRAWING No:
1021/22	JJ	DA.09
		1

# **SPECIFICATION NOTES**

- PROVIDE PLASTERBOARD LINING. - INSTALL TO MANUFACTURERS SPECIFICATIONS & AS 2589

EXTERNAL WALLS:
- LIGHTWEIGHT TIMBER OR COMPOSITE WALL CLADDING IN ACCORDANCE WITH NCC VOL 2 PART 3.5.4. - LIGHTWEIGHT METAL WALL CLADDING IN ACCORDANCE WITH NCC VOL 2 PART 3.5.5.

- GROUND FLOOR TO BE SUSPENDED TIMBER FRAMED FINISHED WITH T&G HARDWOOD FLOORING. FIRST FLOOR TO BE TIMBER FRAMED FINISHED WITH T&G HARDWOOD FLOORING.

- ALL WATERPROOFING TO AS 3740

- PROVIDE A GUARANTEED FLEXIBLE WATERPROOF MEMBRANE TO ALL WET AREA FLOORS & SHOWERS WALLS

- SHALL BE INSTALLED TO COMPLY WITH AS1684 AS AMENDED FOR TIMBER COMPONENTS OR AS3620 FOR LIGHTWEIGHT STEEL FRAMING SECTIONS OR AS PER THE NASH ALTERNATIVES TO AS 3623.

SHALL BE INSTALLED IN ACCORDANCE WITH AS3660.

# PROFILED STEEL ROOF: - COLORBOND ROOF CLADDING

- NCC VOL.2 PART 3.5.1.

- DESIGN AND INSTALLATION SHALL BE IN ACCORDANCE WITH AS/NZS 1562.

#### **ROOF TILES OR SHINGLES:**

SHALL BE IN ACCORDANCE WITH NCC VOL.1 PART B1.4 OR VOL.2 PART 3.2.3.

- ALL WORKMANSHIP AND MATERIALS SHALL BE IN ACCORDANCE WITH CURRENT EDITIONS OF THE AS3600

-FOOTINGS TO BE IN ACCORDANCE WITH AS1480.
-FOOTINGS TO BE IN ACCORDANCE WITH NCC VOL.2 PARTS 3.2.3, 3.2.4 AND 3.2.5
- ALL REINFORCEMENTS SHALL CONFORM TO AS1302, AS1303 AND AS1304.

BRICK AND BLOCKWORK:
- CONSTRUCTION OF MASONRY BUILDINGS SHALL BE AS PER AS3700 OR AS4773.

CARPENTRY:
- TIMBER TO COMPLY WITH AS1170.2 OR AS4055.

- ALL WORKMANSHIP AND MATERIALS SHALL BE IN ACCORDANCE WITH AS1684 AND 1720 AS APPLICABLE.

### TIMBER FRAMING:

- TO COMPLY WITH NCC VOL.2 PART 3.4

- GROUND FLOOR TIMBERS SHALL BE ONLY OF HARDWOOD, CYPRESS PINE OR PRESSURE TREATED RADIATA OR CANADA PINE BELOW A HEIGHT OF 300mm ABOVE FINISHED GROUND LEVEL AND MUST NOT BE BUILT INTO BRICKWORK.

- SUBFLOOR VENTILATION SHALL CONFORM TO NCC VOL.2 PART 3.4.1.

- IN BUSHFIRE PRONE AREAS SPECIAL CONDITIONS APPLY.

- WHERE TERMITE BARRIERS NEED TO BE INSPECTED, 400mm CLEARANCE IS REQUIRED BETWEEN THE UNDERSIDE OF BEARER AND GROUND SURFACE.

- USE TREATED TIMBER WHERE REQUIRED FOR DURABILITY.

- USE TREATED TIMBER WHERE REQUIRED FOR DURABILITY.

- DO NOT USE TIMBER UNSUITABLE FOR EXPOSURE TO MOISTURE IN EXPOSED LOCATION.

- PROVIDE STRUCTURE BRACING IN ACCORDANCE WITH AS1684

- PROVIDE STRUCTURE TIEDOWN IN ACCORDANCE WITH AS1684 - USE GALVANISED FIXINGS WHERE EXPOSED TO WEATHER.

#### TERMITE CONTROL:

- TO BE IN ACCORDANCE WITH TO AS3660.1

- SHALL BE IN ACCORDANCE WITH NCC VOL.2 PART 3.1.4 OR VOL.1 PART B1.4.

## **FLASHING AND CAPPINGS:**

- SELECTION AND INSTALLATION OF METAL RAINWATER GOODS REFER TO AS2180

FLASH PROJECTIONS ABOVE THE ROOF WITH TWO PART FLASHINGS CONSISTING OF AN APRON FLASHING AND OVER FLASHING, WITH AT LEAST 100mm OVERLAP.

# PROVIDE FOR INDEPENDENT MOVEMENT BETWEEN ROOF AND PROJECTION.

CONCRETE BLOCKS OR BRICKS:
- TO COMPLY WITH TO AS4455 MASONRY BUILDING BLOCKS/PAVER.

- 40% OF NEW OR ALTERED LIGHT FIXTURES TO BE FITTED WITH FLUORESCENT, COMPACT FLUORESCENT, OR LIGHT-EMITTING-DIODE (LED) LAMPS

## **DOORS & WINDOWS:**

- ALL FRAMED WINDOWS SHALL BE INSTALLED IN ACCORDANCE WITH AS2047-48 FOR ALUMINIUM WINDOWS AND AS2047 FOR TIMBER WINDOWS

- ALUMINIUM FRAMED WINDOWS AND DOORS.

- WEATHER STRIPPING IS TO BE PROVIDED TO ALL EXTERNAL WINDOWS AND DOORS.

- MATERIALS TO BE USED FOR SURFACES OF FLOORS, STAIR LANDING, STEPS AND NOSINGS SHALL BE IN ACCORDANCE WITH THE CLASSIFICATIONS FOR SLIP RESISTANCE AS APPLY IN AS4586 AND HB198.

## WATERPROOFING FOR EXTERNAL TILED BALCONIES:

- WATERPROOFING TO COMPLY WITH AS4654

FFL MAIN DWELLING GROUND FLOOR

+83.80 **ROOF TERRACE** 

+80.70

+77.80

FFL GROUND FLOOR

FFL LOWER GROUND

STAIRS, HANDRAILS AND BALUSTRADES: - NCC VOL.2 PARTS 3.9.1 AND 3.9.2

- RELATIONSHIP OF RISER TO GOING SHALL BE BETWEEN 1:2 AND 1:1.35 UNLESS OTHERWISE DIRECTED TO GOING SHALL BE BETWEEN 1:2 AND 1:1.35 UNLESS OTHERWISE DIRECTED OR AS

WOOD LATTICE WITH EVERGREEN JASMINE OR SIMILAR PLANT

NEW NATIVE PLANTS TO BE PROVIDED BELOW DECK

PERMITTED IN 251697.

BALUSTRADES SHALL BE PROVIDED TO ALL LANDINGS, RAMPS, DECKS, ROOFS AND OTHER ELEVATED PLATFORMS WHERE THE VERTICAL DISTANCE FROM THAT LEVEL IS MORE THAN 1m ABOVE THE ADJOINING FLOOR OR FINISHED GROUND LEVEL.

- THE HEIGHT OF BALUSTRADE MUST BE A MINIMUM OF 1m HIGH ABOVE LANDING AND NOT LESS THAN 865mm ABOVE THE NOSINGS OF ANY STAIR TREADS OR FLOOR RAMP AND HAVE NO OPENING GREATER THAN 125mm.

- THE HEIGHT OF BALUSTRADE TO THE NEW STAIRCASES IS TO BE MEASURED A MINIMUM 865mm ABOVE THE NOSING LINE AND HAVE NO OPENING GREATER NO OPENING GREATER

#### STORMWATER:

#### EAVES GUTTERS, VALLEY GUTTERS AND DOWPIPES

- TO COMPLY WITH AS/NZS 2179 FOR METAL AND AS1273 FOR UPVC COMPONENTS.
- IN ACCORDANCE WITH NCC VOL 2 PART 3.5.3 NEW DOWNPIPES TO BE CONNECTED INTO EXISTING STORMWATER LINE
- COLORBOND GUTTERS AND DOWNPIPES - MINIMUM SLOPE OF EAVES AND GUTTERS 1:200

POST BY ENGINEER

FLOOR STRUCTURE BY ENG.

**GLAZING:** - NCC VOL.1 PARTS B 1.4, D 3.12, F1.13 OR NCC VOL.2 PART 3.6

CASCADING PLANTS FOR PARAPET

PAVED TERRACE

W16

BEDROOM 2

<u>FFL+77.8</u>0

FFL<u>+8</u>0.65

COLORBOND ROOF 1º PITCH

500

BALCONY

FFL<u>+77</u>.75

SMOKE DETECTORS/ALARMS:
- NCC VOL 2 PART 3.7.5. FIRE/SMOKE DETECTORS COMPLYING WITH THE REQUIREMENTS OF THE LOCAL GOVERNMENT ACT AND/OR STATE OR TERRITORY REGULATIONS MUST BE FITTED IN THE LOCATIONS REQUIRED AND APPROVED BY THE AUTHORITY AND SHALL BE INSTALLED IN ACCORDANCE WITH AS3786. - INSTALLATIONS IN BUILDINGS OTHER THAN CLASS 1 AND 10 MUST BE INSTALLED AND MANAGED TO COMPLY

- MULTIPLE ALARMS WITHIN HOUSES AND SOLE OCCUPANCY UNITS MUST BE HARD WIRED AND INTERCONNECTED.


#### WASTE MANAGEMENT:

- ALL WASTE SHALL BE TAKEN AWAY BY TRUCKS TO A SUITABLE LANDFILL OR RECYCLE DEPOT.
- ALL WASTE SHALL BE COVERED DURING TRANSPORTATION.
   WASTE GENERATED DURING CONSTRUCTION SHALL BE PLACED IN STEEL BINS AND TAKEN AWAY BY AN APPROVED CONTRACTOR TO A APPROVED LANDFILL SITE.

### SEDIMENT CONTROL:

- A FILTER CLOTH SYSTEM SHALL BE INSTALLED TO STOP ANY SEDIMENT ENTERING COUNCILS STORMWATER

ALL PLANS ARE TO BE READ IN CONJUNCTION AND COMPLY WITH THE BASIX CERTIFICATE, BUSHFIRE AND GEOTECH REPORTS.

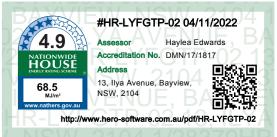

FLOOR STRUCTURE BY ENG.

SELECTED PLANTS FOR TOP

ROOF TERRACE

TOP ROOF TERRACE

RL+83.80

W13

LIVING ROOM

FFL<u>+8</u>0.70

## NOTES (E & OE)

- All structures including stormwater & drainage to engineer's details.
  Do not obtain dimensions by scaling drawings.
  All dimensions are to be checked on site prior to starting work.
  These drawings are to be read in conjunction with all other consultant's drawings and
- specifications.

   All workmanship & materials shall be in accordance with the requirements of current editions cluding amendments of the National Construction Code, relevant Australian Sta
- council requirements.

  New materials are to be used throughout unless otherwise noted.

  Concrete footings, slab, structural beams or any other structural members are to be designed.
- by a practicing engineer

II Draftina Division of JJ DRAFTING AUSTRALIA PTY LTD 26/90 Mona Vale Road, Mona Vale, NSW, 2103 PO Box 687, Dee Why, NSW, 2099 Mob. 0414 717 541 | Email, iidraft@tpg.com.au

www.jjdrafting.com.au


ACN 651 693 346


REV:	DATE:	DESCRIPTION:
Α	01/09/22	PRELIM. DRAWINGS UPDATED
В	06/09/22	PRELIM. DRAWINGS UPDATED


**SECTION A-A** 

PROPOSED NEW SECONDARY DWELLING 13 ILYA AVENUE - BAYVIEW NSW 2104 CLIENT:	DAT
Rex Pemberton	JOB
DRAWING TITLE: SECTION AA / SPECIFICATION NOTES	

	7-11-71-1	79 7 7 111111
TE:	DRAWN BY:	SCALE:
April/22	LB	1:100 @ A3
B No:	CHECKED BY:	DRAWING No:
1021/22	JJ	DA.10

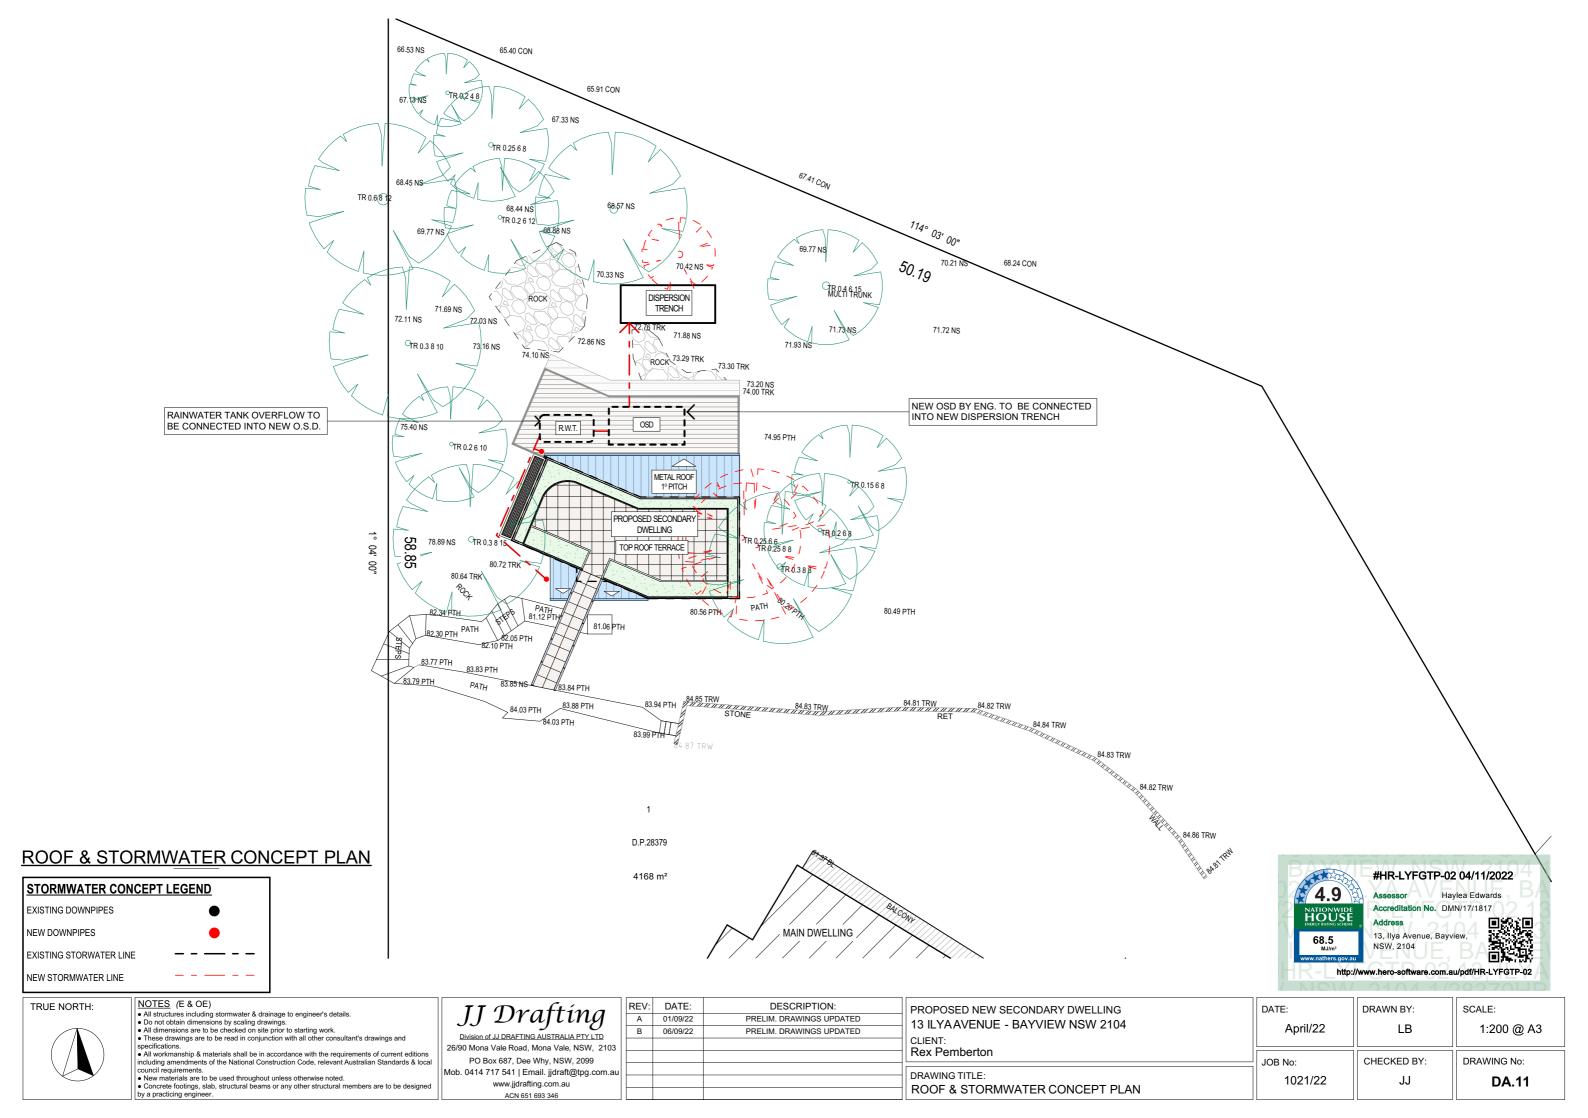

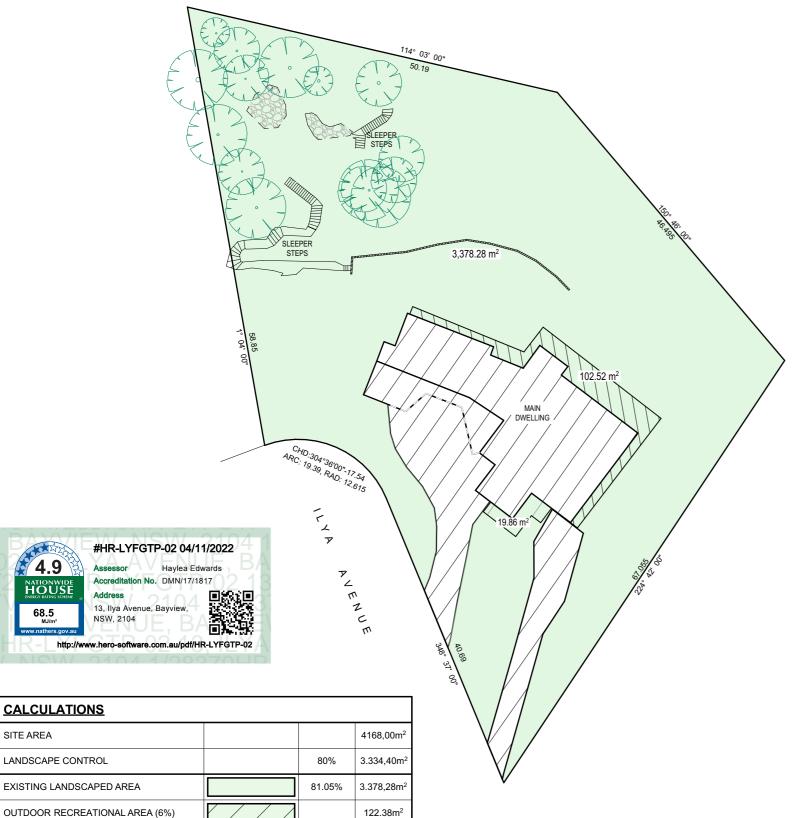

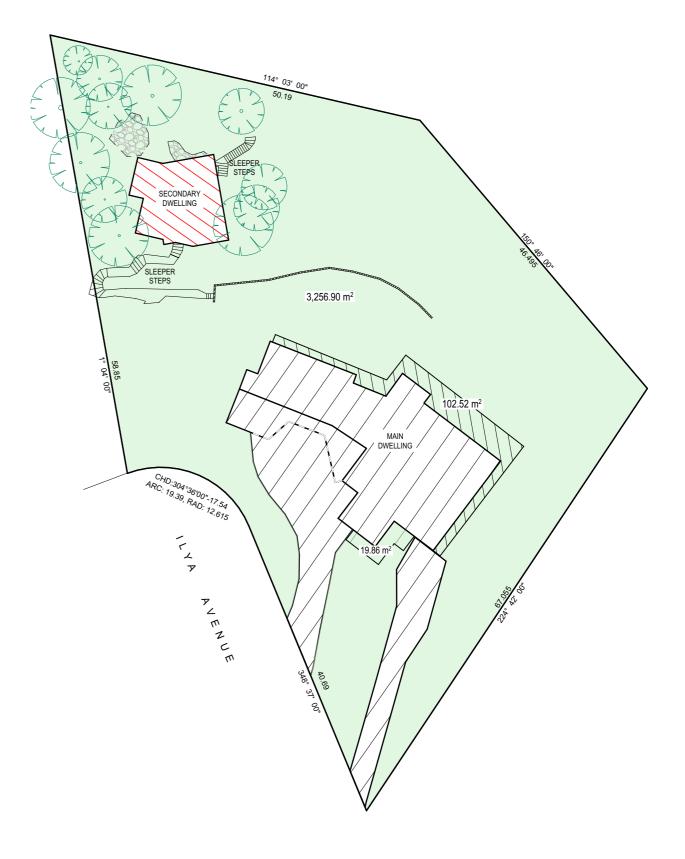

# 3256,90m<sup>2</sup> 789,72m<sup>2</sup>

121,38m<sup>2</sup> 911,10m<sup>2</sup>

78.14%

21.86%

**EXISTING LANDSCAPE CALCULATION PLAN** 

REV: DATE:

Α

В

01/09/22

06/09/22

# PROPOSED LANDSCAPE CALCULATION PLAN

#### TRUE NORTH:



TOTAL NEW LANDSCAPED AREA

EXISTING HARD SURFACE AREA

NEW HARD SURFACE AREA

TOTAL HARD SURFACE AREA

- NOTES (E & OE)

  All structures including stormwater & drainage to engineer's details.

  Do not obtain dimensions by scaling drawings.
  All dimensions are to be checked on site prior to starting work.
- Insee crawings are to be read in conjunction with all other consultants drawings and specifications.
   All workmanship & materials shall be in accordance with the requirements of current editions including amendments of the National Construction Code, relevant Australian Standards & local council requirements.
   New materials are to be used throughout unless otherwise noted.
   Concrete footings, slab, structural beams or any other structural members are to be designed by a practicing penipser.
- by a practicing engineer.

JJ Drafting
Division of JJ DRAFTING AUSTRALIA PTY LTD
26/90 Mona Vale Road, Mona Vale, NSW, 2103
PO Box 687, Dee Why, NSW, 2099
Mob_0414.717.541   Email_iidraft@tog.com.au

1	JJ 2 rog cong		
1	Division of JJ DRAFTING AUSTRALIA PTY LTD		
1	26/90 Mona Vale Road, Mona Vale, NSW, 2103		
	PO Box 687, Dee Why, NSW, 2099		
1	Mob. 0414 717 541   Email. jjdraft@tpg.com.au		
1	www.jjdrafting.com.au		
-	ACN 651 603 346		

DESCRIPTION:	PROPOSED NEW SECONDARY DWELLING	
PRELIM. DRAWINGS UPDATED	13 ILYAAVENUE - BAYVIEW NSW 2104	
PRELIM. DRAWINGS UPDATED		
	CLIENT:	L
	Rex Pemberton	
	DRAWING TITLE:	
	LANDSCAPED AREA CALCULATION PLAN	
	LANDSCAFED AREA CALCULATION FLAN	L

DATE:	DRAWN BY:	SCALE:
April/22	LB	1:500 @ A3
JOB No:	CHECKED BY:	DRAWING No:
1021/22	JJ	DA.12





LOMANDRA CONFERTIFOLIA



TRAILING ROSEMARY



KANGAROO PAW






SILVER FALLS



SYMBOL	COMMON NAME	SCIENTIFIC NAME	HEIGHT	SPREAD
A	NATIVE PLANTS (EXAMPLES):			
• • •	LOMANDRA CONFERTIFOLIA	Seascape	0.6 m	0.6m
	EMU BUSH	Eremophila Maculate	1.0 m	1m
	KANGAROO PAW	Anigozanthos	2.5 m	3m
End	SELECTED CASCADE PLANTS (EXAMPLES):			
	SILVER FALLS	Dichondra	1.0 m	0.5m
	TRAILING ROSEMARY	Anigozanthos	0.5 m	3m
	SELECTED PLANTS BY CLIENT	-	-	-
	EXISTING TREE TO REMAIN	-	-	-
M.	EXISTING PALM TREE TO REMAIN	-	-	-
ET.	EXISTING TREE TO BE REMOVED	-	-	-

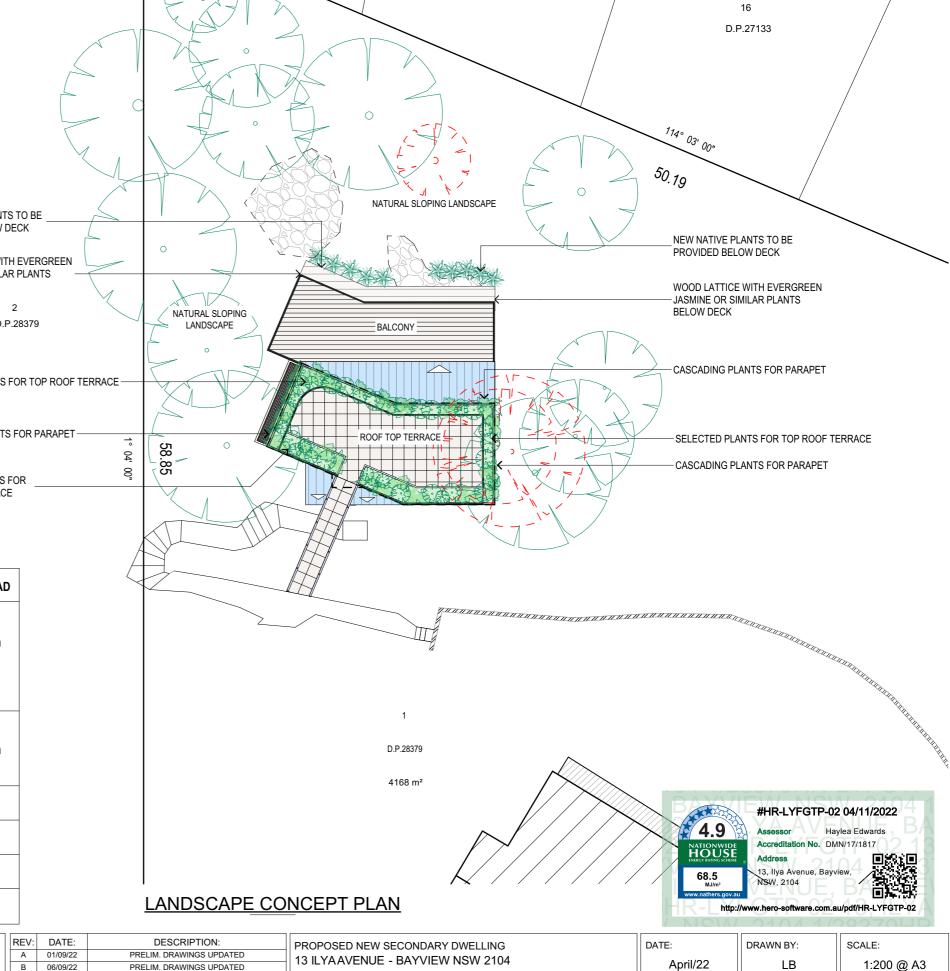

D.P.27133

## TRUE NORTH:



NOTES (E & OE)

All structures including stormwater & drainage to engineer's details.
 Do not obtain dimensions by scaling drawings.
 All dimensions are to be checked on site prior to starting work.

New materials are to be used throughout unless otherwise noted.
 Concrete footings, slab, structural beams or any other structural members are to be designed.

by a practicing engineer.

# \_\_\_\_ JJ Drafting Division of JJ DRAFTING AUSTRALIA PTY LTD

26/90 Mona Vale Road, Mona Vale, NSW, 210 PO Box 687, Dee Why, NSW, 2099 Mob. 0414 717 541 | Email. jjdraft@tpg.com.a www.jjdrafting.com.au ACN 651 693 346

- 1	IIVE V.	DAIL.	DESCRIPTION.
	Α	01/09/22	PRELIM. DRAWINGS UPDATED
	В	06/09/22	PRELIM. DRAWINGS UPDATED
03			
.au			

PROPOSED NEW SECONDARY DWELLING 13 ILYAAVENUE - BAYVIEW NSW 2104 CLIENT:		DATE: April/22	DRAWN BY:
	Rex Pemberton	JOB No:	CHECKED BY:
ı	DRAWING TITLE: I ANDSCAPE CONCEPT PLAN	1021/22	JJ

DRAWING No:

**DA.13** 

## **NOTES**

#### DESIGNATED SITE MANAGER/BUILDER

PRIOR TO COMMENCEMENT OF WORK A SITE MANAGER OR BUILDER MUST BE NOMINATED. THE SITE MANAGER OR BUILDER WILL BE RESPONSIBLE AND LIABLE FOR ALL WORKS CARRIED OUT ON THE SITE. THIS ASSUMES THE RESPONSIBILITY FOR THE ACTIONS OF ALL SUBCONTRACTED PARTIES AS WELL AS ADVISING THEM OF COUNCIL'S REQUIREMENTS WHEN CARRYING OUT

#### TOPSOIL MANAGEMENT

PRIOR TO THE STRIPPING OF TOPSOIL, THE VEGETATIVE COVER MUST BE REDUCED BY EITHER SLASHING OR MOWING. ALL TOPSOIL IS TO BE RETAINED AND PROTECTED FOR REUSE ON SITE. SOIL STOCKPILES MUST NOT BE LOCATED ON NATURE STRIPS, FOOTPATHS, ROADWAYS, KERBS, ACCESSWAYS, WITHIN DRAINAGE LINES/FLOWS/PATHS OR AROUND OR AGAINST TREE SHRUBS. SEDIMENT CONTROL MEASURES MUST BE INCORPORATED WITH ANY RESULTING STOCKPILE. THE STOCKPILE CAN BE PROTECTED FROM EROSION BY COVERING IT WITH AN MPERVIOUS MATERIAL, IN CONJUNCTION WITH THE INSTALLATION OF A SEDIMENT FENCE AROUND IT. IF STOCKPILES ARE TO REMAIN FOR MORE THAN ONE MONTH THEY ARE TO BE GRASSED IMMEDIATELY AND STABILISED WITHIN FOURTEEN DAYS. SURPLUS TOPSOIL MUST BE REASONABLY REMOVED FROM SITE.

#### **BUILDING MATERIAL STOCKPILING**

SUFFICIENT AREA MUST BE ALLOCATED WITHIN THE SITE FOR SUCH STORAGE OF BUILDING MATERIALS, DEMOLITION WASTE, WASTE CONTAINERS, ETC. AS WILL BE REQUIRED.

A SEDIMENT FENCE SHOULD BE LOCATED ALONG THE DOWNSLOPE BOUNDARY(S) OF THE SITE ON THE CONSTRUCTION SIDE OF THE TURF FILTER STRIP OR NATIVE VEGETATION, AND AROUND ALL STOCKPILES OF MATERIAL ON THE SITE.

ALL TRUCKS/UTES MUST COVER THEIR LOADS AT ALL TIMES. APPROPRIATE METHODS ARE TO BE EMPLOYED TO PREVENT BLOWING DUST CREATING AN UNACCEPTABLE HAZARD OR NUISANCE ON THE SITE OR DOWN WIND. PRODUCTION OF DUST CAN BE MINIMISED BY LIMITING AREA OF EARTHWORKS, WATERING AND PROGRESSIVE VEGETATION. WHERE DUST IS CREATED AS A RESULT WORKS AND/OR SOIL EXPOSURE, THE BARE SOIL AREAS MUST BE WATERED, DURING AND/OR AT THE END OF EACH DAY TO LAY THE DUST. EARTH MOVING ACTIVITIES SHOULD BE AVOIDED WHERE WINDS ARE SUFFICIENTLY STRONG ENOUGH TO RAISE VISIBLE

#### EROSION & SEDIMENT CONTROLS

APPROPRIATE EROSION AND SEDIMENT CONTROLS MUST BE IMPLEMENTED ON ALL SITES THAT INVOLVE SOIL DISTURBANCE. THE MEASURES MUST BE IN PLACE PRIOR TO THE COMMENCEMENT OF WORK. THOSE CONTROLS ARE TO BE MONITORED AND MAINTAINED IN ORDER TO SERVE THEIR INTENDED FUNCTION FOR THE DURATION OF THE WORKS OR UNTIL SUCH TIME AS THE SITE IS FULLY STABILISED. IF ANY CONTROLS ARE DAMAGED OR BECOME INEFFECTIVE DURING THE COURSE OF THE WORKS THEY ARE TO BE REINSTATED OR REPLACED IMMEDIATELY. SUFFICIENT ACCESS TO THESE CONTROLS MUST BE PROVIDED IN CASE OF THE

## SEDIMENT TRAPS


WHERE A SEDIMENT FENCE IS NOT USED APPROPRIATE SEDIMENT TRAPS SHOULD BE LOCATED AT ALL POINTS WHERE STORMWATER LEAVES THE CONSTRUCTION SITE OR LEAVES THE GUTTER AND ENTERS THE DRAINAGE SYSTEM. A COMMON TECHNIQUE IS THE GRAVEL SAUSAGE.

#### **DIVERSION CHANNELS**

A DIVERSION CHANNEL IS AN EXCAVATED EARTH DITCH OR PATH. THESE STRUCTURES ARE JSED TO INTERCEPT AND DIRECT RUN-OFF TO A DESIRED LOCATION WHERE POSSIBLE. ALL STORMWATER RUN-OFF FLOWING ONTO DISTURBED AREAS, INCLUDING STOCKPILES, MUST BE INTERCEPTED, DIVERTED AND/OR SAFELY DISPOSED OF. THIS CAN BE ACHIEVED BY CONSTRUCTING A TEMPORARY EARTH BANK AROUND THE UPSLOPE EXTENT OF THE CONSTRUCTION SITE WHERE THE DIVERSION DOES NOT AFFECT THE NEIGHBOURING

#### VEHICLE MOVEMENTS

TO LIMIT DISTURBANCE TO THE SITE AND TRACKING OF MATERIAL ONTO THE STREET ALL VEHICLES AND PLANT EQUIPMENT ARE TO USE A SINGLE ENTRY/EXIT POINT UNLESS COUNCIL HAS APPROVED ALTERNATIVE ARRANGEMENTS. ACCESS POINTS AND PARKING AREAS ARE TO BE STABILISED WITH COMPACTED SUB-GRADE ASAP AFTER THEIR FORMATION. IF SPILLAGE DOES OCCUR IT IS TO BE CONTAINED IMMEDIATELY AND CAREFULLY REMOVED. THE AREA AFFECTED IS TO BE RESTORED TO A STANDARD EQUAL TO OR BETTER THAN ITS PREVIOUS CONDITION. ALL VEHICLES ARE TO BE WASHED PRIOR TO EXISTING THE SITE. THIS SERVES THE PURPOSE OF REMOVING SITE MATERIAL ON THE VEHICLE AND PREVENTS IT FROM BEING DEPOSITED ON THE ROAD NETWORK ADJACENT TO THE SITE AND THUS, THE STORMWATER SYSTEM. NO VEHICLE ASSOCIATED WITH THE WORK IS TO BE PARKED ON A FOOTPATH OR PUBLIC RESERVE. ALL VEHICLES VISITING THE SITE DURING DEMOLITION, EXCAVATION AND/OR CONSTRUCTION WORKS, ARE TO COMPLY WITH THE PARKING REQUIREMENTS IN THAT AREA.

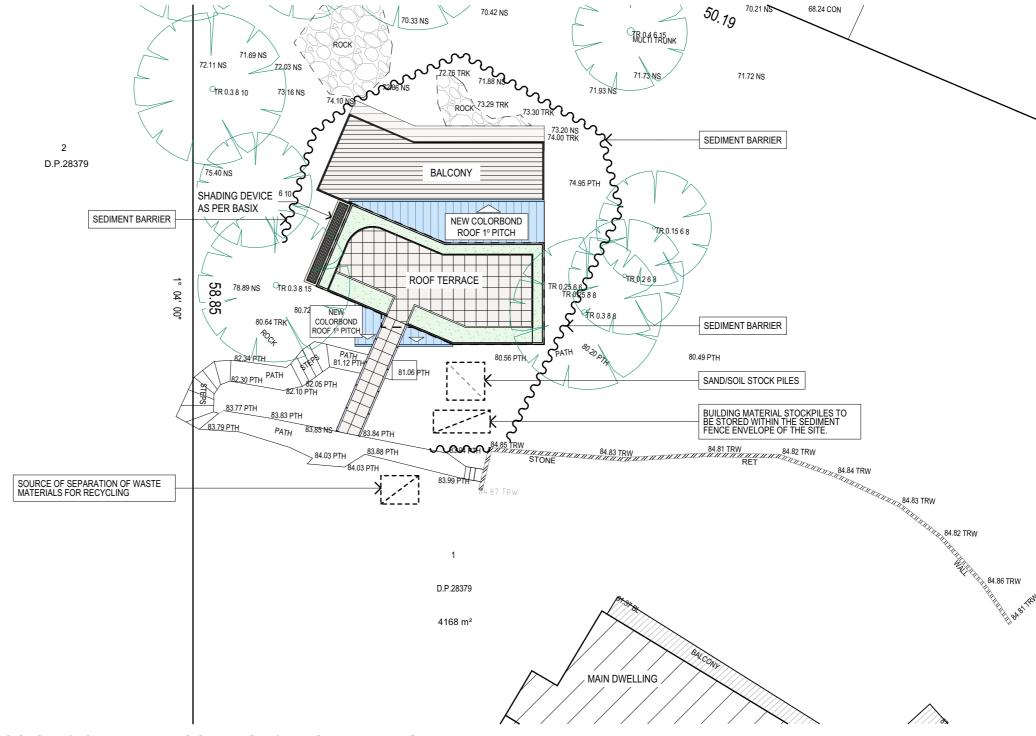


## **EROSION & SEDIMENT CONTROL / WASTE MANAGEMENT PLAN**

DESCRIPTION:

PRELIM. DRAWINGS UPDATED

PRELIM. DRAWINGS UPDATED

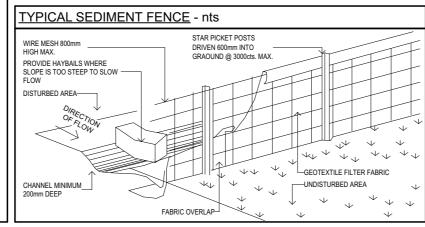


REV: DATE:

В

01/09/22

06/09/22

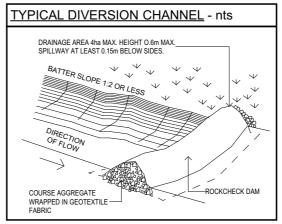

MANAGEMENT PLAN



#### TRUE NORTH:



NOTES (E & OE)

All structures including stormwater & drainage to engineer's details
Do not obtain dimensions by scaling drawings.
All dimensions are to be checked on site prior to starting work.

These drawings are to be read in conjunction with all other consultant's drawings and


 All workmanship & materials shall be in accordance with the requirements of current edition nts of the National Construction Code, relevant Australian Standards & loca

Cluding arrienance of the control of by a practicing engineer

	JJ Drafting
ı	Division of JJ DRAFTING AUSTRALIA PTY LTD
ı	26/90 Mona Vale Road, Mona Vale, NSW, 2103
ı	PO Box 687, Dee Why, NSW, 2099
ı	Mob. 0414 717 541   Email. jjdraft@tpg.com.au
ı	www.jjdrafting.com.au
1	ACN 651 693 346

PROPOSED NEW SECONDARY DWELLING 13 ILYA AVENUE - BAYVIEW NSW 2104 CLIENT: Rex Pemberton	
DRAWING TITLE: EROSION & SEDIMENT CONTROL / WASTE	

DATE:	DRAWN BY:	SCALE:
April/22	LB	1:200 @ A3
JOB No:	CHECKED BY:	DRAWING No:
1021/22	JJ	DA.14

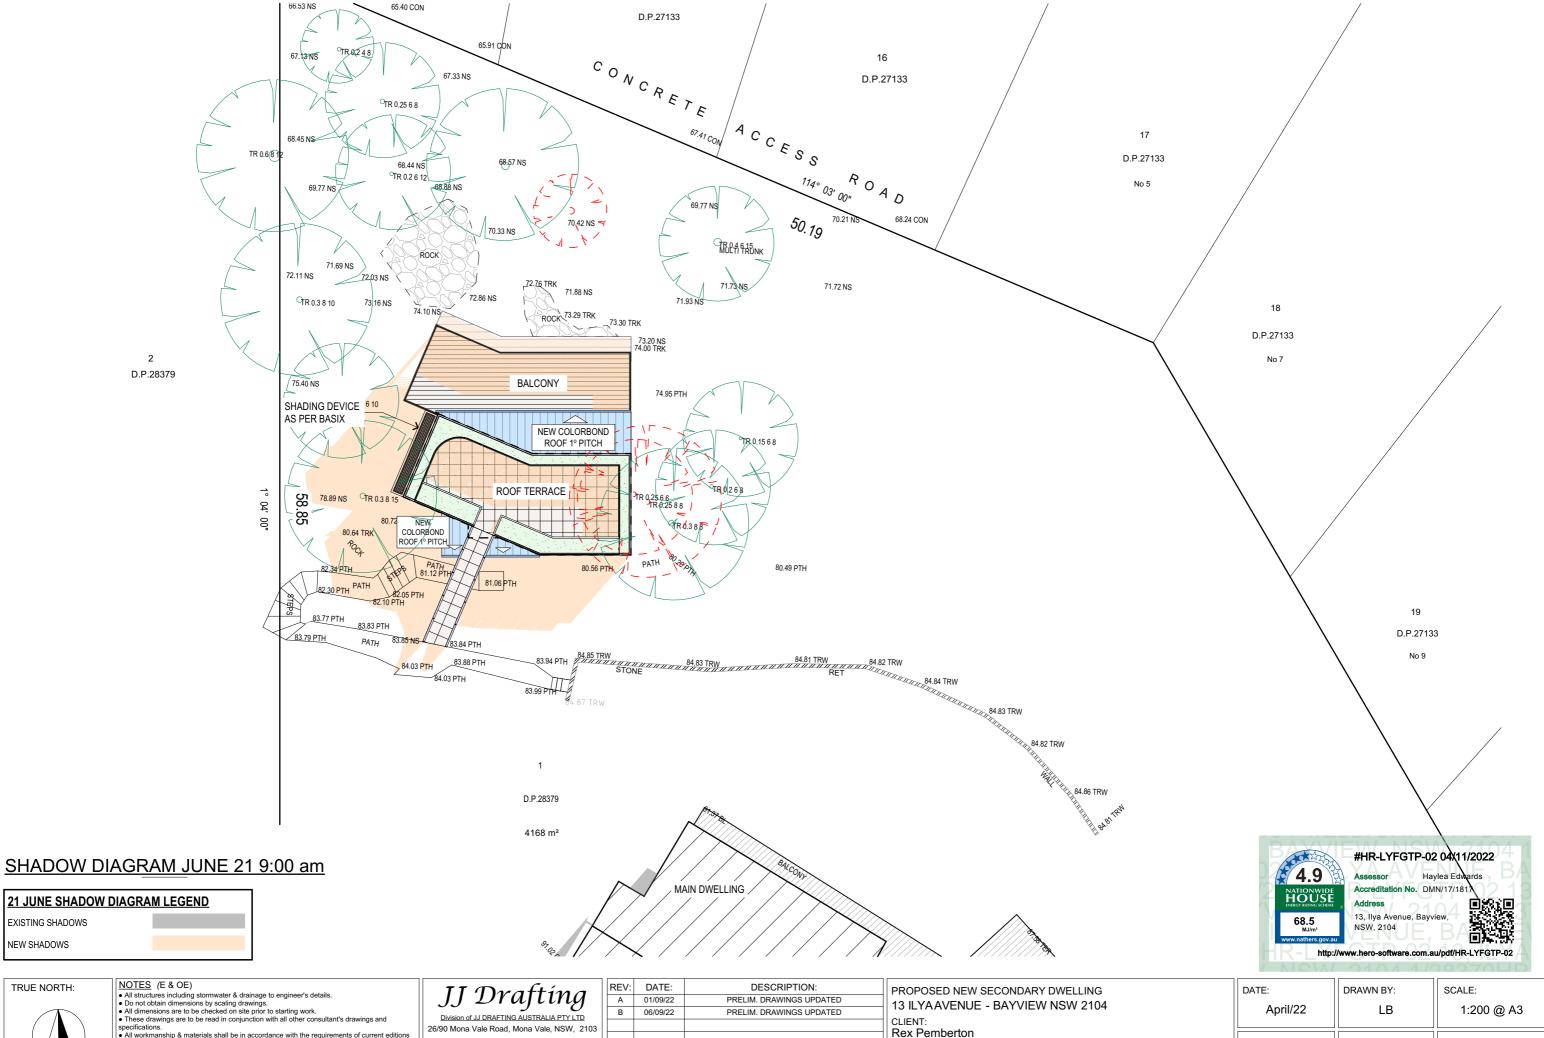


- New materials are to be used throughout unless otherwise noted.
   Concrete footings, slab, structural beams or any other structural members are to be designed. by a practicing engineer.

PO Box 687, Dee Why, NSW, 2099 Mob. 0414 717 541 | Email. jjdraft@tpg.com.au www.jjdrafting.com.au ACN 651 693 346

	Α	01/09/22	PRELIM. DRAWINGS UPDATED
	В	06/09/22	PRELIM. DRAWINGS UPDATED
3			
1			
au			
_			

PROPOSED NEW SECONDARY DWELLING 13 ILYA AVENUE - BAYVIEW NSW 2104
CLIENT: Rex Pemberton
DRAWING TITLE: SHADOW DIAGRAM JUNE 21 9:00 am

DATE:	DRAWN BY:	SCALE:
April/22	LB	1:200 @ A3
JOB No:	CHECKED BY:	DRAWING No:
1021/22	JJ	DA.15

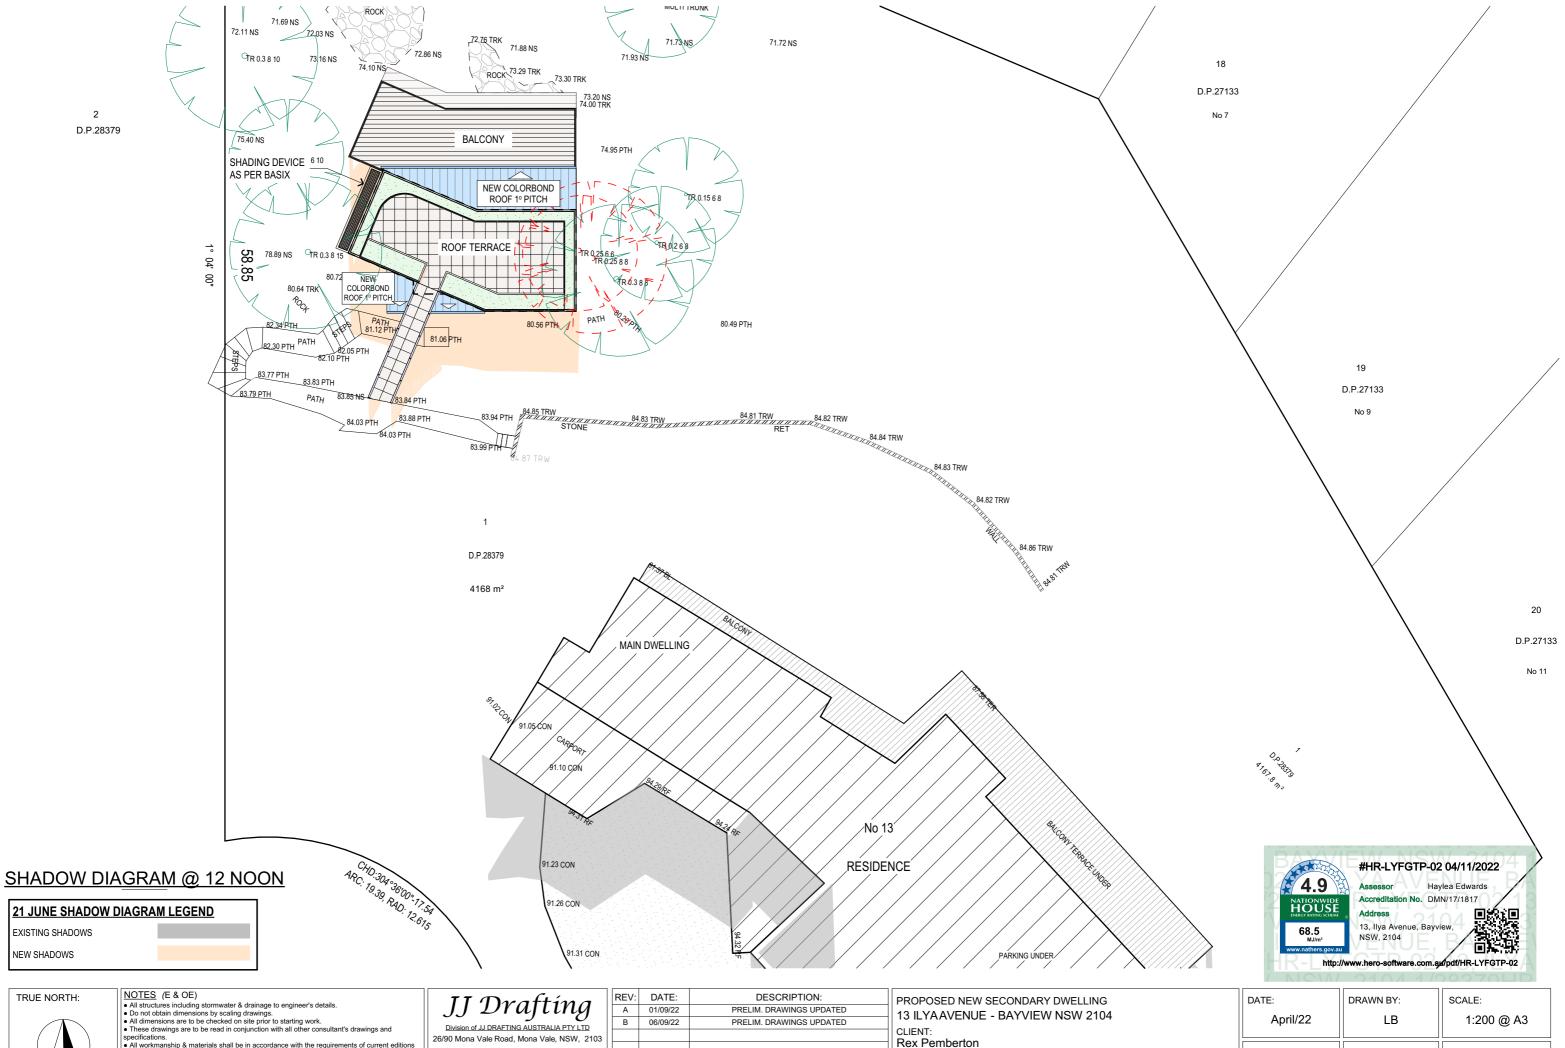




- New materials are to be used throughout unless otherwise noted.
   Concrete footings, slab, structural beams or any other structural members are to be designed.
- by a practicing engineer.

	ıt
Division of JJ DRAFTING AUSTRALIA PTY LTD	H
6/90 Mona Vale Road, Mona Vale, NSW, 2103	H
PO Box 687, Dee Why, NSW, 2099	H
ob. 0414 717 541   Email. jjdraft@tpg.com.au	H
www.jjdrafting.com.au	H
ACN 651 693 346	П

=V:	DATE:	DESCRIPTION:	PROPOSED NEW SE
Α	01/09/22	PRELIM. DRAWINGS UPDATED	13 ILYAAVENUE -
В	06/09/22	PRELIM. DRAWINGS UPDATED	
			CLIENT:
			Rex Pemberton
			DRAWING TITLE:
			SHADOW DIAGRA

PROPOSED NEW SECONDARY DWELLING 13 ILYAAVENUE - BAYVIEW NSW 2104	[
CLIENT: Rex Pemberton	
DRAWING TITLE: SHADOW DIAGRAM JUNE 21 12 noon	

DATE:	DRAWN BY:	SCALE:
April/22	LB	1:200 @ A3
JOB No:	CHECKED BY:	DRAWING No:
1021/22	JJ	DA.16

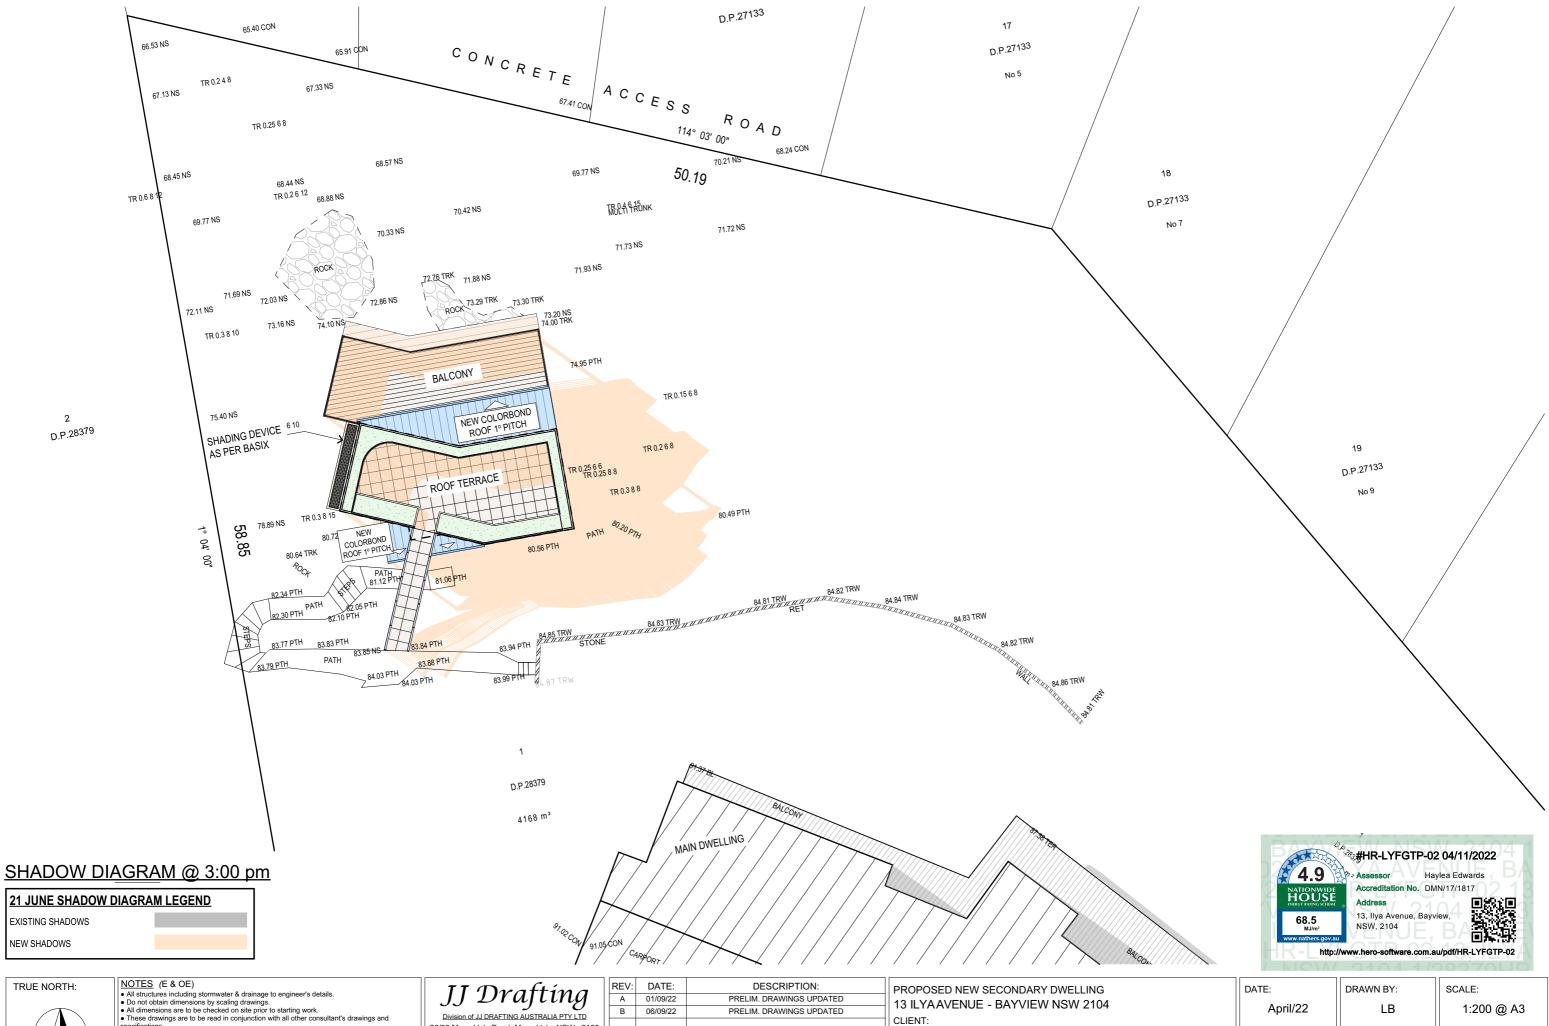

TRUE NORTH:



- specifications.

   All workmanship & materials shall be in accordance with the requirements of current editions
- All workflariship of inaterials shall be in accordance with the requirements of current construction including amendments of the National Construction Code, relevant Australian Standards & local council requirements.

  New materials are to be used throughout unless otherwise noted.

  Concrete footings, slab, structural beams or any other structural members are to be designed the construction of the c by a practicing engineer.

$JJ \mathcal{D}r$	aft i	inį	9
Division of JJ DRAFTIN	IG AUSTRALI	A PTY L	TD
6/90 Mona Vale Road	Mona Vale	NISW	2103

PO Box 687, Dee Why, NSW, 2099 Mob. 0414 717 541 | Email. jjdraft@tpg.com.a www.jjdrafting.com.au ACN 651 693 346

	IKEV.	DATE.	DESCRIPTION.
	Α	01/09/22	PRELIM. DRAWINGS UPDATED
	В	06/09/22	PRELIM. DRAWINGS UPDATED
13			
au			

PROPOSED NEW SECONDARY DWELLING 13 ILYAAVENUE - BAYVIEW NSW 2104	
CLIENT: Rex Pemberton	
DRAWING TITLE: SHADOW DIAGRAM JUNE 21 3:00 pm	

DATE:	DRAWN BY:	SCALE:	
April/22	LB	1:200 @ A3	
JOB No:	CHECKED BY:	DRAWING No:	
1021/22	JJ	DA.17	