DEVELOPMENTAPPLICATION

ALTERATIONS AND ADDITIONS TO 4C MINKARA ROAD BAYVIEW, NSW, 2104 LOT 53 / DP 774017

NO:	SHEET NAME	DATE
DA00	TITLE PAGE	1/9/2023
DA01	EXISTING AREAS CALCULATIONS	1/9/2023
DA02	PROPOSED AREAS CALCULATIONS	1/9/2023
DA03	HEIGHT CONTROLS	1/9/2023
DA04	SITE ANALYSIS	1/9/2023
DA05	SITE - WASTE - SEDIMENT PLAN	1/9/2023
DA06	EXISTING GROUND FLOOR PLAN	1/9/2023
DA07	PROPOSED GROUND FLOOR PLAN	1/9/2023
DA08	EXISTING FIRST FLOOR PLAN	1/9/2023
DA09	PROPOSED FIRST FLOOR PLAN	1/9/2023
DA10	EXISTING ROOF PLAN	1/9/2023
DA11	PROPOSED ROOF / CONCEPT STORMWATER PLAN	1/9/2023
DA12	EXISTING GARAGE FLOOR PLAN	1/9/2023
DA13	PROPOSED GARAGE FLOOR PLAN	1/9/2023
DA14	EXISTING GARAGE ROOF PLAN	1/9/2023
DA15	PROPOSED GARAGE ROOF PLAN	1/9/2023
DA16	ELEVATIONS - NORTH & SOUTH	1/9/2023
DA17	ELEVATIONS - EAST & WEST	1/9/2023
DA18	SECTIONS - A & B	1/9/2023
DA19	SECTIONS - C & D	1/9/2023
DA20	POOL PLANS	1/9/2023
DA21	POOL SECTIONS	1/9/2023
DA22	FINISHES BOARD	1/9/2023
DA23	SHADOW DIAGRAM - JUNE 21ST - 9AM	1/9/2023
DA24	SHADOW DIAGRAM - JUNE 21ST - 12PM	1/9/2023
DA25	SHADOW DIAGRAM - JUNE 21ST - 3PM	1/9/2023
DA26	BASIX REQUIREMENTS	1/9/2023
DA27	BASIX REQUIREMENTS	1/9/2023







BUSHFIRE BAL 29 RATING ALL BUILDING WORKS TO COMPLY AND MEET THE REQUIREMENTS OF AS1530 & AS3959

SITE AREA:

7612.20m²



DWELLING, GARAGE, SHEDS



LANDSCAPE AREA

REQUIRED 96.00% - 400m² (6907.71m²) EXISTING 84.66% (6444.55m²) PROPOSED 84.72% (6449.13m²)



LANDSCAPE AREA: GRAVEL DRIVEWAY AND PATH

PRIVATE (

PRIVATE OPEN SPACE


 REQUIRED
 240.00m²

 EXISTING
 2651.58m²

 PROPOSED
 2525.35m²



PRINCIPLE OPEN SPACE 16m² WITH A MINIMUM DIMENSION OF 4m REQUIRED

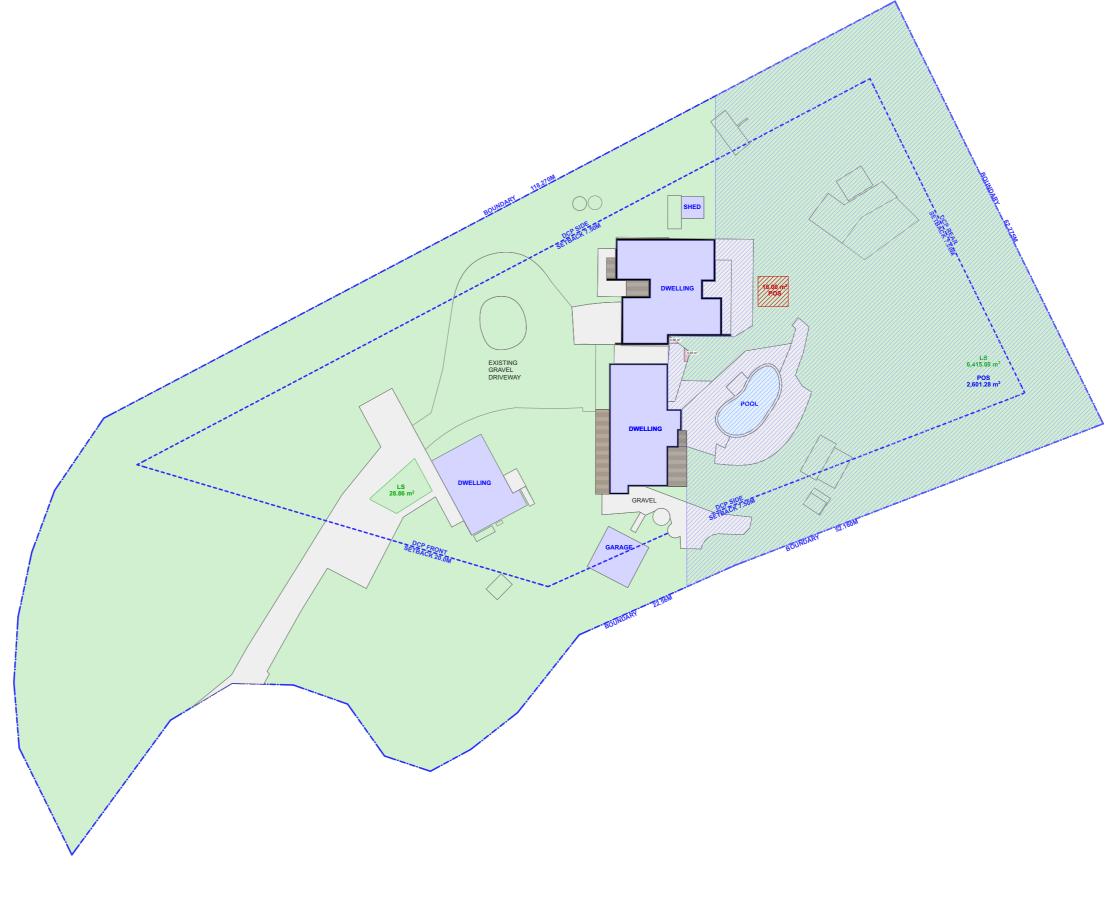

1 EXISTING AREA CALCULATIONS 1:500



progressive plans

0400 699 850 UNIT 4/40-42 AVALON PARADE AVALON, NSW, 2107 HELLO@PROGRESSIVEPLANS.COM.AU WWW.PROGRESSIVEPLANS.COM.AU THE BUILDER SHALL CHECK AND VERIFY ALL DIMENSIONS AND VERIFY ALL ERRORS AND OMISSIONS TO THE DRAFTING OFFICE. DO NOT SCALE THE DRAWING. DRAWINGS SHALL NOT BE USED FOR CONSTRUCTION PURPOSES UNTIL ISSUED BY THE DRAFTING OFFICE FOR CONSTRUCTION AND NOTED ON THE TITLE BLOCK. THE WORK MUST BE VERIFIED BY STRUCTURAL BUGNESS WORK COMMENCES.

REV.	NOTES.	INITIAL	DATE	LEGEND
Α	DA SUBMISSION	SS	13.06.23	DWELLING WALLS
В	WINDOW & COL. CHANGE	SS	01.09.23	CONCRETE / PAVERS
				CONORETE / PAVERS
				TIMBER DECK
				POOL / WATER



1010

DA01



SITE AREA:

7612.20m²



DWELLING, GARAGE, SHEDS



LANDSCAPE AREA

96.00% - 400m² (6907.71m²) 84.66% (6444.55m²) REQUIRED **EXISTING** PROPOSED 84.72% (6449.13m²)




LANDSCAPE AREA: GRAVEL DRIVEWAY AND PATH

PRIVATE OPEN SPACE

REQUIRED 240.00m² **EXISTING** 2651.58m² PROPOSED 2525.35m²



PRINCIPLE OPEN SPACE 16m² WITH A MINIMUM DIMENSION OF 4m REQUIRED

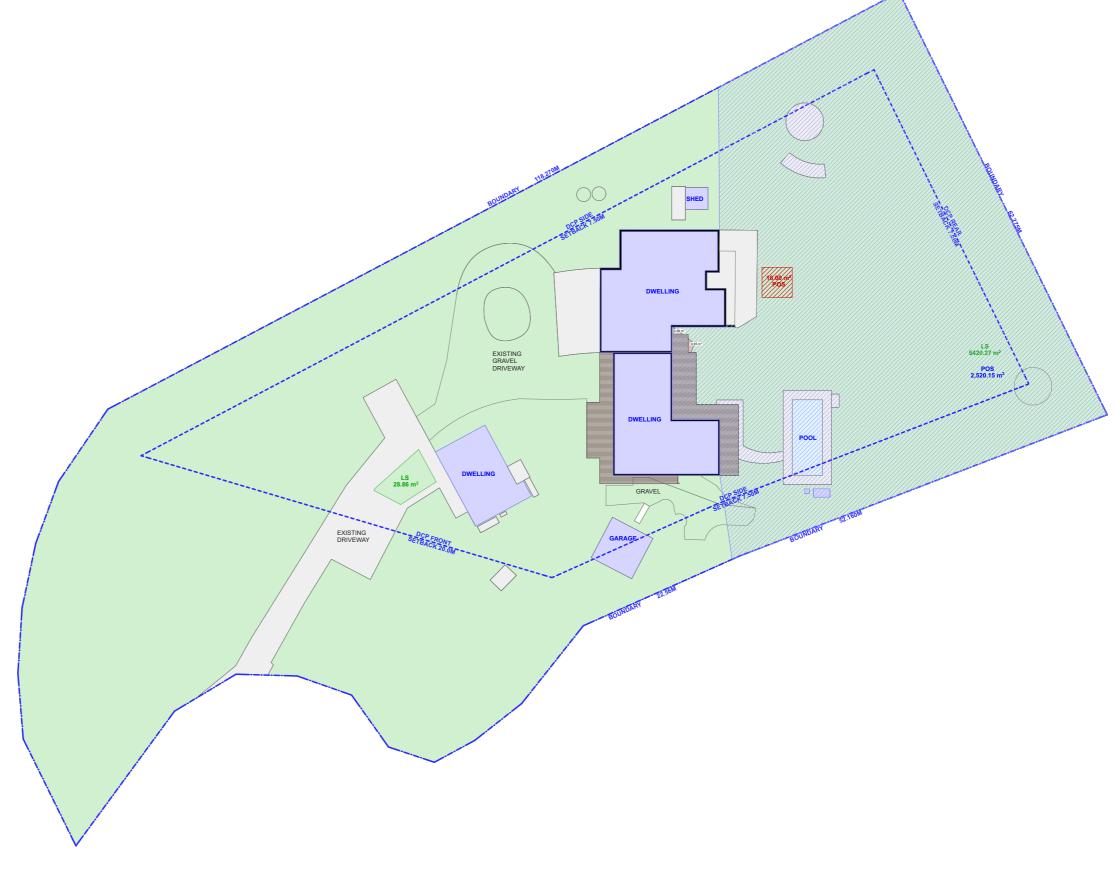

PROPOSED AREA CALCULATIONS 1:500




progressive plans

UNIT 4/40-42 AVALON PARADE AVALON, NSW, 2107 HELLO@PROGRESSIVEPLANS.COM.AU WWW.PROGRESSIVEPLANS.COM.AU

THE BUILDER SHALL CHECK AND VERIFY ALL DIMENSIONS AND VERIFY ALL ERRORS AND OMISSIONS TO THE DRAFTING OFFICE. DO NOT SCALE THE DRAWING. DRAWINGS SHALL NOT BE USED FOR CONSTRUCTION PURPOSES UNTIL ISSUED BY THE DRAFTING OFFICE FOR CONSTRUCTION
AND NOTED ON THE TITLE BLOCK.
THE WORK MUST BE VERIFIED BY
STRUCTURAL ENGINEER BEFORE WORK

REV.	NOTES.	INITIAL	DATE	LEGEND			
Α	DA SUBMISSION	SS	13.06.23	DWELLING WALLS			
В	WINDOW & COL. CHANGE	ss	01.09.23	CONCRETE / PAVERS TIMBER DECK POOL / WATER			

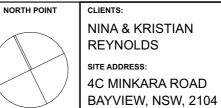


NINA & KRISTIAN REYNOLDS 4C MINKARA ROAD

DRAWING TITLE: PROPOSED AREAS CALCULATIONS DATE: 1/9/2023 1:500 @A3 PROJECT NO: DRAWING NO:

DA02

1010

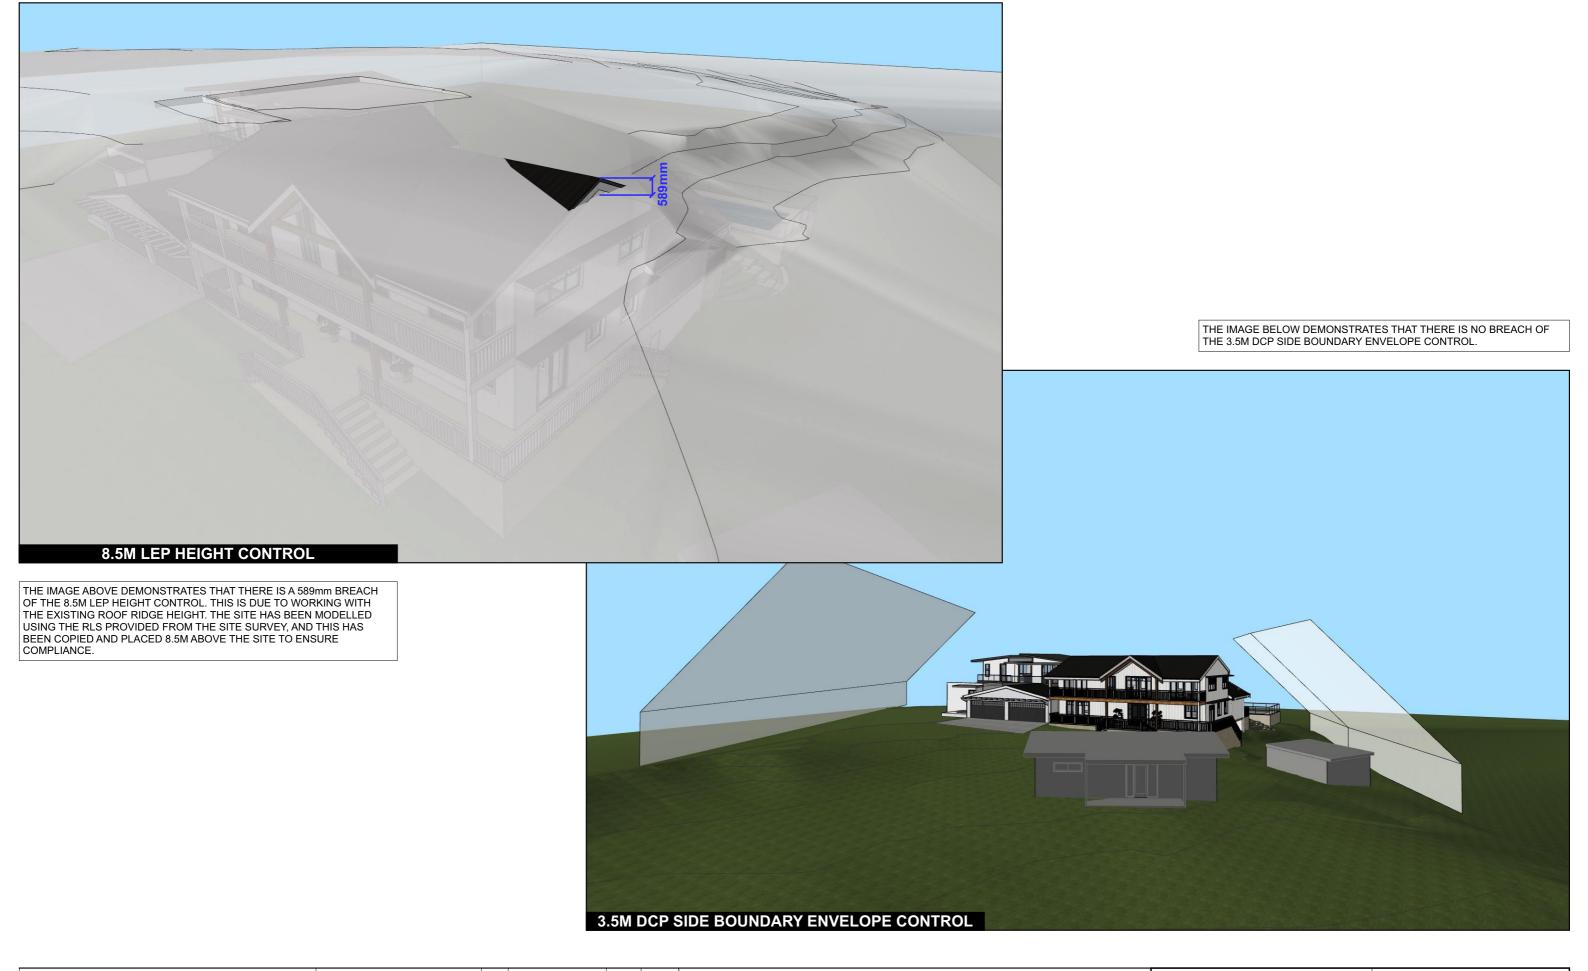



progressive plans

0400 699 850 UNIT 4/40-42 AVALON PARADE AVALON, NSW, 2107 HELLO@PROGRESSIVEPLANS.COM.AU WWW.PROGRESSIVEPLANS.COM.AU NOTES

THE BUILDER SHALL CHECK AND VERIFY ALL DIMENSIONS AND VERIFY ALL ERRORS AND OMISSIONS TO THE DRAFTING OFFICE. DO NOT SCALE THE DRAWING. DRAWINGS SHALL NOT BE USED FOR CONSTRUCTION PURPOSES UNTIL ISSUED BY THE DRAFTING OFFICE FOR CONSTRUCTION AND NOTED ON THE TITLE BLOCK. THE WORK MUST BE VERIFIED BY STRUCTURAL ENGINEER BEFORE WORK COMMENCES.

REV.	NOTES.	INITIAL	DATE
А	DA SUBMISSION	SS	13.06.23
В	WINDOW & COL. CHANGE	SS	01.09.23


NINA & KRISTIAN
REYNOLDS
SITE ADDRESS:
4C MINKARA ROAD
BAYVIEW, NSW, 2104

DRAWING TITLE:
HEIGHT CONTROLS


SCALE: DATE:
NTS 19/2023

PROJECT NO: DRAWING NO:
1010 DA03



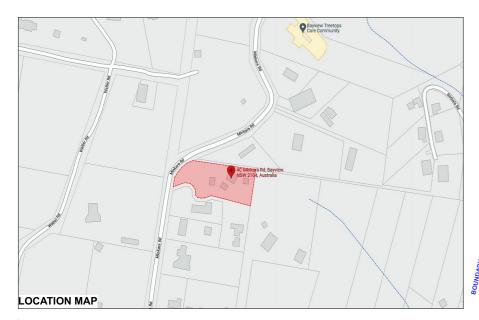



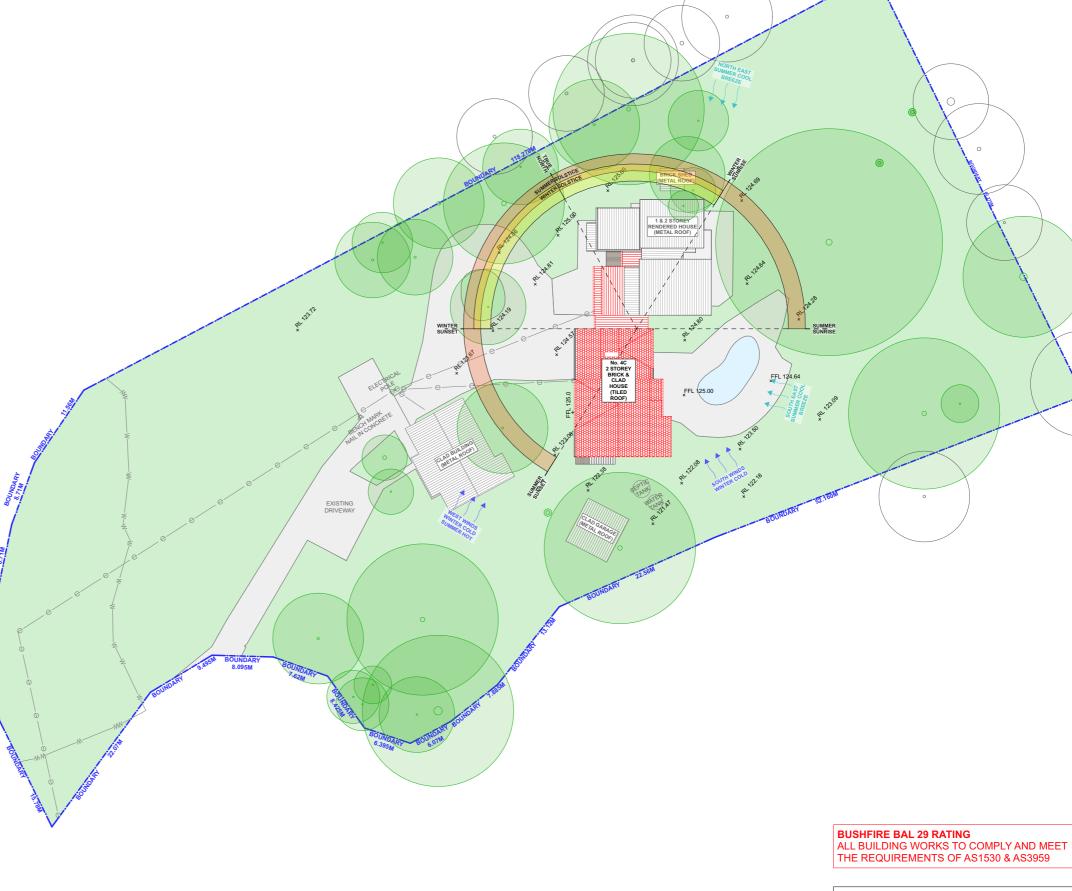

1:500 **SITE ANALYSIS**

NOTE: ALL DEMOLITION WORK TO BE CARRIED OUT IN ACCORDANCE WITH AS2601-2001

progressive plans

0400 699 850 UNIT 4/40-42 AVALON PARADE AVALON, NSW, 2107 HELLO@PROGRESSIVEPLANS.COM.AU WWW.PROGRESSIVEPLANS.COM.AU

THE BUILDER SHALL CHECK AND VERIFY ALL
DIMENSIONS AND VERIFY ALL ERRORS AND
OMISSIONS TO THE DRAFTING OFFICE.
DO NOT SCALE THE DRAWING.
DRAWINGS SHALL NOT BE USED FOR
CONSTRUCTION PURPOSES UNTIL ISSUED BY
THE DRAFTING OFFICE FOR CONSTRUCTION
AND NOTED ON THE TITLE BLOCK.
THE WORK MUST BE VERIFIED BY
STRUCTURAL ENGINEER BEFORE WORK
COMMENCES.

REV.	NOTES.	INITIAL	DATE	LEGEND
Α	DA SUBMISSION	SS	13.06.23	EXISTING LANDSCAPE / GRASS
В	WINDOW & COL. CHANGE	SS	01.09.23	DEMOLISHED CONCRETE / PAVERS
				EXISTING ROOF TIMBER DECK
				PROPOSED ROOF POOL / WATER
				SEDIMENT EROSION FENCE


ABBREVIATIONS DP: DEPOSIT PLAN RL: REDUCED LEVEL SP: STRATA PLAN

NORTH POINT

CLIENTS: NINA & KRISTIAN REYNOLDS SITE ADDRESS: 4C MINKARA ROAD BAYVIEW, NSW, 2104 DRAWING TITLE:


SITE ANALYSIS						
scale: 1:500 @A3	DATE: 1/9/2023					
PROJECT NO: 1010	DA04					



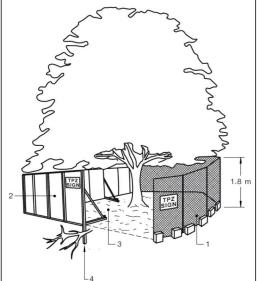


TREE PROTECTION ZONE (TPZ) FENCING (WHEN POSSIBLE):

- 1. CHAIN WIRE MESH PANELS WITH SHADE CLOTH (IF REQUIRED) ATTACHED, HELD IN PLACE WITH CONCRETE FEET.
- 2. ALTERNATIVE PLYWOOD OR WOODEN PALING FENCE PANELS. THE FENCING MATERIAL ALSO PREVENTS BUILDING MATERIALS OR SOIL ENTERING THE TPZ.
- 3. MULCH INSTALLATION ACROSS SURFACE OF TPZ (AT THE DISCRETION OF THE PROJECT ARBORIST). NO EXCAVATION, CONSTRUCTION ACTIVITY, GRADE CHANGES, SURFACE TREATMENT OR STORAGE OF MATERIALS OF ANY KIND IS PERMITTED WITHIN THE TPZ.
- 4. BRACING IS PERMISSIBLE WITHIN THE TPZ. INSTALLATION OF SUPPORTS TO AVOID DAMAGING ROOTS.

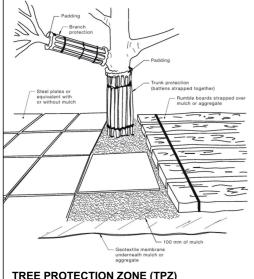

TREE PROTECTION ZONE (TPZ) FENCING (NOT POSSIBLE):

- 1. FOR TRUNK AND BRANCH PROTECTION USE BOARDS AND PADDING THAT WILL PREVENT DAMAGE TO BARK. BOARDS ARE TO BE STRAPPED TO TREES, NOT NAILED, OR
- 2. RUMBLE BOARDS SHOULD BE OF SUITABLE THICKNESS TO PREVENT SOIL COMPACTION AND ROOT DAMAGE.

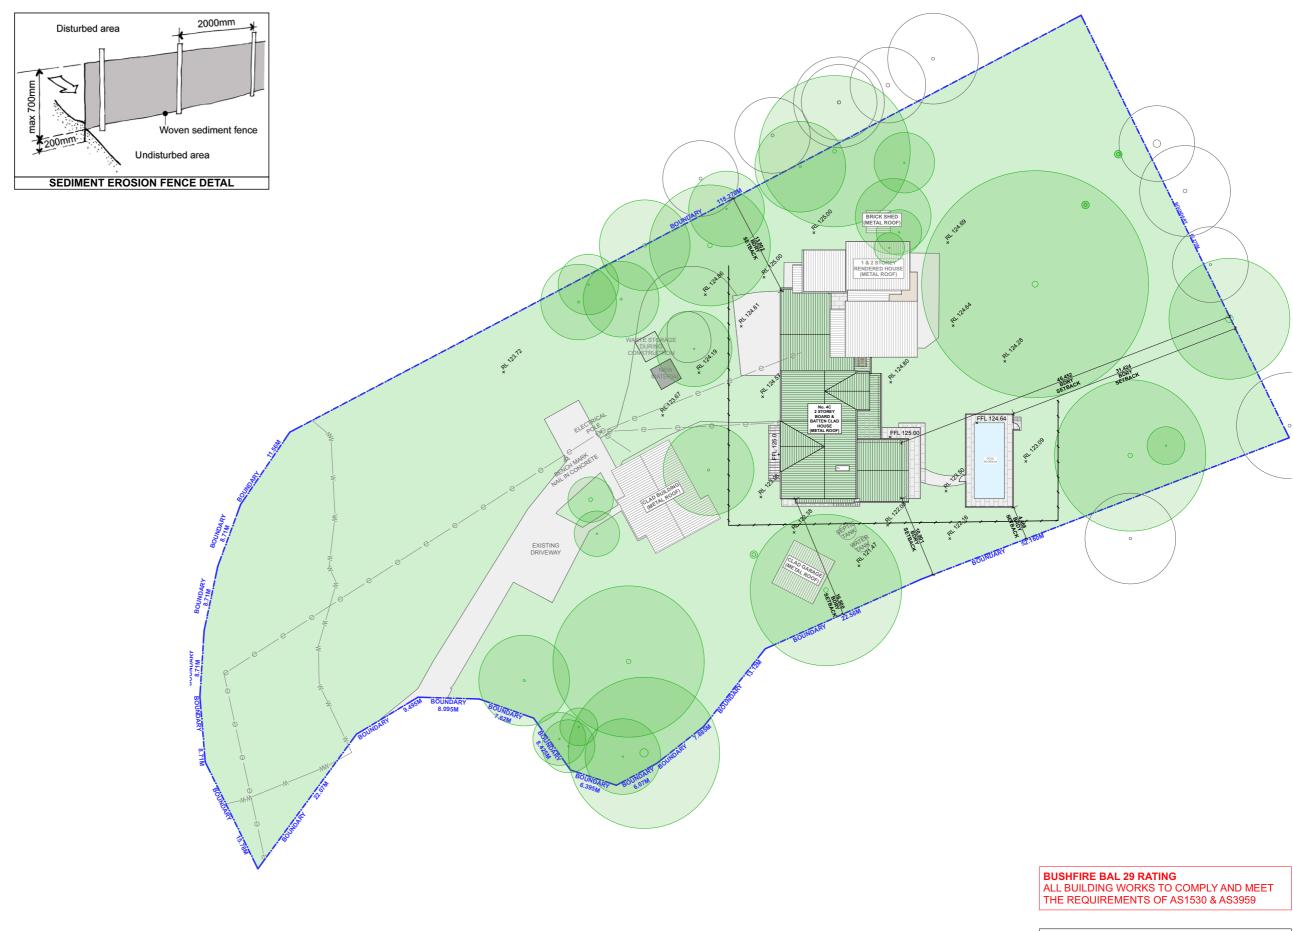

SITE - WASTE - SEDIMENT PLAN

1:500

NOTE: TPZ AND SRZ TO ARBORIST'S DETAILS




progressive plans

UNIT 4/40-42 AVALON PARADE AVALON, NSW, 2107 HELLO@PROGRESSIVEPLANS.COM.AU WWW.PROGRESSIVEPLANS.COM.AU


NOTES
THE BUILDER SHALL CHECK AND VERIFY ALL
DIMENSIONS AND VERIFY ALL ERRORS AND
OMISSIONS TO THE DRAFTING OFFICE.
DO NOT SCALE THE DRAWING.
DRAWINGS SHALL NOT BE USED FOR
CONSTRUCTION PURPOSES UNTIL ISSUED BY
THE DRAFTING OFFICE FOR CONSTRUCTION
AND NOTED ON THE TITLE BLOCK.
THE WORK MUST BE VERIFIED BY
STRUCTURAL ENGINEER BEFORE WORK
COMMENCES.


REV.	NOTES.	INITIAL	DATE	LEGEND	ABBREVIATIONS
Α	DA SUBMISSION	SS	13.06.23	EXISTING LANDSCAPE / GRASS	DP: DEPOSIT PLAN
В	WINDOW & COL. CHANGE	SS	01.09.23	DEMOLISHED CONCRETE / PAVERS	RL: REDUCED LEVEL SP: STRATA PLAN
				EXISTING ROOF TIMBER DECK	
				PROPOSED ROOF POOL/WATER	
				SEDIMENT EROSION FENCE	

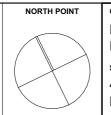

CLIENTS: NINA & KRISTIAN REYNOLDS SITE ADDRESS: 4C MINKARA ROAD BAYVIEW, NSW, 2104

DRAWING TITLE: SITE - WASTE - SEDIMENT PLAN 1:500 @A3 1/9/2023 PROJECT NO: DRAWING NO: 1010 **DA05**

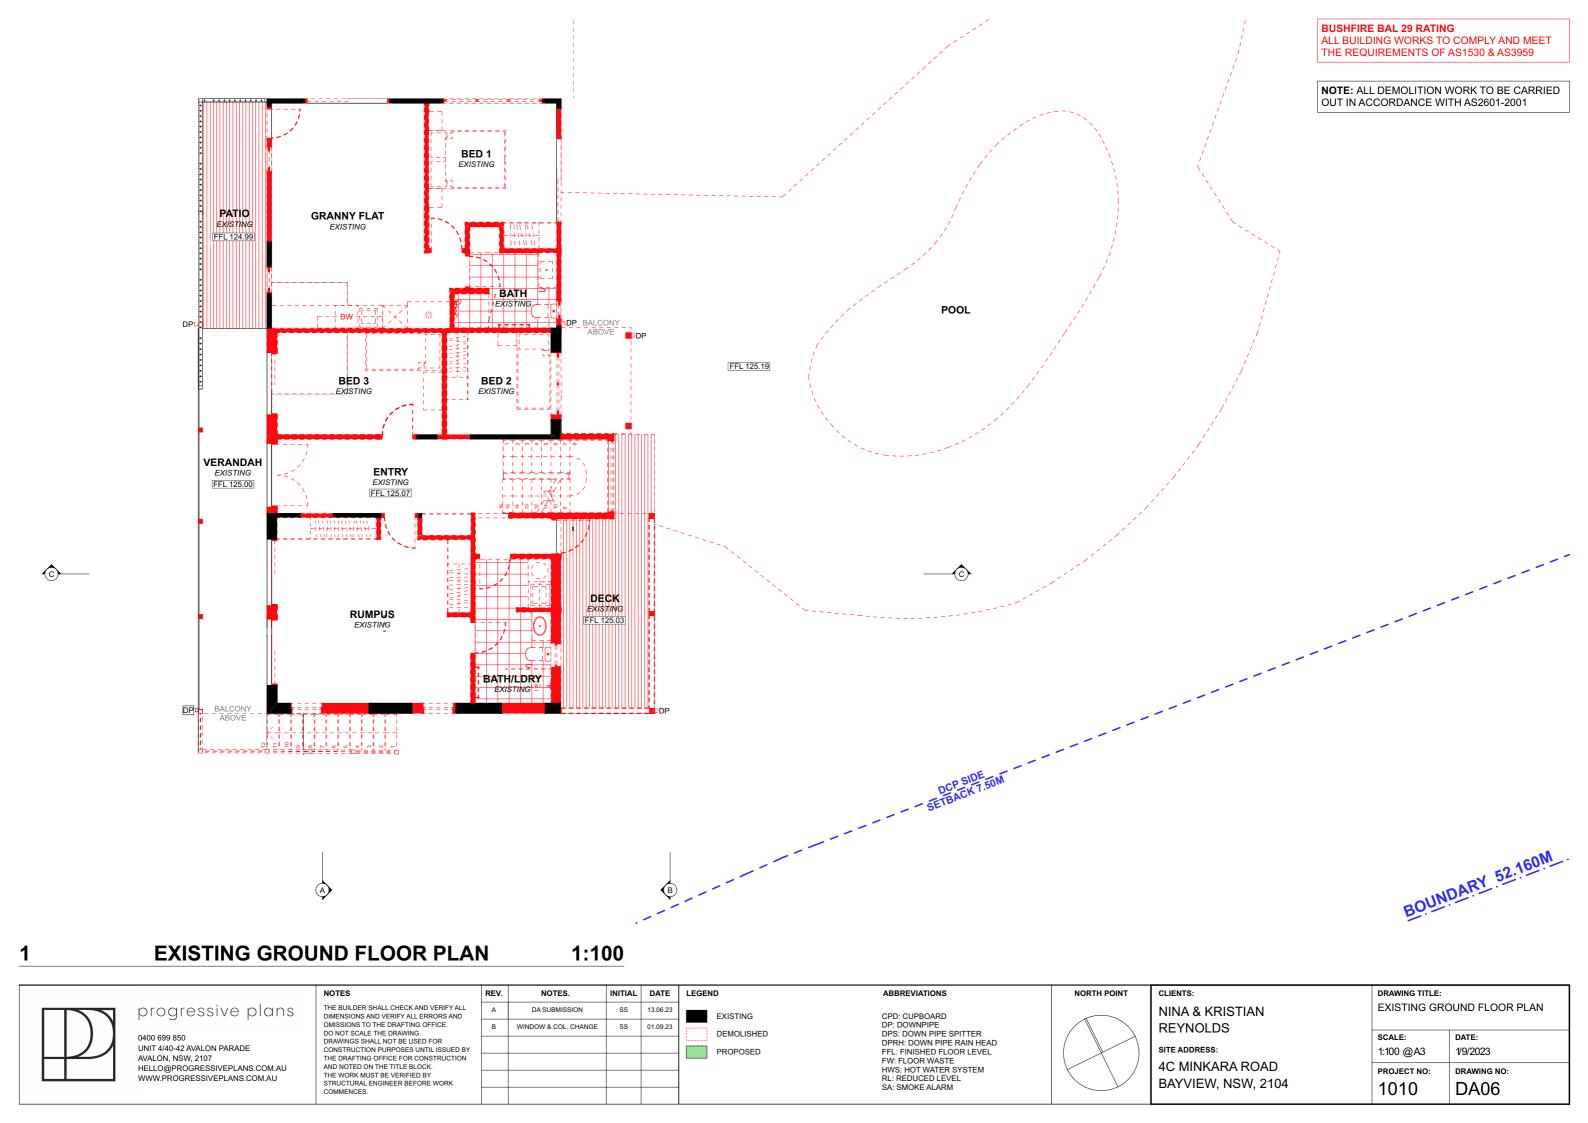

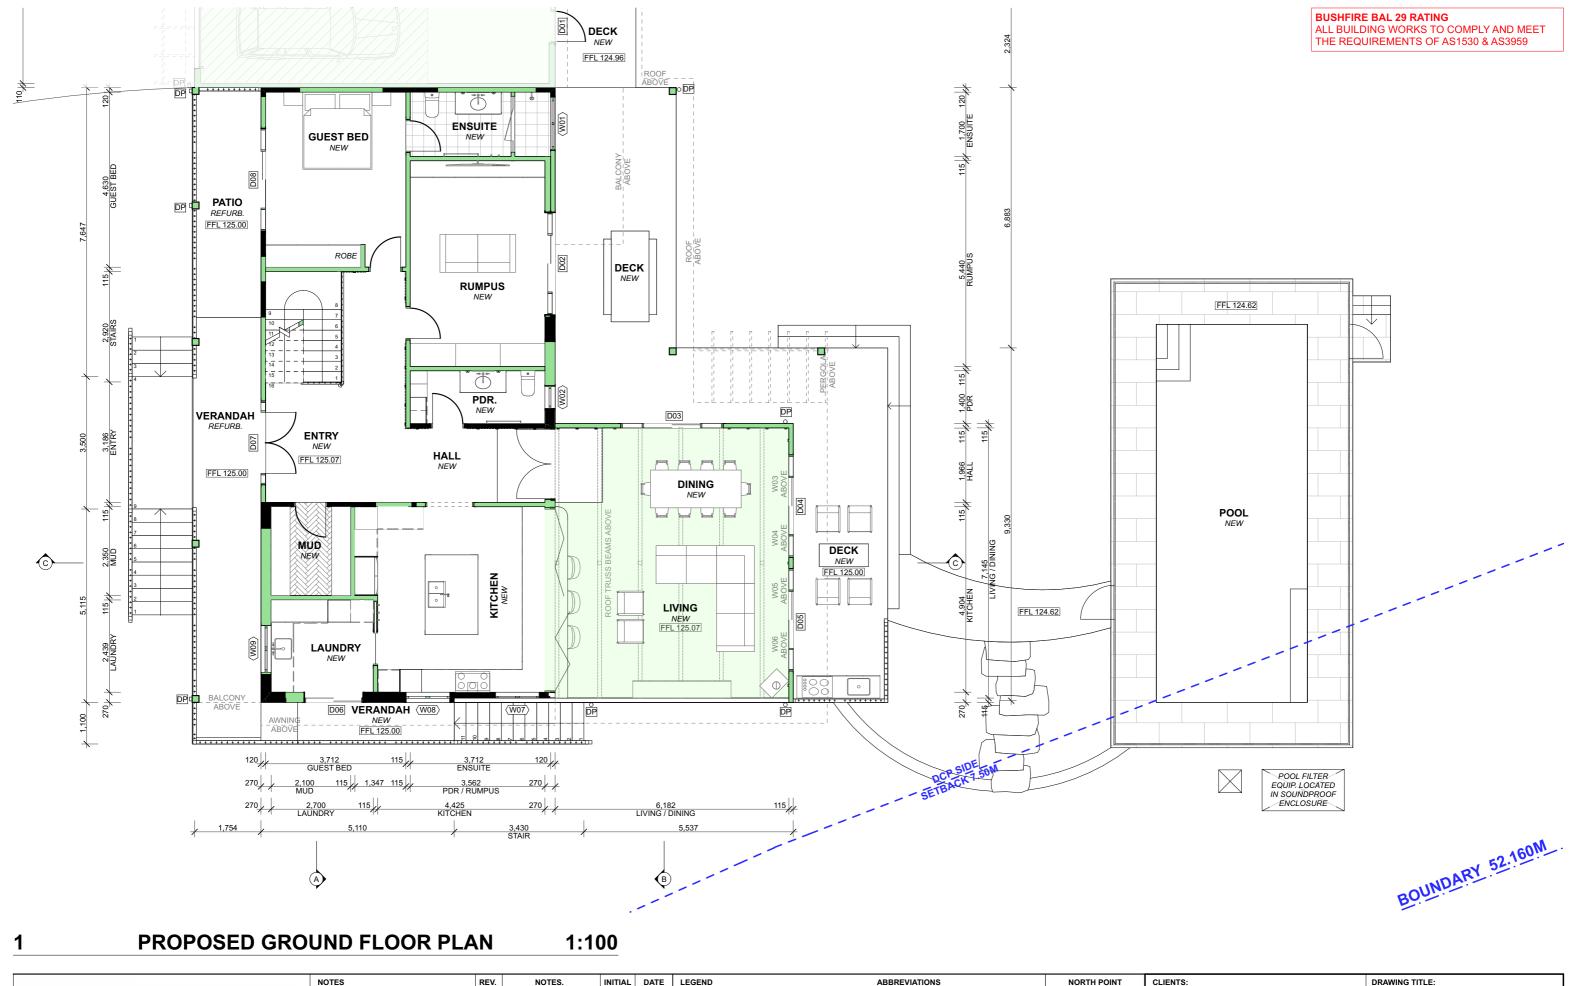

progressive plans

0400 699 850 UNIT 4/40-42 AVALON PARADE AVALON, NSW, 2107 HELLO@PROGRESSIVEPLANS.COM.AU WWW.PROGRESSIVEPLANS.COM.AU NOTES

THE BUILDER SHALL CHECK AND VERIFY ALL DIMENSIONS AND VERIFY ALL ERRORS AND OMISSIONS TO THE DRAFTING OFFICE.


DO NOT SCALE THE DRAWING.
DRAWINGS SHALL NOT BE USED FOR CONSTRUCTION PURPOSES UNTIL ISSUED BY THE DRAFTING OFFICE FOR CONSTRUCTION AND NOTED ON THE TITLE BLOCK.
THE WORK MUST BE VERIFIED BY STRUCTURAL ENGINEER BEFORE WORK

REV.	NOTES.	INITIAL	DATE	LEGEND
Α	DA SUBMISSION	SS	13.06.23	EXISTING
В	WINDOW & COL. CHANGE	SS	01.09.23	DEMOLISHED
				PROPOSED
				PROPOSED

CPD: CUPBOARD DP: DOWNPIPE DPS: DOWN PIPE SPITTER DPRH: DOWN PIPE RAIN HEAD FEL: FINISHED FLOOR LEVEL. FW: FLOOR WASTE HWS: HOT WATER SYSTEM RL: REDUCED LEVEL SA: SMOKE ALARM

l F
s
4
E
ı

DRAWING TITLE:	DRAWING TITLE:					
PROPOSED GROUND FLOOR PLAN						
SCALE:	DATE:					
1:100 @A3	1/9/2023					
PROJECT NO:	PROJECT NO: DRAWING NO:					
PROJECT NO. DRAWING NO.						
1010	DA07					
1010	DAU/					

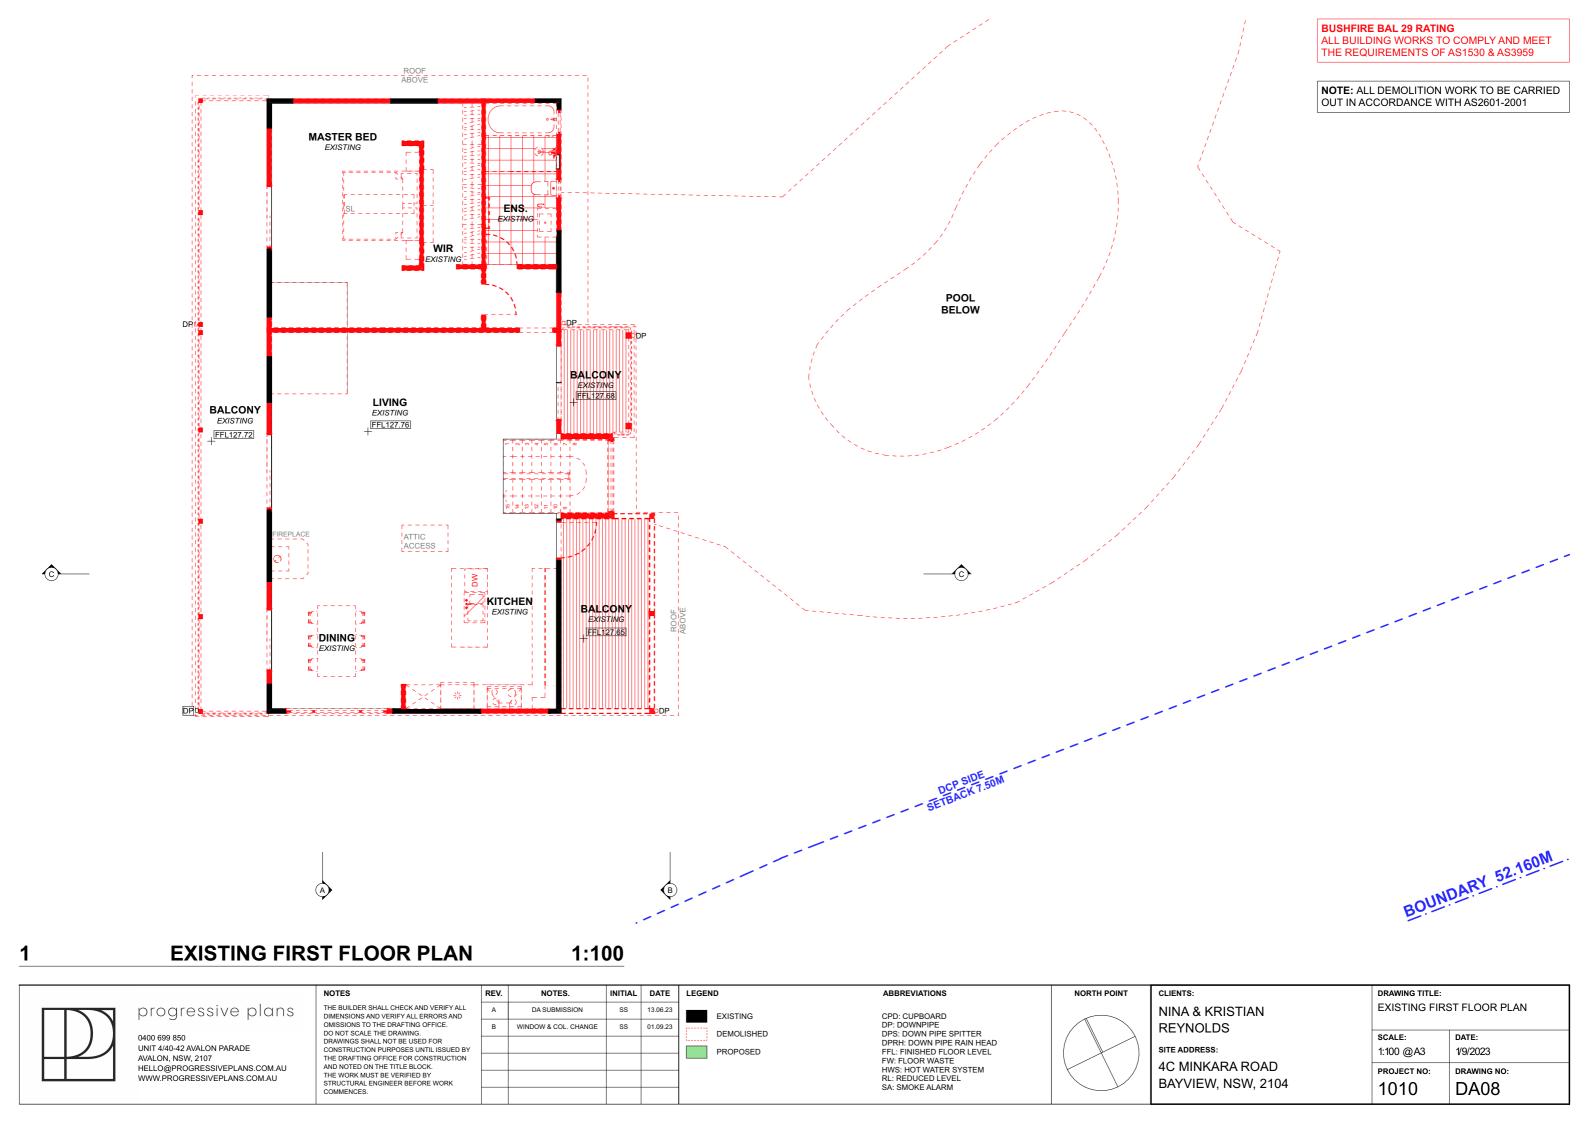



PROPOSED FIRST FLOOR PLAN



progressive plans

UNIT 4/40-42 AVALON PARADE AVALON, NSW, 2107 HELLO@PROGRESSIVEPLANS.COM.AU WWW.PROGRESSIVEPLANS.COM.AU

THE BUILDER SHALL CHECK AND VERIFY ALL DIMENSIONS AND VERIFY ALL ERRORS AND OMISSIONS TO THE DRAFTING OFFICE. DO NOT SCALE THE DRAWING. DRAWINGS SHALL NOT BE USED FOR CONSTRUCTION PURPOSES UNTIL ISSUED BY THE DRAFTING OFFICE FOR CONSTRUCTION. THE DRAFTING OFFICE FOR CONSTRUCTION
AND NOTED ON THE TITLE BLOCK.
THE WORK MUST BE VERIFIED BY
STRUCTURAL ENGINEER BEFORE WORK

	REV. NOTES.		INITIAL	DATE	LEGEND
	Α	DA SUBMISSION	SS	13.06.23	EXISTING
	В	WINDOW & COL. CHANGE	ss	01.09.23	DEMOLISHED
					PROPOSED
Γ					i

CPD: CUPBOARD
DP: DOWNPIPE
DPS: DOWN PIPE SPITTER
DPRH: DOWN PIPE RAIN HEAD
FEL: FINISHED FLOOR LEVEL
FW: FLOOR WASTE
HWS: HOT WATER SYSTEM
RL: REDUCED LEVEL
SA: SMOKE ALARM

ABBREVIATIONS




CLIENTS: NINA & KRISTIAN REYNOLDS SITE ADDRESS: 4C MINKARA ROAD BAYVIEW, NSW, 2104

DRAWING TITLE: PROPOSED FIRST FLOOR PLAN DATE: 1/9/2023 1:100 @A3 PROJECT NO: DRAWING NO: 1010 **DA09**

BUSHFIRE BAL 29 RATING
ALL BUILDING WORKS TO COMPLY AND MEET
THE REQUIREMENTS OF AS1530 & AS3959

NOTE: ALL DEMOLITION WORK TO BE CARRIED OUT IN ACCORDANCE WITH AS2601-2001

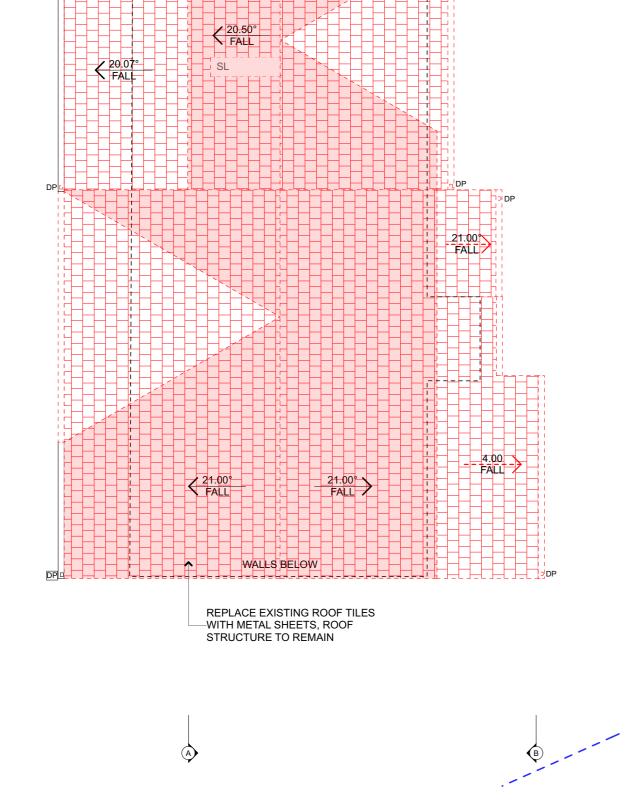

WALLS BELOW

EXISTING ROOF PLAN

1:100

7		progressive plans	
		0400 699 850	

0400 699 850
UNIT 4/40-42 AVALON PARADE
AVALON, NSW, 2107
HELLO@PROGRESSIVEPLANS.COM.AU
WWW.PROGRESSIVEPLANS.COM.AU

NOTES
THE BUILDER SHALL CHECK AND VERIFY ALL
DIMENSIONS AND VERIFY ALL ERRORS AND
OMISSIONS TO THE DRAFTING OFFICE.
DO NOT SCALE THE DRAWING.
DRAWINGS SHALL NOT BE USED FOR
CONSTRUCTION PURPOSES UNTIL ISSUED BY
THE DRAFTING OFFICE FOR CONSTRUCTION
AND NOTED ON THE TITLE BLOCK.
THE WORK MUST BE VERIFIED BY
STRUCTURAL ENGINEER BEFORE WORK

REV.	NOTES.	INITIAL	DATE	LEGEND
Α	DA SUBMISSION	SS	13.06.23	EXISTING
В	WINDOW & COL. CHANGE	SS	01.09.23	DEMOLISHED
				PROPOSED
				1

ABBREVIATIONS

CPD: CUPBOARD
DP: DOWNPIPE
DPS: DOWN PIPE SPITTER
DPRH: DOWN PIPE RAIN HEAD
FEL: FINISHED FLOOR LEVEL
FW: FLOOR WASTE
HWS: HOT WATER SYSTEM
RL: REDUCED LEVEL
SA: SMOKE ALARM

NORTH POINT

CLIENTS:
NINA & KRISTIAN REYNOLDS
SITE ADDRESS:
4C MINKARA ROAD

BAYVIEW, NSW, 2104

RAWING TITLE:				
EXISTING ROC	OF PLAN			
CALE:	DATE:			
:100 @A3	1/9/2023			
ROJECT NO:	DRAWING NO:			
1010	DA10			

BOUNDARY 52.160M

BUSHFIRE BAL 29 RATING ALL BUILDING WORKS TO COMPLY AND MEET THE REQUIREMENTS OF AS1530 & AS3959 NOTE: PROPOSED DOWNPIPES TO DRAIN INTO **EXISTING STORMWATER LINES** WALLS BELOW 33.00° FALL √ 20.50°
FALL < 33.00° FALL DΡ 5.00° 33.00° > FALL 33.00° (S01) 21.00° > WALLS BELOW 7.009 BOUNDARY 52.160M A PROPOSED ROOF / CONCEPT STORMWATER PLAN 1:100 INITIAL DATE LEGEND ABBREVIATIONS NORTH POINT CLIENTS: DRAWING TITLE: NOTES. THE BUILDER SHALL CHECK AND VERIFY ALL DIMENSIONS AND VERIFY ALL ERRORS AND OMISSIONS TO THE DRAFTING OFFICE. DO NOT SCALE THE DRAWING. DRAWINGS SHALL NOT BE USED FOR CONSTRUCTION PURPOSES UNTIL ISSUED BY THE DRAFTING OFFICE FOR CONSTRUCTION AND NOTED ON THE TITLE BLOCK. THE WORK MUST BE VERIFIED BY STRUCTURAL ENGINEER BEFORE WORK COMMENCES. PROPOSED ROOF / CONCEPT DA SUBMISSION 13.06.23 NINA & KRISTIAN progressive plans CPD: CUPBOARD
DP: DOWNPIPE
DPS: DOWN PIPE SPITTER
DPRH: DOWN PIPE RAIN HEAD
FFL: FINISHED FLOOR LEVEL
FW: FLOOR WASTE EXISTING STORMWATER PLAN WINDOW & COL. CHANGE SS 01.09.23 REYNOLDS DEMOLISHED UNIT 4/40-42 AVALON PARADE SITE ADDRESS: PROPOSED 1:100 @A3 1/9/2023

HWS: HOT WATER SYSTEM RL: REDUCED LEVEL SA: SMOKE ALARM

4C MINKARA ROAD

BAYVIEW, NSW, 2104

PROJECT NO:

1010

DRAWING NO:

DA11

AVALON, NSW, 2107 HELLO@PROGRESSIVEPLANS.COM.AU

WWW.PROGRESSIVEPLANS.COM.AU

BED BED BATH **EXISTING EXISTING** MEDIA ROOM ENSUITE LDRY **EXISTING** IINEN HALL EXISTING FFL 125.61 MASTER WIR EXISTING BED **GARAGE EXISTING ENSUITE** EXISTING FFL 125.61 B **D**____ BED 1 PATIO EXISTING GRANNY FLAT EXISTING **EXISTING GARAGE FLOOR PLAN** 1:100 ABBREVIATIONS

BUSHFIRE BAL 29 RATING

ALL BUILDING WORKS TO COMPLY AND MEET THE REQUIREMENTS OF AS1530 & AS3959

NOTE: ALL DEMOLITION WORK TO BE CARRIED OUT IN ACCORDANCE WITH AS2601-2001




0400 699 850 UNIT 4/40-42 AVALON PARADE AVALON, NSW, 2107 HELLO@PROGRESSIVEPLANS.COM.AU WWW.PROGRESSIVEPLANS.COM.AU NOTES


THE BUILDER SHALL CHECK AND VERIFY ALL DIMENSIONS AND VERIFY ALL ERRORS AND OMISSIONS TO THE DRAFTING OFFICE. DO NOT SCALE THE DRAWING. DRAWINGS SHALL NOT BE USED FOR CONSTRUCTION PURPOSES UNTIL ISSUED BY THE DRAFTING OFFICE FOR CONSTRUCTION AND NOTED ON THE TITLE BLOCK. THE WORK MUST BE VERIFIED BY STRUCTURAL ENGINEER BEFORE WORK COMMENCES.

EV.	NOTES.	INITIAL	DATE	LEGEND
A	DA SUBMISSION	SS	13.06.23	EXISTING
В	WINDOW & COL. CHANGE	SS	01.09.23	DEMOLISHED
				PROPOSED
				1

CPD: CUPBOARD
DP: DOWNPIPE
DPS: DOWN PIPE SPITTER
DPRH: DOWN PIPE RAIN HEAD
FEL: FINISHED FLOOR LEVEL
FW: FLOOR WASTE
HWS: HOT WATER SYSTEM
RL: REDUCED LEVEL
SA: SMOKE ALARM

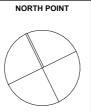

DRAWING TITLE:			
EXISTING GARAGE FLOOR PLAN			
SCALE:	DATE:		
1:100 @A3	1/9/2023		
DDG IFOT NO.	DD AMENO NO.		
PROJECT NO:	DRAWING NO:		
1010	DA12		

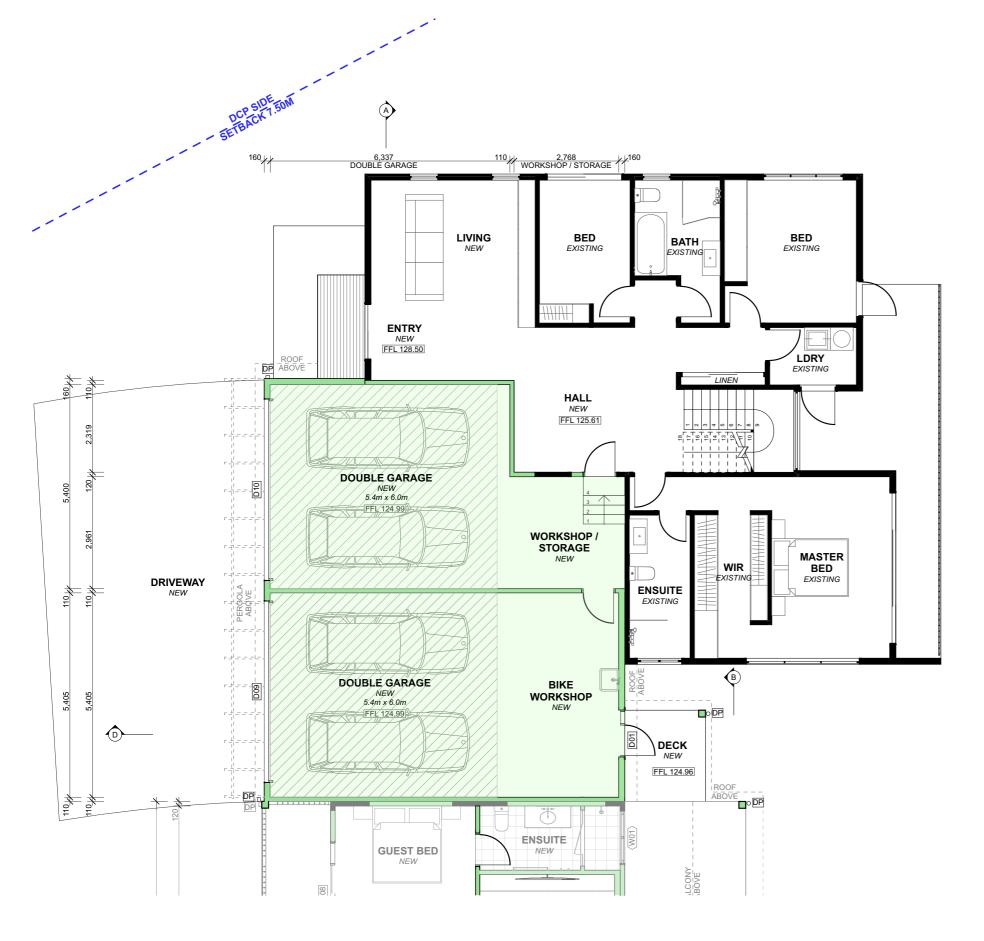

PROPOSED GARAGE FLOOR PLAN 1:100



progressive plans


UNIT 4/40-42 AVALON PARADE AVALON, NSW, 2107 HELLO@PROGRESSIVEPLANS.COM.AU WWW.PROGRESSIVEPLANS.COM.AU

THE BUILDER SHALL CHECK AND VERIFY ALL DIMENSIONS AND VERIFY ALL ERRORS AND OMISSIONS TO THE DRAFTING OFFICE. DO NOT SCALE THE DRAWING. DRAWINGS SHALL NOT BE USED FOR CONSTRUCTION PURPOSES UNTIL ISSUED BY THE DRAFTING OFFICE FOR CONSTRUCTION
AND NOTED ON THE TITLE BLOCK.
THE WORK MUST BE VERIFIED BY
STRUCTURAL ENGINEER BEFORE WORK COMMENCES.

EV.	NOTES.	INITIAL	DATE	LEGEN	D
A	DA SUBMISSION	SS	13.06.23		EXISTING
В	WINDOW & COL. CHANGE	SS	01.09.23		DEMOLISHED
					PROPOSED
					THOI GOLD

ABBREVIATIONS

CPD: CUPBOARD
DP: DOWNPIPE
DPS: DOWN PIPE SPITTER
DPRH: DOWN PIPE RAIN HEAD
FFL: FINISHED FLOOR LEVEL
FW: FLOOR WASTE
HWS: HOT WATER SYSTEM
RL: REDUCED LEVEL
SA: SMOKE ALARM

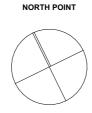

DRAWING TITLE:			
PROPOSED GARAGE FLOOR PLAN			
SCALE:	DATE:		
1:100 @A3	1/9/2023		
PROJECT NO:	DRAWING NO:		
1010	DA13		

1.00° FALL WALLS BELOW WALLS BELOW

BUSHFIRE BAL 29 RATING
ALL BUILDING WORKS TO COMPLY AND MEET
THE REQUIREMENTS OF AS1530 & AS3959

NOTE: ALL DEMOLITION WORK TO BE CARRIED OUT IN ACCORDANCE WITH AS2601-2001

1 EXISTING GARAGE ROOF PLAN 1:100



progressive plans


0400 699 850 UNIT 4/40-42 AVALON PARADE AVALON, NSW, 2107 HELLO@PROGRESSIVEPLANS.COM.AU WWW.PROGRESSIVEPLANS.COM.AU NOTES

THE BUILDER SHALL CHECK AND VERIFY ALL DIMENSIONS AND VERIFY ALL ERRORS AND OMISSIONS TO THE DRAFTING OFFICE. DO NOT SCALE THE DRAWING. DRAWINGS SHALL NOT BE USED FOR CONSTRUCTION PURPOSES UNTIL ISSUED BY THE DRAFTING OFFICE FOR CONSTRUCTION AND NOTED ON THE TITLE BLOCK. THE WORK MUST BE VERIFIED BY STRUCTURAL ENGINEER BEFORE WORK COMMENCES.


REV.	NOTES.	INITIAL	DATE	LEGEND
Α	DA SUBMISSION	SS	13.06.23	EXISTING
В	WINDOW & COL. CHANGE	SS	01.09.23	DEMOLISHED
				PROPOSED

ABBREVIATIONS

CPD: CUPBOARD
DP: DOWNPIPE
DPS: DOWN PIPE SPITTER
DPRH: DOWN PIPE RAIN HEAD
FFL: FINISHED FLOOR LEVEL
FW: FLOOR WASTE
HWS: HOT WATER SYSTEM
RL: REDUCED LEVEL
SA: SMOKE ALARM

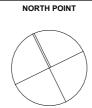

DRAWING TITLE:			
EXISTING GARAGE ROOF PLAN			
SCALE:	DATE:		
1:100 @A3	1/9/2023		
DDO IFOT NO	DD AMENO NO.		
PROJECT NO:	DRAWING NO:		
1010	DA14		

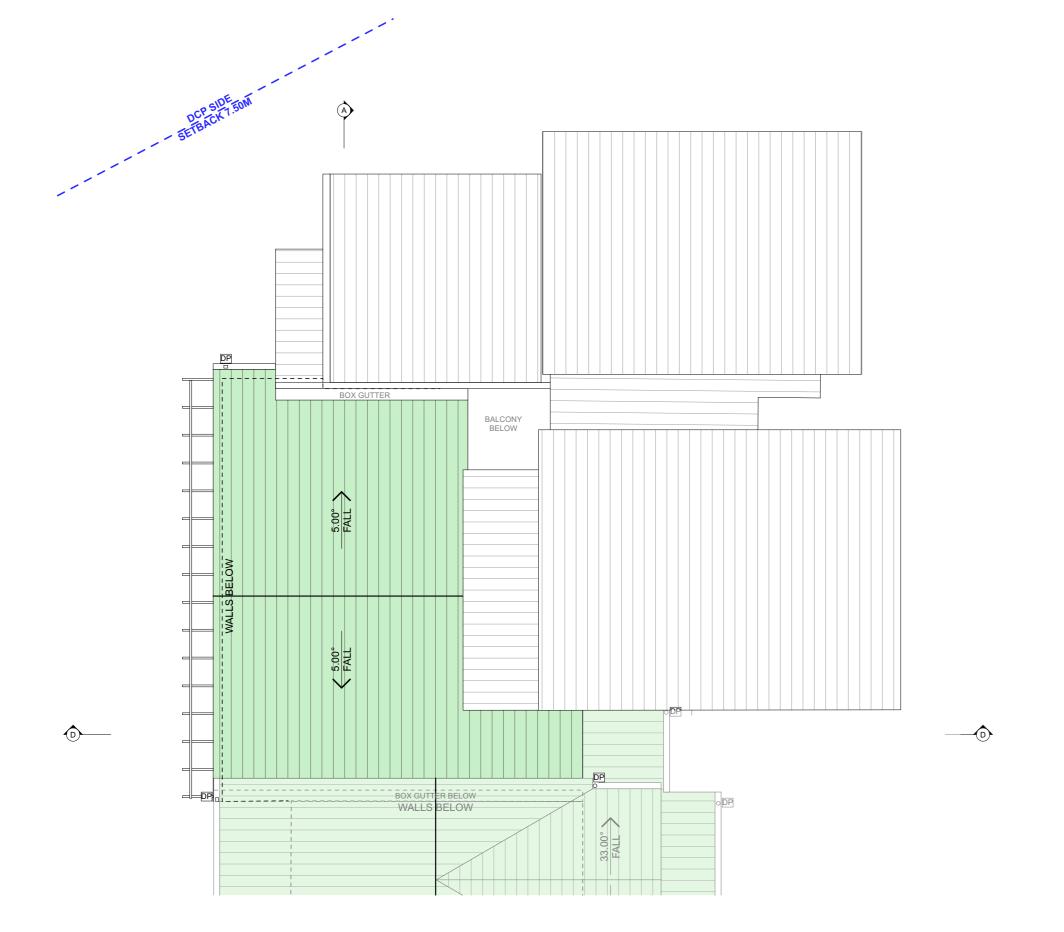

BUSHFIRE BAL 29 RATING
ALL BUILDING WORKS TO COMPLY AND MEET
THE REQUIREMENTS OF AS1530 & AS3959

NOTE: PROPOSED DOWNPIPES TO DRAIN INTO EXISTING STORMWATER LINES

1 PROPOSED GARAGE ROOF PLAN 1:100



progressive plans

0400 699 850 UNIT 4/40-42 AVALON PARADE AVALON, NSW, 2107 BYDEPROGRESSIVEPLANS.COM.AU WWW.PROGRESSIVEPLANS.COM.AU NOTES

THE BUILDER SHALL CHECK AND VERIFY ALL DIMENSIONS AND VERIFY ALL ERRORS AND OMISSIONS TO THE DRAFTING OFFICE.

DO NOT SCALE THE DRAWING.
DRAWINGS SHALL NOT BE USED FOR CONSTRUCTION PURPOSES UNTIL ISSUED BY THE DRAFTING OFFICE FOR CONSTRUCTION AND NOTED ON THE TITLE BLOCK.
THE WORK MUST BE VERIFIED BY STRUCTURAL ENGINEER BEFORE WORK COMMENCES.

REV.	NOTES.	INITIAL	DATE	LEGEND
Α	DA SUBMISSION	SS	13.06.23	EXISTING
В	WINDOW & COL. CHANGE	ss	01.09.23	DEMOLISHED
				PROPOSED

ABBREVIATIONS

CPD: CUPBOARD
DP: DOWNPIPE
DPS: DOWN PIPE SPITTER
DPRH: DOWN PIPE RAIN HEAD
FEL: FINISHED FLOOR LEVEL
FW: FLOOR WASTE
HWS: HOT WATER SYSTEM
RL: REDUCED LEVEL
SA: SMOKE ALARM




CLIENTS: NINA & KRISTIAN REYNOLDS SITE ADDRESS:

INE INCEDE
SITE ADDRESS:
4C MINKARA ROAD
BAYVIEW, NSW, 210

DRAWING TITLE:		
PROPOSED GARAGE ROOF PLAN		
SCALE:	DATE:	
1:100 @A3	1/9/2023	
PROJECT NO:	DRAWING NO:	
1010	DΔ15	

8.50M LEP HEIGHT CONTROL

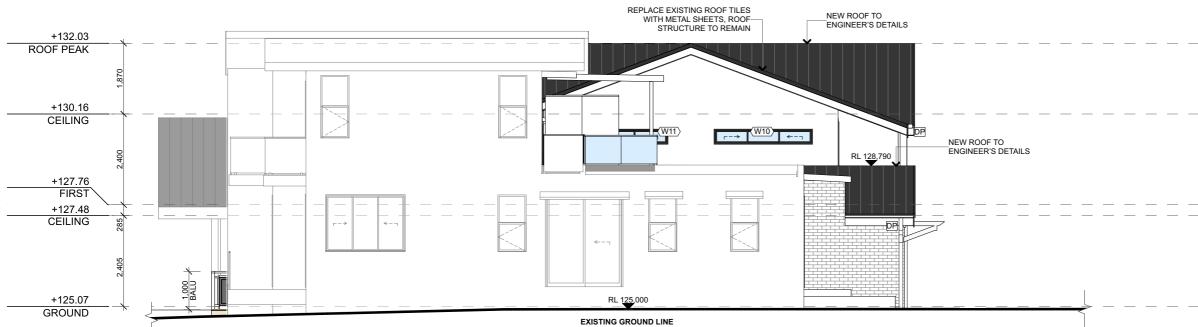

1 NORTH ELEVATION 1:100



2 SOUTH ELEVATION 1:100

LEGEND DRAWING TITLE: REV. NOTES. INITIAL DATE ABBREVIATIONS CLIENTS: THE BUILDER SHALL CHECK AND VERIFY ALL DIMENSIONS AND VERIFY ALL ERRORS AND **ELEVATIONS - NORTH & SOUTH** progressive plans DA SURMISSION 13.06.23 **NINA & KRISTIAN** BOARD AND BATTENS EXISTING CPD: CUPBOARD DP: DOWNPIPE DPS: DOWN PIPE SPITTER OMISSIONS TO THE DRAFTING OFFICE. WINDOW & COL. CHANGE SS 01.09.23 **REYNOLDS** OMISSIONS TO THE DRAFTING OFFICE.


DO NOT SCALE THE DRAWING.


DRAWINGS SHALL NOT BE USED FOR


CONSTRUCTION PURPOSES UNTIL ISSUED BY SANDSTONE WALL DEMOLISHED DPRH: DOWN PIPE RAIN HEAD UNIT 4/40-42 AVALON PARADE SITE ADDRESS: FFL: FINISHED FLOOR LEVEL HWS: HOT WATER SYSTEM TIMBER POST 1:100 @A3 1/9/2023 THE DRAFTING OFFICE FOR CONSTRUCTION
AND NOTED ON THE TITLE BLOCK.
THE WORK MUST BE VERIFIED BY
STRUCTURAL ENGINEER BEFORE WORK AVALON, NSW, 2107 4C MINKARA ROAD HELLO@PROGRESSIVEPLANS.COM.AU GLASS RL: REDUCED LEVEL PROJECT NO: DRAWING NO: WWW.PROGRESSIVEPLANS.COM.AU BAYVIEW, NSW, 2104 1010 ROOF SHEETS **DA16** COMMENCES

BUSHFIRE BAL 29 RATING ALL BUILDING WORKS TO COMPLY AND MEET THE REQUIREMENTS OF AS1530 & AS3959


NOTE: SETBACKS HAVE NOT BEEN SHOWN DUE TO SPLAYED LOT BOUNDARIES, WITH SETBACKS BEST REPRESENTED ON SITE PLANS

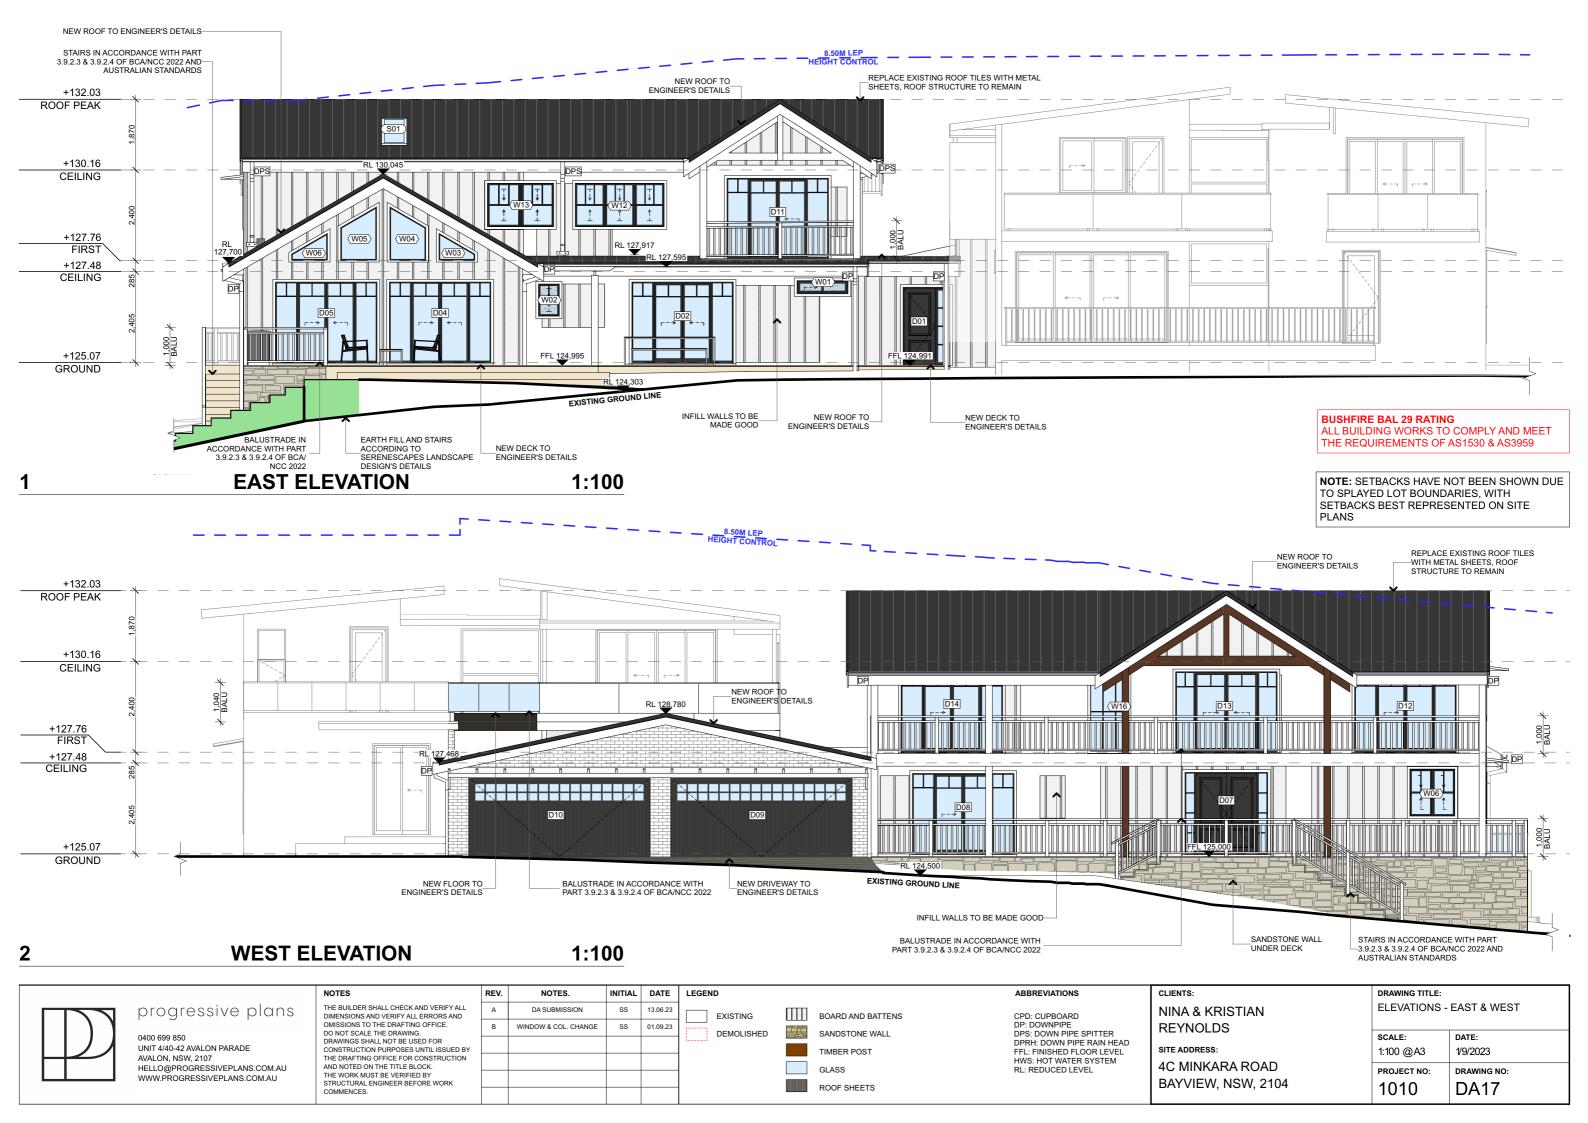

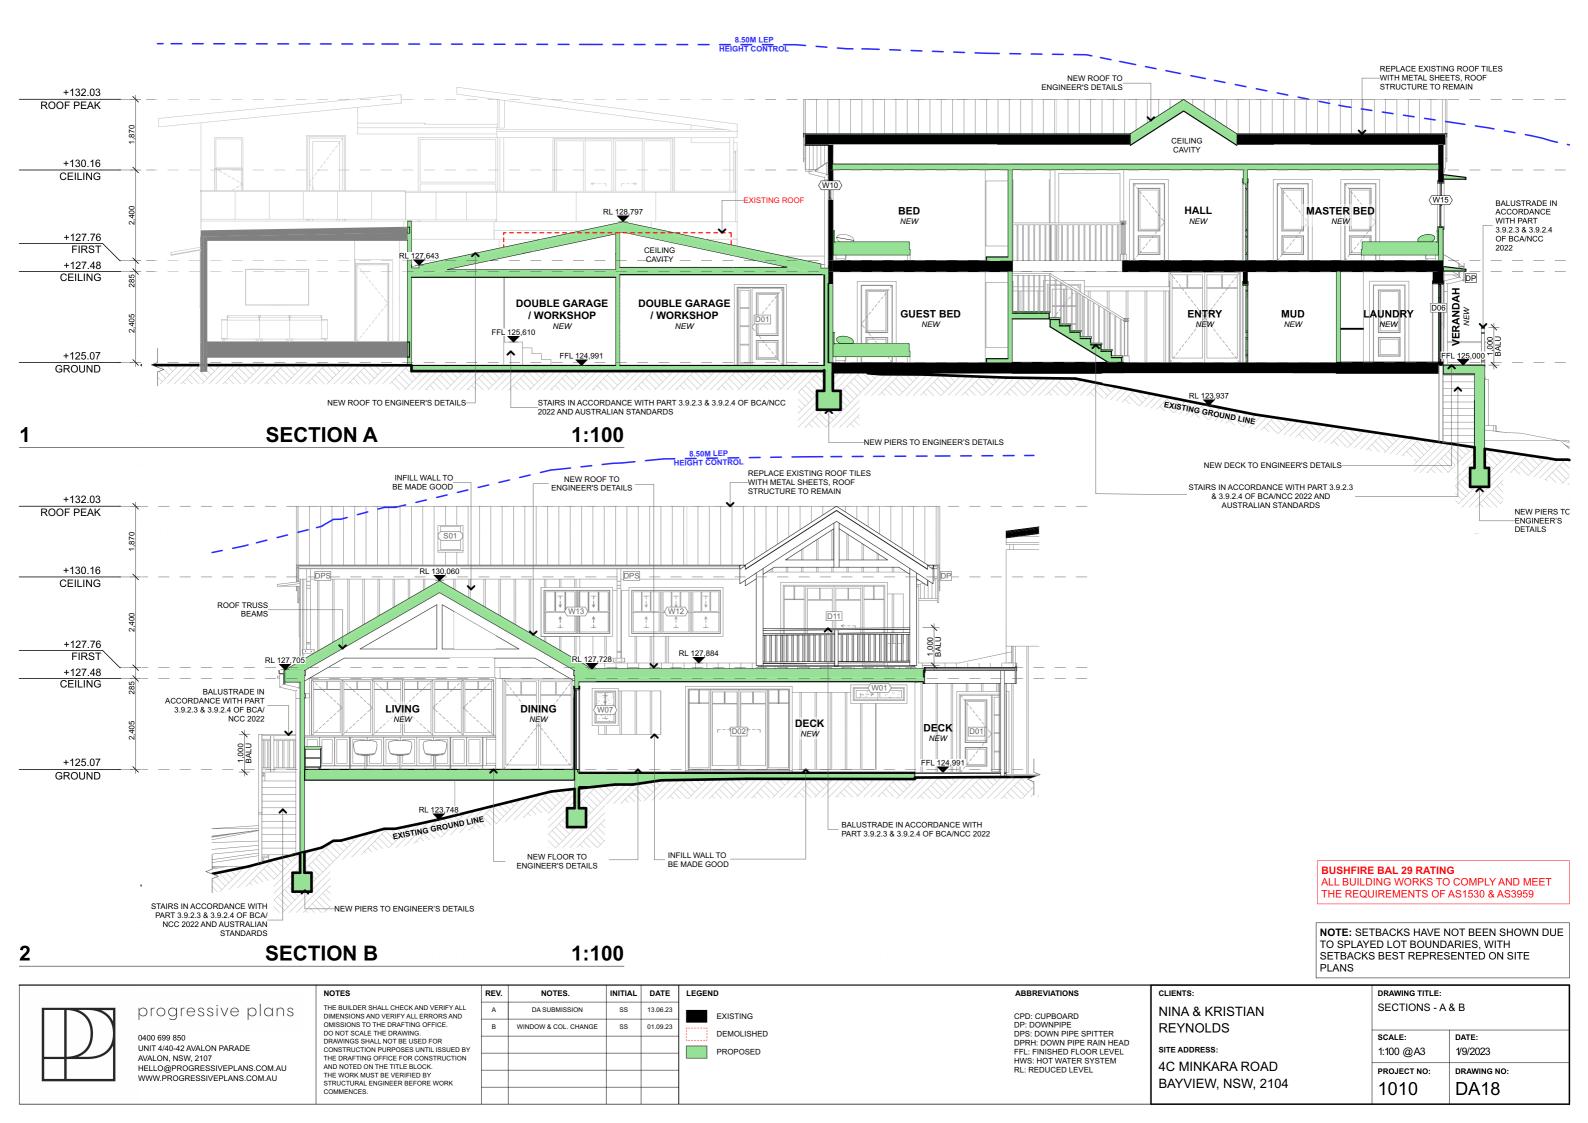

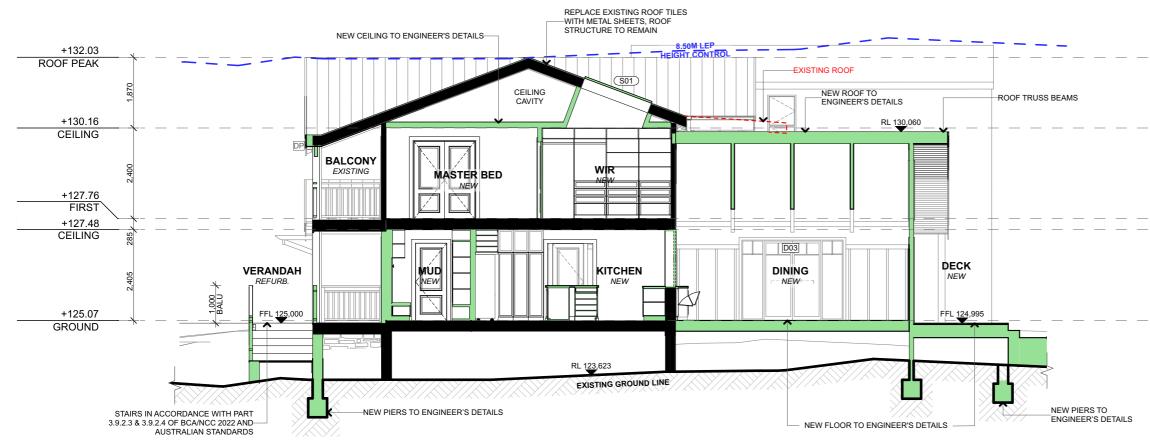

1 SECTION C 1:100

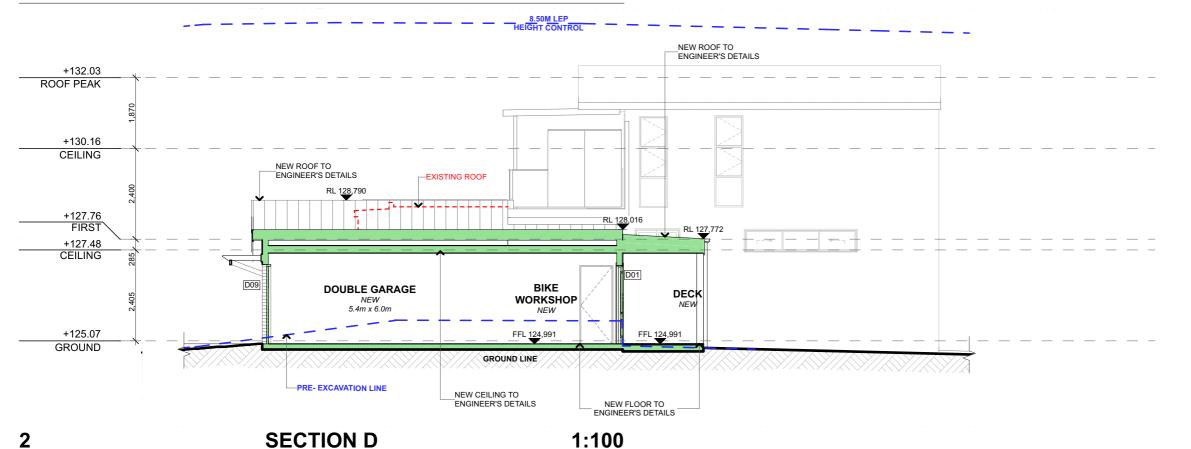

BUSHFIRE BAL 29 RATING

ALL BUILDING WORKS TO COMPLY AND MEET THE REQUIREMENTS OF AS1530 & AS3959

NOTE: SETBACKS HAVE NOT BEEN SHOWN DUE TO SPLAYED LOT BOUNDARIES, WITH SETBACKS BEST REPRESENTED ON SITE PLANS



progressive plans

0400 699 850 UNIT 4/40-42 AVALON PARADE AVALON, NSW, 2107 HELLO@PROGRESSIVEPLANS.COM.AU WWW.PROGRESSIVEPLANS.COM.AU NOTES


THE BUILDER SHALL CHECK AND VERIFY ALL DIMENSIONS AND VERIFY ALL ERRORS AND OMISSIONS TO THE DRAFTING OFFICE. DO NOT SCALE THE DRAWING. DRAWINGS SHALL NOT BE USED FOR CONSTRUCTION PURPOSES UNTIL ISSUED BY THE DRAFTING OFFICE FOR CONSTRUCTION AND NOTED ON THE TITLE BLOCK. THE WORK MUST BE VERIFIED BY STRUCTURAL ENGINEER BEFORE WORK COMMENCES

REV.	NOTES.	INITIAL	DATE	LEGEND
Α	DA SUBMISSION	SS	13.06.23	EXISTING
В	WINDOW & COL. CHANGE	SS	01.09.23	DEMOLISHED
				PROPOSED

CPD: CUPBOARD DP: DOWNPIPE DPS: DOWN PIPE SPITTER DPRH: DOWN PIPE RAIN HEAD FFL: FINISHED FLOOR LEVEL HWS: HOT WATER SYSTEM RL: REDUCED LEVEL

ABBREVIATIONS

DRAWING TITLE:		
SECTIONS - C & D		
SCALE:	DATE:	
1:100 @A3	1/9/2023	
PROJECT NO:	DRAWING NO:	
1010	DA19	

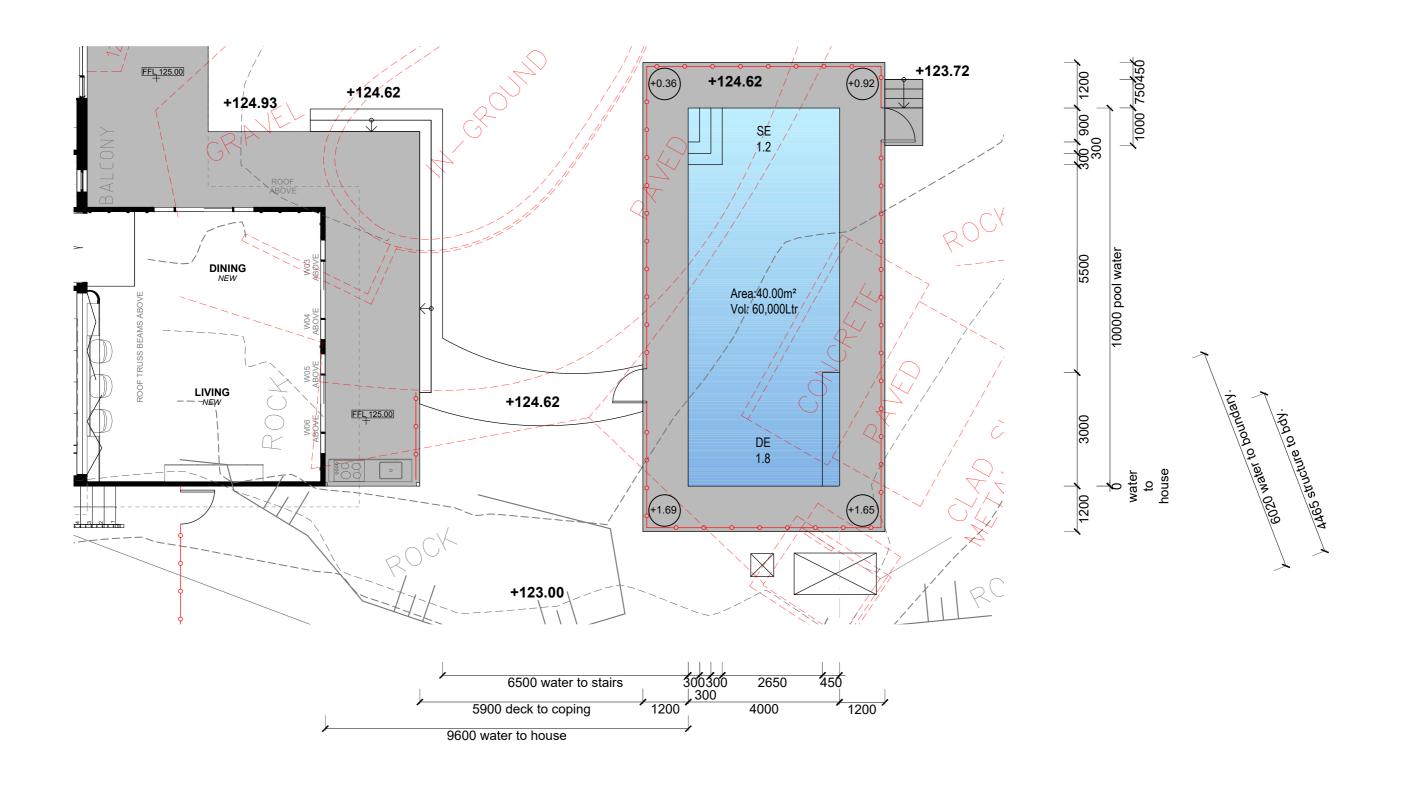

BUSHFIRE BAL 29 RATING
ALL BUILDING WORKS TO COMPLY AND MEET
THE REQUIREMENTS OF AS1530 & AS3959

NOTE: POOL PLAN TO SERENESCAPES LANDSCAPE DESIGNS DETAILS



progressive plans


UNIT 4/40-42 AVALON PARADE AVALON, NSW, 2107 HELLO@PROGRESSIVEPLANS.COM.AU WWW.PROGRESSIVEPLANS.COM.AU

THE BUILDER SHALL CHECK AND VERIFY ALL DIMENSIONS AND VERIFY ALL ERRORS AND OMISSIONS TO THE DRAFTING OFFICE. DO NOT SCALE THE DRAWING. DRAWINGS SHALL NOT BE USED FOR CONSTRUCTION PURPOSES UNTIL ISSUED BY THE DRAFTING OFFICE FOR CONSTRUCTION AND NOTED ON THE TITLE BLOCK. THE WORK MUST BE VERIFIED BY STRUCTURAL ENGINEER BEFORE WORK COMMENCES.

REV.	NOTES.	INITIAL	DATE	LEGEN	D
Α	DA SUBMISSION	SS	13.06.23		EXISTING
В	WINDOW & COL. CHANGE	SS	01.09.23		DEMOLISHED
					PROPOSED
				l	

ABBREVIATIONS


CPD: CUPBOARD
DP: DOWNPIPE
DPS: DOWN PIPE SPITTER
DPRH: DOWN PIPE RAIN HEAD
FFL: FINISHED FLOOR LEVEL
FW: FLOOR WASTE
HWS: HOT WATER SYSTEM
RL: REDUCED LEVEL
SA: SMOKE ALARM

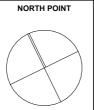

CLIENTS: NINA & KRISTIAN REYNOLDS SITE ADDRESS: 4C MINKARA ROAD

BAYVIEW, NSW, 2104

DRAWING TITLE:	
POOL PLANS	
SCALE:	DATE:
1:100 @A3	1/9/2023
PROJECT NO:	DRAWING NO:
	DRAWING NO.
1010	DA20
	•

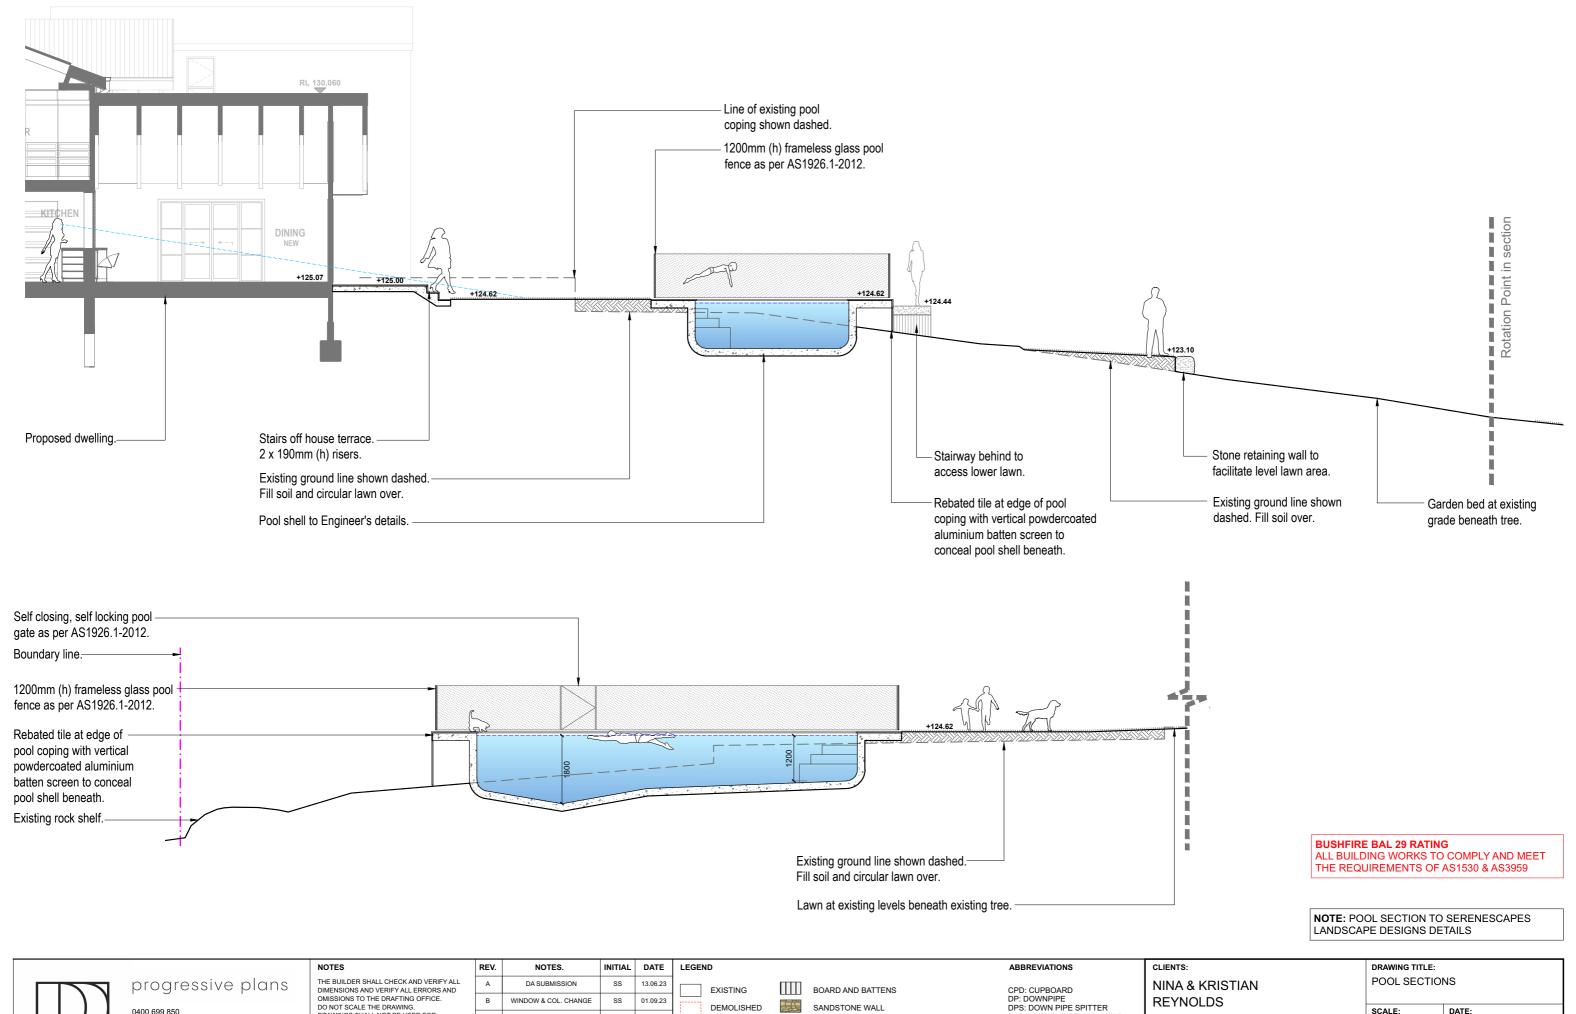



UNIT 4/40-42 AVALON PARADE AVALON, NSW, 2107 HELLO@PROGRESSIVEPLANS.COM.AU WWW.PROGRESSIVEPLANS.COM.AU

OMISSIONS TO THE DRAFTING OFFICE.

DO NOT SCALE THE DRAWING.

DRAWINGS SHALL NOT BE USED FOR

CONSTRUCTION PURPOSES UNTIL ISSUED BY THE DRAFTING OFFICE FOR CONSTRUCTION
AND NOTED ON THE TITLE BLOCK.
THE WORK MUST BE VERIFIED BY
STRUCTURAL ENGINEER BEFORE WORK

REV.	NOTES.	INITIAL	DATE	LEGEND
Α	DA SUBMISSION	SS	13.06.23	EXISTING BOARD AND BATTENS
В	WINDOW & COL. CHANGE	SS	01.09.23	DEMOLISHED SANDSTONE WALL
				TIMBER POST
				GLASS
				ROOF SHEETS
		I	I	

CPD: CUPBOARD
DP: DOWNPIPE
DPS: DOWN PIPE SPITTER
DPRH: DOWN PIPE RAIN HEAD
FFL: FINISHED FLOOR LEVEL
HWS: HOT WATER SYSTEM RL: REDUCED LEVEL

SITE ADDRESS: 4C MINKARA ROAD

BAYVIEW, NSW, 2104

DRAWING TITLE:	
POOL SECTION	NS
SCALE:	DATE:
1:100 @A3	1/9/2023
PROJECT NO:	DRAWING NO:
PROJECT NO:	DRAWING NO:
1010	DA21



ROOF
- COLORBOND MATT IN MONUMENT
OR SIMILAR

GABLE ROOF TRUSS & COLUMN
- RAW RECYCLED TIMBER OR SIMILAR

DOORS & WINDOWS
- PAINTED COLORBOND MONUMENT BLACK
OR SIMILAR



WALLS
- FIBRE CEMENT BOARD WITH TIMBER BATTENS
PAINTED WHITE OR SIMILAR

RAILINGS, GUTTERS & DP, ROOF TRIMS
- PAINTED WHITE OR SIMILAR



progressive plans

0400 699 850 UNIT 4/40-42 AVALON PARADE AVALON, NSW, 2107 HELLO@PROGRESSIVEPLANS.COM.AU WWW.PROGRESSIVEPLANS.COM.AU

OTES

THE BUILDER SHALL CHECK AND VERIFY ALL DIMENSIONS AND VERIFY ALL ERRORS AND OMISSIONS TO THE DRAFTING OFFICE. DO NOT SCALE THE DRAWING. DRAWINGS SHALL NOT BE USED FOR CONSTRUCTION PURPOSES UNTIL ISSUED BY THE DRAFTING OFFICE FOR CONSTRUCTION AND NOTED ON THE TITLE BLOCK. THE WORK MUST BE VERIFIED BY STRUCTURAL ENGINEER BEFORE WORK COMMENCES.


REV.	NOTES.	INITIAL	DATE
Α	DA SUBMISSION	SS	13.06.23
В	WINDOW & COL. CHANGE	SS	01.09.23

CLIENTS:
NINA & KRISTIAN
REYNOLDS

SITE ADDRESS:

4C MINKARA ROAD BAYVIEW, NSW, 2104

DRAWING TITLE:		
FINISHES BOARD		
SCALE:	DATE:	
NTS	1/9/2023	
PROJECT NO:	DRAWING NO:	
	DRAWING NO:	
1010	DA22	

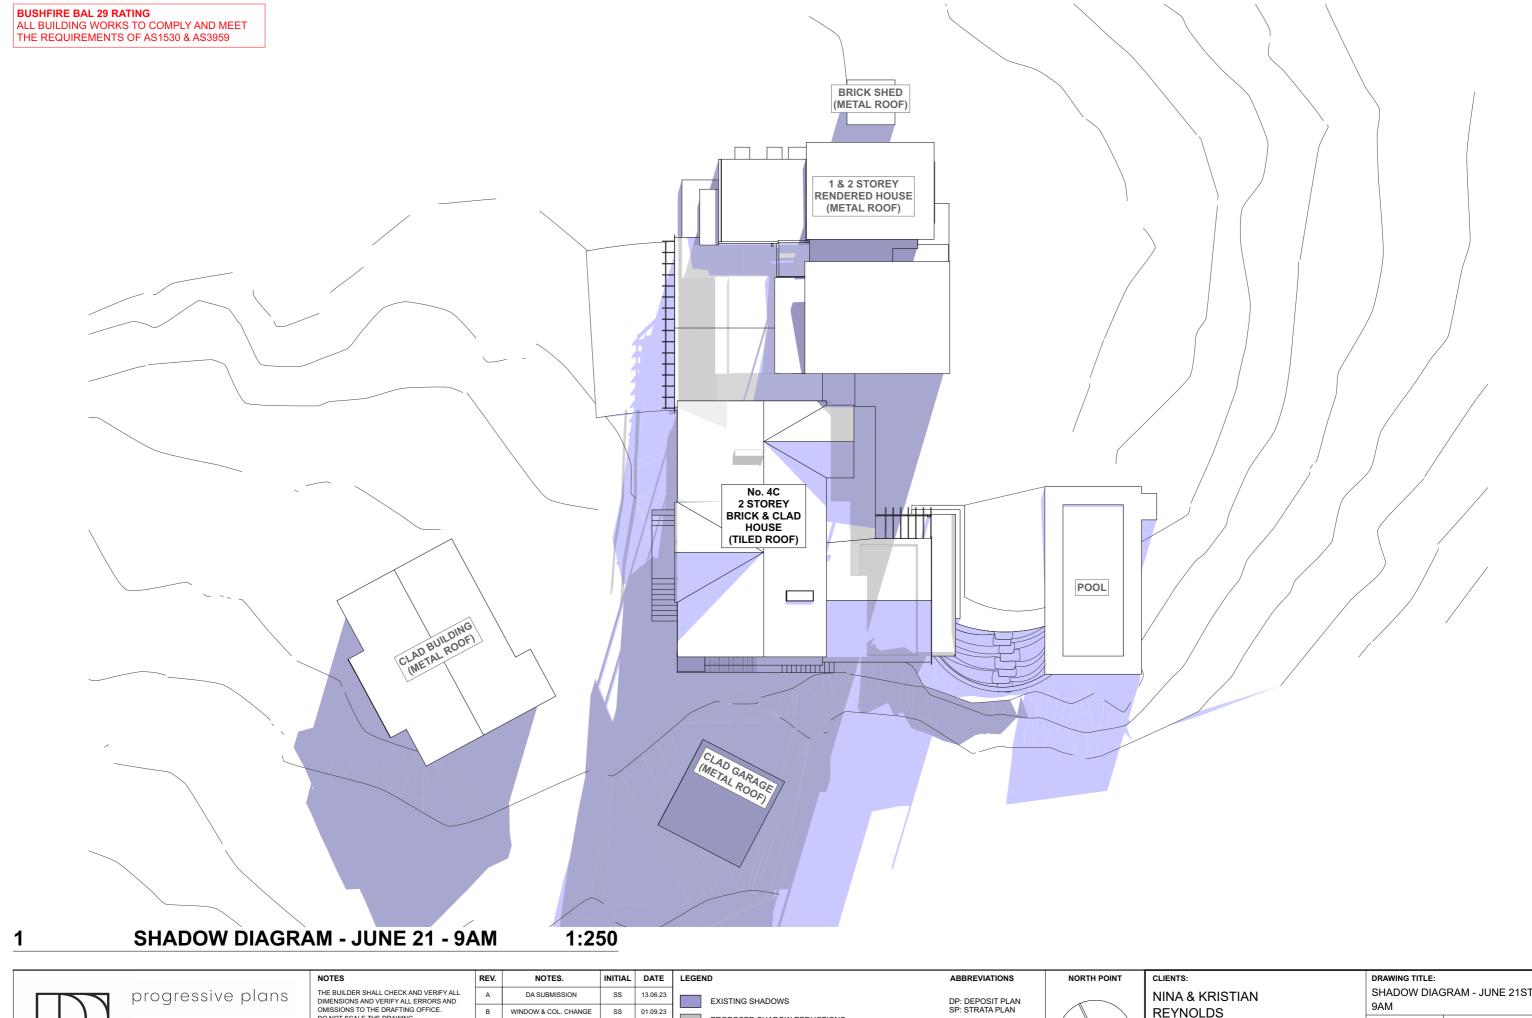




0400 699 850 UNIT 4/40-42 AVALON PARADE AVALON, NSW, 2107 HELLO@PROGRESSIVEPLANS.COM.AU WWW.PROGRESSIVEPLANS.COM.AU THE BUILDER SHALL CHECK AND VERIFY ALL DIMENSIONS AND VERIFY ALL ERRORS AND OMISSIONS TO THE DRAFTING OFFICE. DO NOT SCALE THE DRAWING. DRAWINGS SHALL NOT BE USED FOR CONSTRUCTION PURPOSES UNTIL ISSUED BY THE DRAFTING OFFICE FOR CONSTRUCTION AND NOTED ON THE TITLE BLOCK. THE WORK MUST BE VERIFIED BY STRUCTURAL ENGINEER BEFORE WORK COMMENCES.

REV.	NOTES.	INITIAL	DATE	LEGEND
Α	DA SUBMISSION	SS	13.06.23	EXISTING SHADOWS
В	WINDOW & COL. CHANGE	SS	01.09.23	PROPOSED SHADOW REDUCTIONS
				PROPOSED SHADOW ADDITIONS

PLAN LAN

CLIENTS:
NINA & KRISTIAN
REYNOLDS
SITE ADDRESS:
4C MINKARA ROAD
BAYVIEW, NSW, 2104

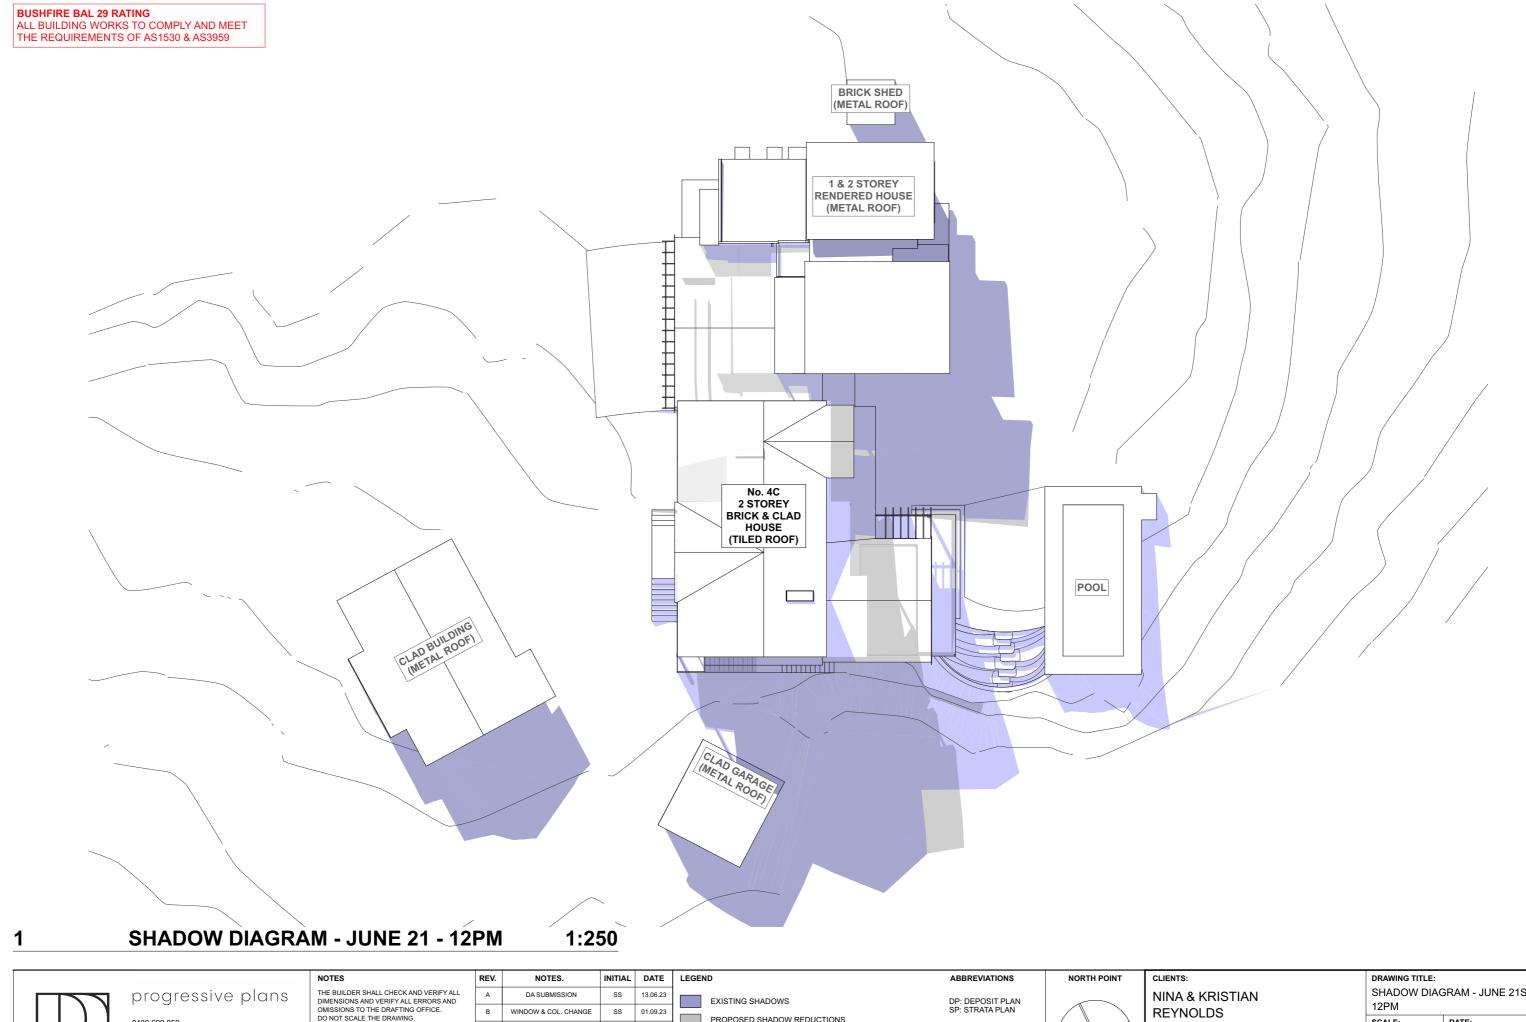




UNIT 4/40-42 AVALON PARADE AVALON, NSW, 2107 HELLO@PROGRESSIVEPLANS.COM.AU WWW.PROGRESSIVEPLANS.COM.AU

THE BUILDER SHALL CHECK AND VERIFY ALL DIMENSIONS AND VERIFY ALL ERRORS AND OMISSIONS TO THE DRAFTING OFFICE. DO NOT SCALE THE DRAWING. DRAWINGS SHALL NOT BE USED FOR CONSTRUCTION PURPOSES UNTIL ISSUED BY THE DRAFTING OFFICE FOR CONSTRUCTION AND NOTED ON THE TITLE BLOCK. THE WORK MUST BE VERIFIED BY STRUCTURAL ENGINEER BEFORE WORK COMMENCES. COMMENCES.

KEV.	NOTES.	INITIAL	DAIL	LEGEND
Α	DA SUBMISSION	SS	13.06.23	EXISTING SHADOWS
В	WINDOW & COL. CHANGE	SS	01.09.23	PROPOSED SHADOW REDUCTIONS
				The object in th
				PROPOSED SHADOW ADDITIONS

SITE ADDRESS: 4C MINKARA ROAD BAYVIEW, NSW, 2104 SHADOW DIAGRAM - JUNE 21ST -SCALE: 1:250 @A3 1/9/2023 PROJECT NO: DRAWING NO: DA24 1010

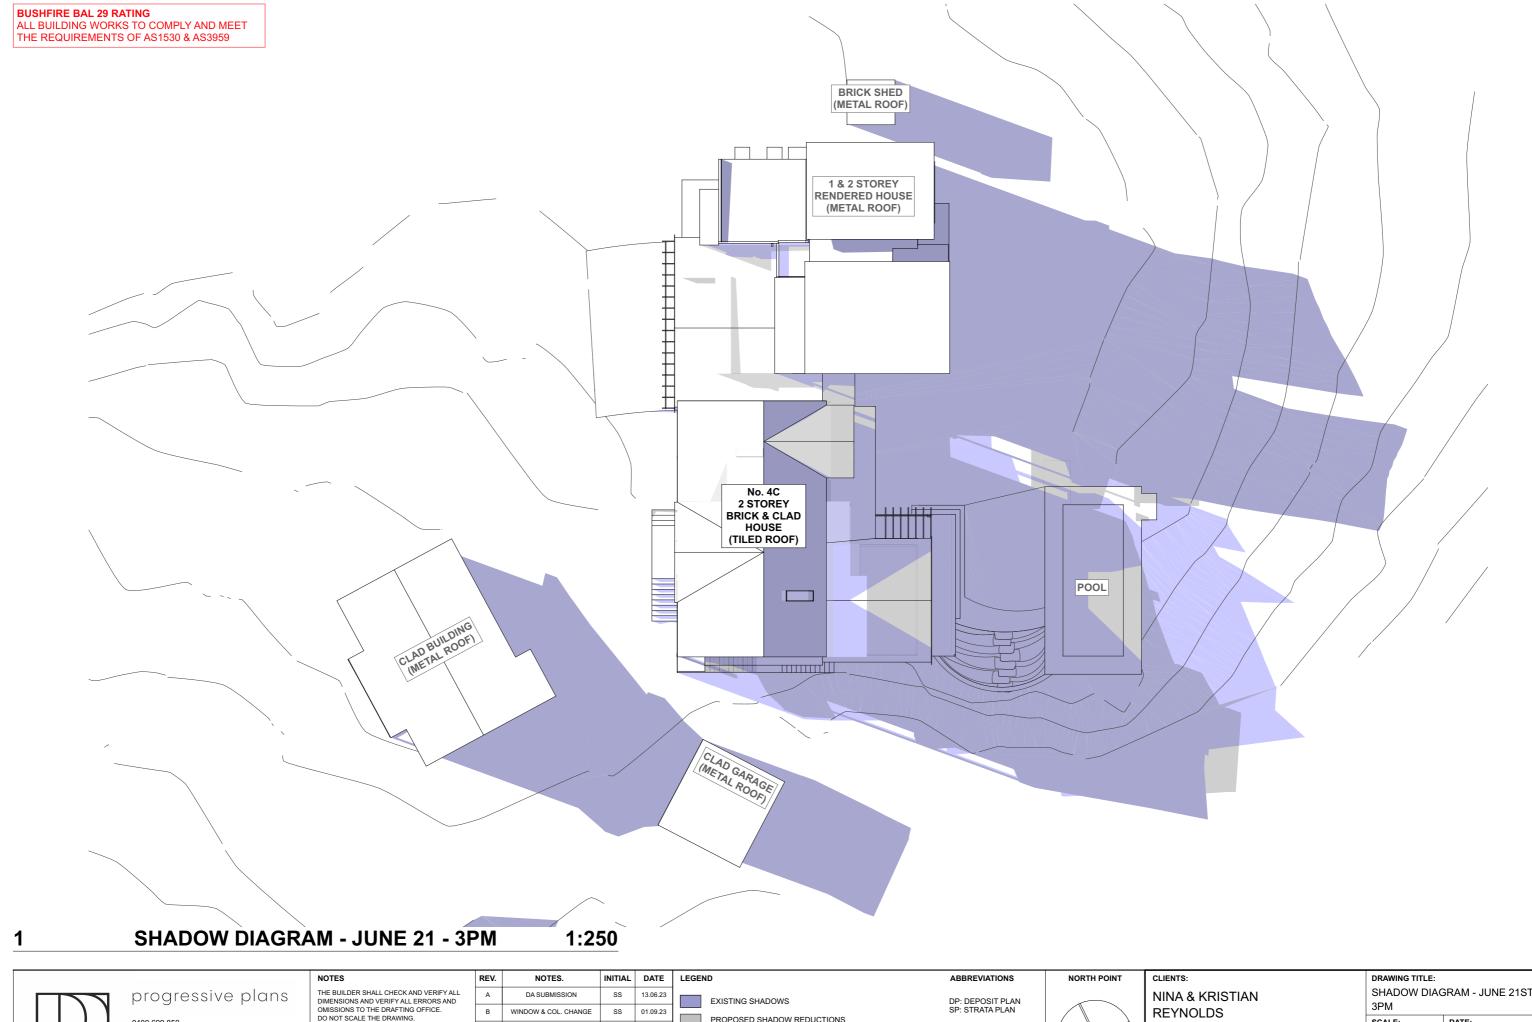



UNIT 4/40-42 AVALON PARADE AVALON, NSW, 2107 HELLO@PROGRESSIVEPLANS.COM.AU WWW.PROGRESSIVEPLANS.COM.AU

THE BUILDER SHALL CHECK AND VERIFY ALL DIMENSIONS AND VERIFY ALL ERRORS AND OMISSIONS TO THE DRAFTING OFFICE. DO NOT SCALE THE DRAWING. DRAWINGS SHALL NOT BE USED FOR CONSTRUCTION PURPOSES UNTIL ISSUED BY THE DRAFTING OFFICE FOR CONSTRUCTION AND NOTED ON THE TITLE BLOCK. THE WORK MUST BE VERIFIED BY STRUCTURAL ENGINEER BEFORE WORK COMMENCES.

REV.	NOTES.	INITIAL	DATE	LEGEND
Α	DA SUBMISSION	SS	13.06.23	EXISTING SHADOWS
В	WINDOW & COL. CHANGE	SS	01.09.23	PROPOSED SHADOW REDUCTIONS PROPOSED SHADOW ADDITIONS
				THOI GOLD STADOW ADDITIONS

SITE ADDRESS: 4C MINKARA ROAD BAYVIEW, NSW, 2104 SHADOW DIAGRAM - JUNE 21ST -1:250 @A3 1/9/2023 PROJECT NO: DRAWING NO: DA25 1010



Building Sustainability Index www.basix.nsw.gov.au

Alterations and Additions

Certificate number: A489234

This certificate confirms that the proposed development will meet the NSW government's requirements for sustainability, if it is built in accordance with the commitments set out below. Terms used in this certificate, or in the commitments, have the meaning given by the document entitled "BASIX Alterations and Additions Definitions" dated 06/10/2017 published by the Department. This document is available at www.basix.nsw.gov.au

Secretary
Date of issue: Wednesday, 05, July 2023
To be valid, this certificate must be lodged within 3 months of the date of issue.



development may be issued.

Project address	Project address							
Project name	BAYVIEW - 4C Minkara Road							
Street address	4c Minkara Road Baview 2104							
Local Government Area	Northern Beaches Council							
Plan type and number	Deposited Plan 774017							
Lot number	53							
Section number								
Project type								
Dwelling type	Separate dwelling house							
Type of alteration and addition	My renovation work is valued at \$50,000 or more and includes a pool (and/or spa).							

Certificate Prepared by (please complete before submitting to Council or PCA)
Name / Company Name: Progressive Plans
ABN (if applicable): 59879808402

Legend
In these commitments, "applicant" means the person carrying out the development.
Commitments identified with a "\sqrt{"}" in the "Show on DA plans" column must be shown on the plans accompanying the development application for the proposed development (if a development application is to be lodged for the proposed development).
Commitments identified with a "\sqrt{"}" in the "Show on CC/CDC plans & specs" column must be shown in the plans and specifications accompanying the application for a construction certificate / complying development certificate for the proposed development.
Commitments identified with a "\right" in the "Certifier check" column must be certified by a certifying authority as having been fulfilled, before a final occupation certificate for the

Des

Construction			Show on DA Plans	Show on CC/CDC Plans & specs	Certifier Check
nsulation requirements					
The applicant must construct the new or altered the table below, except that a) additional insulat is not required for parts of altered construction v	~	✓	~		
Construction	Additional insulation required (R-value)	Other specifications			
concrete slab on ground floor.	nil				
suspended floor with open subfloor: framed (R0.7).	R0.8 (down) (or R1.50 including construction)				
floor above existing dwelling or building.	nil				
external wall: framed (weatherboard, fibro, metal clad)	R1.30 (or R1.70 including construction)				
internal wall shared with garage: plasterboard (R0.36)	nil				
flat ceiling, pitched roof	ceiling: R3.00 (up), roof: foil/sarking	dark (solar absorptance > 0.70)			

Fixtures and systems	Show on DA Plans	Show on CC/CDC Plans & specs	Certifier Check
Lighting			
The applicant must ensure a minimum of 40% of new or altered light fixtures are fitted with fluorescent, compact fluorescent, or light-emitting-diode (LED) lamps.		✓	✓
Fixtures			
The applicant must ensure new or altered showerheads have a flow rate no greater than 9 litres per minute or a 3 star water rating.		✓	~
The applicant must ensure new or altered toilets have a flow rate no greater than 4 litres per average flush or a minimum 3 star water rating.		✓	✓
The applicant must ensure new or altered taps have a flow rate no greater than 9 litres per minute or minimum 3 star water rating.		✓	

Pool and Spa	Show on DA Plans	Show on CC/CDC Plans & specs	Certifier Check
Rainwater tank			
The applicant must install a rainwater tank of at least 1273 litres on the site. This rainwater tank must meet, and be installed in accordance with, the requirements of all applicable regulatory authorities.	~	~	~
The applicant must configure the rainwater tank to collect rainwater runoff from at least 363.15 square metres of roof area.		✓	~
The applicant must connect the rainwater tank to a tap located within 10 metres of the edge of the pool.		✓	~
Outdoor swimming pool	•		
The swimming pool must be outdoors.	V	✓	~
The swimming pool must not have a capacity greater than 60 kilolitres.	✓	✓	~
The swimming pool must have a pool cover.		~	✓
The applicant must install a pool pump timer for the swimming pool.		✓	~
The applicant must install the following heating system for the swimming pool that is part of this development: electric heat pump.		V	_

Skylights								
The applicant mus	e applicant must install the skylights in accordance with the specifications listed in the table below.							
The following requ	irements must also	be satisfied in relation to each	skylight:		~	~		
Each skylight may the table below.		~	✓					
Skylights glaz								
Skylight number	Area of glazing inc. frame (m2)	Shading device	Frame and glass type					
S01	1.23	no shading	timber, low-E internal/argon fill/clear external, (or U-value: 2.5, SHGC: 0.456)	71				



progressive plans

UNIT 4/40-42 AVALON PARADE AVALON, NSW, 2107 HELLO@PROGRESSIVEPLANS.COM.AU WWW.PROGRESSIVEPLANS.COM.AU

THE BUILDER SHALL CHECK AND VERIFY ALL DIMENSIONS AND VERIFY ALL ERRORS AND OMISSIONS TO THE DRAFTING OFFICE. DO NOT SCALE THE DRAWING. DRAWINGS SHALL NOT BE USED FOR CONSTRUCTION PURPOSES UNTIL ISSUED BY THE DRAFTING OFFICE FOR CONSTRUCTION AND NOTED ON THE TITLE BLOCK. THE WORK MUST BE VERIFIED BY STRUCTURAL ENGINEER BEFORE WORK COMMENCES.

COMMENCES.

	REV.	NOTES.	INITIAL	DATE	NOTES
	Α	DA SUBMISSION	SS	13.06.23	- DOORS
	В	WINDOW & COL. CHANGE	SS	01.09.23	- DOORS - NEW W
,					- NEW W

- DOORS, WINDOWS & SKYLIGHTS TO MEET BASIX/NATHERS REQUIREMENTS
- DOORS, WINDOWS & SKYLIGHTS TO BE ORDERED TO MEASURE BY BUILDER/SUPPLIER
- NEW WINDOWS TO BEDROOMS IN ACCORDANCE WITH PART 3.9.2.6 OF NCC
- NEW WINDOWS TO ROOMS OTHER THAN BEDROOMS IN ACCORDANCE WITH PART 3.9.2.7 OF NCC

DRAWING TITLE:						
BASIX REQUIREMENTS						
SCALE:	DATE:					
	1/9/2023					
DDO IFOT NO	DD AMENIC NO.					
PROJECT NO:	DRAWING NO:					
1010	DA26					

Glazing re	equirements						Show on DA Plans	Show on CC/CDC Plans & specs	Certifier Check
Windows a	and glazed d	loors							
	nt must install rershadowing s	the specifications listed in the table below.	✓	✓	✓				
The followin	ng requirement	s must also	be satisfi	ed in relation	to each window and glazed door:			✓	✓
have a U-va	alue and a Sola	ar Heat Gai	n Coefficie	ent (SHGC) r		d glass may either match the description, or, le below. Total system U-values and SHGCs s.		✓	✓
					each eave, pergola, verandah, bal han 2400 mm above the sill.	cony or awning must be no more than 500 mm	✓	✓	✓
	ons described a nown in the tab		he ratio of	f the projection	on from the wall to the height above	the window or glazed door sill must be at	✓	✓	✓
Pergolas wit	th polycarbona	ate roof or s	imilar tran	slucent mate	erial must have a shading coefficien	t of less than 0.35.		✓	✓
					e window or glazed door above which ens must not be more than 50 mm.	ch they are situated, unless the pergola also		✓	✓
	ving buildings of the 'overshado				nt and distance from the centre and	the base of the window and glazed door, as	✓	✓	✓
Windows	and glazed	l doors g	lazing r	equireme	nts				
Window / do	oor Orientatio	Area of glass			Shading device	Frame and glass type			
		inc. frame (m2)	Height (m)	Distance (m)					
W01	E	0.56	0	0	eave/verandah/pergola/balcony >=900 mm	standard aluminium, single clear, (or U-value: 7.63, SHGC: 0.75)			
W02	E	0.6	0	0	eave/verandah/pergola/balcony >=900 mm	standard aluminium, single clear, (or U-value: 7.63, SHGC: 0.75)			
W03	E	0.78	0	0	eave/verandah/pergola/balcony >=900 mm	standard aluminium, single clear, (or U-value: 7.63, SHGC: 0.75)			
W04	E	1.48	0	0	eave/verandah/pergola/balcony >=900 mm	standard aluminium, single clear, (or U-value: 7.63, SHGC: 0.75)			
W05	E	1.48	0	0	eave/verandah/pergola/balcony >=900 mm	standard aluminium, single clear, (or U-value: 7.63, SHGC: 0.75)			
W06	E	1.6	0	0	eave/verandah/pergola/balcony >=900 mm	standard aluminium, single clear, (or U-value: 7.63, SHGC: 0.75)			
W07	S	1.67	0	0	eave/verandah/pergola/balcony >=750 mm	standard aluminium, single clear, (or U-value: 7.63, SHGC: 0.75)			
W08	S	1.67	0	0	eave/verandah/pergola/balcony >=750 mm	standard aluminium, single clear, (or U-value: 7.63, SHGC: 0.75)			
W09	W	1.6	0	0	eave/verandah/pergola/balcony >=900 mm	standard aluminium, single clear, (or U-value: 7.63, SHGC: 0.75)			
W10	N	1.04	2.14	2.4	eave/verandah/pergola/balcony >=600 mm	standard aluminium, single clear, (or U-value: 7.63, SHGC: 0.75)			
W11	N	1.04	2.14	2.4	eave/verandah/pergola/balcony >=600 mm	standard aluminium, single clear, (or U-value: 7.63, SHGC: 0.75)			
W12	Е	2.88	26	23	projection/height above sill ratio >=0.23	standard aluminium, single clear, (or U-value: 7.63, SHGC: 0.75)			
W13	E	2.16	26	23	projection/height above sill ratio >=0.23	standard aluminium, single clear, (or U-value: 7.63, SHGC: 0.75)			
W14	S	2.16	0	0	none	standard aluminium, single clear, (or U-value: 7.63, SHGC: 0.75)			
W15	S	2.88	0	0	none	standard aluminium, single clear, (or U-value: 7.63, SHGC: 0.75)			
W16	W	2.25	0	0	eave/verandah/pergola/balcony >=900 mm	standard aluminium, single clear, (or U-value: 7.63, SHGC: 0.75)			

Glazing req	uirements						Show on DA Plans	Show on CC/CDC Plans & specs	Certifier Check
Window / doo no.	r Orientation	Area of glass inc. frame (m2)	Oversha Height (m)	Distance (m)	Shading device	Frame and glass type			
D01	E	2.57	0	0	eave/verandah/pergola/balcony >=900 mm	standard aluminium, single clear, (or U-value: 7.63, SHGC: 0.75)			
D02	E	5.8	0	0	eave/verandah/pergola/balcony >=900 mm	standard aluminium, single clear, (or U-value: 7.63, SHGC: 0.75)			
D03	N	5.8	0	0	eave/verandah/pergola/balcony >=900 mm	standard aluminium, single clear, (or U-value: 7.63, SHGC: 0.75)			
D04	E	5.8	0	0	eave/verandah/pergola/balcony >=900 mm	standard aluminium, single clear, (or U-value: 7.63, SHGC: 0.75)			
D05	E	5.8	0	0	eave/verandah/pergola/balcony >=900 mm	standard aluminium, single clear, (or U-value: 7.63, SHGC: 0.75)			
D06	S	3.26	0	0	eave/verandah/pergola/balcony >=750 mm	standard aluminium, single clear, (or U-value: 7.63, SHGC: 0.75)			
D07	W	4.8	0	0	eave/verandah/pergola/balcony >=900 mm	standard aluminium, single clear, (or U-value: 7.63, SHGC: 0.75)			
D08	W	4.8	0	0	eave/verandah/pergola/balcony >=900 mm	standard aluminium, single clear, (or U-value: 7.63, SHGC: 0.75)			
D09	W	10.08	0	0	eave/verandah/pergola/balcony >=900 mm	standard aluminium, single clear, (or U-value: 7.63, SHGC: 0.75)			
D10	W	10.08	0	0	eave/verandah/pergola/balcony >=900 mm	standard aluminium, single clear, (or U-value: 7.63, SHGC: 0.75)			
D11	E	5.8	0	0	eave/verandah/pergola/balcony >=900 mm	standard aluminium, single clear, (or U-value: 7.63, SHGC: 0.75)			
D12	W	5.8	0	0	eave/verandah/pergola/balcony >=900 mm	standard aluminium, single clear, (or U-value: 7.63, SHGC: 0.75)			
D13	W	5.8	0	0	eave/verandah/pergola/balcony >=900 mm	standard aluminium, single clear, (or U-value: 7.63, SHGC: 0.75)			
D14	W	5.8	0	0	eave/verandah/pergola/balcony >=900 mm	standard aluminium, single clear, (or U-value: 7.63, SHGC: 0.75)			



progressive plans

0400 699 850 UNIT 4/40-42 AVALON PARADE AVALON, NSW, 2107 HELLO@PROGRESSIVEPLANS.COM.AU WWW.PROGRESSIVEPLANS.COM.AU THE BUILDER SHALL CHECK AND VERIFY ALL DIMENSIONS AND VERIFY ALL ERRORS AND OMISSIONS TO THE DRAFTING OFFICE. DO NOT SCALE THE DRAWING. DRAWINGS SHALL NOT BE USED FOR CONSTRUCTION PURPOSES UNTIL ISSUED BY THE DRAFTING OFFICE FOR CONSTRUCTION AND NOTED ON THE TITLE BLOCK. THE WORK MUST BE VERIFIED BY STRUCTURAL ENGINEER BEFORE WORK COMMENCES.

REV.	NOTES.	INITIAL	DATE	NOTES
Α	DA SUBMISSION	SS	13.06.23	- DOORS
В	WINDOW & COL. CHANGE	SS	01.09.23	- DOORS - NEW W
				- NEW W
				1

- DOORS, WINDOWS & SKYLIGHTS TO MEET BASIX/NATHERS REQUIREMENTS
- DOORS, WINDOWS & SKYLIGHTS TO BE ORDERED TO MEASURE BY BUILDER/SUPPLIER

- DOORS, WINDOWS & SKYLIGHTS TO BE ORDERED TO MEASURE BY BUILDER/SUPPLIER
- NEW WINDOWS TO BEDROOMS IN ACCORDANCE WITH PART 3,9,2,6 OF NCC
- NEW WINDOWS TO ROOMS OTHER THAN BEDROOMS IN ACCORDANCE WITH PART 3,9,2,7 OF NCC

DRAWING TITLE:						
BASIX REQUIREMENTS						
SCALE:	DATE:					
	1/9/2023					
PROJECT NO:	DRAWING NO:					
	DRAWING NO.					
1010	DA27					