

SITE CRITERIA

No.19 MORESBY PLACE ALLAMBIE HEIGHTS N.S.W. 2100 19 D.P. 28394

SITE AREA EXISTING HARDSTAND EXISTING SOFT OPEN SPACE	=	625.8 313.8 312.0	sq, m. sq, m. sq, m.
PROPOSED DRIVEWAY AREA PROPOSED GARAGE FLOOR AREA UNDER GROUND FLOOR	=	40.9 52.5	są, m. są, m.
PROPOSED GROUND FLOOR AREA PROPOSED GROUND FLOOR FRONT DECK AREA PROPOSED GROUND FLOOR REAR DECK AREA PROPOSED TOTAL FIRST FLOOR AREA	=	23.6 29.2	sq, m. sq, m. sq, m. sq, m.
DWELLING ROOF AREA	=	210.9	są, m.

2 CAR PARKING SPACES PROVIDED IN GARAGE

POST SOFT OPEN SPACE AREA POST HARDSTAND OPEN SPACE AREA POST TOTAL OPEN SPACE	. = . =	54.0 434.1	są, m. są, m.	60.7%
HARDSTAND POST DEVELOPEMENTTOTAL HARDSTAND POST DEVELOPEMENT				39.3%

REQUIRED OSD AREA = SITE AREA x 40% = 250.3 sq.m. POST OSD AREA (ROOF + IMPERVIOUS PERVIOUS) = 249.7 sq, m. 39.9%





TO BE READ INCONJUCTION WITH THE BASIX CERTICATE NUMBER 1374624M ROOF AREA TO TANK TO BE USED FOR TOILET FLUSHING, COLD WATER

CLOTHS MASHING AND GARDEN TAPS SUPPLY (MINIMUM)	210.9 sq.m.
WATER STORAGE TANK CAPACITY	2,000 MIN. LITRES
NEW SHOWER HEAD MINIMUM RATING	3 STAR RATING
NEW TOILET MINIMUM RATING	4 STAR RATING
ALL NEW TAP FITTINGS MINIMUM RATING	4 STAR RATING
GLAZING TO ALUMINIUM FRAMED WINDOWS AND NOTED ARE TO BE IN ACCORDANCE WITH THE I	
ROOF COLOUR	MEDIUM - SA < 0.40 < 0.60
FLOOR ABOVE ENCLOSED SUBFLOOR	R2.0 RATING
FLOOR ABOVE ENCLOSED SUBFLOOR FLOOR ABOVE GARAGE ROOF SHEETING ON INSULATION EXTERNAL MALLS INSULATION INTERNAL MALLS INSULATION CEILING INSULATION CEILING INSULATION	R2.0 RATING N.A. R1.3 RATING R2.5 RATING N.A. RY, PONDER ROOM & BATHROOM) CECLUDES GARAGE CEILING) EGETATION THRU-OUT 10 sqm.

HUI WAILK SERVICE ID BE ELECTRIC HEAT PUMP AIR SOURCED WITH A PERFORMANCE OF FEWER THAN ISSTC'S OR BETTER.

COOLING SYSTEM TO BE IN AT LEAST I LIVING AREA \$ 1 BEDROOM TO BE A I-PHASE AIR CONDITIONING MITH AN ENERGY RATING OF EER 3,0-3,5 OR BETTER PLUS A CEILING FAN TO BEDROOM ONLY, THE COOLING SYSTEM MUST MUST PROVIDE FOR DAYNIGHT ZONING BETWEEN LIVING \$ BEDROOM AREAS.

HEATING SYSTEMM IN AT LEAST I LIVING AREA \$ 1 BEDROOM TO BE 1-PHASE AIR CONDITIONING WITH AN ENERGY RATING OF EER 3.0 - 3.5 OR BETTER.

FIXED OUTDOORS CLOTHES DRYING LINE TO BE INSTALLED

INDUCTION COOKER WITH ELECTRIC OVEN.

APPLICANT MUST ENSURE THAT THE "PRIMARY TYPE OF ARTIFICAL LIGHTING" IS FLUORESCENT OR LIGHT EMITTING DIODE (LED) LIGHTINS IN EACH OF THE FOLLOWING ROOMS, AND HAVER THE "DEPLOATED" APPEARS, THE FITTINGS FOR THOSE LIGHTS MUST ONLY BE CAPABLE OF ACCEPTING FLUORESCENT OR LIGHT EMITTING DIODE (LED) LAMPS:

- THE LAUNDRY, AT LEAST 5 OF THE BEDROOMS (DEDICATED)
- STUDY, 4 LIVING/DINING ROOMS (DEDICATED)
- . ALL BATHROOMS/TOILETS, KITCHEN, HALLWAYS (DEDICATED)

NOTES:-

- 1. ALL GLAZING TO WINDOWS & DOORS SHALL BE IN ACCORDANCE WITH

- 1. ALL GLAZING TO WINDONS & DOORS SHALL BE IN ACCORDANCE WITH THE NATHERS REPORT.
 2. EXTERNAL WALL CLADDING SHALL BE SELECTED PLANK CLADDING WITH A SPECIFIED PAINTED COLOUR FINISH.
 3. AN APPROVED RATED INSULATION TO ALL EXTERNAL TIMBER FRAMED WALLS IN ACCORDANCE WITH THE BASIX REPORT.
 4. AN APPROVED RATED INSULATION MATERIAL TO BE PLACED IN THE CEILING SPACE WITHIN THE PERIMETER OF ALL EXTERNAL WALLS IN ACCORDANCE WITH THE BASIX REPORT WITH THE BASIX REPORT
- 5. AN APPROVED RATED CONDENSATION BLANKET PLACED UNDER ROOF SHEETING THRU-OUT IN ACCORDANCE WITH THE BASIX REPORT. 6. ROOF FINISHES TO BE IN ACCORDANCE WITH THE BASIX REPORT.
- 7. EXTERNAL WALL FINISHES TO BE IN ACCORDANCE WITH THE BASIX REPORT.
- 8. ALL WINDOWS AND DOORS TO HAVE WEATHER STRIPPING, 9. ALL WINDOWS & DOORS AS NOTED ON PLAN WITH SPECIFIED COLOUR FINISH.
- 10. ALL PAINTING TO OWNERS REQUIREMENTS.
- 11. ALL POWER OUTLETS & SWITCHES TO OWNERS REQUIREMENTS.
 12. ALL GLAZING TO CODE ASI288

- 13. ALL PEST TREATMENT TO CODE AS3660.1-2000 14. SMOKE ALARM DENOTED SA ON PLAN TO BCA 3.7.2 \$ AS3786 15. ALL WATERPROOFING TO WET AREAS TO CODE AS3740

- 16. ALL TIMBER FRAMING TO CODE ASI684
 17. ALL WORK CARRIED OUT TO BE IN ACCORDANCE WITH THE BCA.

GENERAL NOTES AND BCA / NCC COMPLIANCE

EARTHWORKS METHOD OF EXCAVATION AND FILL TO COMPLY WITH PART 3.1.1, B.C.A. TERMITE RISK MANAGEMENT TO COMLPY WITH PART 3.1.3 OF THE B.C.A. AND AS3660-I FOOTINGS AND SLABS TO COMPLT WITH PART 3.2 OF THE B.C.A. , AS2870

AND ENGINEERS DETAILS MASONARY CONSTRUCTION TO COMPLY WITH PART 3.3 OF THE B.C.A. AND AS3700

- HIMBER FRAMING TO COMPLY WITH PART 3.4 OF THE B.C.A. AND ASI684
 GLAZING TO COMPLY WITH PART 3.6 OF THE B.C.A. AND ASI288
 SMOKE ALARMS TO COMPLY WITH PART 3.7.2 OF THE B.C.A. AND AS3786
 STAIR CONSTRUCTION TO COMPLY WITH PART 3.9.1 OF THE B.C.A.
- BALISTRADES AND OTHER BARRIERS TO COMPLY WITH PART 3.9.2 OF THE B.C.A.

- BALISTRADES AND OTHER BARRIERS TO COMPLY WITH PART 3.9.2 OF THE B.C.A.
 NATURAL LIGHT TO COMPLY WITH PART 3.8.4 OF THE B.C.A.
 VENTILATION TO COMPLY WITH PART 3.8.5 OF THE B.C.A.
 ALL DAMP AND MEATHERPROOFING TO COMPLY WITH PART 3.8 OF THE B.C.A.
 ROOFING TO COMPLY WITH PART 3.5.1 OF THE B.C.A. AND AS/NZI562
 FLOOR SURFACES OF WATER CLOSETS, SHOWER COMPARTMENTS AND THE A LIKE
 TO BE OF MATERIALS IMPERVIOUS TO MOISTURE AND WALLS FINISHED WITH AN APPROVED IMPERVIOUS FINISH TO COMPLY WITH THE REQUIREMENTS OF
- PART 3.8 OF THE B.C.A. AND AS3740 CLOTHS WASHING, DRYING AND COOKING FACILITIES TO BE PROVIDED TO COMPLY WITH PART 3.8.3 OF THE B.C.A.



P.O. BOX 5240 CHITTAWAY BAY N.S.W. 2261 Tel: (02) 4352 1189 Fax: (02) 4352 1198 Builders Lic. 158741C ABN 65 687 862 151

© This drawing and design remains the property of CLASSIC COUNTRY COTTAGES and may not be copied in whole or in part without prior approval of CLASSIC COUNTRY COTTAGES

PROJECT

PROPOSED NEW DWELLING 19 MORESBY PLACE **ALLAMBIE HEIGHTS**

FOR

Mr. R. & Mrs. L. MERRY


DATE DEC. 2022 SCALE 1:200


JOB No


DWG No





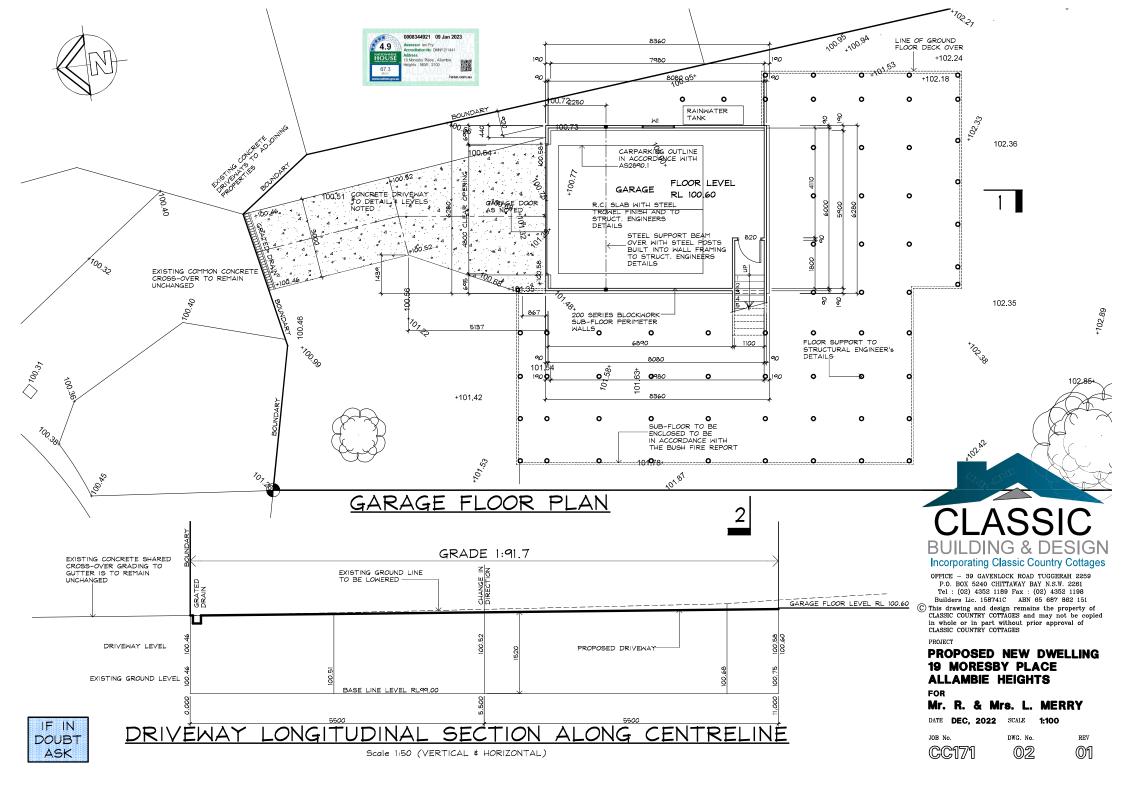

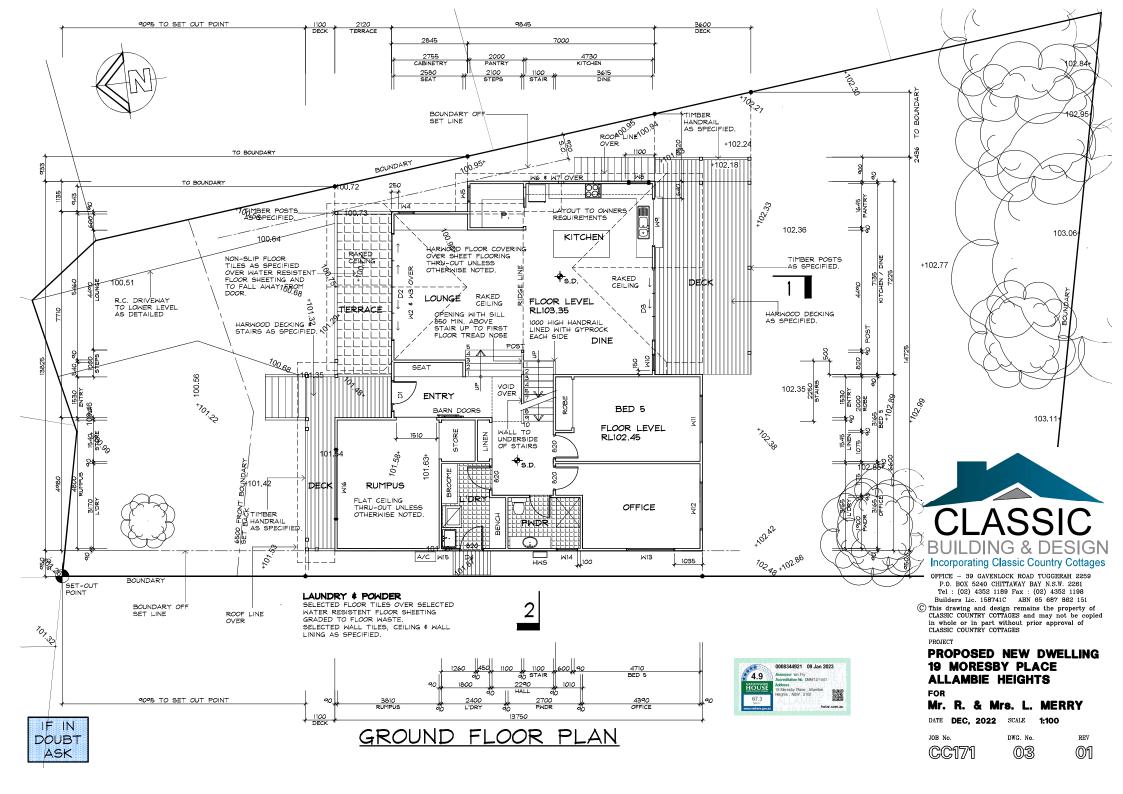

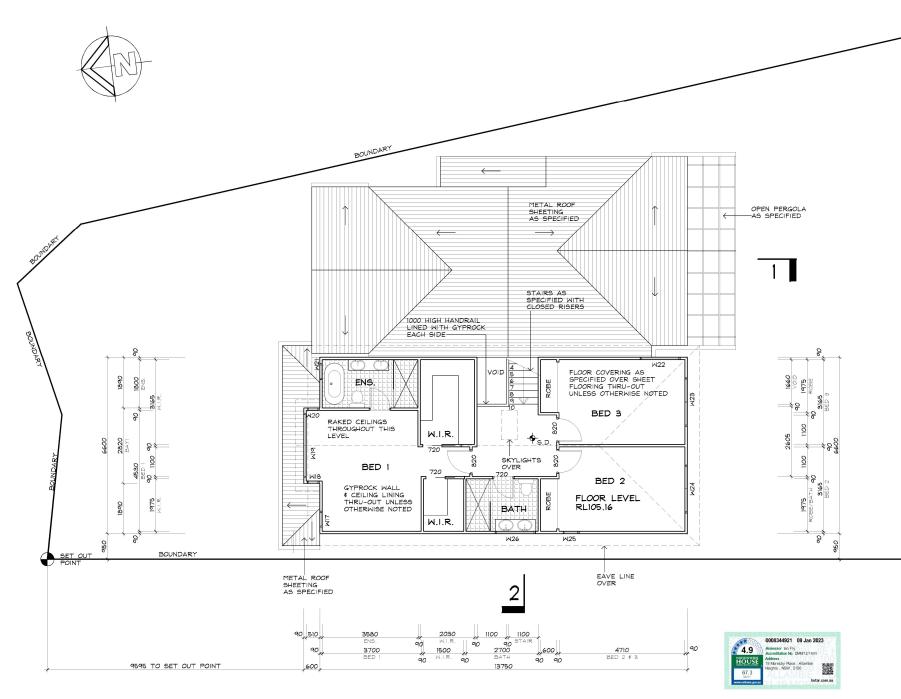



Incorporating Classic Country Cottages OFFICE - 39 GAVENLOCK ROAD TUGGERAH 2259 P.O. BOX 5240 CHITTAWAY BAY N.S.W. 2261

Tel: (02) 4352 1189 Fax: (02) 4352 1198 Builders Lic. 158741C ABN 65 687 862 151 © This drawing and design remains the property of CLASSIC COUNTRY COTTAGES and may not be copied

in whole or in part without prior approval of CLASSIC COUNTRY COTTAGES

PROJECT

PROPOSED NEW DWELLING 19 MORESBY PLACE **ALLAMBIE HEIGHTS**


FOR


Mr. R. & Mrs. L. MERRY

DATE DEC, 2022 SCALE 1:100

JOB No.

DWG. No. 04

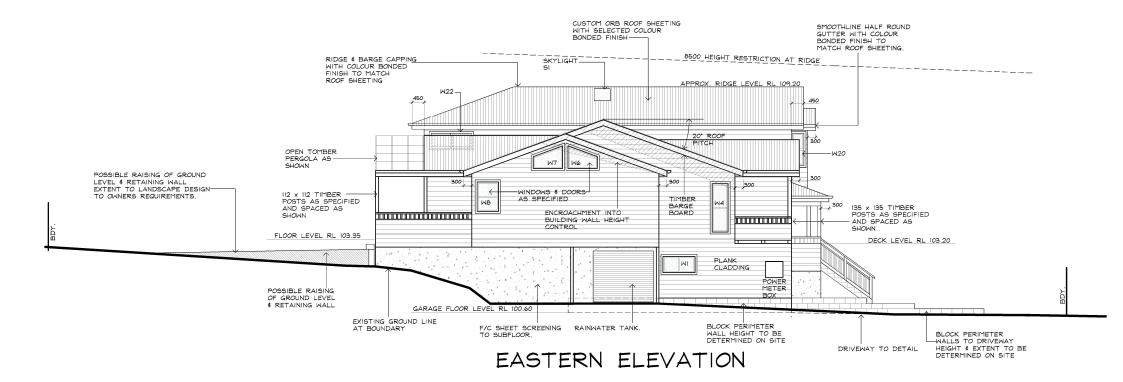

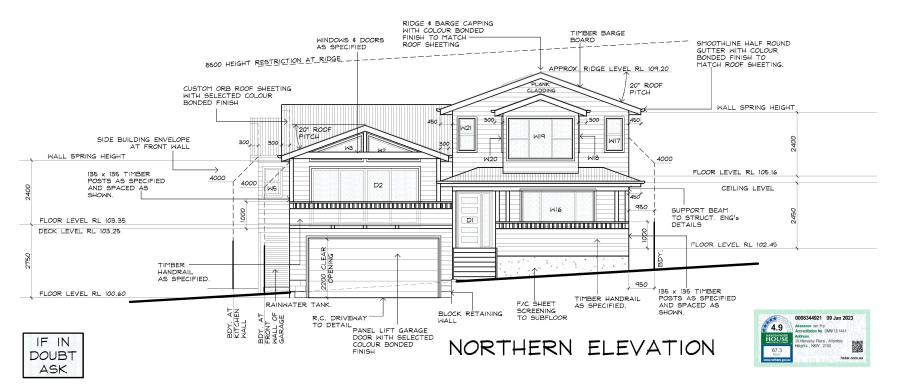



OFFICE - 39 GAVENLOCK ROAD TUGGERAH 2259 P.O. BOX 5240 CHITTAWAY BAY N.S.W. 2261 Tel: (02) 4352 1189 Fax: (02) 4352 1198 Builders Lic. 158741C ABN 65 687 862 151

(C) This drawing and design remains the property of CLASSIC COUNTRY COTTAGES and may not be copied in whole or in part without prior approval of CLASSIC COUNTRY COTTAGES

PROJECT


PROPOSED NEW DWELLING 19 MORESBY PLACE **ALLAMBIE HEIGHTS**


FOR

Mr. R. & Mrs. L. MERRY

DATE DEC, 2022 SCALE

JOB No.

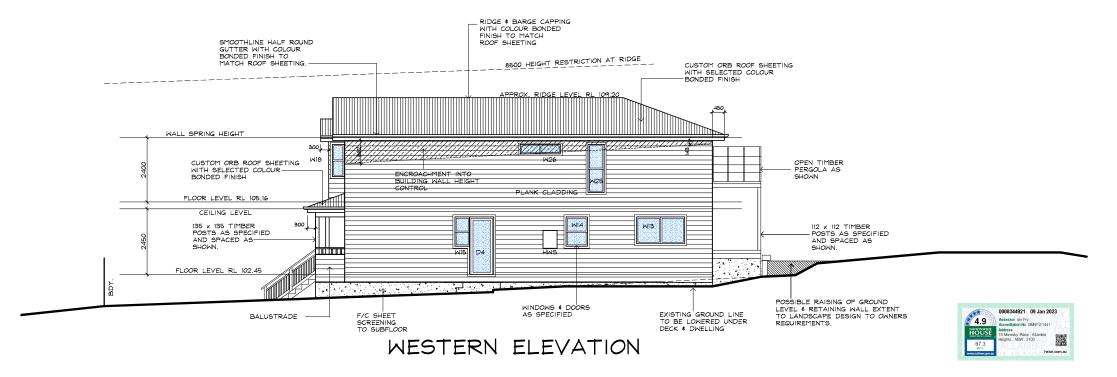

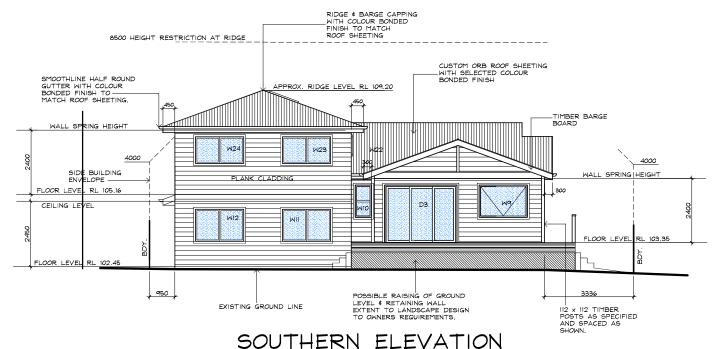





OFFICE - 39 GAVENLOCK ROAD TUGGERAH 2259 P.O. BOX 5240 CHITTAWAY BAY N.S.W. 2261 Tel : (02) 4352 1189 Fax : (02) 4352 1198 Builders Lic. 158741C ABN 65 687 862 151 © This drawing and design remains the property of CLASSIC COUNTRY COTTAGES and may not be copied in whole or in part without prior approval of CLASSIC COUNTRY COTTAGES

PROJECT

PROPOSED NEW DWELLING 19 MORESBY PLACE **ALLAMBIE HEIGHTS**


FOR


Mr. R. & Mrs. L. MERRY

JOB No.

DATE DEC, 2022 SCALE 1:100


DWG. No. **(0)**(6)

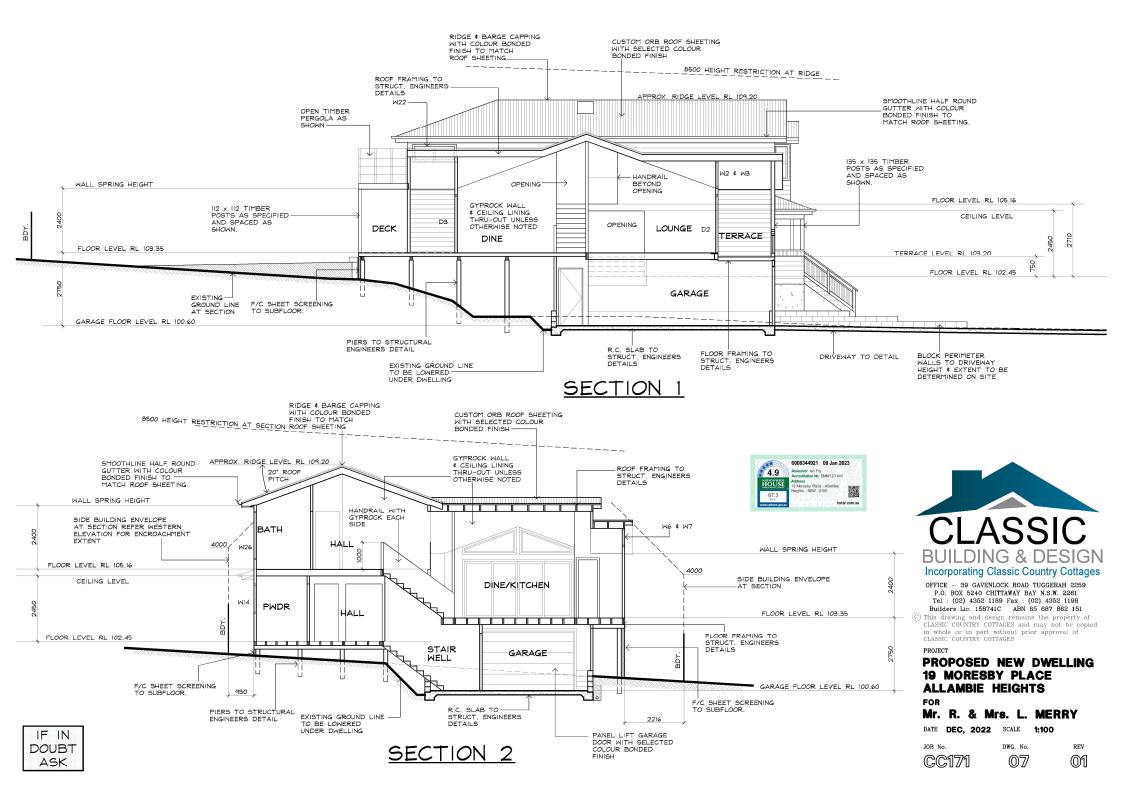

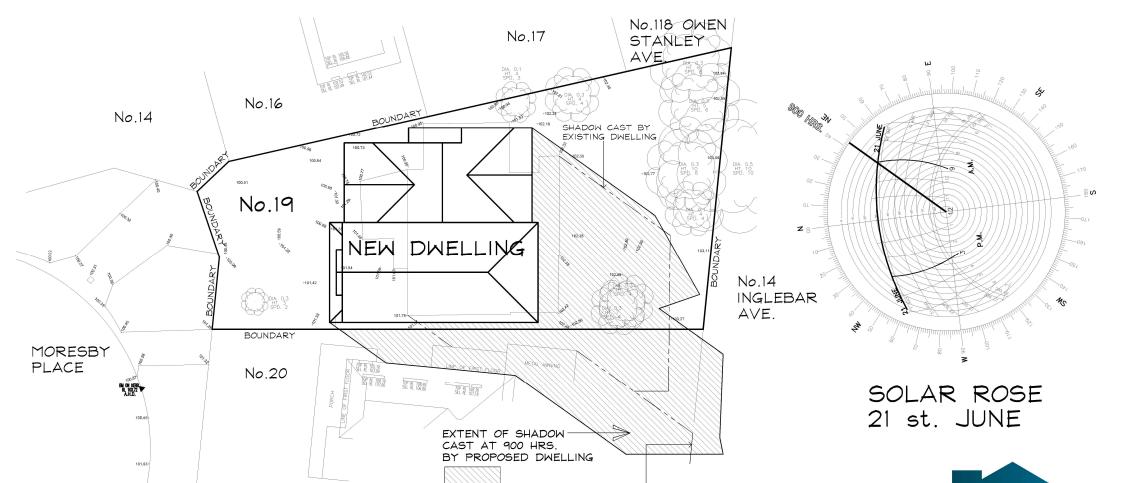

SHADOW CAST BY EXISTING No.20 DWELLING

0900 HRS. SOLAR ANALYSIS PLAN

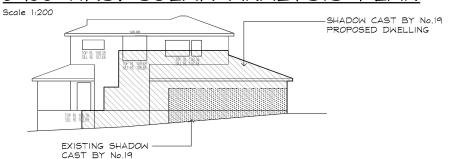

NORTH-EAST ELEVATION No.20 Scale 1:200







P.O. BOX 5240 CHITTAWAY BAY N.S.W. 2261 Tel: (02) 4352 1189 Fax: (02) 4352 1198 Builders Lic. 158741C ABN 65 687 862 151

© This drawing and design remains the property of CLASSIC COUNTRY COTTAGES and may not be copied in whole or in part without prior approval of CLASSIC COUNTRY COTTAGES

PROPOSED NEW DWELLING 19 MORESBY PLACE **ALLAMBIE HEIGHTS**

FOR

Mr. R. & Mrs. L. MERRY


DATE DEC, 2022 SCALE 1:200

JOB No.

DWG. No.

REV

01

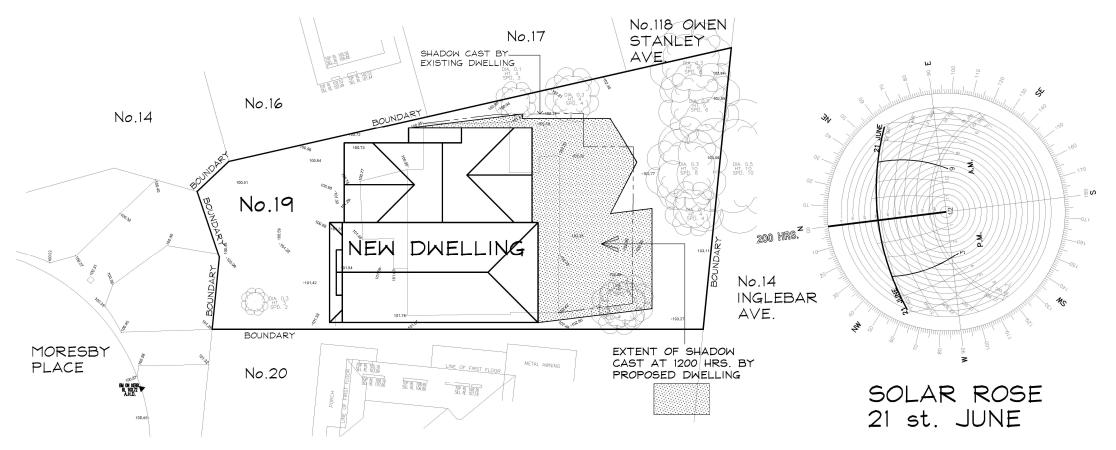

HRS. SOLAR ANALYSIS PLAN

Scale 1:200

NO ADJOINING PROPERTY RESIDENCE ARE AFFECTED







OFFICE - 39 GAVENLOCK ROAD TUGGERAH 2259 P.O. BOX 5240 CHITTAWAY BAY N.S.W. 2261 Tel: (02) 4352 1189 Fax: (02) 4352 1198 Builders Lic. 158741C ABN 65 687 862 151

© This drawing and design remains the property of CLASSIC COUNTRY COTTAGES and may not be copied in whole or in part without prior approval of CLASSIC COUNTRY COTTAGES

PROPOSED NEW DWELLING 19 MORESBY PLACE **ALLAMBIE HEIGHTS**

FOR


Mr. R. & Mrs. L. MERRY

DATE DEC, 2022 SCALE 1:200

JOB No.

DWG. No.



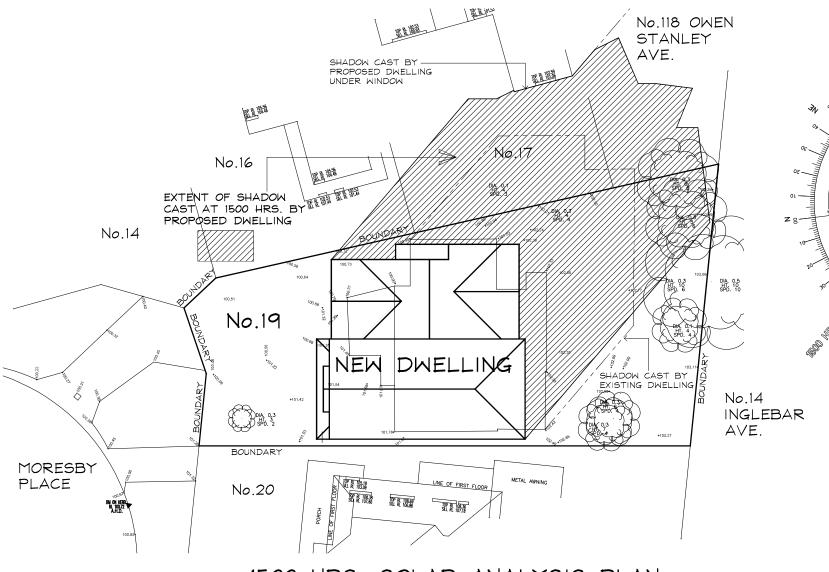

1500 HRS. SOLAR ANALYSIS PLAN

NO ADJOINING PROPERTY RESIDENCE ARE AFFECTED

Scale 1:200









Incorporating Classic Country Cottages

OFFICE - 39 GAVENLOCK ROAD TUGGERAH 2259 P.O. BOX 5240 CHITTAWAY BAY N.S.W. 2261 Tel: (02) 4352 1189 Fax: (02) 4352 1198 Builders Lic. 158741C ABN 65 687 862 151 © This drawing and design remains the property of CLASSIC COUNTRY COTTAGES and may not be copied in whole or in part without prior approval of CLASSIC COUNTRY COTTAGES

PROPOSED NEW DWELLING 19 MORESBY PLACE **ALLAMBIE HEIGHTS**

FOR


Mr. R. & Mrs. L. MERRY


DATE DEC, 2022 SCALE 1:200 JOB No.


CC171

DWG. No. 100



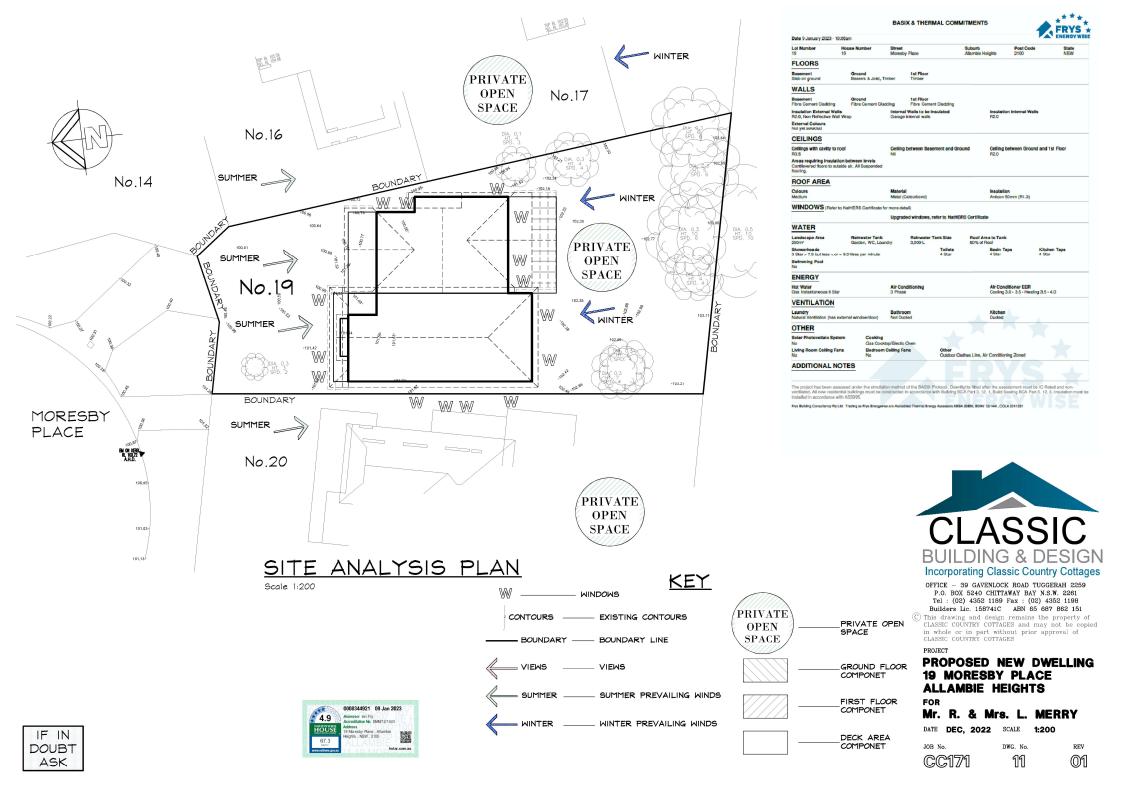

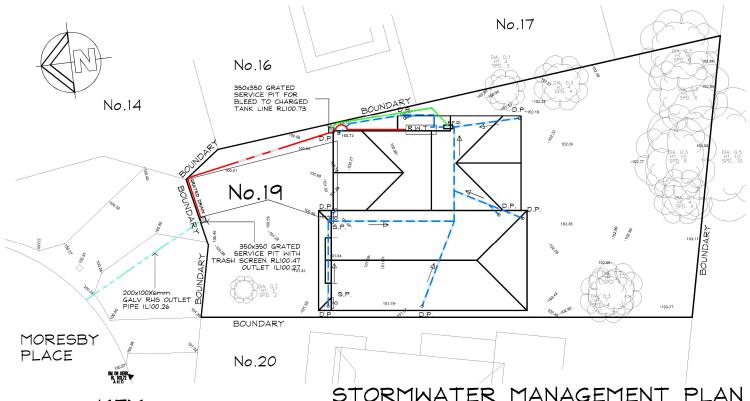

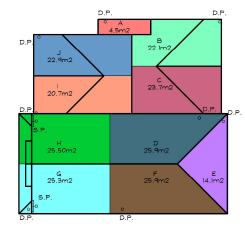

STORMWATER

AVERAGE RECURRENCE

INTERVAL 1 IN 20 YEAR

200mm/hr

4.9

KEY

DOWN PIPE (SPREADER)

--- DOWN PIPE 90mm

FIRST FLUSH DIVERTER

100mm DIA STORM WATER PIPE TO STORAGE TANK

90mm DIA STORM WATER DISCARD PIPE TO SERVICE PIT STORMWATER PIPE

60mm DIA BLEED PIPE

EXISTING STORMWATER PIPE

GALVANISED STEEL RHS PIPE TO KERB

DRAINAGE GRATE

GRATED PIT 150mm

RW/T ---- RAIN WATERTANK

IF IN DOUBT ASK

STORMWATER MANAGEMENT PLAN

HYDRAULIC NOTES

- THE CONTRACTOR SHALL GIVE NOTICE TO COUNCIL'S ENGINEER IN ACCORDANCE WITH COUNCIL'S SPECIFICATIONS WHEN INSPECTIONS ARE REQUIRED
- 2. WHERE DEPTH OF STORMWATER DRAINAGE PITS EXCEEDS 1.2m, HOT DIPPED
- EQUIVALENT UNLESS NOTED OTHERWISE.
- STORMWATER CONNECTION TO COUNCIL'S DRAINAGE SYSTEM SHALL BE DONE UNDER THE SUPERVISION OF COUNCIL'S ENGINEER.
- MINIMUM PIPE COVER TO BE 700mm UNLESS NOTED OTHERWISE.
- IN SANDY SOILS THE EXCAVATED SOIL MAY BE REUSED.
- FINISHED SURFACE LEVELS AND COVERED WITH A MINIMUM OF 500mm GRAVEL.
- 12. PIPE BEDDING SUPPORT SHALL BE H1 UNLESS NOTED OTHERWISE.

 13. STORMWATER GRATES AND MANHOLE CLASSES SHALL BE IN ACCORDANCE 14 WITH AS3996
- GRADES SHALL BE 1% UNO.

 16. PIPE GRADES INDICATED ON DRAWINGS ARE MINIMUM GRADES. IF MINIMUM.

GRADES CANNOT BE ACHIEVED CONTACT

17. THE DESIGN ENGINEER PRIOR TO PLACEMENT

RAINWATER TANK NOTES

- 1. ALL WORK TO BE CARRIED OUT IN ACCORDANCE WITH AS. 3500.3.2. 2.THIS PLAN TO BE READ IN CONJUNCTION WITH THE BASIX CERTIFICATE NUMBER LISTED IN BASIX/NATHERS NOTES.
- 3.A TOTAL RAINWATER TANK STORAGE CAPACITY OF 2,000 LITRES IS PROVIDED VIA ONE SLIMLINE TANK CONSISTING OF AN APPROX SIZE 685mm WIDE X 2,060mm L X 1,905mm H WATER TANK CONNECTED TO THE FOLLOWING:
- ALL TOILETS IN THE DEVELOPEMNT.
- THE COLD WATER TAP THAT SUPPLIES EACH CLOTHES WASHER IN THE DEVELOPMENT. - AT LEAST ONE OUTDOOR TAP IN THE DEVELOPMENT (NOTED: NSW HEALTH DOES NOT
- RECOMMEND THAT RAINWATER BE USED FOR HUMAN CONSUMPTION.)
 4. ALL PIPE AND DOWN PIPES TO BE PRESUSSURE GRADE PIPES TO 500mm ABOVE MAXIMUM WATER LEVEL OF RAIN WATERTANKS.

GUTTER NOTES

- 1. ALL GUTTERS TO HAVE A MINIMUM CROSS SECTION AS OUTLINED IN TABLE 1.
 2. ALL GUTTER GRADIENTS TO BE NOT LESS THAN 1:500
- TOP OF FASCIA TO BE A MINIMUM OF 15mm ABOVE GUTTER SLOTTED OVERFLOW 4. DOWNPIPE SIZES TO BE IN ACCORDANCE WITH TABLE 1.

- GALVANISED STEEL STEP IRONS SHALL BE PROVIDED.
 ALL PITS SHALL BE PRECAST CONCRETE WITH GRATE OR APPROVED
- ALL STORMWATER PIPES BELOW AND INCLUDING 2250 SHALL BE UPVC OR APPROVED EQUIV. UNLESS NOTED OTHERWISE.
- ALL PIPES ABOVE 2250 SHALL BE REINFORCED CONCRETE WITH RUBBER RING JOINTS UNLESS NOTED OTHERWISE.
- ALL PIPES TO BE LAID AND COVERED WITH SAND TO A MINIMUM DEPTH EQUAL TO THE PIPE DIAMETER, BUT NOT LESS THAN 300mm.
- ALL 100Ø SUBSOIL DRAINAGE TO BE PLACED A MINIMUM OF 650mm BELOW
- 15. WHERE PIPE GRADES ARE NOT SHOWN ON DRAWINGS, MINIMUM PIPE

24.4

AREA INC

SLOPE

4.8

23.5

25.2

27.5

15.0

27.5

26.9

27.1

22.0

PLAN VIEW

AREA m2

4.5

22.1

23.7

25.9

14.1

25.9

25.3

25.5

20.7

22.9

В

D

F

G

SITE CALCULATIONS TOTAL SITE AREA: 625.8 m2 ROOF CATCHMENT AREA 210.9 m2 OTHER PAVED AREAS (Refer to Site Plan) 34.8 m2 TOTAL IMPERVIOUS AREA 245.7 m2 (39.3%) RAIN WATER TANK STORAGE (MINIMUM) 2,000 LITRES ON-SITE DETENTION IS NOT REQUIRED AS 249,7 m2 IS < 250,3 m2 OR 40% OF SITE AREA

CATCHMENT AREAS FOR INDIVIDUAL DOWNPIPES AND GUTTERS

GUTTER mm2

(CROSS

SECTION)

7700

7700

DOWNPIPE

90mm

CI	ASSIC	
	DING & DESIGN	

OFFICE - 39 GAVENLOCK ROAD TUGGERAH 2259 P.O. BOX 5240 CHITTAWAY BAY N.S.W. 2261 Tel: (02) 4352 1189 Fax: (02) 4352 1198 Builders Lic. 158741C ABN 65 687 862 151


C This drawing and design remains the property of CLASSIC COUNTRY COTTAGES and may not be copied in whole or in part without prior approval of CLASSIC COUNTRY COTTAGES


PROPOSED NEW DWELLING 19 MORESBY PLACE ALLAMBIE HEIGHTS

FOR

Mr. R. & Mrs. L. MERRY

DATE DEC, 2022 SCALE 1:200

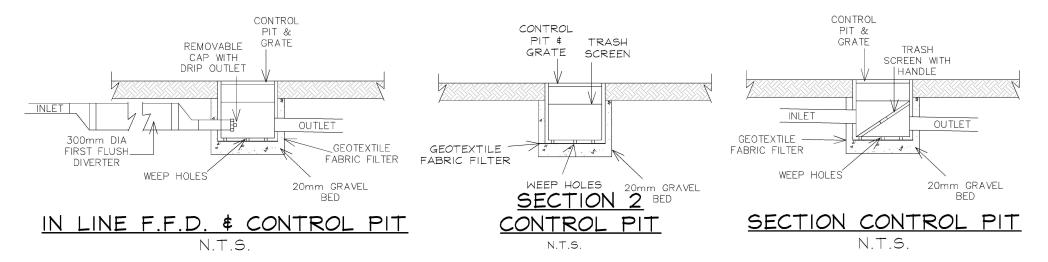

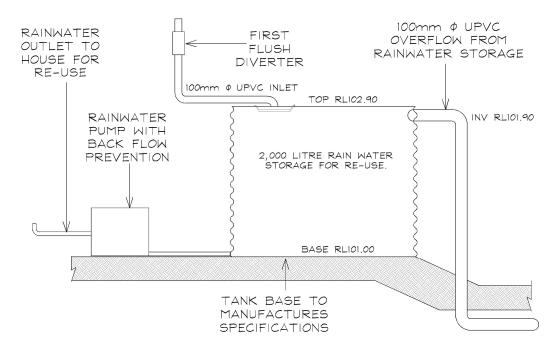

IF IN DOUBT ASK

SECTION 1 RAINWATER TANK

N.T.S

HYDRAULIC NOTES

- THE CONTRACTOR SHALL GIVE NOTICE TO COUNCIL'S ENGINEER IN ACCORDANCE WITH COUNCIL'S SPECIFICATIONS WHEN INSPECTIONS ARE
- WHERE DEPTH OF STORMWATER DRAINAGE PITS EXCEEDS 1.2m, HOT DIPPED GALVANISED STEEL STEP IRONS SHALL BE PROVIDED.
- ALL PITS SHALL BE PRECAST CONCRETE WITH GRATE OR APPROVED
- EQUIVALENT UNLESS NOTED OTHERWISE.
- STORMWATER CONNECTION TO COUNCIL'S DRAINAGE SYSTEM SHALL BE DONE UNDER THE SUPERVISION OF COUNCIL'S ENGINEER.
- ALL STORMWATER PIPES BELOW AND INCLUDING 225¢ SHALL BE UPVC OR APPROVED EQUIV. UNLESS NOTED OTHERWISE.
- ALL PIPES ABOVE 225¢ SHALL BE REINFORCED CONCRETE WITH RUBBER RING JOINTS UNLESS NOTED OTHERWISE.
- MINIMUM PIPE COVER TO BE 700mm UNLESS NOTED OTHERWISE.
- ALL PIPES TO BE LAID AND COVERED WITH SAND TO A MINIMUM DEPTH EQUAL TO THE PIPE DIAMETER, BUT NOT LESS THAN 300mm.
- IN SANDY SOILS THE EXCAVATED SOIL MAY BE REUSED.
- 10. ALL 100Ø SUBSOIL DRAINAGE TO BE PLACED A MINIMUM OF 650mm BELOW FINISHED SURFACE LEVELS AND COVERED WITH A
- MINIMUM OF 500mm GRAVEL.
- 12. PIPE BEDDING SUPPORT SHALL BE H1 UNLESS NOTED OTHERWISE.
- 13. STORMWATER GRATES AND MANHOLE CLASSES SHALL BE IN ACCORDANCE
- 14. WITH AS3996
- 15. WHERE PIPE GRADES ARE NOT SHOWN ON DRAWINGS, MINIMUM PIPE GRADES SHALL BE 1% UNO.
- 16. PIPE GRADES INDICATED ON DRAWINGS ARE MINIMUM GRADES. IF MINIMUM. GRADES CANNOT BE ACHIEVED CONTACT
- 17. THE DESIGN ENGINEER PRIOR TO PLACEMENT.

RAINWATER TANK NOTES

- 1. ALL WORK TO BE CARRIED OUT IN ACCORDANCE WITH AS. 3500.3.2. 2. THIS PLAN TO BE READ IN CONJUNCTION WITH THE BASIX CERTIFICATE NUMBER LISTED IN BASIX/NATHERS NOTES.
- 3.A TOTAL RAINWATER TANK STORAGE CAPACITY OF 2.000 LITRES IS PROVIDED VIA ONE SLIMLINE TANK CONSISTING OF AN APPROX SIZE 685mm WIDE
- X 2,060mm L X 1,905mm H WATER TANK CONNECTED TO THE FOLLOWING:
- ALL TOILETS IN THE DEVELOPEMNT.
- THE COLD WATER TAP THAT SUPPLIES EACH CLOTHES WASHER IN THE DEVELOPMENT. - AT LEAST ONE OUTDOOR TAP IN THE DEVELOPMENT (NOTED: NSW HEALTH DOES NOT RECOMMEND THAT RAINWATER BE USED FOR HUMAN CONSUMPTION.)
- 4. ALL PIPE AND DOWN PIPES TO BE PRESUSSURE GRADE PIPES TO 500mm ABOVE MAXIMUM WATER LEVEL OF RAIN WATERTANKS.

GUTTER NOTES

- 1. ALL GUTTERS TO HAVE A MINIMUM CROSS SECTION AS OUTLINED IN TABLE 1.
- 2. ALL GUTTER GRADIENTS TO BE NOT LESS THAN 1:500
- 3. TOP OF FASCIA TO BE A MINIMUM OF 15mm ABOVE GUTTER SLOTTED OVERFLOW
- 4. DOWNPIPE SIZES TO BE IN ACCORDANCE WITH TABLE 1.





OFFICE - 39 GAVENLOCK ROAD TUGGERAH 2259 P.O. BOX 5240 CHITTAWAY BAY N.S.W. 2261 Tel: (02) 4352 1189 Fax: (02) 4352 1198 Builders Lic. 158741C ABN 65 687 862 151

C This drawing and design remains the property of CLASSIC COUNTRY COTTAGES and may not be copied in whole or in part without prior approval of CLASSIC COUNTRY COTTAGES


PROJECT

PROPOSED NEW DWELLING 19 MORESBY PLACE ALLAMBIE HEIGHTS

FOR

Mr. R. & Mrs. L. MERRY

DATE DEC, 2022 SCALE N.T.S.

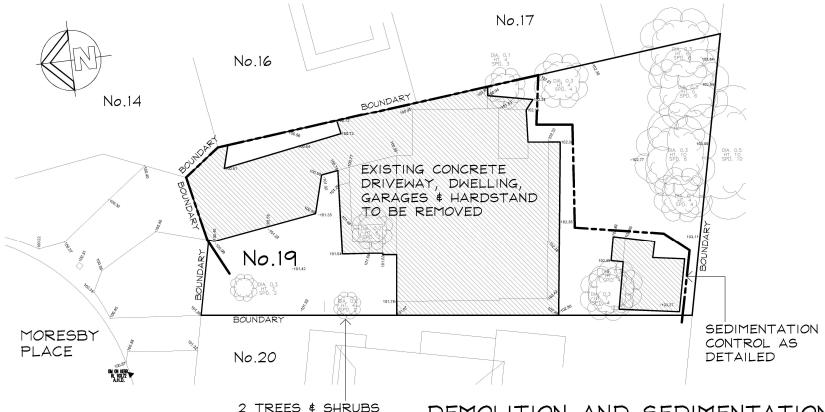

DEMOLITION AND SEDIMENTATION FENCE PLAN

Scale 1:200

GEOTEXTILE FILTER FABRIC 3000 MAX. WIRE OR STEEL MESH-MAX. STAR PICKETS DRIVEN -0.6m INTO GROUND DISTURBED SOME INTO ROCK AREA UNDISTURBED AREA DETAIL OF OVERLAP IF IN

DOUBT ASK

TO BE REMOVED

SEDIMENT CONTROL:

- 1. INSTALL SEDIMENT CONTROL STRUCTURES IN LOCATIONS INDICATED ON DRAWINGS AND AS OTHERWISE REQUIRED TO CONTROL SEDIMENT DURING ALL EXCAVATIONS AND WHILST AREAS OF THE SITE ARE EXPOSED TO EROSION.
- 2. CONTROL STRUCTURES TO BE AS DETAILED OR AS OTHERWISE REQUIRED
- 3. REVIEW CONTROL MEASURES AND MAINTAIN STRUCTURES DURING CONSTRUCTION.
- 4. IF ADDITIONAL MEASURES ARE REQUIRED FOR EROSION CONTROL OR BY COUNCIL REQUIREMENTS REFER TO "URBAN EROSION AND SEDIMENT CONTROL" GUIDELINES PREPARED BY THE DEPARTMENT OF CONSERVATION AND LAND MANAGEMENT.





OFFICE - 39 GAVENLOCK ROAD TUGGERAH 2259

P.O. BOX 5240 CHITTAWAY BAY N.S.W. 2261 Tel: (02) 4352 1189 Fax: (02) 4352 1198 Builders Lic. 158741C ABN 65 687 862 151

C This drawing and design remains the property of CLASSIC COUNTRY COTTAGES and may not be copied in whole or in part without prior approval of CLASSIC COUNTRY COTTAGES

PROPOSED NEW DWELLING 19 MORESBY PLACE **ALLAMBIE HEIGHTS**

FOR

Mr. R. & Mrs. L. MERRY

DATE DEC, 2022 SCALE 1:200

DWG. No.

SEDIMENTATION CONTROL FENCE DETAIL

SCALE = N.T.S.