DRAWING LIST

DA000 A

DA001 A

DA321 A

DA322 A

NAME NO. REV


TITLE PAGE

LANDSCAPING

DA002 A **EXCAVATION** WASTE MANAGEMENT PLAN DA003 A DA004 A SHADOW ANALYSIS PLANS DA005 A SHADOW ANALYSIS - ELEVATIONS 01 DA006 A SHADOW ANALYSIS - ELEVATIONS 02 DA101 A SITE PLAN / ROOF PLAN **DEMOLITION GARAGE & ROOF** DA110 A DA120 A DRIVEWAY DA121 A MATERIAL BOARD DA122 A 3D VIEWS DA200 A LEVEL 4 CARPORT AND ROOF PLAN DA201 A LEVEL 3 BEDROOMS PLAN DA202 A LEVEL 2 LIVING PLAN LEVEL 1 RUMPUS PLAN DA203 A **BOAT SHED PLAN** DA204 A DA301 A EAST ELEVATION DA302 A NORTH ELEVATION DA303 A WEST ELEVATION DA304 A SOUTH ELEVATION

SECTION - AA - PROPOSED

SECTION - BB - PROPOSED

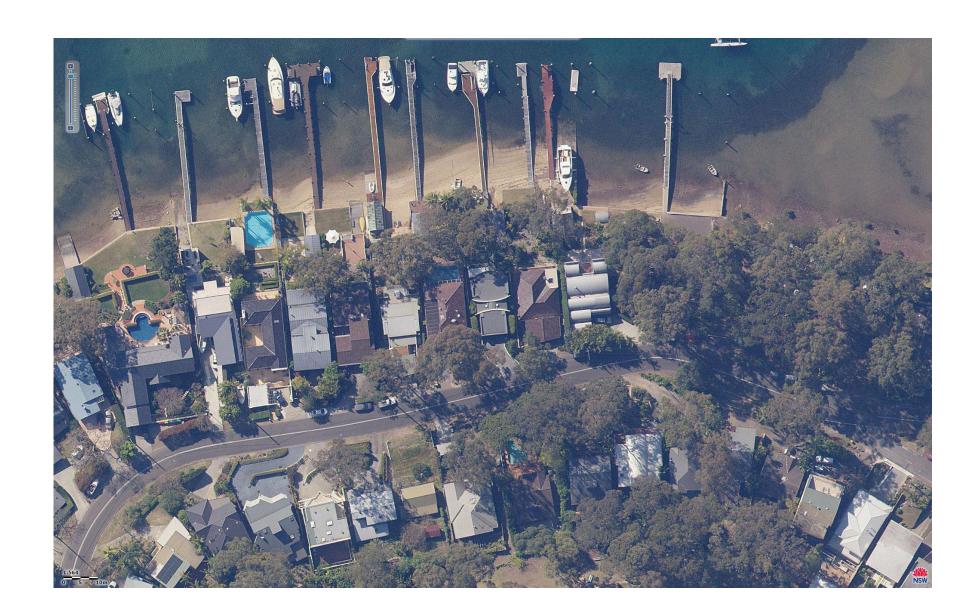


106 PRINCE ALFRED PARADE, NEWPORT

DEVELOPMENT APPLICATION

DEVELOPMENT APPLICATION TITLE PAGE

106 Prince Alfred Parade Newport - Lot 25 DP13457

TITLE PAGE

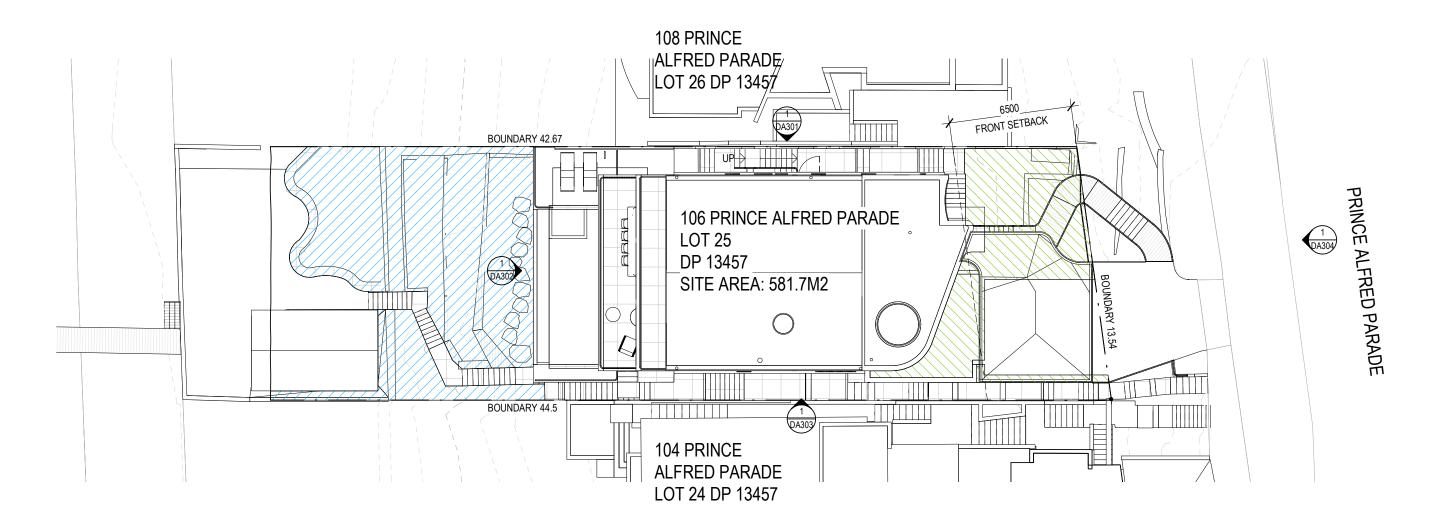

PITTWATER DCP

The following soil depths are required in order to be counted as landscaping:

300mm for lawn 600mm for shrubs 1metre for trees

The front of buildings (between the front boundary and any built structures) shall be landscaped to screen those buildings from the street as follows: 60% for a single dwelling house, secondary dwelling, rural workers' dwellings, or dual occupancy, and

DEEP SOIL KEY




LANDSCAPING

LANDSCAPE FRONT SETBACK

LANDSCAPE REAR SETBACK

LANDSCAPING CALCULATION

DEEP SOIL	AREA(sqm)	PERCENTAGE
SITE AREA	581.7m ²	
PROPOSED FRONT EXISTING FRONT DCP COMPLIANCE	60.1m ² of total 109.8m ² 38m ² of total 109.8m ² 65.88m ²	55% 34.6% 60%
PROPOSED REAR EXISTING REAR	133.5m ² of total 186.7m ² 141.5m ² of total 186.7m ²	71.5% 76%
PROPOSED TOTAL DEEP SOIL AREA	193.6m ² of a total 581.7m ²	33%
EXISTING TOTAL DEEP SOIL AREA	179.5m ² of a total 581.7m ²	31%

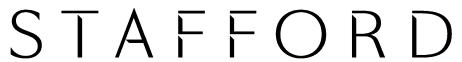


DEVELOPMENT APPLICATION LANDSCAPING



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PROJECT NO. STAGE DWG NO. REV 106 Prince Alfred Parade Newport - Lot DA001 196 25 DP13457 1:200@A3



EXCAVATION KEY

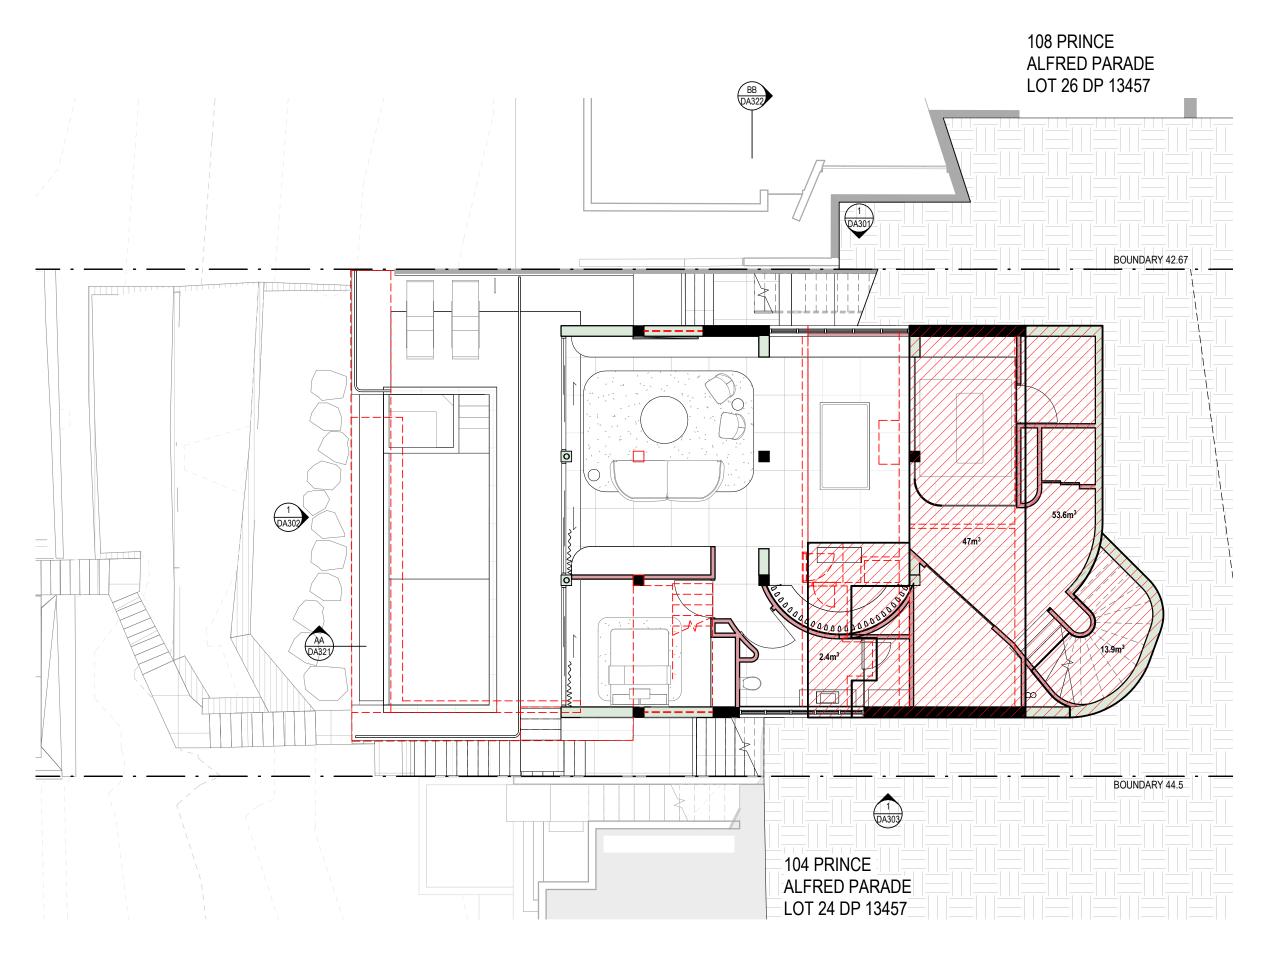

EXCAVATION CALCULATION

EXCAVATION

PROPOSED EXCAVATION

BASEMENT

116.9m³

BACK FILL TOTAL

Nil

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DEVELOPMENT APPLICATION EXCAVATION



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PROJECT
106 Prince Alfred Parade Newport - Lot
25 DP13457


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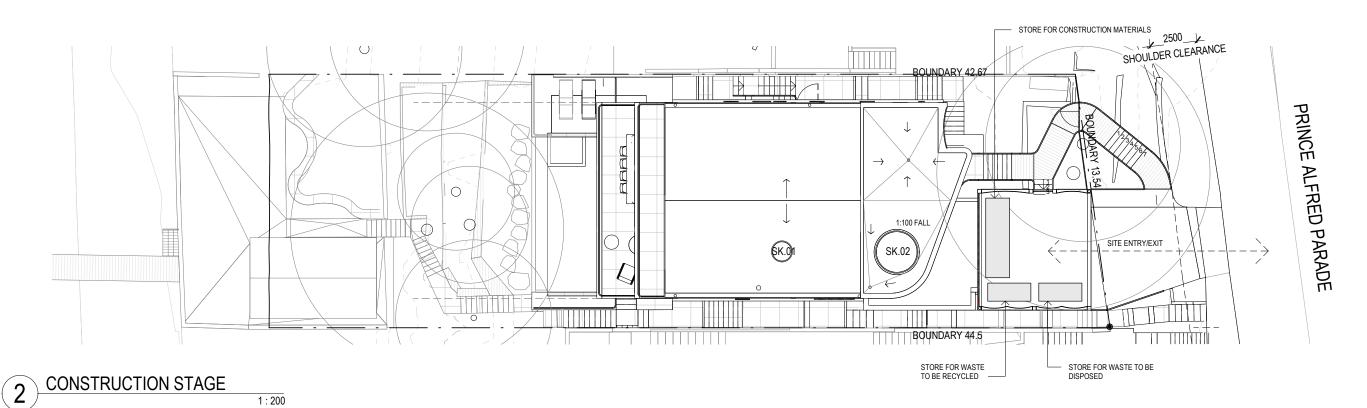
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Drawn: ES Scale:

EXCAVATION

Checked: BS Date:



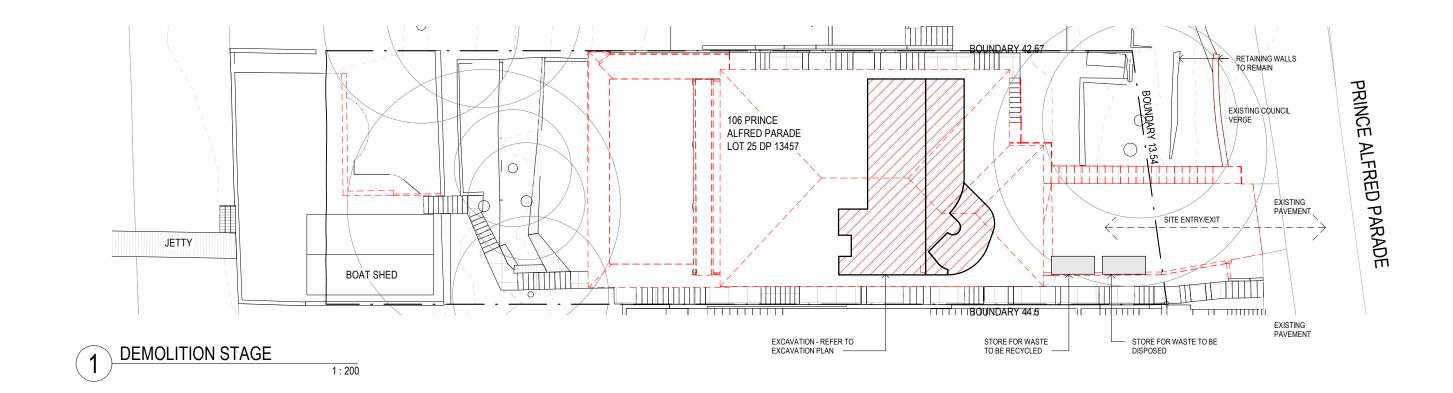

STAFFORD

DEVELOPMENT APPLICATIONWASTE MANAGEMENT PLAN




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 PROJECT
 STAGE DWG NO. REV

 106 Prince Alfred Parade Newport - Lot
 196 DA003 A

 25 DP13457
 Drawn: Drawn



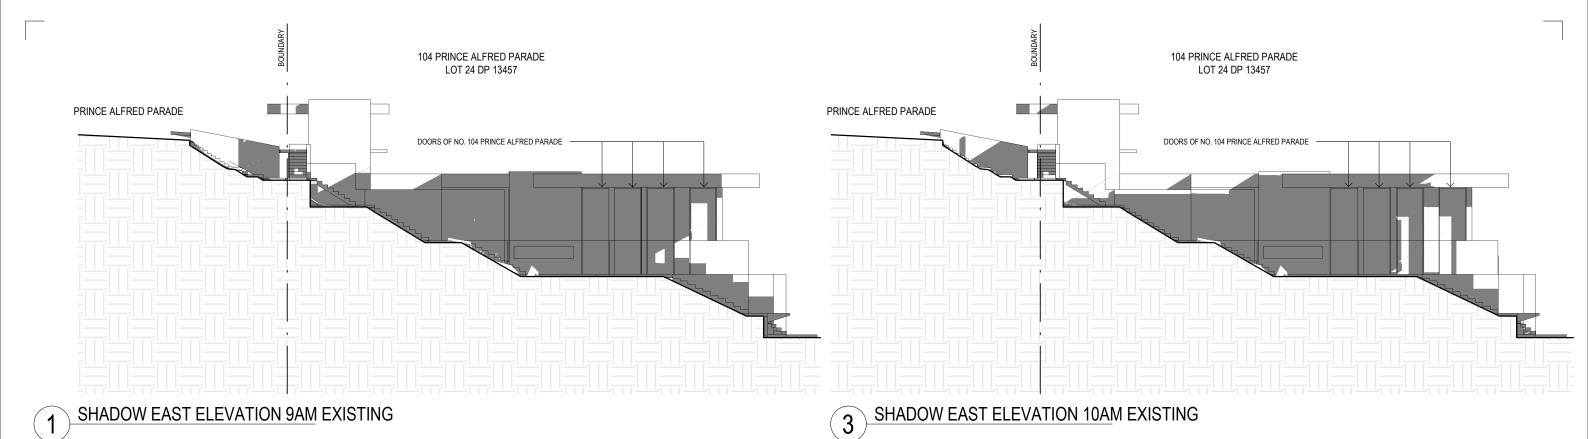

PRINCE ALFRED PARADE

104 PRINCE ALFRED PARADE

LOT 24 IDP 13457

PRINCE ALFRED PARADE

00076 0° NO 541 PRINCE ALFRED PARADE

SHADOW EAST ELEVATION 9AM PROPOSED

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DEVELOPMENT APPLICATIONSHADOW ANALYSIS -

ELEVATIONS 01

GENERAL NOT

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REFER TO CAD DRAFT PLANS FOR CERTIFICATION OF SHADOWS


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 PROJECT NO.
 STAGE DWG NO.
 REV


 106 Prince Alfred Parade Newport - Lot
 196
 DA005
 A

 25 DP13457

 DRAWNING
 Drawn:
 ES
 Scale:
 1:200 @AS

 SHADOW ANALYSIS - ELEVATIONS 01
 Checked:
 BS
 Date:
 30.06.21

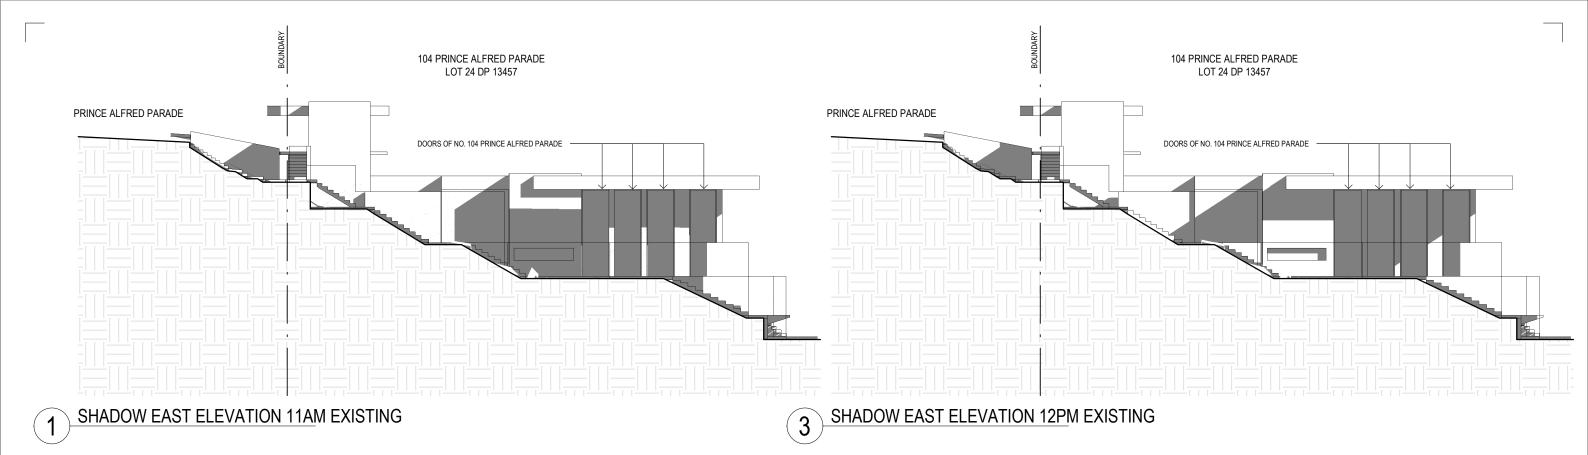

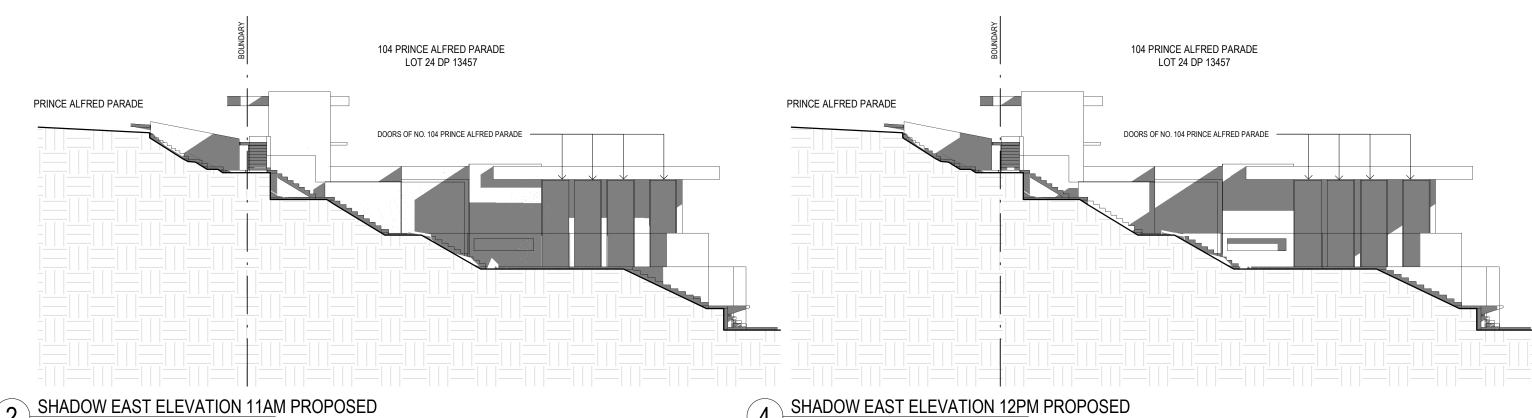

SHADOW EAST ELEVATION 11AM PROPOSED

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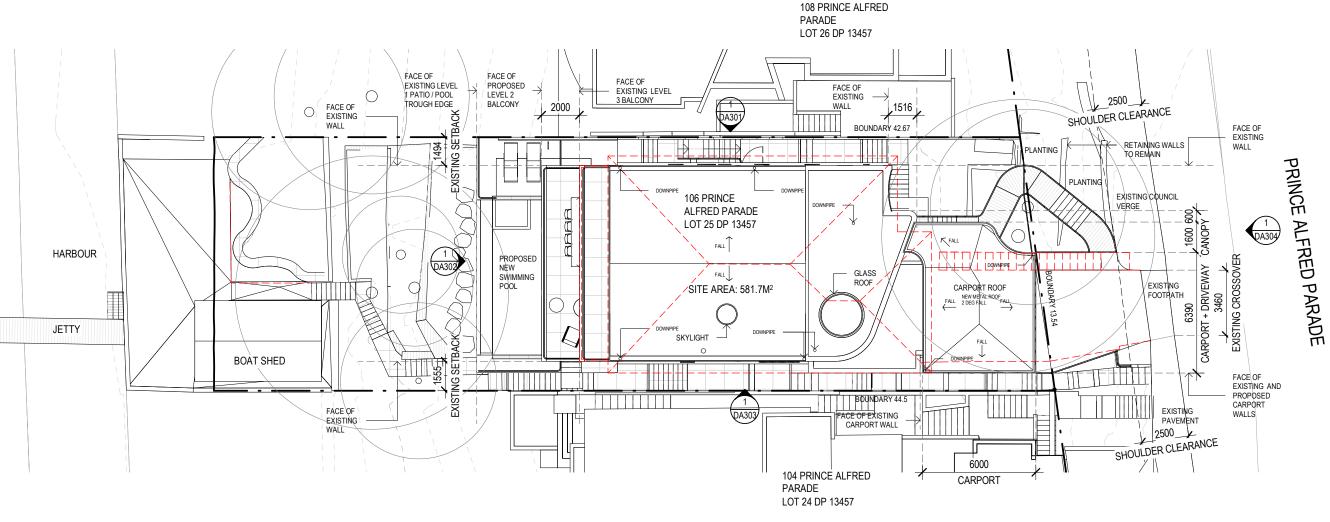
DEVELOPMENT APPLICATION

SHADOW ANALYSIS -**ELEVATIONS 02**

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REFER TO CAD DRAFT PLANS FOR CERTIFICATION OF SHADOWS

PROJECT 106 Prince Alfred Parade Newport - Lot 25 DP13457	196	T NO.	DA006	NO. REV
DRAWING SHADOW ANALYSIS - ELEVATIONS 02	Drawn:	ES	Scale:	1 : 200 @A3
	Checked:	BS	Date:	30.06.21



BASIX

The applicant must install a rainwater tank of at least 1356 litres on the site. The rainwater tank must meet, and be installed in accordance with, the requirements of all applicable regulatory authorities.

The swimming pool must be outdoors
The swimming pool must not have a capacity greater than 26 kilolitres

The spa must not have a capacity greater than 2.3 kilolitres The applicant must install the following hot water system in the development: gas storage

The applicant must construct the new or altered construction in accordance with the specification list below, except that a) additional insulation is not required where the area of new construction is less than 2m2, b) insulation specified is not required for parts of altered construction where insulation already exists

Concrete slab on ground floor – nil additional insulation required External wall: cavity brick – nil additional insulation required

 additional insulation ceilieng:R2.50 (up), roof: foil/sarking
 Other specifications medium (solar absorptance 0.475-0.70) Flat ceiling, pitched roof

Flat ceiling, flat roof: concrete/plasterboard internal – additional insulation ceiling: R2.50 (up), roof: none
- Other specifications: light (solar absorptance <0.475)

Windows and glazed doors glazing requirements

The applicant must install the windows, glazed doors and shading devices in accordance with the specifications listed in the table of page 6 of the BASIX report. Relevant overshadowing specifications must be satisfied for each window and glazed door.

For projections descibed as a ratio, the ratio of the projection from the wall to the height above the window or glazed door sill must be at least that


shown in the table of page 6 of the BASIX report.

Overshadowing building or vegetation must be of the height and distance from the centre and the base of the window and glazed door, as specified in the 'overshadowing' column in the table below.

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All windows to be improved aluminium, single clear (U-value: 6.44, SHGC:0.75).

Skylight 1 - timber frame, glass type - double clear/air fill (U-value: 4.3, SHGC: 0.5)
Glazed Roof G1- glass type improved aluminium, single pyrolytic low-e, (U-value: 4.48, SHGC: 0.46)

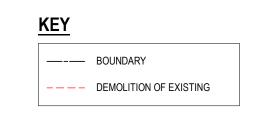

DEVELOPMENT APPLICATION SITE PLAN / ROOF PLAN




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PROJECT NO. STAGE DWG NO. REV 106 Prince Alfred Parade Newport - Lot 196 DA101 25 DP13457 1:200@A3 SITE PLAN / ROOF PLAN 30.06.21

LEGEND

-- EXISTING ELEMENT TO BE DEMOLISHED

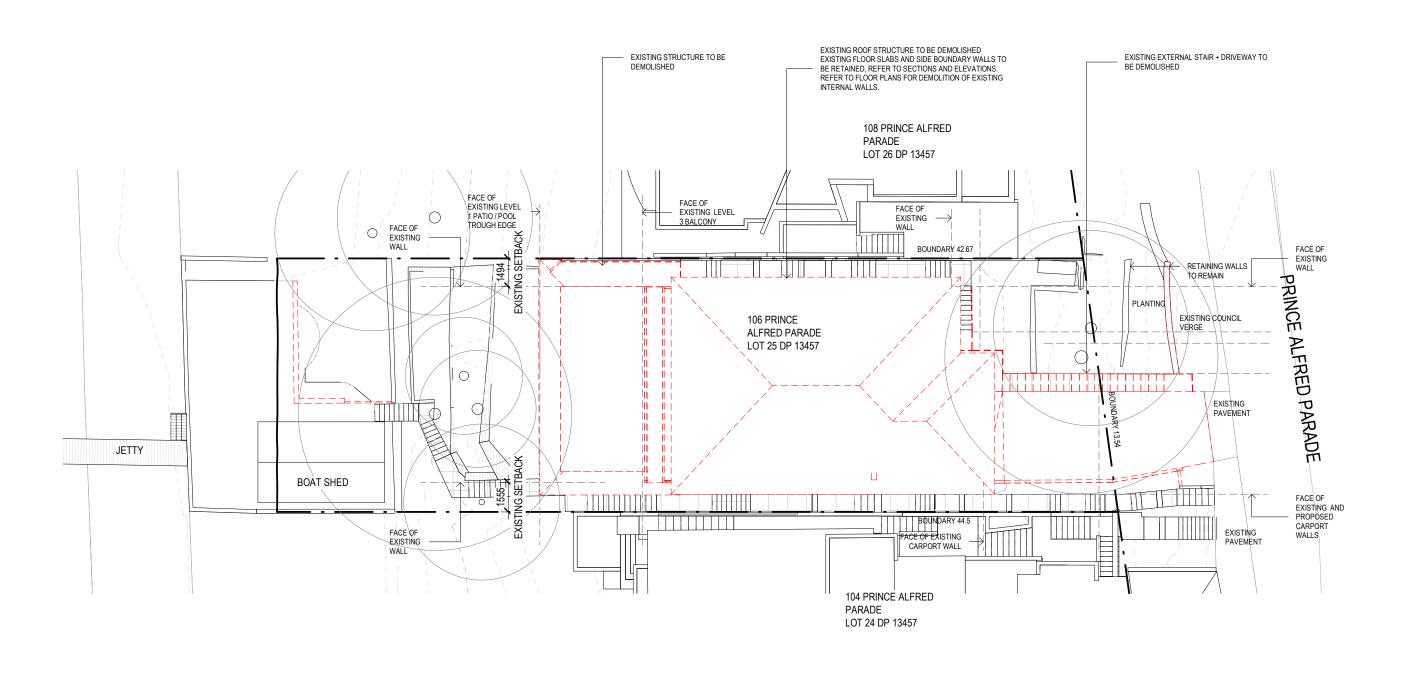

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DATE REV AMENDMENT

21.11.09 A REVISED AMENDMENTS FROM COUNCIL

106 Prince Alfred Parade Newport - Lot
25 DP13457


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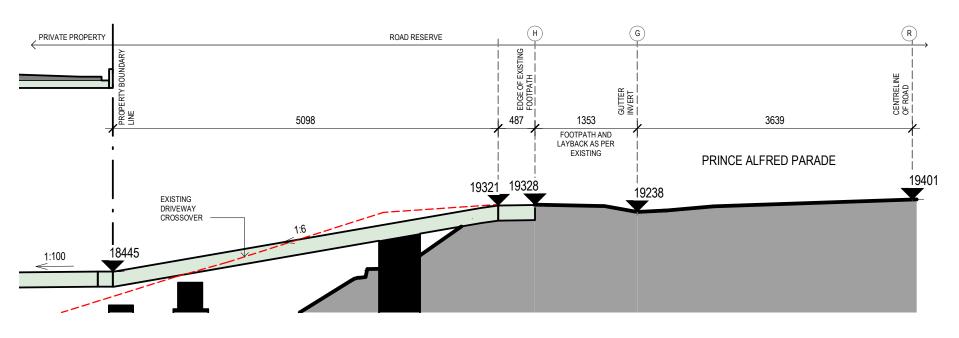
PROJECT NO. STAGE DWG NO. REV

196 DA110 A

1:200@A3

30.06.21



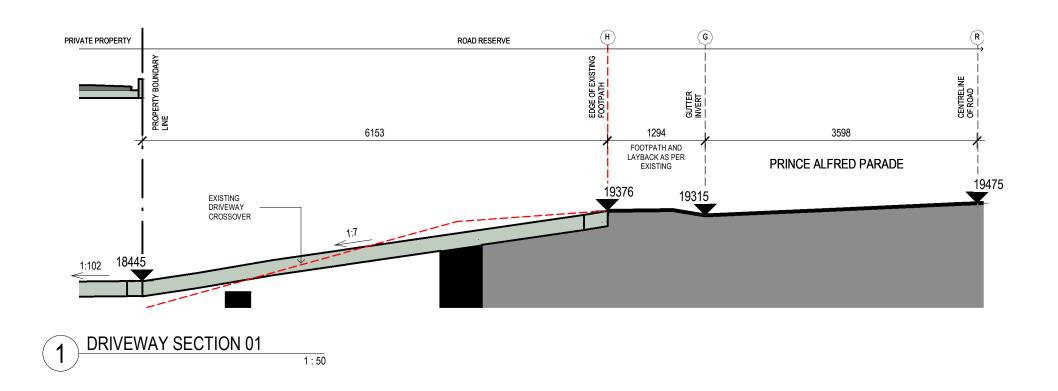

2 DRIVEWAY SECTION 02

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DEVELOPMENT APPLICATIONDRIVEWAY

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 PROJECT
 PROJECT NO. STAGE DWG NO. REV

 106 Prince Alfred Parade Newport - Lot
 196
 DA120
 A

 25 DP13457
 DRAWING
 Drawn:
 ES
 Scale:
 1:50 @A3

 DRIVEWAY
 Checked:
 BS
 Date:
 30.06.21




RIVERSTONE PEBBLE BALLAST TO CONCRETE ROOF



METAL DECK
TO ROOF WHERE NOTED



BRICK
TO CEILING + WALLS
WHERE NOTED

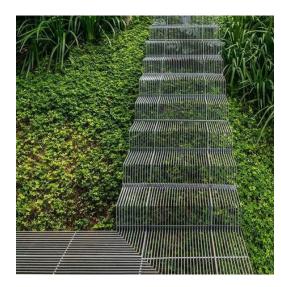

OPEN METAL TO ENTRY PATH



CRAZY PAVE FLOOR FINISH



STONE CLADDING RETAINING WALLS WHERE NOTED



CEMENT RENDER
WALL FINISH WHERE NOTED




POWDERCOAT ALUMINIUM DOORS AND WINDOWS





STREET VIEW TOWARD PROPOSED CARPORT





REAR VIEW OF PROPOSED

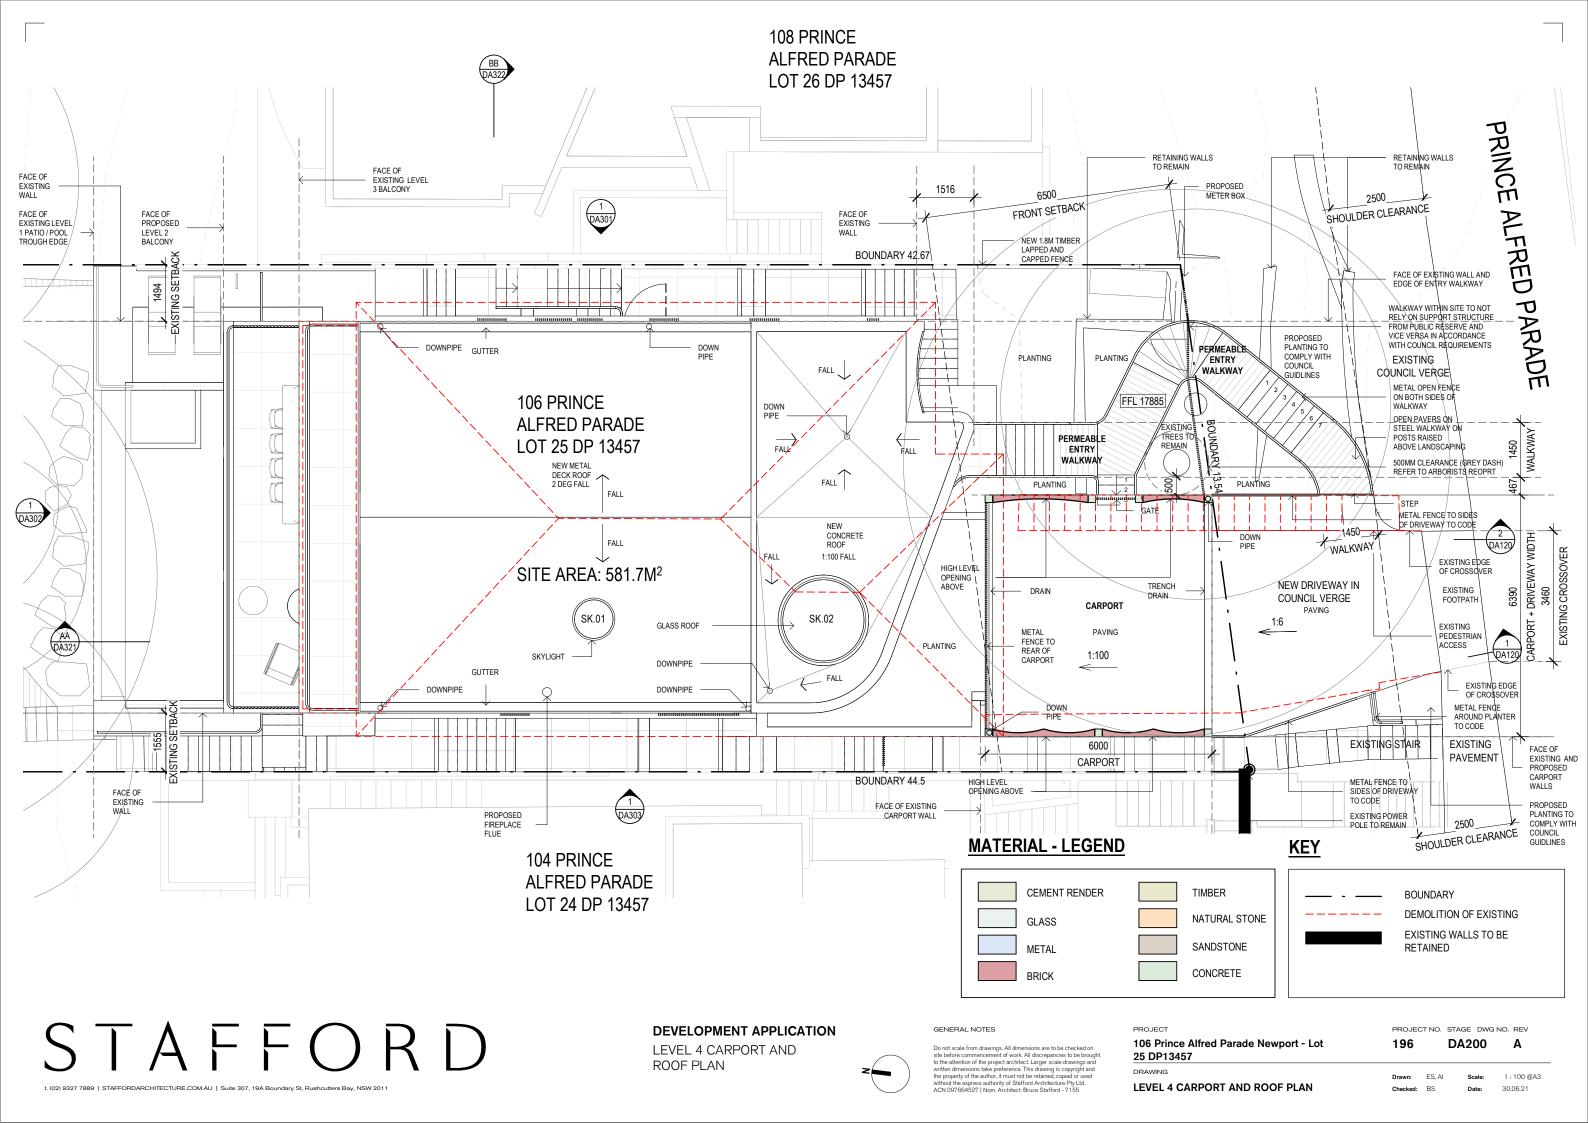

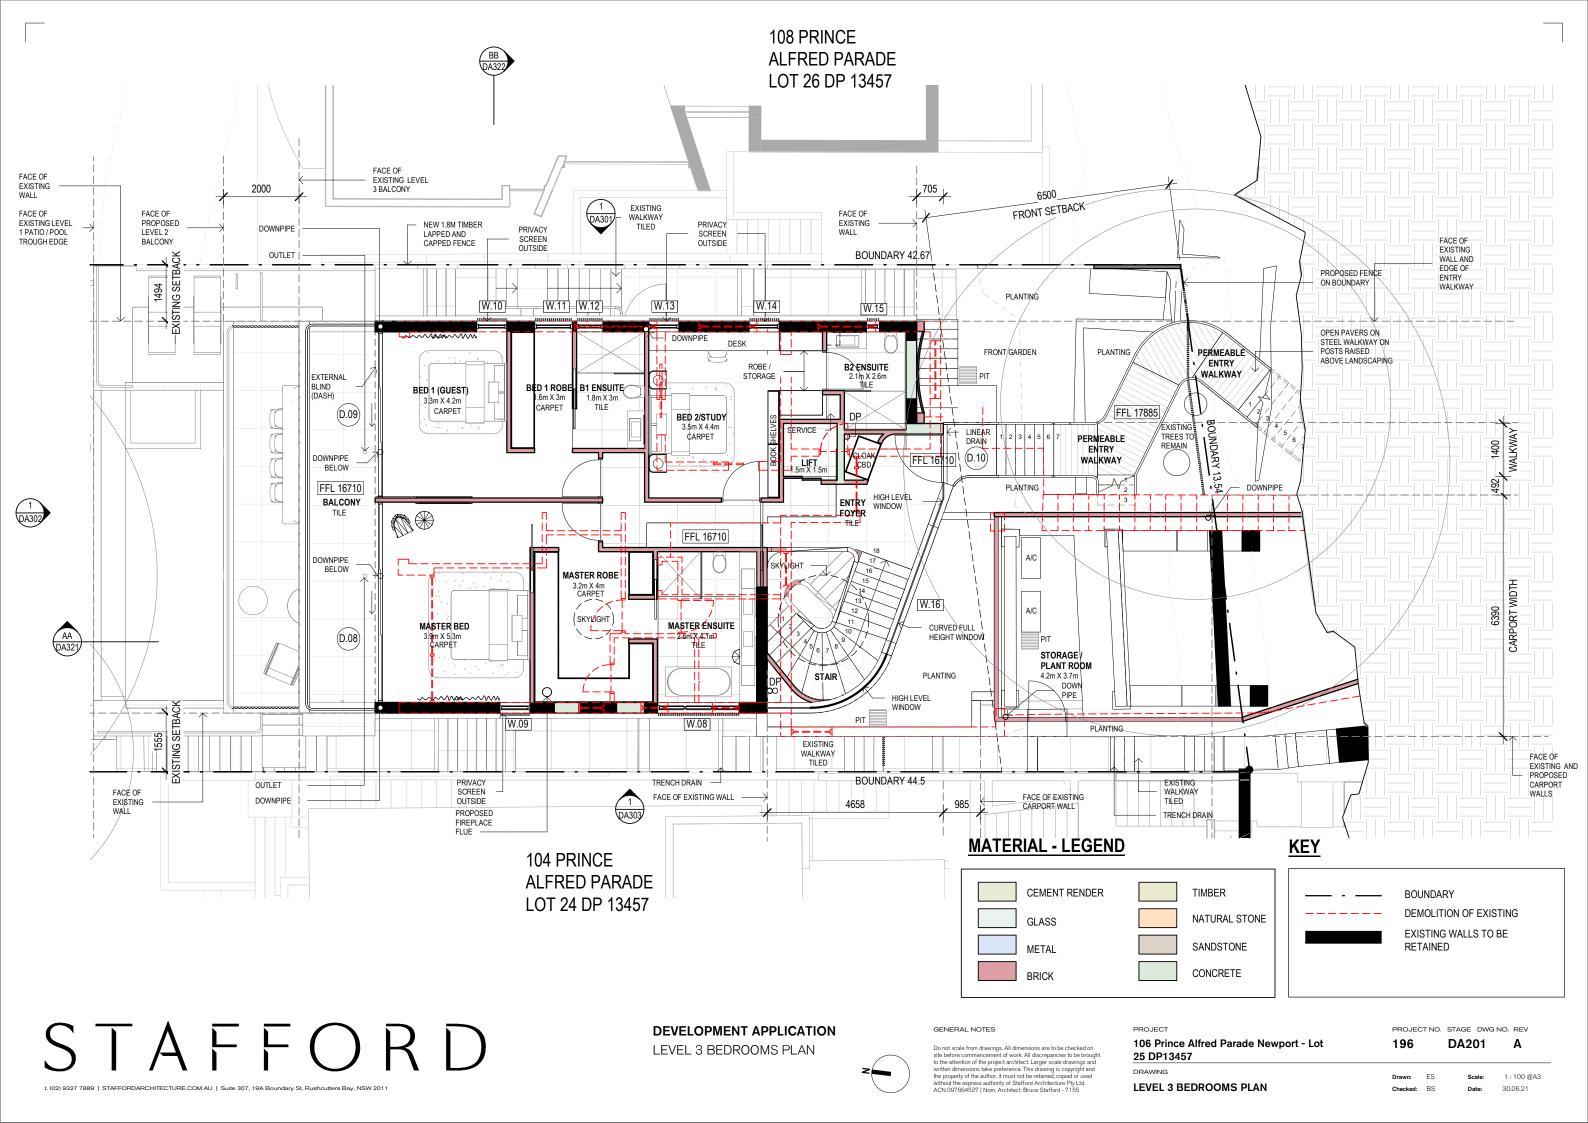


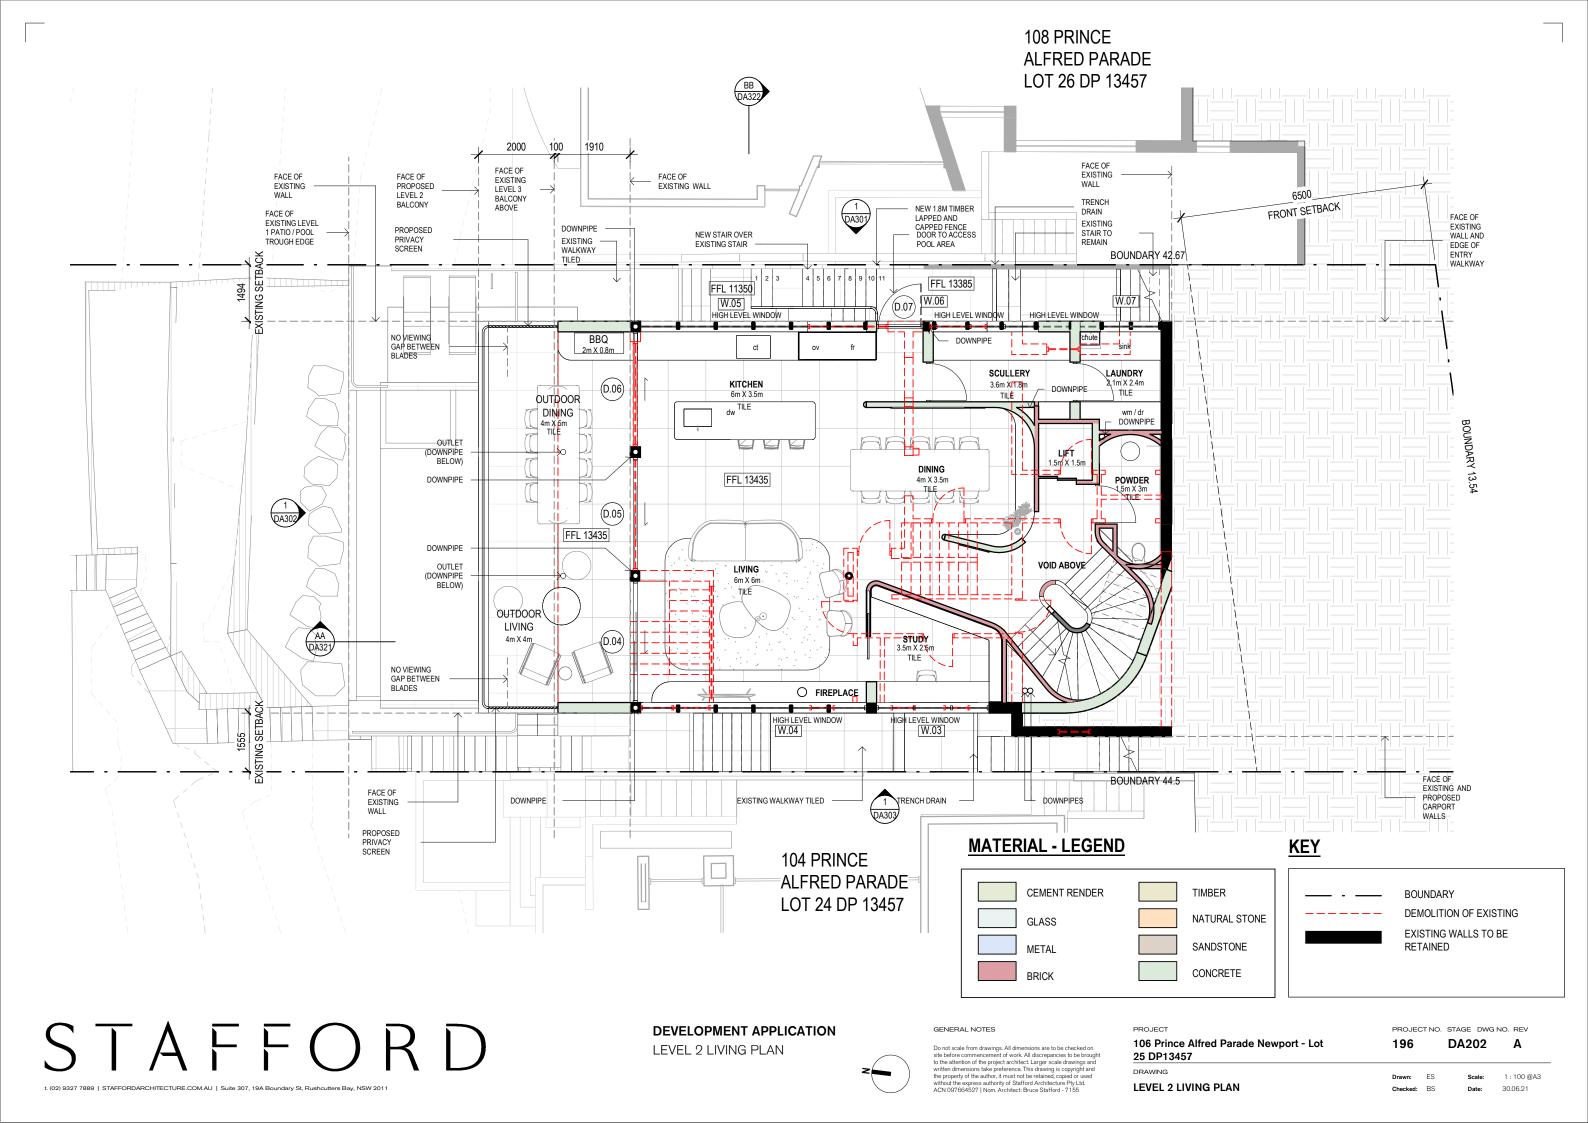

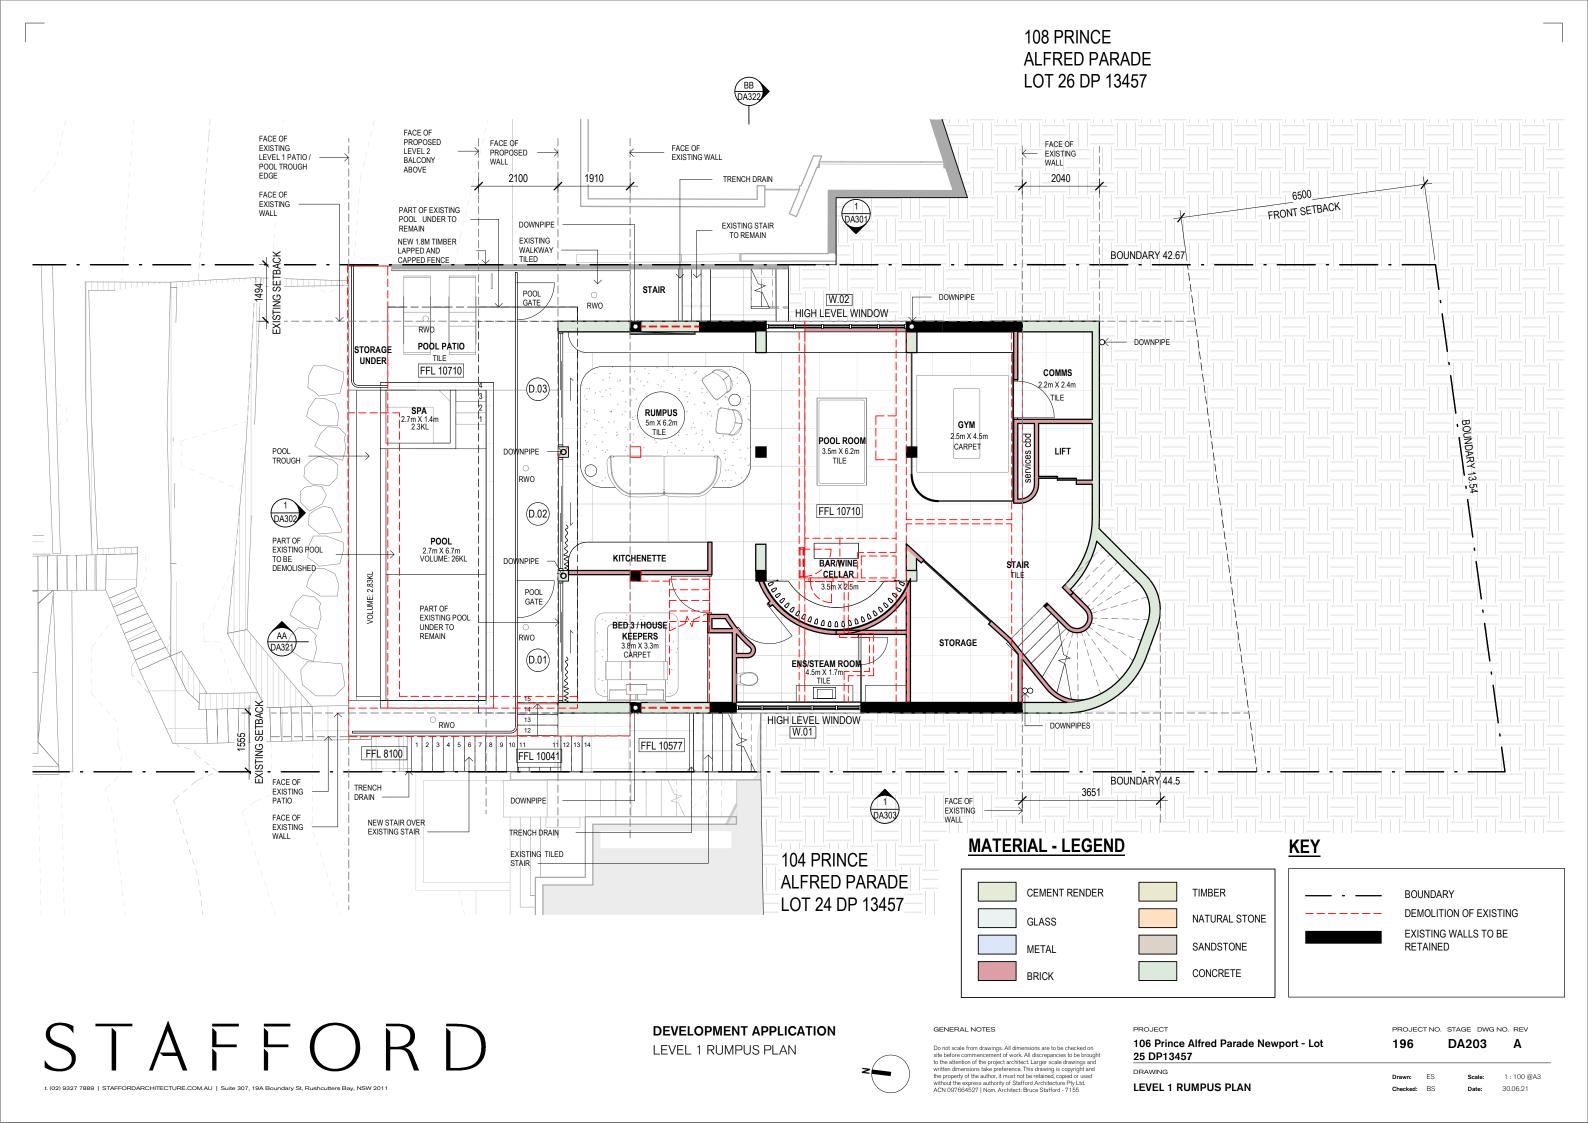

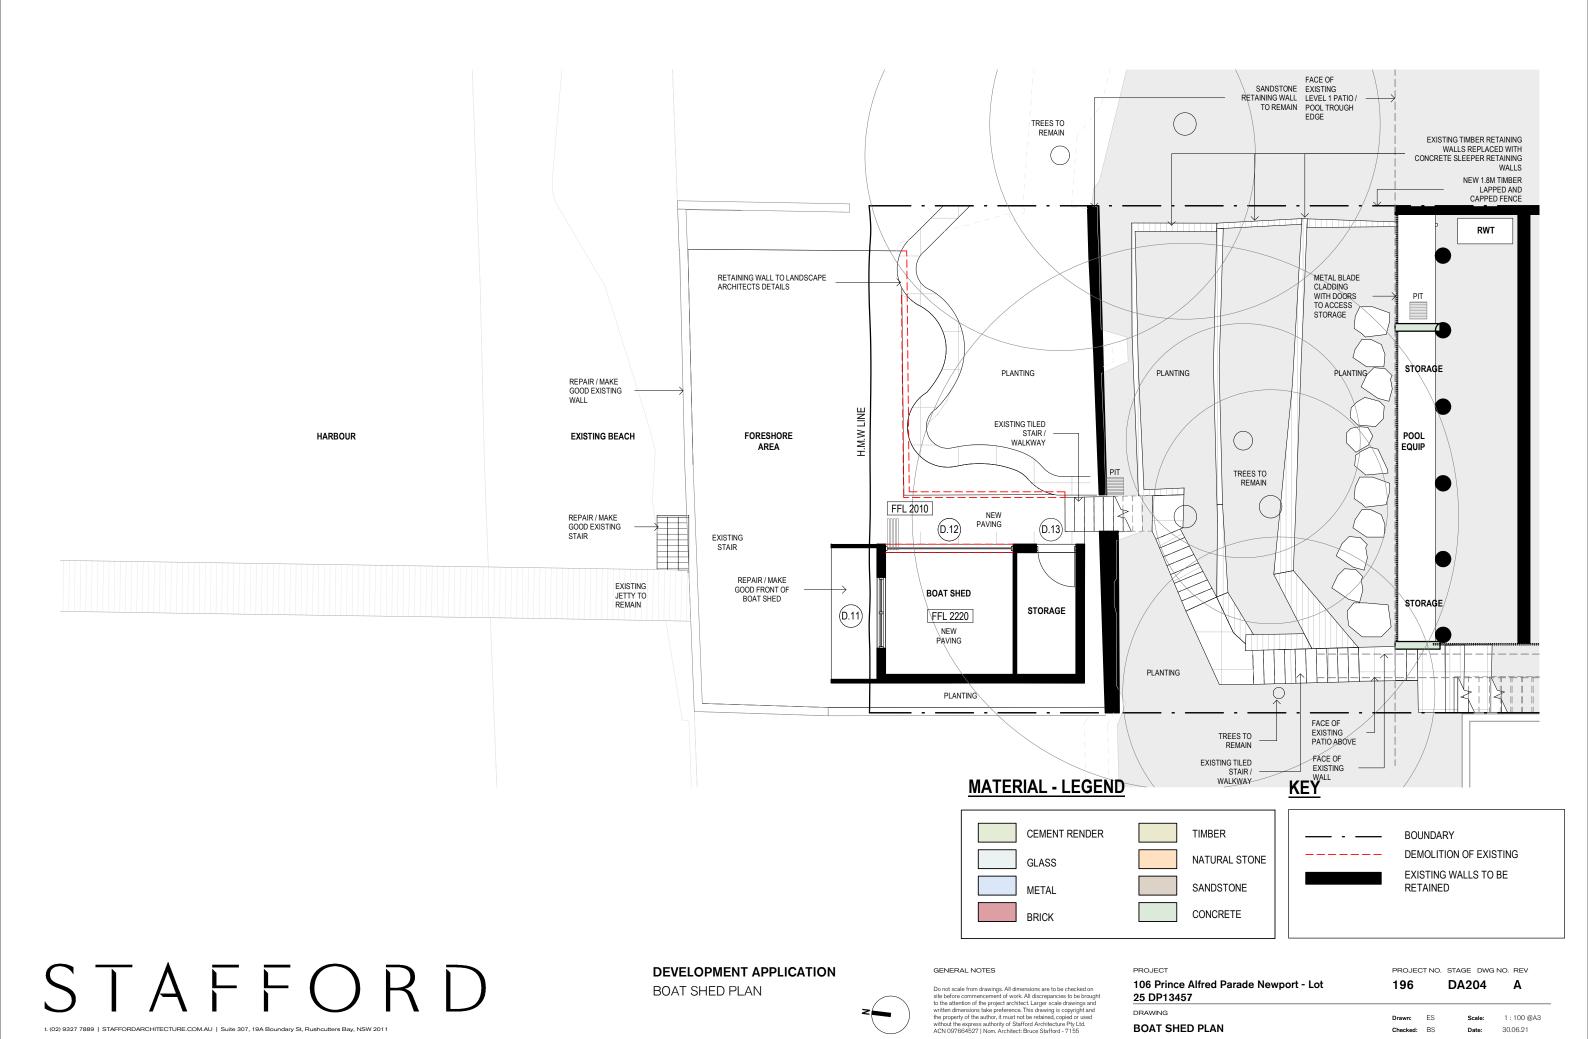

30.06.21

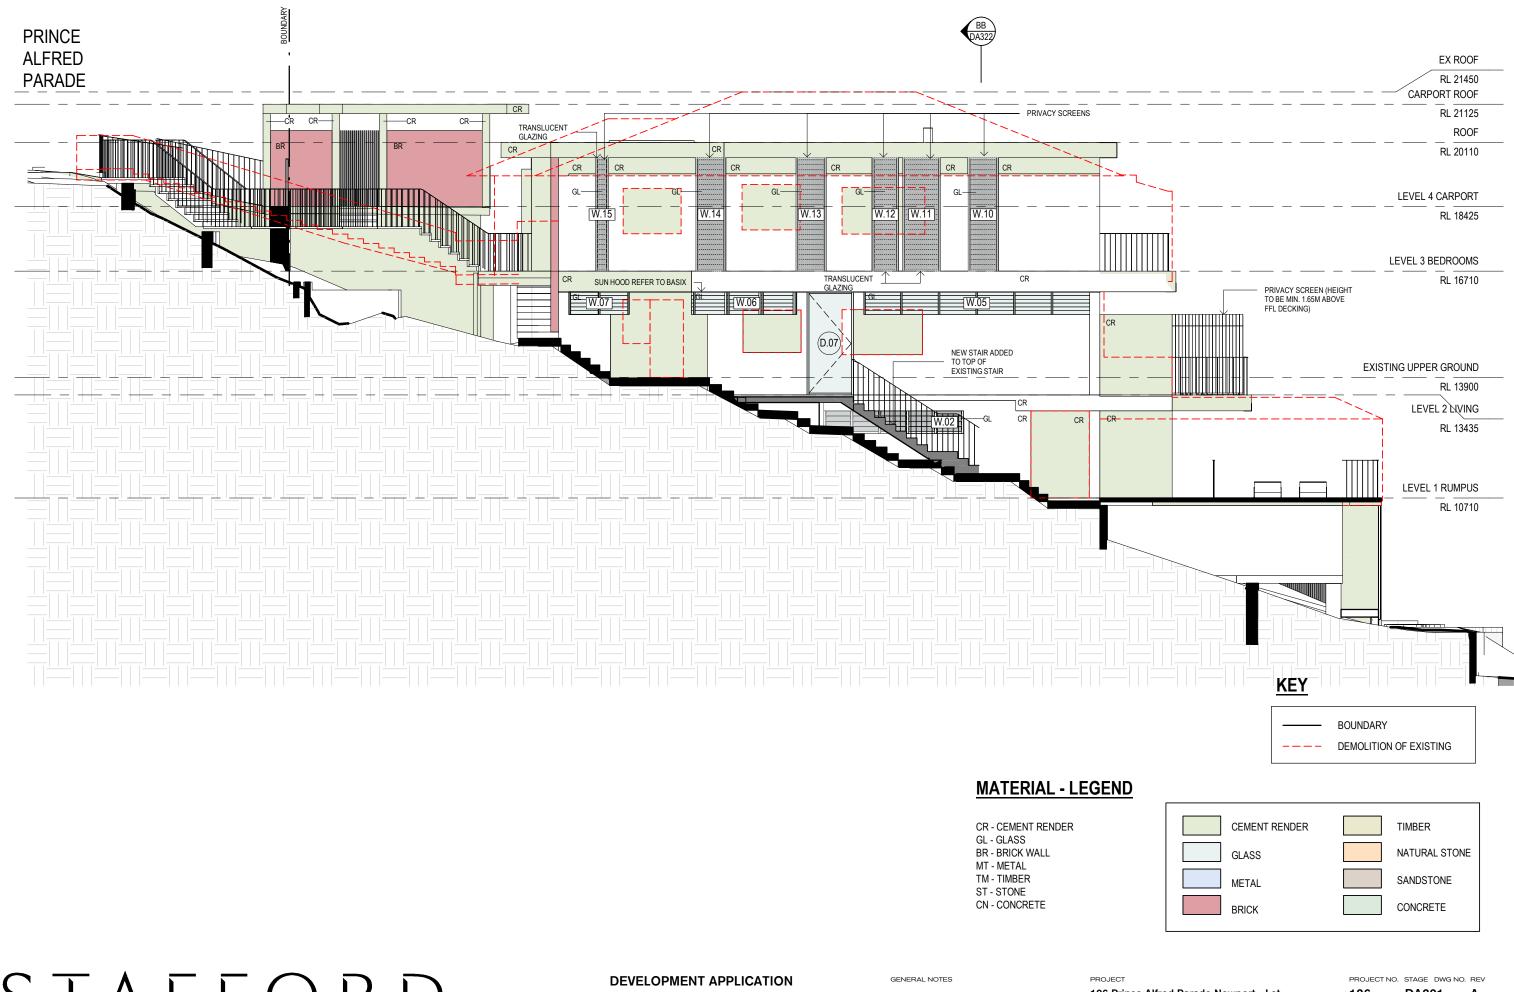


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EAST ELEVATION

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106 Prince Alfred Parade Newport - Lot DA301 25 DP13457 **EAST ELEVATION**



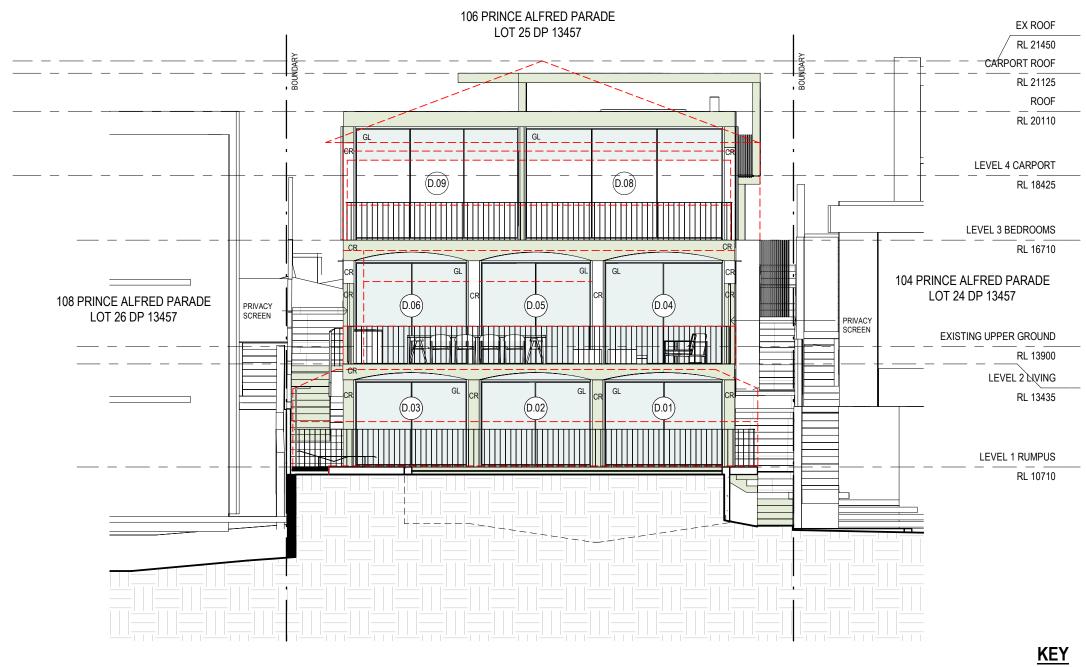

BOUNDARY ---- DEMOLITION OF EXISTING

30.06.21

MATERIAL - LEGEND

CR - CEMENT RENDER GL - GLASS


BR - BRICK WALL

MT - METAL

TM - TIMBER

ST - STONE

CN - CONCRETE

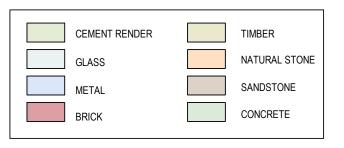




DEVELOPMENT APPLICATION


NORTH ELEVATION

GENERAL NOTES


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PROJECT NO. STAGE DWG NO. REV 106 Prince Alfred Parade Newport - Lot DA302 25 DP13457 1:100@A3 NORTH ELEVATION



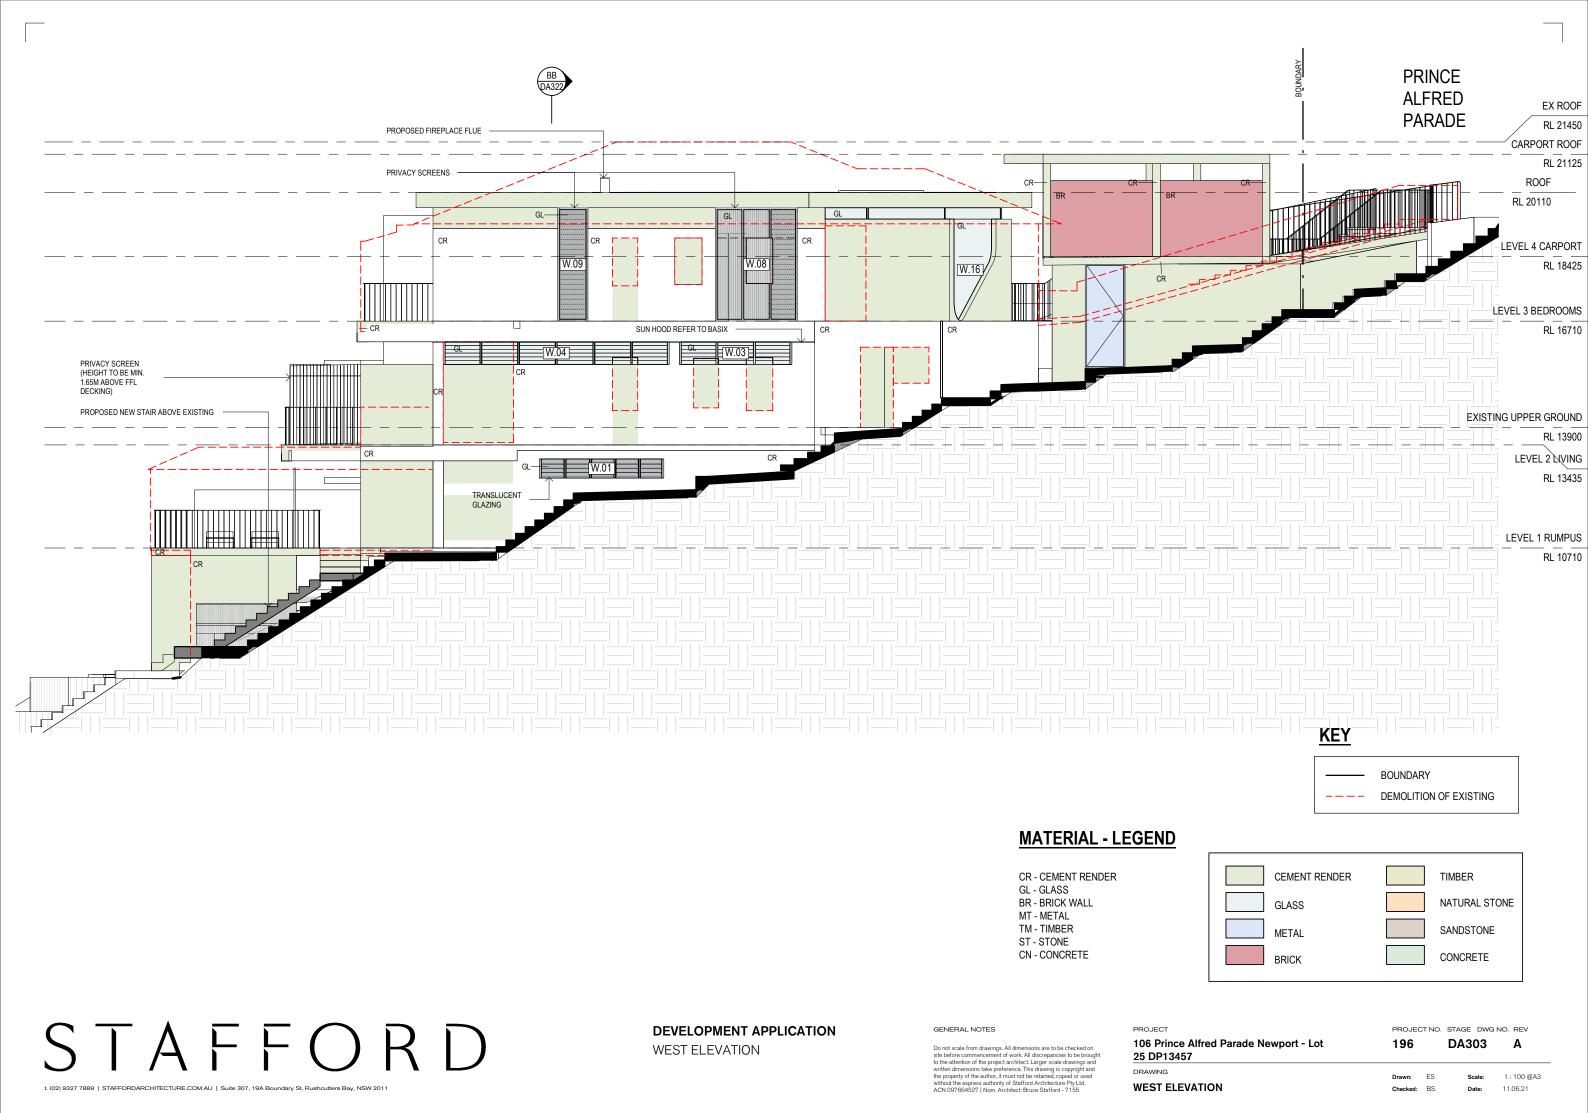

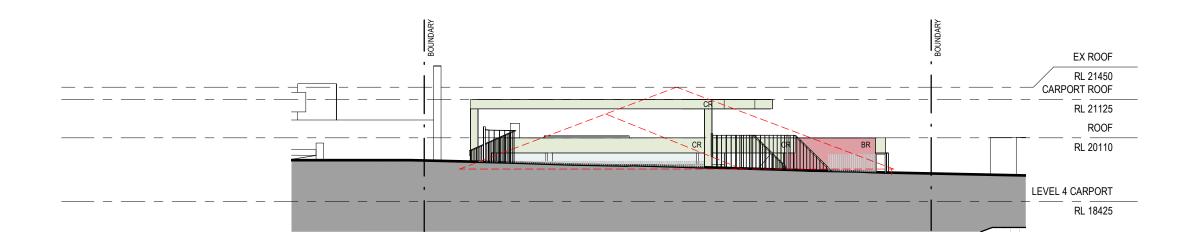1 SOUTH ELEVATION - STREET
1:10

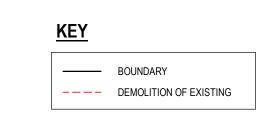

MATERIAL - LEGEND

SOUTH ELEVATION

CR - CEMENT RENDER GL - GLASS

BR - BRICK WALL MT - METAL

TM - TIMBER ST - STONE

CN - CONCRETE

CEMENT RENDER TIMBER

GLASS NATURAL STONE

METAL SANDSTONE

BRICK CONCRETE

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DEVELOPMENT APPLICATIONSOUTH ELEVATION

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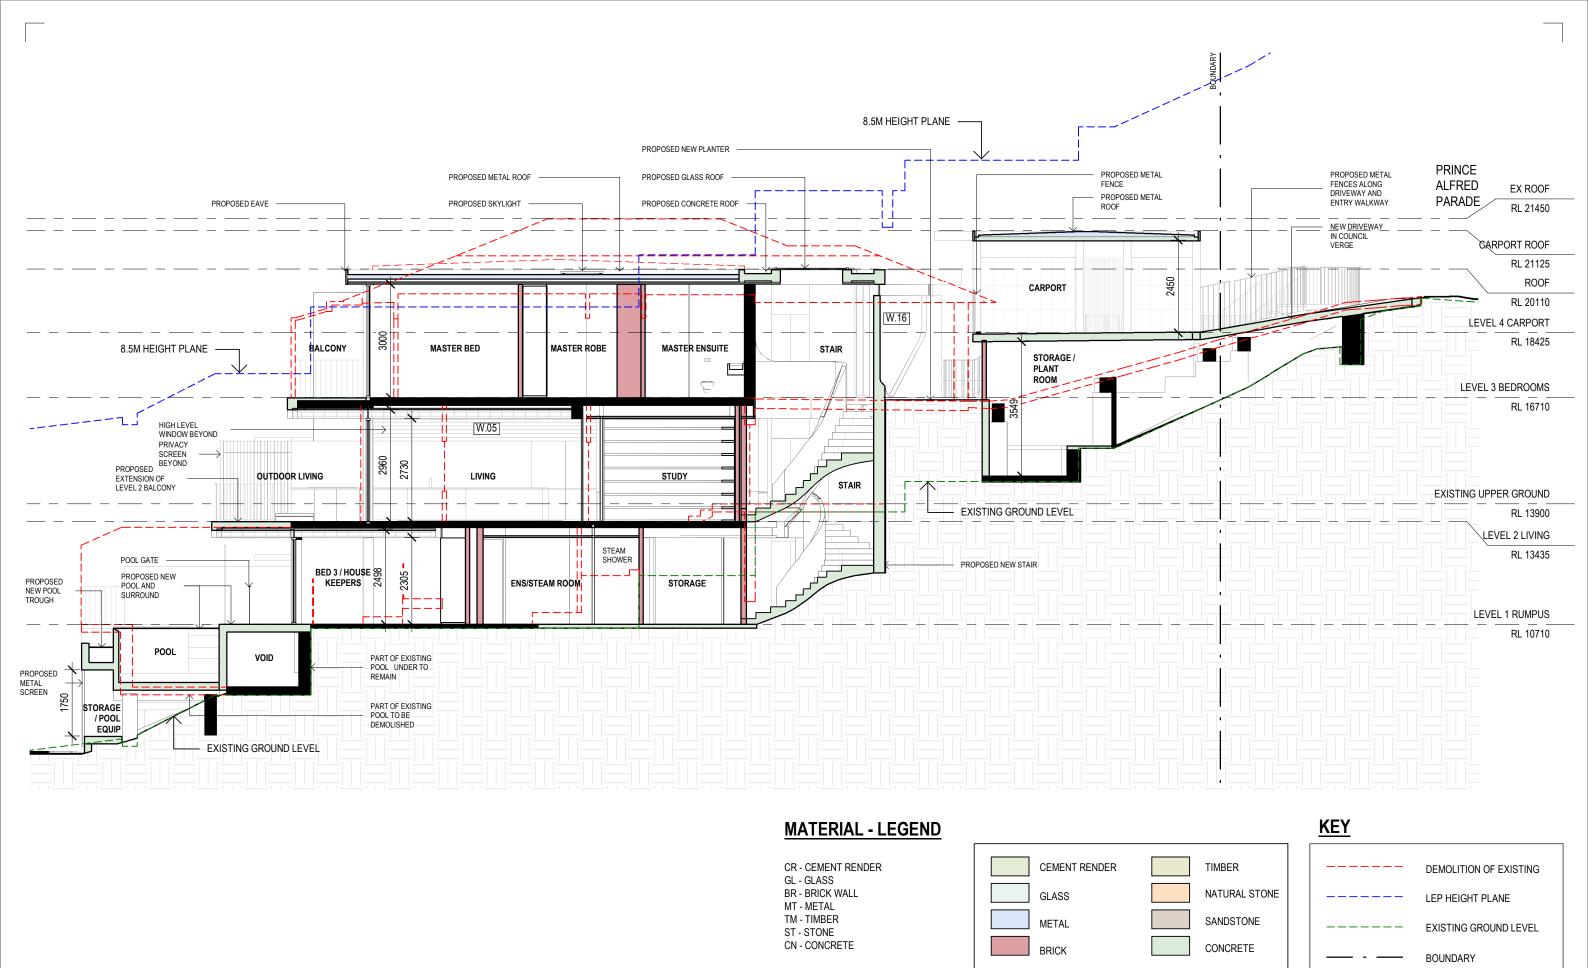
106 Prince Alfred Parade Newport - Lot
25 DP13457

DRAWING

PROJECT NO. STAGE DWG NO. REV

196 DA304 A

Prawn: ES Scale: 1:100 @A3





DEVELOPMENT APPLICATION


SECTION - AA - PROPOSED


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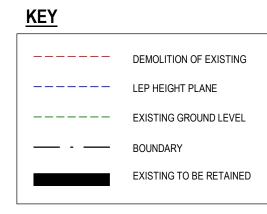
PROJECT NO. STAGE DWG NO. REV 106 Prince Alfred Parade Newport - Lot 25 DP13457

196 DA321 1:100@A3 **SECTION - AA - PROPOSED**

EXISTING TO BE RETAINED



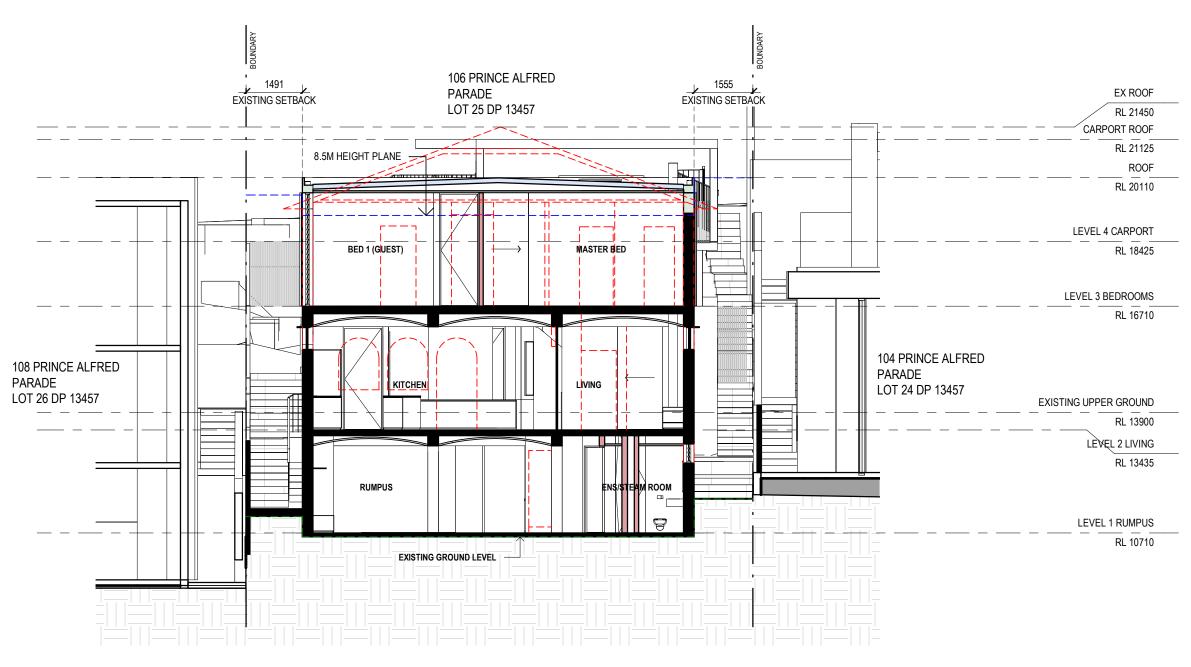

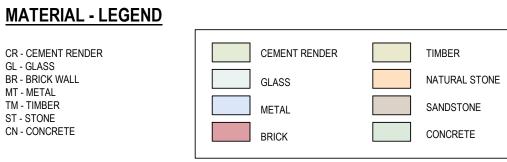



DEVELOPMENT APPLICATION

SECTION - BB - PROPOSED

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106 Prince Alfred Parade Newport - Lot 25 DP13457

PROJECT NO. STAGE DWG NO. REV 196 **DA322** 1:100@A3 **SECTION - BB - PROPOSED**