#### ARCHITECTURAL DRAWINGS

DA0.00	Cover Sheet	С
DA0.01	BASIX	Α
DA1.02	Proposed site plan	В
DA2.01	Proposed garage plan	С
DA2.02	Proposed lower ground plan	В
DA2.03	Proposed ground floor plan	Α
DA2.51	Proposed roof plan	Α
DA3.01	Proposed elevations 1	Α
DA3.02	Proposed elevations 2	С
DA4.01	Proposed sections 1	В
DA4.02	Proposed sections 2	В
DA4.03	Proposed driveway section detail	Α
DA5.01	Shadow diagrams	Α
DA7.01	External finishes	Α

#### **CONSULTANT DRAWINGS**

Survey by Realserve dated 26.03.2021 78057

A465223 BASIX by xxxx dated 01.07.2022

Landscape plans by Bates Landscape dated 11.04.2022

Stormwater Drainage plans by ITMDesign dated 30.06.2022 21/225

Statement of Environmental Effects by BBF Town Planners dated June 2022

Geotech report by White Geotechnical Group dated 06.05.2022 J4204

Development Application

For Alterations and Additions at 123 Bynya Road, Palm Beach NSW 2108

### DA APPLICATION

notes:
- do not scale from drawings.
- all dimensions are to be check measured onsite prior to commencement of work.
- written dimensions take precedence.
- this document is copyright and the property of the property of the author, and must not be retained, copied in whole or part.

additional information 27.09.2022 09.08.2022 driveway sections issue for DA 01.07.2022 Rev. Description Date

design studio group

a: suite 5, 706 military road mosman nsw 2088 e: info@designstudiogroup.com.au ph: 0421062266 NSW ARB #7988 www.designstudiogroup.com.au

#### COLOUR CODES / LEGEND BRICKWORK

TIMBER STONE GLASS

METAL ROOF TILE

CONCRETE

CEMENT RENDER

EXISTING WALLS

☐ ☐ WALLS TO BE DEMOLISHED

client	drawing title	scale As indicated @A	
Anna & Niall Lenahan	Cover Sheet		
project	drawing no.	revision	drawn KL
123 Bynya Road, Palm Beach NSW 2108 - DP 572887	DA0.00	С	job ref. PB 2021

**BASIX**\*Certificate Building Sustainability Index www.basix.nsw.gov.au

Alterations and Additions

Certificate number: A465223

This certificate confirms that the proposed development will meet the NSW government's requirements for sustainability, if it is built in accordance with the commitments set out below. Terms used in this certificate, or in the commitments, have the meaning given by the document entitled "BASIX Alterations and Additions Definitions" dated 06/10/2017 published by the Department. This document is available at www.basix.nsw.gov.au

Secretary
Date of issue: Friday, 01, July 2022
To be valid, this certificate must be lodged within 3 months of the date of issue.

Project address	
Project name	Palm Beach
Street address	123 Bynya Road oalm beach 2108
Local Government Area	Northern Beaches Council
Plan type and number	Deposited Plan 572887
Lot number	23
Section number	
Project type	
Dwelling type	Separate dwelling house
Type of alteration and addition	My renovation work is valued at \$50,000 or more and does not include a pool (and/or spa).

page 1 / 6

Certificate Prepared b	y (please complete before submitting to Council or PCA)
Name / Company Name: de	sign studio group architects
ARN (if applicable): 84 101	100 015

BASIX Certificate number: A465223

Fixtures and systems	Show on DA Plans	Show on CC/CDC Plans & specs	Certifier Check
Lighting			
The applicant must ensure a minimum of 40% of new or altered light fixtures are fitted with fluorescent, compact fluorescent, or light-emitting-diode (LED) lamps.		~	1
Fixtures			-
The applicant must ensure new or altered showerheads have a flow rate no greater than 9 litres per minute or a 3 star water rating.		~	1
The applicant must ensure new or altered toilets have a flow rate no greater than 4 litres per average flush or a minimum 3 star water rating.		~	1
The applicant must ensure new or altered taps have a flow rate no greater than 9 litres per minute or minimum 3 star water rating.		1	

Construction			Show on DA Plans	Show on CC/CDC Plans & specs	Certifier Check
nsulation requirements				-	
The applicant must construct the new or altered construction (floor(s), walls, and ceilings/roofs) in accordance with the specifications listed in the table below, except that a) additional insulation is not required where the area of new construction is less than 2m2, b) insulation specified is not required for parts of altered construction where insulation already exists.					1
**************************************	### ### ### ### ### ### ### #### ####		_		
is not required for parts of altered const	Additional insulation required (R-value)	Other specifications	-		
**************************************	### ### ### ### ### ### ### #### ####	Other specifications			
Construction	Additional insulation required (R-value)	Other specifications			

Planning, Industry & Environment Planning, Industry & Environment Building Sustainability Index www.basix.nsw.gov.au

BASIX Certificate number: A465223

BASIX Certificate number: A465223

	uirements					Show on DA Plans	Show on CC/CDC Plans & specs	Certifier Check
Windows an	d glazed doc	ors						
				and shading devices, in accordance with ed for each window and glazed door.	the specifications listed in the table below.	~	~	~
The following	requirements m	nust also be	satisfied in re	lation to each window and glazed door:			~	~
have a U-valu	e and a Solar H	Heat Gain Co	pefficient (SH		ed glass may either match the description, or, le below. Total system U-values and SHGCs s.		<b>✓</b>	~
				lge of each eave, pergola, verandah, ba nore than 2400 mm above the sill.	Icony or awning must be no more than 500 mm	✓	~	~
Pergolas with	polycarbonate	roof or simil	ar translucen	material must have a shading coefficier	nt of less than 0.35.		~	~
				to the window or glazed door above whi battens must not be more than 50 mm.	ich they are situated, unless the pergola also		~	1
shades a perp Overshadowir	endicular windo	ow. The spa vegetation m	cing betweer nust be of the	battens must not be more than 50 mm. height and distance from the centre and		~	✓ ✓	✓ ✓
shades a perp Overshadowir specified in th Windows a	endicular windo ng buildings or v e 'overshadowin ind glazed d	ow. The spa vegetation m ng' column i	cing between nust be of the n the table be ing require	battens must not be more than 50 mm. height and distance from the centre and low.  ments	I the base of the window and glazed door, as	<b>√</b>	✓ ✓	✓ ✓
shades a perp Overshadowir specified in th Windows a Window / doo	pendicular windo ng buildings or v e 'overshadowii and glazed d or Orientation	ow. The spa vegetation m ng' column i loors glaz Area of O	nust be of the nust be of the nust be table be ling require vershadowing eight Distal	battens must not be more than 50 mm. height and distance from the centre and low.  ments Shading device	THE RESERVE THE PROPERTY OF THE PARTY OF THE	<b>√</b>	✓ ✓	✓ ✓
shades a perp Overshadowir specified in th Windows a Window / doo no.	pendicular windong buildings or velocity of control of the control	vegetation many column is column.	nust be of the nust be of the nust be table be ling require vershadowing eight Distal	battens must not be more than 50 mm. height and distance from the centre and low.  ments Shading device	I the base of the window and glazed door, as	<b>✓</b>	<b>*</b>	✓ ✓
shades a perp Overshadowin specified in th Windows a Window / doo no.	pendicular windong buildings or vershadowing discount glazed door Orientation	ow. The spa vegetation m ng' column i loors glaz Area of O glass inc. (m frame (m2)	cing between nust be of the n the table be ling require vershadowing eight Distan n)	battens must not be more than 50 mm. height and distance from the centre and low.  Perments Shading device nce eave/verandah/pergola/balcony	Frame and glass type standard aluminium, single clear, (or	~	×	✓ ✓
shades a perp Overshadowin specified in th Windows a Window / doo no.	nendicular windong buildings or vershadowing discounting discounti	ow. The spa vegetation m ng' column i loors glaz Area of Oglass inc. (rframe (m2) 15 3	nust be of the n the table be ling require vershadowing eight Distar (m)	battens must not be more than 50 mm. height and distance from the centre and low.  Perments Shading device nce eave/verandah/pergola/balcony	Frame and glass type  standard aluminium, single clear, (or U-value: 7.63, SHGC: 0.75)	✓ ·	× ×	✓ ✓
shades a perp Overshadowir specified in th Windows a Window / doo no.  W1  Skylights  The applicant	must install the	vegetation many column is	nust be of the n the table be ling require vershadowing eight Distarn)  4	battens must not be more than 50 mm. height and distance from the centre and low.  Break Shading device  ce  eave/verandah/pergola/balcony >=900 mm	Frame and glass type  standard aluminium, single clear, (or U-value: 7.63, SHGC: 0.75)		× ×	<b>*</b>

Planning, Industry & Environment Building Sustainability Index www.basix.nsw.gov.au

BASIX Certificate number	er: A465223					page
Glazing require	ements			Show on DA Plans	Show on CC/CDC Plans & specs	Certifier Check
the table below. External awnings	and louvres must f	ully shade the skylight above which they a	re situated when fully drawn or closed.		<b>√</b>	~
Skylights glaz	ing requiremen	nts				
Skylight number	Area of glazing inc. frame (m2)	Shading device	Frame and glass type			
S1	3	external adjustable awning or blind	aluminium, moulded plastic single clear, (or U-value: 6.21, SHGC: 0.808)	]		
S2	3	external adjustable awning or blind	aluminium, moulded plastic single clear, (or U-value:	1		

In these commitments, "applicant" means the person carrying out the development.

Commitments identified with a "\sqrt "in the "Show on DA plans" column must be shown on the plans accompanying the development application for the proposed development (if a development application is to be lodged for the proposed development). Commitments identified with a "v/" in the "Show on CC/CDC plans & specs" column must be shown in the plans and specifications accompanying the application for a construction certificate / complying development certificate for the proposed development.

Commitments identified with a "\sqrt " in the "Certifier check" column must be certified by a certifying authority as having been fulfilled, before a final occupation certificate for the development may be issued.

Planning, Industry & Environment Building Sustainability Index www.basix.nsw.gov.au Planning, Industry & Environment Building Sustainability Index www.basix.nsw.gov.au

## **DA APPLICATION**

Rev.

notes:
- do not scale from drawings.
- all dimensions are to be check measured onsite prior to commencement of work.
- written dimensions take precedence.
- this document is copyright and the property of the property of the author, and must not be retained, copied in whole or part.

issue for DA

Description


01.07.2022 Date

design studio group

a: suite 5, 706 military road mosman nsw 2088 e: info@designstudiogroup.com.au ph: 0421062266 NSW ARB #7988 www.designstudiogroup.com.au

client	drawing title	scale @A2	
Anna & Niall Lenahan	BASIX	date Dec 2021	
project	drawing no.	revision	drawn Author
123 Bynya Road, Palm Beach NSW 2108 - DP 572887	DA0.01	Α	job ref. PB 2021

page 6 / 6

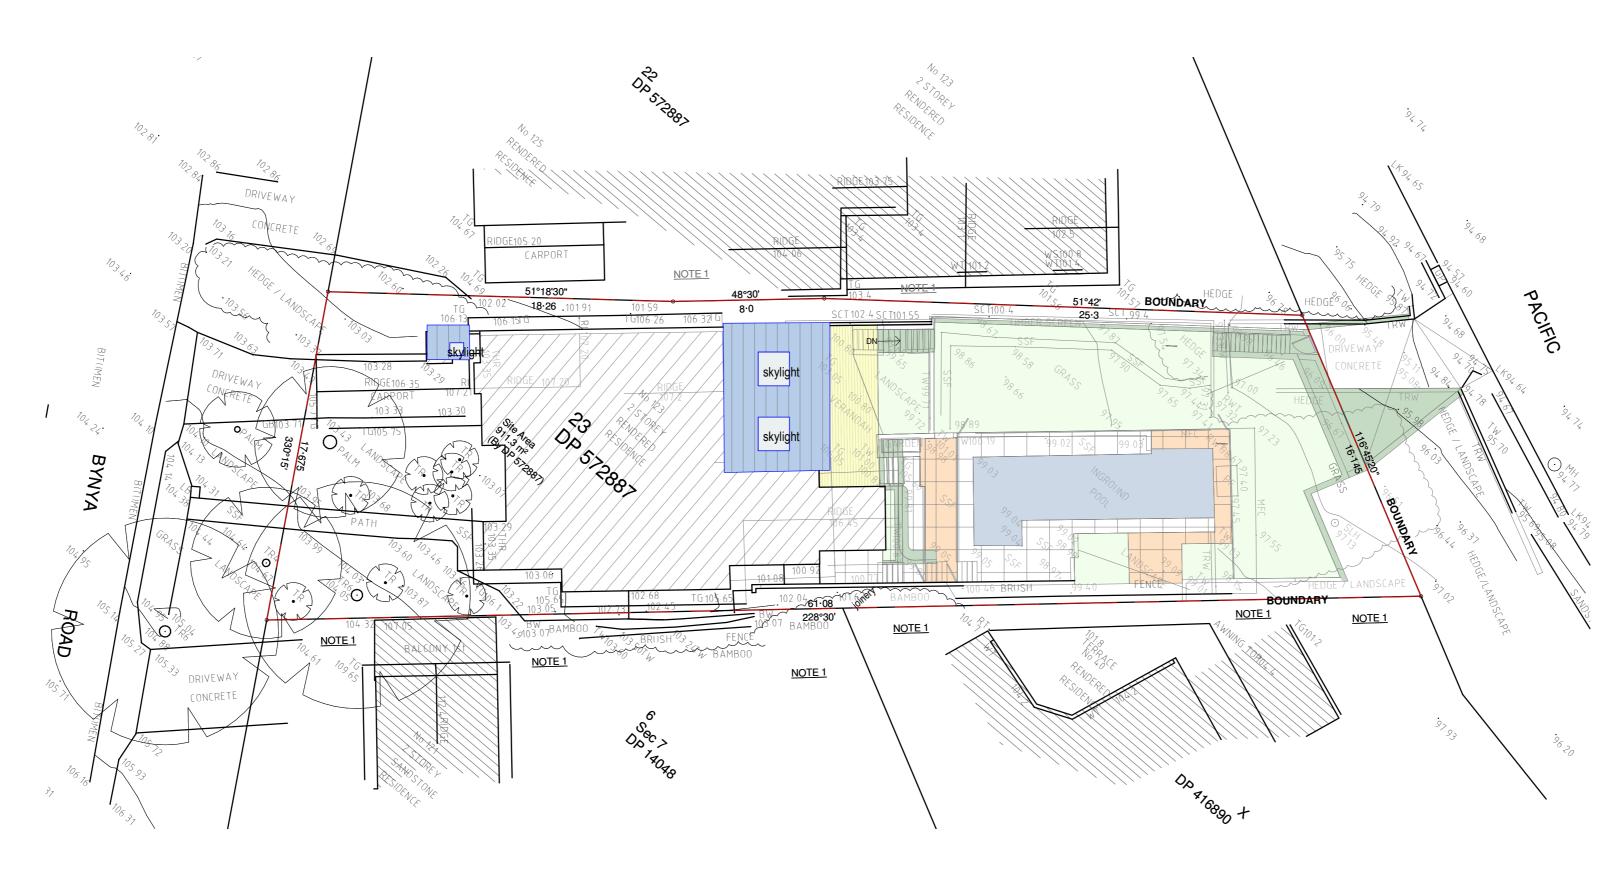

PROPOSED SITE PLAN
1:200

# DA APPLICATION

Rev.

notes:
- do not scale from drawings.
- all dimensions are to be check measured onsite prior to commencement of work.
- written dimensions take precedence.
- this document is copyright and the property of the property of the author, and must not be retained, copied in whole or part.

additional information 27.09.2022 issue for DA 01.07.2022 Description Date

#### design studio group

a: suite 5, 706 military road mosman nsw 2088 e: info@designstudiogroup.com.au ph: 0421062266 NSW ARB #7988 www.designstudiogroup.com.au



client	drawing title	scale As indicated @A2		
Anna & Niall Lenahan	Proposed site plan	date Dec 2021		
project 123 Bynya Road, Palm Beach NSW 2108 - DP 572887	drawing no. DA1.02	revision B	drawn KL job ref. PB 2021	

COLOUR CODES / LEGEND

BRICKWORK

STONE


METAL

ROOF TILE
CONCRETE

CEMENT RENDER

EXISTING WALLS

☐ ☐ WALLS TO BE DEMOLISHED

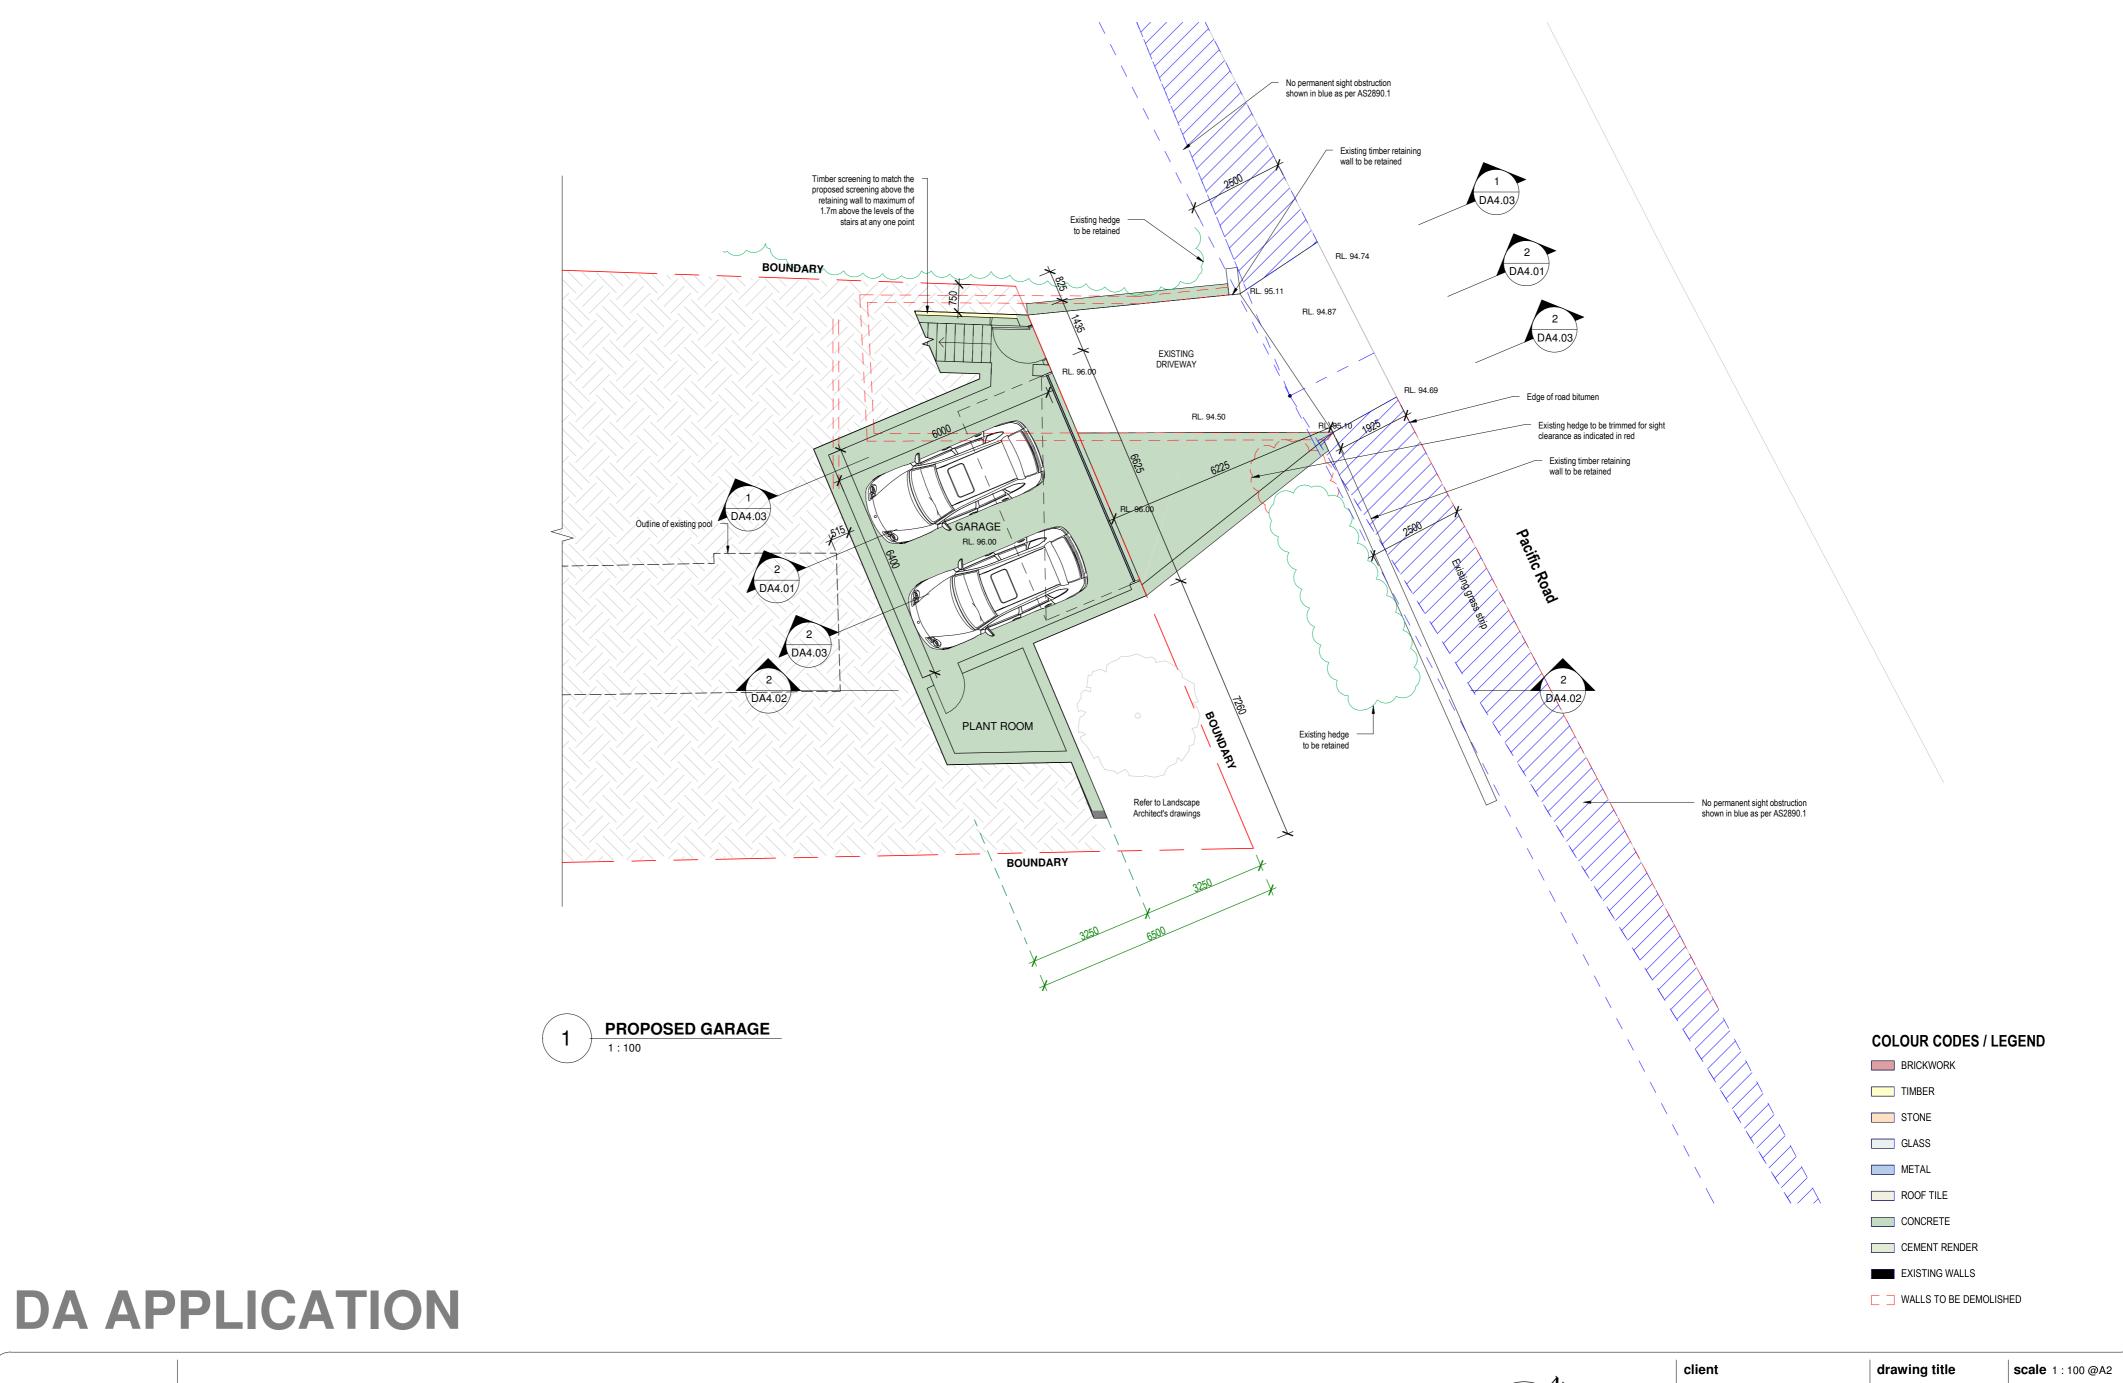

notes:
- do not scale from drawings.
- all dimensions are to be check measured onsite prior to commencement of work.
- written dimensions take precedence.
- this document is copyright and the property of the property of the author, and must not be retained, copied in whole or part.

driveway sight clearance additional information driveway sections issue for DA Description 20.10.2022


20.10.2022
27.09.2022
09.08.2022
01.07.2022
Date

Rev.

#### design studio group



			_
client	drawing title	<b>scale</b> 1:10	0 @A2
Anna & Niall Lenahan	Proposed garage plan	date Dec 2	2021
project	drawing no.	revision	drawn KL
123 Bynya Road, Palm Beach NSW 2108 - DP 572887	DA2.01	D	job ref. PB 2021

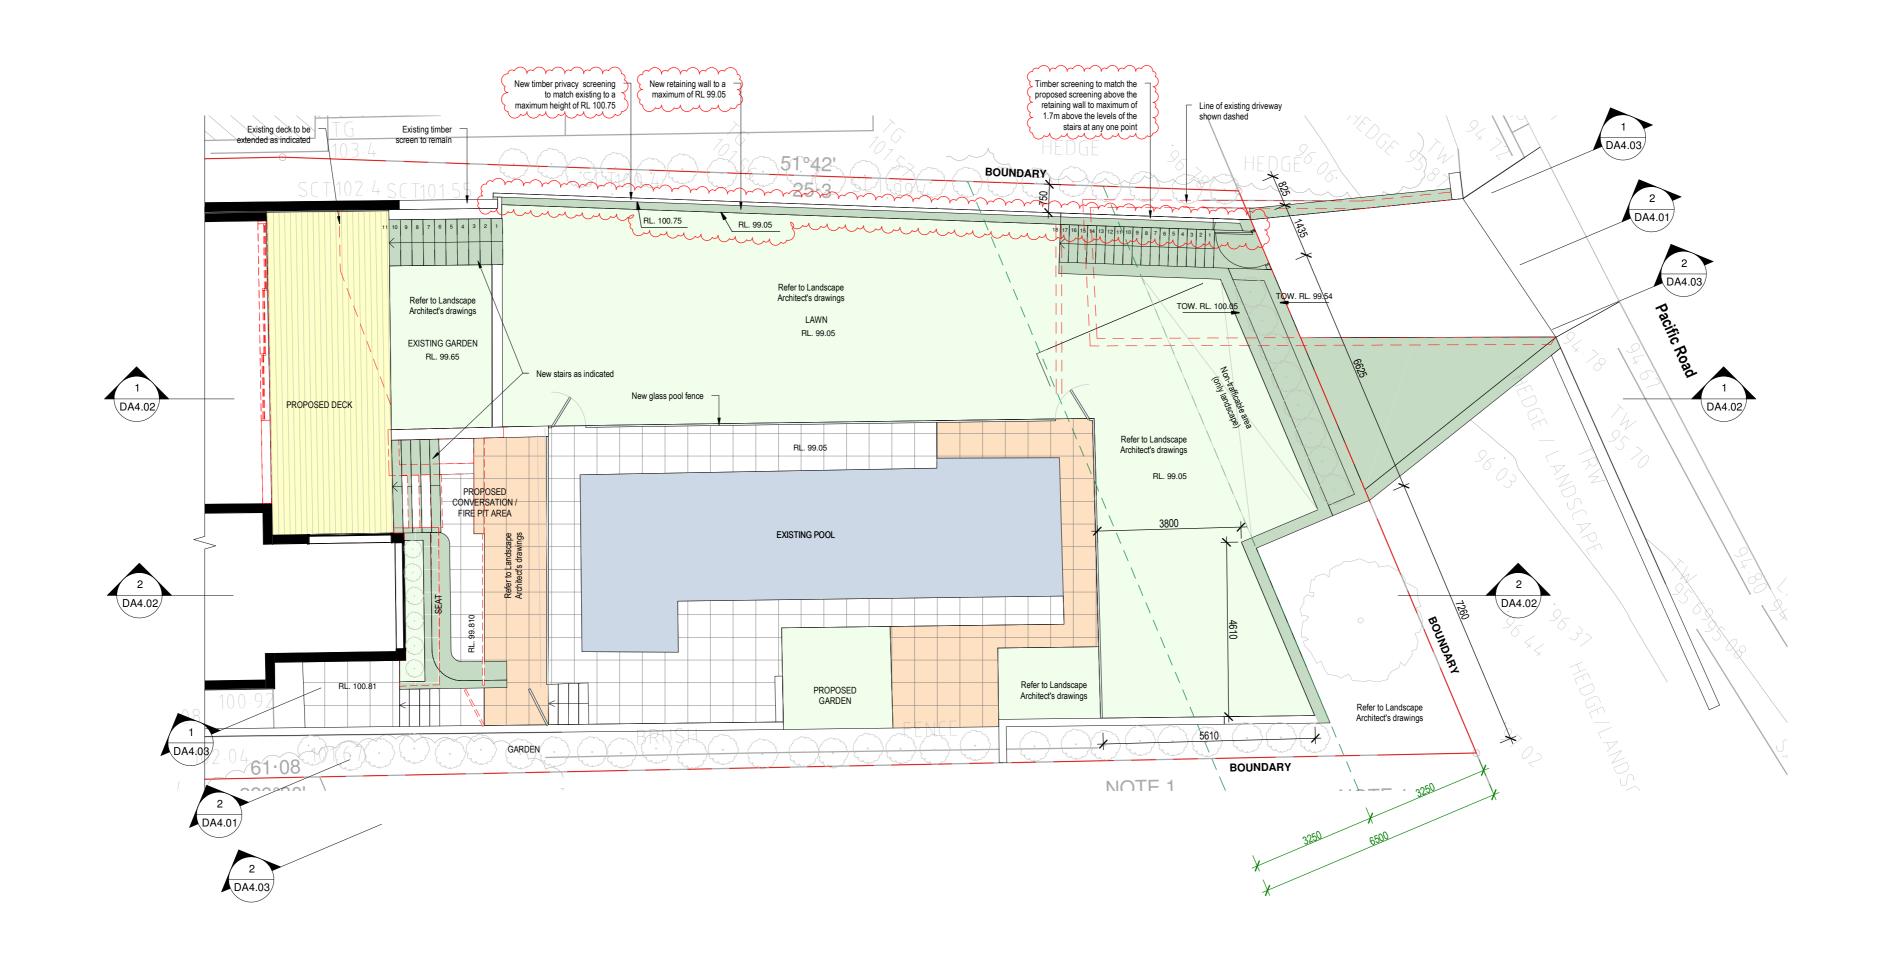



Rev.

notes:
- do not scale from drawings.
- all dimensions are to be check measured onsite prior to commencement of work.
- written dimensions take precedence.
- this document is copyright and the property of the property of the author, and must not be retained, copied in whole or part.

27.09.2022 additional information issue for DA 01.07.2022 Description Date

design studio group

a: suite 5, 706 military road mosman nsw 2088 e: info@designstudiogroup.com.au ph: 0421062266 NSW ARB #7988 www.designstudiogroup.com.au



_					
	client	drawing title	<b>scale</b> 1:100@A2		
	Anna & Niall Lenahan	Proposed lower ground plan	date Dec 2	2021	
	project	drawing no.	revision	drawn KL	
	123 Bynya Road, Palm Beach NSW 2108 - DP 572887	DA2.02	В	job ref. PB 2021	

**COLOUR CODES / LEGEND** 

BRICKWORK

TIMBER

STONE


METAL


ROOF TILE CONCRETE


CEMENT RENDER EXISTING WALLS


☐ ☐ WALLS TO BE DEMOLISHED


PB 2021

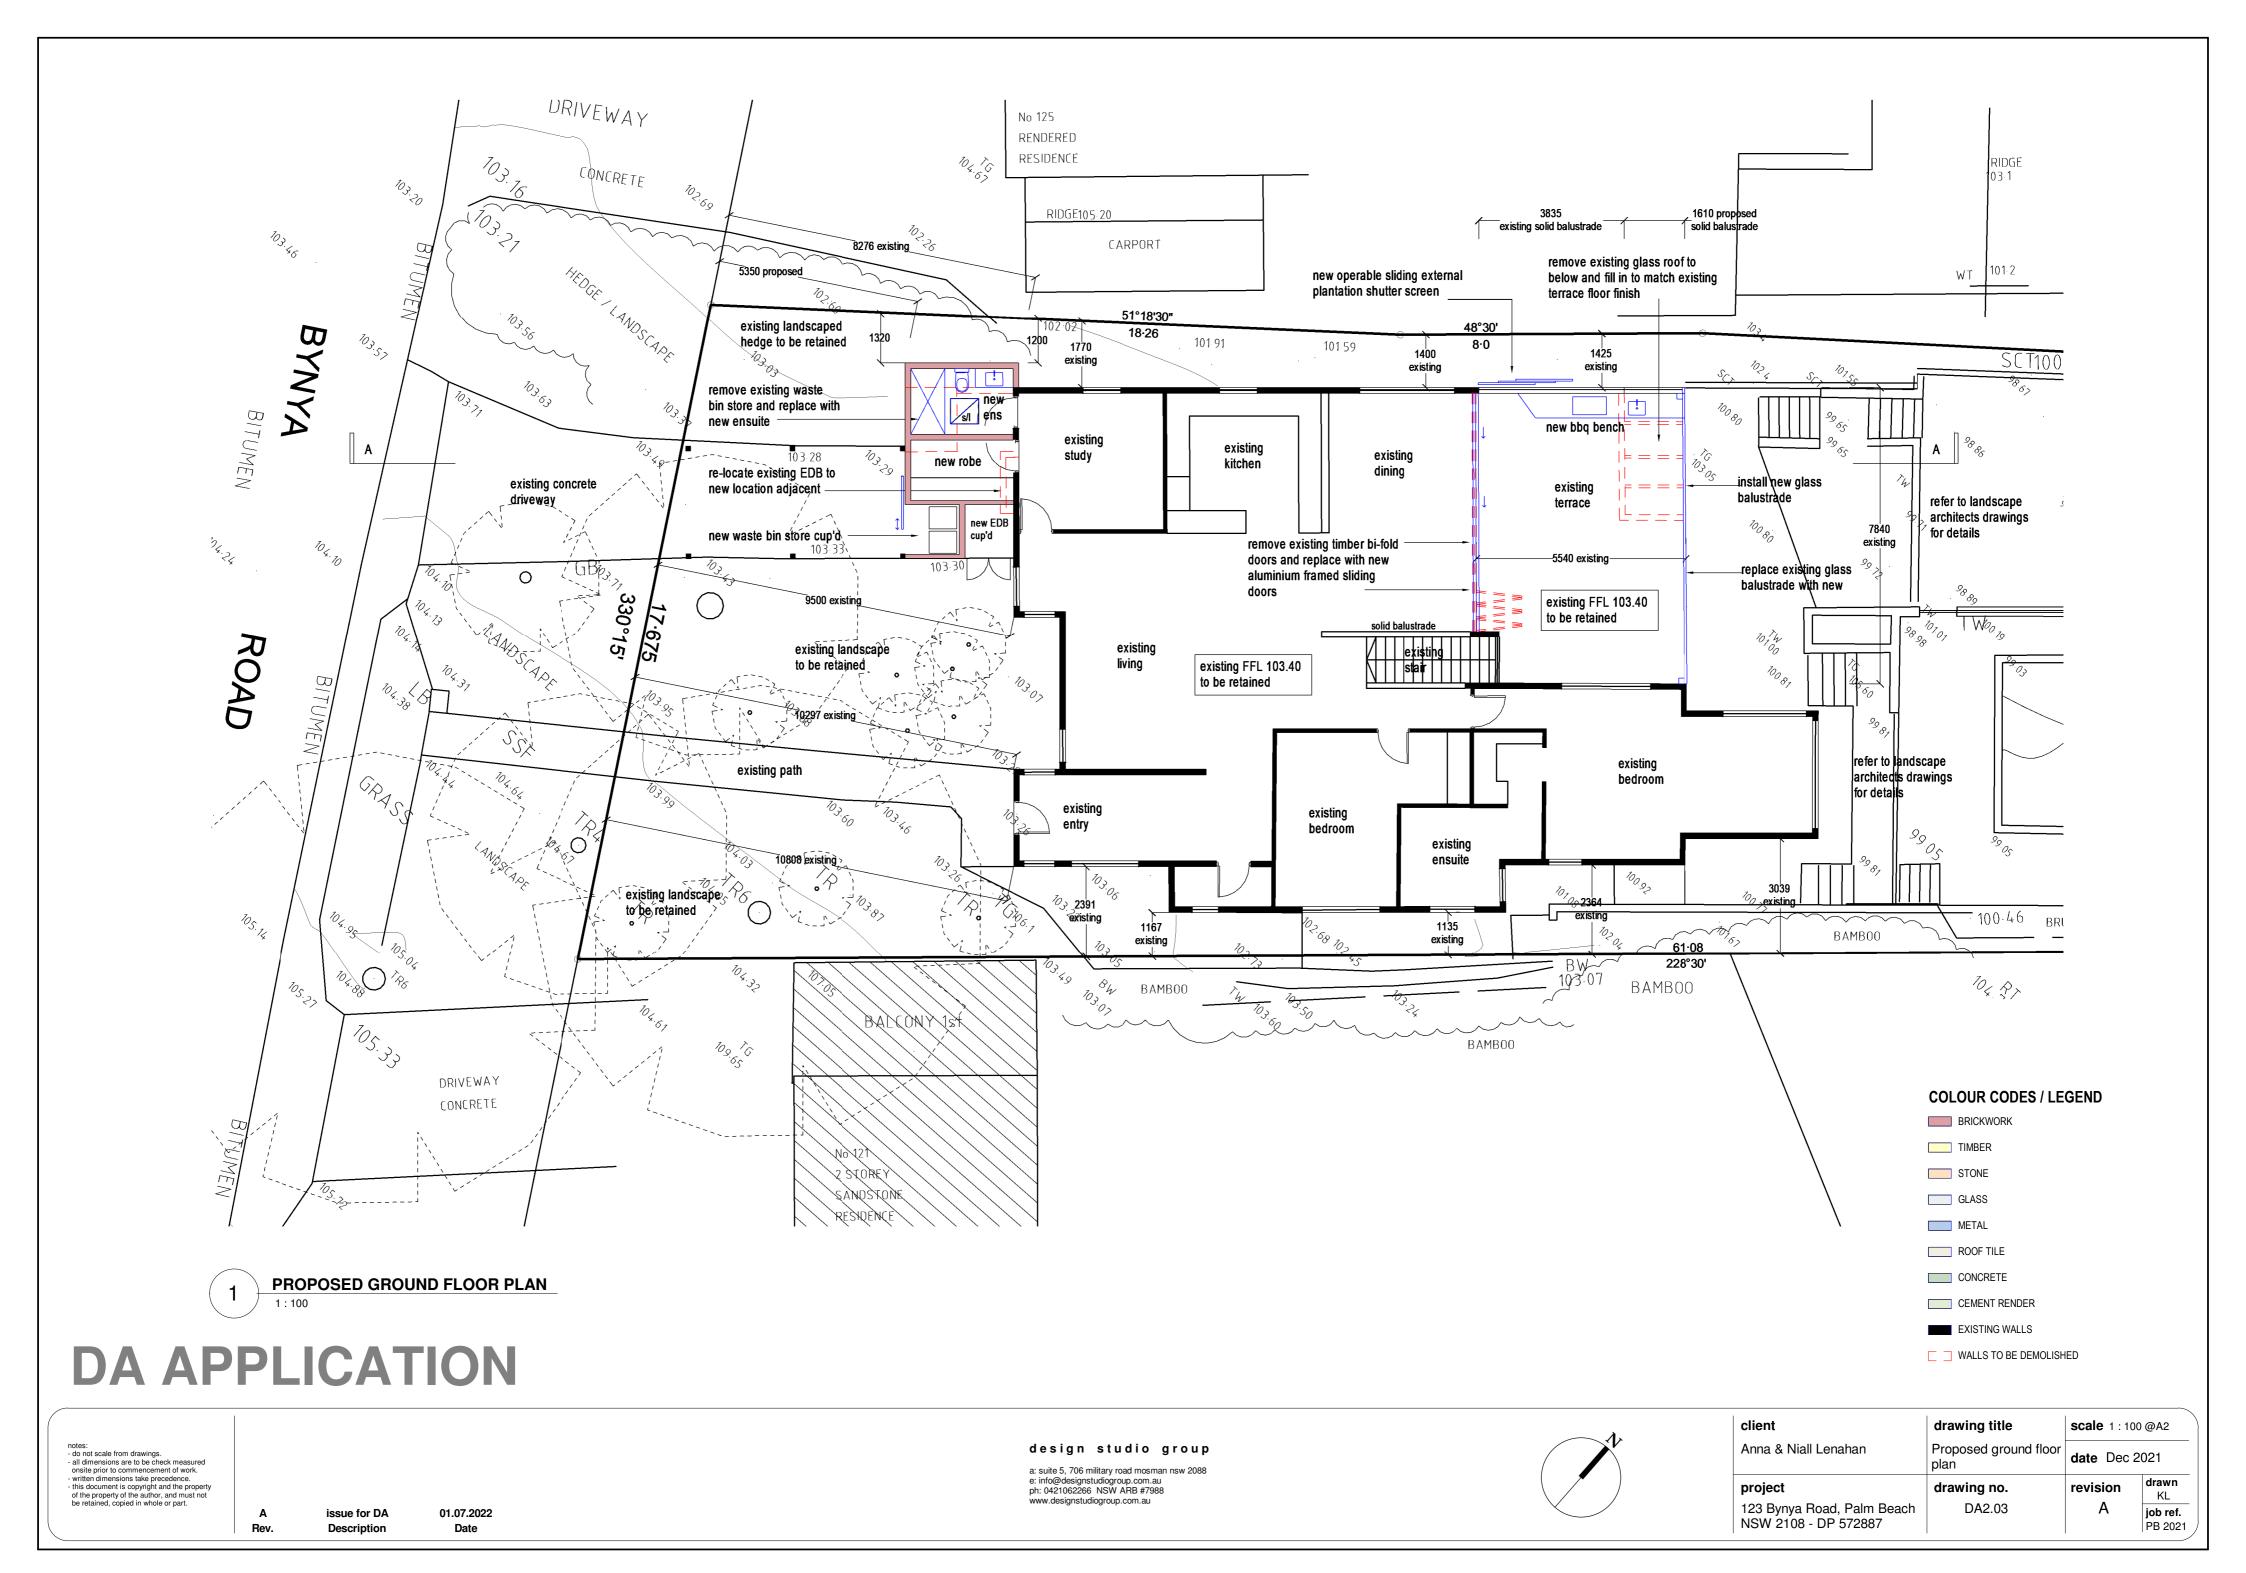

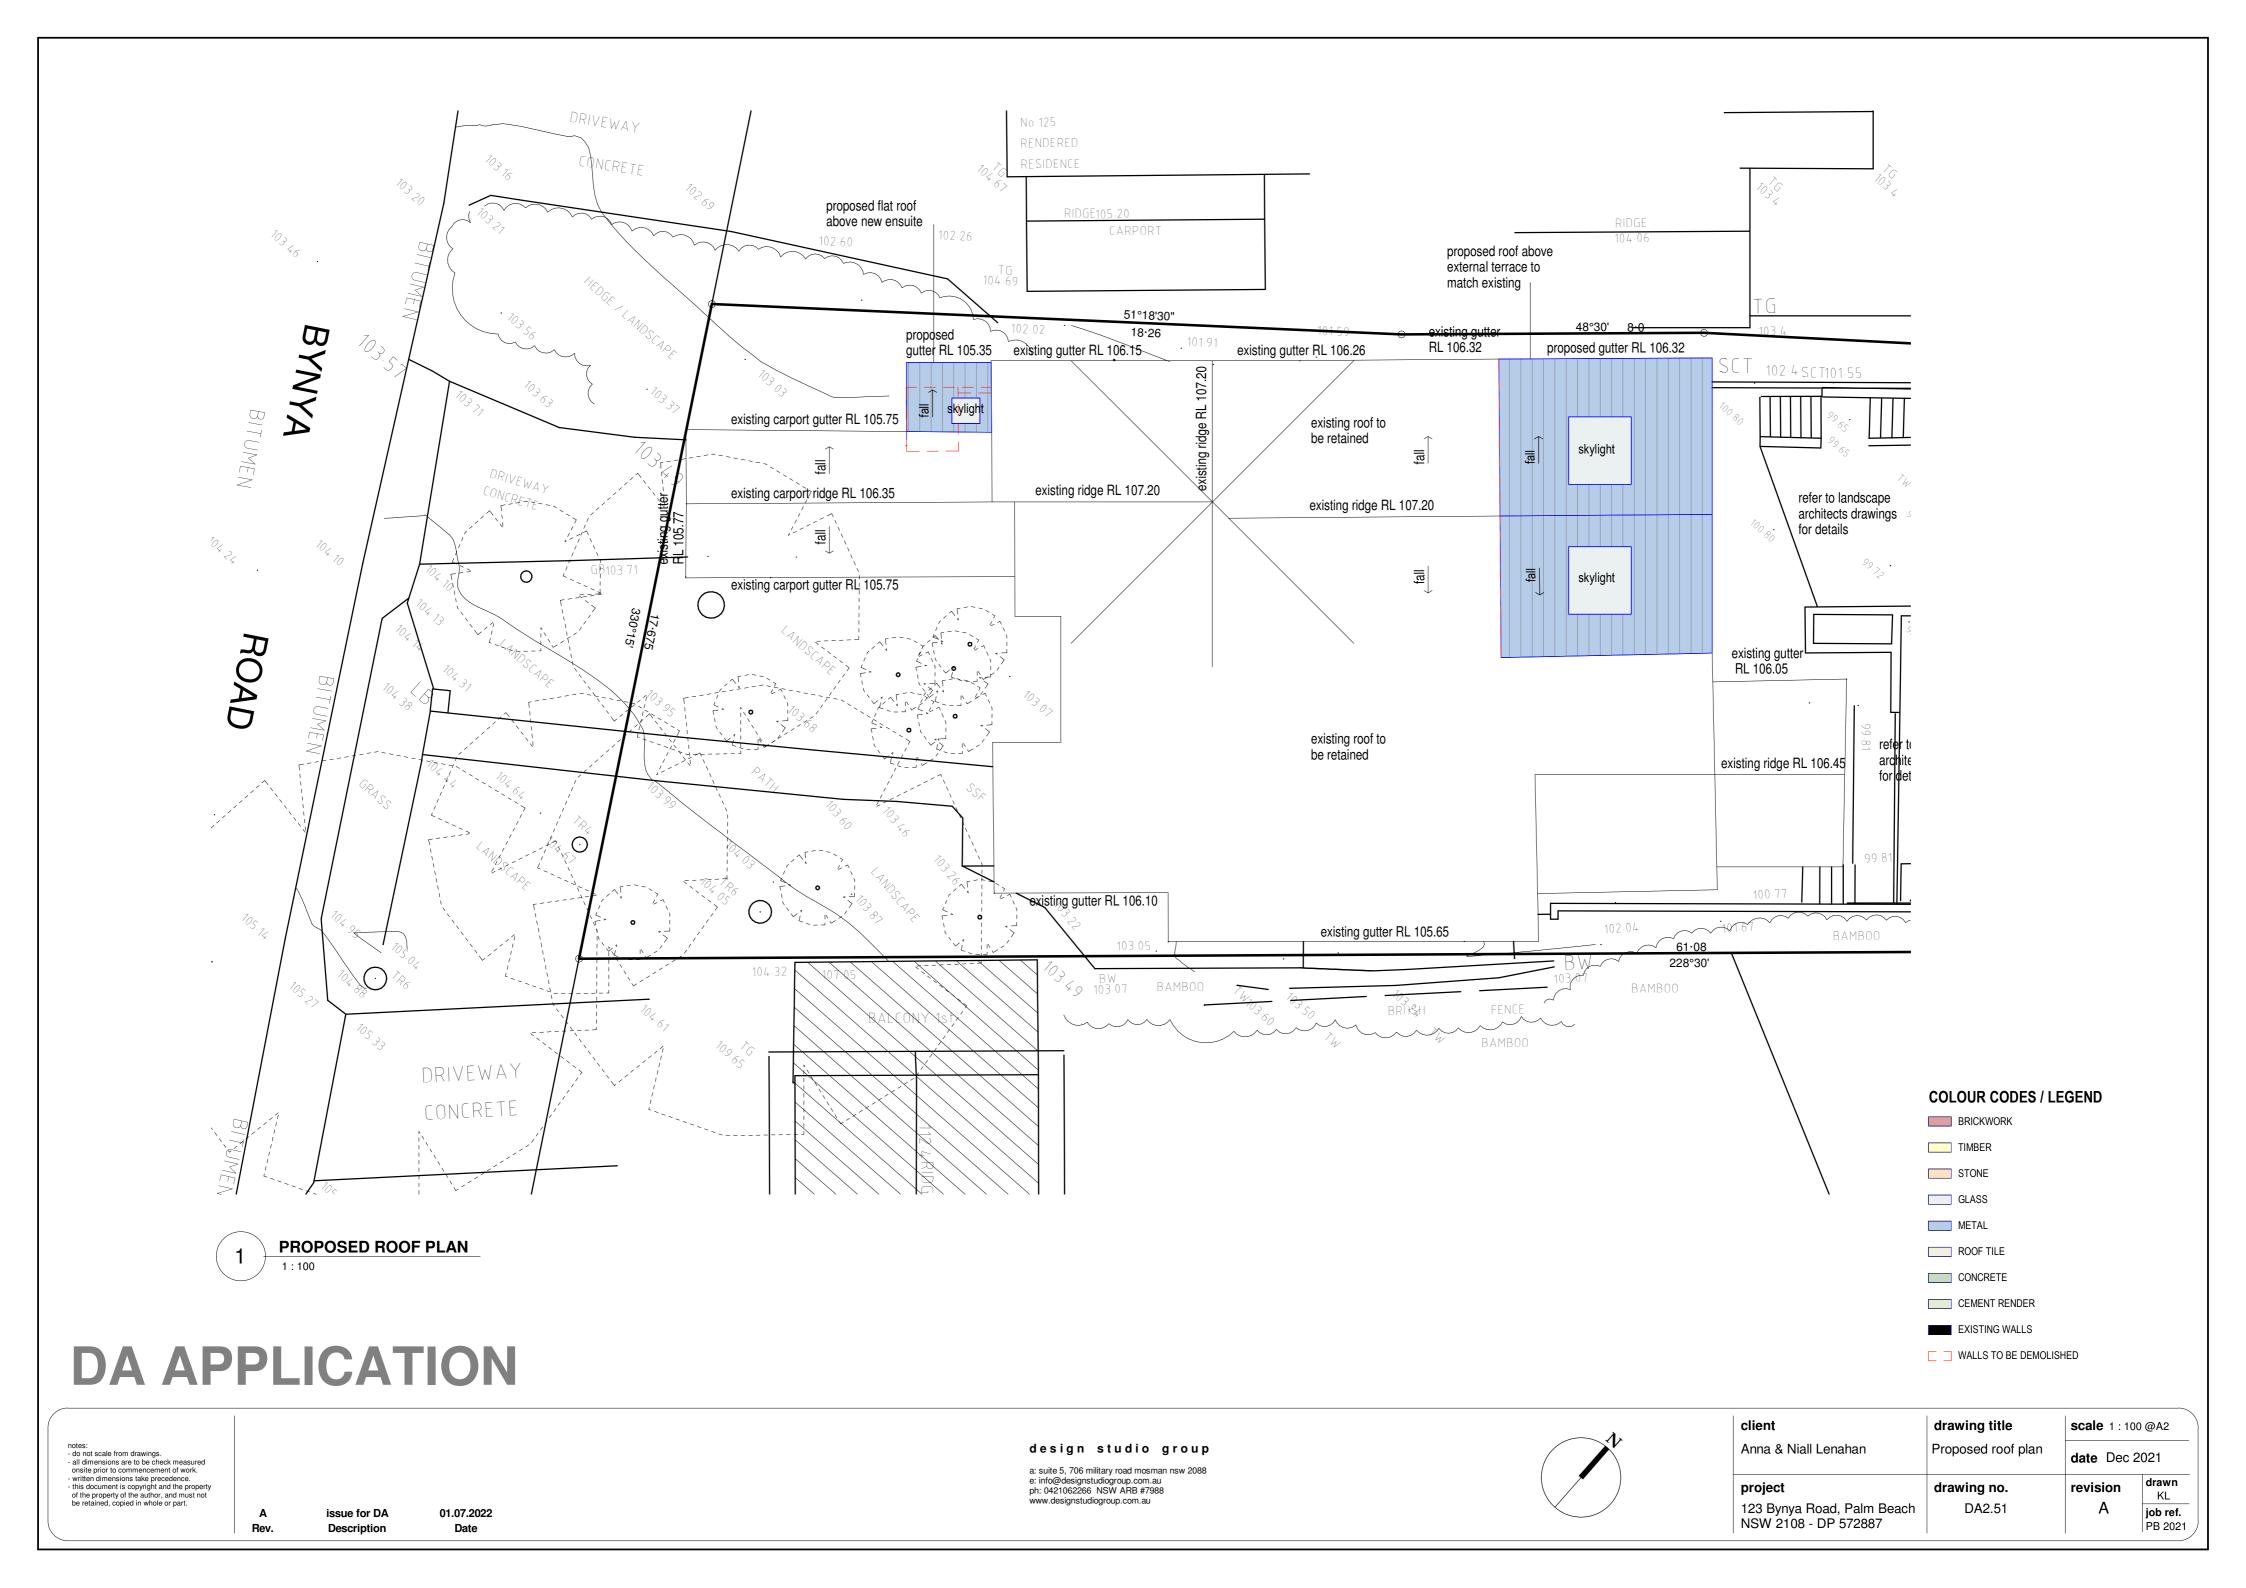

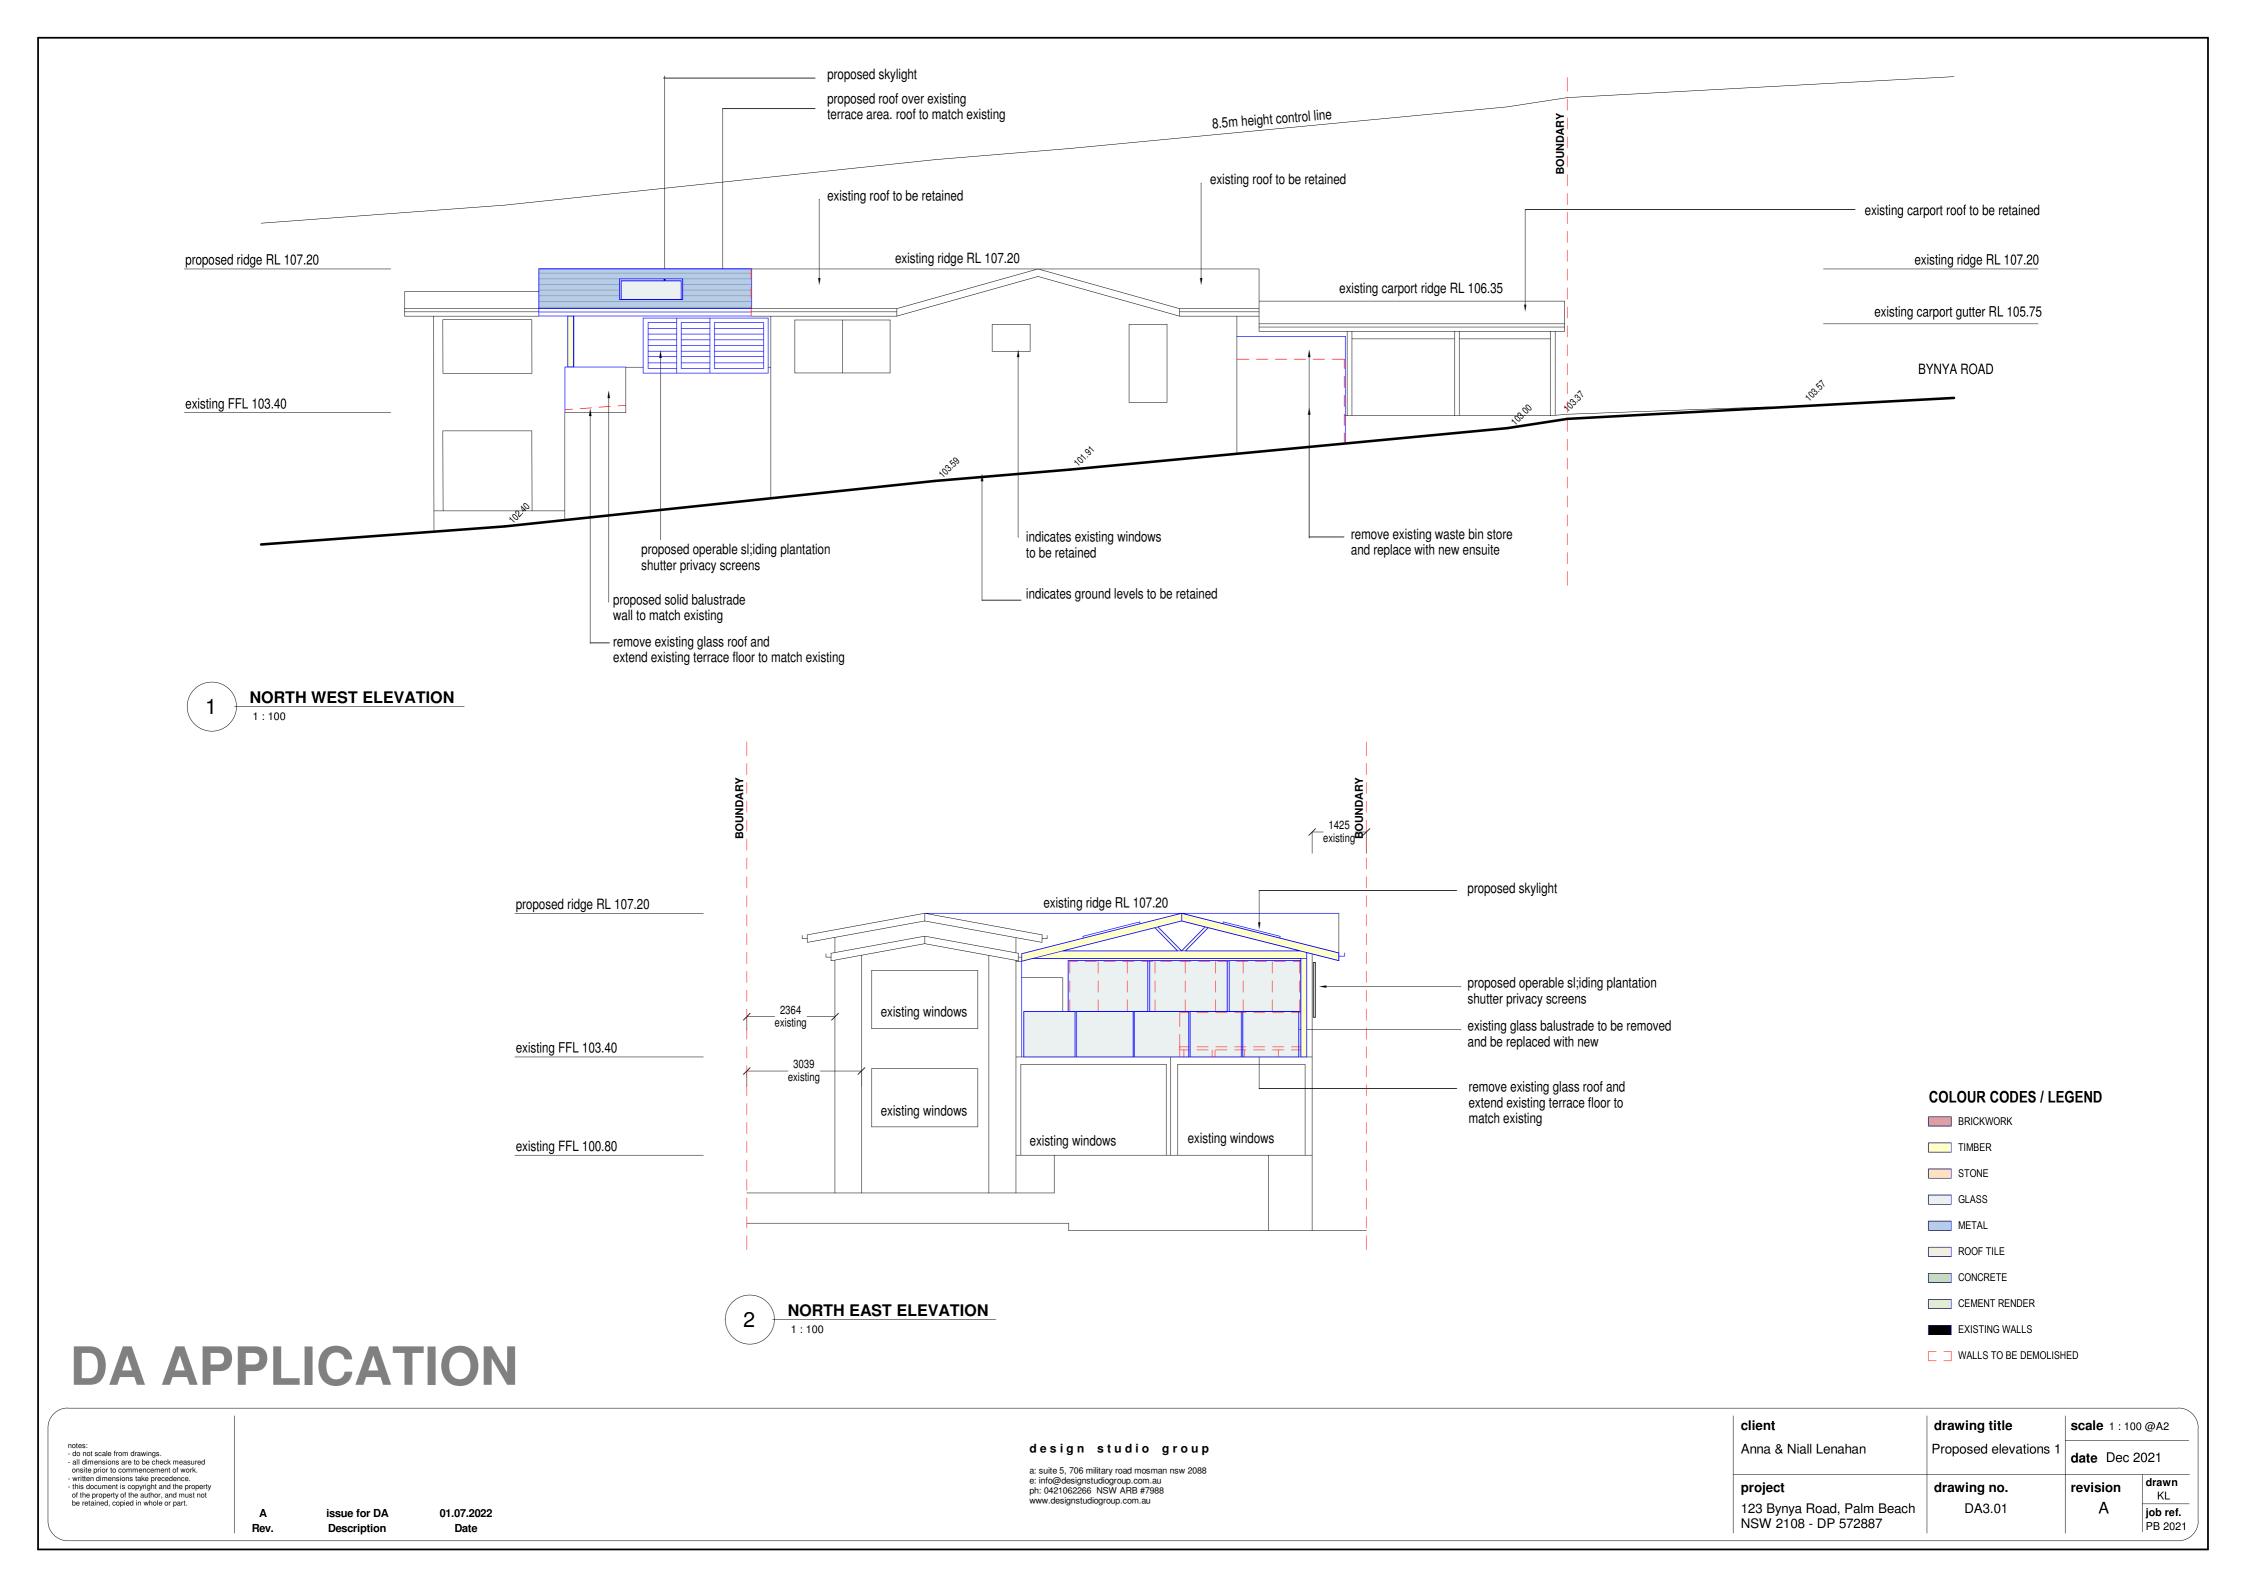

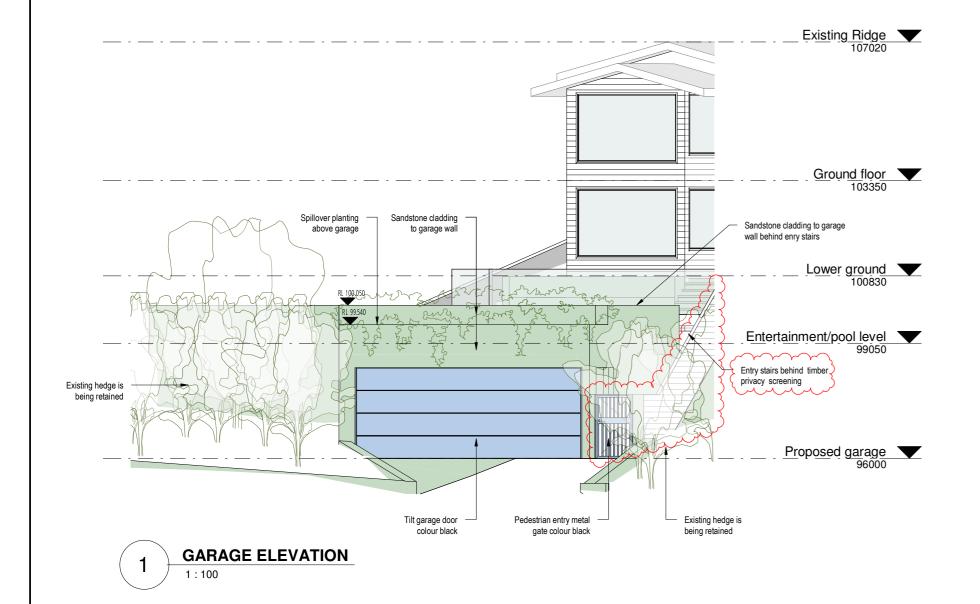

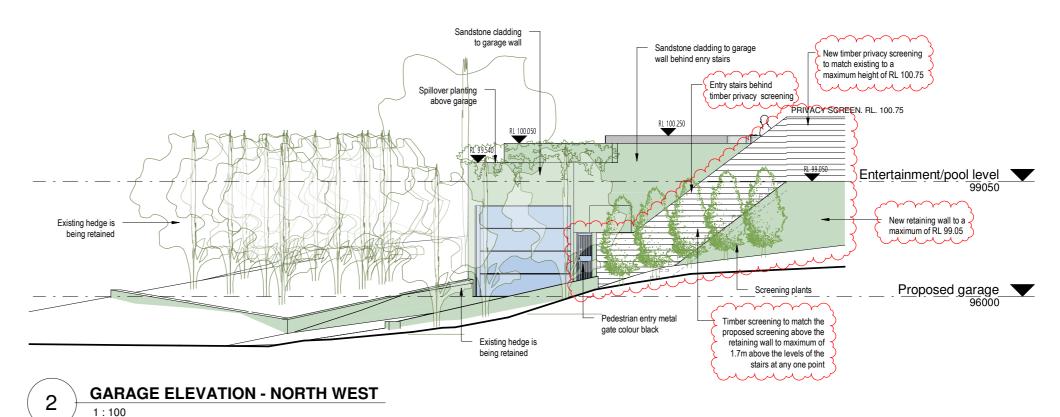

Entertainment/pool level 99050 Sandstone cladding to garage wall Proposed garage 96000

GARAGE ELEVATION - SOUTH EAST 1:100

### **DA APPLICATION**

notes:
- do not scale from drawings.
- all dimensions are to be check measured onsite prior to commencement of work.
- written dimensions take precedence.
- this document is copyright and the property of the property of the author, and must not be retained, copied in whole or part.

additional information 27.09.2022 request of further information 18.08.2022 issue for DA 01.07.2022 Rev. Description Date

a: suite 5, 706 military road mosman nsw 2088 e: info@designstudiogroup.com.au ph: 0421062266 NSW ARB #7988 www.designstudiogroup.com.au

client	drawing title	scale 1:100@A2		
Anna & Niall Lenahan	Proposed elevations 2	date Dec 2021		
project 123 Bynya Road, Palm Beach	drawing no. DA3.02	revision C	drawn KL job ref.	
NSW 2108 - DP 572887			PB 2021	

**COLOUR CODES / LEGEND** BRICKWORK

TIMBER STONE

METAL


ROOF TILE

CONCRETE CEMENT RENDER


**EXISTING WALLS** 


☐ ☐ WALLS TO BE DEMOLISHED

design studio group

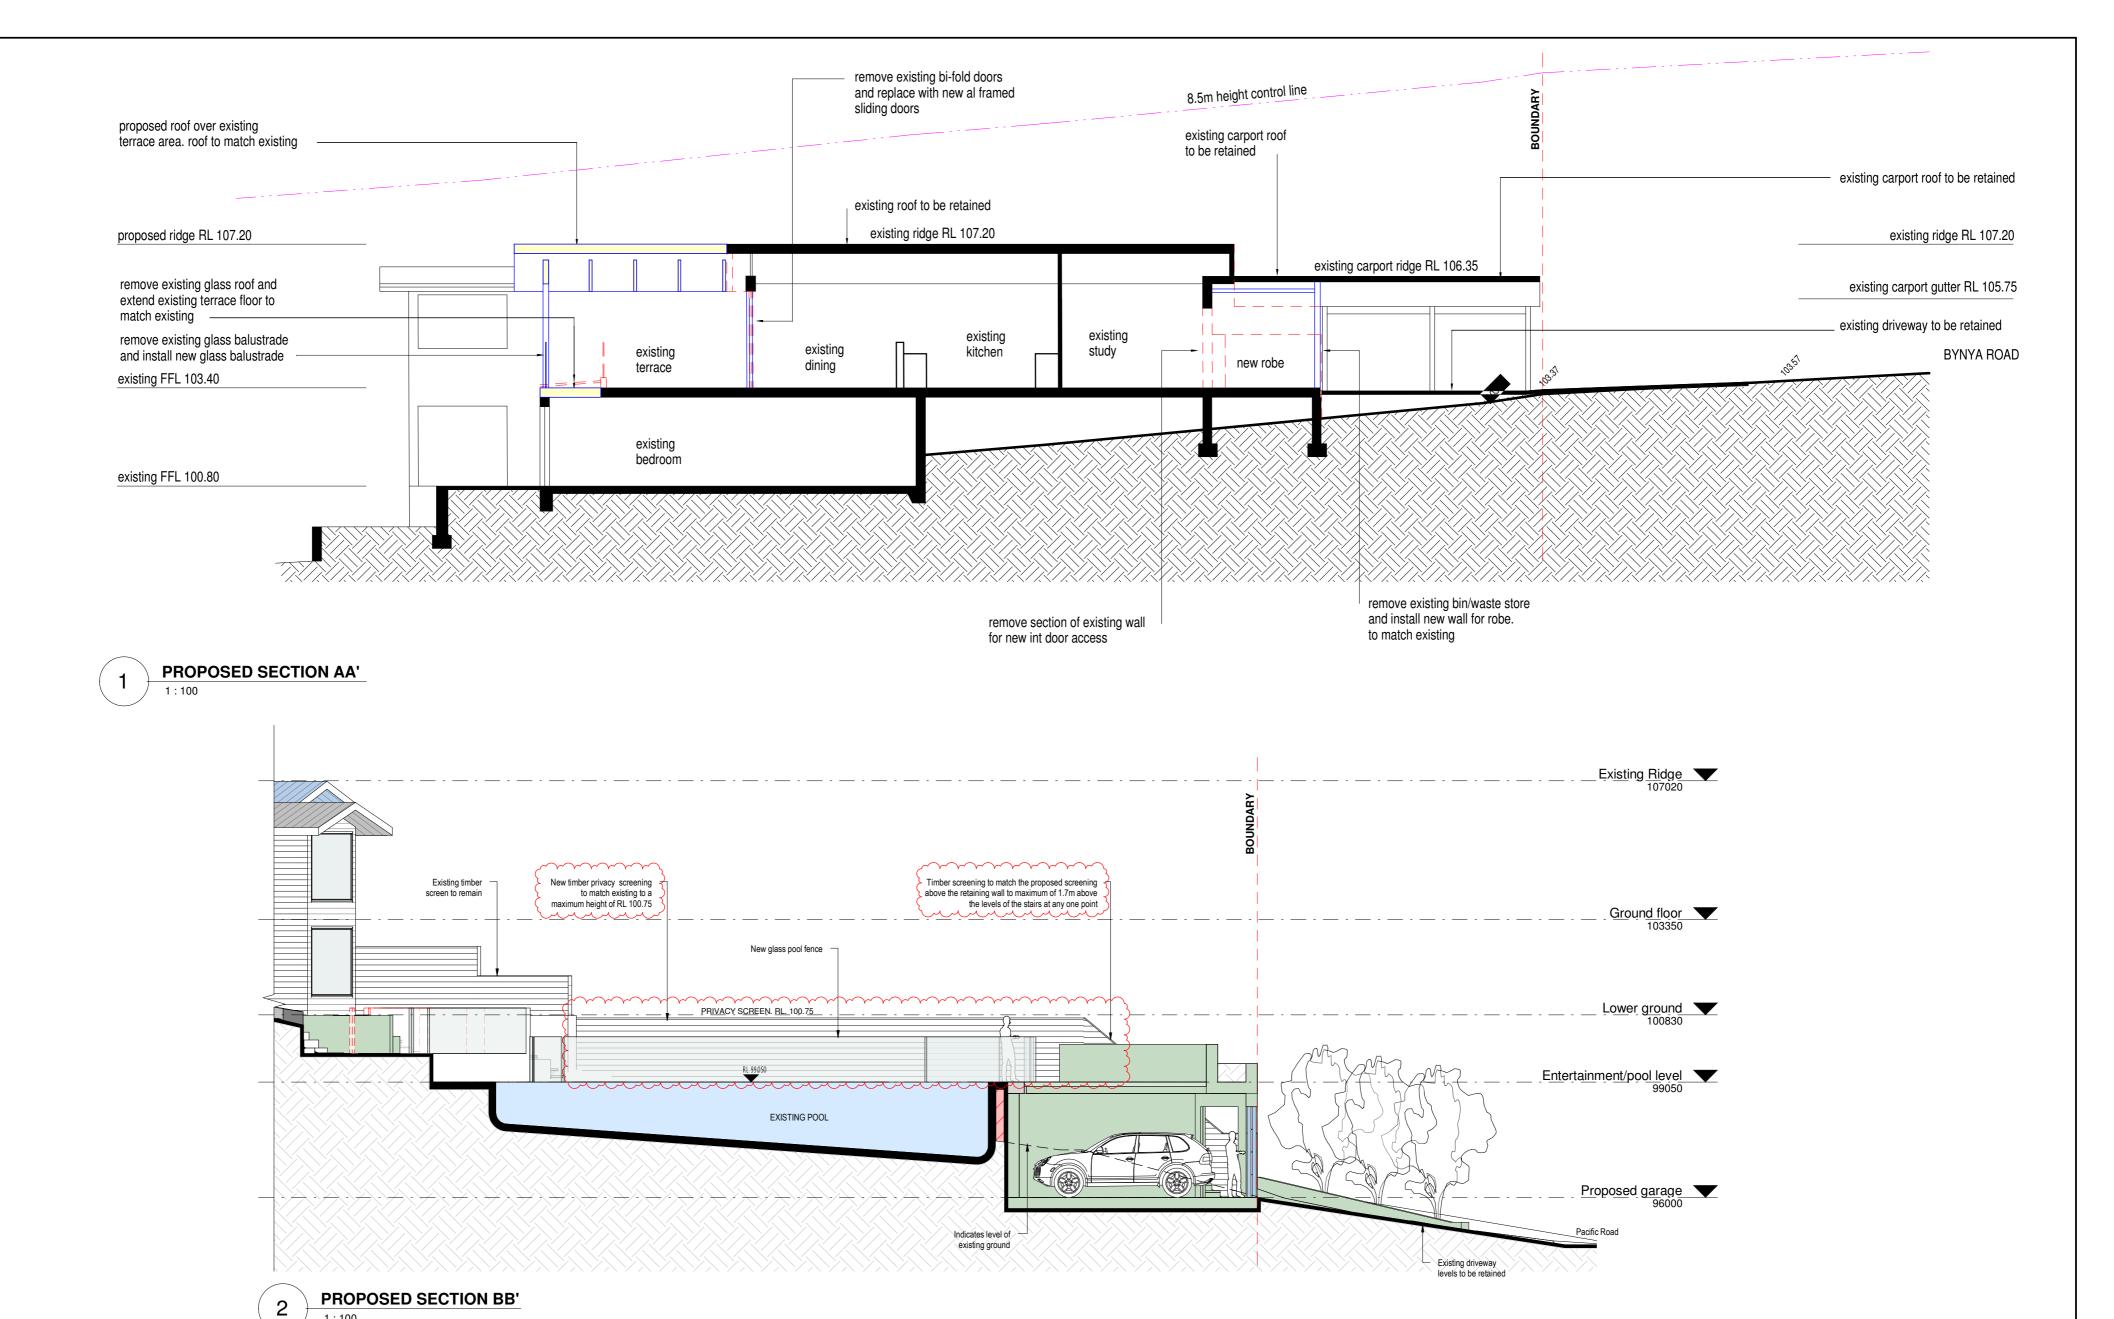


client drawing title scale 1:100@A2 notes:
- do not scale from drawings.
- all dimensions are to be check measured onsite prior to commencement of work.
- written dimensions take precedence.
- this document is copyright and the property of the property of the property of the author, and must not be retained, copied in whole or part. Anna & Niall Lenahan design studio group Proposed sections 1 date Dec 2021 a: suite 5, 706 military road mosman nsw 2088 e: info@designstudiogroup.com.au ph: 0421062266 NSW ARB #7988 www.designstudiogroup.com.au drawn revision drawing no. project KL 27.09.2022 additional information 123 Bynya Road, Palm Beach NSW 2108 - DP 572887 DA4.01 issue for DA 01.07.2022 job ref. PB 2021 Rev. Description Date

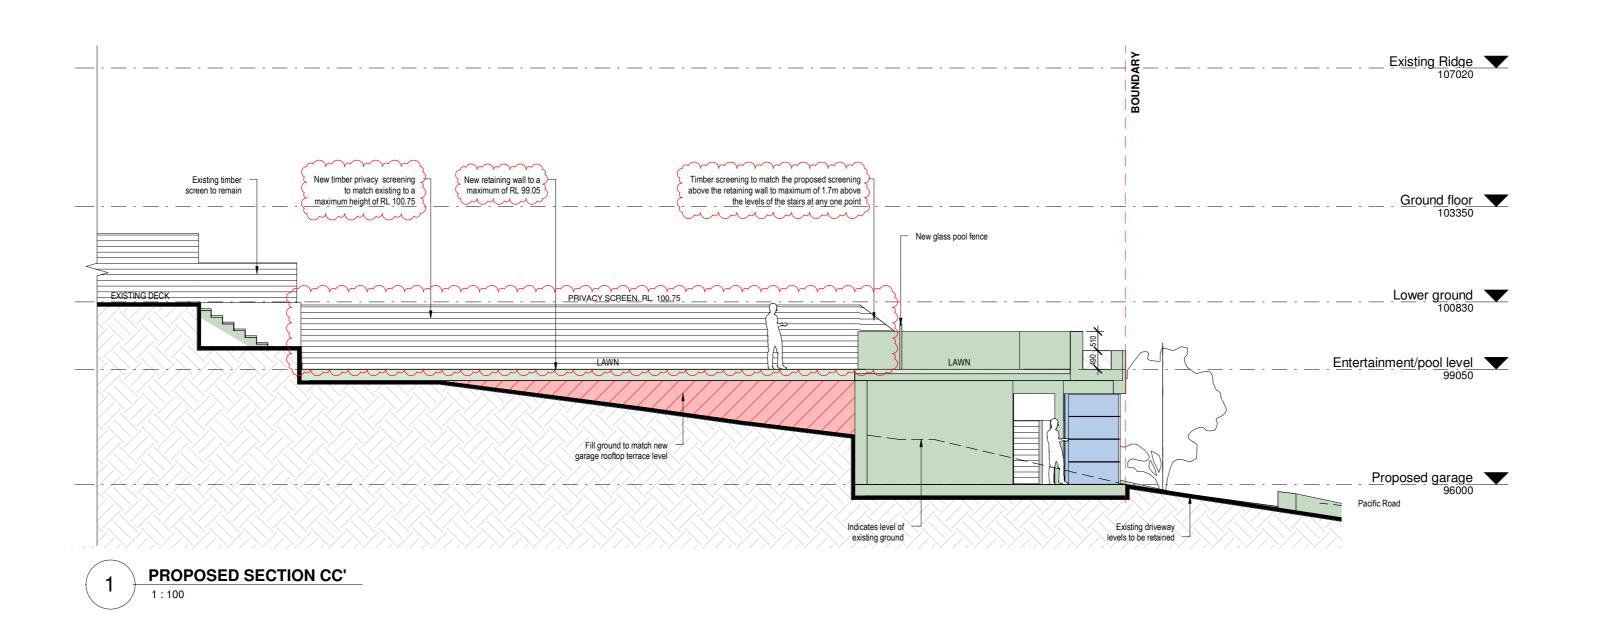


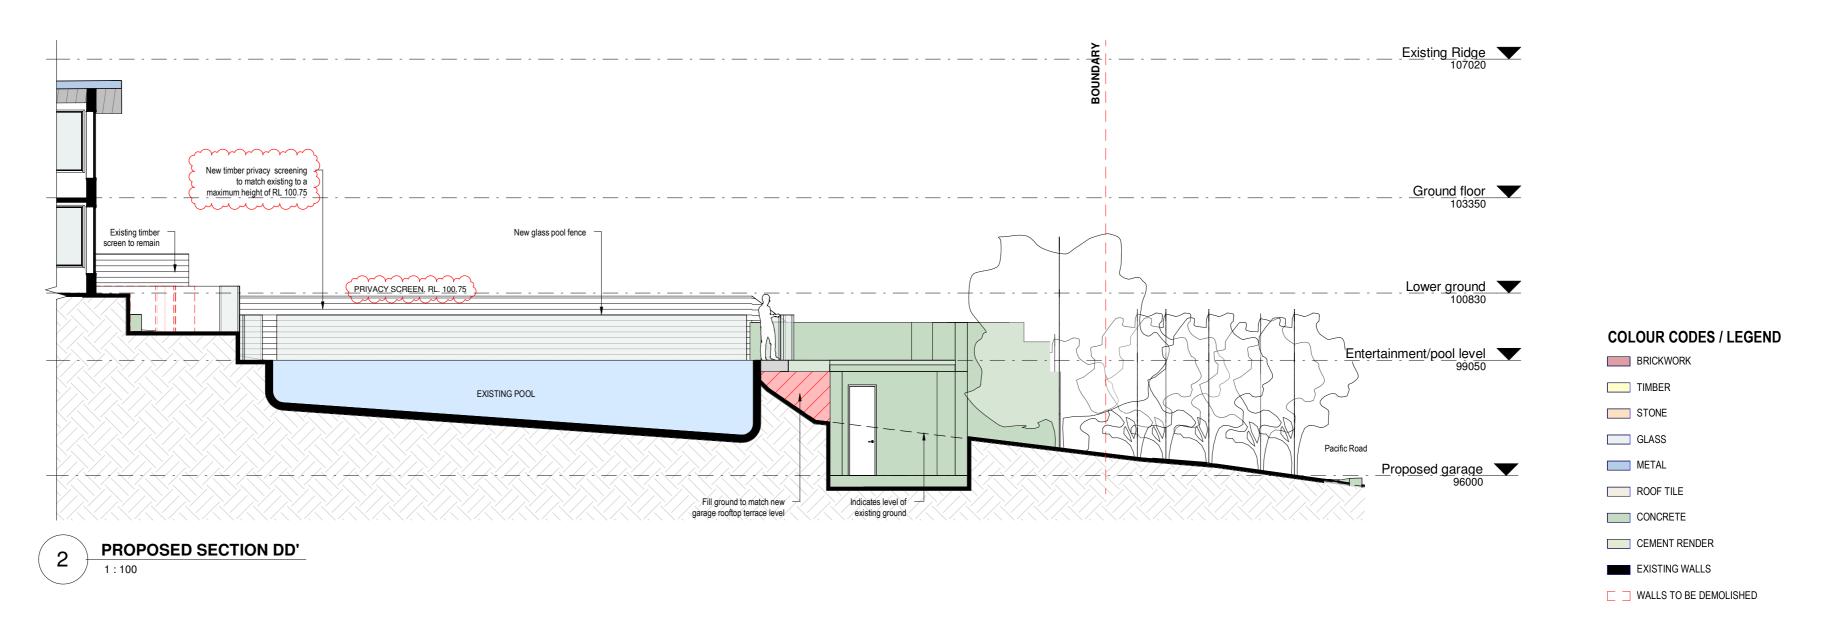

client drawing title scale 1:100@A2 notes:
- do not scale from drawings.
- all dimensions are to be check measured onsite prior to commencement of work.
- written dimensions take precedence.
- this document is copyright and the property of the property of the author, and must not be retained, copied in whole or part. design studio group Anna & Niall Lenahan Proposed sections 2 date Dec 2021 a: suite 5, 706 military road mosman nsw 2088 e: info@designstudiogroup.com.au ph: 0421062266 NSW ARB #7988 www.designstudiogroup.com.au drawn revision drawing no. project KL 27.09.2022 additional information 123 Bynya Road, Palm Beach NSW 2108 - DP 572887 В DA4.02 issue for DA 01.07.2022 job ref. PB 2021 Rev. Description Date

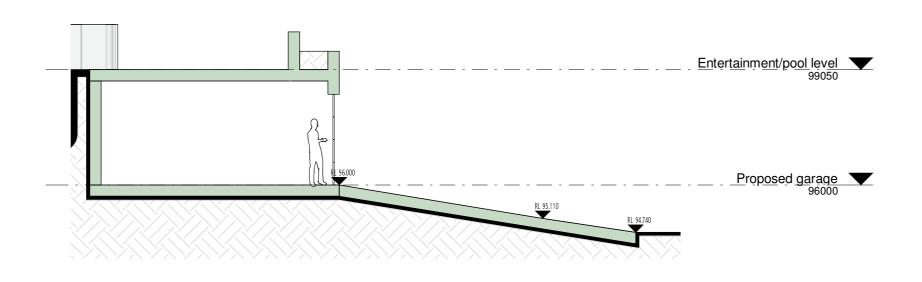

1 PROPOSED DRIVEWAY SECTION BB'1

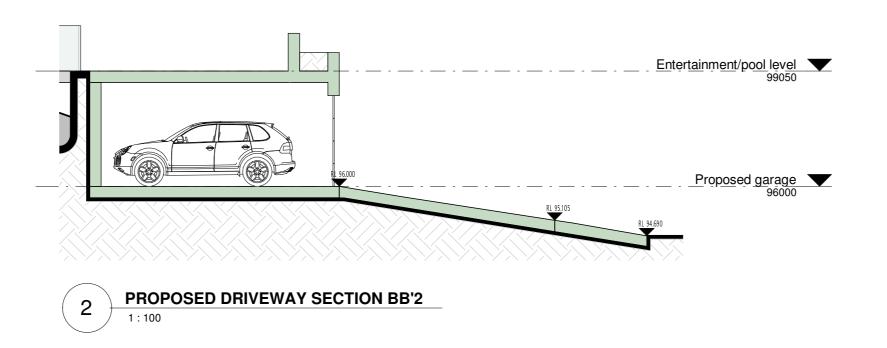

## **DA APPLICATION**

notes:
- do not scale from drawings.
- all dimensions are to be check measured onsite prior to commencement of work.
- written dimensions take precedence.
- this document is copyright and the property of the property of the author, and must not be retained, copied in whole or part.

A Rev.

driveway sections


Description

09.08.2022


Date

design studio group

client	drawing title	scale 1:100@A2		
Anna & Niall Lenahan	Proposed driveway section detail	date Dec 2021		
project	drawing no.	revision	drawn Author	
123 Bynya Road, Palm Beach NSW 2108 - DP 572887	DA4.03	Α	job ref. PB 2021	

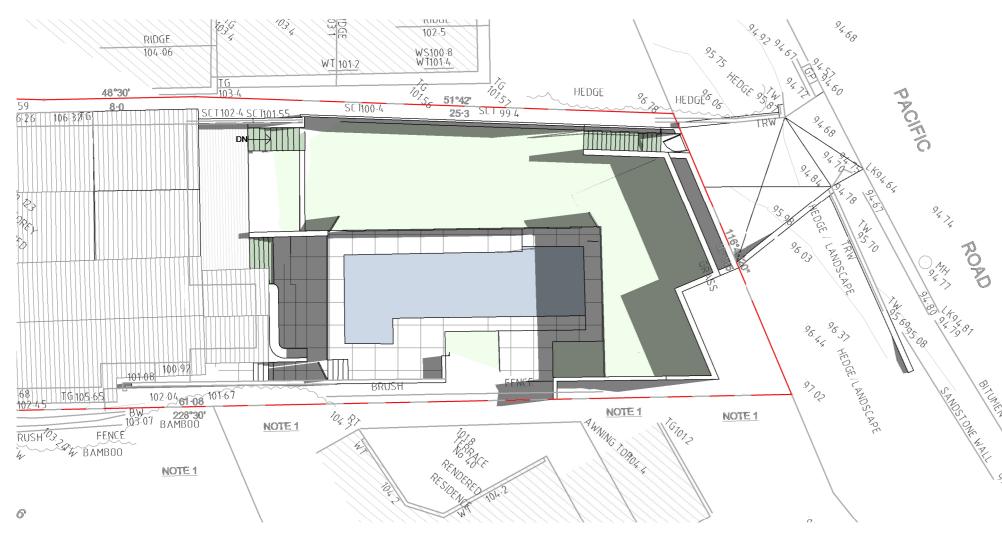

PROPOSED SHADOW DIAGRAM - 21st JUNE 9AM

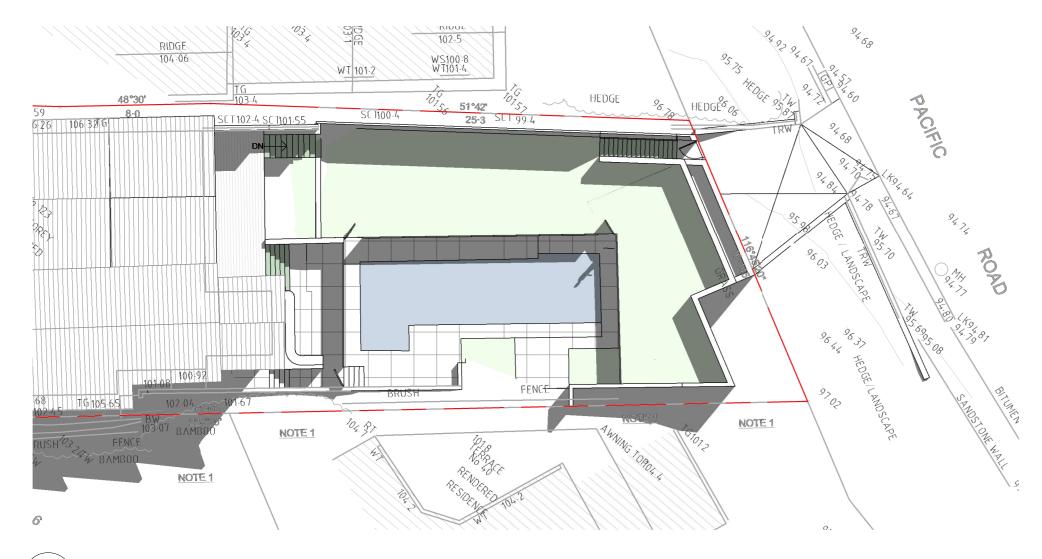

PROPOSED SHADOW DIAGRAM - 21st JUNE 3PM

### PROPOSED SHADOW DIAGRAM - 21st JUNE 12PM

## **DA APPLICATION**

Rev.

notes:
- do not scale from drawings.
- all dimensions are to be check measured onsite prior to commencement of work.
- written dimensions take precedence.
- this document is copyright and the property of the property of the author, and must not be retained, copied in whole or part.


issue for DA

Description

01.07.2022

Date


design studio group

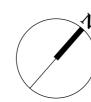

client Anna & Niall Lenahan	drawing title Shadow diagrams	scale 1:200@A2 date Dec 2021	
project 123 Bynya Road, Palm Beach NSW 2108 - DP 572887	drawing no. DA5.01	revision A	drawn KL job ref. PB 2021






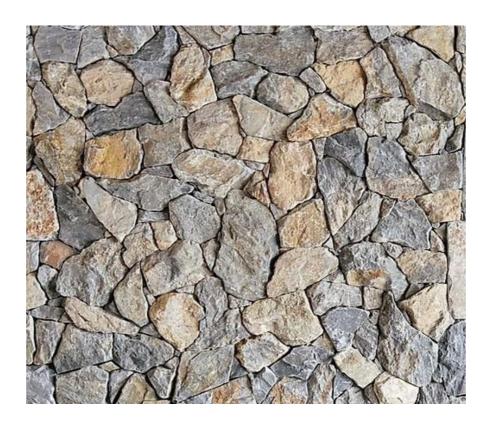

Fire place feature wall Natural stone wall cladding



Timber deck

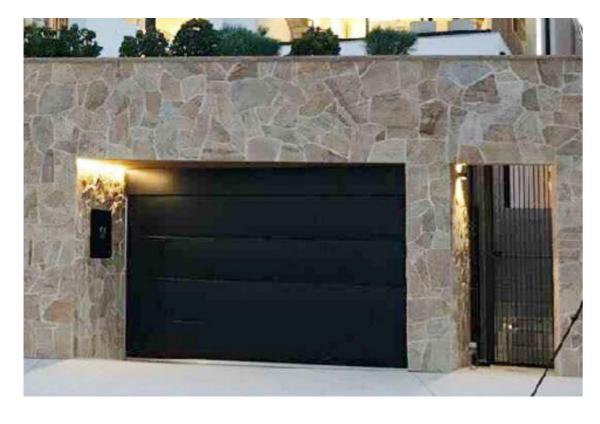

Sandstone to garage wall



Grey render to match existing

notes:
- do not scale from drawings.
- all dimensions are to be check measured onsite prior to commencement of work.
- written dimensions take precedence.
- this document is copyright and the property of the property of the author, and must not be retained, copied in whole or part.


Rev.

issue for DA Description

01.07.2022 Date

#### design studio group


client Anna & Niall Lenahan	drawing title External finishes	scale @A2 date Dec 2021	
project 123 Bynya Road, Palm Beach NSW 2108 - DP 572887	drawing no. DA7.01	revision A	drawn KL job ref. PB 2021

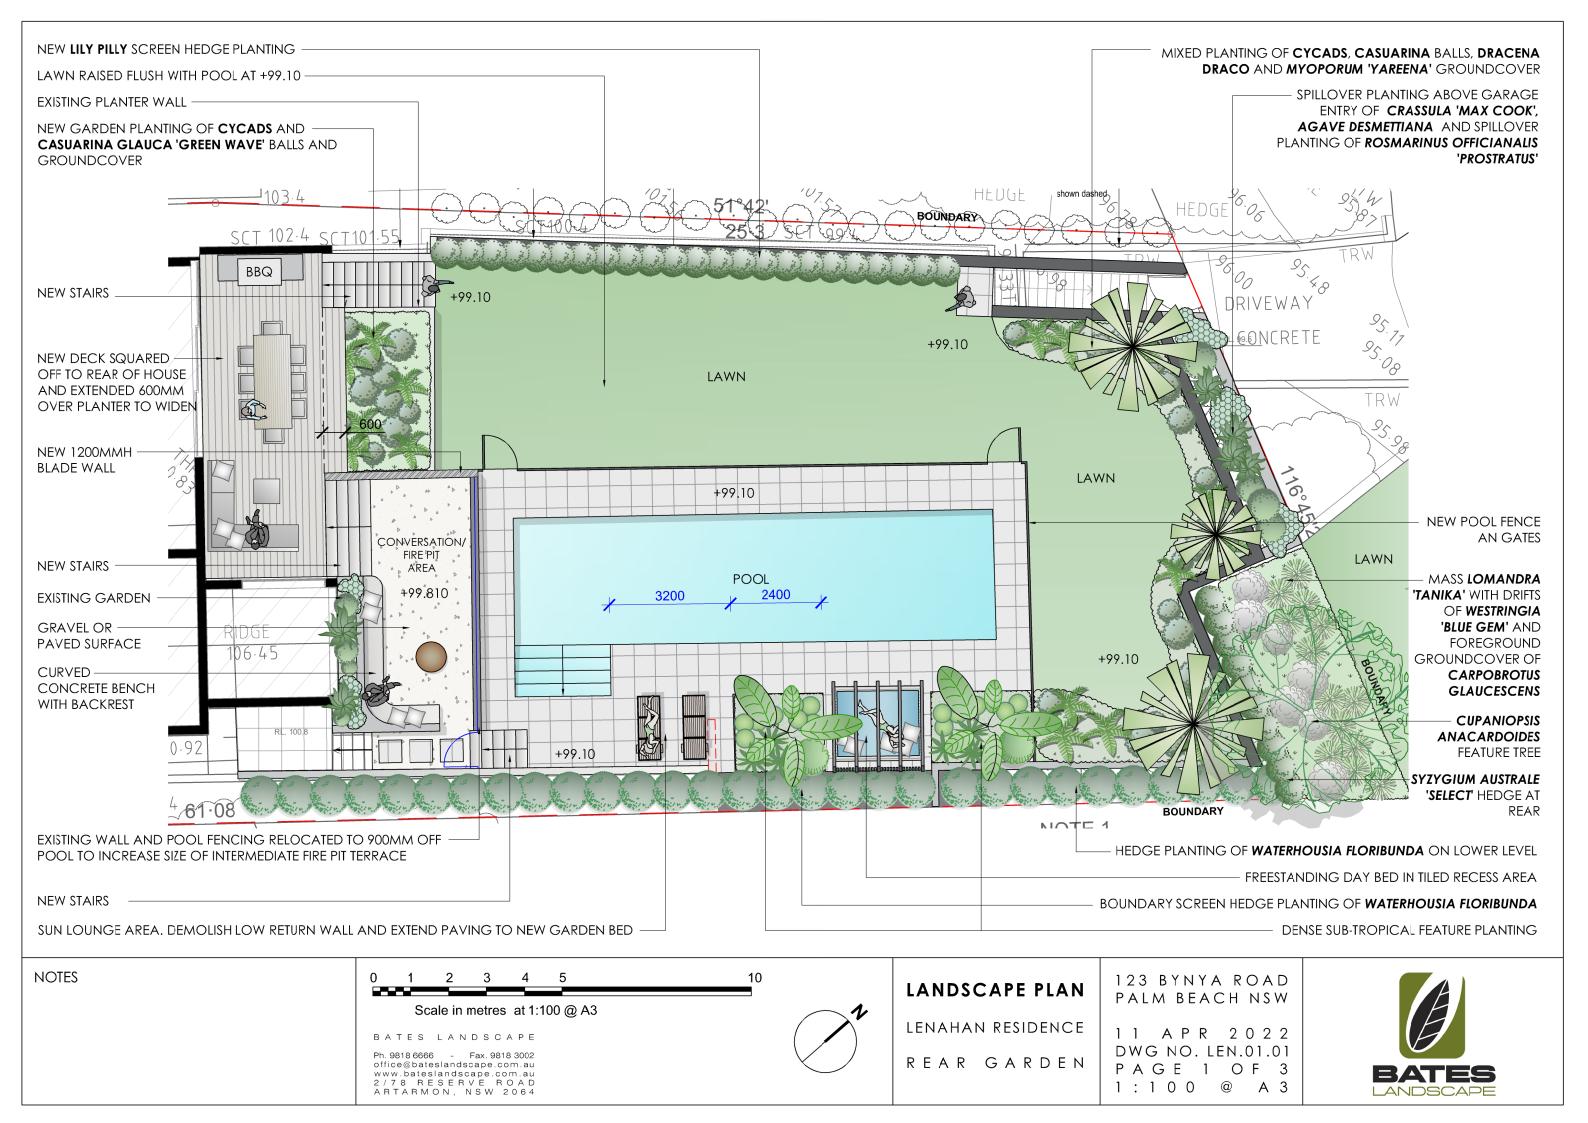

#### **PLANT SCHEDULE**

NOTES

SYMBOL	QTY	BOTANICAL NAME	COMMON NAME	POT SIZE	MATURE SIZE	SPACING
紫	6	Agave desmettiana 'El Mirador's Gold'	Variegated Smooth Agave	25Ltr	800mm	600cts
The state of the s	2	Alpinia zerumbert	Shell Ginger	45Ltr	1.5m	800cts
8	17	Carissa macrocarpa ' Desert Star'	Dwarf Natal Plum	200mm	500mm	500cts
* * * *	30	Carpobrotus glaucescens	Native Pig Face	140mm	300mm	600cts
	33	Casuarina 'Cousin It'	Prostrate She Oak	140mm	400mm	600cts
	8	Crassula arborescens 'Max Cook'	Ripple Jade Plant	25Ltr	1m	600cts
	1	Cupaniopsis anacardoides	Tuckeroo	75Ltr	8m	per plan
	17	Cycas revoluta	Cycad	25Ltr	1m	per plan
	3	Dracena draco	Dragons Blood Tree	75Ltr	4m	per plan
	3	Howea belmoreana	Sentry Palm or Curly Palm	200Ltr	10-12m	per plan
	13	Lomandra longifolia 'Tanika'	Mat Rush 'Tanika'	140mm	600mm	500cts
4 4	45	Myoporum parvifolium 'Yareena'	Boobiala	140mm	300mm	1mcts
	9	Rosmarinus officianalis 'Prostrata'	Prostrate Rosemary	140mm	300mm	600cts
*	6	Strelitzia reginae	Bird of Paradise	45Ltr	1.5m	700cts
	33	Syzygium australe 'Select'	Lily Pilly	200mm	2m hedge	600cts
	16	Trachelospermum asiaticum	Asiatic Jasmine	140mm	250mm	500cts
	30	Waterhousia floribunda	Weeping Lily Pilly	250mm	3m hedge	800cts
	7	Westringia fruticosa 'Blue Gem'	Coastal Rosemary cvs	200mm	800mm mounds	800cts

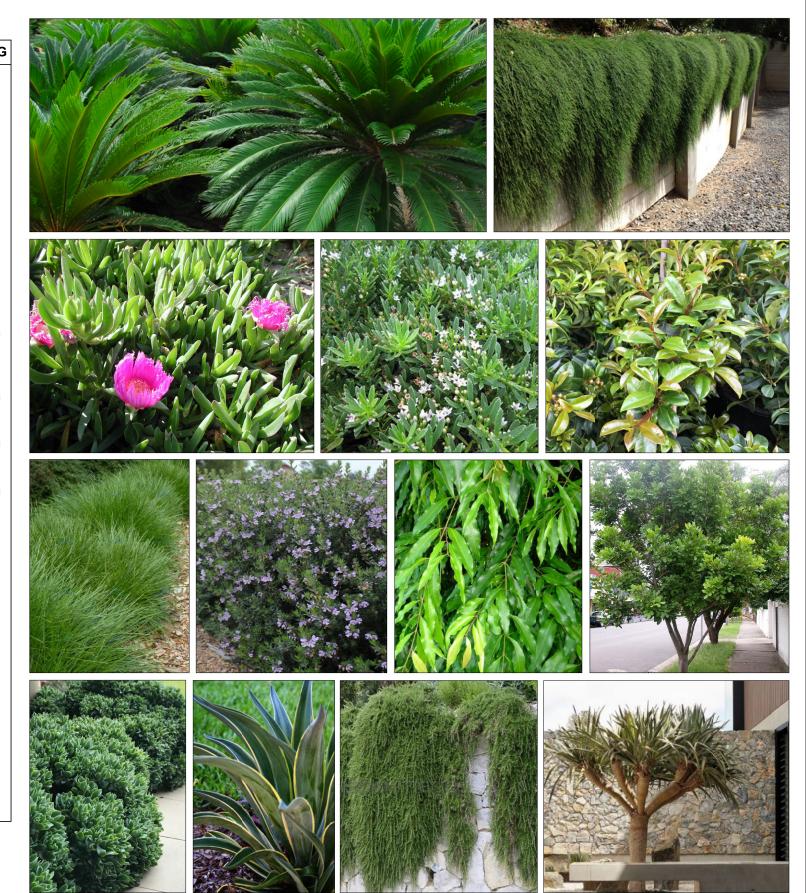

Selection of proposed planting species -

Cycas revoluta, Ccsuarina 'Cousin It', Carpobrotus glaucescens, Myoporum parvifolium 'Yareena', Syzygium australe 'Select',Lomandra 'Tanika', Westringia 'Blue Gem', Waterhousia floribunda, Cupariopsis anacardoides, Crassula 'Max Cook', Agave desmettiana, Rosmarinus 'Prostrata', Dracena draco

0 1 2 3 4 5 10 Scale in metres at 1:100 @ A3

Ph. 9818 6666 - Fax. 9818 3002 office@bateslandscape.com.au www.bateslandscape.com.au 2 / 7 8 RESERVEROAD ARTARMON, NSW 2064

#### LANDSCAPE PLAN

LENAHAN RESIDENCE

PLANT SCHEDULES & PLANT IMAGES

123 BYNYA ROAD PALM BEACH NSW

1 1 A P R 2 0 2 2 DWG NO. LEN.01.02 P A G E 2 O F 3 1:100 @ A 3





SITE AREA 911.30m<sup>2</sup>

EXISTING BUILT UPON AREA 496.69m² PROPOSED BUILT UPON AREA 502.43m²

EXISTING LANDSCAPE AREA 414.59m<sup>2</sup> (45.49%) PROPOSED LANDSCAPE AREA 408.87m<sup>2</sup> (44.86%)

LANDSCAPE AREA REQUIRED 546.78m<sup>2</sup> (60.00%) AS PER PITTWATER 21 DCP - D12.10 LANDSCAPED AREA - ENVIRONMENTALLY SENSITIVE LAND (E4)

NOTES

0 1 2 3 4 5

Scale in metres at 1:100 @ A3

BATES LANDSCAPE

Ph. 9818 6666 - Fax. 9818 3002
office@bateslandscape.com.au
www.bateslandscape.com.au
2/78 RESERVE ROAD
ARTARMON, NSW 2064



#### LANDSCAPE PLAN


LENAHAN RESIDENCE

REAR GARDEN

123 BYNYA ROAD PALM BEACH NSW

1 1 A P R 2 0 2 2 DWG NO. LEN.01.03 P A G E 3 O F 3 1:100 @ A 3



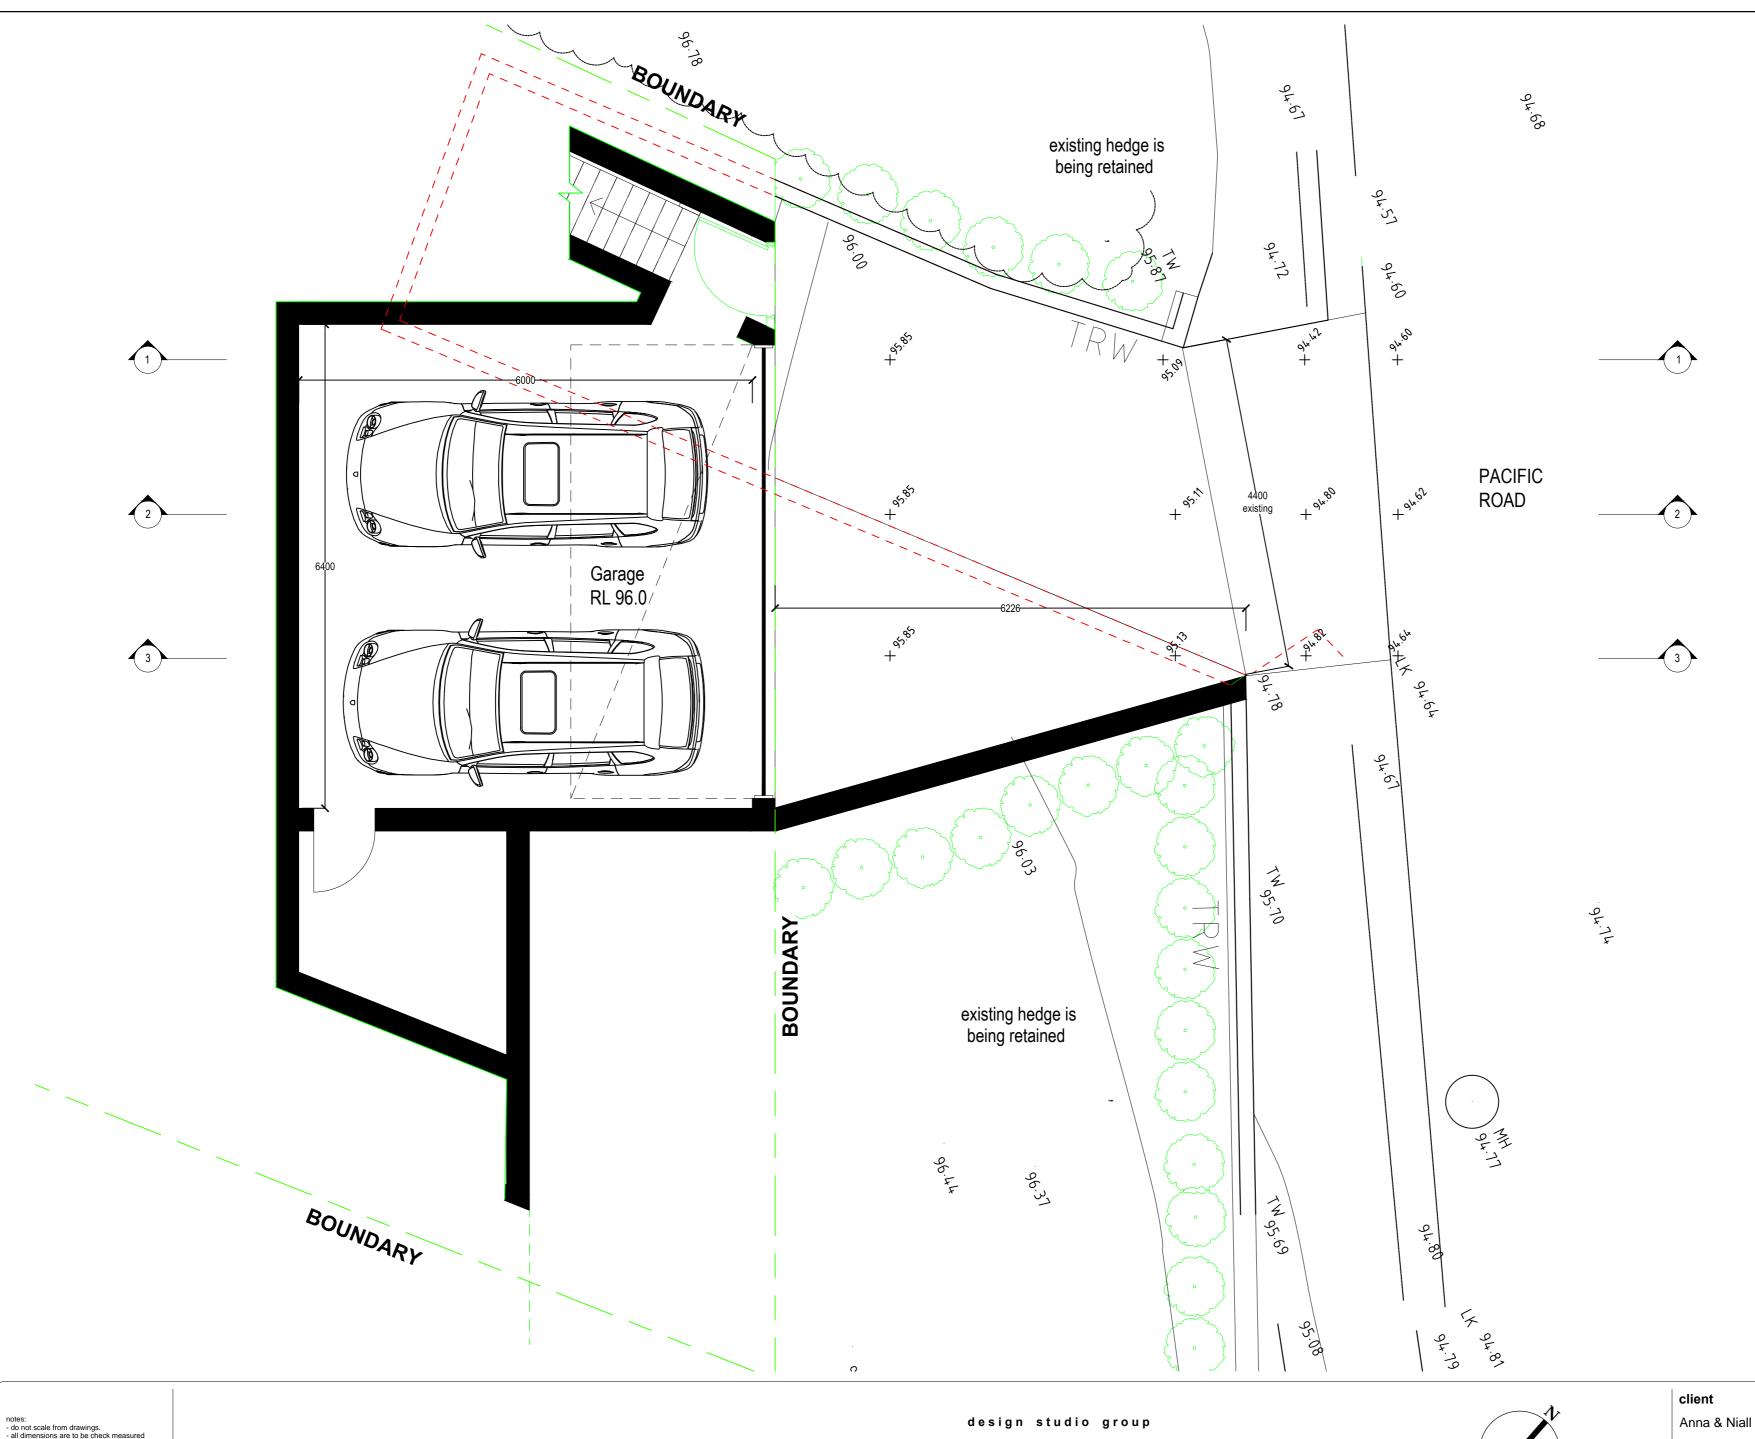

notes:
- do not scale from drawings.
- all dimensions are to be check measured onsite prior to commencement of work.
- written dimensions take precedence.
- this document is copyright and the property of the author, and must not be retained, copied in whole or part.

additional DA information 12.08.2022


Date

Description

Rev.



client	drawing title	scale 1:50 @ A2		
Anna & Niall Lenahan	Driveway Sections	date Aug 2022		
project	drawing no.	revision	drawn KL	
123 Bynya Road, Palm Beach NSW 2108 - DP 572887	DA6.01	A	job ref. PB 2021	

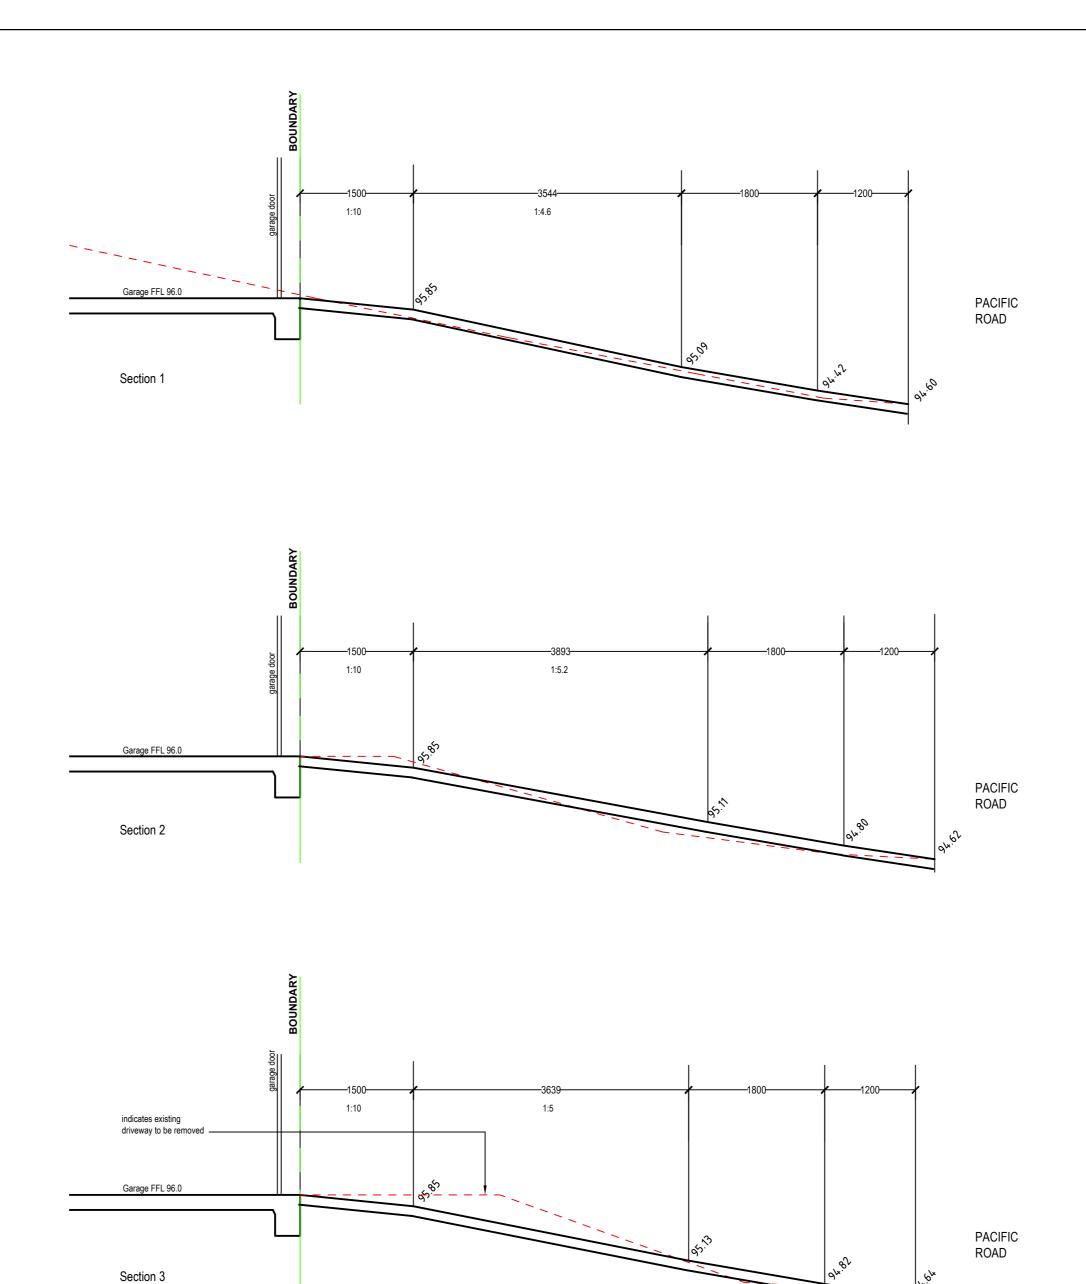

notes:
- do not scale from drawings.
- all dimensions are to be check measured onsite prior to commencement of work.
- written dimensions take precedence.
- this document is copyright and the property of the property of the author, and must not be retained, copied in whole or part.

design studio group

a: suite 5, 706 military road mosman nsw 2088 e: info@designstudiogroup.com.au ph: 0421062266 NSW ARB #7988 www.designstudiogroup.com.au



client	drawing title	scale 1:50 @ A2 date Aug 2022	
Anna & Niall Lenahan	Driveway Sections		
project	drawing no.	revision	drawn KL
123 Bynya Road, Palm Beach NSW 2108 - DP 572887	DA6.01	A	job ref. PB 2021

Date

Description

Rev.