28 INGLEBAR AVENUE. ALLAMBIE HEIGHTS, NSW 2100

LOT 3, DP 245112

PROPOSED NEW DWELLING AND INGROUND SWIMMING POOL

DRAWING REGISTER

DA001 DRAWING REGISTER, LOCATION PLAN, SPECIFICATION AND NOTES

DA011 DEMOLITION SITE PLAN

DA012 DEMOLITION FLOOR PLANS

DA013 DEMOLITION ELEVATIONS

DA101 SITE ANALYSIS PLAN

DA102 PROPOSED SITE PLAN

DA201 PROPOSED GROUND FLOOR PLAN

DA202 PROPOSED FIRST FLOOR PLAN

DA203 PROPOSED ROOF PLAN

DA301 PROPOSED NORTH AND SOUTH ELEVATIONS

DA302 PROPOSED WEST AND EAST ELEVATIONS

DA401 PROPOSED SECTIONS a-a, b-b, c-c, d-d

DA402 PROPOSED SECTIONS e-e, f-f

DA501 SHADOW DIAGRAMS

H01-02 HYDRAULIC PLANS AND DETAILS by Peninsula Consulting Engineers 01 LANDSCAPE PLANS AND DETAILS by Libby Birley Landscape Design

4920 SURVEY by DC Surveys.M


SCOPE OF WORKS

DEMOLITION OF EXISTING DWELLING AND ATTACHED GARAGE NEW TWO STOREY DWELLING WITH FIVE BEDROOMS INCLUDING BALCONIES SWIMMING POOL AND ASSOCIATED DECKS POOL FENCE AND LANDSCAPING







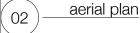

da submission

25.11.21

general notes issue date description

All work is to comply with the building code of australia, saa codes and relevant by-laws

All measurements are in millimetres and are to be verified on site prior to commencement of any work

All dimensions relating to site boundaries and easements are subject to veriifcation by a site survey.

All structural work is to be done in aDAordance with structural engineers' documentation Do not scale drawings

BASIX REQUIREMENTS

INSULATION:

- for external framed walls (weatherboard, fibro, metal clad) use R2.00 (or R2.40 including
- for flat ceing, flat roof use R0.7 (up) roof 100mm foil backed insulation
- gable end vents, light roof (solar absorptance < 0.475)

GLAZED DOORS & WINDOWS: (U-value: 6.70, SHGC: 0.57)

- The applicant must install the windows, glazed doors and shading devices, in accordance with the specifications listed in the table below. W01

aluminium, single, clear, solid overhang 1405mm, 250mm above head, 2-4m H, 2-5m away W02, W03, W04

aluminium, single, clear, solid overhang 1975mm, 250mm above head, 2-4m H, 2-5m away

aluminium, single, clear, solid overhang 500mm, 250mm above head W06

aluminium, single, clear, solid overhang 500mm, 970mm above head

aluminium, single, clear, eaves 100mm, 330mm above head, >4m H, <2m away W08, W10

aluminium, single, clear, solid overhang 1005mm, 10mm above head W/N9

aluminium, single, clear, solid overhang 5565mm, 10mm above

aluminium, single, clear, solid overhang 500mm, 1160mm above head

aluminium, single, clear, solid overhang 500mm, 1160mm above head, 1-2m H, >1.5m away W13

aluminium, single, clear, solid overhang 500mm, 250mm above, 2-4m H, 2-5m away

aluminium, single, clear, solid overhang 500mm, 150mm above head,2-4m H, 5-8m away W16

aluminium, single, clear, solid overhang 500mm, 2750mm above head,2-4m H, 5-8m away

aluminium, single, clear, solid overhang 1370mm, 380mm above head W18, W19, W20 aluminium, single, clear, solid overhang 1960mm, 300mm above head

W21, W22, W23

aluminium, single, clear, solid overhang 2660mm, 300mm above head W24

aluminium, single, clear, solid overhang 500mm, 440mm above head W25, W26, W27, W28, W32, W34, W36, W37, W18

aluminium, single, clear, solid overhang 500mm, 150mm above head W29, W30, 31 aluminium, single, clear, solid overhang 3805mm, 10mm above head

aluminium, single, clear, solid overhang 500mm, 150mm above head, 1-2m H, >1.5m away

SWIMMING POOL:

- swimming pool maximum capacity of 38 kilolitres
- swimming pool to have a pool cover and a pool pump timer installed
- swimming pool to have a heat pump installed for heating run by solar (gas boosted)

RAINWATER TANK:

- rainwater tank minimum capacity 3000 litres to be installed on site
- rainwater tank should collect rainwater runoff from at least 119.5 square metres of roof area -

HOT WATER:

- a gas instantaneous hot water heater is to be installed on site

ALTERNATIVE ENERGY:

- applicant to install a photovoltaic system to generate minimum 2kW peak electricity must be installed and connected to electrical system

legend

- indigenous or low water species to be installed to minimum of 180 square metres of site

FINISHES SCHEDULE ROOF: LONG RUN AND CUSTOM ORB METAL **ROOFING** COLORBOND SHALE GREY DULUX DEWPOINTQUARTER S32A1Q TRIM. DOORS: **DULUX WHITE** ALUMINIUM WINDOW FRAMES: SATIN WHITE POWDERCOAT **GUTTERS:** COLORBOND WHITE

DA SUBMISSION

project title: 28 inglebar avenue, allambie heights clare and jack luchetti dwa title:

drawing register, location plan,

basix and notes


DA issue: date:

scale:

nov 2021


nts@A3


drawn by: emc

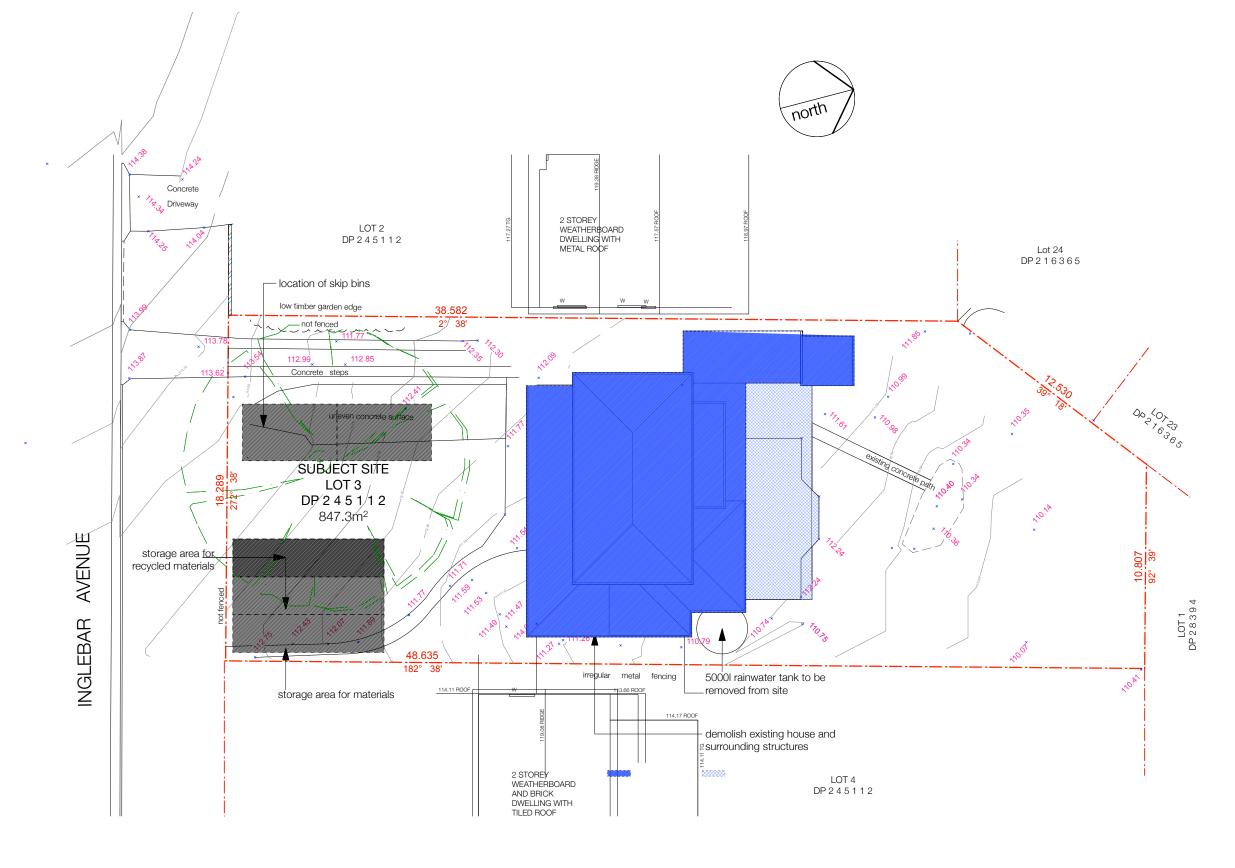

demolition plan

issue	general notes	legend				DA SUB	MISSION
rev date description A 25.11.21 da submission	All work is to comply with the building code of australia, saa codes and relevant by-laws. All measurements are in millimetres and are to be verified on site prior to commencement of any work. All dimensions relating to site boundaries and easements are subject to veriification by a site survey. All structural work is to be done in aDAordance with structural engineers' documentation Do not scale drawings		existing tree to be removed existing house to be removed existing steps, awnings and deck to be removed	project title: 28 inglebar avenue, allambie heights client: clare and jack luchetti dwg title: demolition site plan	scale: issue: date: drawn b	1:100@A3 DA nov 2021 by: emc	DA011 rev:

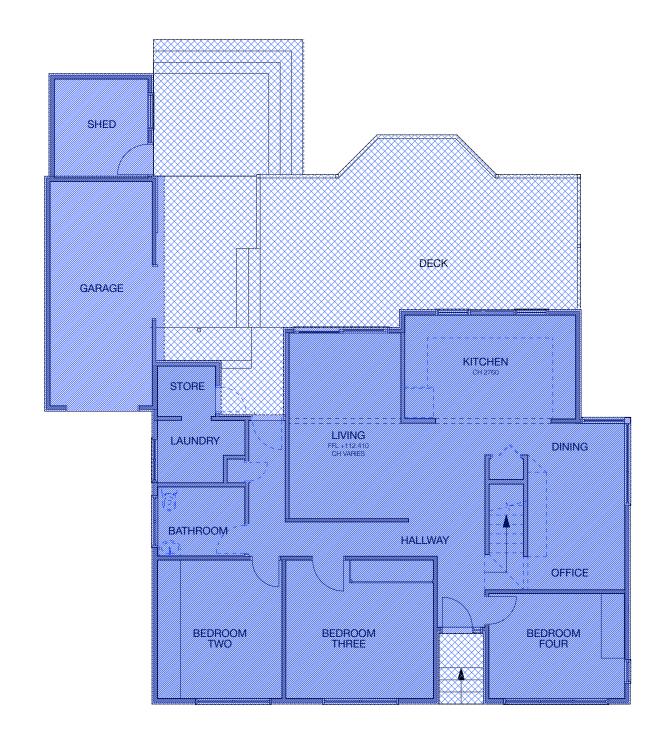

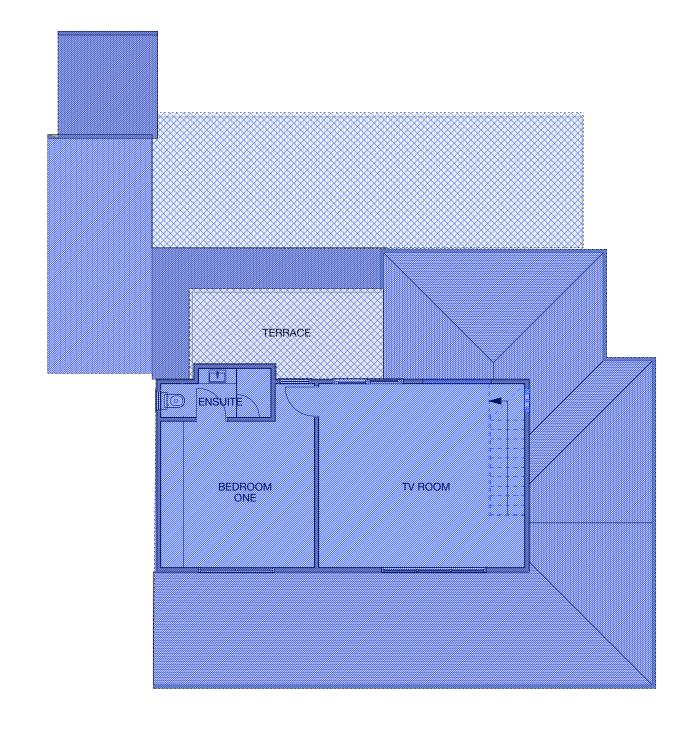


existing ground floor plan

02 existing first floor plan

issue	general notes	legend			DA SUBMISSI	ION
rev date description A 25.11.21 da submission	All work is to comply with the building code of australia, saa codes and relevant by-laws. All measurements are in millimetres and are to be verified on site prior to commencement of any work. All dimensions relating to site boundaries and easements are subject to verification by a site survey. All structural work is to be done in aDAordance with structural engineers' documentation Do not scale drawings	existing house to be removed existing steps, awnings and deck to be removed	project title: 28 inglebar avenue, allambie heights client: clare and jack luchetti dwg title: existing floor plans	issue: D	1:100@A3 DA (DA nov 2021	dwg no: 012 rev:



Do not scale drawings

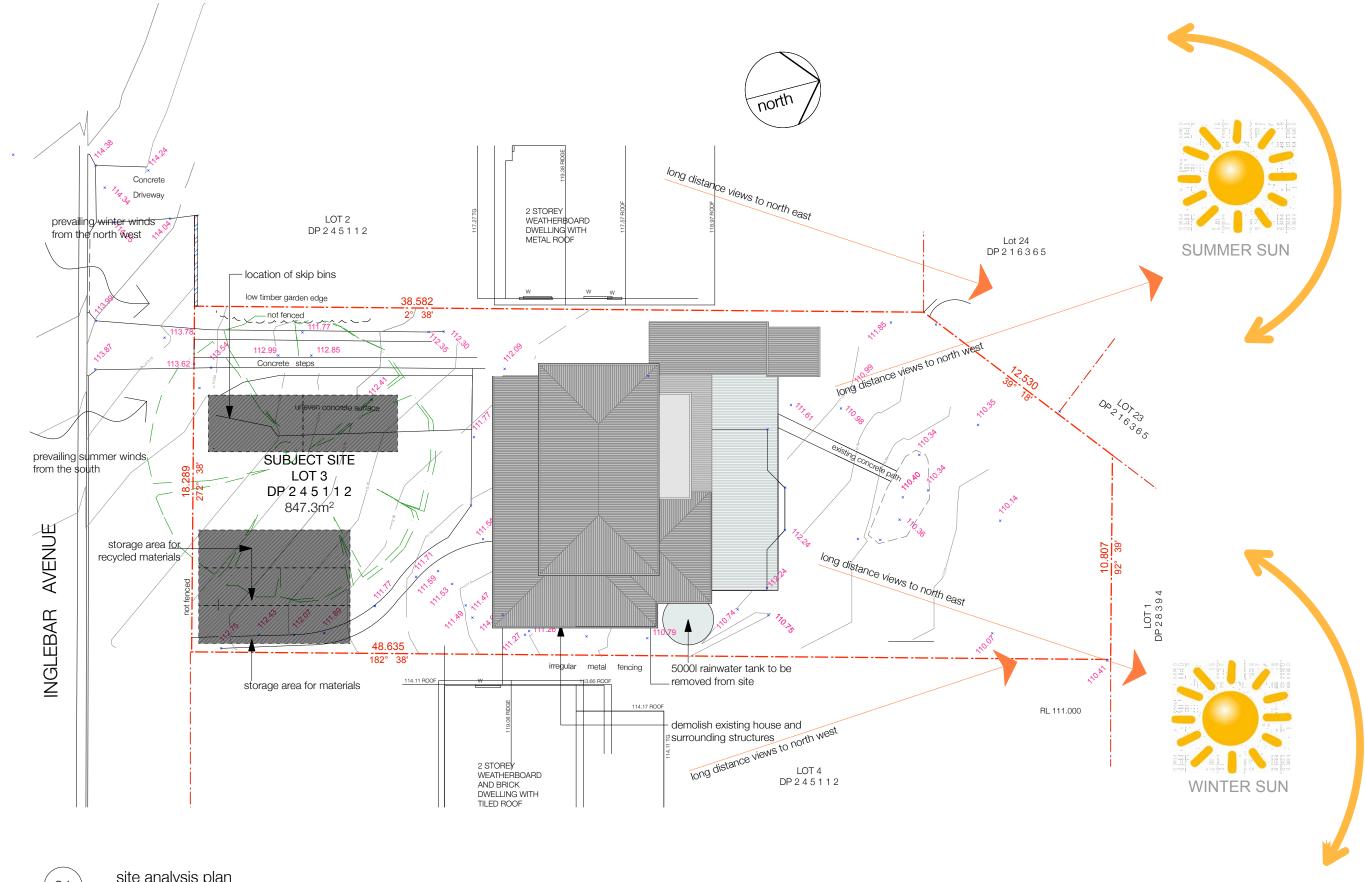

site analysis plan 01

issue	general notes	legend		DA SUBMISSION
rev date description A 29.06.21 prelimina 05.07.21 issue to a 16.09.21 issue to a B 25.11.21 da subm	All measurements are in millimetres and are to be verified on site ape designer prior to commencement of any work.	boundary 110.000 existing ground level existing tree to be removed	project title: 28 inglebar avenue, allambie heights scale: client: clare and jack luchetti dwg title: site analysis plan scale: issue: date: date:	1:200@A3 DA101 DA rev: nov 2021 emc B

required landscaped area is 40% of 847.3m² = 338.92m² proposed landscaped area is 359.01m² = 42.4% private open space is 183.0m² refer to landscape plan




SEDIMENT CONTROL MEASURES COMPLY WITH COUNCIL GUIDELINES ON

INSTALL SEDIMENT CONTROL STRUCTURES IN LOCATIONS INDICATED ON DRAWINGS AND AS


EROSION AND SEDIMENT CONTROL


OTHERWISE REQUIRED TO CONTROL

13300	gonoral notes	logoria				
rev date description A 29.06.21 preliminary 05.07.21 issue to end 16.09.21 issue to lan B 25.11.21 da submiss	All measurements are in millimetres and are to be verified on site cape designer prior to commencement of any work.	boundary sediment control fence minimum setbacks 110.000 existing ground level 110.000 new ground level	new garden areas new grassed areas mulch hard landscaped areas/ driveway	project title: 28 inglebar avenue, allambie heights client: clare and jack luchetti dwg title: proposed site plan	scale: 1:200@A33 issue: DA date: nov 2021 drawn by: emc	DA102 rev:

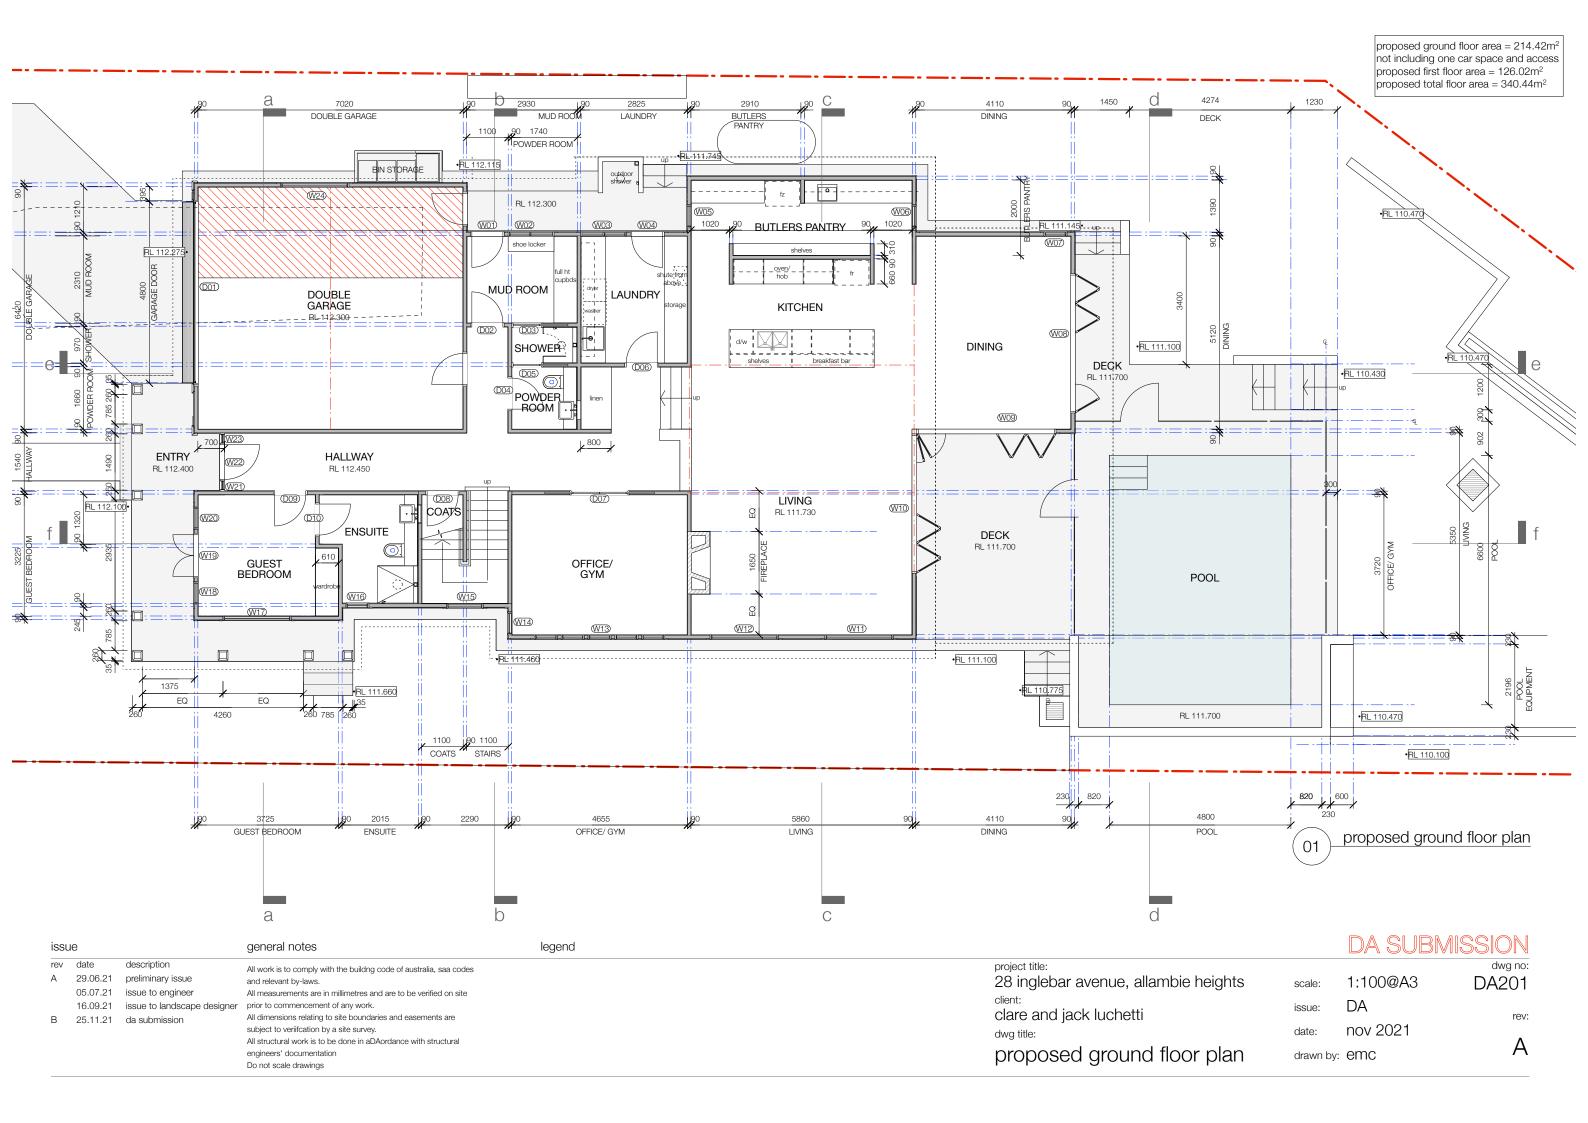


proposed ground floor area = 214.42m² not including one car space and access proposed first floor area = 126.02m² proposed total floor area = 340.44m² d G850 MASTER BEDROOM 3530 BEDROOM 3 4330 BEDROOM 4 ENSUITE BATHROOM 90 700 90 WARDROBE 2185 LINEN SUITE BEDROOM 3 BEDROOM 4 BATHROOM (W29) MASTER W30) BEDROOM TERRACE WIR W31 LINEN D14 HALLWAY ·D19 (D17) RL 115.300 W32 W36) MEDIA ROOM BEDROOM 2 (W34) (W33) nstall new flue in non combustible duct for slow combustion heater in living room below 90 1225 TERRACE BEDROOM 2 proposed first floor plan d а DA SUBMISSION issue general notes legend description All work is to comply with the building code of australia, saa codes preliminary issue new masonry walls 29.06.21 28 inglebar avenue, allambie heights 1:100@A3 DA202 and relevant by-laws. 05.07.21 issue to engineer All measurements are in millimetres and are to be verified on site new 90mm timber or metal stud walls DA issue to landscape designer prior to commencement of any work. 16.09.21 issue: clare and jack luchetti new timber stud walls to terraces and planters All dimensions relating to site boundaries and easements are 25.11.21 da submission subject to veriifcation by a site survey. nov 2021 date: All structural work is to be done in aDAordance with structural В proposed first floor plan engineers' documentation drawn by: emc Do not scale drawings

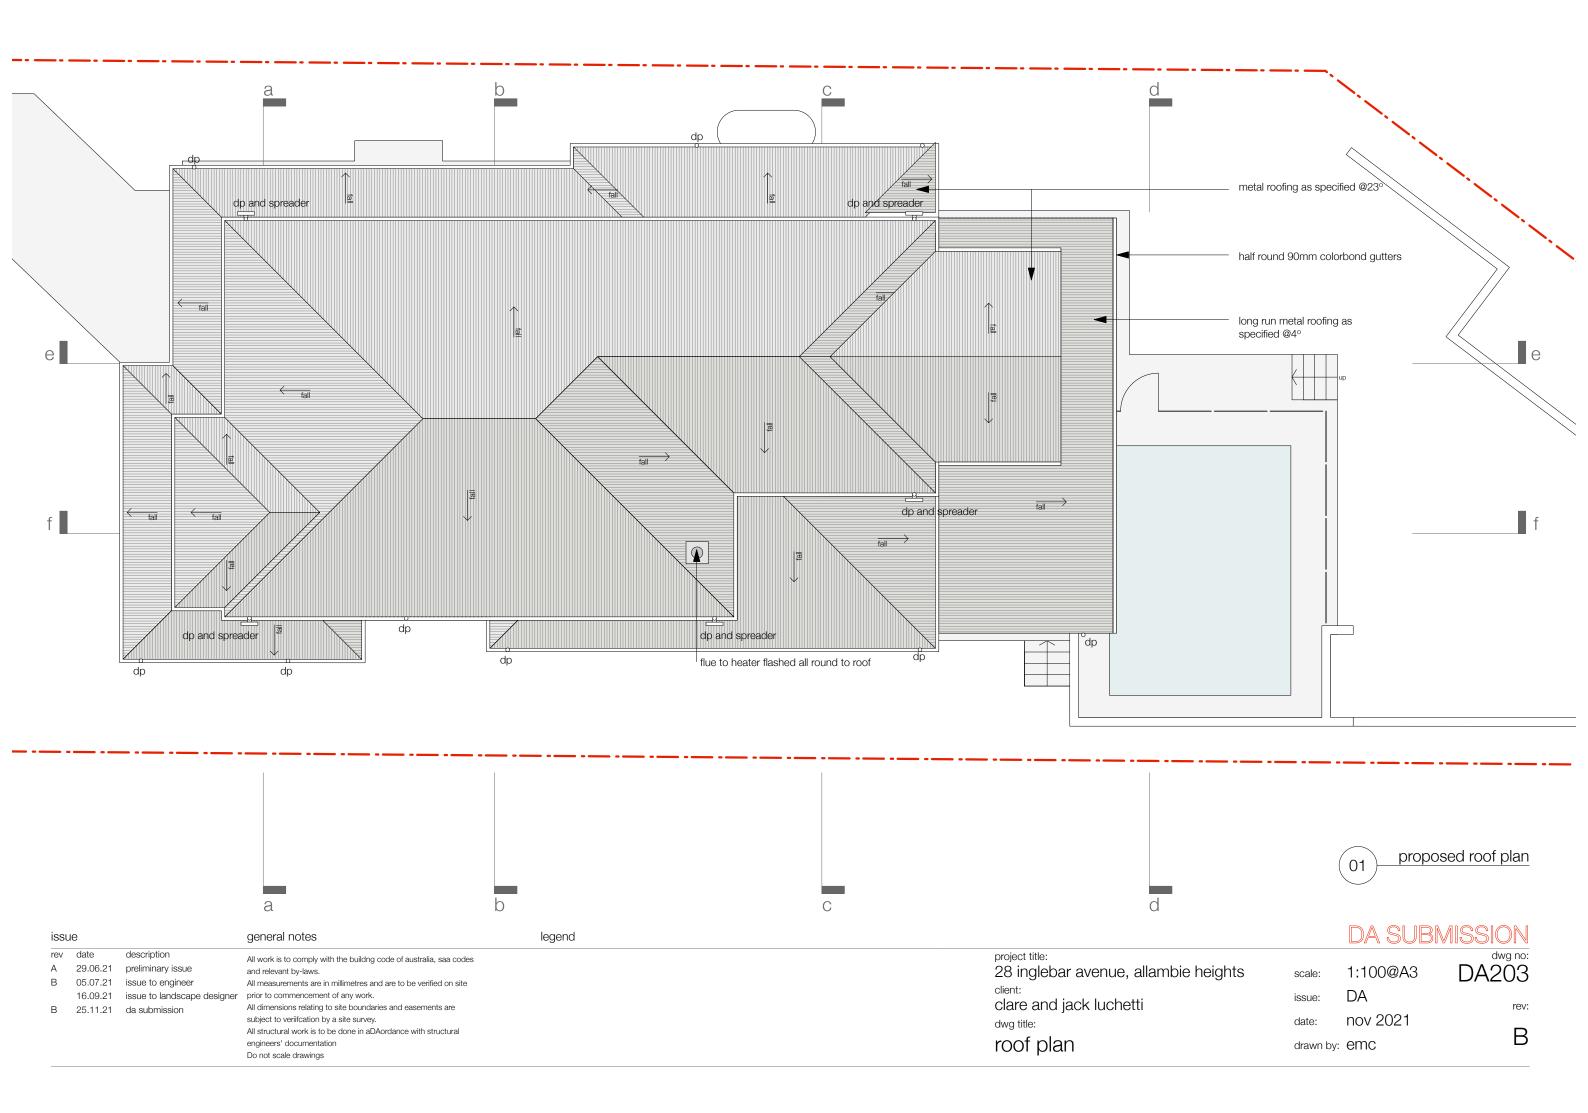


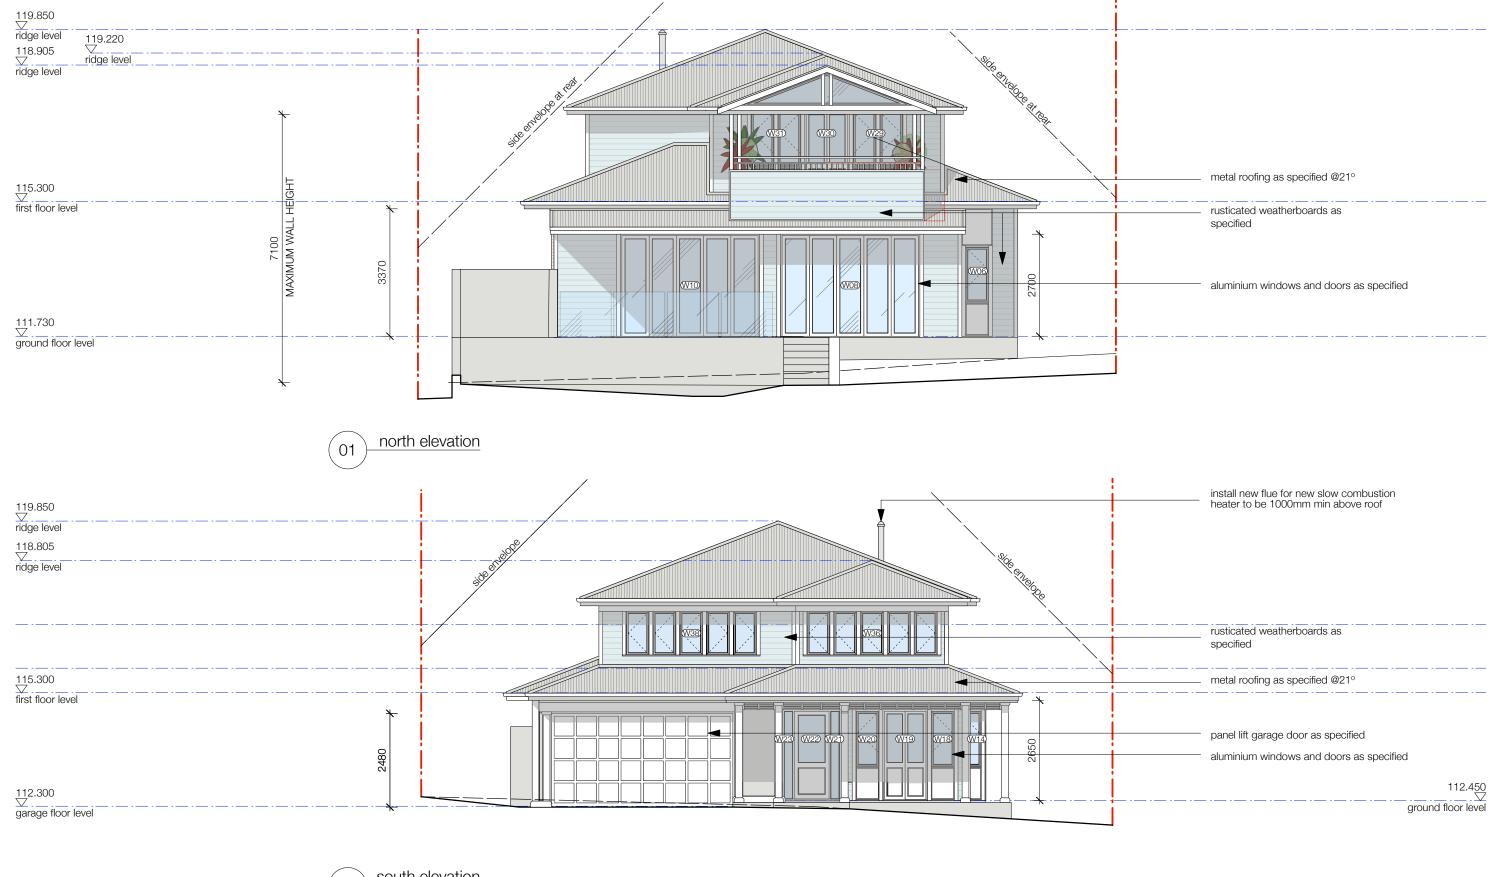



02 south elevation


issue	е		general notes	legend			DA SUB	MISSION
	29.06.21	description preliminary issue issue to engineer	All work is to comply with the building code of australia, saa codes and relevant by-laws. All measurements are in millimetres and are to be verified on site		project title: 28 inglebar avenue, allambie heights	scale:	1:100@A3	DA301
В	16.09.21 25.11.21	issue to landscape designer da submission roof slope changed to 21°	prior to commencement of any work. All dimensions relating to site boundaries and easements are subject to verification by a site survey.		client: clare and jack luchetti dwg title:	issue: date:	DA nov 2021	rev:
С	22.02.22	revised da submission	All structural work is to be done in aDAordance with structural engineers' documentation Do not scale drawings		proposed elevations	drawn l	oy: emc	С

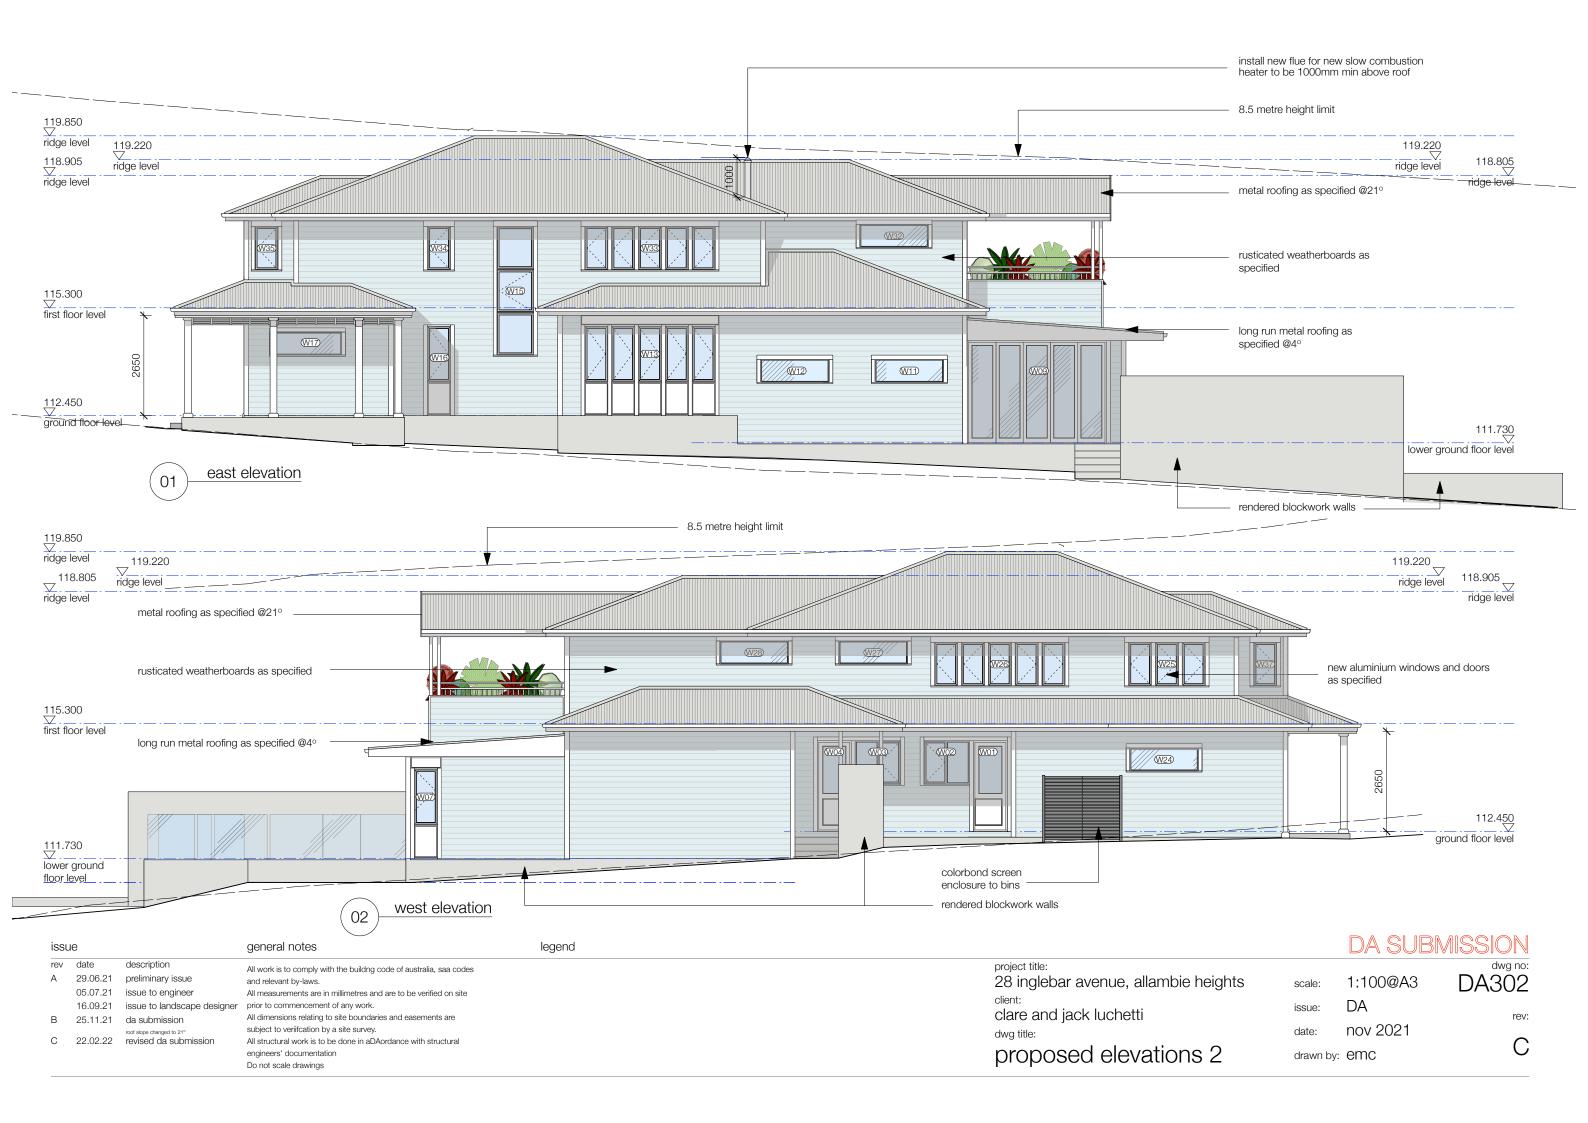


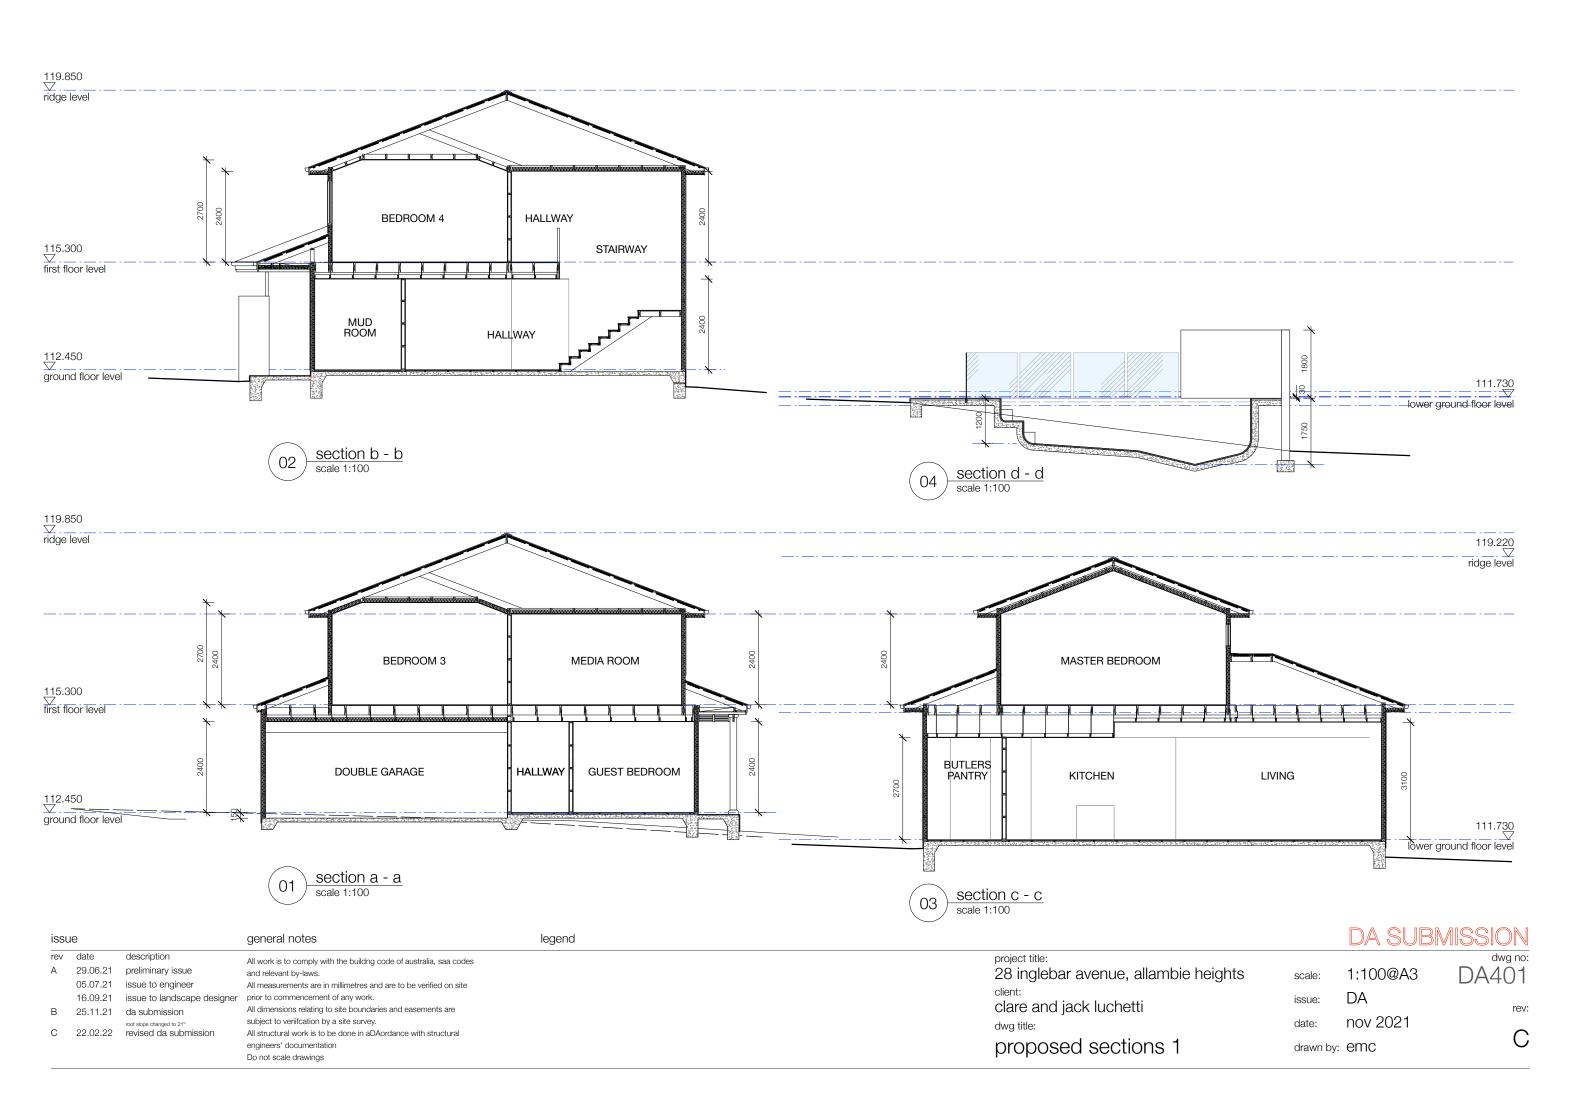

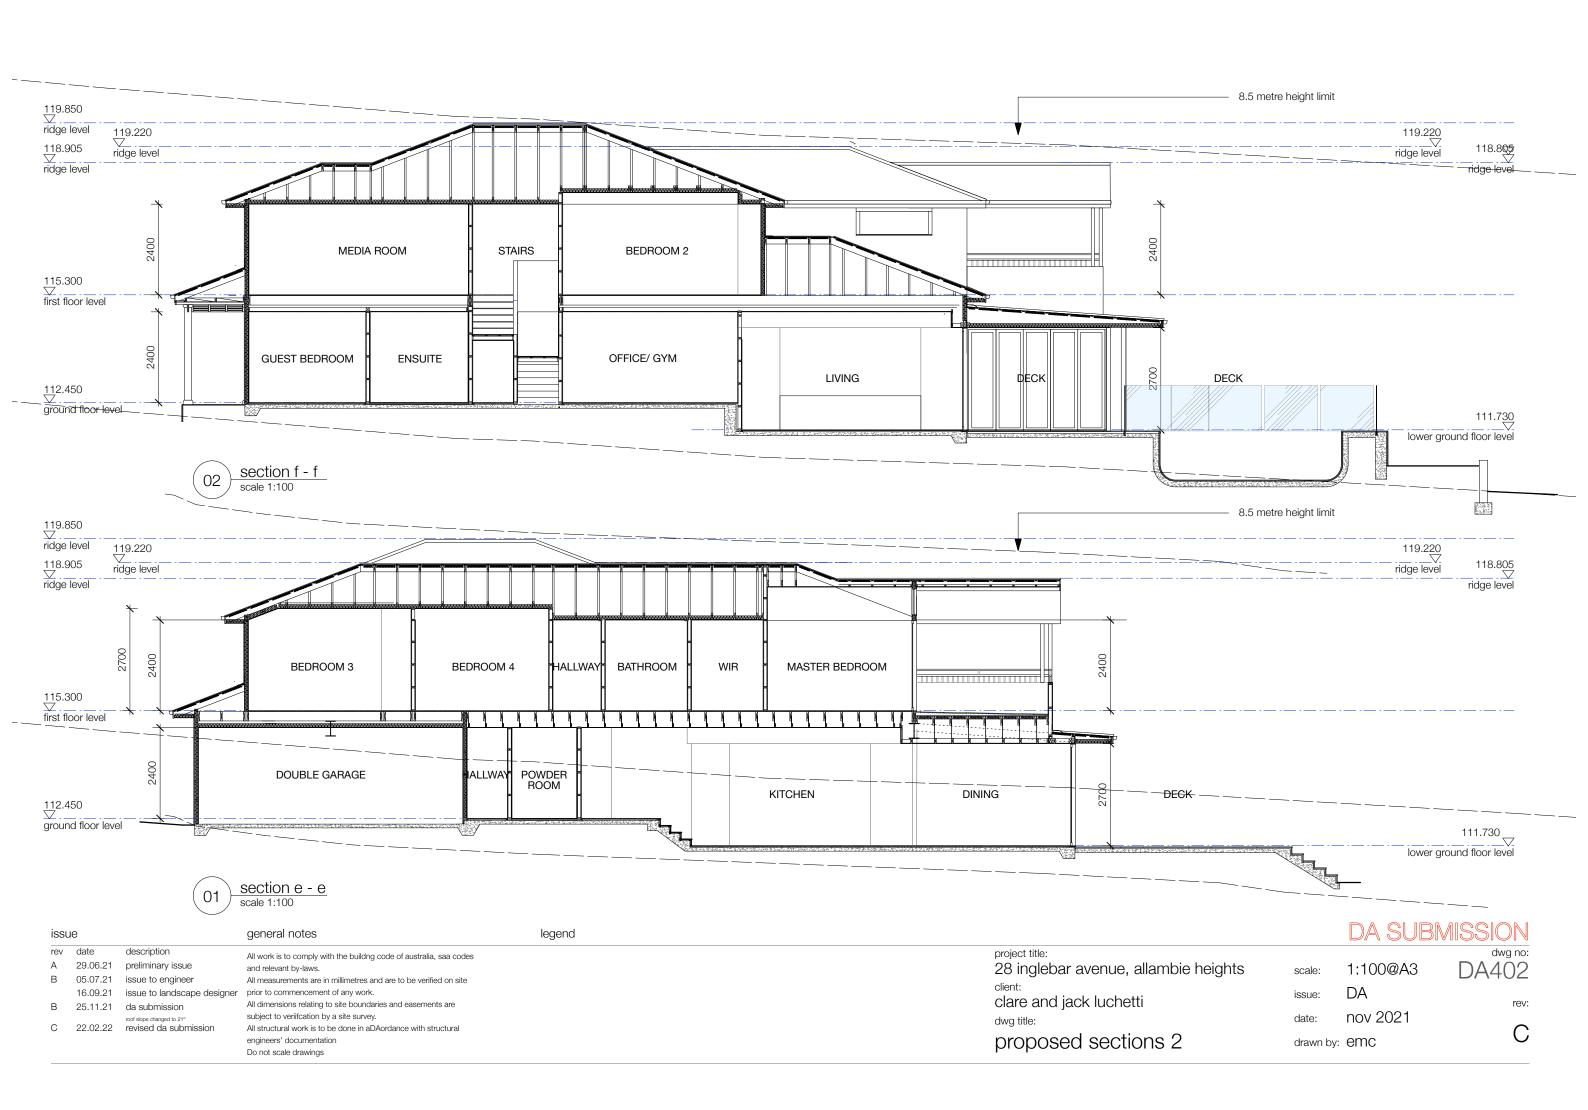

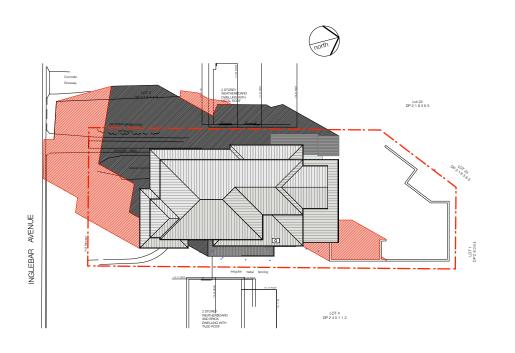

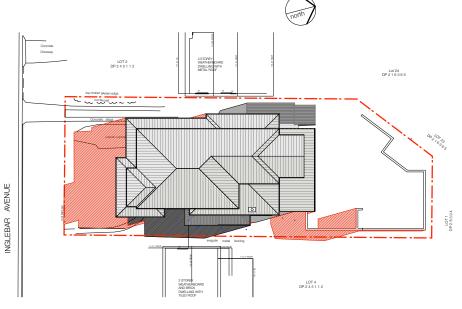

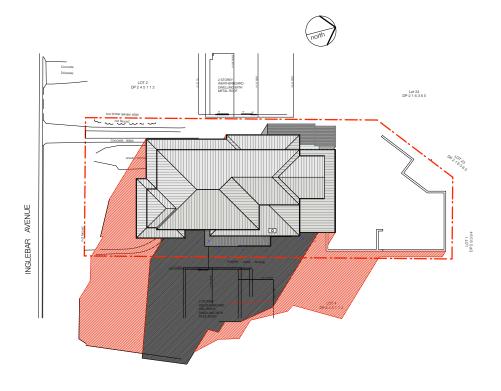


9am 22 june

92 shadow diagram 12pm 22 june

shadow diagram 3pm 22 june

issue	9		general notes	legend				DA SUBN	AISSION .
rev A		description plælsatimaississue	All work is to comply with the building code of australia, saa codes and relevant by-laws. All measurements are in millimetres and are to be verified on site		existing shadow	project title: 28 inglebar avenue, allambie heights	scale:	as shown@A3	dwg no: DA501
		issue to landscape designer da submission	prior to commencement of any work. All dimensions relating to site boundaries and easements are subject to veriifcation by a site survey. All structural work is to be done in aDAordance with structural engineers' documentation Do not scale drawings		additional shadow	client: clare and jack luchetti dwg title: winter shadow diagrams	issue: date: drawn b	DA nov 2021 by: emc	rev:

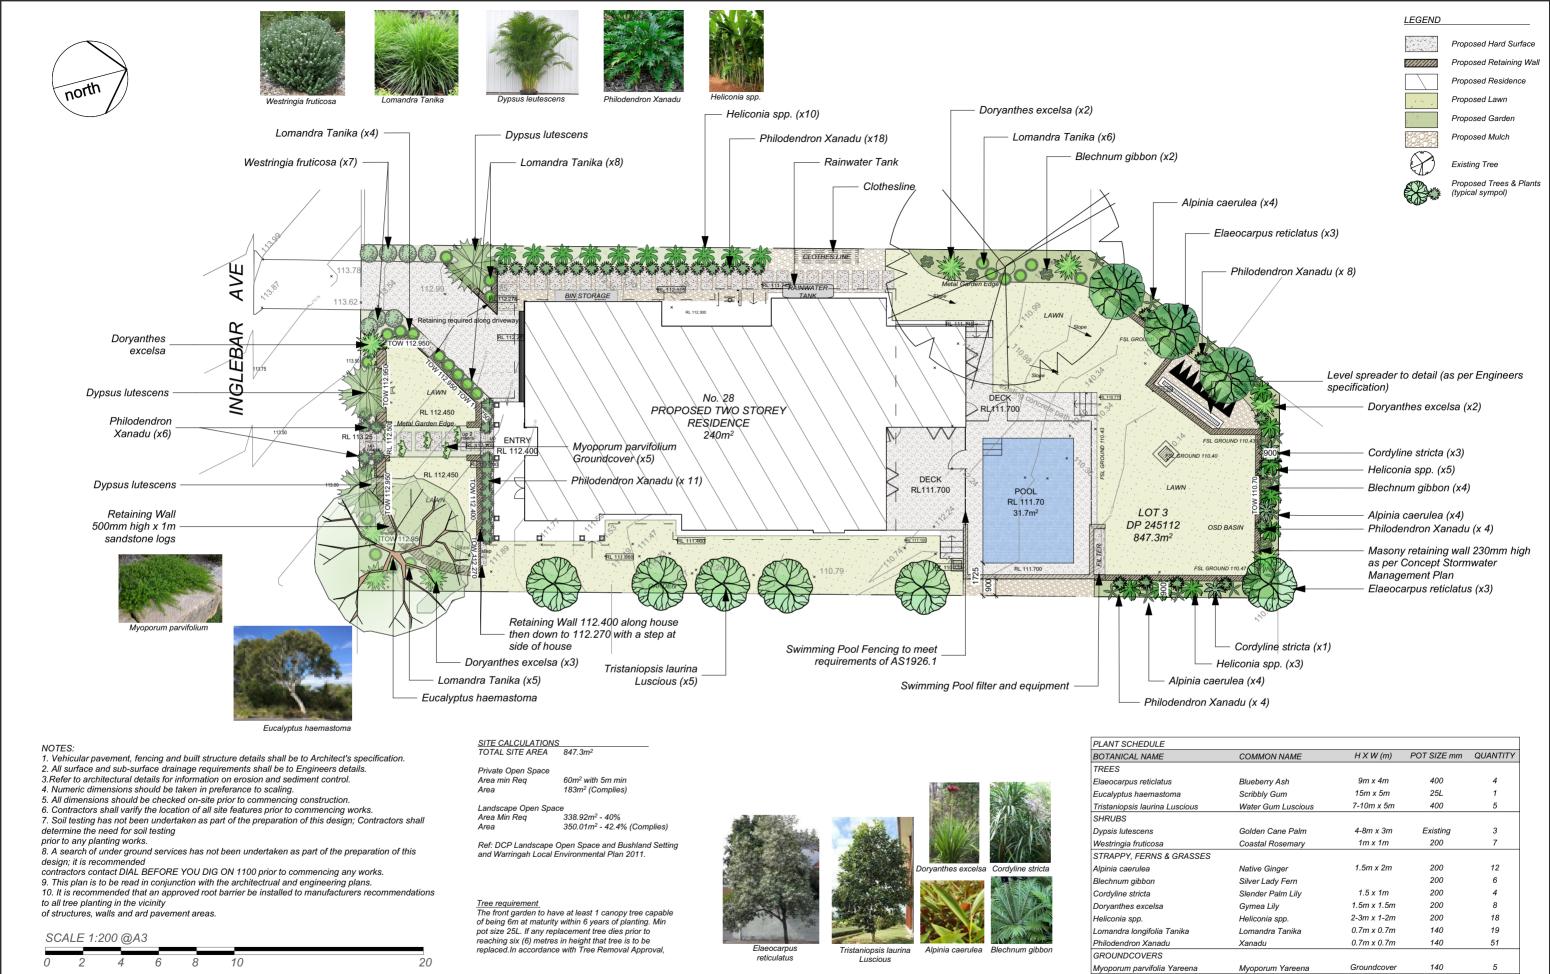

C and J LUCHETTI Landscape Plan 28 Inglebar Ave VW 1:200 Allambie Heights Reviewed By 22/11/2021 REVISION 01 DESIGNING GARDENS FOR LIVING IN LANDSCAPE PLAN 22.10.21 22/10/21 FOR DA 52 Condamine St Balgowah Phone:0411082380 Info@libbybirleygardendesign.com.au www.libbybirleyga Zone Approvals No. Date No. Date Revision Notes Issue Notes 11Kindsroad-vwx