STORMWATER MANAGEMENT PLAN

83-85 BOWER STREET MANLY



Con Katsoulas BE (Civil), MIEAust, CPEng No. 449924

SHEET No.	TITLE	AMMENDMENT No.
1	INDEX SHEET	2
2	STORMWATER DETAIL PLAN	2
3	BASEMENT PLAN	2
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8	EROSION AND SEDIMENT CONTROL PLAN	2

LEGEND IL 0.00 PIT/PIPE INVERT LEVEL **FLOWPATH** TK 0.00 TOP OF KERB LEVEL FS-1 FLOW SPREADER AND DOWNPIPE TYPE 1 + 00.00 EXISTING SURFACE LEVEL + 00.00 PROPOSED SURFACE LEVEL PROPOSED SEALED WATER TIGHT PIT SEALED INSPECTION OPENING ● DP-1 DOWNPIPE - TYPE 1 PROPOSED STORMWATER PIPE - GRAVITY PROPOSED V-DRAIN PROPOSED STORMWATER PIPE - CHARGED TERRACE/BALCONY PROPOSED RISING MAIN (PRESSURE PIPE) PROPOSED SUBSOIL DRAIN BASIX ROOF AREA DRAINING TO RAINWATER TANK PROPOSED BUILDING - GROUND FLOOR PROPOSED BUILDING - FIRST FLOOR AREA BYPASSING ON-SITE DETENTION TANK PROPOSED CONTOURS


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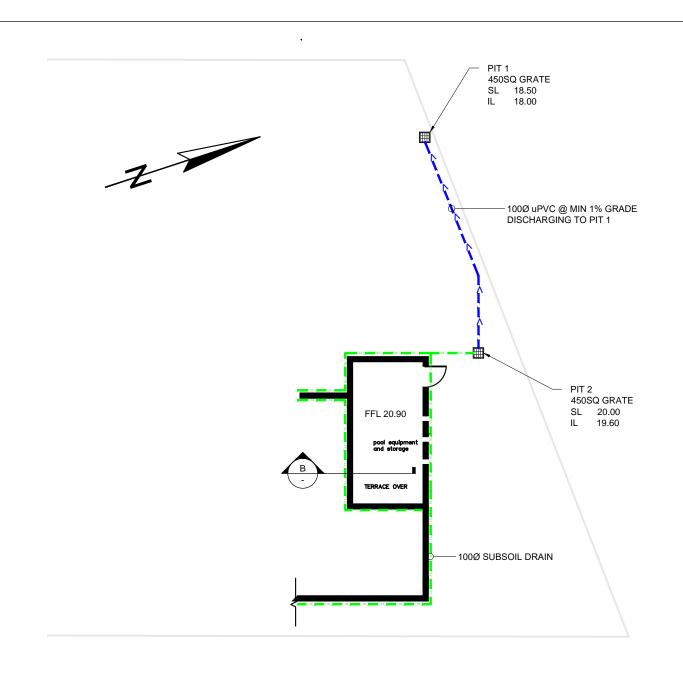
- ALL PROPOSED PITS TO BE 450 x 450 CAST IN-SITU OR PRECAST PITS UNLESS SHOWN OTHERWISE.
- 2. ALL CHARGED LINE PIPES TO BE 100Ø uPVC SEWER CLASS UNLESS SHOWN OTHERWISE
- ALL DOWNPIPES TO BE 90Ø uPVC OR 100 x 50 UNLESS OTHERWISE SHOWN
- ALL NON-PRESSURE STORMWATER PIPES TO BE 100Ø uPVC UNLESS SHOWN OTHERWISE
- ALL GRATED DRAINS TO BE MINIMUM 150 WIDE GALVANIZED HEAVY DUTY GRATES.
- 6. ALL NON-TRAFFICABLE PITS TO BE LIGHT DUTY. PITS IN TRAFFICABLE AREAS TO BE HEAVY DUTY.
- ALL WORK SHALL BE CARRIED OUT IN ACCORDANCE WITH COUNCILS SPECIFICATIONS.
- ALL PITS GREATER THAN 1.2m DEPTH SHALL INCLUDE STEP IRONS AND HAVE MINIMUM CLEAR DIMENSIONS OF 600 x 600.
- 9. ALL PITS ARE TO BE BENCHED TO ALLOW SMOOTH FLOW
 OF WATER THROUGH PITS
- ALL DOWNPIPES SHALL CONFORM TO AS/NZS 1866 FOR ALUMINIUM PIPES AND AS 1254, AS/NZS 1260, AS 1273, AS/NZS 1477, AS/NZS 2179.2 AND AS 2032 FOR uPVC PIPES
- ALL BOX GUTTERS SHALL COMPLY WITH AS/NZS 2179.1
 ALL BOX GUTTERS SHALL BE CONSTRUCTED WITH A
- MINIMUM 1:200 GRADE TO SUMP/DOWNPIPES


 13. ALL DRAINAGE WORKS SHALL BE IN ACCORDANCE WITH AS 3500 3 2

DOWNPIPE TYPE	DOWNPIPE SIZES						
DOWNFIPE ITPE	ROUND	RECTANGULAR					
1	90Ø	100 X 75					
2	100Ø	100 X 75					
3	125Ø	100 X 100					
4	150Ø	150 X 150					

SURVEYOR	0	DA ISSUE	6/03/20				C.K. ENGINEERING SERVICES	CLIENT:	DRAWING TITLE:	DRAWN:	M.P.	SIGNED:	DATE: MARCH 2021
C.M.S SURVEYORS	1	DA ISSUE - AMENDED TO ARCH. DETAILS	20/06/20				ABN 67 115 216 496	RAY & JULIE BALCOMB	INDEX	DEGIONED	0.1/	161	SCALE: AS SHOWN
ARCHITECT	2	DA ISSUE - AMENDED TO ARCH. DETAILS	23/03/21				49 FLORA ST			DESIGNED:	C.K.	(-1)	SCALE: AS SHOWN
EVANS AND GREEN							ROSELANDS, NSW 2196	PROJECT:		CHECKED:	C.K.	4	DATUM: AHD
CONSULTANT	No	o. AMMENDMENT	DATE	No. A	AMMENDMENT	DATE	MOB: 0403 329 327	83-85 BOWER STREET MANLY		JOB & DRAV	MINIC No:	40007	No. IN SET:
-	DO NOT SCALE		EMAIL: ckatsoulas@gmail.com			WING NO.	19987	1 OF 8 ISSUE: Z					



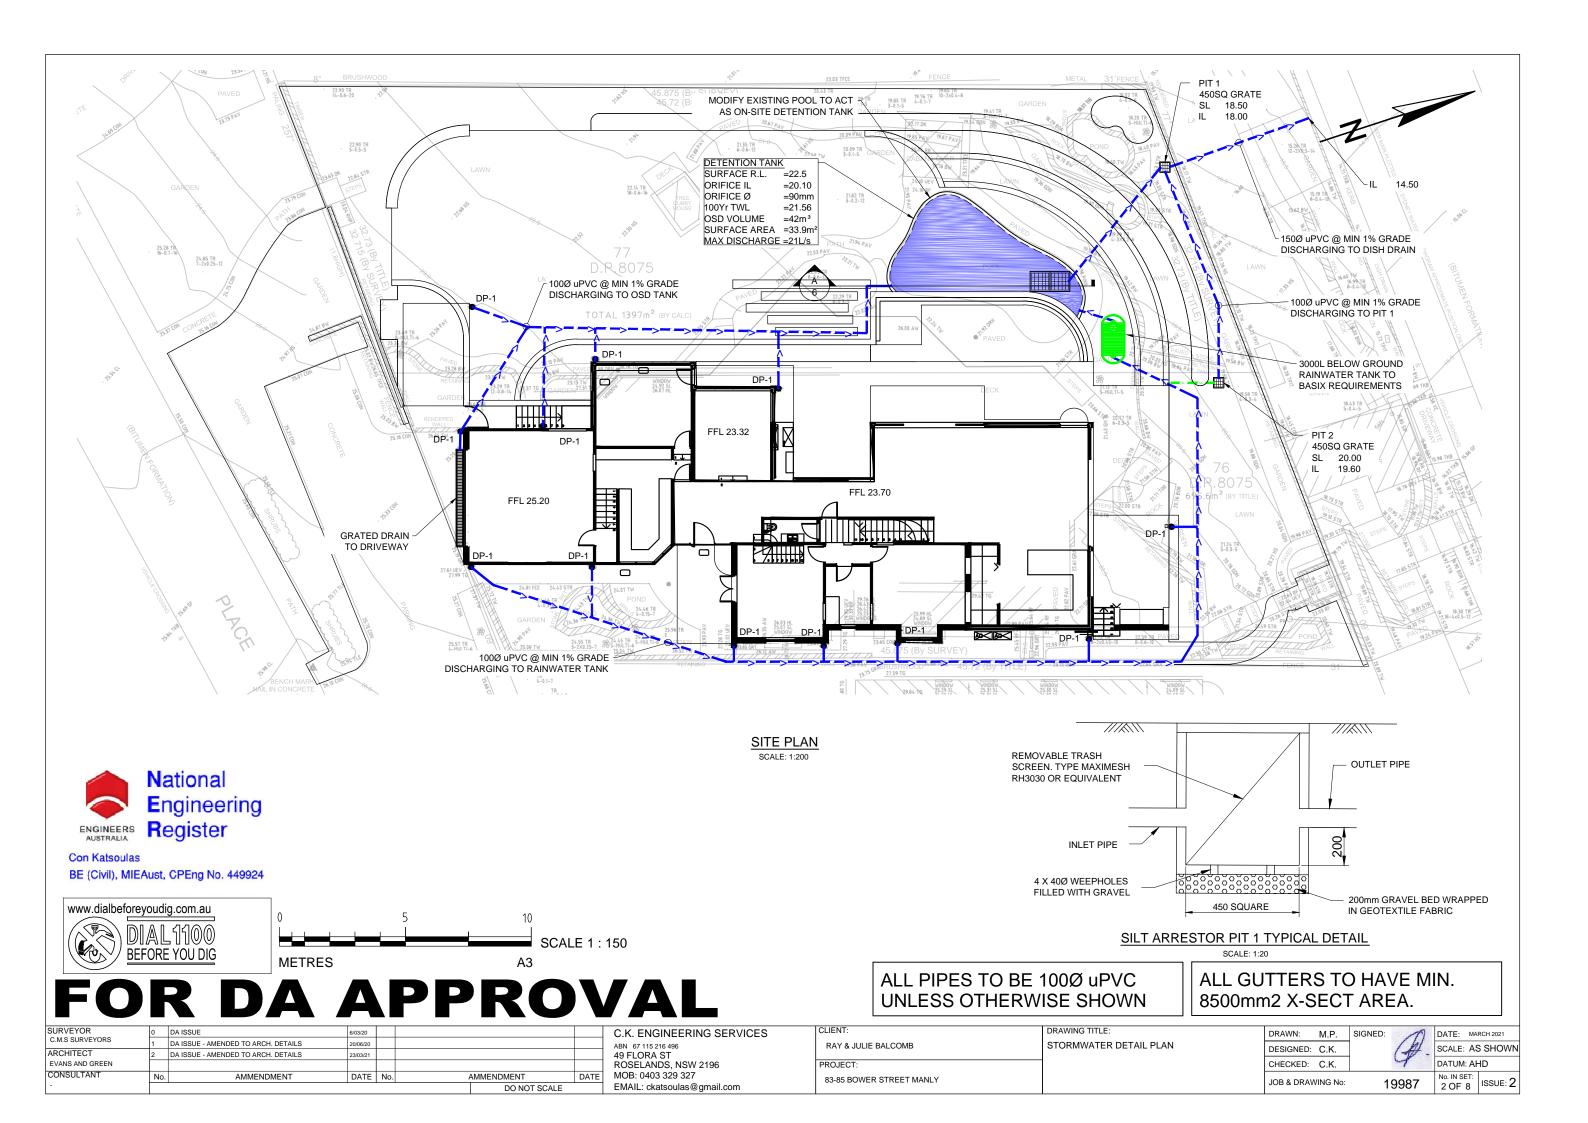

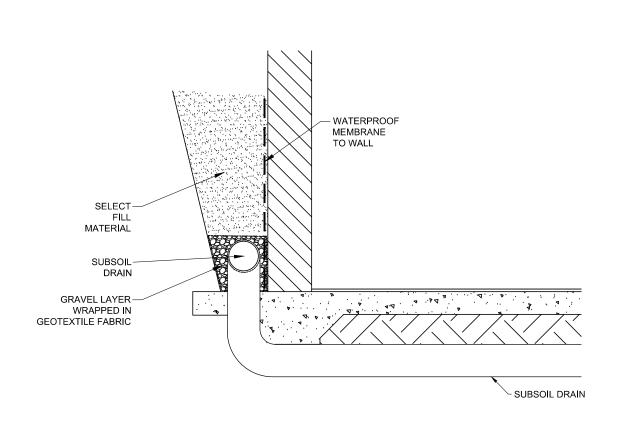

SUBSOIL DRAIN DETAIL SCALE: N.T.S.

BASEMENT PLAN SCALE: 1:200



Con Katsoulas

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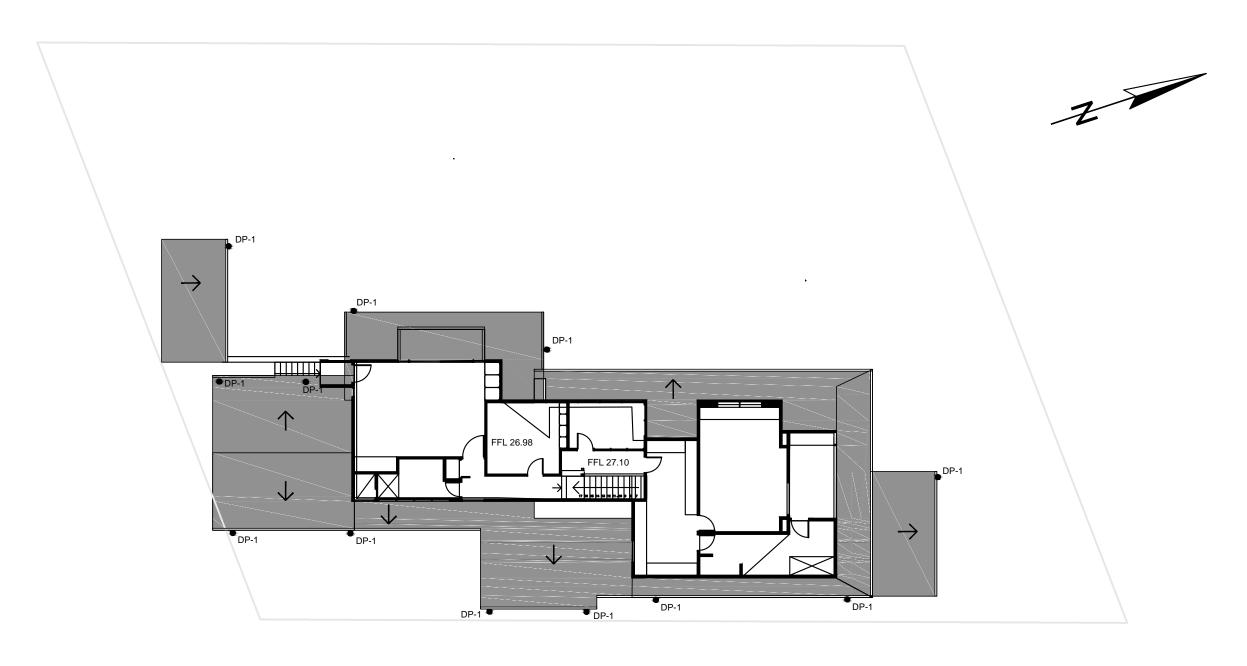
ABN 67 115 216 496 49 FLORA ST ROSELANDS, NSW 2196 MOB: 0403 329 327 EMAIL: ckatsoulas@gmail.com

DRAWING TITLE: RAY & JULIE BALCOMB BASEMENT PLAN PROJECT: 83-85 BOWER STREET MANLY

DRAWN: M.P. SIGNED: DESIGNED: C.K. CHECKED: C.K.

JOB & DRAWING No:

DATE: MARCH 2021 SCALE: AS SHOWN DATUM: AHD No. IN SET: 3 OF 8 ISSUE: 2 19987




FIRST FLOOR PLAN



BE (Civil), MIEAust, CPEng No. 449924

SURVEYOR	0	DA ISSUE	6/03/20				C.K. ENGINEERING SERVICES	CLIENT:	DRAWING TITLE:	DRAWN:	M.P.	SIGNED:	DATE: MARCH 2021	
C.M.S SURVEYORS	1	DA ISSUE - AMENDED TO ARCH. DETAILS	20/06/20				ABN 67 115 216 496	RAY & JULIE BALCOMB	FIRST FLOOR PLAN	DESIGNED		16	SCALE: AS SHOW	14/1/
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EVANS AND GREEN							ROSELANDS, NSW 2196	PROJECT:		CHECKED:	C.K.	7	DATUM: AHD	
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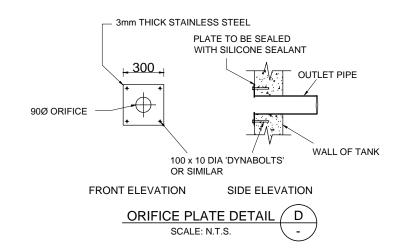


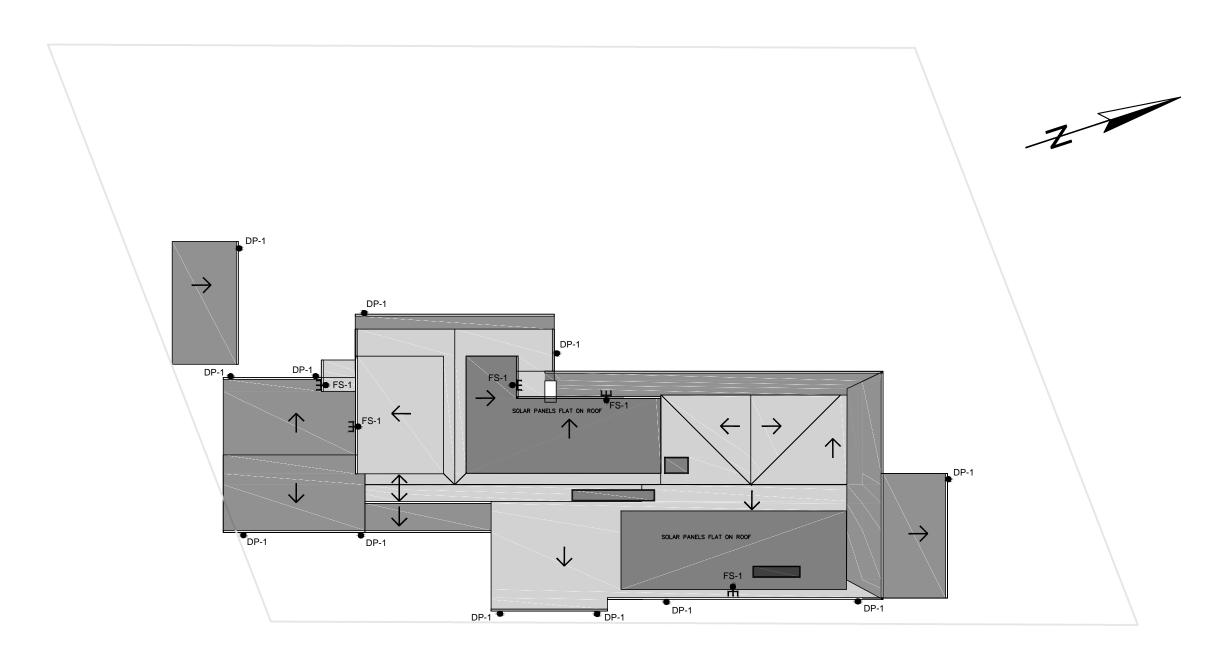
ROOF PLAN



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EVANS AND GREEN				ROSELANDS, NSW 2196	PROJECT:		CHECKED:	C.K.		7	DATUM: AHD
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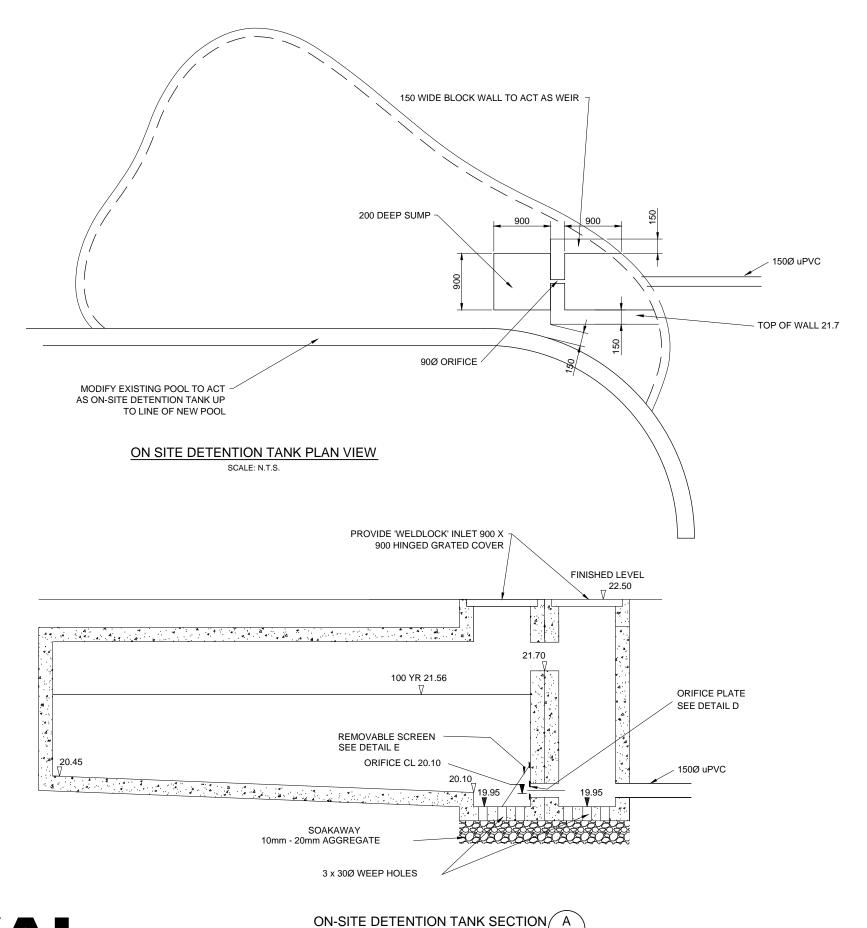






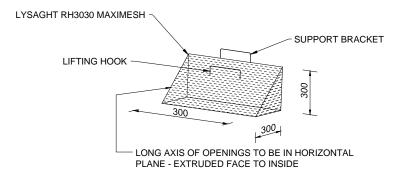

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BN 67 115 216 496 49 FLORA ST ROSELANDS, NSW 2196 MOB: 0403 329 327 EMAIL: ckatsoulas@gmail.com

DRAWING TITLE: ON-SITE DETENTION DETAILS RAY & JULIE BALCOMB PROJECT: 83-85 BOWER STREET MANLY

SCALE: N.T.S.


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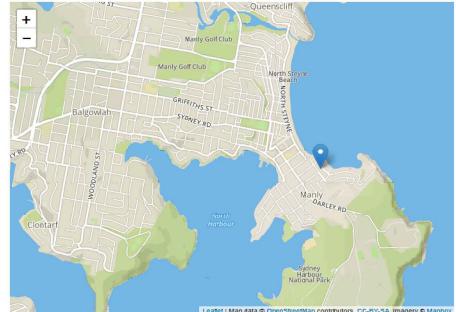
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No. IN SET: 6 OF 8 ISSUE: 2 19987

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C.M.S SURVEYORS	1	DA ISSUE - AMENDED TO ARCH. DETAILS	20/06/20					A E
SUKVETUK	0	DA ISSUE	6/03/20					

Australian Rainfall & Runoff Data Hub - Results



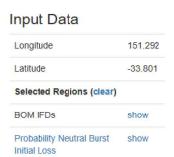

Location

Label: Not provided

Latitude: -33.801 [Nearest grid cell: 33.8125 (S)] Longitude:151.292 [Nearest grid cell: 151.2875 (E)]




Issued: 06 March 2020

IFD Design Rainfall Intensity (mm/h)

Rainfall intensity for Durations, Exceedance per Year (EY), and Annual Exceedance Probabilities (AEP). FAQ for New ARR probability terminology

Table Chart	t					U	nit: mm/h
		Annı	ual Exceed	lance Prol	ability (A	EP)	
Duration	63.2%	50%#	20%*	10%	5%	2%	1%
1 min	153	171	228	269	309	363	406
2 min	129	143	187	218	248	291	325
3 min	118	132	173	202	231	271	303
4 min	111	123	164	192	219	258	288
5 min	105	117	155	182	209	245	274
10 min	82.1	92.0	124	146	168	197	221
15 min	68.3	76.6	103	122	140	165	184
20 min	59.0	66.1	88.8	105	120	142	158
25 min	52.2	58.4	78.4	92.2	106	125	139
30 min	47.0	52.5	70.3	82.7	95.1	112	125
45 min	36.7	41.0	54.6	64.1	73.5	86.4	96.5
1 hour	30.6	34.1	45.3	53.0	60.8	71.5	79.9
1.5 hour	23.6	26.2	34.6	40.5	46.4	54.6	61.1
2 hour	19.6	21.7	28.6	33.5	38.4	45.2	50.7
3 hour	15.1	16.7	22.0	25.7	29.6	34.9	39.2


32 83-85 Bower Street Manly-REV 2.drn - DRAINS

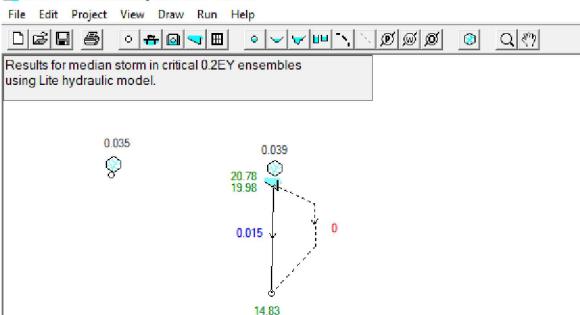

0.2EY (5 YR ARI) RESULTS

SCALE: 1:100



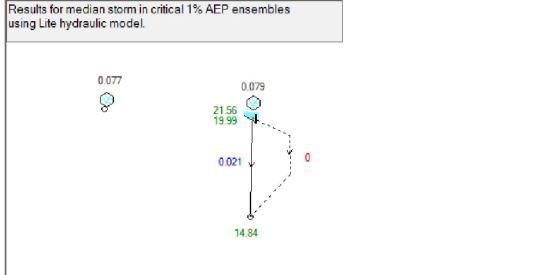

1%AEP (100 YR ARI) RESULTS

SCALE: 1:100

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C.M.S SURVEYORS	1	DA ISSUE - AMENDED TO ARCH. DETAILS	20/06/20				AB
ARCHITECT	2	DA ISSUE - AMENDED TO ARCH. DETAILS	23/03/21				49
EVANS AND GREEN							R(
CONSULTANT	No.	AMMENDMENT	DATE	No.	AMMENDMENT	DATE	M
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ABN 67 115 216 496 49 FLORA ST ROSELANDS, NSW 2196 MOB: 0403 329 327 EMAIL: ckatsoulas@gmail.com

DRAWING TITLE: RAY & JULIE BALCOMB DRAINS CALCULATIONS PROJECT: 83-85 BOWER STREET MANLY


DRAWN: M.P. DESIGNED: C.K. CHECKED: C.K.

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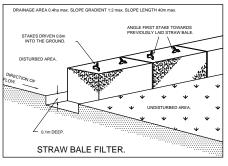
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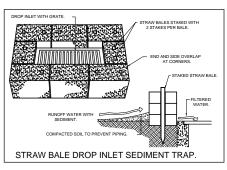
No. IN SET: 7 OF 8 ISSUE: 2








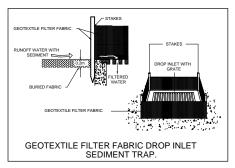



DETAIL (2)

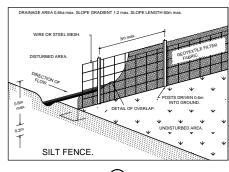






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RAY & JULIE BALCOMB PROJECT: 83-85 BOWER STREET MANLY

JOB & DRAWING No:

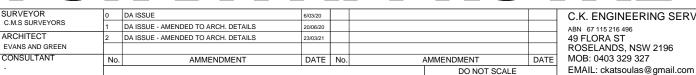19987

DATE: MARCH 2021 SCALE: AS SHOWN DATUM: AHD No. IN SET: 8 OF 8 | ISSUE: 2

DRAWN: M.P. **EROSION AND SEDIMENT CONTROL PLAN** DESIGNED: C.K. CHECKED: C.K.

EROSION CONTROL NOTES:

TEMPORARY CONSTRUCTION EXIT

DETAIL (3)

- ALL WORK SHALL BE CARRIED OUT IN ACCORDANCE WITH COUNCIL'S STANDARD SPECIFICATIONS AND TO THE SATISFACTION OF COUNCIL'S
- EROSION AND SEDIMENTATION CONTROLS SHALL BE CONSTRUCTED AS SHOWN 2. ON SHEET 2 AND 3 OF THIS PLAN AND/OR WHERE DIRECTED BY COUNCIL'S ENGINEER.
- SEDIMENTATION AND EROSION CONTROL DEVICES SHALL BE IMPLEMENTED PRIOR TO OR IN CONJUNCTION WITH THE FIRST PHASE OF EARTHWORKS AND SHALL BE REMOVED ONLY WHEN THE AREAS ABOVE IT HAVE BEEN STABILISED. EACH SEDIMENTATION AND EROSION CONTROL DEVICE SHALL BE INSPECTED AFTER EACH STORM FOR STRUCTURAL DAMAGE OR CLOGGING BY SILT AND OTHER DEBRIS AND PROMPTLY DESILTED, REPAIRED OR REPLACED IF
- TOPSOIL STOCKPILES SHALL BE LOCATED OUTSIDE HAZARD AREAS SUCH AS DRAINAGE DEPRESSIONS.
- ALL AREAS NOT SUBJECT TO CONSTRUCTION WORKS SHALL BE RETAINED FREE FROM DISTURBANCE OR DAMAGE FOR THE DURATION OF THE WORKS.
- TREES TO BE RETAINED SHALL BE PROTECTED DURING SITE WORKS AND CONSTRUCTION BY THE ERECTION OF SOLID BARRICADES AT THE DRIP LINE OR AS SPECIFIED BY COUNCIL'S ENGINEER.
- THE DEVELOPER OR CONTRACTOR WILL TAKE ALL MEASURES TO PREVENT DAMAGE TO TREES AND ROOT SYSTEMS DURING SITE WORKS AND CONSTRUCTION ACTIVITIES INCLUDING THE PROVISION OF WATER, SEWERAGE AND STORMWATER DRAINAGE SERVICES. IN PARTICULAR, WORKS, ERECTION OF STRUCTURES, EXCAVATION OR CHANGES TO SOIL LEVELS WITHIN 4 METRES OF THE TRUNKS OF TREES TO BE RETAINED ARE NOT PERMITTED UNLESS PART OF THE DEVELOPMENT AS APPROVED, AND THE STORAGE OF SPOIL, BUILDING MATERIALS, SOILS OR THE DRIVING OR PARKING OF ANY VEHICLE OR MACHINERY WITHIN 4 METRES OF THE TRUNK OF A TREE TO BE RETAINED, IS NOT PERMITTED.
- WETTING OF THE SITE SHOULD BE CARRIED OUT AS OFTEN AS NECESSARY AS A FORM OF DUST CONTROL.
- SILT FENCES TO BE CONSTRUCTED WHERE EVER NATURAL SURFACE SLOPES AWAY FROM DISTURBED AREAS OR WHERE DIRECTED BY THE ENGINEER.



ABN 67 115 216 496

49 Flora Street, Roselands NSW 2196 Mob: 0403 329 327

e-mail: ckatsoulas@gmail.com

Mr & Mrs R Balcolmb c/- Evans + Green 43 McKell St, Birchgrove NSW 2041

23 March 2021

RE: 83-85 BOWER STREET MANLY — HYDRAULIC SERVICES FOR PROPOSED NEW DWELLING

Dear Anthony,

I hereby certify that the stormwater drainage design prepared by C.K.Engineering Services Drawing No 19987 Revision 2 dated 23 March 2021 is in accordance with:

- Northern Beaches Council's Guidelines and Specifications
- AS/NZS 3500.3 2018 Plumbing and Drainage Stormwater Drainage

I hold appropriate qualifications and relevant experience to issue this certification.

Should you require any further information regarding the above, please contact me on 0403 329 327.

Sincerely,

Con Katsoulas

BE (Civil) MIEAust CPEng NER

Mob: 0403 329 327