

HOMES

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SCHEDULE OF DRAWINGS:

SHEET: DRAWING TITLE:

- TITLE SHEET
- SITE PLAN
- **GROUND FLOOR PLAN**
- FIRST FLOOR PLAN
- **ELEVATIONS 1 ELEVATIONS 2**
- CONCRETE SLAB PLAN
- GND FLOOR ELECTRICAL PLAN
- FIRST FLOOR ELECTRICAL PLAN
- WET AREA DETAILS

AMENDMENT DESCRIPTION:

COLOUR PLANS

CONSTRUCTION MANAGEMENT PLAN

DRAWN: DATE:

17.06.11

SCD

1							
		Paragraph					
This is the plan/spec. referred Fitzgerald Certifiers Certifiers. No. 2011 1523	to in						
Fitzgerald Certifiers Certifi	cate						
No: 2011 152	2						
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Titzgerald Accreditation No.	BLR O	119	CUI	OII	RPI	ZNC	
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RAWSON HOMES

UNIT 34/11-21 UNDERWOOD ROAD **HOMEBUSH NSW 2140** TELEPHONE 02 9764 6442 FAX 02 9764 6992

Builder's Licence No.33493C

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CLIENT: MR & MRS McHUGH SITE ADDRESS: LOT 93 25 MONTAUBAN AVENUE **SEAFORTH**

HOUSETYPE: MODEL:

MANHATTAN 12

Paul Fitzgerald

FACADE:

CLASSIC

DOUBLE GARAGE SPECIFICATION: LUXE+ GOLD

DRAWING TITLE:

TITLE SHEET


DRAWN BY: APPROVED FOR CONSTRUCTION: DATE DRAWN: CHECKED BY: SCD 17.06.11

COUNCIL AREA: SCALE:

MANLY JOB No: DRWG No.: ISSUE:

J/001715

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No 27
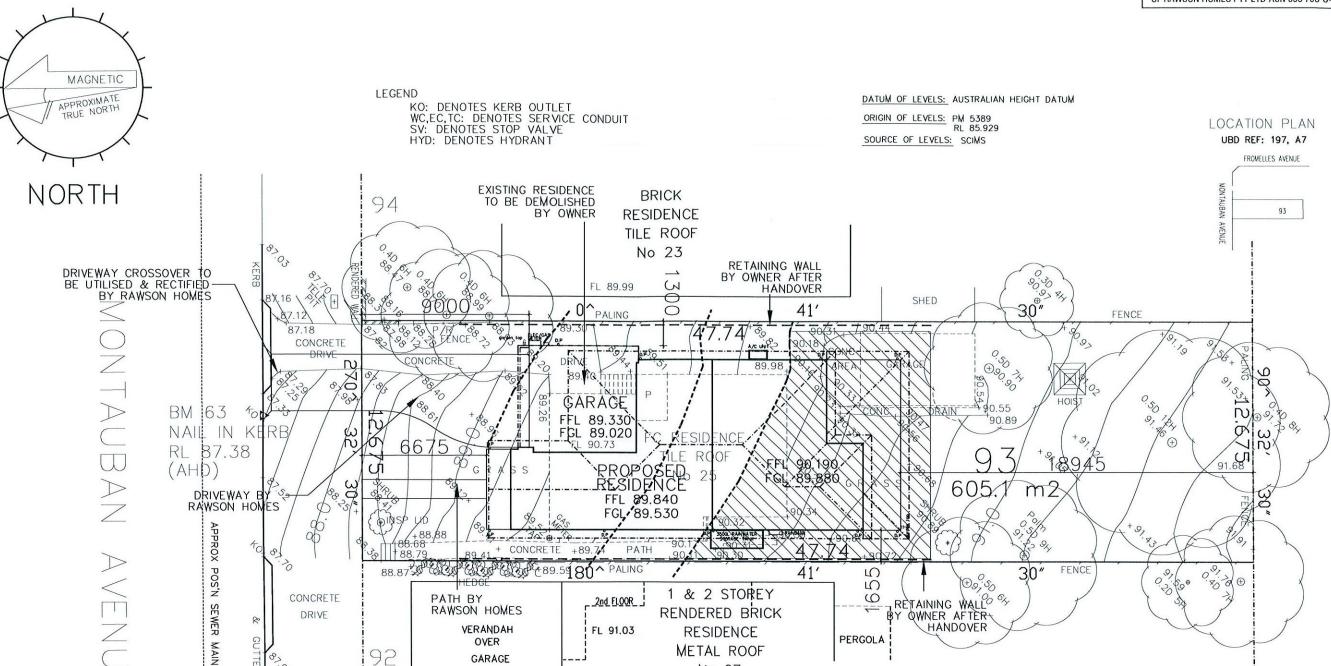
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NOTES:

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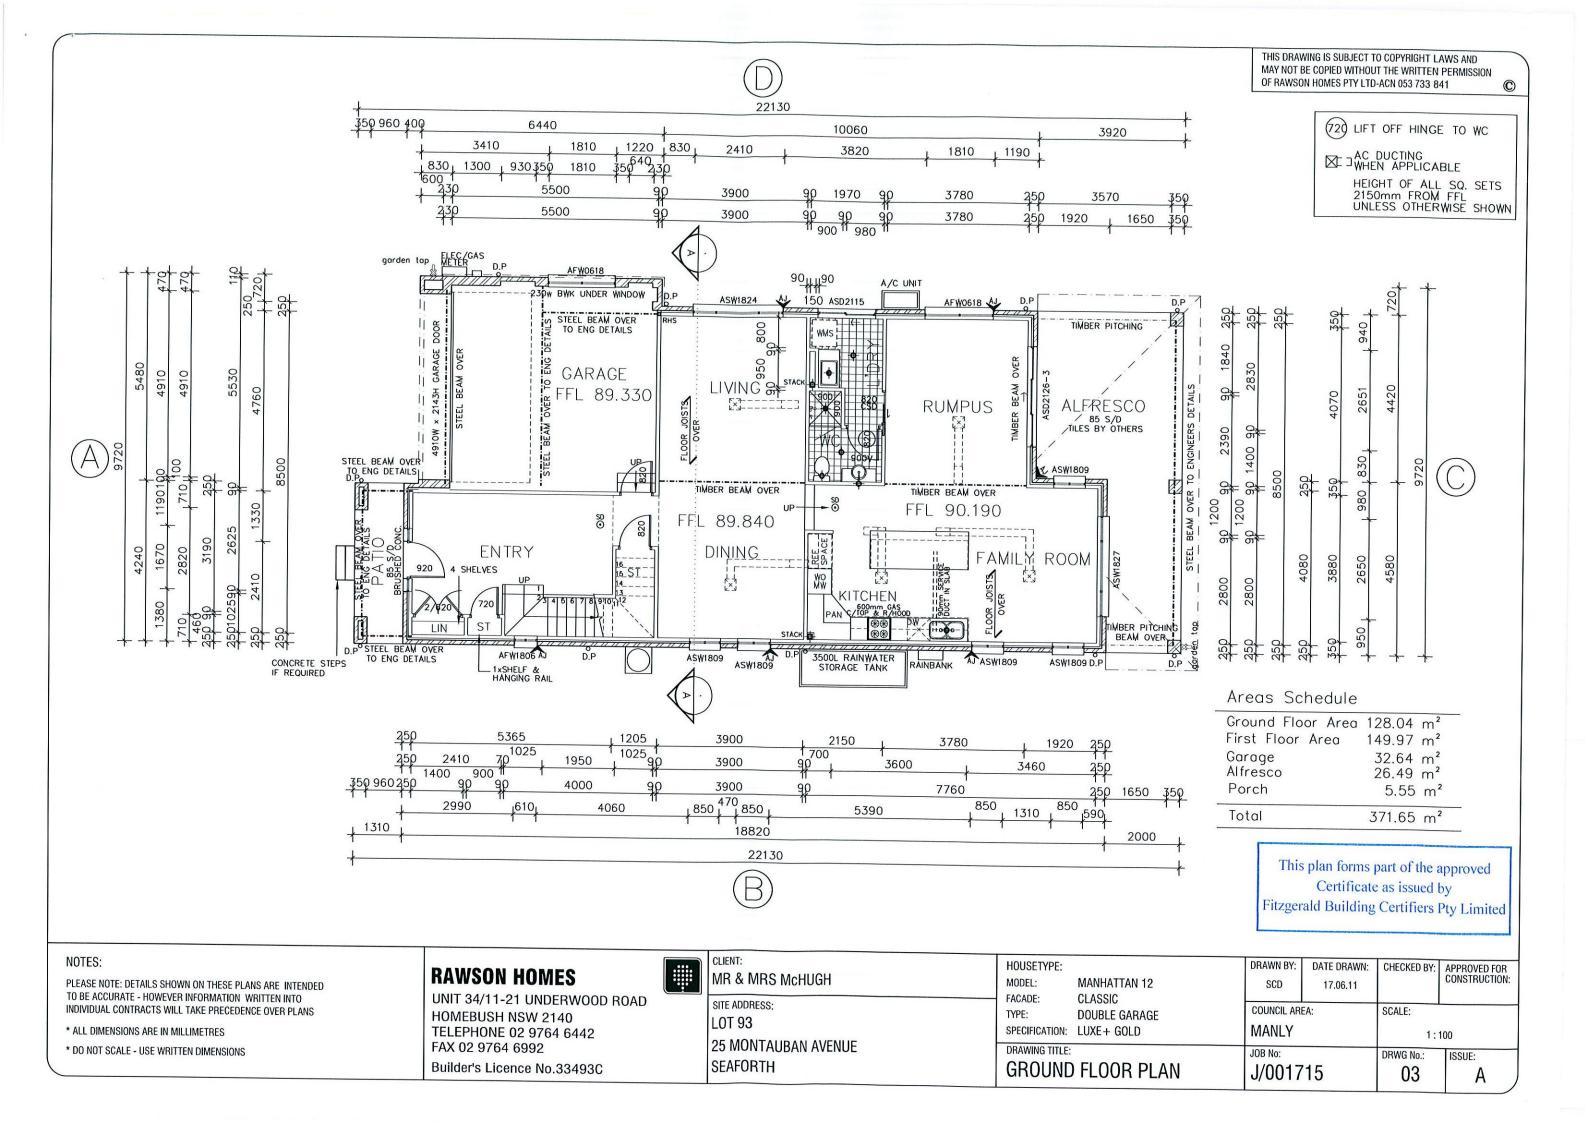
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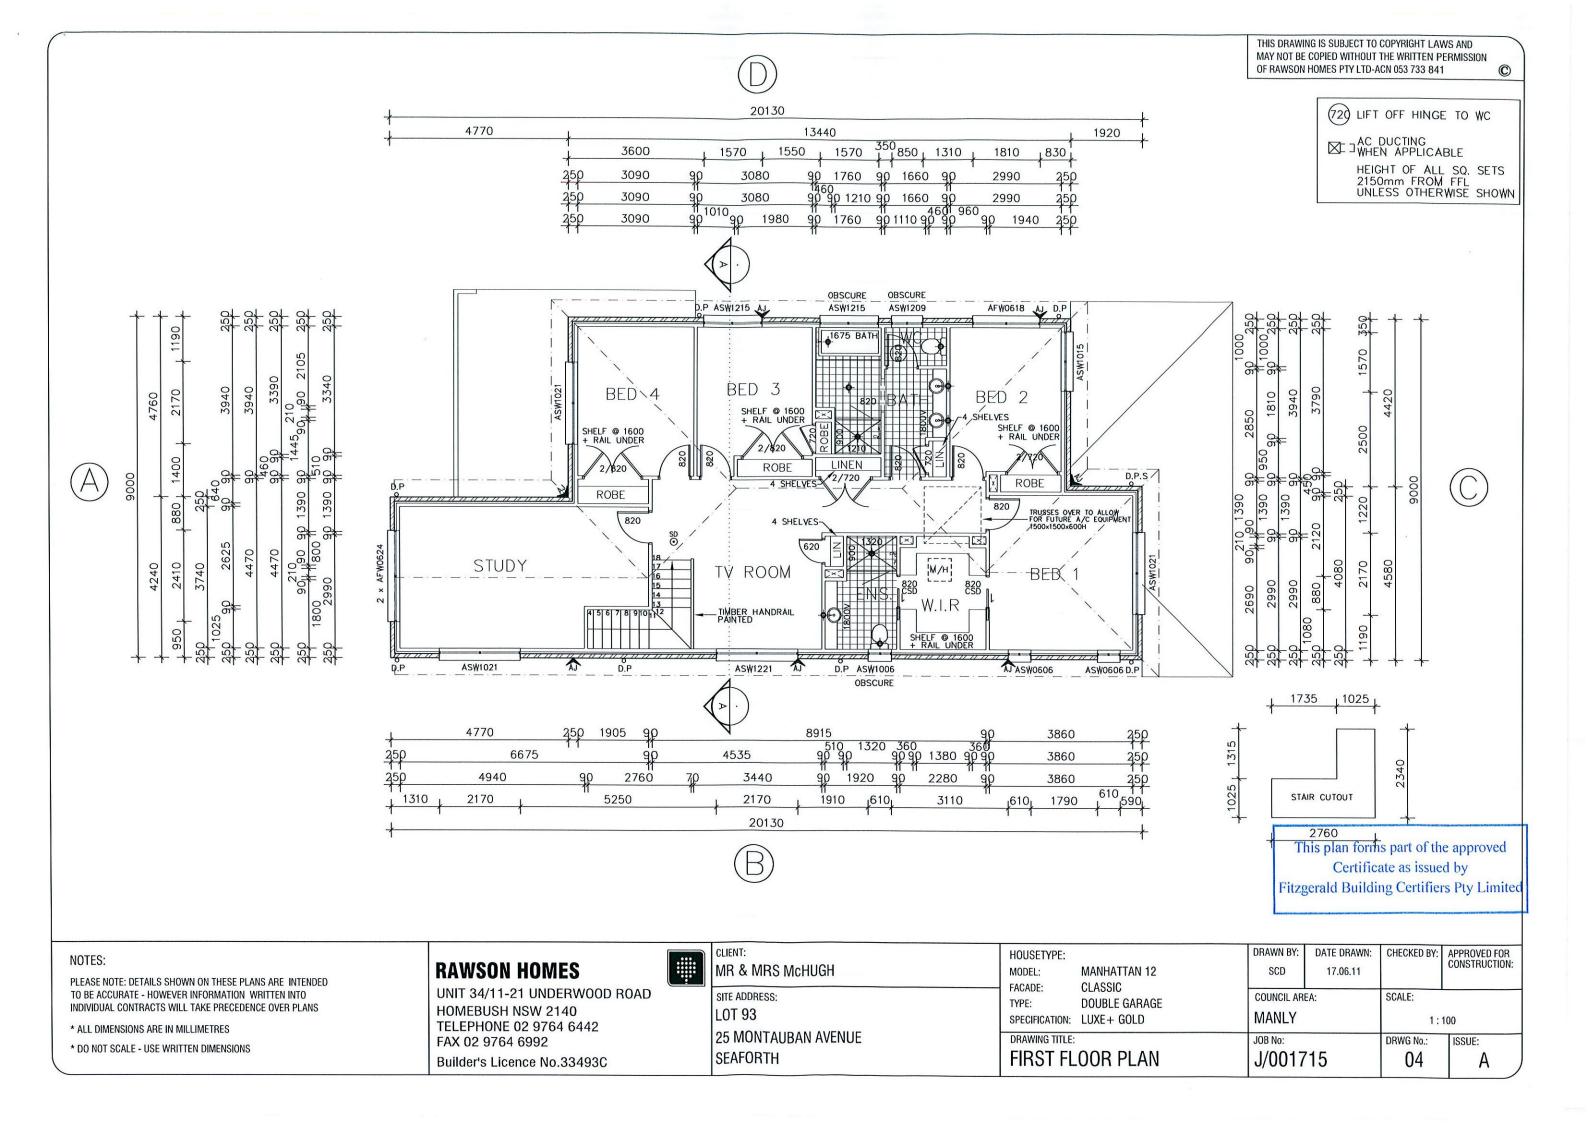
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GARAGE


CLIENT: MR & MRS McHUGH	HOUSETYPE: MODEL: MANHATTAN 12 FACADE: CLASSIC	DRAWN BY: SCD	DATE DRAWN: 17.06.11	CHECKED BY:	APPROVED FOR CONSTRUCTION:
SITE ADDRESS: LOT 93	FACADE: CLASSIC TYPE: DOUBLE GARAGE SPECIFICATION: LUXE + GOLD	COUNCIL AREA: MANLY		SCALE: 1:200	
25 MONTAUBAN AVENUE SEAFORTH	DRAWING TITLE: SITE PLAN	JOB No: J/0017	715	DRWG No.: 02	ISSUE:






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PROVIDE FIBREGLASS MESH FLYSCREENS TO ALL OPEN WINDOWS & SLIDING DOORS



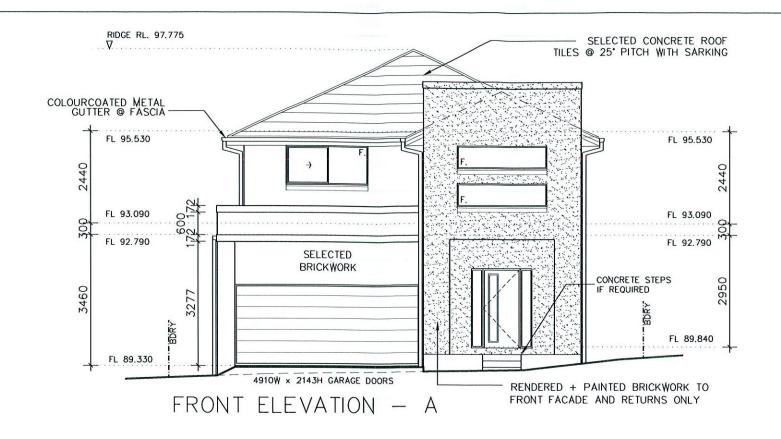
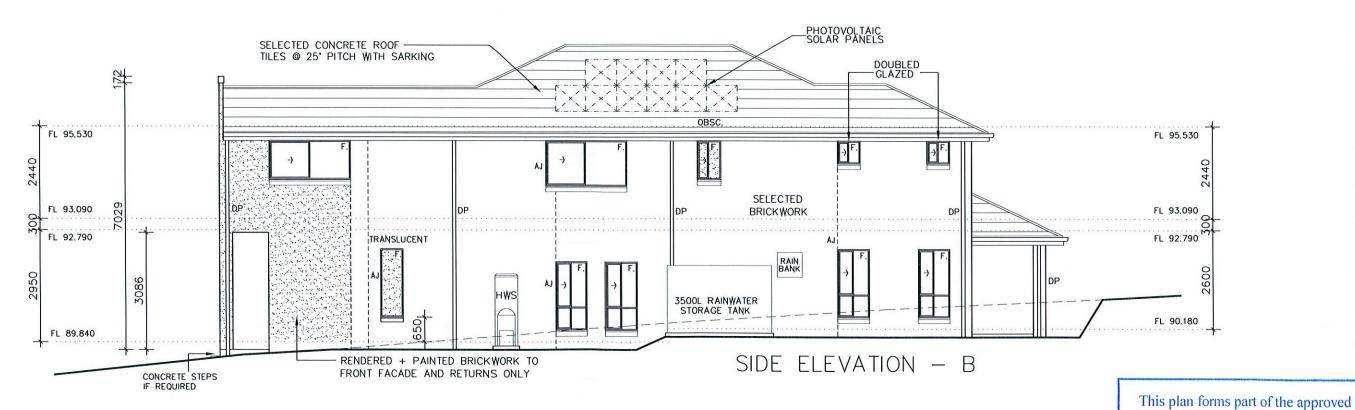
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UNIT 34/11-21 UNDERWOOD ROAD HOMEBUSH NSW 2140 TELEPHONE 02 9764 6442 FAX 02 9764 6992

Builder's Licence No.33493C

CLIENT: MR & MRS McHUGH	
SITE ADDRESS: LOT 93	100
25 MONTAUBAN AVENUE SEAFORTH	

HOUSETYPE:

MODEL: MANHATTAN 12

FACADE: CLASSIC

TYPE: DOUBLE GARAGE

SPECIFICATION: LUXE+ GOLD

DRAWING TITLE:

ELEVATION 1

 DRAWN BY:
 DATE DRAWN:
 CHECKED BY:
 APPROVED FOR CONSTRUCTION:

 COUNCIL AREA:
 SCALE:

 MANLY
 1:100


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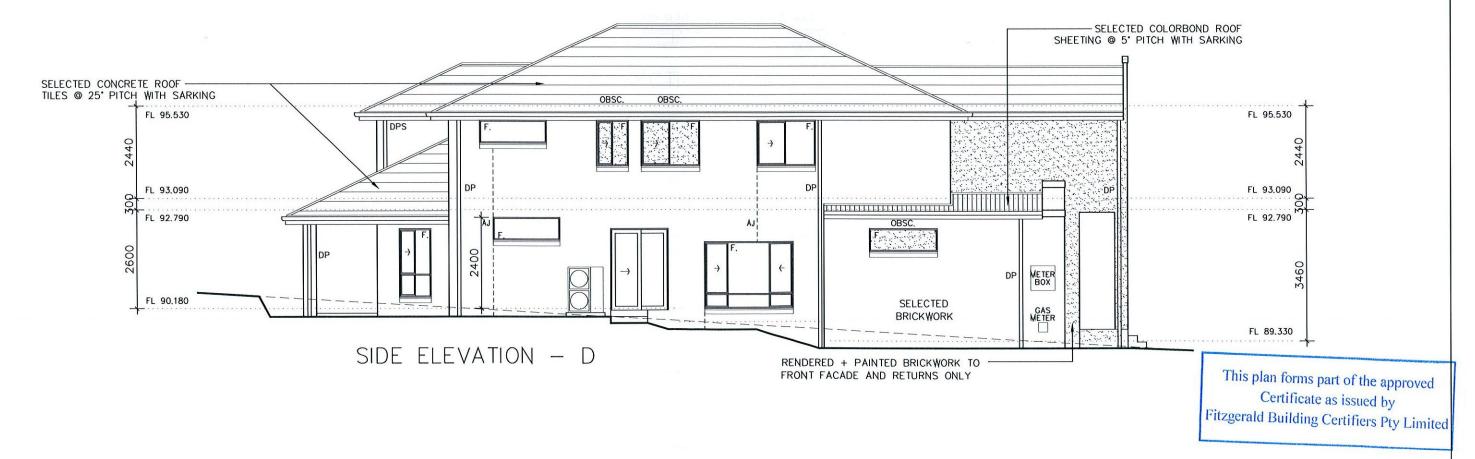
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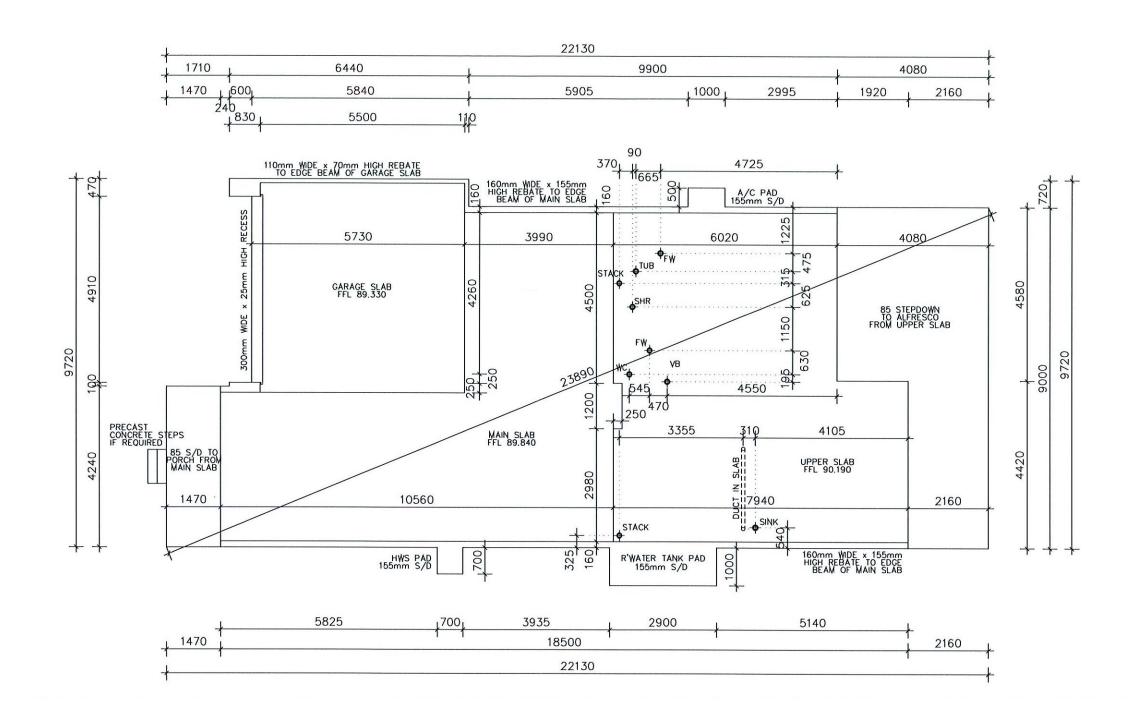
Builder's Licence No.33493C

CLIENT:
MR & MRS McHUGH

SITE ADDRESS:
LOT 93
25 MONTAUBAN AVENUE
SEAFORTH

CHECKED BY: APPROVED FOR CONSTRUCTION: DRAWN BY: DATE DRAWN: HOUSETYPE: MANHATTAN 12 SCD 17.06.11 MODEL: CLASSIC FACADE: COUNCIL AREA: SCALE: DOUBLE GARAGE MANLY SPECIFICATION: LUXE+ GOLD 1:100 DRAWING TITLE: JOB No: DRWG No.: ISSUE: **ELEVATION 2** J/001715 06

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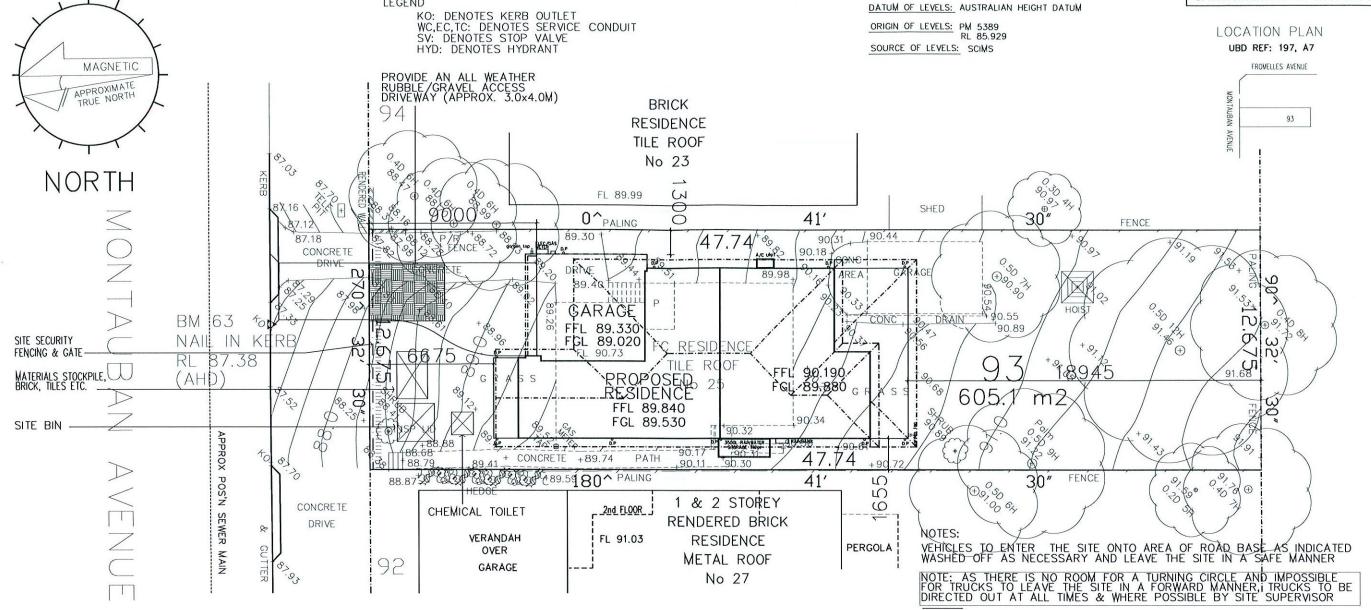
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UNIT 34/11-21 UNDERWOOD ROAD HOMEBUSH NSW 2140 TELEPHONE 02 9764 6442 FAX 02 9764 6992

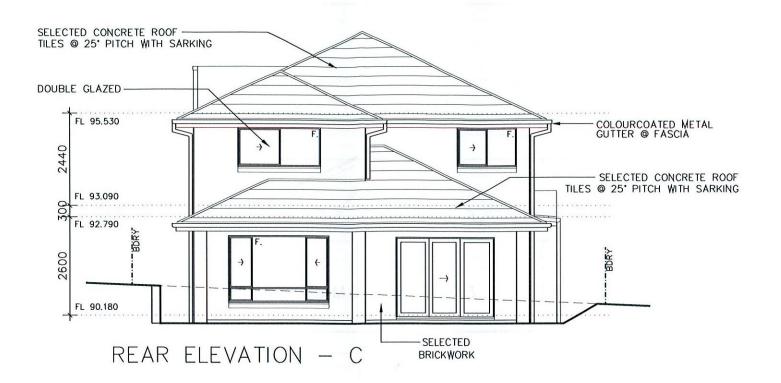CLIENT: MR & MRS McHUGH
 SITE ADDRESS: LOT 93
25 MONTAUBAN AVENUE SEAFORTH

I	HOUSETYPE:		DRAWN BY:	DATE DRAWN:	CHECKED BY:	APPROVED FOR
I	MODEL:	MANHATTAN 12	SCD	17.06.11		CONSTRUCTION:
1	FACADE:	CLASSIC	COLINGII AD	<u> </u>	SCALE:	
ı	TYPE:	DOUBLE GARAGE	COUNCIL AR	EA:	SUALE:	
I	SPECIFICATION:	LUXE+ GOLD	MANLY		1:1	100
	DRAWING TITLE:		JOB No:		DRWG No.:	ISSUE:
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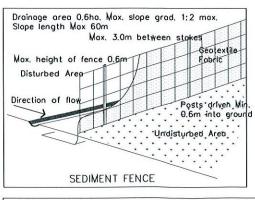



DUST CONTROL MEASURES:

- · SITE TO BE WET DOWN PRIOR TO ANY DEMOLITION OR CONSTRUCTION WORK
- AN AREA OF ROAD BASE WILL BE POSITIONED FOR HEAVY VEHICLES TO REDUCE DUST & PROVIDE AN AREA TO WASH TRUCKS OFF (IF REQUIRED)

NOISE & VIBRATION MEASURES

- · ALL EXCAVATION WILL BE CARRIED OUT BETWEEN THE TIME STIPULATED IN THE COUNCIL CONDITIONS.
- · MACHINERY SIZE WILL BE KEPT TO A MINIMUM REQUIREMENT FOR THE JOB.



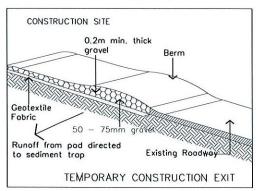

SEDIMENT CONTROL POLICY OBJECTIVE

- * To minimise disturbance to soil and vegetation on the site
- To ensure the protection of the environment by adequately controlling the site to prevent erosion and the export of sediment from the site
- Direct clean uphill water around the building site
- Limit access to one point and stabilise
 Install sediment fences below the site
- Stockpile and protect stripped topsoil Store materials within the sediment fence envelope
- * Provide a protected washout area
- Connect stormwater before roof is laid
- Maintain controls * Respread topsoil and stabili

FOR LOCATION OF SEDIMENT TOON TROL REFER TO SITE PLAN
EXACT LOCATION TO BE DETERMINED ON SITE PLAN
Certificate as issued by

NOTE: -HOURS OF OPERATION: - 7 AM - 5 PM, MONDAY TO FRIDAY. ONLY Building Certifiers Pty Limited

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LEGEND


UNIT 34/11-21 UNDERWOOD ROAD **HOMEBUSH NSW 2140** TELEPHONE 02 9764 6442 FAX 02 9764 6992

Builder's Licence No.33493C



CLIENT: MR & MRS McHUGH	
 SITE ADDRESS: LOT 93	
25 MONTAUBAN AVENUE SEAFORTH	

HOUSETYPE: MODEL:	MANHATTAN 12	DRAWN BY: SCD	DATE DRAWN: 17.06.11	CHECKED BY:	APPROVED FO CONSTRUCTIO
FACADE: TYPE: SPECIFICATION:	CLASSIC DOUBLE GARAGE LUXE+ GOLD	COUNCIL AF	REA:	SCALE:	200
DRAWING TITLE:	MGMT PLAN	JOB No: J/001	715	DRWG No.: 12	ISSUE:

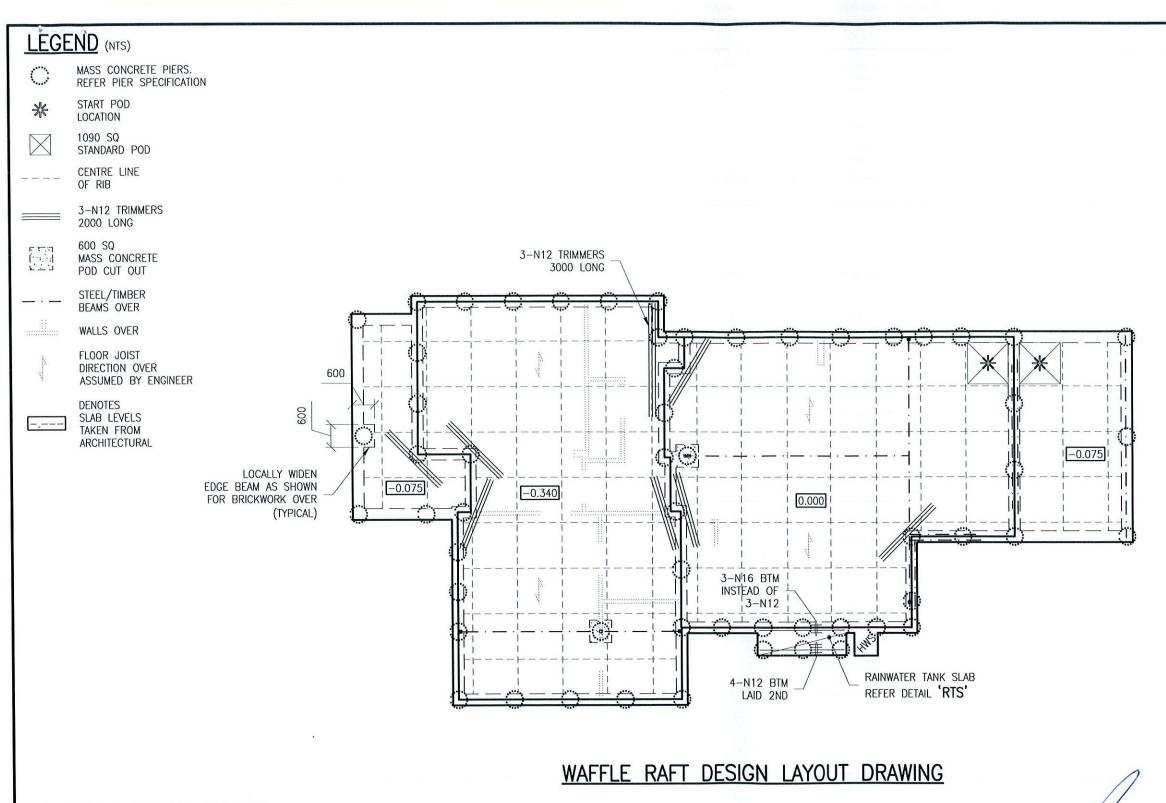

IF IN DOUBT, CONTACT ENGINEER.

	HAVE BEEN PREPARED E WITH ARCHITECTURAL
PREPARED BY:	RAWSON HOMES
DRAWING/JOB No.	- ,
REVISION/ISSUE:	02
DATED:	FEB 11

WAFFLE	RAFT	SPEC	IFICATION
SLAB	THICKNESS:		85
SLA	B FABRIC:		SL72
F'c A	T 28 DAYS:		N20 U.N.O
	SLUMP:		100
MAXIMUM	SIZE AGGREG	GATE	20

THE OWNERS ATTENTION SHALL BE DRAWN TO APPENDIX 'A' 'PERFORMANCE REQUIREMENTS AND FOUNDATION MAINTENANCE' OF AS 2870 AND CSIRO PUBLICATION 'GUIDE TO HOME OWNERS ON FOUNDATION MAINTENANCE AND FOOTING PERFORMANCE'. CURRENT EDITIONS.

ARTICULATION NOTE:

THIS SLAB IS DESIGNED FOR ARTICULATED MASONRY VENEER TYPE CONSTRUCTION AND ARTICULATION JOINTS ARE TO BE PROVIDED AS PER THE B.C.A. VOL.2 CURRENT EDITION

TRUSSED ROOF NOTE:

SLAB HAS BEEN DESIGNED FOR ROOF LOADING TO BE SUPPORTED BY PROPRIETARY TRUSSES ONTO EXTERNAL WALLS ONLY.

PIER SPECIFIC	CATION
DIAMETER Ø	400
F'c AT 28 DAYS:	N15 U.N.O
SLUMP:	80
MAXIMUM SIZE AGGREGATE	20

EXPECTED CONCRETE PIERS/FOOTINGS REQUIRED TO UNIFORM BEARING. ENGINEER AND COUNCIL TO INSPECT GROUND BEARING OF PIERS/FOOTINGS PRIOR TO POURING OF CONCRETE.

ENGINEER TO BE NOTIFIED IF PIERS/FOOTINGS COLLAPSE IN CONSTRUCTION. BUCKET OR SCREW PIERS MAY NEED TO BE USED

SITE CLASSIFICATION	P/M
WIND CLASSIFICATION	N2
SITE LOCATION CLASSIFICATION	SL2

- SL1. LESS THAN 1km FROM BREAKING SURF OR LESS THAN 100m FROM SALT WATER NOT SUBJECT TO BREAKING SURF OR WITHIN HEAVY INDUSTRIAL AREAS.
- SL2. 1km OR MORE BUT LESS THAN 10km FROM BREAKING SURF OR 100m OR MORE BUT LESS THAN 1km FROM SALT WATER NOT SUBJECT TO BREAKING SURF
- SL3. 10km OR MORE FROM BREAKING SURF OR 1km OR MORE FROM SALT WATER NOT SUBJECT TO BREAKING SURF.

REFER BCA CLASS 1 AND CLASS 10 BUILDINGS HOUSING PROVISIONS VOLUME 2 FOR TABLES:

- PROTECTIVE COATINGS FOR STEELWORK (TABLE 3.4.4.2)
 CORROSION PROTECTION OF BUILT-IN STRUCTURAL STEEL MEMBERS (TABLE 3.3.3.2)
- CORROSION PROTECTION FOR WALL TIES (TABLE 3.3.3.1)

DRAWN	DATE	AMENDMENT	REV	CLIENT:	FOR:	NSW: BPB 0255 APPROVED BY: JOB No. DW 3.0.1	/ISION
				MANON S	MR & MRS HART	ENGINEERING QLD: RPEQ 4109 WW Garthy RW391	
			_		SITE ADDRESS:	CONSULTING ENGINEERS A.W. McCARTHY B.Sc.(Eng), M.I.E.Aust, N.P.E.R., C.P.Eng. 12/08/11 1:100 SHEE: 1:100	2000
						1/19 Jonathan Street, Greystanes NSW 2145 T: 02 9896 5494 F: 02 9636 1064 NSW: BPB 0255 CLIENT REF: DRAWN: 3/256 Argyle Street, Moss Vale NSW 2577 T: 02 4869 5003 F: 02 4869 5008 VIC: EC 24609 CLIENT REF: DRAWN: www.residentialengineering.com.au enquiries@residentialengineering.com.au QLD: RPEQ 4109 C.O.	1/9
				Builder's License No.33493C		COPYRIGHT: THIS DRAWING REMAINS THE PROPERTY OF RESIDENTIAL ENGINEERING AND MAY NOT BE ALTERED IN ANY WAY WITHOUT RESIDENTIAL ENGINEERING WRITTI	TTEN CONSENT

GENERAL NOTES

- G1. ENGINEERS STRUCTURAL DRAWINGS ARE SIGNED AND ISSUED D1. STRIP TOPSOIL AND VEGETATION TO A 100mm MINIMUM F1. ON THE UNDERSTANDING THAT THE BUILDER MAINTAINS IN FORCE, PROPER AND ADEQUATE CONTRACT WORKS INSURANCE AND PUBLIC LIABILITY INSURANCE DURING THE FULL COURSE OF THE CONSTRUCTION, AND/OR ANY MAINTENANCE PERIOD. CLAIMS OF DAMAGE TO ANY ADJACENT PROPERTY OR D3. BUILDING IS NOT THE RESPONSIBILITY OF THE ENGINEER.
- THESE DRAWINGS SHALL BE READ IN CONJUNCTION WITH ALL ARCHITECTURAL AND OTHER CONSULTANTS DRAWINGS AND SPECIFICATIONS AND WITH SUCH OTHER WRITTEN INSTRUCTIONS AS MAY BE ISSUED DURING THE COURSE OF THE CONTRACT. ALL DISCREPANCIES SHALL BE REFERRED TO THE ARCHITECT FOR DECISION BEFORE PROCEEDING WITH
- DURING CONSTRUCTION THE BUILDING SHALL BE MAINTAINED IN A STABLE CONDITION AND NO PART SHALL BE OVERSTRESSED AT ANY TIME. TEMPORARY BRACING SHALL BE PROVIDED BY THE CONTRACTOR AS REQUIRED. THE CONTRACTOR SHALL BE RESPONSIBLE FOR ANY DAMAGE TO THE WORKS DURING CONSTRUCTION.
- ALL WORKMANSHIP AND MATERIALS SHALL BE IN ACCORDANCE D4. WITH THE REQUIREMENTS OF THE CURRENT EDITIONS OF THE SAA CODES AND THERE-BY LAWS AND ORDINANCES OF THE RELEVANT BUILDING AUTHORITY
- DIMENSIONS SHALL NOT BE OBTAINED BY SCALING THE STRUCTURAL DRAWINGS. REFER TO ARCHITECTURAL DRAWINGS D5. FOR SET OUT PLAN MEASUREMENTS. ANY SET OUT DIMENSIONS SHOWN ON THIS DOCUMENT SHALL BE VERIFIED
- ANY DISCREPANCIES/SUBSTITUTION IN THESE DOCUMENTS D6. SHALL BE REFERRED TO THE ENGINEER FOR DECISION BEFORE PROCEEDING WITH THE WORK
- THE SECTIONS/DETAILS ON THESE DRAWINGS ARE INTENDED TO GIVE THE STRUCTURAL SPECIFICATIONS ONLY. ARCHITECTURAL SECTIONS/DETAILS ON THESE DRAWINGS ARE ILLUSTRATIVE ONLY.
- THESE DOCUMENTS ARE SIGNED SUBJECT TO CERTIFICATE OF D7. INSPECTION BEING ISSUED BY THIS FIRM. ALL PIERS, SLAB AND FOOTING REINFORCEMENT SHALL BE INSPECTED BY THE FNGINFER PRIOR TO THE POURING OF CONCRETE. GIVE 24hrs NOTICE TO THE ENGINEER.

SITE CLASSIFICATION

- THE SITE HAS BEEN CLASSIFIED BY RESIDENTIAL ENGINEERING IN ACCORDANCE WITH AS 2870 RESIDENTIAL SLABS AND FOOTINGS. THESE DOCUMENTS HAVE BEEN PREPARED USING P2. THE ABOVE CODE ON THE BASIS OF A 'M' CLASSIFICATION, HOWEVER, THE SOIL TYPE AND SITE CONDITIONS SHOULD BE CHECKED BY THIS CONSULTANCY PRIOR TO THE PLACEMENT P3. OF CONCRETE
- C2. THE FOOTING DETAILS SHOWN ARE FOR THE SITE P4. CLASSIFICATION STIPULATED. WHILE EVERY CARE HAS BEEN PS. TAKEN TO VERIFY THAT THE INFORMATION SHOWN IS CORRECT, RESIDENTIAL ENGINEERING TAKES NO RESPONSIBILITY FOR VARIATIONS WHICH MAY OCCUR IN SITE CONDITIONS SUBSECUENT TO CONSTRUCTION.
- C3. IF THE SITE HAS BEEN THE SUBJECT OF A GEOTECHNICAL INVESTIGATION REQUIRING ADHERENCE TO PARTICULAR CONSTRUCTION PROCEDURES AND/OR TECHNIQUES. THE REQUIREMENTS OF THE APPROPRIATE QUALIFIED GEOTECHNICAL ENGINEER'S REPORT SHALL BE COMPLIED WITH IN FULL.

ALL REFERENCE TO AUSTRALIAN STANDARDS AND B.C.A TO BE CURRENT EDITION.

IF IN DOUBT CONTACT ENGINEER.

SITE PREPARATION AND DRAINAGE

- DEPTH AND STOCKPILE.
- THE SITE IS TO BE BENCHED BY CUT AND FILL TO DESIRED F2. LEVELS.
- ANY FILL USED IN THE CONSTRUCTION OF A SLAB EXCEPT WHERE THE SLAB IS SUSPENDED SHALL CONSIST OF "ROLLED OR CONTROLLED FILL".
- D3A. ROLLED FILL SHALL BE PLACED IN LAYERS OF 150mm MAXIMUM IN ACCORDANCE WITH AS 2870 AND THOROUGHLY COMPACTED USING AN EXCAVATOR, UNLESS THIS FILL IS COMPACTED IN ACCORDANCE WITH AS 2870 IT IS NOT ADEQUATE FOR THE LONG TERM STRUCTURAL SUPPORT TO THE SLAB/FOOTING SYSTEM, THEREFORE PIERS MUST BE INSTALLED.
- D3B. CONTROLLED FILL SHALL BE PLACED, TESTED AND CERTIFIED BY A QUALIFIED GEOTECHNICAL ENGINEER AS DEFINED IN AS 3798. THIS IS THEN DEEMED TO BE ADEQUATE TO SUPPORT THE SLAB/FOOTING SYSTEM.
- THE FILL IS TO EXTEND PAST THE EDGE OF THE SLAB BY AT LEAST ONE METRE AND SHALL BE BATTERED OFF NOT STEEPER THAN TWO HORIZONTALLY TO ONE VERTICAL OR RETAINED BY A SUITABLE STRUCTURE PROVIDED BY THE OWNER OR BUILDER AS SOON AS POSSIBLE.
- THE FINISHED LEVELS ABOVE THE ADJACENT GROUND SHALL ALLOW FOR THE MAIN SLAB TO BE AT LEAST:

D5A. STIFFENED RAFT: 150mm

D5B. WAFFLE RAFT: 300mm

- SURFACE DRAINAGE SHALL BE PROVIDED AS REQUIRED TO AVOID THE POSSIBILITY OF WATER PONDING NEAR THE SLAB. A FALL OF 50mm OVER A DISTANCE OF ONE METRE AWAY FROM THE SLAB IS CONSIDERED ADEQUATE. SUBSOIL DRAINS (AGRICULTURAL DRAINS) ARE CONSIDERED DESIRABLE BUT SHOULD BE AVOIDED BEING LOCATED DIRECTLY ADJACENT TO THE FOOTINGS.
- IF ANY FOOTING IS LOCATED SUCH THAT A LINE DRAWN AT 45' FOR CLAY AND 30' FOR SAND FROM ITS BASE INTERSECTS A SERVICE TRENCH THEN PIERS ARE REQUIRED, RFFFR SERVICE TRENCH DETAIL

PIERS

- PIER DIAMETER AND LOCATIONS ARE SHOWN ON PLAN. ONLY WITH THE PRIOR APPROVAL OF THE ENGINEER MAY THE PIER DIAMETER BE VARIED AS PER THE "PIER DIAMETER TABLE".
- U.N.O MINIMUM PIER DEPTH IS 600mm BELOW FOOTING TRENCH AND WHEREVER NOMINATED SHOULD BE SOCKETED A MINIMUM 300mm INTO STIFF CLAY.
- ALL PIER HOLES SHALL BE CLEANED AND DE-WATERED PRIOR TO THE PLACEMENT OF CONCRETE.

ALL PIERS SHALL BE POURED SEPARATE TO RAFT SLAB.

IT SHOULD BE NOTED THAT IF ANY OF THE FOOTING BEAMS ENCOUNTER ROCK OR SHALE, THEN ALL BEAMS AND LOAD BEARING SPINE BEAMS SHALL BE PIERED TO ROCK OR SHALE. IF PARTIALLY PIERED TO ROCK THEN BRICK JOINTS ARE TO BE PROVIDED AT THE ROCK/NON-ROCK INTERFACE.

	PIER DIAME	ILN IA	DLL
STRATA	MINIMUM BEARING CAPACITY 'kPa'	SINGLE STOREY	DOUBLE STOREY
STIFF CLAY	250	ø400 AT 2.0m CTS	ø450−2.0m CTS OR ø400−1.5m CTS
ROCK AND SHALE	600	ø400 AT 2.0m CTS	ø400-2.0m CTS
natural Sand	150	REFER PLAN	REFER PLAN

FOOTING AND SLAB NOTES

- ALL WORKMANSHIP AND MATERIALS SHALL BE IN ACCORDANCE WITH AS 3600 AND AS 2870
- IT IS THE RESPONSIBILITY OF THE CONTRACTOR TO ENSURE PIER TOPS ARE CLEAN OF FOREIGN MATTER PRIOR TO THE PLACEMENT OF THE MEMBRANE AND CONCRETE SLAB. ENGINEER'S SPOT K2. ALL CONCRETE SHALL BE MECHANICALLY VIBRATED. CHECK DOES NOT RELEASE THE CONTRACTOR FROM THIS RESPONSIBILITY.
- F3. 50 THICK SAND LEVELLING LAYER:
 - F3A. STIFFENED RAFT: PLACE A NOMINAL 50 THICK SCREEDED SAND LEVELING LAYER, DROP PANELS IF REQUIRED ARE TO BE FORMED UP IN THE SAND SCREED.

F.3B. WAFFLE RAFT: OPTIONAL

- SUBTERRANEAN TERMITE PROTECTION IS TO BE PROVIDED IN ACCORDANCE WITH THE REQUIREMENTS OF AS 3660.1
- A HIGH IMPACT RESISTANT DAMP PROOF MEMBRANE MUST BE PLACED BENEATH THE SLAB SO THAT THE BOTTOM OF THE SLAB IS ENTIRELY UNDERLAIN. THE DAMP PROOF MEMBRANE MUST BE 0.2mm NOMINAL THICKNESS POLYTHENE FILM AND OF HIGH IMPACT RESISTANCE, LAPS SHALL BE 200mm MINIMUM AT JOINTS. ALL PLUMBING PENETRATIONS AND JOINTS ARE TO BE TAPED AND K6. MADE WATERPROOF. THE SITE IS TO BE PROPERLY DRAINED TO ELIMINATE SURFACE AND SUBSOIL WATER FLOW.
- ALL REINFORCEMENT SHALL BE FIRMLY SUPPORTED ON INSULATED STEEL, PLASTIC OR CONCRETE CHAIRS. BAR CHAIRS SHALL BE PLACED SUCH THAT REINFORCEMENT IS ALWAYS POSITIONED WITH
- F7. IF TRENCH MESH IS USED REINFORCEMENT SHALL BE LAPPED 500 AT SPLICES AND PLACED ON CHAIRS TO GIVE SPECIFIED K7. THE OWNERS ATTENTION SHALL BE DRAWN TO APPENDIX 'A' COVER, LAP REINFORCEMENT AT 'T' AND 'L' JUNCTIONS FULL WIDTH ACROSS THE JUNCTION.
- IF SLAB FABRIC IS USED IT IS TO BE SUPPLIED IN FLAT SHEETS AND IS TO BE LAPPED ONE FULL SQUARE PLUS 25mm AT SPLICES AND PLACED ON BAR CHAIRS AT ONE METRE CENTRES BOTH WAYS UNLESS REDUCED SPACING IS SPECIFIED.
- F8A. STIFFENED RAFT: AT EACH DROP PANEL PLACE A 100mm CHAIR ON THE PIER TOP TO ENSURE ACCURATE FABRIC LOCATION.
- SPLICES IN REINFORCEMENT SHALL BE MADE ONLY IN THE POSITIONS SHOWN. THE WRITTEN APPROVAL OF THE ENGINEER SHALL BE OBTAINED FOR ANY OTHER SPLICES. WHERE LAP LENGTHS ARE NOT SHOWN THEY SHALL SATISFY THE REQUIREMENTS OF AS 3600.
- WELDING OF REINFORCEMENT OTHER THAN TACK WELDING FOR PURPOSE OF MAINTAINING BARS IN CORRECT POSITION IS NOT PERMITTED UNLESS SPECIFICALLY NOMINATED ON THE DRAWINGS OR AS DIRECTED BY THE ENGINEER
- F11. BEAM WIDTH:
 - F11A. STIFFENED RAFT: WHERE EXTERNAL BEAMS ARE WIDER THAN THAT SPECIFIED, AN EXTRA BOTTOM BAR OR EQUIVALENT OF THE SAME BAR SIZE IS REQUIRED FOR EACH 100mm ADDITIONAL WIDTH.
 - F11B. WAFFLE RAFT: REFER TO TABLE(S) TOTAL REINFORCEMENT REQUIREMENTS WITHIN FOOTING BEAMS AND STEM WIDTH REQUIREMENTS FOR DEEPENED BEAMS
- F12. REINFORCEMENT IS REPRESENTED DIAGRAMMATICALLY ONLY, IT IS NOT NECESSARILY SHOWN IN TRUE PROJECTION
- F13. PIPE PENETRATIONS IN THE EDGE AND SPINE BEAMS ARE TO BE CARRIED OUT IN ACCORDANCE WITH THE DETAILS. WHERE SLAB FABRIC IS CUT TO PERMIT PENETRATIONS OF PIPES, A 600x600 PIECE OF FABRIC IS TO BE SPLICED OVER THE PENETRATION.
- F14. FOR 'H' AND 'E' CLASS SITES ALL PENETRATIONS THROUGH FOOTINGS AND EDGE BEAMS SHALL BE SLEAVED TO ALLOW FN1 MINIMUM 20mm ('H1' CLASS) AND 40mm ('H2' & 'E' CLASS) MOVEMENT AS PER AS 2870. ALL PLUMBING AND DRAINAGE SERVICES ARE TO BE FITTED WITH FLEXIBLE CONNECTIONS AS
- F15. PIPES OR CONDUITS SHALL NOT BE PLACED WITHIN THE CONCRETE COVER TO REINFORCEMENT WITHOUT THE FN3. UNO CONCRETE TO BE STRENGTH N20 WITH A 20mm APPROVAL OF THE ENGINEER.
- F16. BEAM DEPTHS ARE WRITTEN FIRST AND INCLUDE SLAB THICKNESS IF ANY, THICKNESS OF APPLIED FINISHES ARE NOT INCLUDED.

CONTROL OF PLASTIC SHRINKAGE AND SLAB MAINTENANCE

- WATER IS NOT TO BE ADDED TO THE CONCRETE ON SITE SO T1. ALL WORKS TO BE IN ACCORDANCE WITH AS 3660.1 AS TO INCREASE THE SLUMP ABOVE THAT SPECIFIED.
- VIBRATORS SHALL NOT BE USED TO SPREAD CONCRETE.
- CURING THE CONCRETE SHALL START IMMEDIATELY AFTER FINISHING BY CONTINUALLY WETTING FOR 7 DAYS MINIMUM PLASTIC OR WAX LIQUID SPRAYS MAY BE USED IN ACCORDANCE WITH THE MANUFACTURERS SPECIFICATIONS. EXTRA PRECAUTION SUCH AS THE METHOD OF EVAPORATIVE RETARDATION (THE USE OF ALIPHATIC ALCOHOLS) IS RECOMMENDED DURING HOT WEATHER POURS TO HELP AVOID THERMAL RELATED SLAB CRACKING.
- K4. CONSTRUCTION JOINTS WHERE NOT SHOWN SHALL BE LOCATED TO THE APPROVAL OF THE ENGINEER
- NO HOLES OR CHASES OTHER THAN THOSE SHOWN ON THE STRUCTURAL DRAWINGS SHALL BE MADE IN CONCRETE ELEMENTS WITHOUT THE PRIOR APPROVAL OF THE ENGINEER.
- CAUTION SHOULD BE EXERCISED WHEN APPLYING BRITTLE FINISHES SUCH AS CERAMIC TILES TO THE FLOOR SLAB. BRITTLE FLOOR COVERINGS ARE TO BE LAID ON A SUITABLE M4. FLEXIBLE TYPE BEDDING SYSTEM AND SUPPLIED WITH CONTROL JOINTS AT 400mm CENTRES MAXIMUM. ALTERNATIVELY SL92 FABRIC CAN BE USED, AS/IF ADVISED BY THE BUILDER ALTERNATIVELY FINISHES TO BE DELAYED FOR 3 MONTHS, REFER TO AS 2870 OR AS 3958.
- PERFORMANCE REQUIREMENTS AND FOUNDATION MAINTENANCE' OF AS 2870 AND CSIRO PUBLICATION 'GUIDE TO HOME OWNERS ON FOUNDATION MAINTENANCE AND FOOTING PERFORMANCE'.

REINFORCEMENT LAP TABLE

NOTE: BAR REINFORCEMENT IS TO BE TIED BENEATH THE FABRIC IF USED OR OTHERWISE PLACED ON BAR CHAIRS AND LAPPED AT SPLICES AS FOLLOWS:

	2 - 172-1-172	A STATE OF THE STA				
BAR SIZE	N12	N16	N20	N24	N28	N32
LAP LENGTH	450	600	800	1200	1350	1650
TAXABLE VALUE OF TAXABLE PARTY.						

REINFORCEMENT COVER TABLE

	SHEL	TERED A	REAS	EXPOSED AREAS			
ELEMENT -	TOP	ВТМ	SIDES	TOP	ВТМ	SIDES	
SLAB	20	40	40	40	40	40	
BEAMS	-	40	40	40	40	40	
STRIP FOOTINGS	_	=	-	50	50	50	
PIERS	-	-	50	-	-	50	

NOTE: BEAMS AND SLAB IN THIS TABLE ARE CONSIDERED TO HAVE AN INTACT MEMBRANE IN CONTACT WITH THE GROUND. BEAMS AND SLABS POURED DIRECTLY AGAINST THE GROUND ARE TO HAVE 50mm CLEAR COVER ALL-ROUND

STRIP FOOTING NOTES


- STRIP FOOTINGS SHALL BEAR ON FIRM UNIFORM NATURAL STRATA WITH A SAFE/MINIMUM BEARING CAPACITY AS PER THE PIER DIAMETER TABLE
- FN2. MASS CONCRETE PIERS MAY BE REQ'D: REFER PIER NOTES AND THE PIER SPECIFICATION
- MAXIMUM AGGREGATE SIZE AND 100Him BUUMP forms part of the approved

NOTES REGARDING SUB-TERRANEAN TERMITE PROTECTION

- T2. ANY FUTURE CRACKING OCCURRING IN THE SLAB/FOOTING SYSTEM IS TO BE ASSESSED BY A QUALIFIED PEST EXPERT AND WHERE DIRECTED BE SEALED BY EPOXY INJECTION
- INSPECTIONS OF THE RESIDENCE AND IMMEDIATE SURROUNDS TO BE CARRIED OUT BY A QUALIFIED PEST EXPERT ON AN ANNUAL BASIS BY THE HOME OWNER.
- SITE MAINTENANCE IS THE RESPONSIBILITY OF THE HOME OWNER. ALL RECOMMENDATIONS OUTLINED BY THE CSIRO SHEET 10-91 SHOULD BE CARRIED OUT.

MASONRY NOTES

- M1. LOAD BEARING MASONRY SHALL COMPLY WITH AS 3700
- M2. MASONRY AND MORTAR DURABILITY SHALL COMPLY WITH THE B.C.A. CLASS 1 AND 10 BUILDINGS VOLUME 2.
- MASONRY SHALL BE ARTICULATED IN ACCORDANCE WITH THE B.C.A CLASS 1 AND 10 BUILDINGS VOLUME 2.
- INTERNAL BRICKWORK BUILT OFF THE SLAB SHALL BE LAID ON TWO LAYERS OF 'ALCOR' OR '3 PLY MALTHOID' OR SIMILAR SLIP JOINT MATERIAL
- M5. MASONRY WALLS MUST NOT BE BUILT ON CONCRETE SLABS OR BEAMS UNTIL ALL FORMWORK/PROPS SUPPORTING THESE SLABS AND BEAMS HAVE BEEN REMOVED.

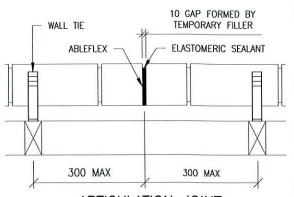

ARTICULATION JOINT AND WALL TIE DETAIL

ALL WALL TIES TO BE BUILT IN AND FIXED TO FRAME PROGRESSIVELY AS CONSTRUCTION PROCEEDS SPACED AT EACH SIDE OF EXPANSION JOINTS AND AT EACH THIRD COURSE. THE SPACING OF ALL OTHER TIES SHALL BE AS DESCRIBED IN THE B.C.A CLASS 1 AND 10 BUILDINGS HOUSING PROVISIONS VOLUME 2

WIND/WALL TIE CLASSIFICATION WIND WALL TIE HORIZONTAL VERTICAL (DUTY) SPACING SPACING (Vp) CLASS LIGHT N1 W28N1 600mm 600mm W33N2 **MEDIUM** N2 600mm 600mm

NOTE:

W41N3

N3

WALL TIE SPACINGS AROUND OPENINGS 300cts EW. POLYMER WALL TIES RATED "LIGHT DUTY ONLY" (W28N1

600mm

• (Vp = PERMISSABLE STRESS METHOD).

MEDIUM

Certificate as issued by Fitzgerald Buildin

ers Pty Limited A.W. McCARTHY

B.Sc.(Eng), M.I.E.Aust, N.P.E.R., C.P.Eng. NSW: BPB 0255

OLD: RPFO 4109

RW391 SCALE: 12/08/11 CLIENT REF DRAWN

SHEET No.

430mm

5 COURSE

REVISION

RAWSON JNIT 34/11-21 UNDERWOOD ROAD OMEBUSH NSW 2140 ELEPHONE 02 9764 6442 AX 02 9764 6992 uilder's License No.334930

AMENDMENT

MR & MRS HART

SITE ADDRESS LOT 17 (178) WYADRA AVENUE, NORTH MANLY

3/256 Argyle Street, Moss Vale NSW 2577

1/19 Jonathan Street, Greystanes NSW 2145 T: 02 9896 5494 F: 02 9636 1064 T: 02 4869 5003

CONSULTING ENGINEERS

F: 02 4869 5008


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NSW: BFD 02.3


REQ 4109


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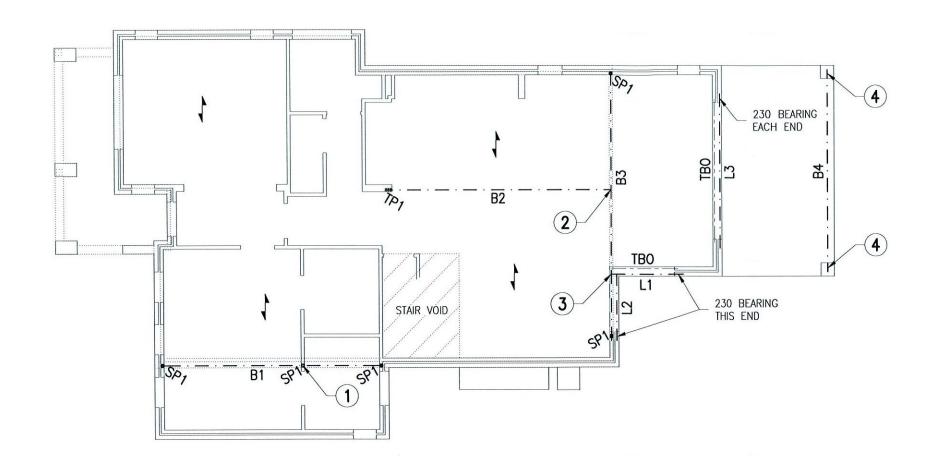
DATE



QLD: RPEQ 4109 HOMES SHEET No. SCALF: A.W. McCARTHY 12/08/11 1:20 B.Sc.(Eng), M.I.E.Aust, N.P.E.R., C.P.Eng UNIT 34/11-21 UNDERWOOD ROAD LOT 17 (178) WYADRA AVENUE, 3/9 T: 02 9896 5494 1/19 Jonathan Street, Greystanes NSW 2145 F: 02 9636 1064 NSW: BPB 0255 CLIENT REF DRAWN: HOMEBUSH NSW 2140 TELEPHONE 02 9764 6442 F: 02 4869 5008 3/256 Argyle Street, Moss Vale NSW 2577 T: 02 4869 5003 NORTH MANLY OLD: RPFO 4109 FAX 02 9764 6992 Builder's License No.334930 COPYRIGHT: THIS DRAWING REMAINS THE PROPERTY OF RESIDENTIAL ENGINEERING AND MAY NOT BE ALTERED IN ANY WAY WITHOUT RESIDENTIAL ENGINEERING WRITTEN CONSEN

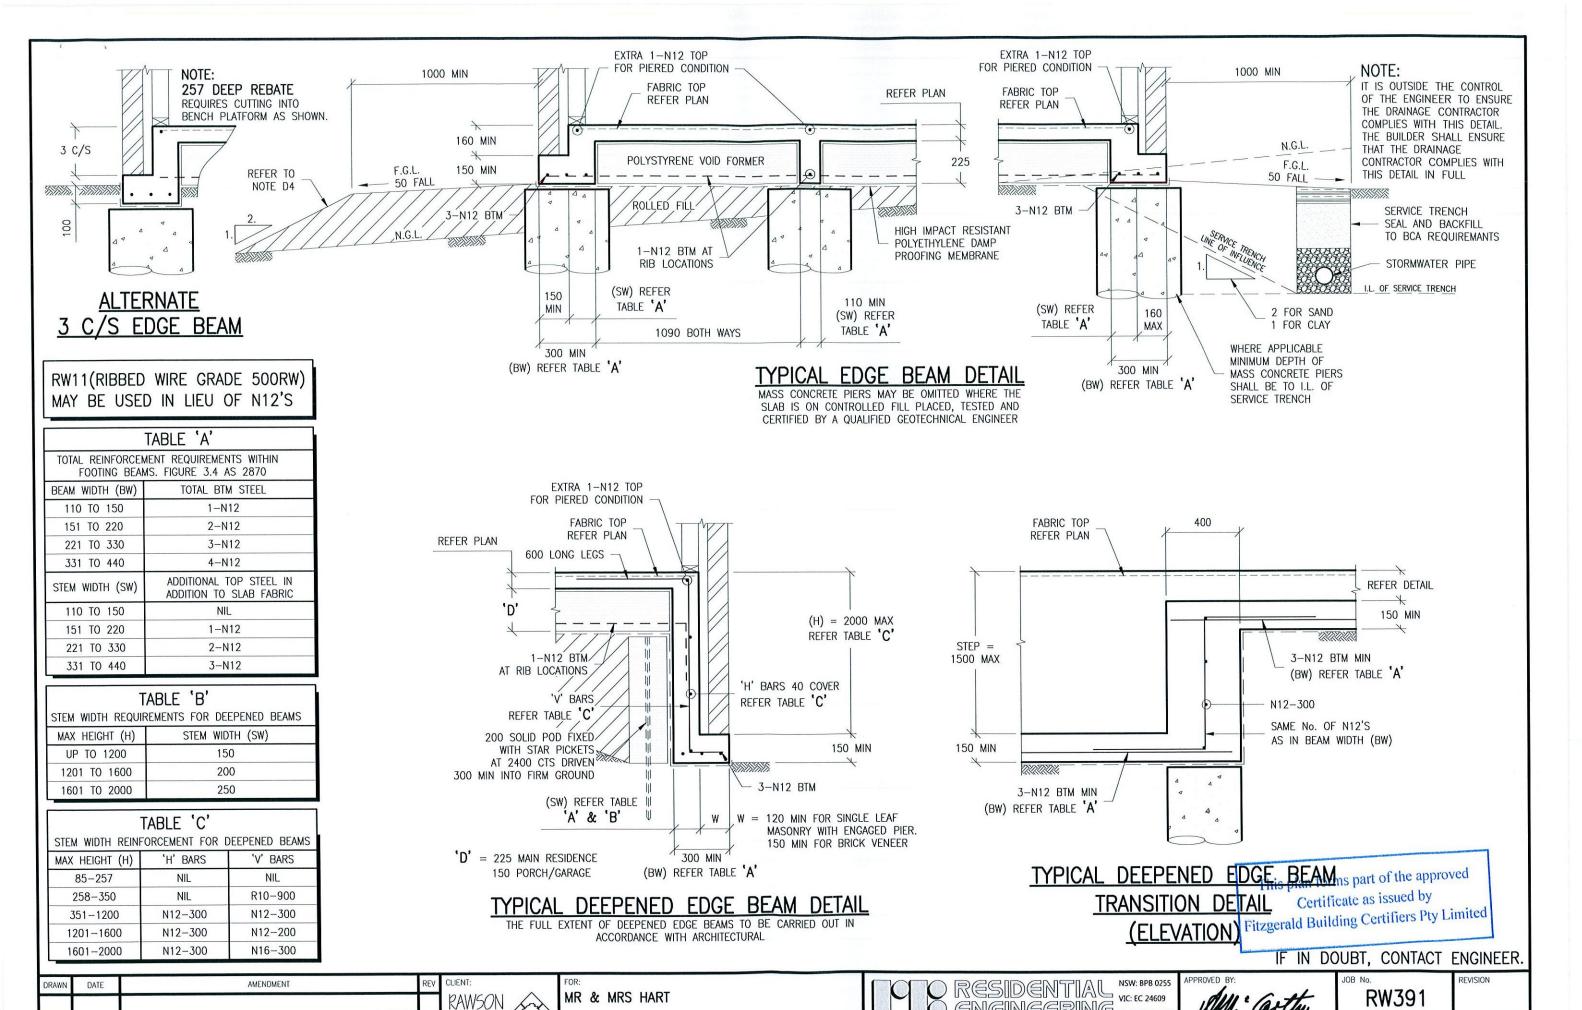

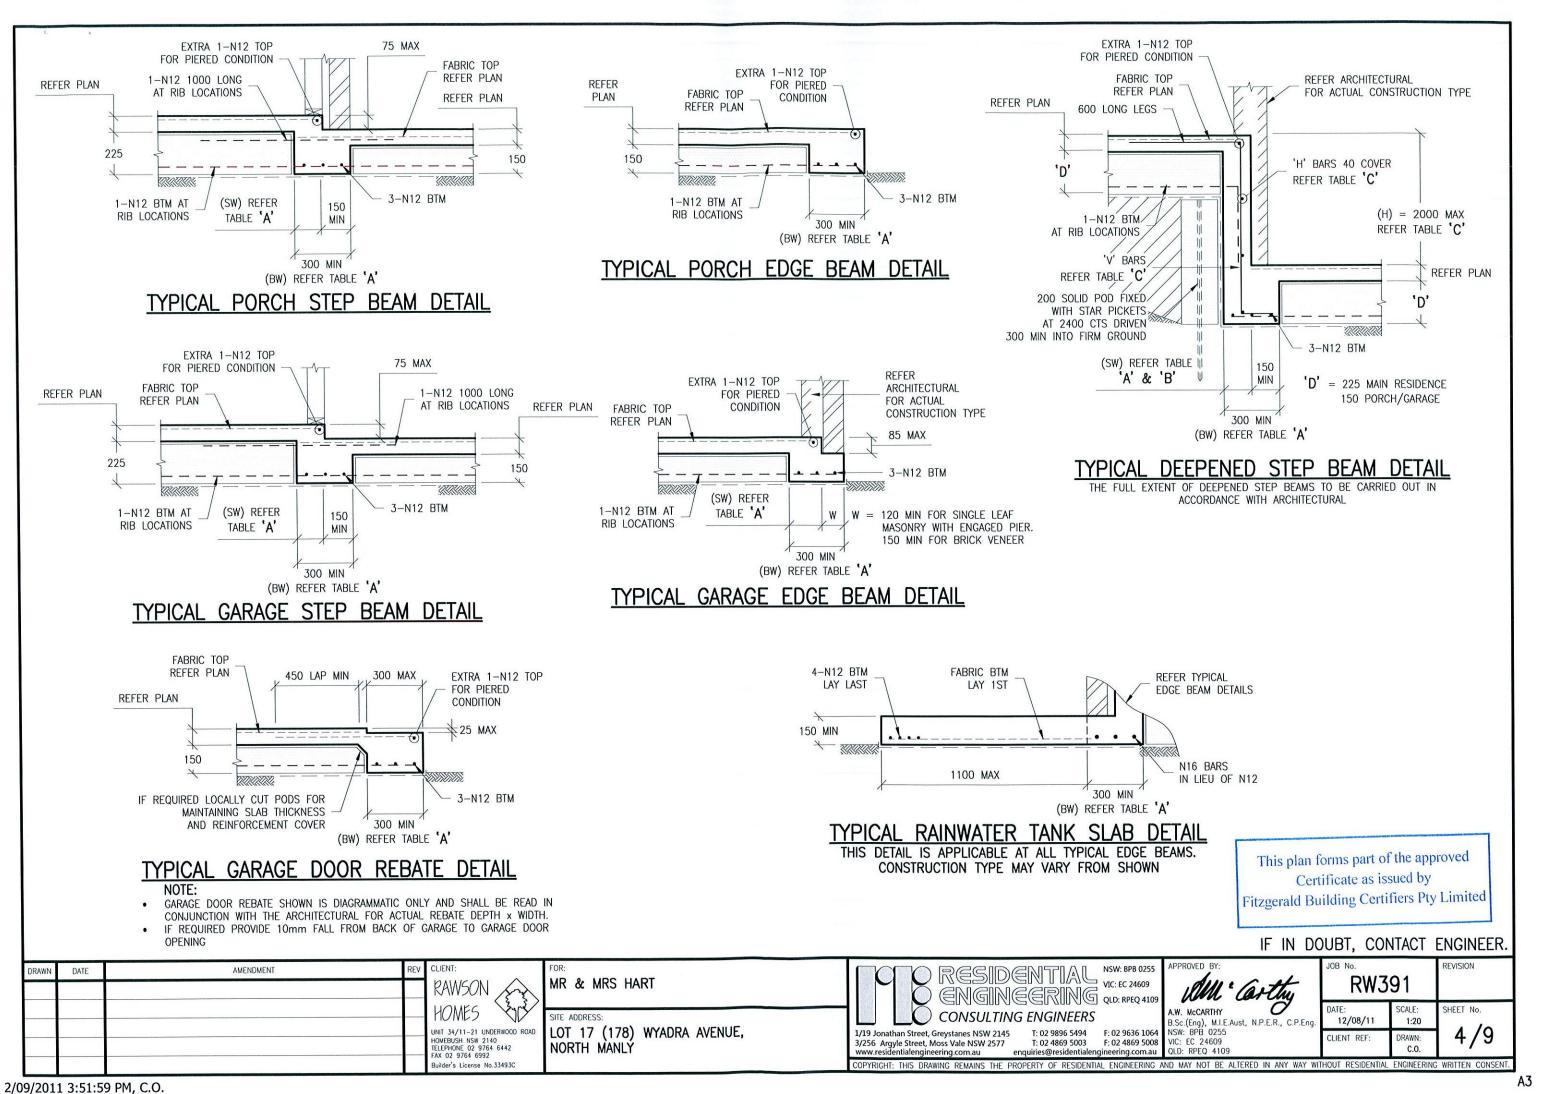

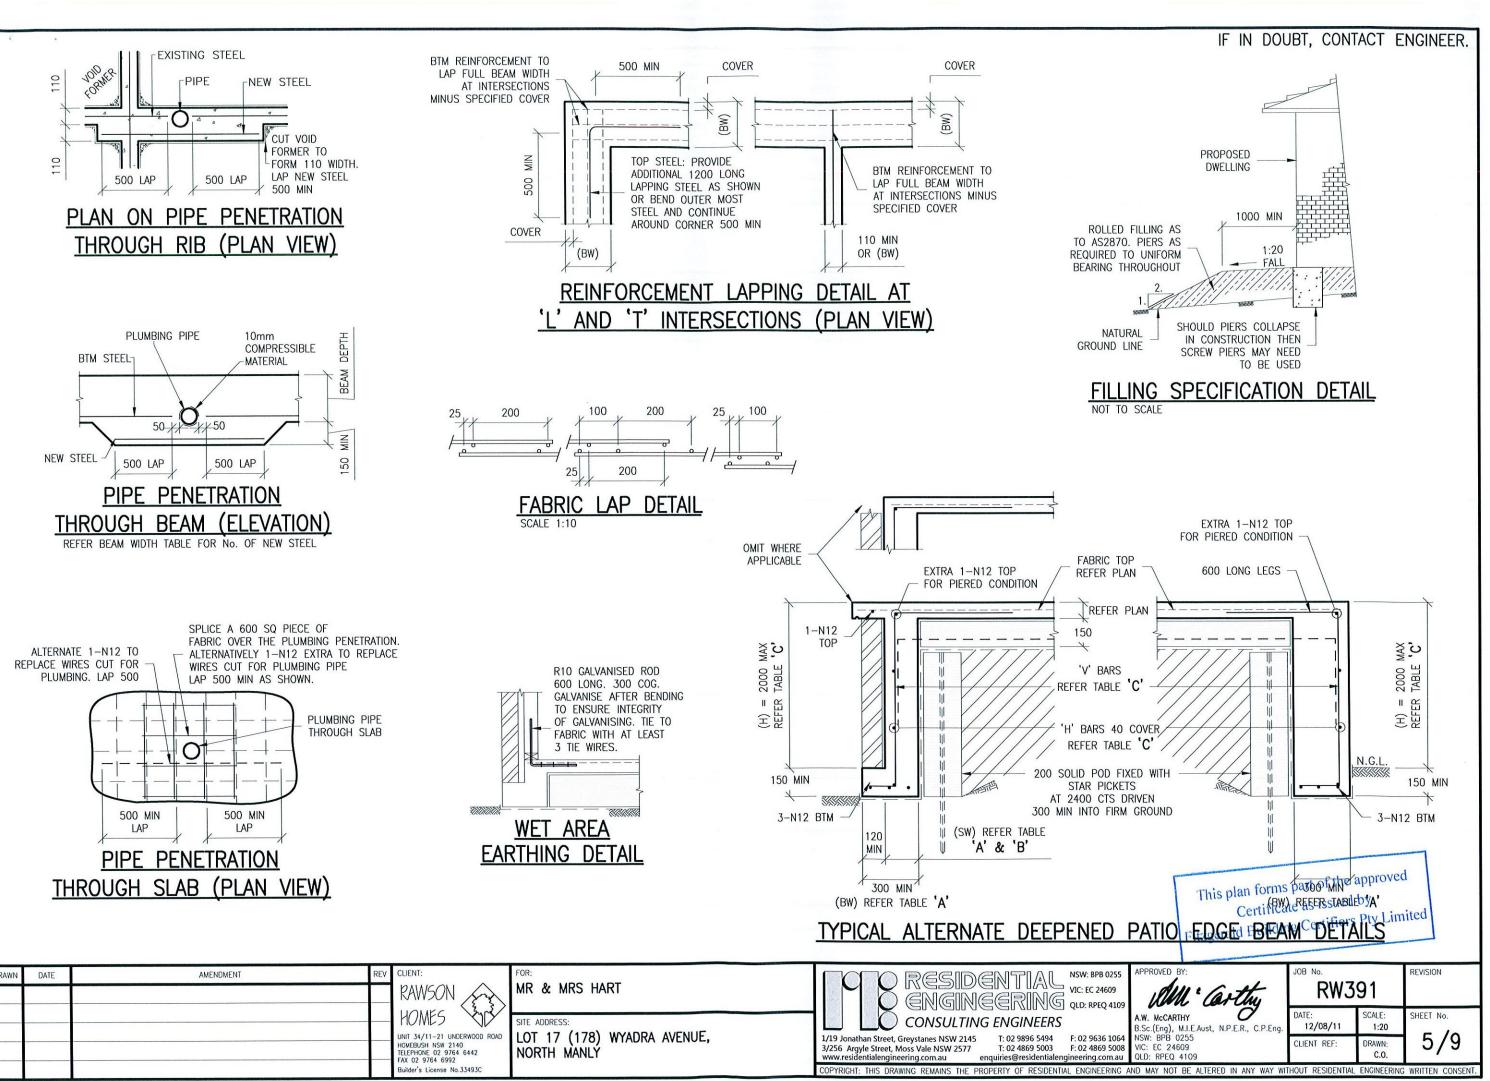

STEELWORK DESIGN MARKING DRAWING

FLOOR JOIST DIRECTION OVER BY BUILDER

STEEL BEAM PROFILE NOTE:
THE BEAM(S) SPECIFIED ON THIS DRAWING DOES NOT REPRESENT THE ONLY POSSIBLE STRUCTURAL SOLUTION. PLEASE CONTACT RESIDENTIAL ENGINEERING IF AN ALTERNATIVE BEAM PROFILE WOULD BE PREFERRED FOR ARCHITECTURAL OR CONSTRUCTABILITY REASONS




BEAM LOADS ALERT: (B3)
LOWER ROOF FRAMING SHALL BE SUPPORTED BY
TIMBER TRUSSES TO ENSURE LOADS ARE NOT
TRANSFERRED TO BEAM B3

MEMBER SCHEDULE

ITEM	DESCRIPTION					
B1	250UB25					
B2	310UB32					
В3	380 PFC					
B4	200 PFC					
L1	150 x 100 x 10 RSA - BRICKWORK ONLY					
L2	150 x 100 x 10 RSA - BRICKWORK ONLY					
L3	150 x 100 x 10 RSA + 130 x 10 MS PL - BWK ONLY					
SP1	75 x 75 x 4.0 SHS ₁ This plan forms part of the approved					
TP1	This plan forms part of the approved 4 / 90 x 45 MGP10 STUDS Certificate as issued by ONUES 1					
TBO	Fitzgerald Building WEER HEAM PRY DIHERED					

IF IN DOUBT CONTACT ENGINEER


IF IN DOUBL, CONTACT ENGINEER.						Titzger	1 112gorous -	
DRAWN	DATE	AMENDMENT	REV	CLIENT: RAWSON	MR & MRS HART	RESIDENTIAL NSW: BPB 0255 VIC: EC 24609 VIC: RPEQ 4109 VIC: RPEQ 4109 VIC: RPEQ 4109	JOB No. RW391	REVISION
				UNIT 34/11-21 UNDERWOOD ROAD	SITE ADDRESS: LOT 17 (178) WYADRA AVENUE, NORTH MANLY	CONSULTING ENGINEERS 1/19 Jonathan Street, Greystanes NSW 2145 3/256 Argyle Street, Moss Vale NSW 2577 T: 02 9896 5494 F: 02 9636 1064 NSW: BPB 0255 VIC: EC 24609 www.residentialengineering.com.au COPVRICHT: THIS DRAWING REMAINS THE PROPERTY OF RESIDENTIAL ENGINEERING. AND MAY NOT BE ALTERED IN ANY WAY	CLIENT REF: DRAWN: C.O.	6/9

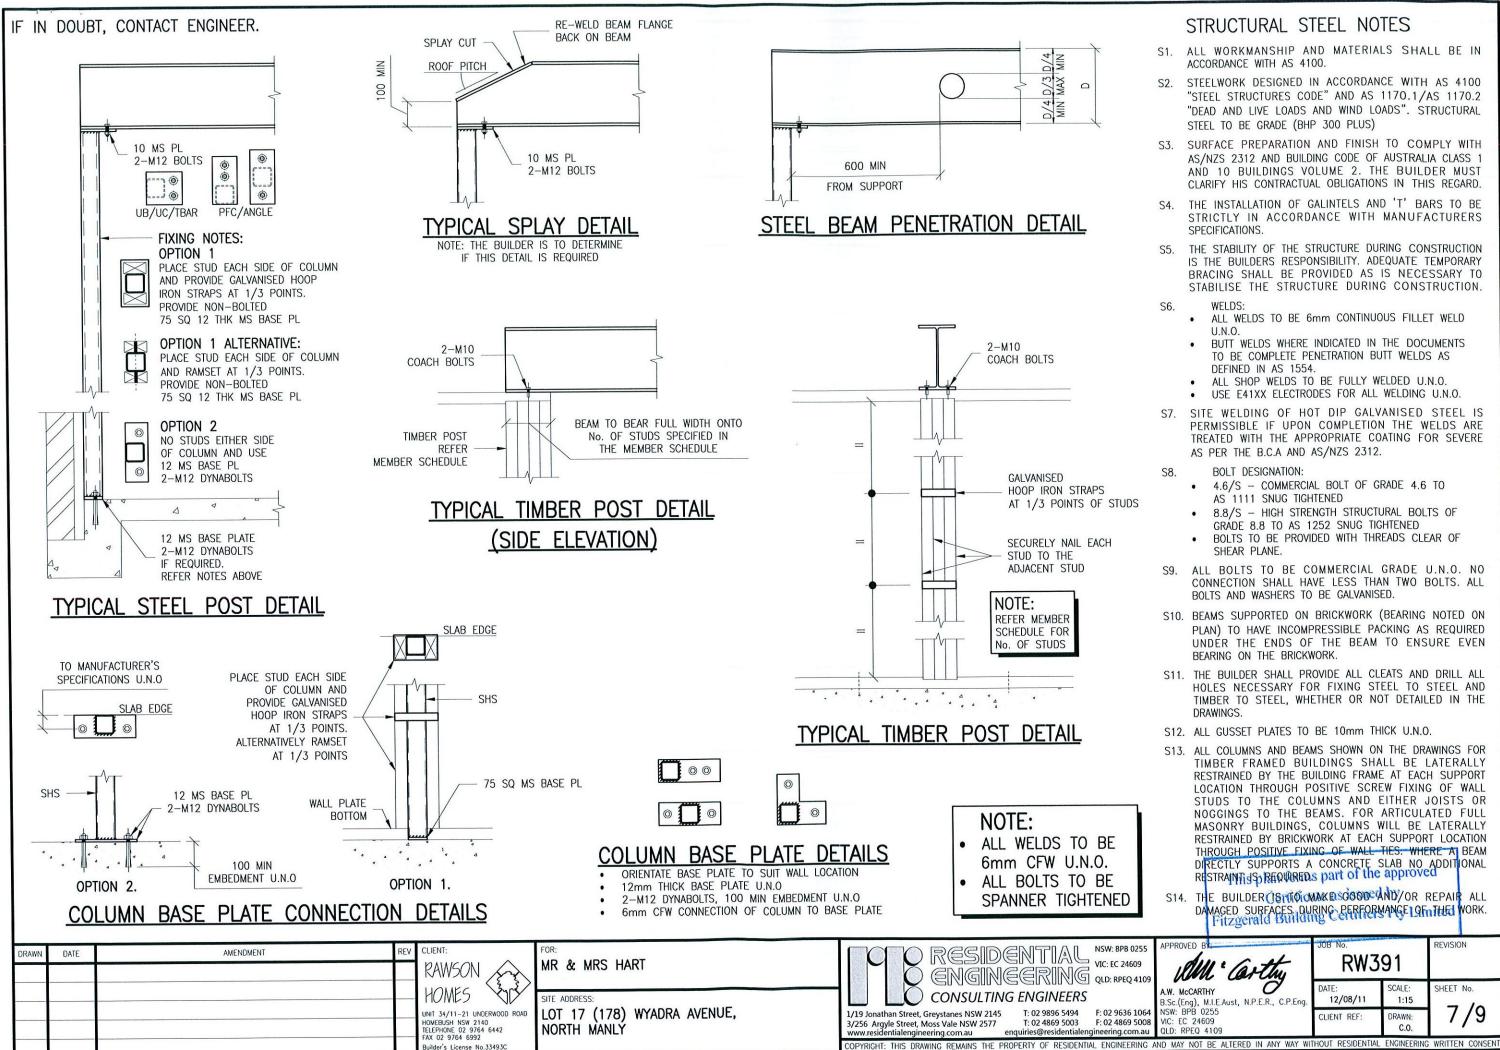

STRUCTURAL STEEL NOTES

- S1. ALL WORKMANSHIP AND MATERIALS SHALL BE IN
- STEELWORK DESIGNED IN ACCORDANCE WITH AS 4100 "STEEL STRUCTURES CODE" AND AS 1170.1/AS 1170.2 "DEAD AND LIVE LOADS AND WIND LOADS". STRUCTURAL STEEL TO BE GRADE (BHP 300 PLUS)
- SURFACE PREPARATION AND FINISH TO COMPLY WITH AS/NZS 2312 AND BUILDING CODE OF AUSTRALIA CLASS 1 AND 10 BUILDINGS VOLUME 2. THE BUILDER MUST CLARIFY HIS CONTRACTUAL OBLIGATIONS IN THIS REGARD.
- THE INSTALLATION OF GALINTELS AND 'T' BARS TO BE STRICTLY IN ACCORDANCE WITH MANUFACTURERS
- THE STABILITY OF THE STRUCTURE DURING CONSTRUCTION IS THE BUILDERS RESPONSIBILITY. ADEQUATE TEMPORARY BRACING SHALL BE PROVIDED AS IS NECESSARY TO STABILISE THE STRUCTURE DURING CONSTRUCTION.
 - ALL WELDS TO BE 6mm CONTINUOUS FILLET WELD
 - BUTT WELDS WHERE INDICATED IN THE DOCUMENTS TO BE COMPLETE PENETRATION BUTT WELDS AS
 - ALL SHOP WELDS TO BE FULLY WELDED U.N.O.
 - USE E41XX ELECTRODES FOR ALL WELDING U.N.O.
- SITE WELDING OF HOT DIP GALVANISED STEEL IS PERMISSIBLE IF UPON COMPLETION THE WELDS ARE TREATED WITH THE APPROPRIATE COATING FOR SEVERE AS PER THE B.C.A AND AS/NZS 2312.
 - 4.6/S COMMERCIAL BOLT OF GRADE 4.6 TO AS 1111 SNUG TIGHTENED
 - 8.8/S HIGH STRENGTH STRUCTURAL BOLTS OF GRADE 8.8 TO AS 1252 SNUG TIGHTENED
 - BOLTS TO BE PROVIDED WITH THREADS CLEAR OF
- ALL BOLTS TO BE COMMERCIAL GRADE U.N.O. NO CONNECTION SHALL HAVE LESS THAN TWO BOLTS. ALL BOLTS AND WASHERS TO BE GALVANISED.
- S10. BEAMS SUPPORTED ON BRICKWORK (BEARING NOTED ON PLAN) TO HAVE INCOMPRESSIBLE PACKING AS REQUIRED UNDER THE ENDS OF THE BEAM TO ENSURE EVEN BEARING ON THE BRICKWORK.
- S11. THE BUILDER SHALL PROVIDE ALL CLEATS AND DRILL ALL HOLES NECESSARY FOR FIXING STEEL TO STEEL AND TIMBER TO STEEL, WHETHER OR NOT DETAILED IN THE
- S12. ALL GUSSET PLATES TO BE 10mm THICK U.N.O.
- S13. ALL COLUMNS AND BEAMS SHOWN ON THE DRAWINGS FOR TIMBER FRAMED BUILDINGS SHALL BE LATERALLY RESTRAINED BY THE BUILDING FRAME AT EACH SUPPORT LOCATION THROUGH POSITIVE SCREW FIXING OF WALL STUDS TO THE COLUMNS AND EITHER JOISTS OR NOGGINGS TO THE BEAMS. FOR ARTICULATED FULL MASONRY BUILDINGS, COLUMNS WILL BE LATERALLY RESTRAINED BY BRICKWORK AT EACH SUPPORT LOCATION THROUGH POSITIVE FIXING OF WALL TIES. WHERE AT BEAM DIRECTLY SUPPORTS A CONCRETE SLAB NO ADDITIONAL RESTRAINTISS REQUIREDS part of the approved
- S14. THE BUILDER OSTUDIONALE SCOOL AND OR REPAIR ALL DAMAGED SURFACES DURING PERFORMANGE OF THE WORK.

REVISION RW391 SHEET No. 12/08/11 CLIENT REF DRAWN:

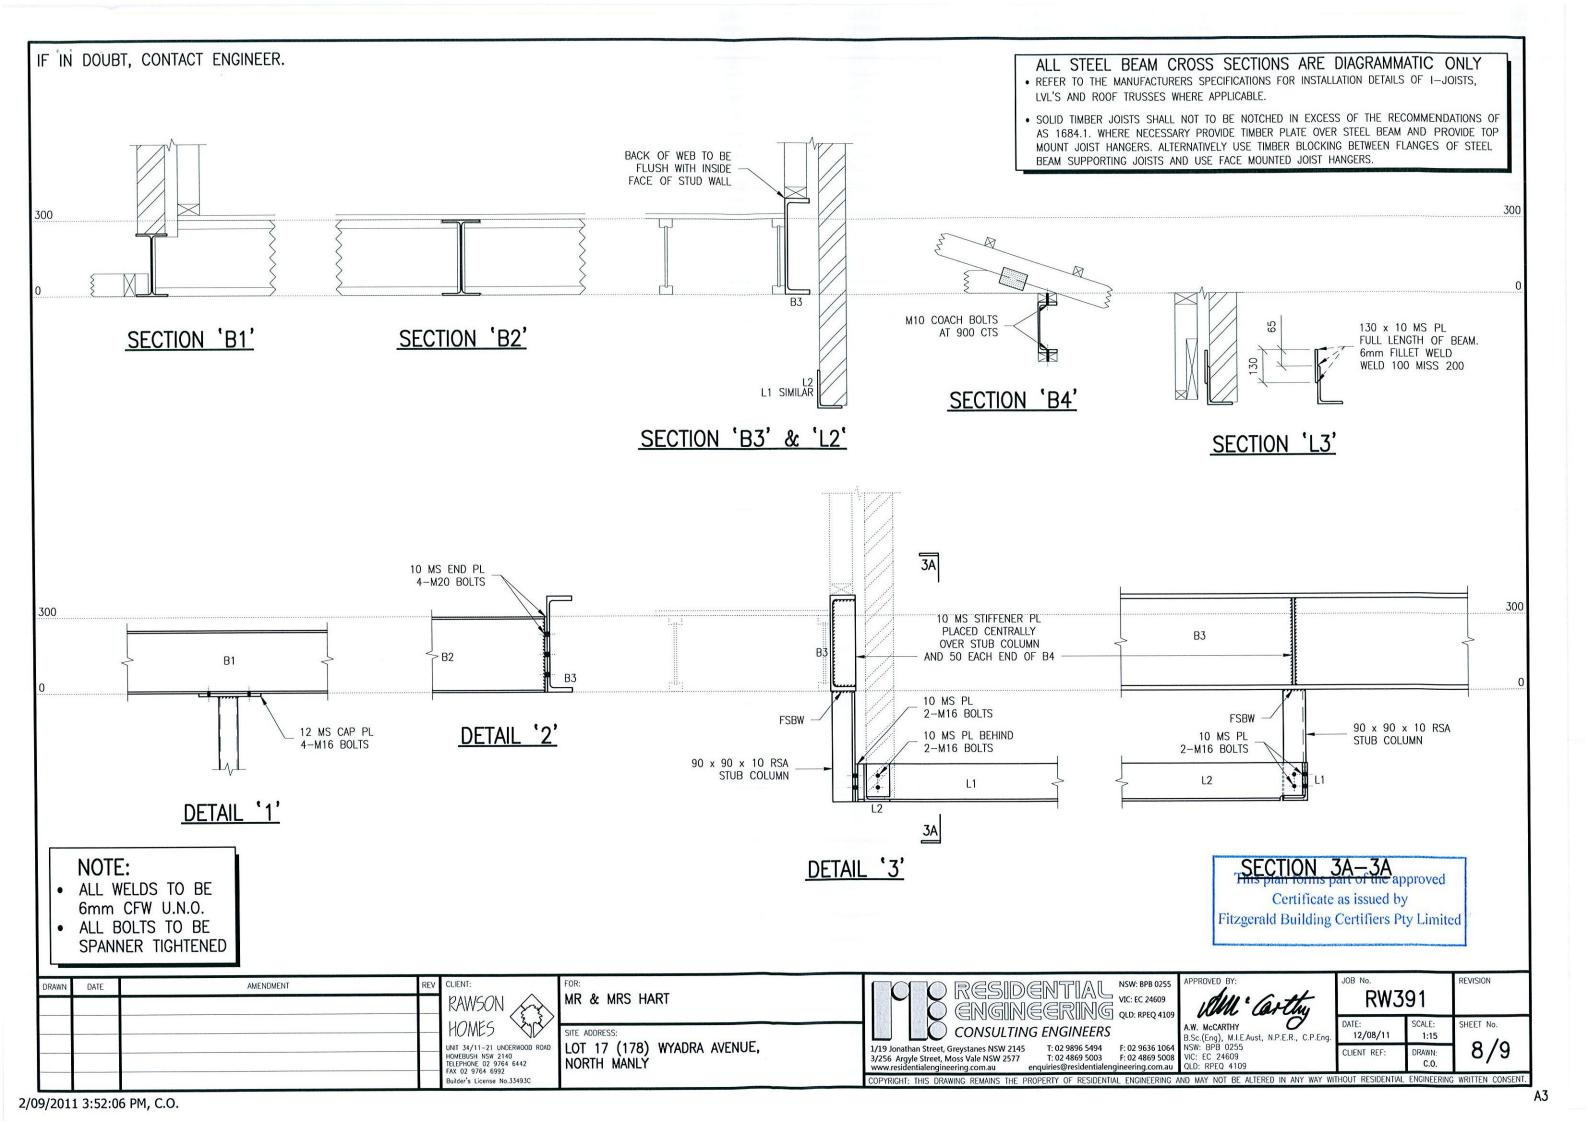

IF IN DOUBT, CONTACT ENGINEER. ALL STEEL BEAM CROSS SECTIONS ARE DIAGRAMMATIC ONLY REFER TO THE MANUFACTURERS SPECIFICATIONS FOR INSTALLATION DETAILS OF I-JOISTS, LVL'S AND ROOF TRUSSES WHERE APPLICABLE. • SOLID TIMBER JOISTS SHALL NOT TO BE NOTCHED IN EXCESS OF THE RECOMMENDATIONS OF AS 1684.1. WHERE NECESSARY PROVIDE TIMBER PLATE OVER STEEL BEAM AND PROVIDE TOP MOUNT JOIST HANGERS. ALTERNATIVELY USE TIMBER BLOCKING BETWEEN FLANGES OF STEEL BEAM SUPPORTING JOISTS AND USE FACE MOUNTED JOIST HANGERS. NAIL STRAP TO TIMBER PLATE ON STEEL BEAM CEILING CEILING B4 MINIMUM 30 \times 1.2 NON PERFORATED GALV. STEEL STRAP 80mm EMBEDMENT IN MORTAR JOINT DETAIL '4' NOTE: This plan forms part of the approved ALL WELDS TO BE Certificate as issued by 6mm CFW U.N.O. Fitzgerald Building Certifiers Pty Limited ALL BOLTS TO BE SPANNER TIGHTENED RAWSON REVISION DATE AMENDMENT RW391 MR & MRS HART EERING QLD: RPEQ 4109 A.W. McCARTHY SHEET No. B.Sc.(Eng), M.I.E.Aust, N.P.E.R., C.P.Eng. NSW: BPB 0255 VIC: EC 24609 QLD: RPEQ 4109 12/08/11 1:15 UNIT 34/11-21 UNDERWOOD ROAD HOMEBUSH NSW 2140 TELEPHONE 02 9764 6442 FAX 02 9764 6992 LOT 17 (178) WYADRA AVENUE, 9/9 1/19 Jonathan Street, Greystanes NSW 2145 T: 02 9896 5494 DRAWN: CLIENT REF: T: 02 4869 5003 enquiries@residentiale F: 02 4869 5008 gineering.com.au 3/256 Argyle Street, Moss Vale NSW 2577 NORTH MANLY

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