NET ROAD AVALON BEACH NSW 2107

CONTENTS

DRG No.	DRAWING	SCALE
DA.00	Drawing Schedule & Palette of Materials	NTS
DA.01	Existing Site/Roof/Analysis Plan	1:200@A3
DA.02	Existing Lower Floor Plan	1:100@A3
DA.03	Existing Entry Floor Plan	1:100@A3
DA.04	Existing South (Street) Elevation	1:100@A3
DA.05	Existing North Elevation	1:100@A3
DA.06	Existing East Elevation	1:100@A3
DA.07	Existing West Elevation	1:100@A3
DA.08	Existing Section	1:100@A3
DA.09	Proposed Site/Roof/Analysis Plan	1:200@A3
DA.10	Proposed Lower Floor Plan	1:100@A3
DA.11	Proposed Entry Floor Plan	1:100@A3
DA.12	Proposed South (Street) Elevation	1:100@A3
DA.13	Proposed North Elevation	1:100@A3
DA.14	Proposed East Elevation	1:100@A3
DA.15	Proposed West Elevation	1:100@A3
DA.16	Proposed Section AA	1:100@A3
DA.17	Proposed Section BB	1:100@A3
DA.18	Proposed Section CC	1:100@A3
DA.19	Shadow Diagram 9am	1:200@A3
DA.20	Shadow Diagram 12 noon	1:200@A3
DA.21	Shadow Diagram 3pm	1:200@A3
DA.22.1	Site Coverage - Existing	1:250@A3
DA.22.2	Site Coverage - Proposed	1:250@A3
DA.23	Concept Stormwater Management Plan	1:200@A3
DA.24	Sediment & Waste Management Plan	1:200@A3

MATERIAL PALETTE



LIGHTWEIGHT CLADDING (LC) to BAL12.5 requirements

HARDWOOD TIMBER DECKING

BALUSTRADE. (BAL) to BAL12.5 requirements METAL ROOF SHEETING (MRS) colorbond "BASALT" (OR SIMILAR) to BAL12.5 requirements

RENDERED MASONRY (M)

BASIX REQUIREMENTS - Alterations & Additions - Certificate number: A498797

Fixtures & Systems

Lighting
- the applicant must ensure a minimum of 40% of new or altered light fixtures are fitted with fluorescent or LED lamps.

Fixtures

- the applicant must ensure new or altered showerheads have a flow rate no greater than 9 litres per minute or a 3 star water rating.
- the applicant must ensure new or altered toilets have a flow rate no greater than 4 litres per average flush or minimum 3 star water rating.
- the applicant must ensure new or altered taps have a flow rate no greater than 9 litres per minute or minimum 3 star water rating.

Thermal Commitments					
Construction (new or altered floors, walls, roofs)	Additional Insulation Req. (R-value) (new or altered floors, walls, roofs)				
floor - suspended floor above enclosed subfloor, conc.	R0.70 (down) (or R1.30 including construction)				
external wall: framed (weatherboard, fibro, metal clad)	R1.30 (or R1.70 including construction)				
ceiling and roof . framed	ceiling: 2.08 (up), roof: foil backed blanket (55mm), medium (solar absorptance 0.475 - 0.70)				

Glazing - Refer Basix Certificate & corelating window/door No.in architectural drawings.

BASIX REQUIREMENTS - Secondary Dwelling - Certificate number: 1398068S

Water Commitments

Landscape

- the applicant must plant indigenous or low water use species of vegetation throughout 50 square metres of the site.

the applicant must installs showerheads with a minimum rating of 4 star (> 4.5 but <= 6 L/min plus spray force and/or coverage tests) in all showers in the development.
- the applicant must install a toilet flushing system with a minimum rating of 6 star in each toilet in the development.

- the applicant must install taps with a minium rating of 6 star in the kitchen in the development. - the applicant must install basin taps with a minimum rating of 6 star in each bathroom in the development

Alternative Water

- the applicant must install a rainwater tank of at least 3000 litres on site. This rainwater tank must meet, and be installed in accordance with, the requirements of all applicable regulatory authorities.

- the applicant must configure the rainwater tank to collect rain runoff from at least 150 square metres of the roof area of the development.

the applicant must connect the rainwater tank to at least one outdoor tap in the development.

Thermal Commitments

	Construction	Additional Insulation Req. (R-value)				
floor - above habitable rooms, conc.		nil				
external wall: framed (weatherboard, fibro, metal clad)		3.00 (or 3.40 including construction)				
	ceiling and roof, framed	ceiling: 4.5 (up), roof: foil backed blanket (55mm), medium (solar absorptance 0.475 - 0.70)				

Glazing - Refer Basix Certificate & corelating window/door No.in architectural drawings. (Secondary Dwelling)

Energy Commitments

Hot Water

the applicant must install the following hot water system in the development, or a system with a higher energy rating: electric heat pump.

the applicant must install a ceiling fan in the living area and the bedroom of the secondary dwelling

Heating System
- no heating system to be installed in the secondary dwelling.

the applicant must install an exhaust fan to the bathroom in the secondary dwelling which is ducted to outside, which has a manual on/off switch.

the applicant must install an exhaust fan to the kitchen in the secondary dwelling which is ducted to outside, which has a manual on/off switch.

the applicant must install an exhaust fan to the laundry in the secondary dwelling which is ducted to outside, which has a manual on/off switch.

Lighting - the applicant must ensure the light fixtures installed throughout the secondary dwelling are fitted with fluorescent or LED lamps.

Natural Lighting - the applicant must install a window in the bathroom and kitchen of the secondary dwelling

the applicant must install an induction cooktop & electric oven in the kitchen of the secondary dwelling.

the applicant must install a fixed outdoor clothes drying line as part of the development.

All footings, slabs, structural beams, etc, to future engineers details. All wall/roof connections + member sizes to NCC & future engineers details Rainwater from gutters to connect to stormwater system to relevant Building Codes, Council requirements.
All wastewater/sewage to connect to existing sewer system to all relevant NCC, Building Codes + Council requirements.
All materials to comply with BAL12.5 requirements.
All works to comply with all relevant NCC, Building Codes + Council requirements.

MATERIAL S


BAL BALUSTRADE
CONC. CONCRETE
COS CONFIRM ON SITE
DP DOWNPIPE DOWNPIPE FIXED GLAZING HARDWOOD LIGHTWEIGHT CLADDING MASONRY METAL ROOF SHEETING NATURAL GROUND LEVEL


NEW WALL

FXISTING WALL TO BE REMOVED


Daniel & Mel Mussett 6 Net Road Avalon Beach NSW 2107 LOT 8 DP 232257, Site Area 1030.7m² ANDY LEHMAN DESIGN Alterations & Additions DWG. NO. DA. 00 DRAWING | Contents & Material Schedule SCALE NTS Tel. 0414 466 665 Please print in A3 or A1. This drawing is copyright and is for Development NOTES


If in doubt ask.

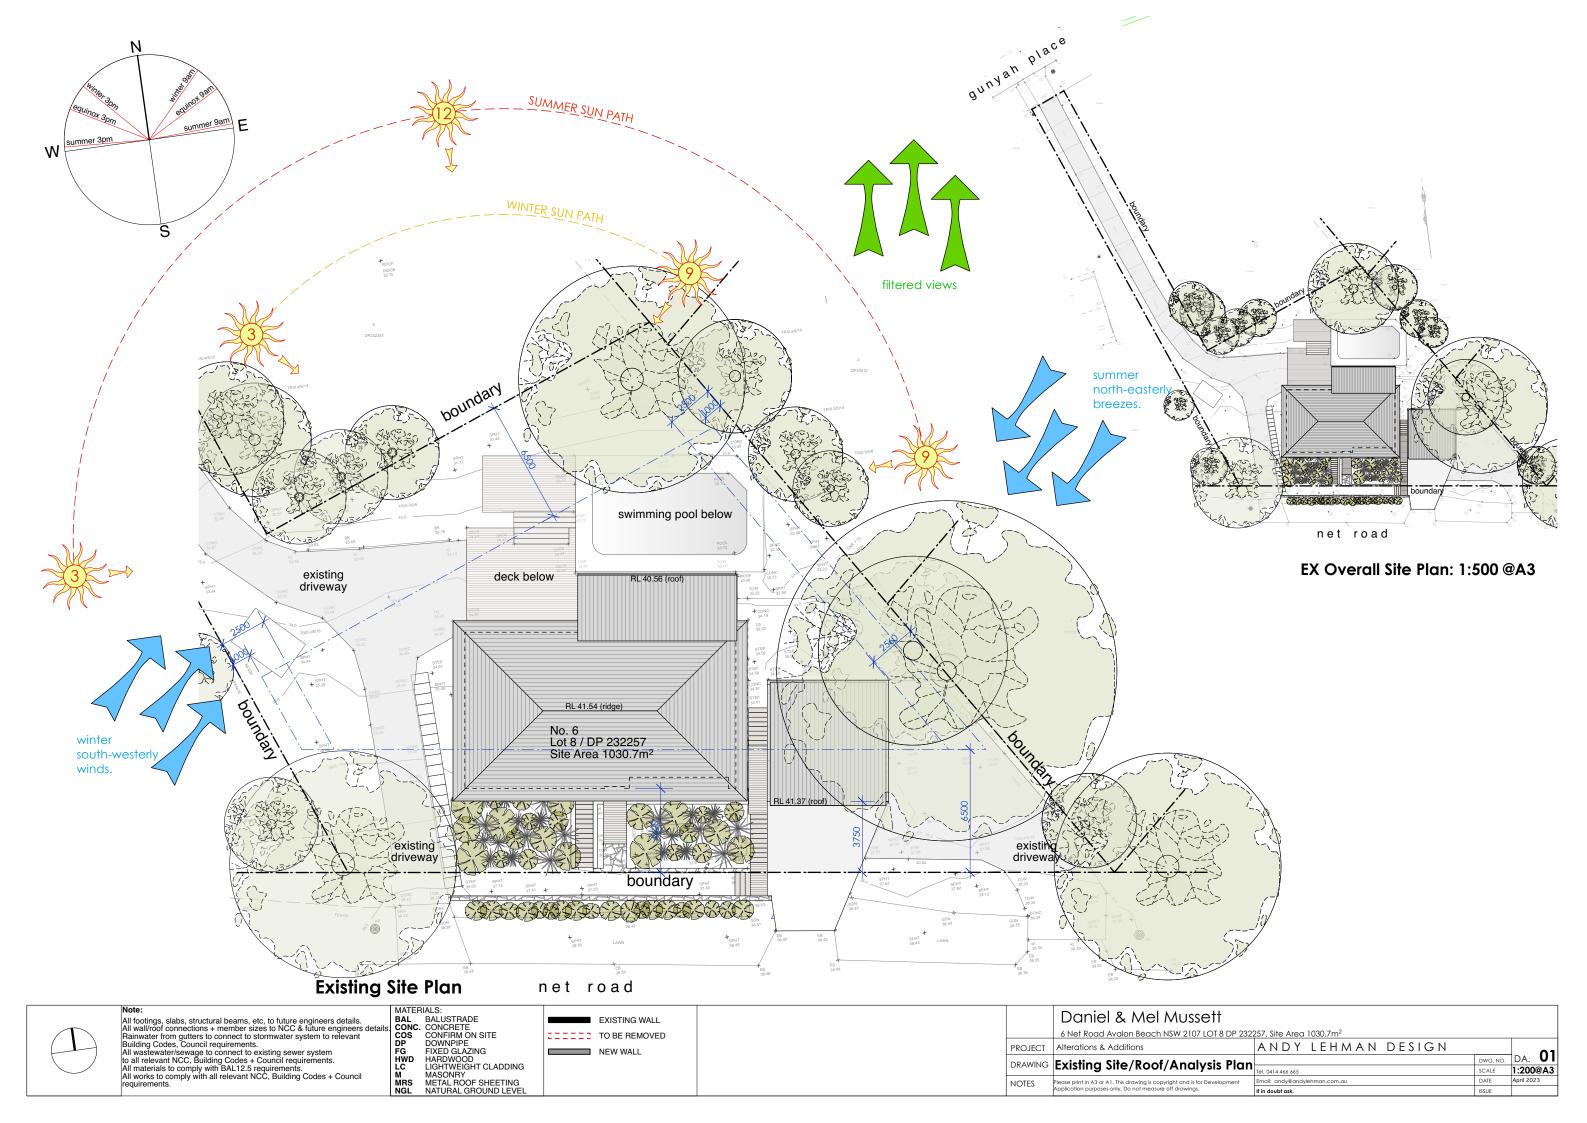

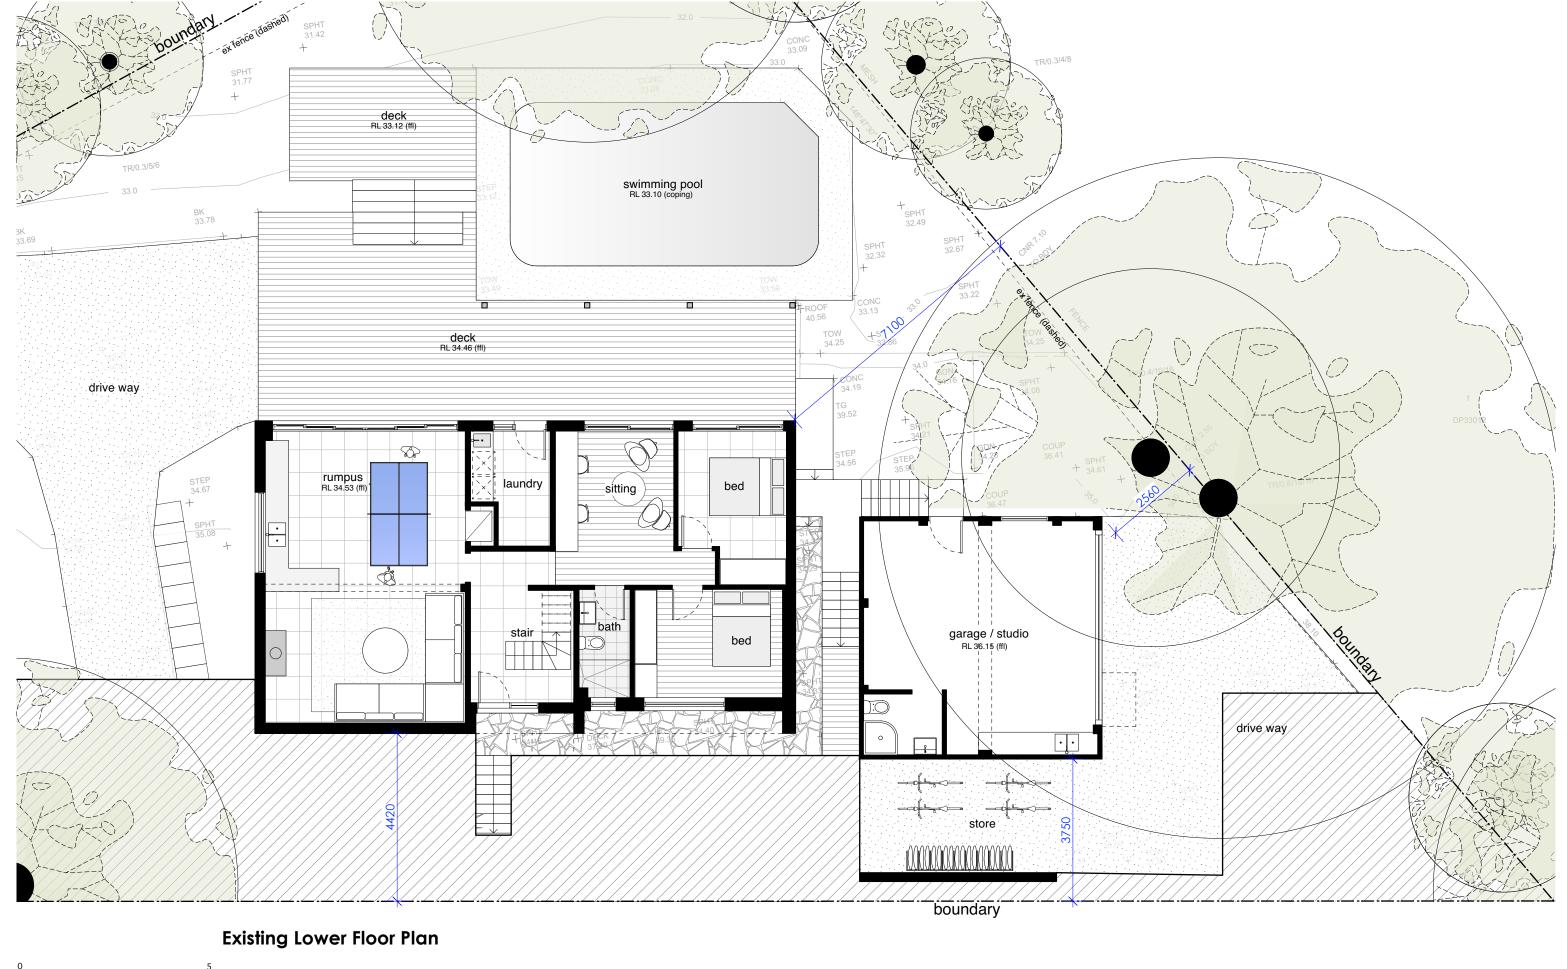



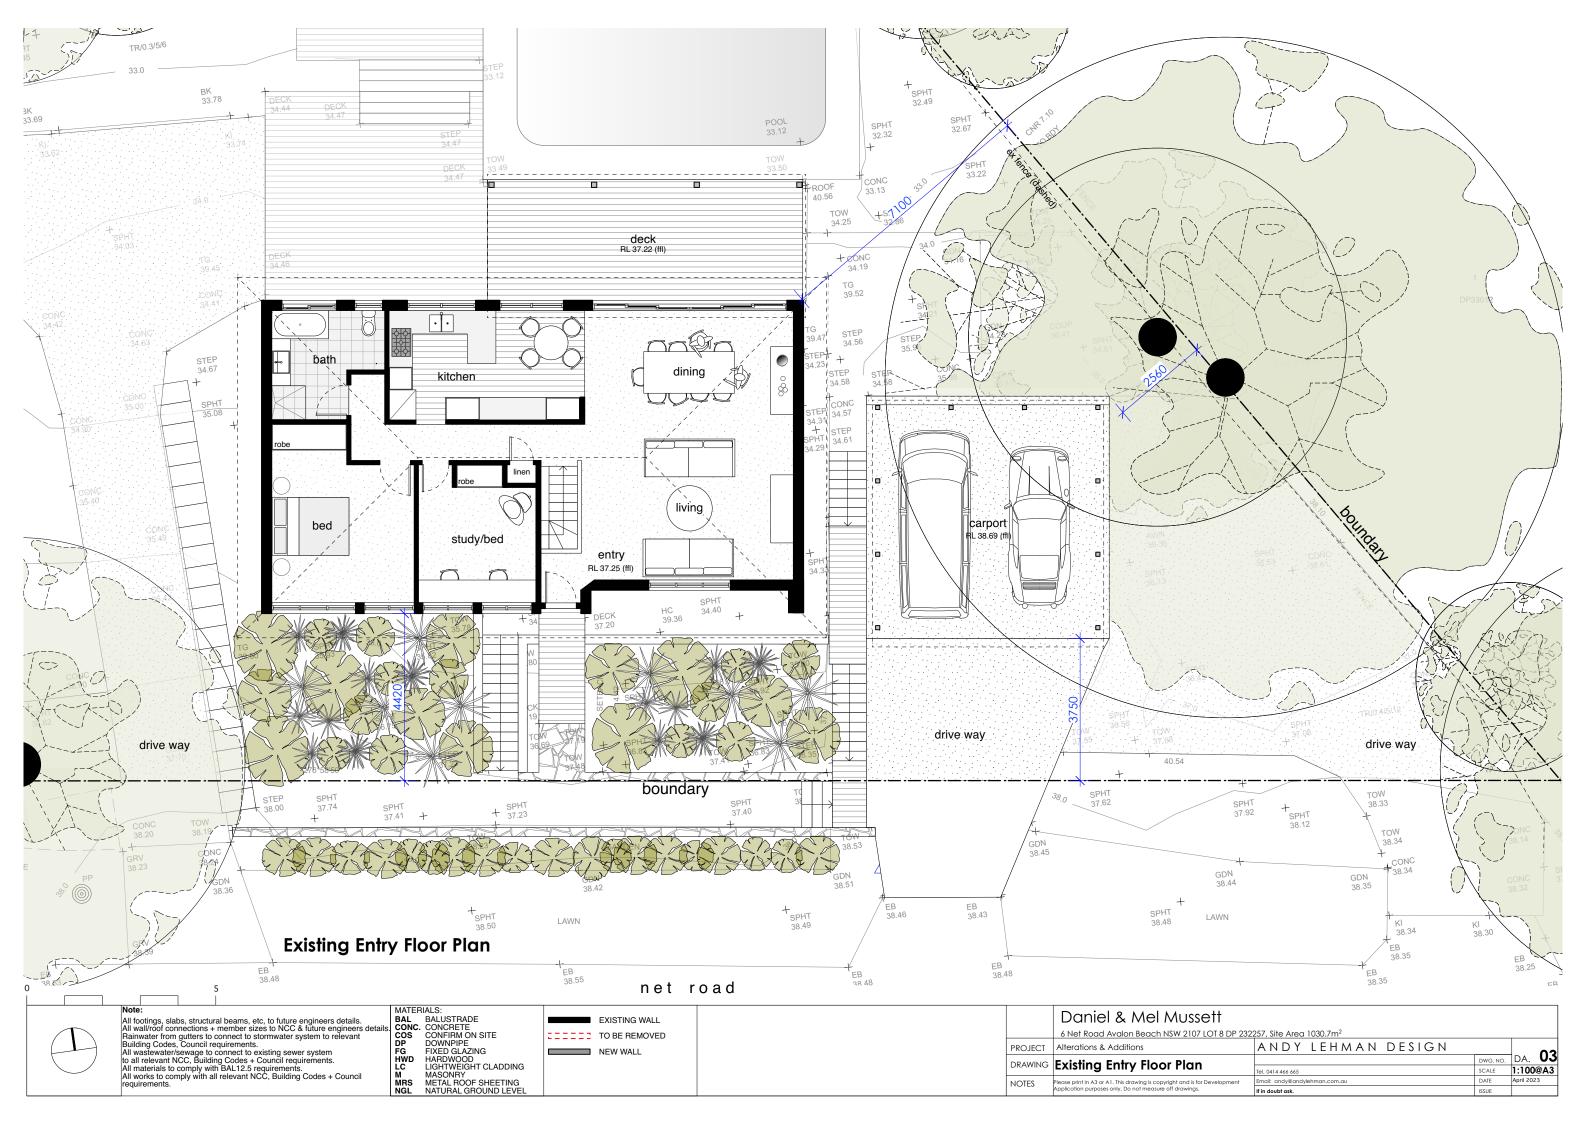


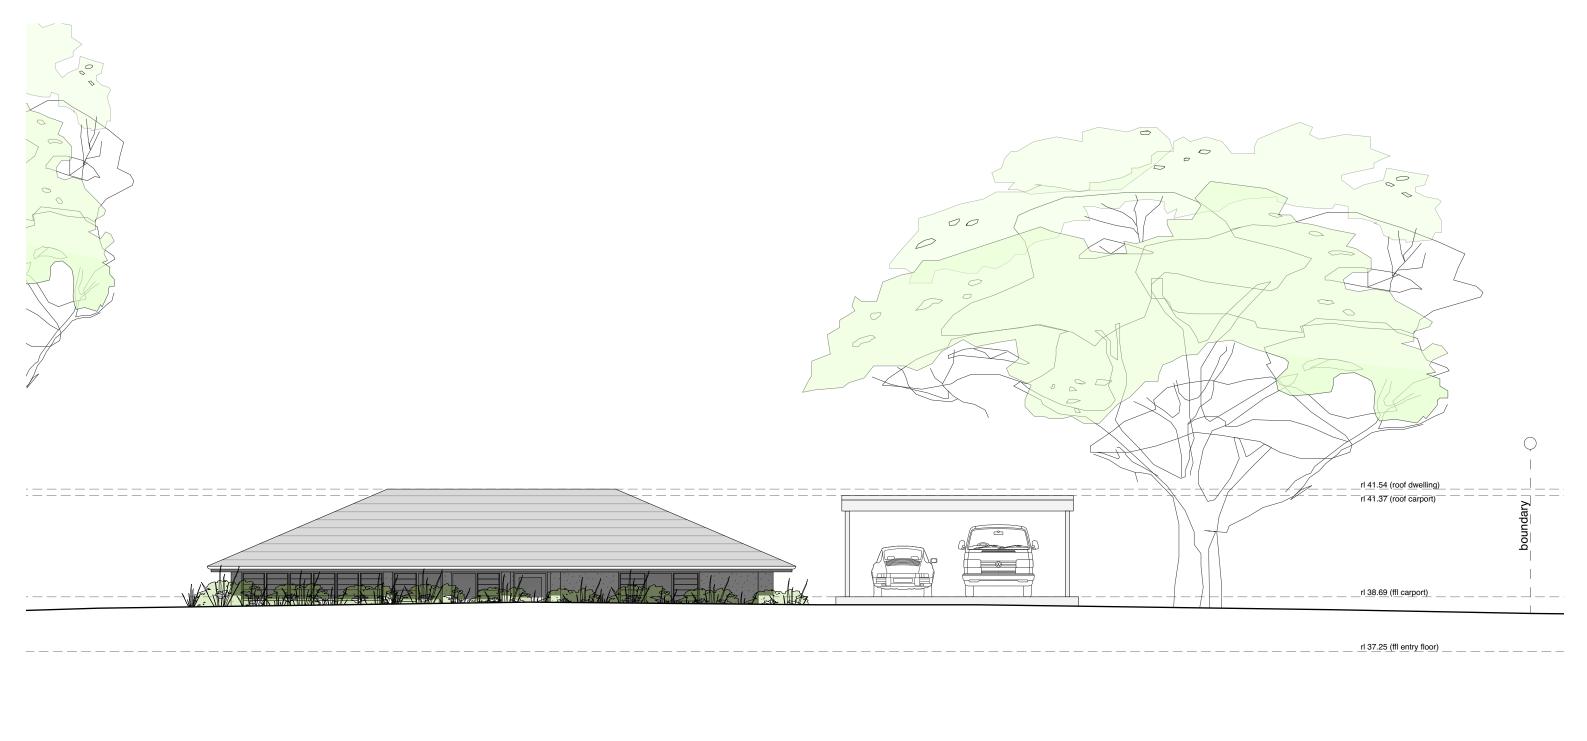

<u>rl 34.53 (ffl lower floor)</u>


Existing Street Elevation



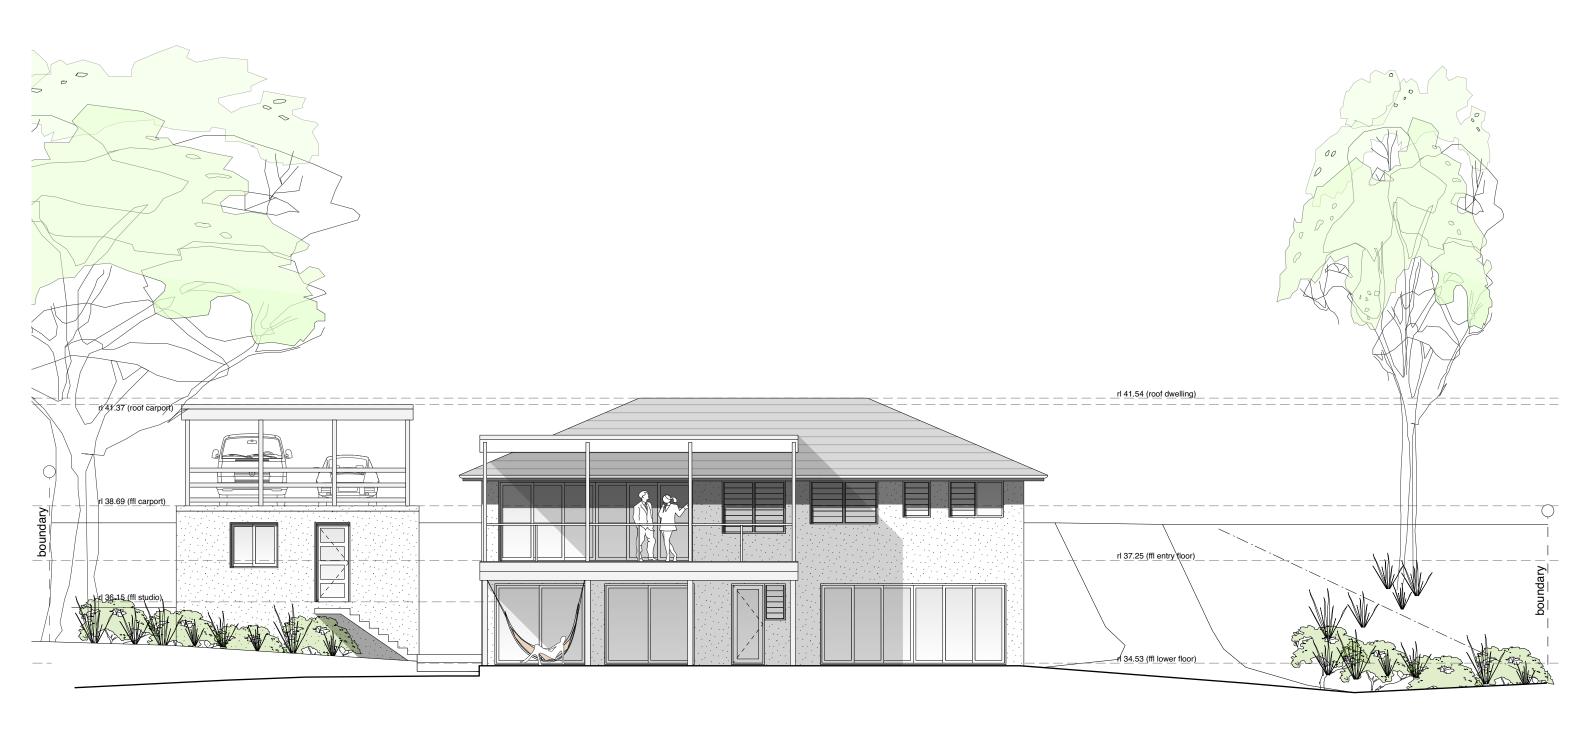


Existing North Elevation

	MATERIALS:			Daniel & Mal Mussett			
All footings, slabs, structural beams, etc, to future engineers details. All wall/roof connections + member sizes to NCC & future engineers details.	BAL BALUSTRADE	EXISTING WALL		Daniel & Mel Mussett			
All wall/roof connections + member sizes to NCC & future engineers details. Rainwater from gutters to connect to stormwater system to relevant	COS CONFIRM ON SITE	TO BE REMOVED		6 Net Road Avalon Beach NSW 2107 LOT 8 DP 23	2257, Site Area 1030.7m ²		_
Building Codes, Council requirements. All wastewater/sewage to connect to existing sewer system	DP DOWNPIPE FG FIXED GLAZING	NEW WALL	PROJECT	Alterations & Additions	ANDY LEHMAN DESIGN		0.5
to all relevant NCC, Building Codes + Council requirements.	HWD HARDWOOD LIGHTWEIGHT CLADDING		DRAWING	Existing North Elevation		DWG. NO.	DA. U 5
All materials to comply with BAL12.5 requirements. All works to comply with all relevant NCC, Building Codes + Council	M MASONRY		DRAWING	exisiing North Elevation	Tel. 0414 466 665	SCALE	1:100@A3
requirements.	MRS METAL ROOF SHEETING		NOTES	Please print in A3 or A1. This drawing is copyright and is for Development	Email: andy@andylehman.com.au	DATE	April 2023
74	NGL NATURAL GROUND LEVEL			Application purposes only. Do not measure off drawings.	If in doubt ask.	ISSUE	

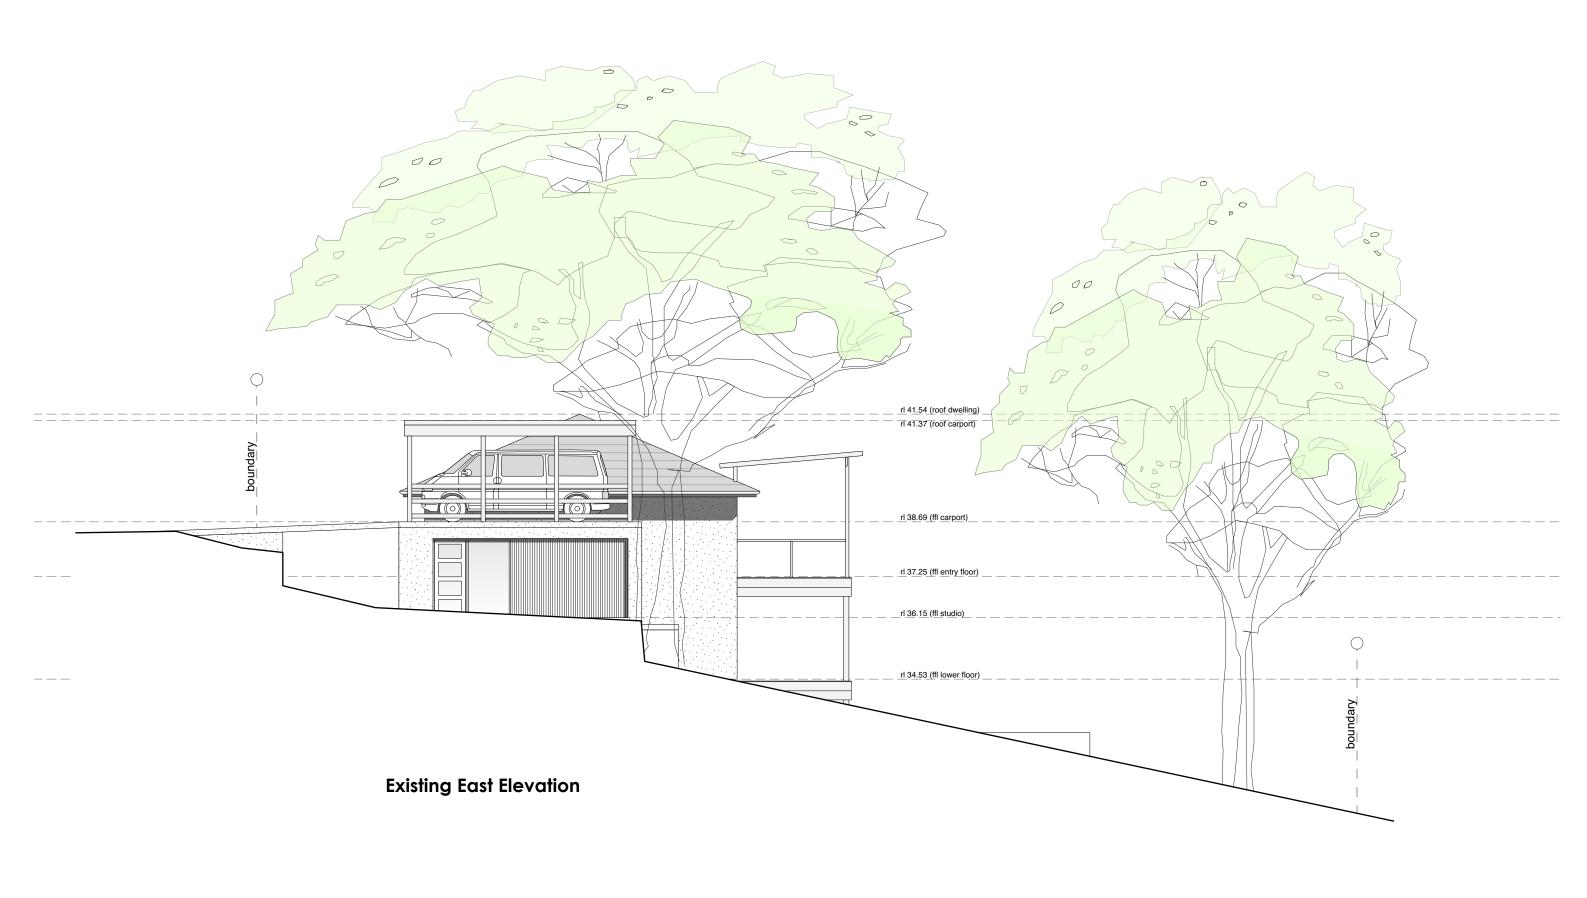



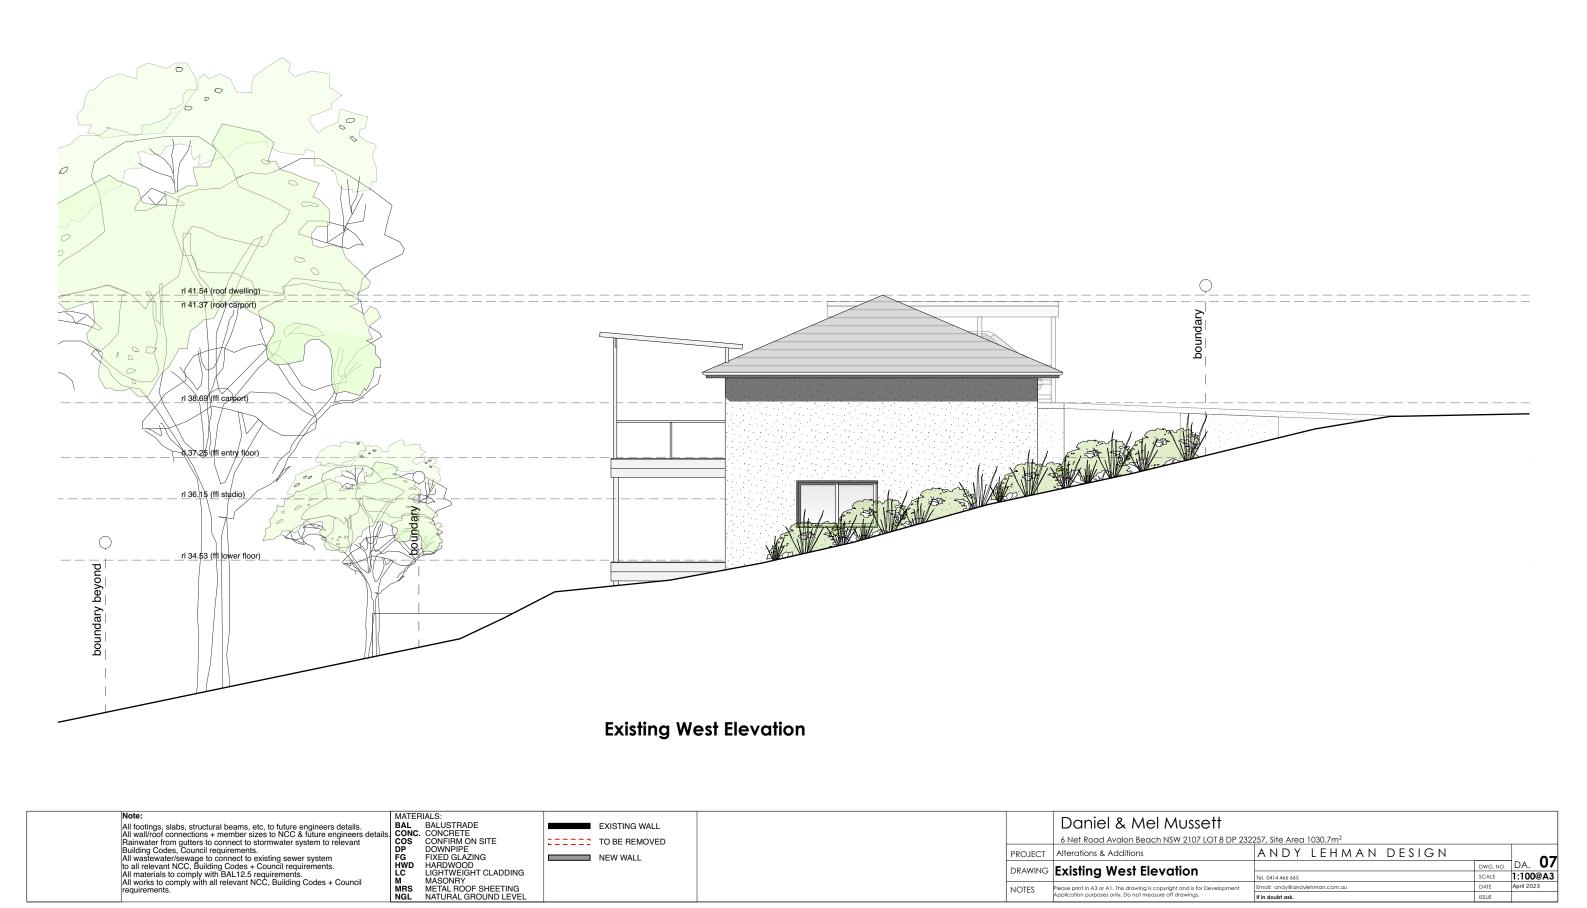

EXISTING WALL

TO BE REMOVED

NEW WALL

Daniel & Mel Mussett

Please print in A3 or A1. This drawing is copyright and is for Development Application purposes only. Do not measure off drawings.

Alterations & Additions

NOTES

DRAWING Existing West Elevation

6 Net Road Avalon Beach NSW 2107 LOT 8 DP 232257, Site Area 1030.7m²

Alterations & Additions

A N D Y L E H M A N D E S I G N

Tel. 0414 466 665

DMG. NO. DA. 07

SCALE 1:100@A3


DATE April 2023


All footings, slabs, structural beams, etc, to future engineers details. All wall/roof connections + member sizes to NCC & future engineers detail Rainwater from gutters to connect to stormwater system to relevant Building Codes, Council requirements.


All wastewater/sewage to connect to existing sewer system to all relevant NCC, Building Codes + Council requirements.


All materials to comply with BAL12.5 requirements.


All works to comply with all relevant NCC, Building Codes + Council requirements.

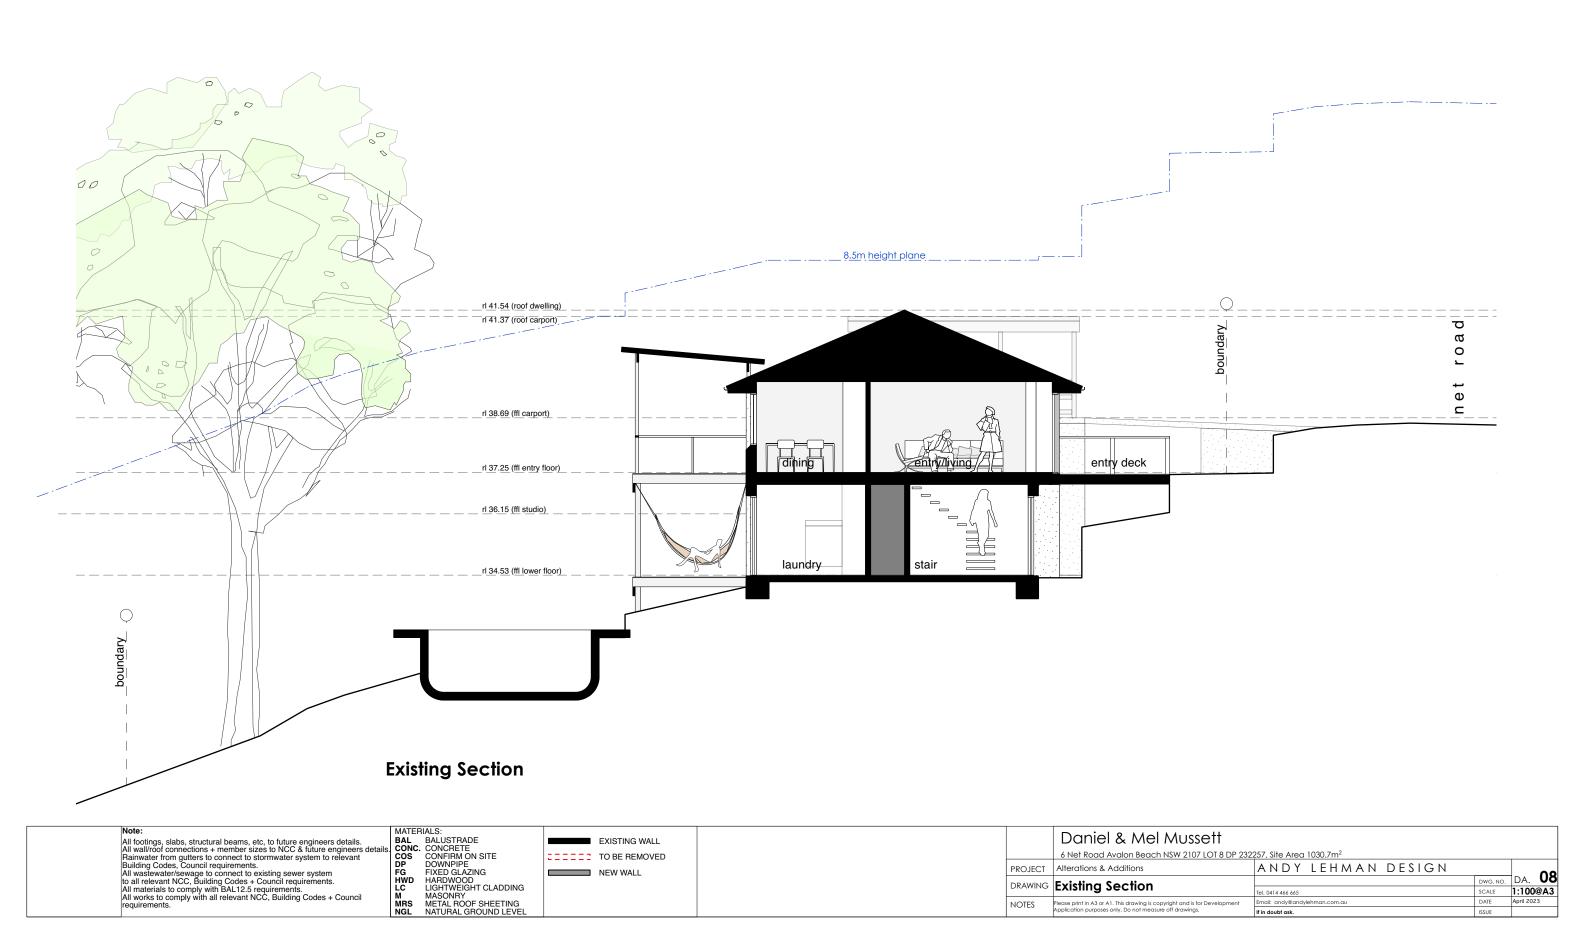

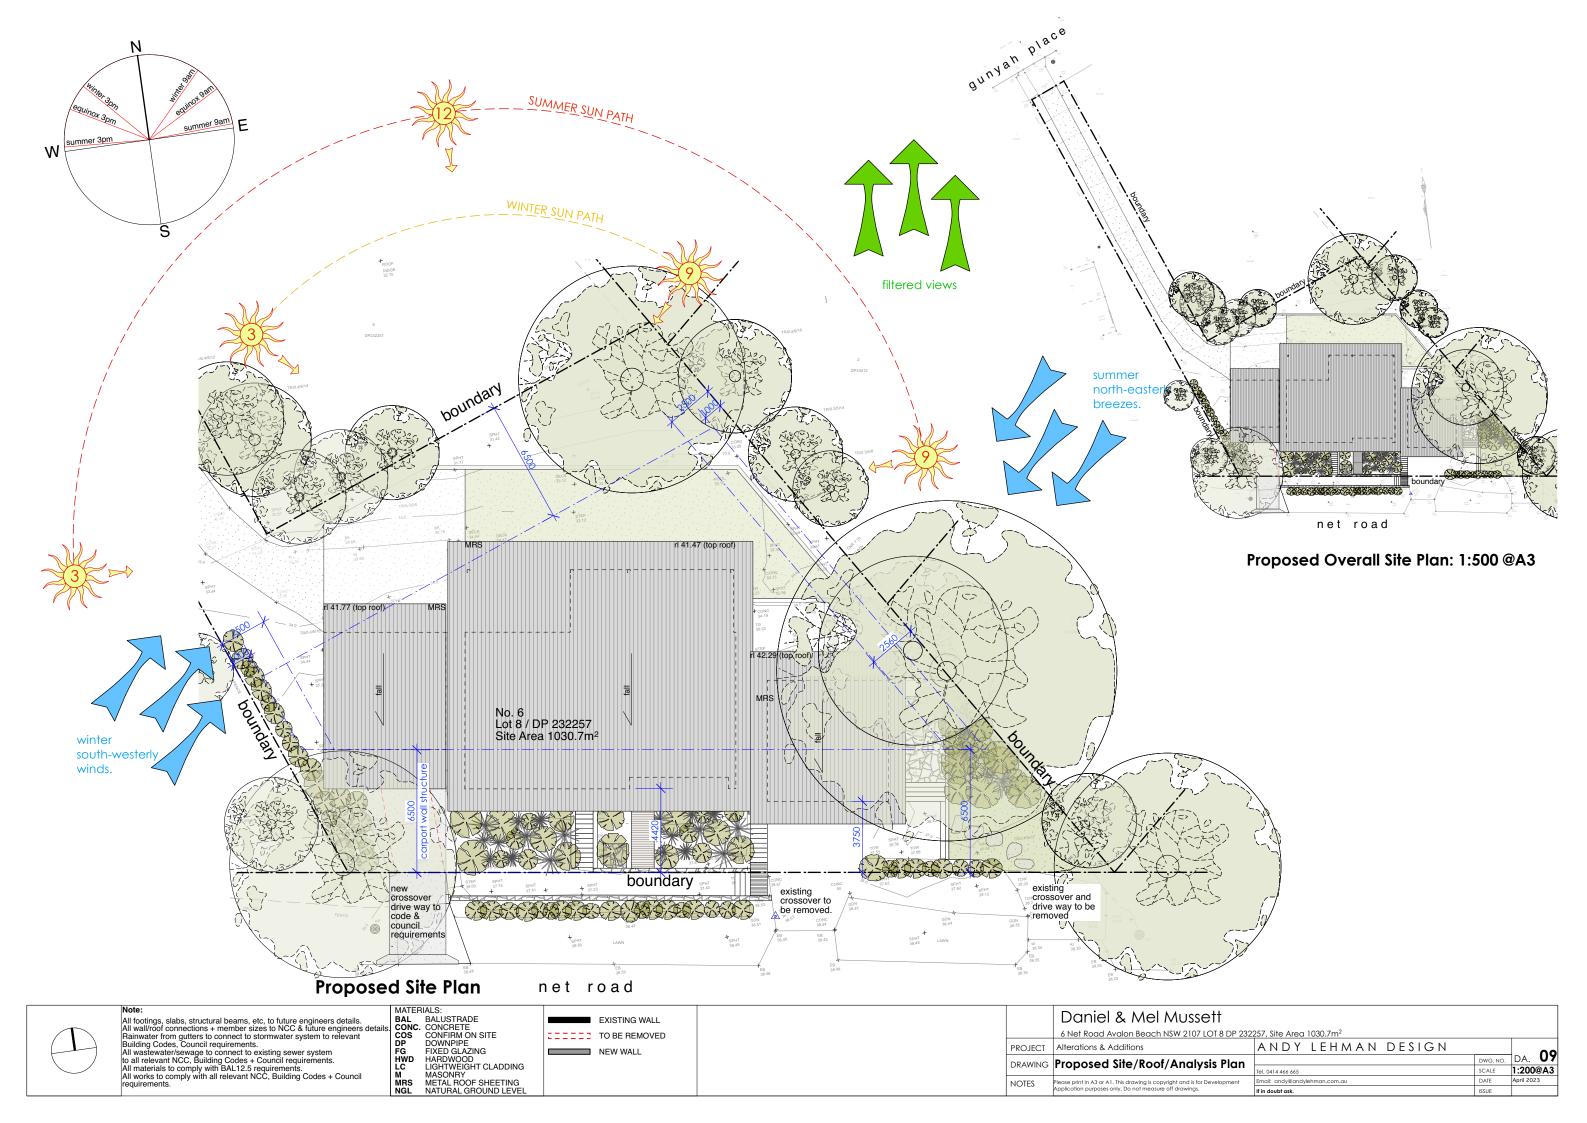

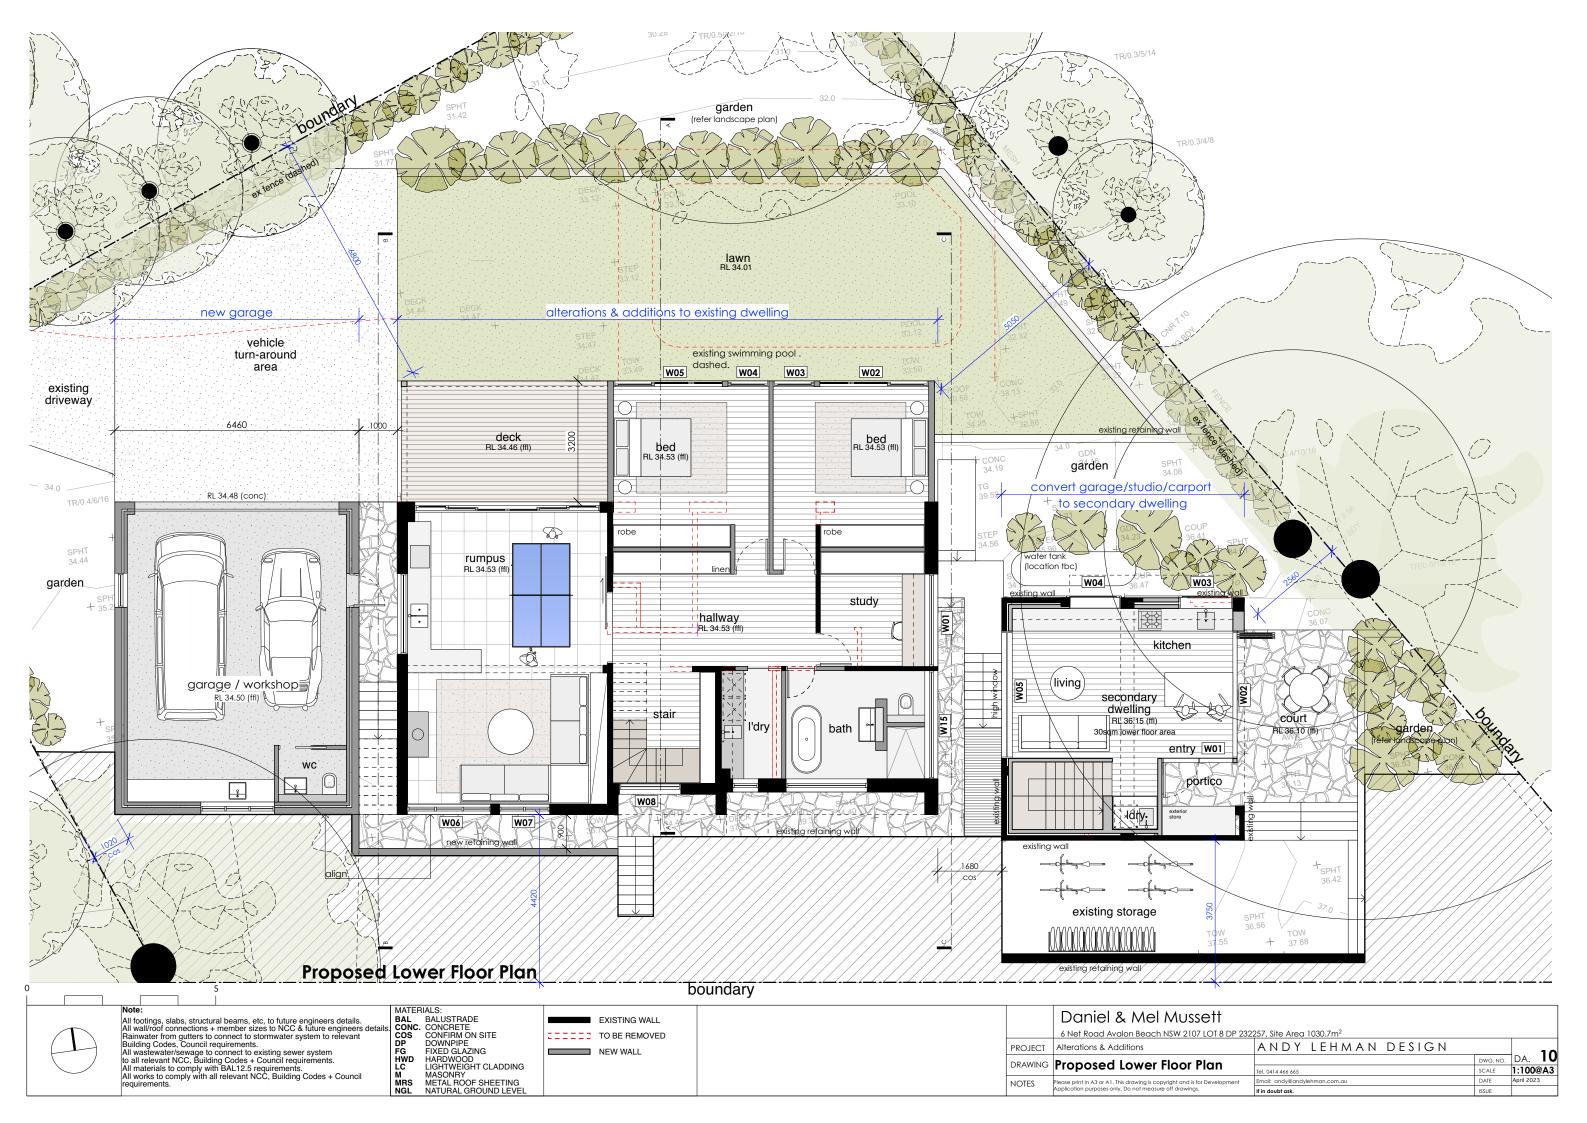

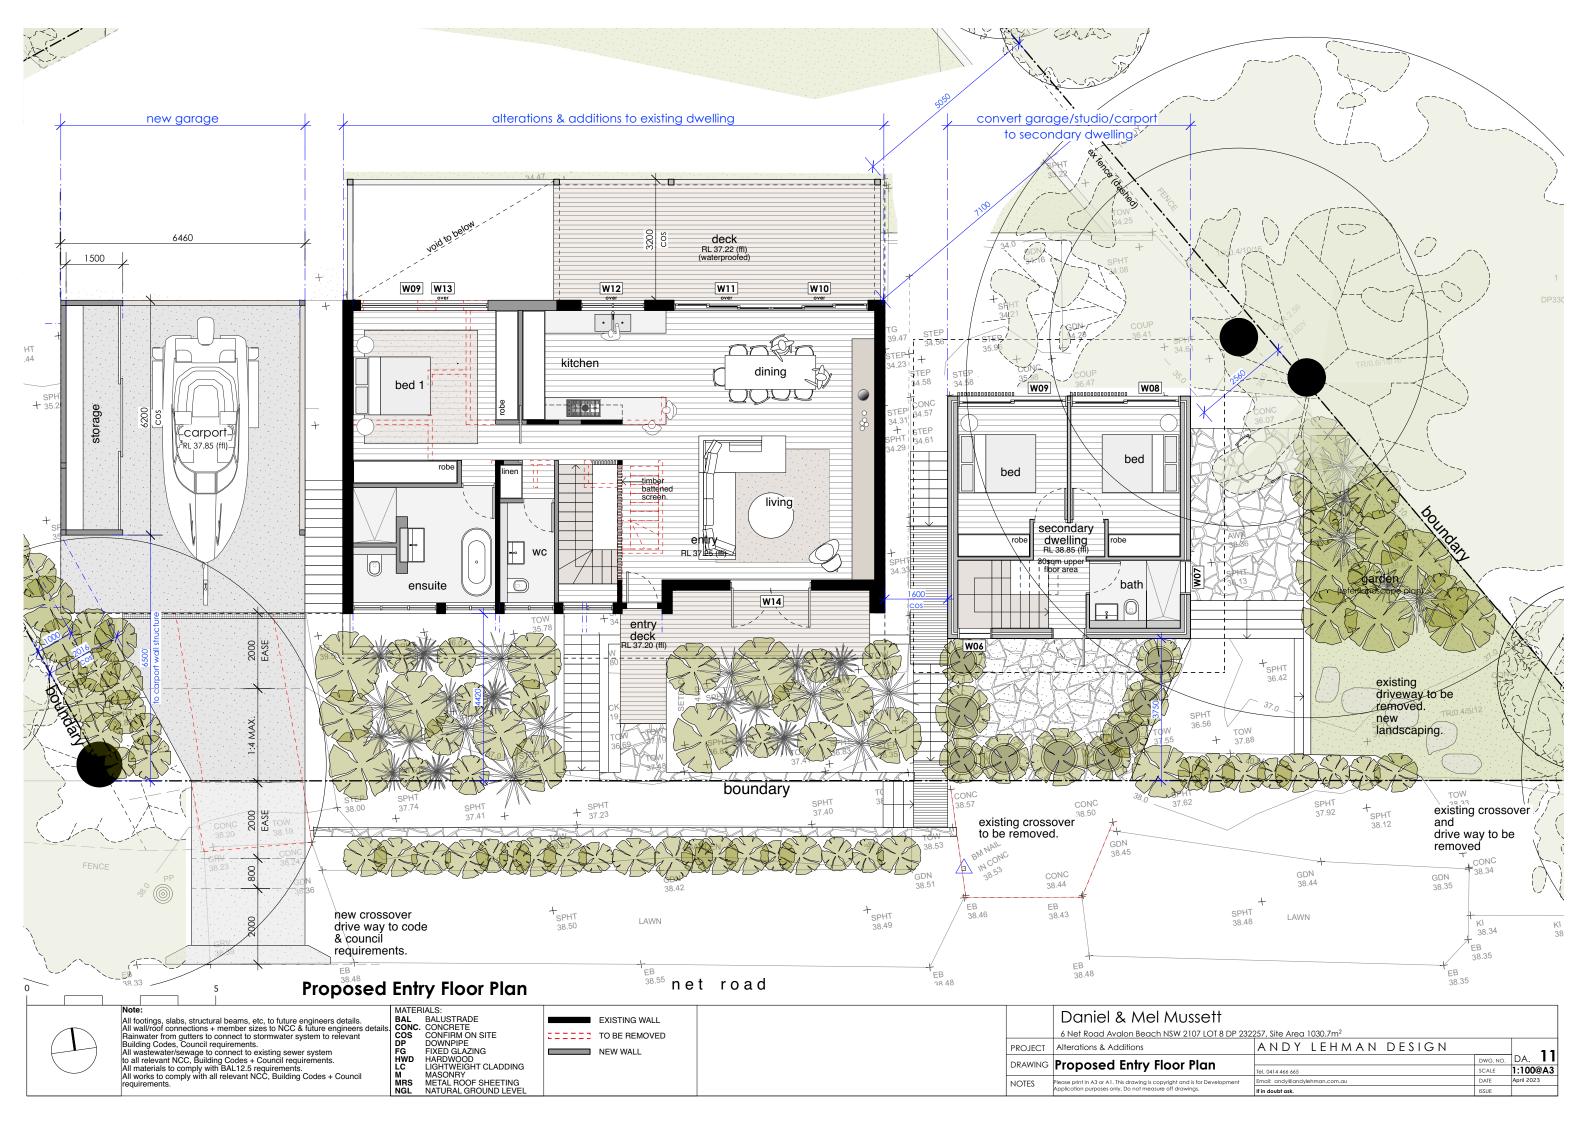

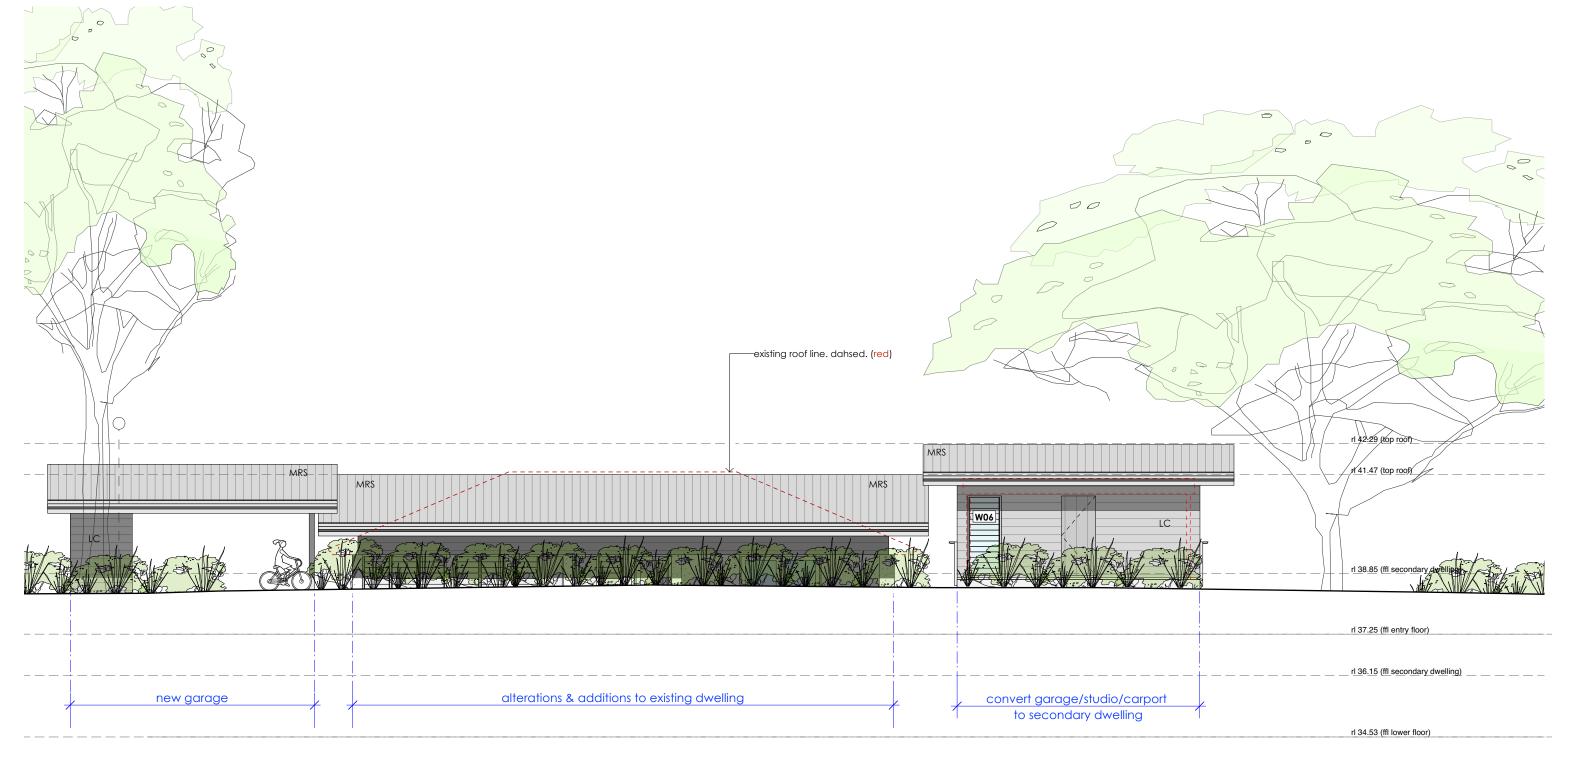

Proposed Street Elevation






Proposed North Elevation

All footings, slabs, structural beams, etc, to future engineers details. All wall/roof connections + member sizes to NCC & future engineers details. Rainwater from gutters to connect to stormwater system to relevant Building Codes, Council requirements.	COS CONFIRM ON SITE DP DOWNPIPE FG FIXED GLAZING HWD HARDWOOD LC LIGHTWEIGHT CLADDING M MASONRY TO BE REMOV NEW WALL			Daniel & Mel Mussett 6 Net Road Avalon Beach NSW 2107 LOT 8 DP 232 Alterations & Additions Proposed North Elevation	257, Site Area 1030.7m ² ANDY LEHMAN DESIGN Tel. 0414 466 665	DWG. NO.		A. 100	
requirements.	MRS METAL ROOF SHEETING NGL NATURAL GROUND LEVEL	4	NOTES	Please print in A3 or A1. This drawing is copyright and is for Development Application purposes only. Do not measure off drawings.	Email: andy@andylehman.com.au If in doubt ask.	DATE	April	120	/3





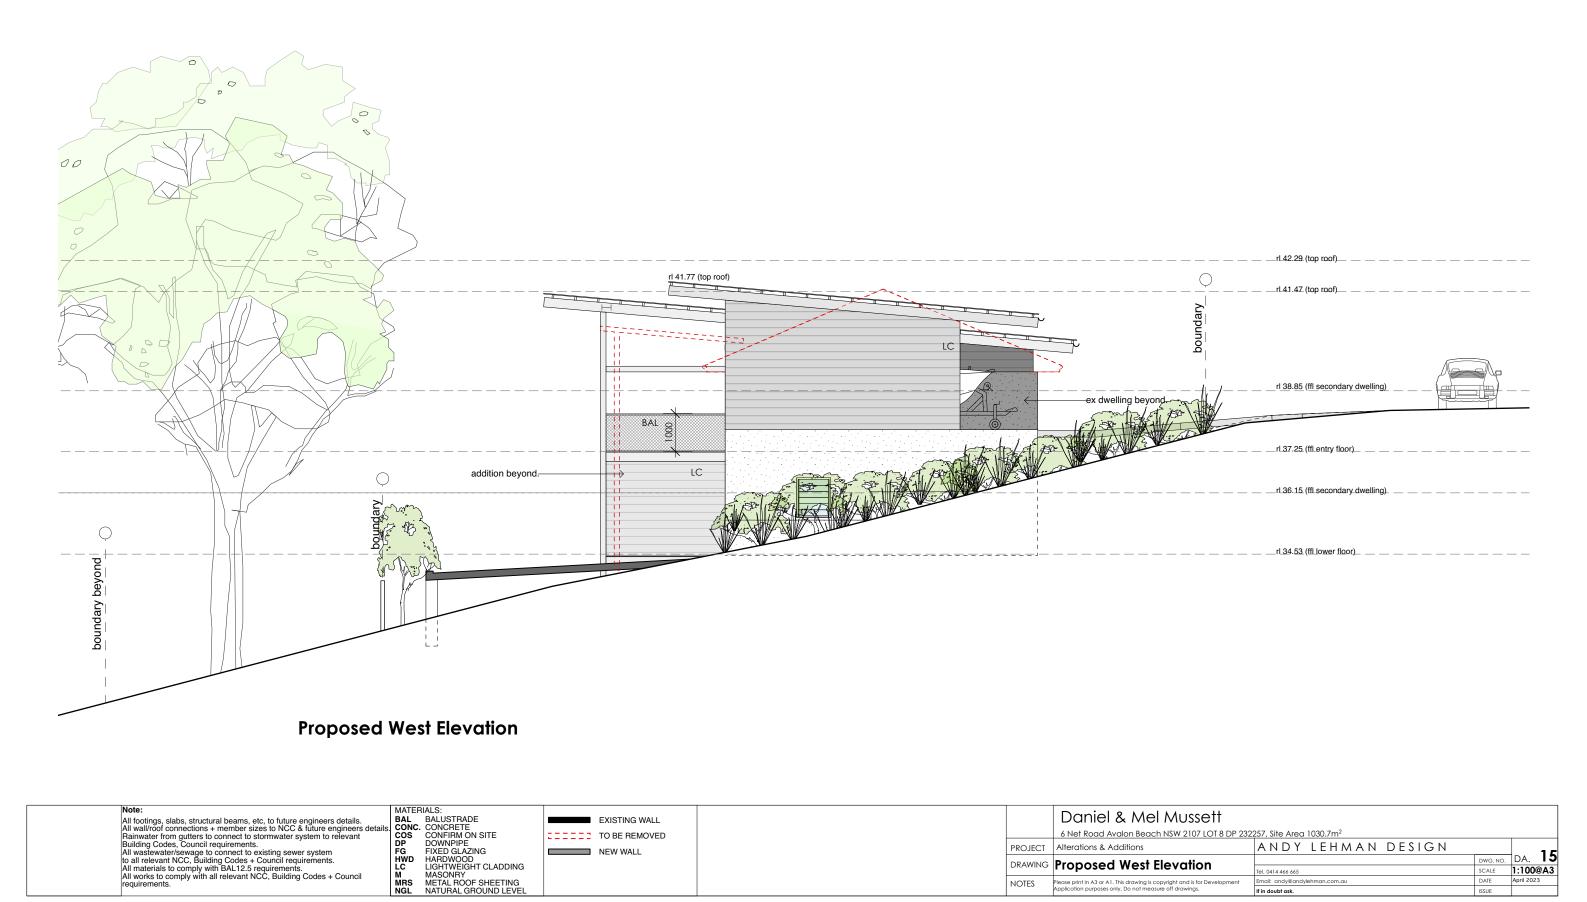

EXISTING WALL

TO BE REMOVED

NEW WALL

Daniel & Mel Mussett

lease print in A3 or A1. This drawing is copyright and is for Development spolication purposes only. Do not measure off drawings.

Alterations & Additions

NOTES

Proposed West Elevation

6 Net Road Avalon Beach NSW 2107 LOT 8 DP 232257, Site Area 1030.7m²

ANDY LEHMAN DESIGN

Tel. 0414 466 665


DA. 15
SCALE 1:100@A3


All footings, slabs, structural beams, etc, to future engineers details. All wall/roof connections + member sizes to NCC & future engineers detail Rainwater from gutters to connect to stormwater system to relevant Building Codes, Council requirements.

All wastewater/sewage to connect to existing sewer system to all relevant NCC, Building Codes + Council requirements.

All materials to comply with BAL12.5 requirements.

All works to comply with all relevant NCC, Building Codes + Council requirements.

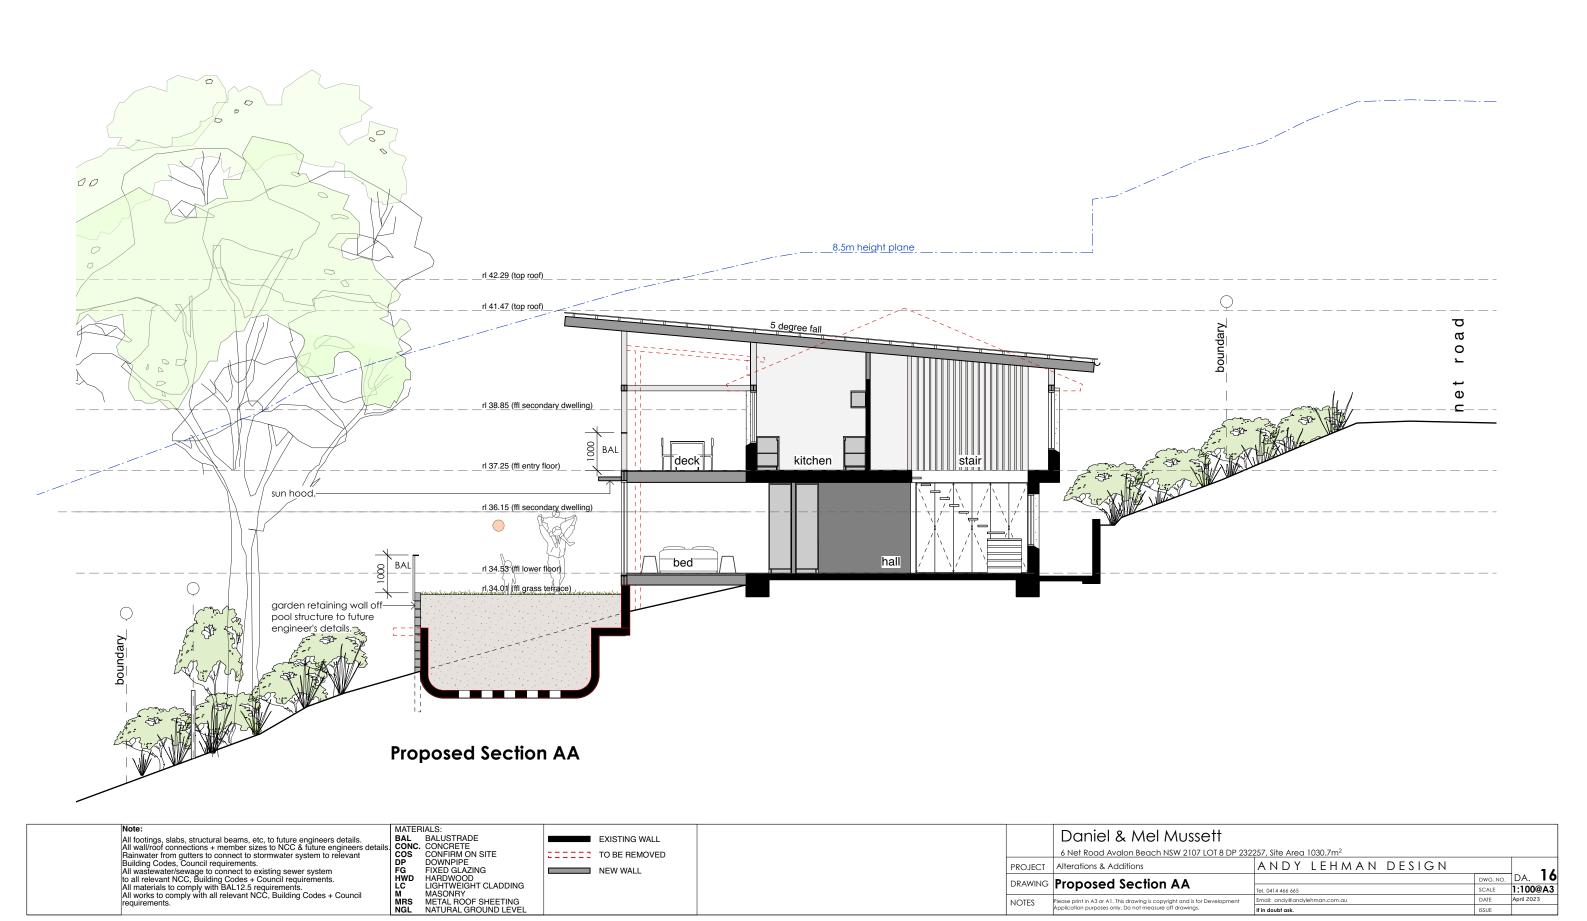

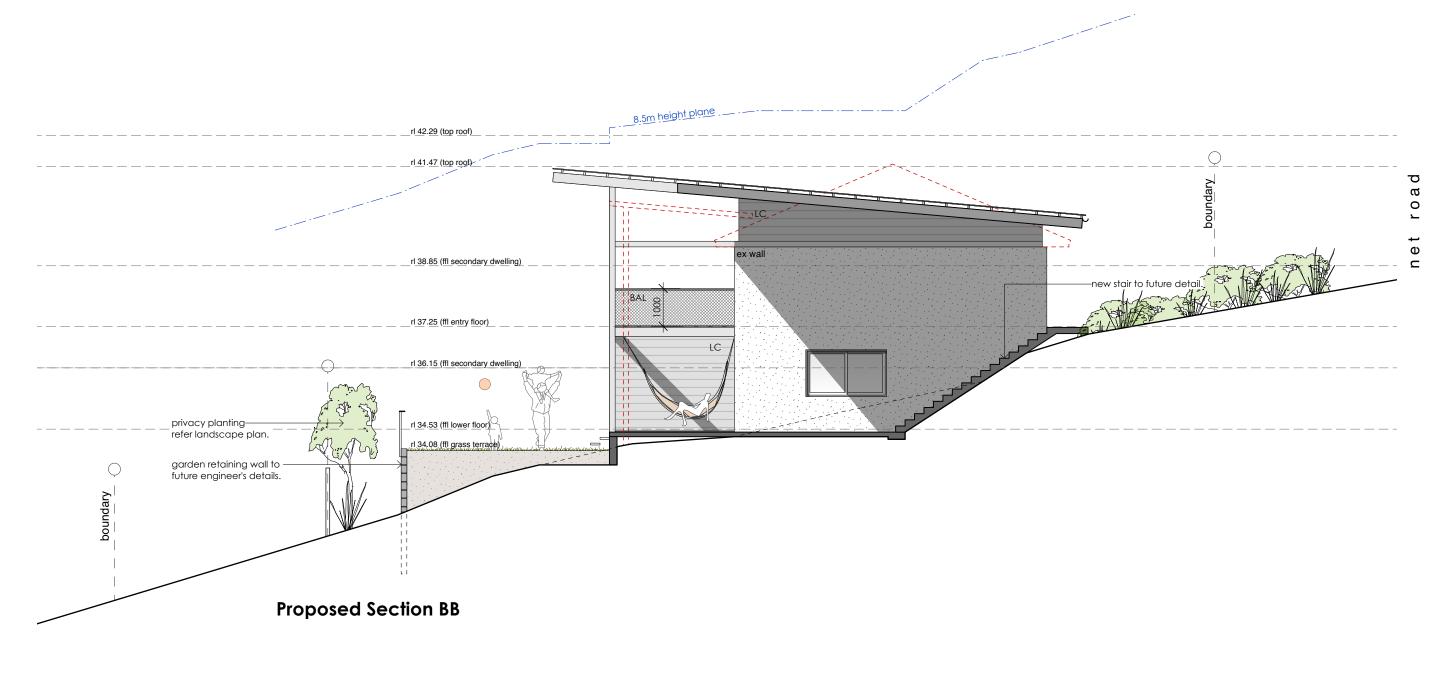

Note:
All footings, slabs, structural beams, etc, to future engineers details.
All wall/roof connections + member sizes to NCC & future engineers details.
Rainwater from gutters to connect to stormwater system to relevant Building Codes, Council requirements.
All wastewater/sewage to connect to existing sewer system to all relevant NCC, Building Codes + Council requirements.
All works to comply with all relevant NCC, Building Codes + Council requirements.
All works to comply with all relevant NCC, Building Codes + Council requirements.
All terrations & All Ind Add Add Add Into Add Add Add Into Add Add I

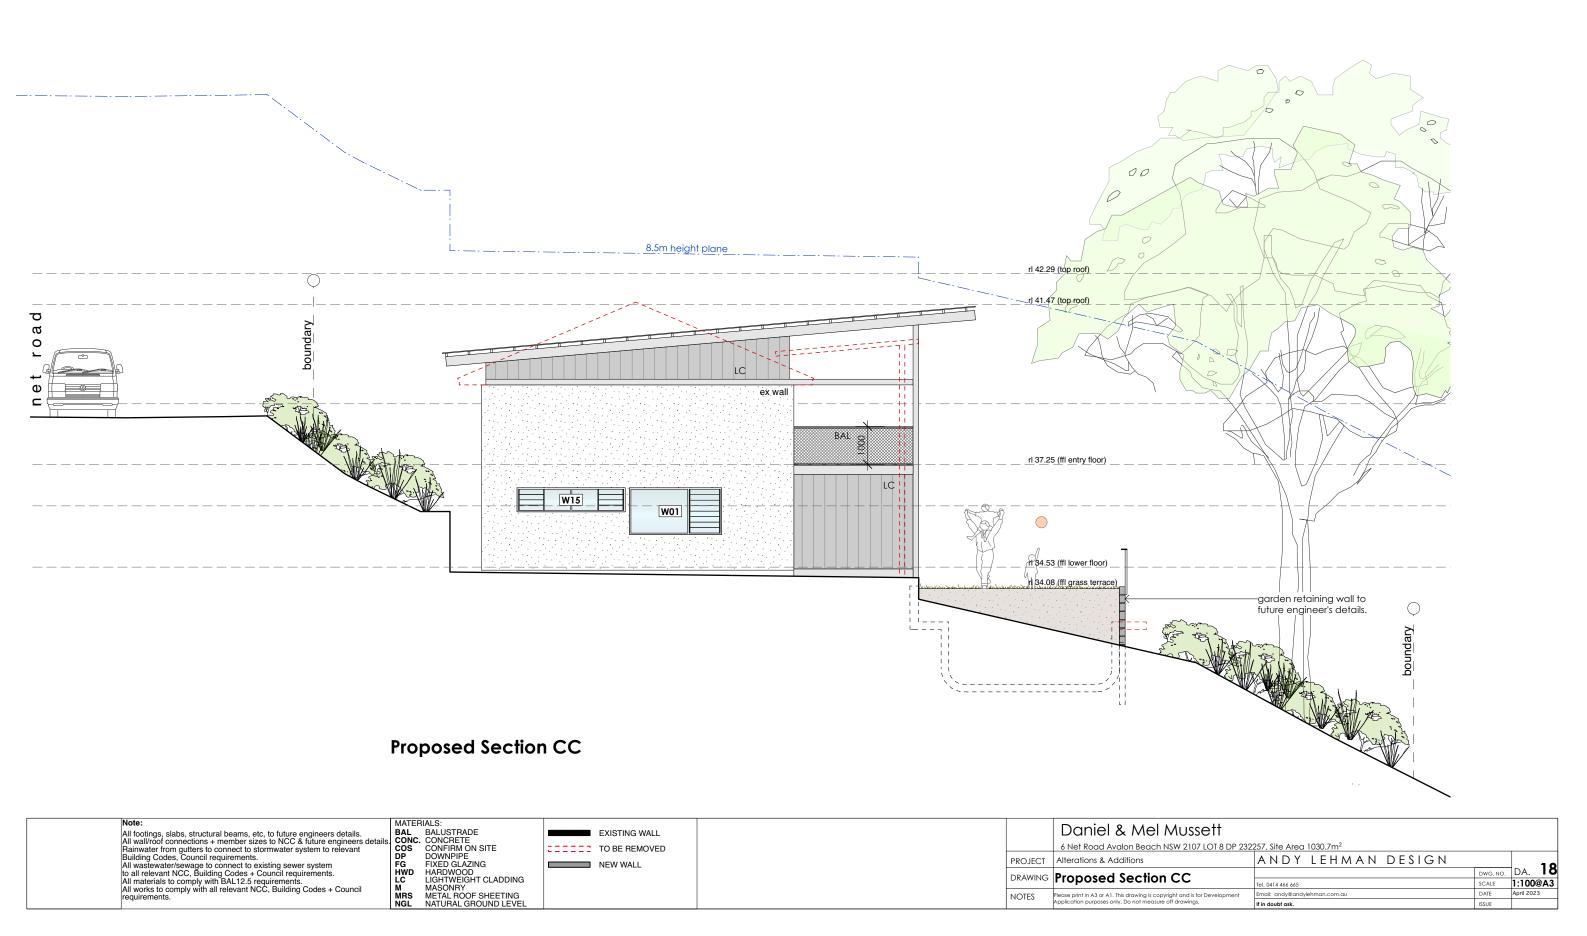

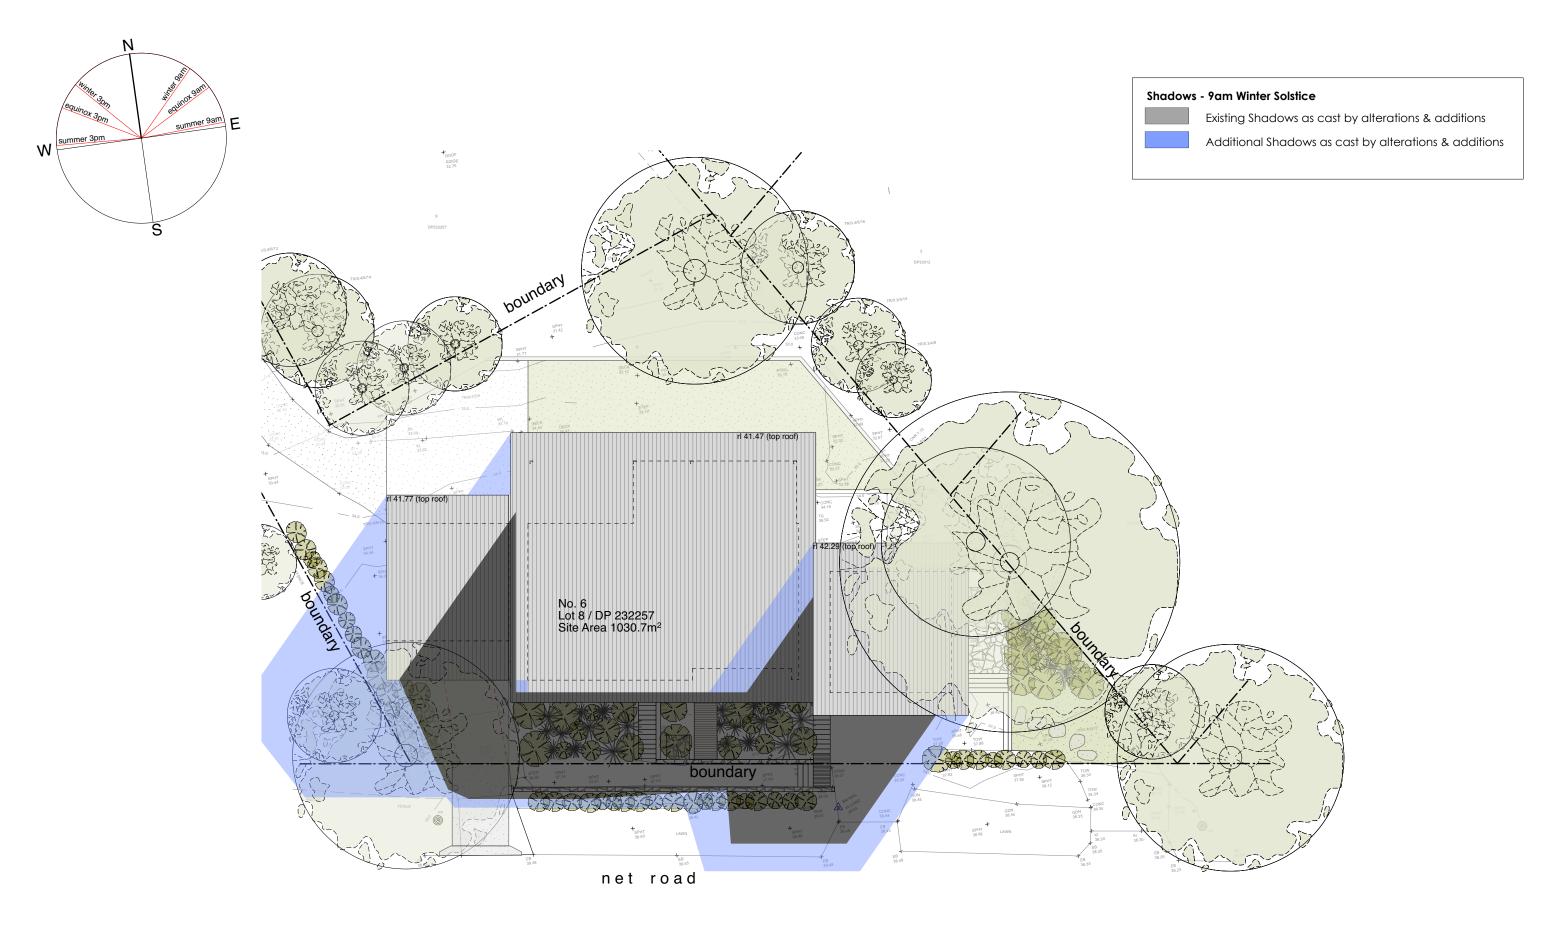

Shadow Diagram - 9am



All tootings, slabs, structural beams, etc, to future engineers details. All wall/roof connections + member sizes to NCC & future engineers details. All wall/roof connections + member sizes to NCC & future engineers detail Rainwater from gutters to connect to stormwater system to relevant Building Codes, Council requirements. All wastewater/sewage to connect to existing sewer system to all relevant NCC, Building Codes + Council requirements. All materials to comply with BAL12.5 requirements.

All works to comply with all relevant NCC, Building Codes + Council requirements.

MATERIALS:
BAL BALUSTRADE
CONC. CONCRETE
COS CONFIRM ON SITE
DP DOWNPIPE
FG FIXED GLAZING
HWD HARDWOOD
LC LIGHTWEIGHT CLADDING
M MASONRY
MRS METAL ROOF SHEETING
NGL NATURAL GROUND LEVEL

EXISTING WALL TO BE REMOVED NEW WALL

Daniel & Mel Mussett 6 Net Road Avalon Beach NSW 2107 LOT 8 DP 232257, Site Area 1030.7m² ANDY LEHMAN DESIGN Alterations & Additions DMG. NO. DA. 19
SCALE 1:200@A3 DRAWING Shadow Diagram 9am el. 0414 466 665 Please print in A3 or A1. This drawing is copyright and is for Development Application purposes only. Do not measure off drawings.



Shadow Diagram - 12noon



Nute:

All footings, slabs, structural beams, etc, to future engineers details. All wall/roof connections + member sizes to NCC & future engineers detail Rainwater from gutters to connect to stormwater system to relevant Building Codes, Council requirements.

All wastewater/sewage to connect to existing sewer system to all relevant NCC, Building Codes + Council requirements.

All materials to comply with BAL12.5 requirements.

All works to comply with all relevant NCC, Building Codes + Council requirements.


MATERIALS:
BAL BALUSTRADE
CONC. CONCRETE
COS CONFIRM ON SITE
DP DOWNPIPE
FG FIXED GLAZING
HWD HARDWOOD
LC LIGHTWEIGHT CLADDING
M MASONRY
MRS METAL ROOF SHEETING
NGL NATURAL GROUND LEVEL

EXISTING WALL TO BE REMOVED NEW WALL

Daniel & Mel Mussett 6 Net Road Avalon Beach NSW 2107 LOT 8 DP 232257, Site Area 1030.7m² ANDY LEHMAN DESIGN Alterations & Additions DRAWING Shadow Diagram 12noon Tel. 0414 466 665

Please print in A3 or A1. This drawing is copyright and is for Development

DMG.NO. DA. 20 SCALE 1:200@A3

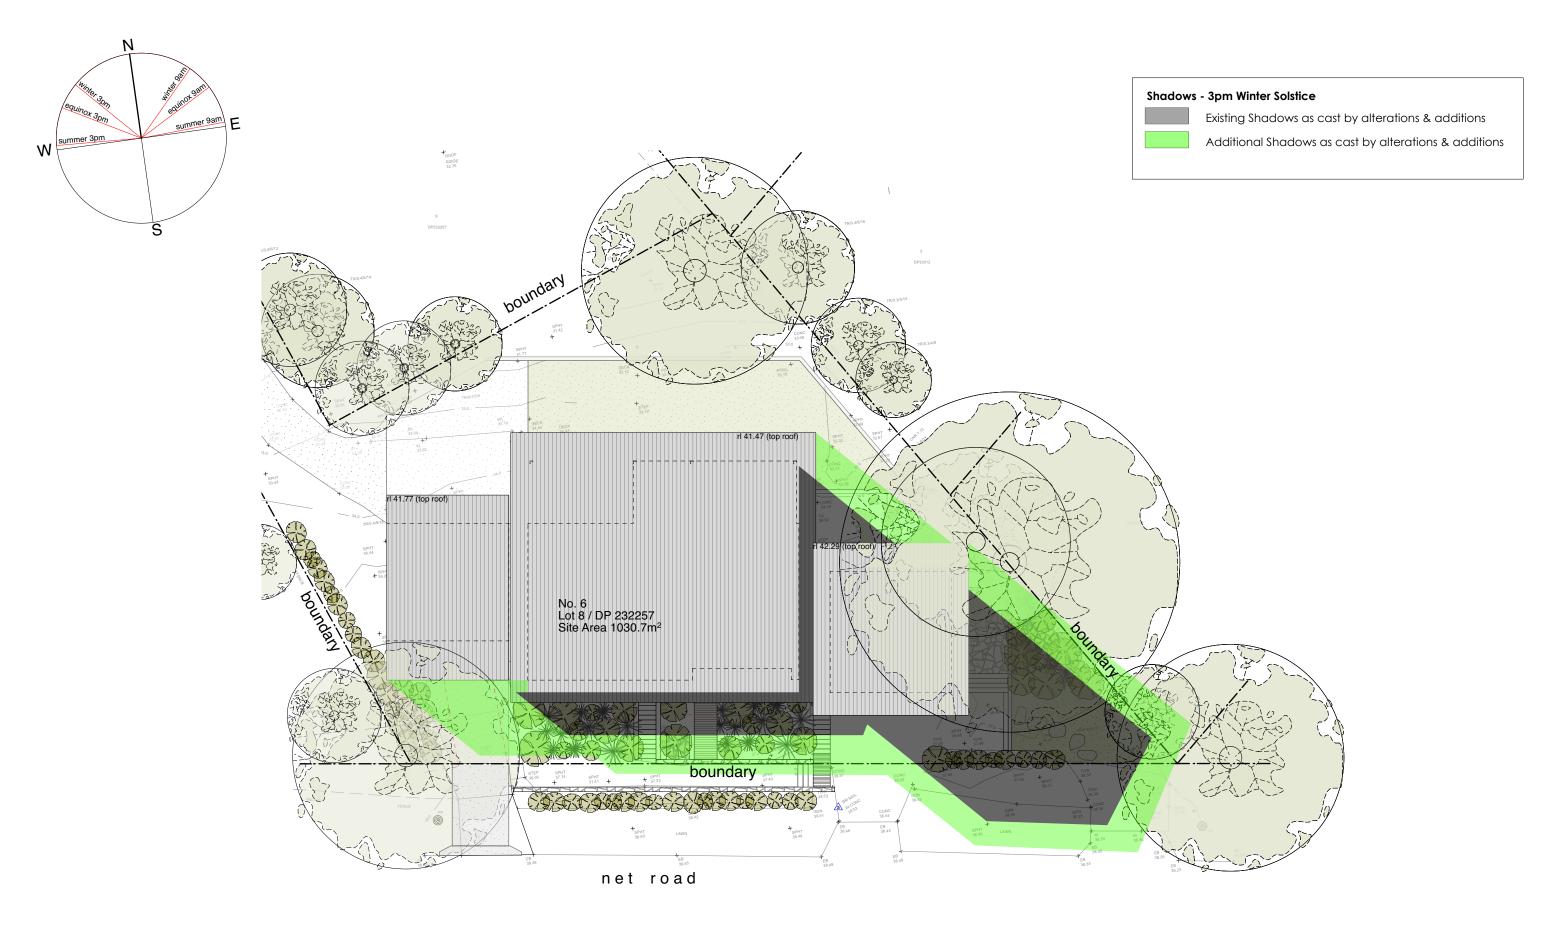

Shadow Diagram - 3pm




All tootings, slabs, structural beams, etc, to future engineers details. All wall/roof connections + member sizes to NCC & future engineers details. All wall/roof connections + member sizes to NCC & future engineers detail Rainwater from gutters to connect to stormwater system to relevant Building Codes, Council requirements. All wastewater/sewage to connect to existing sewer system to all relevant NCC, Building Codes + Council requirements. All materials to comply with BAL12.5 requirements.

All works to comply with all relevant NCC, Building Codes + Council requirements.

MATERIALS:
BAL BALUSTRADE
CONC. CONCRETE
COS CONFIRM ON SITE
DP DOWNPIPE
FG FIXED GLAZING
HWD HARDWOOD
LC LIGHTWEIGHT CLADDING
M MASONRY
MRS METAL ROOF SHEETING
NGL NATURAL GROUND LEVEL

EXISTING WALL TO BE REMOVED NEW WALL

Daniel & Mel Mussett 6 Net Road Avalon Beach NSW 2107 LOT 8 DP 232257, Site Area 1030.7m² ANDY LEHMAN DESIGN Alterations & Additions DA. 21 SCALE 1:200@A3 DRAWING Shadow Diagram 3pm el. 0414 466 665 Please print in A3 or A1. This drawing is copyright and is for Development Application purposes only. Do not measure off drawings. NOTES

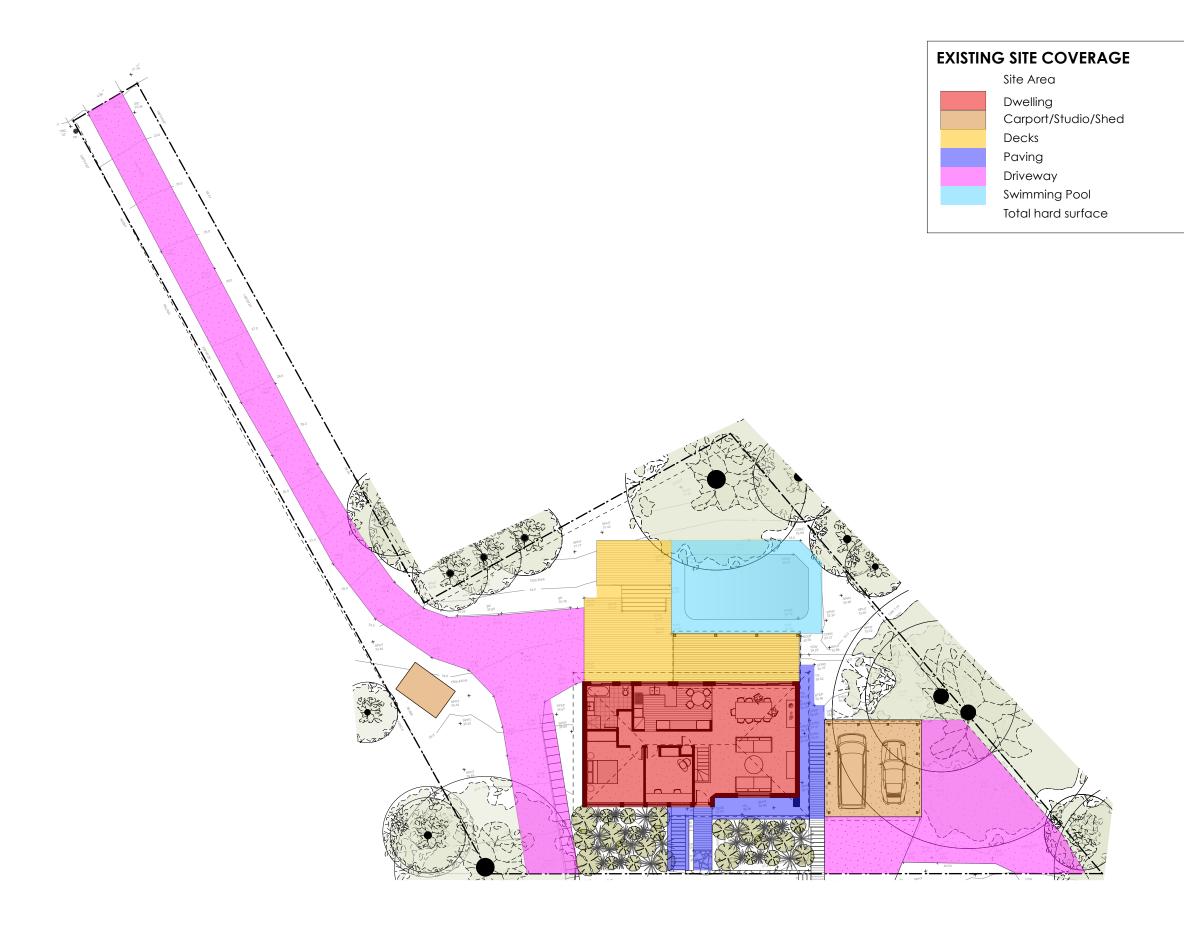

1030.7m²

115.4m²

48.3m²


77.6m²

34.5m² 284.2m²

60.1m²

(60.2%) 620.1m²



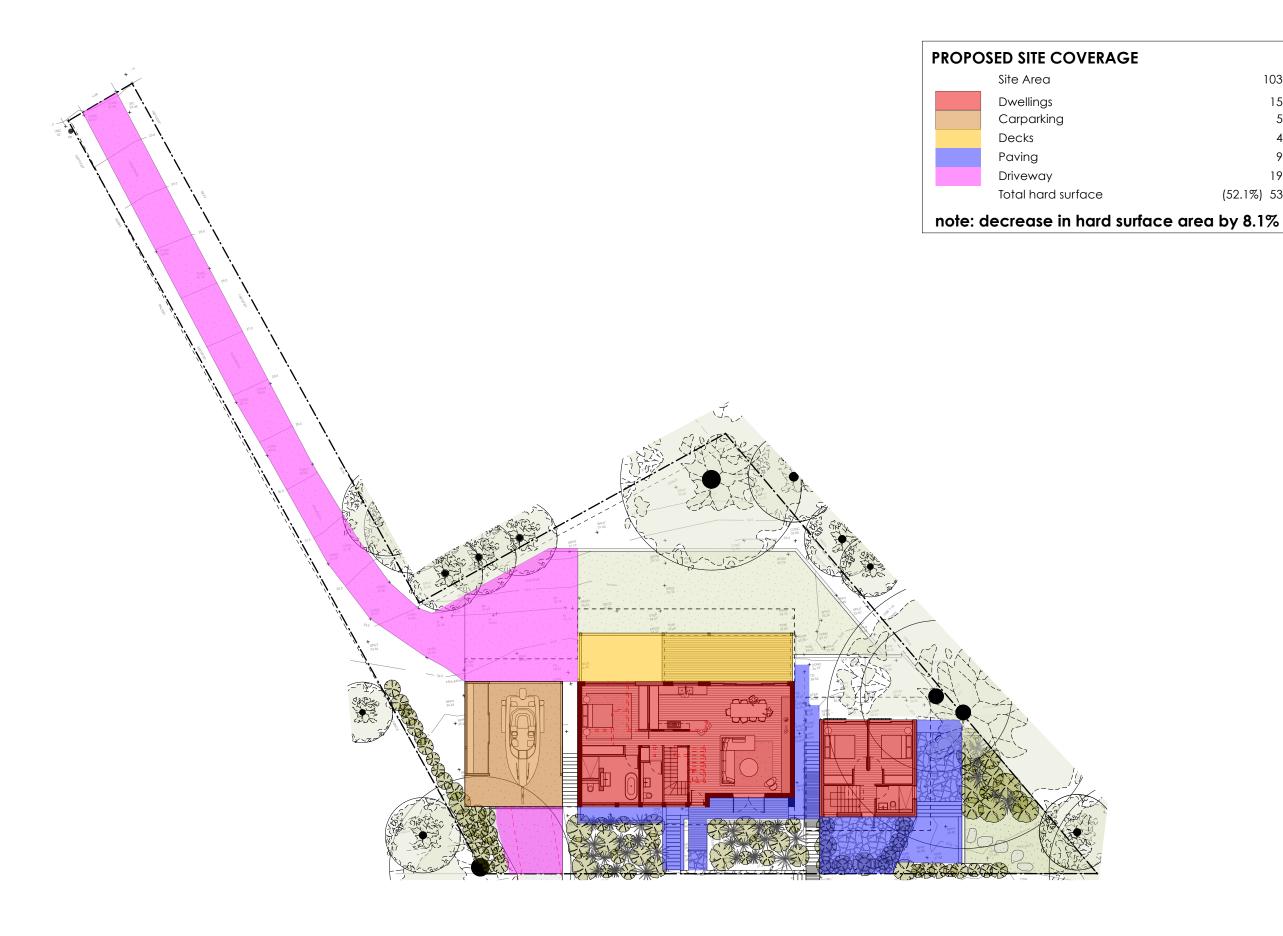

1030.7m²

156.5m²


53.4m²

45.4m²

91.1m² 190.9m²

(52.1%) 537.3m²

MATERIALS: BAL BALUSTRADE CONC. CONCRETE COS CONFIRM ON SITE DP DOWNPIPE FG FIXED GLAZING HWD HARDWOOD LC LIGHTWEIGHT CLADDING M MASONRY MRS METAL ROOF SHEETING NGL NATURAL GROUND LEVEL Note: All footings, slabs, structural beams, etc, to future engineers details. All wall/roof connections + member sizes to NCC & future engineers detail Rainwater from gutters to connect to stormwater system to relevant Building Codes, Council requirements. All wastewater/sewage to connect to existing sewer system to all relevant NCC, Building Codes + Council requirements. All materials to comply with BAL12.5 requirements. All works to comply with all relevant NCC, Building Codes + Council requirements. Daniel & Mel Mussett EXISTING WALL 6 Net Road Avalon Beach NSW 2107 LOT 8 DP 232257, Site Area 1030.7m² TO BE REMOVED ANDY LEHMAN DESIGN Alterations & Additions NEW WALL DA. 22.2 SCALE 1:250@A3 DRAWING Site Coverage - Proposed Tel. 0414 466 665 NOTES Please print in A3 or A1. This drawing is copyright and is for Development

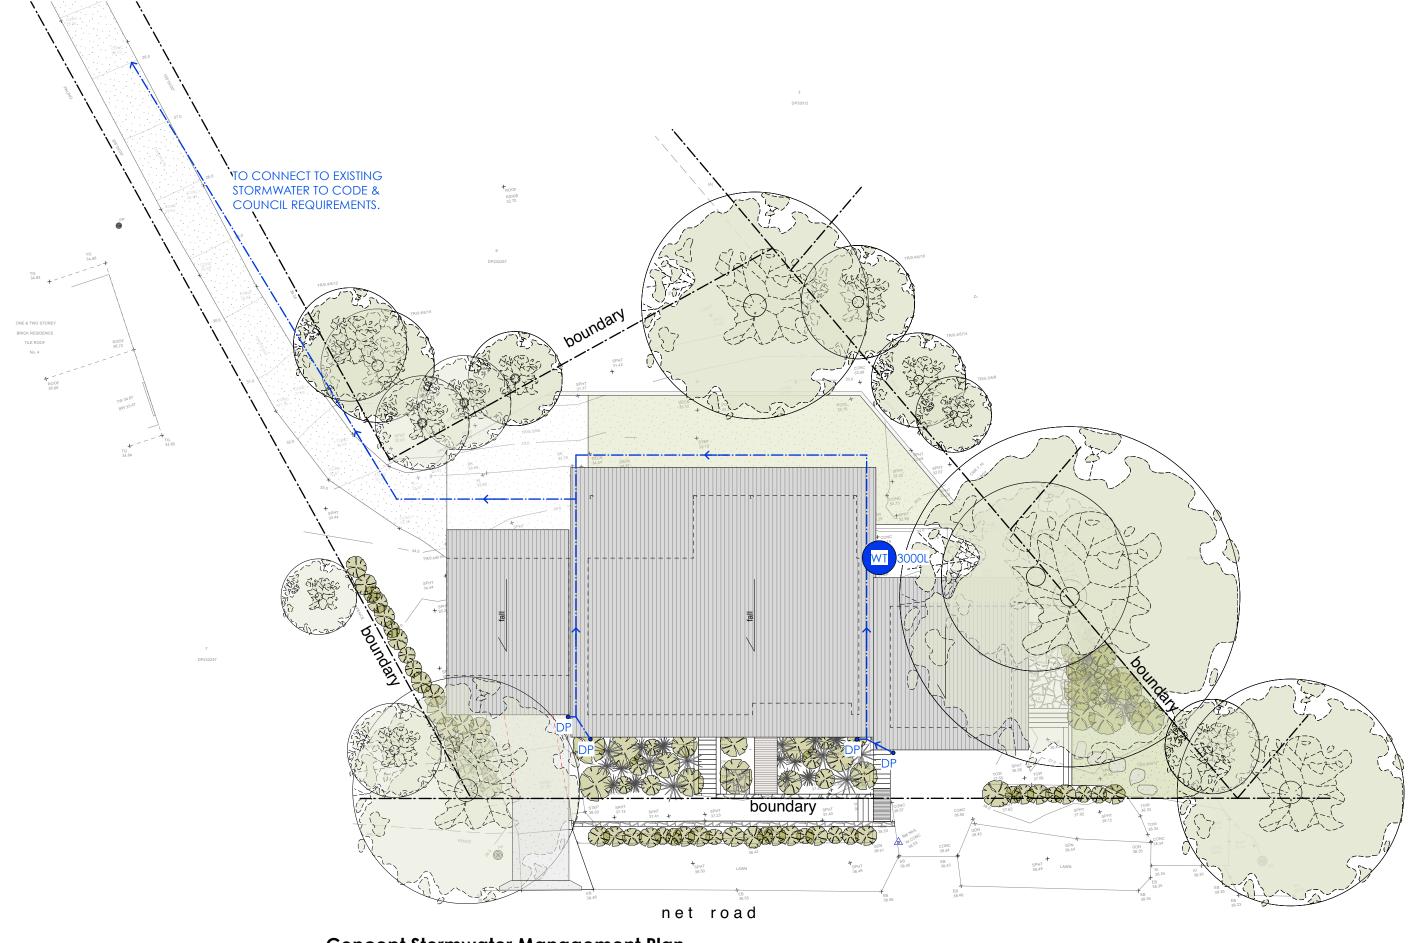

Concept Stormwater Management Plan




Note:
All footings, slabs, structural beams, etc, to future engineers details.
All wall/roof connections + member sizes to NCC & future engineers deta
Rainwater from gutters to connect to stormwater system to relevant
Building Codes, Council requirements.
All wastewater/sewage to connect to existing sewer system
to all relevant NCC, Building Codes + Council requirements.
All materials to comply with BAL12.5 requirements.
All works to comply with all relevant NCC, Building Codes + Council
requirements.

MATERIALS:
BAL BALUSTRADE
CONC. CONCRETE
COS CONFIRM ON SITE
DP DOWNPIPE
FG FIXED GLAZING
HWD HARDWOOD
LC LIGHTWEIGHT CLADDING
M MASONRY
MRS METAL ROOF SHEETING
NGL NATURAL GROUND LEVEL

EXISTING WALL TO BE REMOVED NEW WALL

	Daniel & Mel Mussett			
	6 Net Road Avalon Beach NSW 2107 LOT 8 DP 232	257, Site Area 1030.7m ²		
PROJECT	Alterations & Additions	ANDY LEHMAN DESIGN		. 23
DRAWING	Concept Stormwater Management Plan		DWG. NO.	DA. 23
DRAWING	Concept Communici Management Ha	Tel. 0414 466 665	SCALE	1:200@A3
	Please print in A3 or A1. This drawing is copyright and is for Development	Email: andy@andylehman.com.au	DATE	April 2023
1	Application purposes only. Do not measure off drawings.		100115	

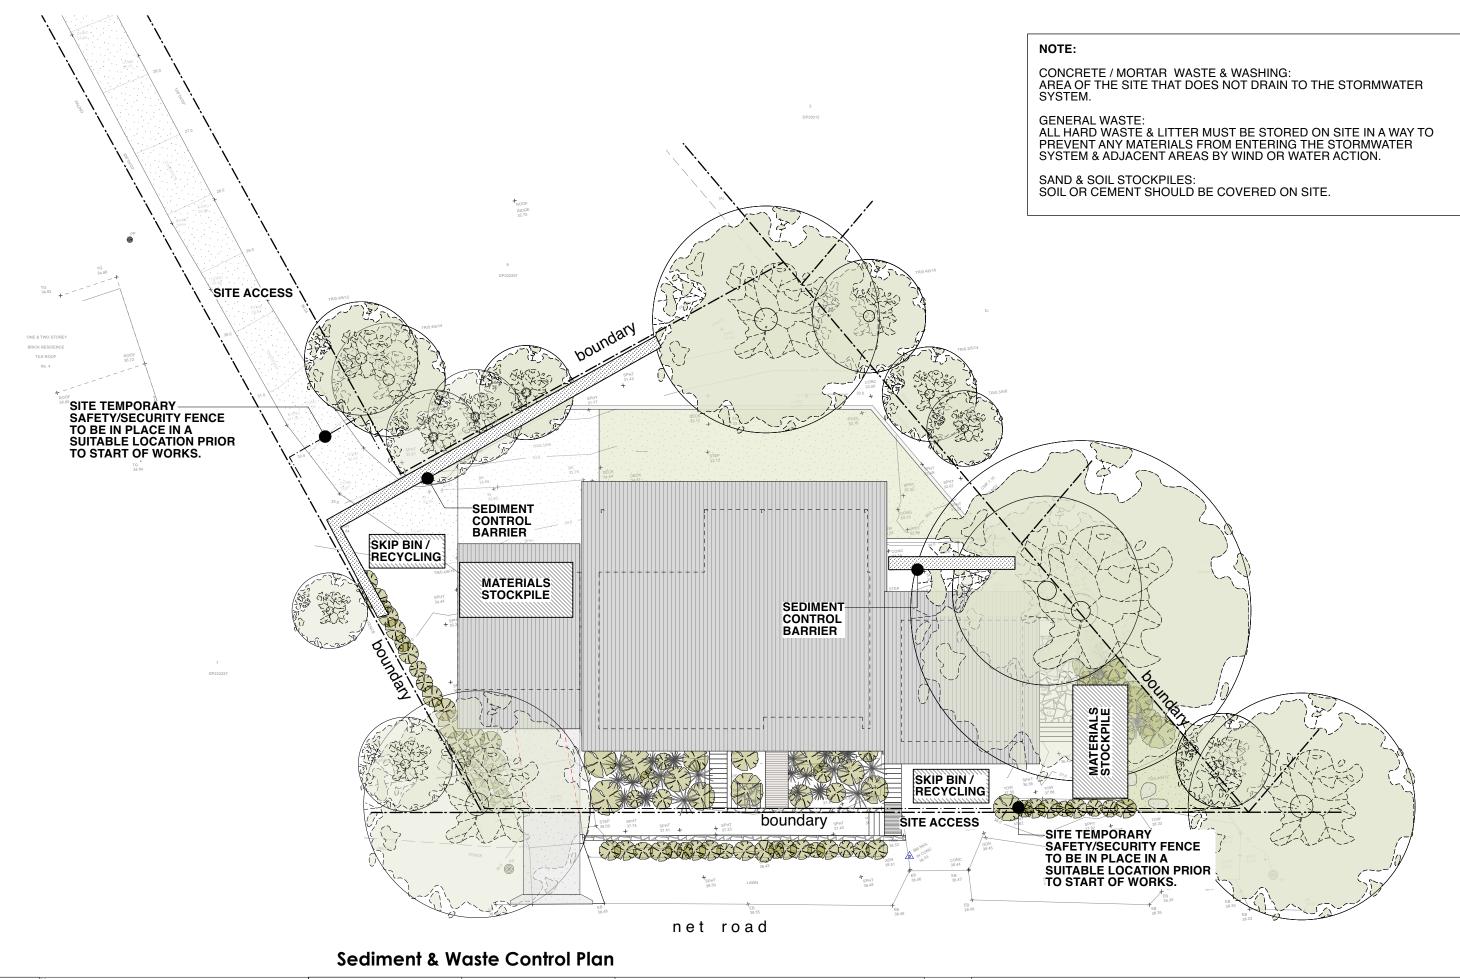



All footings, slabs, structural beams, etc, to future engineers details. All wall/roof connections + member sizes to NCC & future engineers detail Rainwater from gutters to connect to stormwater system to relevant Building Codes, Council requirements.

All wastewater/sewage to connect to existing sewer system to all relevant NCC, Building Codes + Council requirements.

All materials to comply with BAL12.5 requirements.

All works to comply with all relevant NCC, Building Codes + Council requirements.

MATERIALS:
BAL BALUSTRADE
CONC. CONCRETE
COS CONFIRM ON SITE
DP DOWNPIPE
FG FIXED GLAZING
HWD HARDWOOD
LC LIGHTWEIGHT CLADDING
M MASONRY
MRS METAL ROOF SHEETING
NGL NATURAL GROUND LEVEL

EXISTING WALL TO BE REMOVED NEW WALL

Daniel & Mel Mussett 6 Net Road Avalon Beach NSW 2107 LOT 8 DP 232257, Site Area 1030.7m² ANDY LEHMAN DESIGN Alterations & Additions DA. 24 SCALE 1:200@A3 DRAWING Sediment & Waste Control Plan el. 0414 466 665 lease print in A3 or A1. This drawing is copyright and is for Development NOTES