

## **LEGEND**


CR timber framed roof with Colorbond cladding UPVC UPVC window rail to BCA/NCC

CR timber framed
UPVC UPVC window
RA rail to BCA/NC
PG pergola
PW painted wall
SK skylight
SC screen

ALL TIMBER FRAMING AND FOOTINGS TO ENGINEERS DETAILS

EXISTING SITE SERVICES TO BE USED

STORMWATER TO BE CONNECTED TO EXISTING SYSTEM

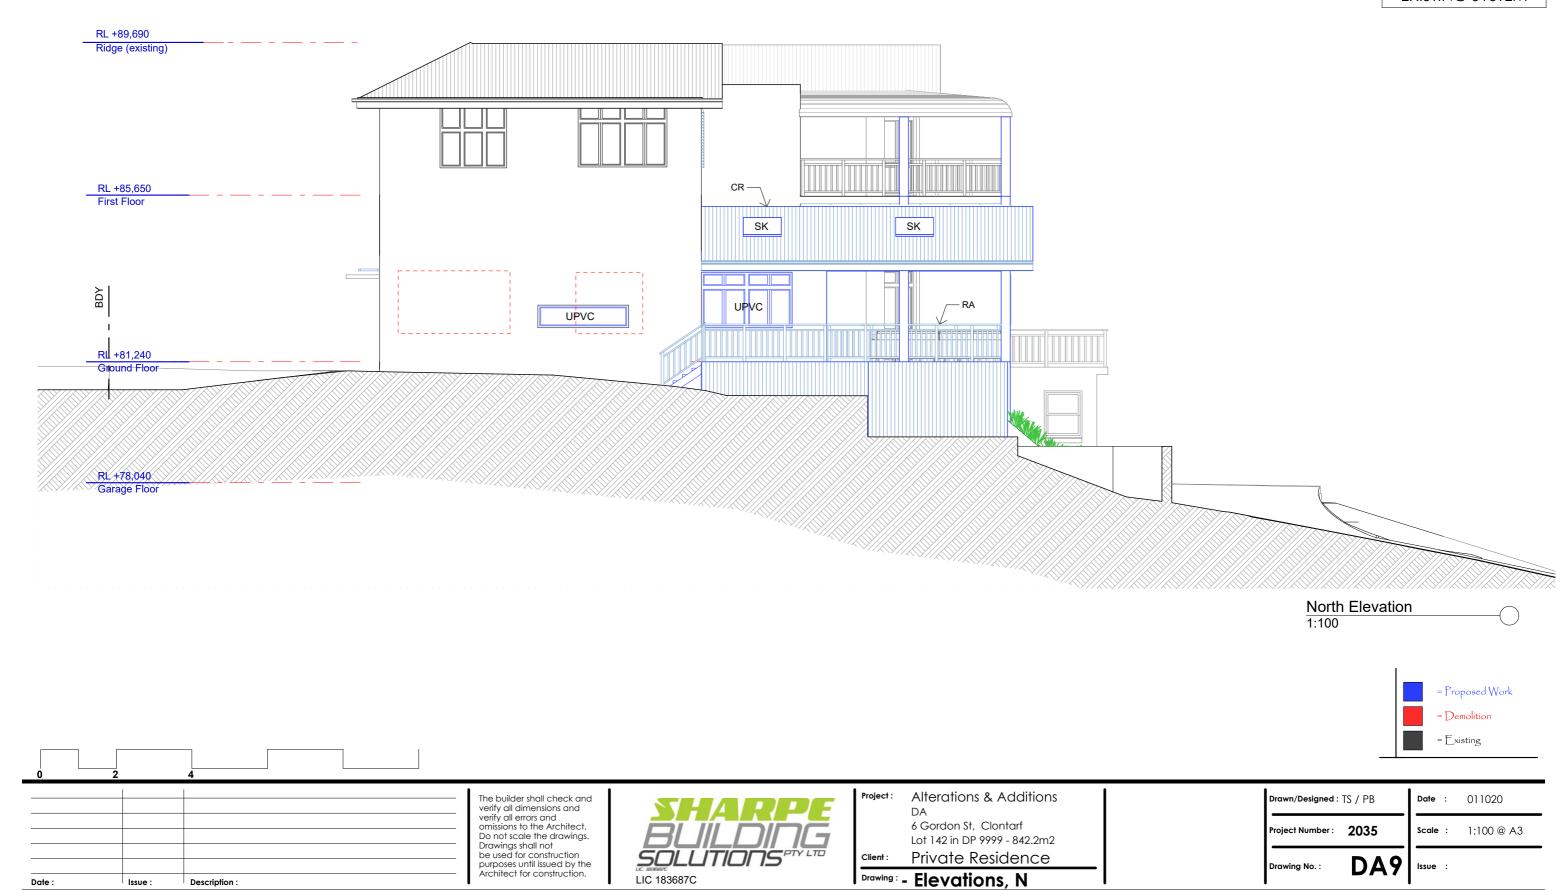

ALL TIMBER FRAMING AND FOOTINGS TO **ENGINEERS DETAILS LEGEND EXISTING SITE** CR UPVC timber framed roof with Colorbond cladding UPVC window SERVICES TO BE USED RA rail to BCA/NCC PG pergola painted wall STORMWATER TO BE PW CONNECTED TO SK SC skylight screen EXISTING SYSTEM RL +89,690 Ridge (existing) RL +85,650 First Floor SC RL +81,240 Ground Floor RL +78,040 Garage Floor RL +75<u>,350</u> South Elevation = Proposed Work 1:100 = Demolition = Existing The builder shall check and verify all dimensions and verify all errors and omissions to the Architect. Do not scale the drawings. Alterations & Additions Drawn/Designed: TS / PBDate : 011020 6 Gordon St, Clontarf Project Number: 2035 Scale: 1:100 @ A3 Lot 142 in DP 9999 - 842.2m2 Drawings shall not be used for construction purposes until issued by the Architect for construction. Private Residence Drawing No.: DA10 Drawing: - Elevations, S LIC 183687C Description : Date:


EXISTING SITE SERVICES TO BE USED

STORMWATER TO BE CONNECTED TO EXISTING SYSTEM

# **LEGEND**

R timber framed roof with Colorbond cladding

UPVC UPVC window
RA rail to BCA/NCC
PG pergola
PW painted wall
SK skylight
SC screen

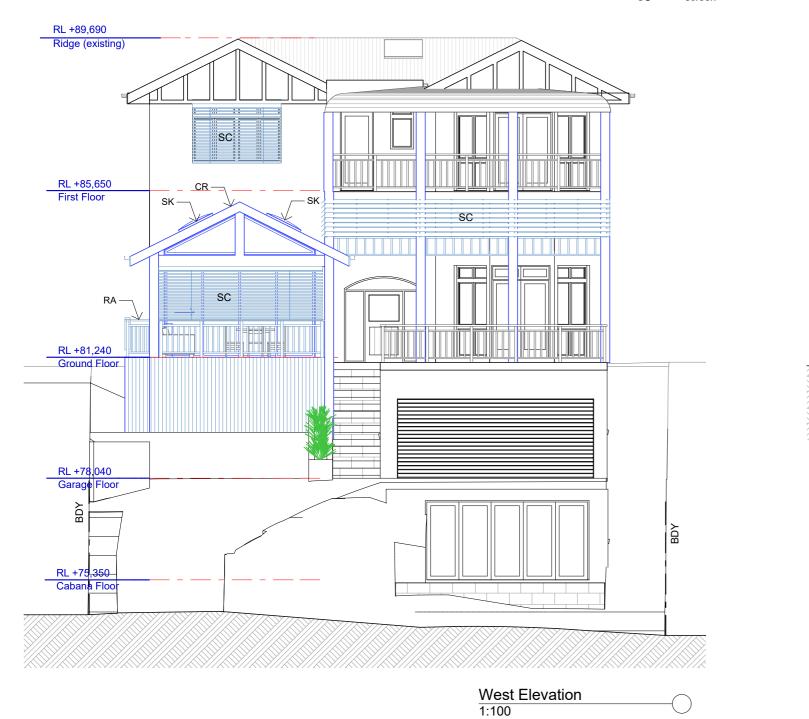



= Proposed Work
= Demolition
= Existing

The builder shall check and verify all dimensions and verify all errors and omissions to the Architect.
Do not scale the drawings.
Drawings shall not be used for construction purposes until issued by the Architect for construction.

Description :

Date:



Alterations & Additions
DA

6 Gordon St, Clontarf Lot 142 in DP 9999 - 842.2m2

Private Residence

Drawing: - Elevations, E, W

Drawn/Designed: TS / PB

1:100

Project Number: 2035

Scale : 1:100 @ A3

Date : 011020

Drawing No.: DA11 Issue :

ALL TIMBER FRAMING AND FOOTINGS TO **ENGINEERS DETAILS** EXISTING SITE SERVICES TO BE USED STORMWATER TO BE CONNECTED TO EXISTING SYSTEM RL +89,690 Ridge (existing) RL +85,650 First Floor BUTLERS PANTRY BDY KITCHEN DECK DINING 81,240 RL +81,240 Ground Floor RL +78,040 Garage Floor Section A-A 1:100 = Proposed Work = Demolition = Existing The builder shall check and verify all dimensions and verify all errors and omissions to the Architect. Do not scale the drawings. Drawings shall not be used for construction purposes until issued by the Architect for construction. Alterations & Additions Date : 011020 Drawn/Designed: TS / PB6 Gordon St, Clontarf Project Number: 2035 Scale : 1:100 @ A3 Lot 142 in DP 9999 - 842.2m2 Private Residence Drawing No.: DA12 Issue : Drawing: - Sections A-A Description : Date:

EXISTING SITE SERVICES TO BE USED

STORMWATER TO BE CONNECTED TO EXISTING SYSTEM

RL +89,690

Ridge (existing)

RL +85,650 First Floor

RL +81,240 Ground Floor





Date: Issue: Description:

The builder shall check and verify all dimensions and verify all errors and omissions to the Architect. Do not scale the drawings. Drawings shall not be used for construction purposes until issued by the Architect for construction.



oject: Alterations & Additions DA

6 Gordon St, Clontarf Lot 142 in DP 9999 - 842.2m2

Client: Private Residence

Drawing: - Sections B-B

Drawn/Designed: TS / PB

Project Number: 2035

ect Number: 2035

Drawing No.: DA13

Scale : 1:100 @ A3

Date : 011020

Issue :

EXISTING SITE SERVICES TO BE USED


STORMWATER TO BE CONNECTED TO EXISTING SYSTEM

RL +89,690

Ridge (existing)

RL +85,650 First Floor

RL +81,240 Ground Floor

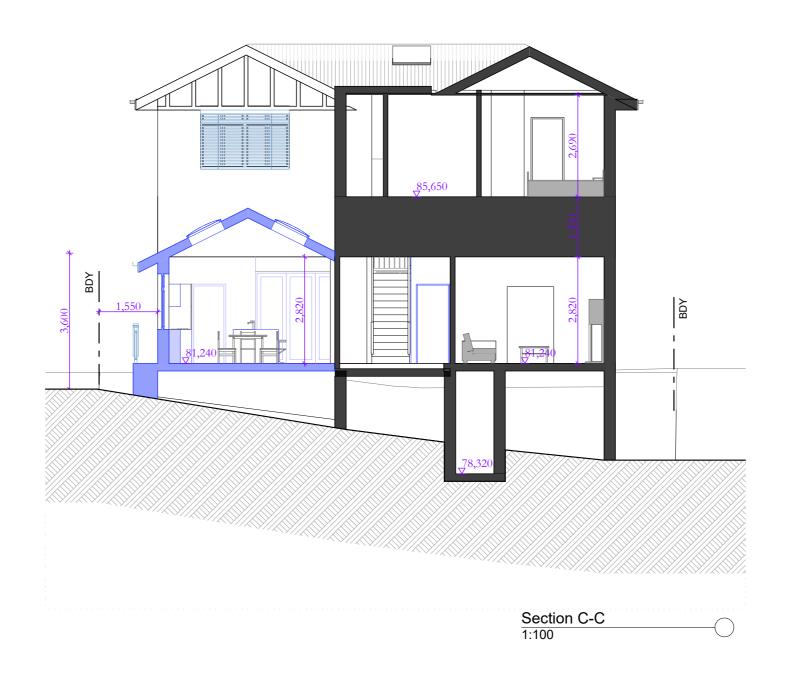

= Proposed Work = Demolition = Existing

Description : Date : Issue :

The builder shall check and verify all dimensions and verify all errors and omissions to the Architect. Do not scale the drawings. Drawings shall not be used for construction purposes until issued by the Architect for construction.



Alterations & Additions

6 Gordon St, Clontarf Lot 142 in DP 9999 - 842.2m2

Private Residence

Drawing: - Sections C-C

Project Number: 2035

Drawn/Designed: TS / PB

Scale : 1:100 @ A3

Date : 011020

Drawing No.: DA14


32.43 m<sup>2</sup>

ALL TIMBER FRAMING AND FOOTINGS TO **ENGINEERS DETAILS** 


**EXISTING SITE** SERVICES TO BE USED

STORMWATER TO BE CONNECTED TO EXISTING SYSTEM

Cabana Floor Area Plan Garage Floor Area Plan 1:200 1:200

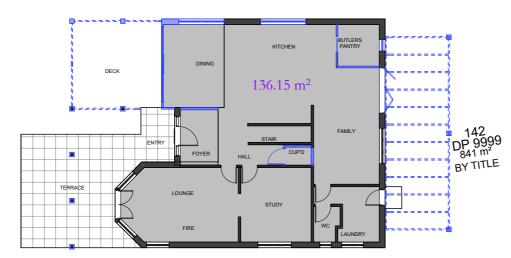

Ground Floor Area Plan

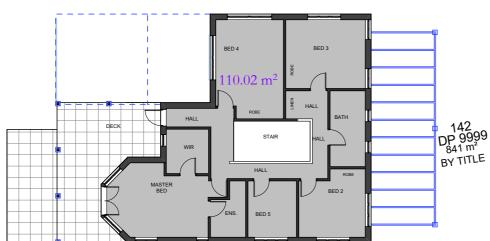

First Floor Area Plan

SITE AREA = 841m<sup>2</sup> FLOOR SPACE RATIO 0.4:1 max FSR  $= 336.4m^2$ CABANA FLOOR AREA  $= 32.43 \text{m}^2$ GARAGE FLOOR AREA  $= 1.34 \text{m}^2$ GROUND FLOOR AREA = 136.15m<sup>2</sup> FIRST FLOOR AREA = 110.02m<sup>2</sup> **TOTAL FLOOR AREA COMPLIES**  $= 279.94m^2$ 

> = Proposed Work = Demolition = Existing


Date :	Issue :	Description :

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Alterations & Additions 6 Gordon St, Clontarf Lot 142 in DP 9999 - 842.2m2

Private Residence




Drawn/Designed: TS / PB
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Project Number: 2035

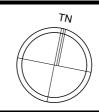**DA15** 


300920 Scale: 1:100 @ A3

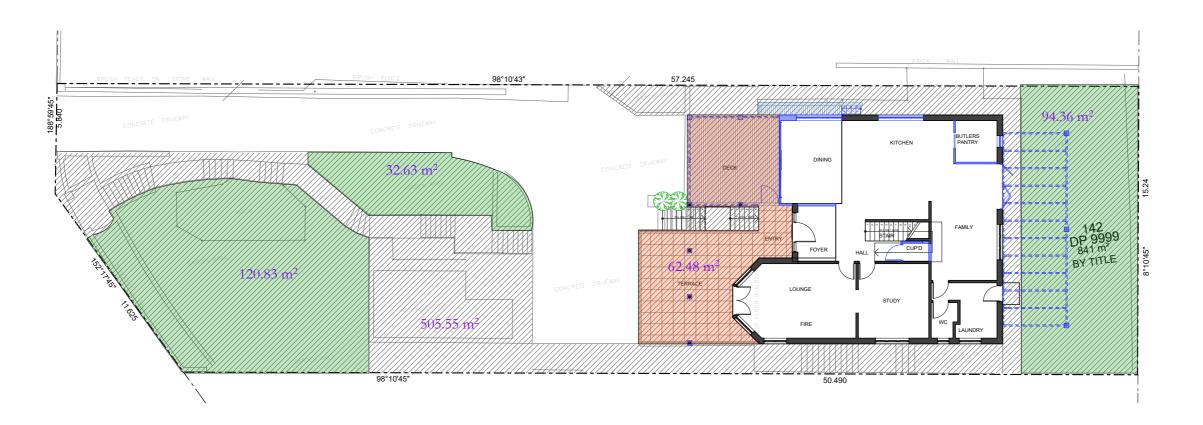


EXISTING SITE SERVICES TO BE USED

STORMWATER TO BE CONNECTED TO EXISTING SYSTEM

Open Space Landscaped Area Proposed Plan 1:200

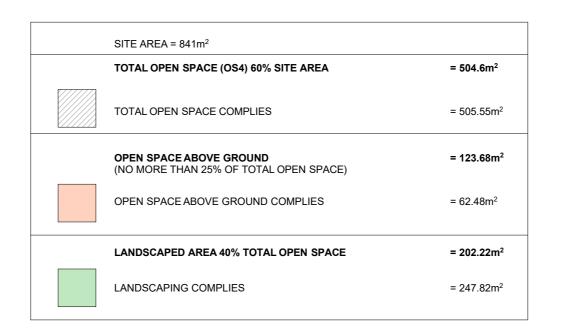

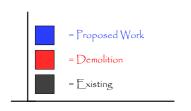

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Alterations & Additions 6 Gordon St, Clontarf

Private Residence

Lot 142 in DP 9999 - 842.2m2 Drawing: - Open Space & Landscaping




Drawn/Designed: TS / PBProject Number: 2035

Scale: 1:100 @ A3 Drawing No.: DA16 | Issue :

Date :

300920

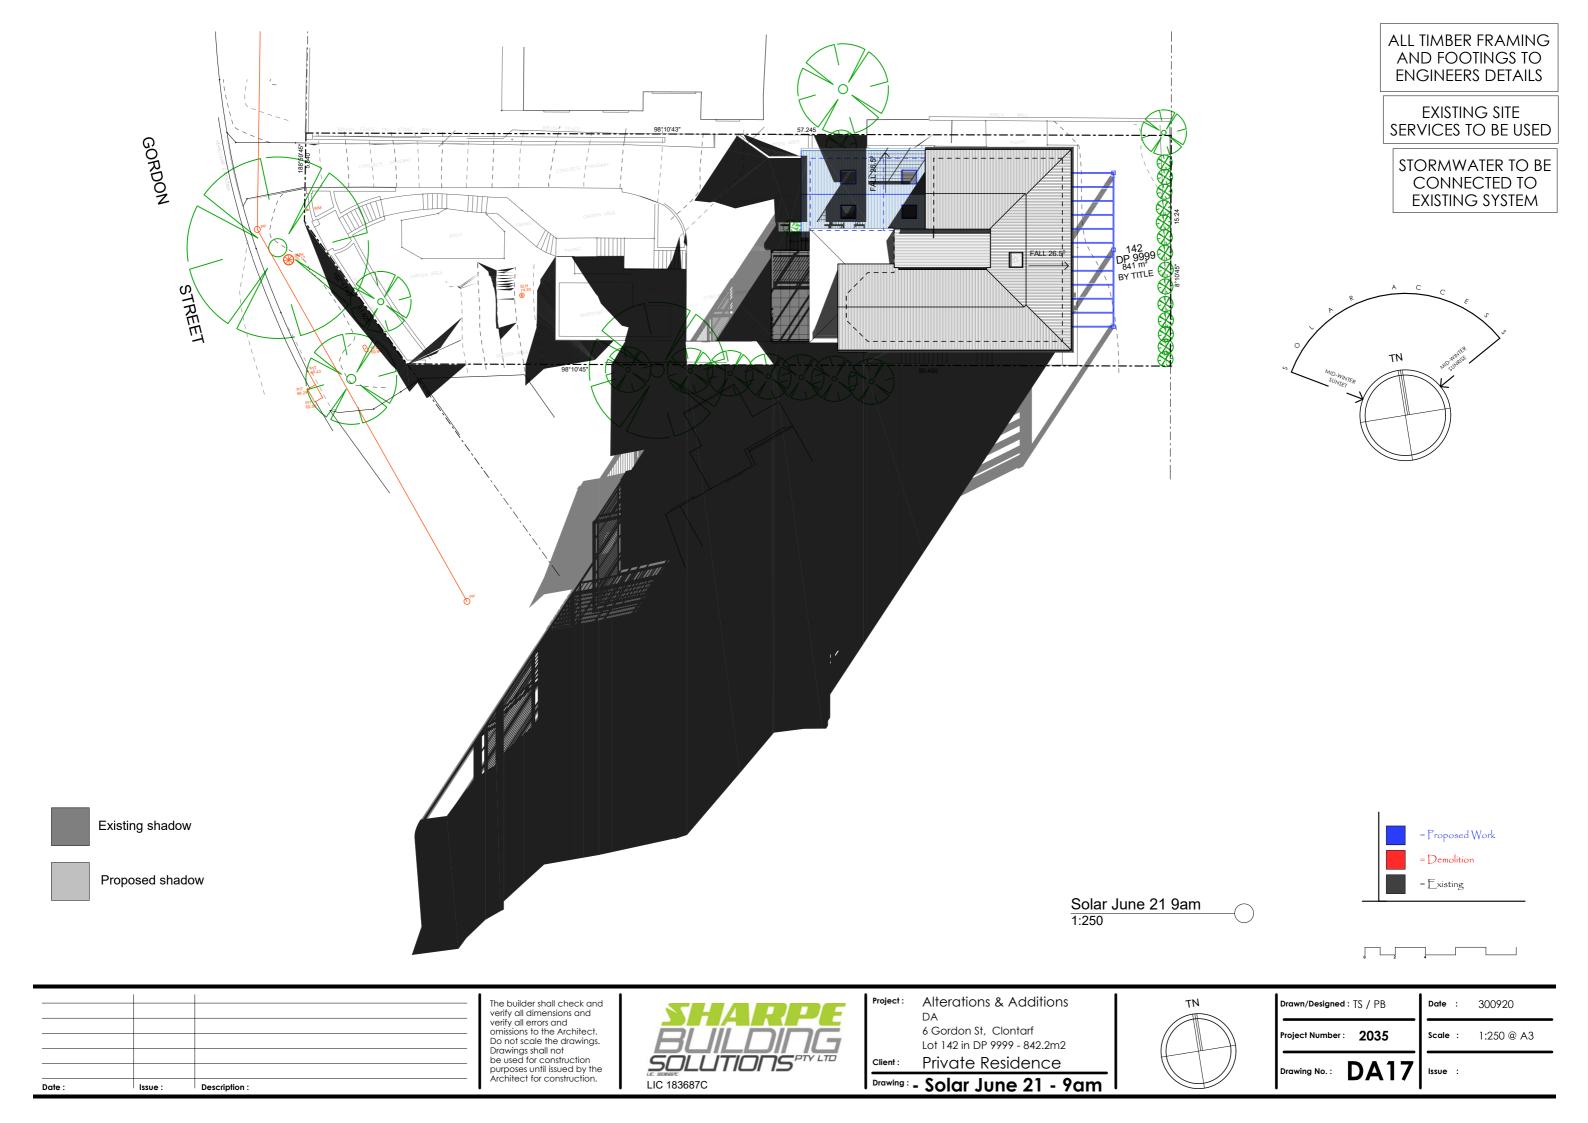


AND FOOTINGS TO ENGINEERS DETAILS EXISTING SITE SERVICES TO BE USED STORMWATER TO BE CONNECTED TO EXISTING SYSTEM GORDON Existing shadow = Proposed Work = Demolition Proposed shadow = Existing Solar June 21 12pm

ALL TIMBER FRAMING


The builder shall check and verify all dimensions and verify all errors and omissions to the Architect. Do not scale the drawings. Drawings shall not be used for construction purposes until issued by the Architect for construction. Alterations & Additions TN Drawn/Designed: TS / PB Date : 300920 6 Gordon St, Clontarf Lot 142 in DP 9999 - 842.2m2 Project Number: 2035 Scale: 1:250 @ A3 Private Residence Drawing No.: DA18 | Issue : Drawing: - Solar June 21 - 12pm LIC 183687C Description : Date: Issue :

1:250

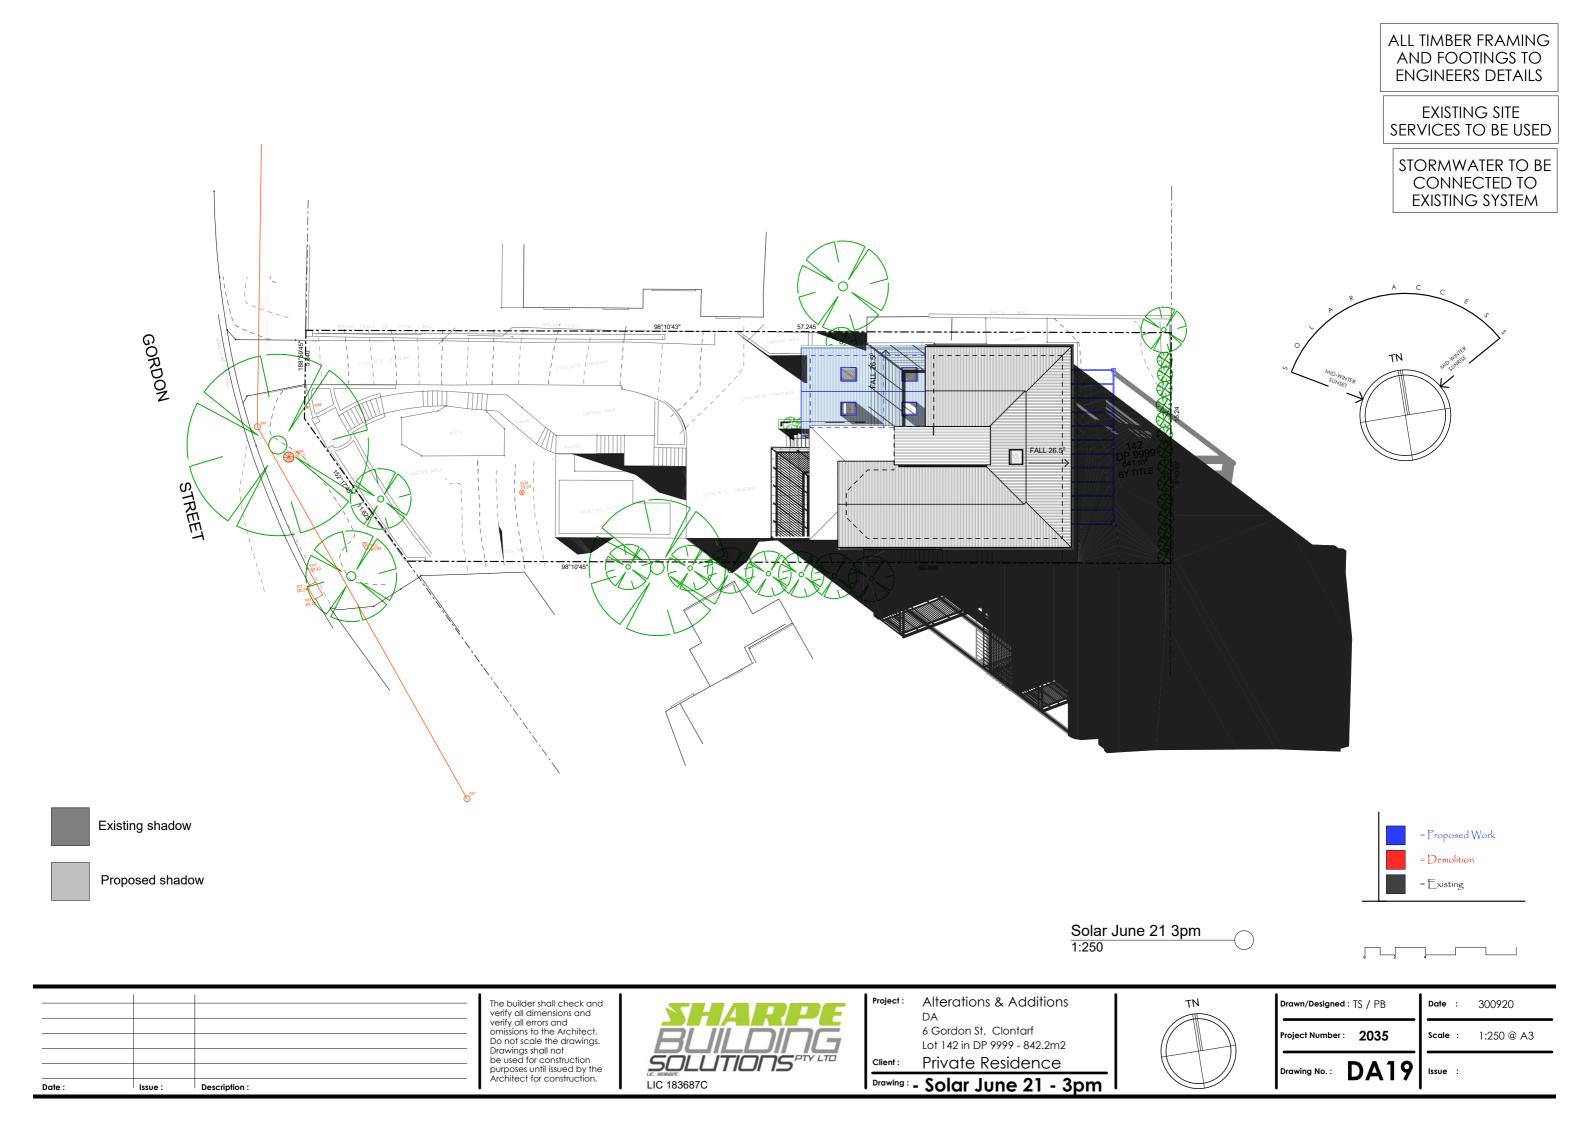

**EXISTING SITE** SERVICES TO BE USED

STORMWATER TO BE CONNECTED TO **EXISTING SYSTEM** 

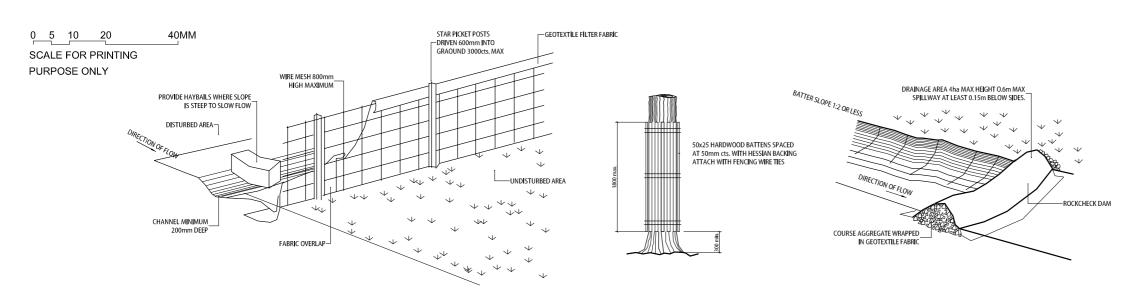

# TYPICAL SEDIMENT FENCE

## Vehicle Movements

TO LIMIT DISTURBANCE TO THE SITE AND TRACKING OF MATERIAL ONTO THE STREET ALL VEHICLES AND PLANT EQUIPMENT ARE TO USE A SINGLE ENTRY/EXIT POINT UNLESS COUMCIL HAS APPROVED ALTERNATIVE ARRANGEMENTS.

ACCESS POINTS AND APRKING AREAS ARE TO BE STABILISED WITH COMPACTED SUB-GRADE AS SOON AS POSSIBLE AFTER THEIR FORMATION.

WHERE SPILLAGE DOES OCCUR IT IS TO BE CONTAINED IMMEDIATELY AND CAREFULLY REMOVED. THE AREA AFFECTED IS TO BE RESTORED TO A STANDARD EQUAL TO OR BETTER THAN ITS PREVIOUS CONDITION.

ALL VEHICLES ARE TO BE WASHED PRIOR TO EXISTING THE SITE.
THIS SERVES THE PURPOSE OF REMOVING SITE MATERIAL ON THE VEHICLE
AND PREVENTS IT FROM BEING DEPOSITED ON THE ROAD NETWORK
ADJACENT TO THE SITE AND THUS, THE STORMATER SYSTEM. ALL POLLUTED
WATER MUST BE RETAINED ON SITE FOOR TREATMENT BEFORE IT IS DISCHARGED

ALL VEHILCES VISITING THE SITE DURING DEMOLITION, EXCAVATION AND/OR CONSTRUCTION WORKS, ARE TO COMPLY WITH THE PARKING REQUIREMENTS IN TAHT AREA.

Sediment Traps WHERE A SEDIMENT FENCE IS NOT USED APPROPRIATE SEDIMENT TRAPS SHOULD BE LOCATED AT ALL POINTS WHERE STORMWATER LEAVES THE CONTSTRUCTION STIE OR LEAVES THE GUTTER AND ENTERS THE DRAIMAGE SYSTEM. A COMMON TECHNIQUE IS THE GRAVEL SAUSAGE.

#### Diversion Channels

A DIVERSION CHANNEL IS AN EXCAVATED EARTH DITCH OR PATH. THESE STRUCTURES AREE USED TO INTERCEPT AND DIRECT RUN-OFF TO A DESIRED LOCATION WHERE POSSIBLE.

ALL STORMWATER RUN-OFF FLOWING ONTO DISTURBED AREAS, INCLUDING STOCKPILES, MUST BE INTERCEPTED, DIVERTED AND/OR SAFELY DISPOSED OF. THIS CAN BE ACHIVED BY CONSTRUCTING A TEMPORARY EARTH BANK AROUND THE UPSLOPE EXTENT OF THE CONSTRUCTION SITE WHERE THE DIVERSION DOES NOT AFFECT THE NEIGHBOURING PROPERTIES.

# TYPICAL TREE PROTECTION

# Erosion & Sediment Controls

APPROPRIATE EROSION AND SEDIMENT CONTROLS MUST BE IMPLEMENTED ON ALL SITES THAT INVOLVE SOIL DISTURBANCE. THE MEASURES MUST BE IN PLACE PRIOR TO THE COMMENCEMENT OF WORK.

THOSE CONTROLS ARE TO BE MONITORED AND MAINTAINED IN ORDER TO SERVE THEIR INTENDED FUNCTION FOR THE DURATION OF THW WORKS OR UNITS JUST THEM AS THE SITE S FLULY STRAILISED. FRAY CONTROLS ARE DAMAGED OR BECOME INEFFECTIVE DURING THE COURSE OF THE WORKS THEY ARE TO BE BERNISTATE OR BEPLACED BAMEDIATELY, SUFFICIENT ACCESS TO THESE CONTROLS MUST BE PROVIDED IN CASE OF THE NEED TO REPORTE

# TYPICAL DIVERSION CHANNEL

# Dust Control

ALL TRUCKS/UTES MUST COVER THEIR LOADS AT ALL TIMES.

APPROPRIATE METHODS ARE TO BE EMPLOYED TO PREVENT BLOWING DUST CREATING AN UNACCEPTABLE HAZARD OR NUISANCE ON THE SITE OR DOWN WIND. PRODUCTION OF DUST CAN BE MINIMISED BY LINITING AREA OF EARTHWORKS, WATERING AND PROGRESSIVE VEGETATION.

WHERE DUST IS CREATED AS A RESULT WORKS AND/OR SOIL EXPOSURE, THE BARE SOIL AREAS MUST BE WATERED, DURING AND/OR AT THE END OF EACH DAY TO LAY THE DUST.

EARTH MOVONG ACTIVITIES SHOULD BE AVOIDED WHERE WINDS ARE SUFFICIENTLY STRONG ENOUGH TO RAISE VISIBLE DUST.

# Designated Site Manager/Builder

PERIOR TO COMMENCEMENT OF WORK A SITE MANAGER OR BUILDER MUST BE NOMINATED. THE SITE MANAGER OR BUILDER WILL BE RESPONSIBLE AND LABEL FOR ALL WORKS CARRED DUT ON THE SITE THIS ASSUMES THE RESONSIBLUTY FOR THE ACTIONS OF ALL SUBCONTRACTED PARTIES AS WILL AS ADVISING THEM OF COUNCIL'S REQUIREMENTS WHEN CARRYING OUT WORKS.

# Topsoil Management

PRIOR TO THE STRIPPING OF TOPSOIL, THE VEGETATIVE COVER MUST BE REDUECED BY EITHER SLASHING OR MOWING.

ALL TOPSOIL IS TO BE RETAINED AND PROTECTED FOR REUSE ON SITE

SOIL STOCKPILES MUST NOT BE LOCATED ON NATURE STRIPS, FOOTPATHS, ROADWAYS, KERBS, ACCESSWAYS, WITHIN DRAINAGE LINES/FLOWS/PATHS OR AROUND OR AGAINST TREE SHRIBS. SEDIMENT CORTROL MEASURES MUST BE INCORPORATED WITH ANY RESULTING STOCKPILE. THE STOCKPILE CAN BE PROTECTED FROM BROSION BY COVERING IT WITH AN INPERVIOUS MATERIAL, IN CONJUNCTION WITH THE INSTALLATION OF A SEDIMENT FENCE AROUND IT.

IF STOCKPILES ARE TO REMAIN FOR MORE THAN ONE MONTH THEY ARE TO BE GRASSED IMMEDIATELY AND STABILISED WITHIN FOURTEEN DAYS. SURPLUS TOPSOIL MUST BE REASONABLY REMOVED FROM SITE.

#### Builidng Material Stockpiling

OF BUILDING MATERIALS, DEMOLITION WASTE, WASTE CONTAINERS, ETC.
AS WILL BE REQUIRED.

#### Sediment Fences

A SEDIMENT FENCE SHOULD BE LOCATED ALONG THE DOWNSLOPE BOUNDARY/SJOP THE SITE, ON THE CONSTRUCTION SIDE OF THE TURF FILTER STIP OF NATIVE VEGETATION, AND AROUND ALL STOCKPILES OF MATERIAL ON THE SITE.

Description : Date:

The builder shall check and verify all dimensions and verify all errors and omissions to the Architect. Do not scale the drawings. Drawings shall not be used for construction purposes until issued by the Architect for construction.



Alterations & Additions

6 Gordon St, Clontarf Lot 142 in DP 9999 - 842.2m2

Private Residence

Drawing: - Sediment & Erosion Control Plan

Drawn/Designed: TS / PB

Project Number: 2035

**DA20** 

Date :

300920

**Scale**: 1:200 @ A3

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Building Sustainability Index www.basix.nsw.gov.au

## Alterations and Additions

Certificate number: A391358\_03

This certificate confirms that the proposed development will meet the NSW government's requirements for sustainability, if it is built in accordance with the commitments set out below. Terms used in this certificate, or in the commitments, have the meaning given by the document entitled "BASIX Alterations and Additions Definitions" dated 06/10/2017 published by the Department. This document is available at www.basix.nsw.gov.au

Secretary
Date of issue: Thursday, 24, September 2020
To be valid, this certificate must be lodged within 3 months of the date of issue.



6 Gordon St DA_03		
6 Gordon Street Clontarf 2093		
Northern Beaches Council		
Deposited Plan 9999		
142		
Separate dwelling house		
My renovation work is valued at \$50,000 or more, and does not include a pool (and/or spa).		

Fixtures and systems	Show on DA Plans	Show on CC/CDC Plans & specs	Certifier Check
Lighting			
The applicant must ensure a minimum of 40% of new or altered light fixtures are fitted with fluorescent, compact fluorescent, or light-emitting-diode (LED) lamps.		~	~
Fixtures			
The applicant must ensure new or altered showerheads have a flow rate no greater than 9 litres per minute or a 3 star water rating.		✓	~
The applicant must ensure new or altered toilets have a flow rate no greater than 4 litres per average flush or a minimum 3 star water rating.		✓	<b>✓</b>
The applicant must ensure new or altered taps have a flow rate no greater than 9 litres per minute or minimum 3 star water rating.		<b>✓</b>	

Construction			Show on DA Plans	Show on CC/CDC Plans & specs	Certifier Check
Insulation requirements					•
	d construction (floor(s), walls, and ceilings/roofs) tion is not required where the area of new const where insulation already exists.  Additional insulation required (R-value)		<b>~</b>	<b>~</b>	<b>~</b>
suspended floor with enclosed subfloor: framed (R0.7).	R0.60 (down) (or R1.30 including construction)	Onto specifications			
external wall: framed (weatherboard, fibro, metal clad)	R1.30 (or R1.70 including construction)				
raked ceiling, pitched/skillion roof: framed	ceiling: R2.24 (up), roof: foil backed blanket (55 mm)	medium (solar absorptance 0.475 - 0.70)			

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Alterations & Additions

6 Gordon St, Clontarf Lot 142 in DP 9999 - 842.2m2

Private Residence

Drawing: - BASIX

	omomo						DA Plans	CC/CDC Plans & specs	Check
Windows and	glazed do	ors							•
					ading devices, in accordance with each window and glazed door.	the specifications listed in the table below.	<b>~</b>	<b>~</b>	<b>~</b>
The following red	quirements r	must also	be satisfie	ed in relation	to each window and glazed door:			✓	✓
have a U-value a	ind a Solar I	Heat Gair	Coefficie	nt (SHGC) n		ed glass may either match the description, or, ole below. Total system U-values and SHGCs s.		<b>✓</b>	<b>✓</b>
have a U-value a must be calculate	ind a Solar I ed in accord	Heat Gair Iance with	Coefficie National	nt (SHGC) n Fenestration	o greater than that listed in the tab	ear glazing, or toned/air gap/clear glazing must ele below. Total system U-values and SHGCs s. The description is provided for information		~	<b>✓</b>
					each eave, pergola, verandah, ba han 2400 mm above the sill.	lcony or awning must be no more than 500 mm	<b>~</b>	✓	<b>✓</b>
For projections described as a ratio, the ratio of the projection from the wall to the height above the window or glazed door sill must be at least that shown in the table below.					✓	✓	✓		
Pergolas with po	lycarbonate	roof or si	milar tran	slucent mate	rial must have a shading coefficier	nt of less than 0.35.		✓	<b>~</b>
					window or glazed door above whens must not be more than 50 mm.	ich they are situated, unless the pergola also		✓	<b>✓</b>
Overshadowing I specified in the 'c					t and distance from the centre and	the base of the window and glazed door, as	✓	✓	<b>✓</b>
Windows and			azing re	equiremer	nts				
Window / door no.	Orientation		Oversha		Shading device	Frame and glass type			
no.		glass inc. frame (m2)	Height (m)	Distance (m)					
W1	W	9.6	0	0	eave/verandah/pergola/balcony >=900 mm	timber or uPVC, single clear, (or U-value: 5.71, SHGC: 0.66)			
									0 111
Glazing requir	ements						Show on DA Plans	Show on CC/CDC	Certifier Check

Glazing requ	irements						DA Plans	CC/CDC Plans & specs	Check
Window / door	Orientation	Area of	Oversha	dowing	Shading device	Frame and glass type			
no.		glass inc. frame (m2)	Height (m)	Distance (m)					
W1A	W	1.3	0	0	eave/verandah/pergola/balcony >=900 mm	timber or uPVC, single clear, (or U-value: 5.71, SHGC: 0.66)			
W1B	W	1.3	0	0	eave/verandah/pergola/balcony >=900 mm	timber or uPVC, single clear, (or U-value: 5.71, SHGC: 0.66)			
W2	N	3.5	0	0	eave/verandah/pergola/balcony >=600 mm	timber or uPVC, single clear, (or U-value: 5.71, SHGC: 0.66)			
W3	N	1.4	3	2.5	none	timber or uPVC, single pyrolytic low-e, (U-value: 3.99, SHGC: 0.4)			
W4	W	0.8	0	0	none	timber or uPVC, single clear, (or U-value: 5.71, SHGC: 0.66)			
W5	W	5.8	5	6.8	projection/height above sill ratio >=0.23	timber or uPVC, single pyrolytic low-e, (U-value: 3.99, SHGC: 0.4)			

In these commitments, "applicant" means the person carrying out the development.

Commitments identified with a "v" in the "Show on DA plans" column must be shown on the plans accompanying the development application for the proposed development (if a development application is to be lodged for the proposed development).

Commitments identified with a "\sqrt{"} in the "Show on CC/CDC plans & specs" column must be shown in the plans and specifications accompanying the application for a construction

Commitments identified with a "\" in the "Certifier check" column must be certified by a certifying authority as having been fulfilled, before a final occupation certificate for the development may be issued.

Drawn/Designed: TS / PBDate : 300920 Project Number: 2035 Scale : Drawing No.: DA21 Issue :