

m: 0426 957 518 e: operations@actionplans.com.au w: www.actionplans.com.au

PLANS PUBLISHED 22 September 2025

# **DEVELOPMENT APPLICATION**

These plans are for Council Approval only.

NO.	DRAWING NAME
DA00	COVER
DA01	NOTATION
DA02	SAFTEY NOTES
DA03	SITE ANALYSIS / DEMOLITION PLAN
DA04	SUBDIVISION PLAN
DA05	SITE / ROOF / SEDIMENT EROSION / WASTE MANAGEMENT
DA06	PROPOSED LOWER GROUND FLOOR PLAN
DA07	PROPOSED GROUND FLOOR PLAN
DA08	PROPOSED FIRST FLOOR PLAN
DA09	WEST / NORTH ELEVATION
DA10	EAST / SOUTH ELEVATION
DA11	WEST FRONT FENCE ELEVATION & POOL SECTIONS
DA12	LONG / CROSS SECTION
DA13	SAMPLE BOARD
DA14	AREA CALCULATIONS
DA15	WINTER SOLSTICE 9 AM
DA16	WINTER SOLSTICE 12 PM
DA17	WINTER SOLSTICE 3 PM
DA18	DRIVEWAY PLAN & LONG SECTION
DA19	CUT AND FILL PLAN
DA20	WINDOW & DOOR SCHEDULE - NORTH LOT
DA21	WINDOW & DOOR SCHEDULE - SOUTH LOT
DA22	BASIX COMMITMENTS

# 23 Loch Street, Freshwater NSW 2096



ITEM DETAILS	DEVELOPMENT APPLICATION				
ADDRESS	25 LOCH STREET, FRESHWATER NSW 2096				
COUNCIL	NORTHERN BEACHS COUNCIL (WARRINGAH)				
SITE AREA	500.3m <sup>2</sup>				
FRONTAGE	12.59m				
CONTROLS	PERMISSIBLE / REQUIRED	PROPOSED	COMPLIANCE		
CONTROLS	m / m² / %	m / m² / %			
<u>LEP</u>					
LAND ZONING	R2 – LOW DENSITY RESIDENTIAL	R2			
MINIMUM LOT SIZE	450m²	500.3m <sup>2</sup>	N/A		
FLOOR SPACE RATIO	NOT IDENTIFIED	N/A	N/A		
MAXIMUM BUILDING HEIGHT	8.5m	8.4m	YES		
<u>HAZARDS</u>					
DEVELOPMENT ON SLOPING	AREA B - FLANKING SLOPES FROM 5	N/A	N/A		
LAND	TO 25 DEGREES	N/A	N/A		
NATIVE VEGETATION	IDENTIFIED	N/A	N/A		
DCP					
WALL HEIGHT	7.2m	8.45m	NO		
NUMBER OF STOREYS	2	3	NO		
SIDE BOUNDARY ENVELOPE	5m	COMPLIANT	YES		
SIDE BOUNDARY SETBACKS	3.5m AVERAGED BETWEEN LOTS,	N: 2.5m	YES		
	MINIMUM 1m	S: 2m	TES		
FRONT BOUNDARY SETBACK	6.5m	6.5m	YES		
REAR BOUNDARY SETBACK	6.0m	10.127m	YES		
LANDSCAPE OPEN SPACE	40% (200.12²)	200.75m²	YES		
DEEP SOIL PLANTING	25% (125.075m²)	133.95m²	YES		
PRIVATE OPEN SPACE	120m² (60m² PER DWELLING)	123.63m²	YES		



#### IMPORTANT NOTATION FOR BUILDERS

- All dimensions are to be confirmed on-site by the builder/subcontractor, any incongruencies must be reported to the Designer in writing before the commencement of any work.
- No Survey has been made on the boundaries. All bearings, distances, and areas have been taken from the contour survey plan. A Survey must be carried out to confirm the exact boundary locations.
- No construction work shall commence until a site survey confirming the site boundaries has been completed. The
  contractor is to ensure that the approved boundary setbacks are confirmed and used, the boundary setbacks take
  precedence over all other dimensions. The Survey work must be performed by a registered Surveyor.
   In the event of encountering any discrepancies on these drawings, specification, or subsequent instructions issued,
- the Builder/Subcontractor shall contact the designer in writing before proceeding further with any work.

  The builder/subcontractor is responsible to ensure that all materials installed on-site are fit for purpose and comply with
- The builder/subcontractor is responsible to ensure that all materials installed on-site are fit for purpose and comply with the NCC and relevant Australian Standards. The builder is to obtain written confirmation of material selection by the Client prior to ordering.
- All construction, control joints, and expansion joints in the walls, floors, and other locations shall be in strict accordance with the structural engineering details. No joints or breaks other than specified are allowed without written permission from the Engineer.
- Measurements for the fabrication of secondary components such as windows, doors, internal frames, structural steel components, and the like, are not to be taken from these documents. Measurements must be taken on-site to suit the work as constructed
- All structural components shall be in strict accordance with details and specifications as prepared by a suitably qualified structural engineer.
- All existing structures need to be examined for structural adequacy, and it is the Contractor's responsibility to ensure that a certificate of structural adequacy is available prior to the start of any work.

#### **SPECIFICATION**

- "Approval" obtained by either an 'Accredited Certifying Authority' or 'Local Council'.
- The Owner will directly pay all fees associated with the following:
- Building approval from council or accredited certifier, any footpath and kerb deposits with the local council, insurance fees to Building Services Corporation, Long Service Leave levy fees and approval fees by water and sewerage authority. All other fees are to be paid by the builder. The amount of any local authority deposits which are forfeited due to damage or other causes, will be deducted from payments due to the builder.
- -The Builder is to provide at his/her own expense adequate Public Risk Insurance and arrange indemnification under the Workers Compensation Act. Works insurance to be as stated in the contract conditions.
- All tenderers are to visit the site to satisfy themselves as to the nature and extent of the Works, facilities available and difficulties entailed in the works as Variations will not be allowed due to work arising owing to neglect of this clause.
- These drawings shall be read in conjunction with all structural and other consultant's drawings and specifications and with any such written instructions as may be issued during the course of the contract.
- Set out dimensions shown on this drawing shall be verified by the builder on site before commencement of any work.
- Dimensions shall not be obtained by scaling the drawings, use figured dimensions. All dimensions are in millimetres.

  The Builder is to ensure all construction, levels and other items comply with the conditions of the Building Approval.

  Any detailing additional to that which is supplied shall be resolved between the Owner and the Builder to the Owner.
- Any detailing additional to that which is supplied shall be resolved between the Owner and the Builder, to the Owner's approval. Except for any structural details or design, which is to be supplied by the Engineer.
   All work to be carried out in a tradesman like manner and in accordance with the standards, codes and regulations of
- Standards Australia, the National Construction Code and any statutory authority having jurisdiction over the works.

   All structural work is to be in accordance with the structural details prepared by a suitably qualified structural engineer, including but not limited to all piers, footings, concrete slabs, retaining walls, steelworks, formwork, underpinning, additional structural loads, timber framing, wind bracing and associated connections. Builder to obtain prior to finalising the tender, unless previously obtained by owners.
- All brickwork is to be selected by the Owner, and is to comply with AS 1640.
- All masonry is to comply with AS 3700.

is more than 4m

- Provide all metalwork and flashings necessary to satisfactorily complete the works.
- All timber construction to be in accordance with AS 1684 Residential timber-framed construction. Level and grade where necessary under timber floors to provide a minimum clearance of 300mm under bearers or 400mm under joists. Adequate precautions shall be taken to ensure that the surface and/or seepage water does not collect or remain under floor area.
- Sustainable timbers, and not rainforest or old growth timber will be used. Recycled timber or second hand timbers are to be sourced and used in preference to plantation timbers, if available and suitable.
- All glazing installation is to comply with AS 1288, AS 2047 and in accordance with manufacturers recommendations.
   All wall and ceiling linings in wet areas to be plasterboard and villaboard, or equal. A breathable wall wrap is to be provided to all external walls. Timber cladding is to be battened out from timber frame to provide an 'air' gap to prevent condensation. Workmanship is to comply with the relevant Australian Standards or installed in accordance with manufacturer's specifications. All bathrooms and wet areas to be waterproofed with a flexible membrane to manufacturer's specifications and to AS 3740, Part H4D2 and Section 10; Part 10.2 of the 2022 NCC.
- All Architraves and skirtings to the profile as selected by owner, and painted or stain finish as selected
- All plumbing and drainage work to be installed and completed by a licensed tradesman and in accordance with the statutory body having authority over the works. Connect all waste to Sydney Water sewer line.
- Connect all stormwater to existing system or street drainage system in accordance with AS 3500, Part H2D2 and Section 3: Part 3.3 of the 2022 NCC.
- Smoke detector alarms are to be installed in accordance with AS 3786, Part H3D6 and Section 9; Part 9.5 of the 2022 NCC.
- If a member which provides structural support to the works is subject to termite attack, management measures are to comply with AS 3660 and Section 3; Part 3.4 of the 2022 NCC. Termite management system to be installed to manufacturer's specifications.
- Stairs and Balustrades to comply with Part H5D2, H5D3 and Section 11; Part 11.2 and 11.3 of the 2022 NCC. Provide a handrail along the full length of the flight and a slip resistant finish to the edge of the nosings to comply with 3.9.1 and 3.9.2 of the NCC. No horizontal elements to facilitate climbing between 150mm and 760mm where floor to level below
- Electrical works to be in accordance with SAA wiring rules and be done by a licenced tradesperson. Obtain electrical layout prior to proceeding. All electrical power (GPO's) and light outlets to be determined by the Owner.
- Painting: All paints or other coatings shall be of the best quality materials & of approved manufacture. All priming materials shall be of an approved brand acceptable to the manufacturer of the finishing coats to be used. External joinery intended to be painted shall be primed on all faces at the place of assembly. Where new work or alteration work adjoins existing painted surfaces allow for repainting existing surfaces to provide uniform appearance.
- ZERO-VOC or LOW-VOC paints and primers only are to be used.
- Any work indicated on the plans but not specified and any item not shown on the plans which is obviously necessary as part of proper construction and/or finish, is to be considered as shown and specified and is to be undertaken as part of the contract. Variations will not be permitted without prior written approval by the owners.
- The Builder shall provide sediment and siltration control measures as required by Council, and maintain them
  throughout the duration of the works.
   A legible copy of the plans bearing approval stamps, must be maintained on the job site at all times. Hours of
- A legible copy of the plans bearing approval stamps, must be maintained on the job site at all times. Hours of construction shall be restricted to the times as required by the building approval.
- The Builder is to arrange for all inspections required by the relevant authorities and/or lending institutions, to their requirements.

- The Builder is to obtain approval for interruptions to existing services and minimise the duration and number of interruptions. Any interruptions to existing services and equipment is to be undertaken by appropriately qualified tradespersons.
- The Builder shall restore, reinstate or replace any damage to existing structures or landscaping caused by the
- Provide protection to existing trees to remain, or as required by the Approval Conditions.

#### **GENERAL NOTATION**

- Approved means by the 'relevant local authority' or council?
- All work and materials to comply with the current Australian standards at the time of commencement, where applicable.
- The builder is to comply with all ordinances, local authority regulations and the requirements of all services supply authorities having jurisdiction over the works.
- All new downpipes are to be connected to the existing stormwater system.
- All timber sizes and concrete details to be confirmed by the builder prior to commencement of any work
- All gutters, downpipes to be colorbond.
- All wall and ceiling linings to be plasterboard or cement render as selected, and villa board in wet areas. To comply with relevant Australian standards, and installed in accordance with manufacturers specification.

## NCC 2022 & AS COMPLIANCES SPECIFICATIONS

- Structure Part H1 & Section 2 of NCC
- Structural Provisions PART H1D2 & PART 2.2 of NCC
- Site Preparation Part H1D3 & Section 3 of NCC
- Earthworks Part 3.2 of NCC
- Drainage Part 3.3 of NCC
- Termite Risk Management Part 3.4 of NCC
- Footings & Slabs Part H1D4 & Section 4 of NCC
- Footings, Slabs & Associated Elements Part 4.2 of NCC
- Masonry Part H1D5 & Section 5 of NCC
- Masonry Veneer Part 5.2 of NCC
- Cavity Masonry Part 5.3 of NCC
   Unreinforced Single Leaf Masonry Part 5.4 of NCC
- Isolated Piers Part 5.5 of NCC
- Masonry Components & Accessories Part 5.6 of NCC
- Waetherproofing of Masonry Part 5.7 of NCC
- Framing Part H1D6 & Section 6 of NCC
- Sub Floor Ventilation Part 6.2 of NCC
- Structural Steel Members Part 6.3 of NCC
- Roof & Wall Cladding Part H1D7 & Section 7 of NCC
- Sheet Roofing Part 7.2 of NCC
- Roof Tiles & Shingles Part 7.3 of NCC
- Gutters & Downpipes Part 7.4 of NCC
- Timber & Composite Wall Cladding Part 7.5 of NCC
- Glazing Part H1D8 & Section 8 of NCC
- Windows & External Glazed Doors Part 8.2 of NCC
- Glass Part 8.3 of NCC
- Glazing Human Impact Part 8.4 of NCC
- Damp & Weatherproofing Part H2 of NCC
- Fire Safety Part H3 & Section 9 of NCC
- Fire Separation of External Walls Part 9.2 of NCC
- Fire Protection of Separating Walls & Floors Part 9.3 of NCC
- Fire Protection of Garage Top Dwellings Part 9.4 of NCC
   Smoke Alarms & Evacuation Lighting Part 9.5 of NCC
- Smoke Alaims & Evacuation Lighting Part 9.5 or No
- Health & Amenity Part H4 & Section 10 of NCC Wet Area Waterproofing Part 10.2 of NCC
- Room Heights Part 10.3 of NCC
- Facilities Part 10.4 of NCC
- Light Part 10.5 of NCC
- Ventilation Part 10.6 of NCC
- Sound Insulation Part 10.7 of NCC
- Condensation Management Part 10.8 of NCC
- Safe Movement & Access Part H5 & Section 11 of NCC
- Stairway & Ramp Construction Part 11.2 of NCC
- Barriers & Handrails Part 11.3 of NCC
- Ancillary Provisions Part H7 & Section 12 of NCC
- Construction in Alpine Areas Part 12.2 of NCC
- Attachment of Framed Decks & Balconies to External Walls of Buildings Using a Waling Plate Part 12.3 of NCC
- Attachment of Framed Decks & Balconies to External Walls of Building Heating Appliances, Fireplaces, Chimneys & Flues Part 12.4 of NCC
- Swimming Pools Part H7P1 & NSW H7D2 of NCC
- Construction in Bushfire Prone Areas Part NSW H7D4 of NCC Energy Efficiency Part H6 & Section 13 of NCC
- Energy Efficiency Part Ho & Section - Building Fabric - Part 13.2 of NCC
- External Glazing Part 13.3 of NCC
- Building Sealing Part 13.4 of NCC - Ceiling Fans - Part 13.5 of NCC
- Whole of Home Energy Usage Part 13.6 of NCC
- Services Part 13.7 of NCC



- Pool Fencing & other provisions - Regulations, & AS 1926

- Demolition Works to comply with AS 2601-2001 The Demolition of Structures.

- Waterproofing of Wet Areas to comply with AS 3740:2021

- All plumbing & drainage work to comply with AS 3500:2021

- All plasterboard work to comply with AS 2588:2018

- All structural steel work to comply with AS 4100:2020 & AS 1554.1:2014

- All concrete work to comply with AS 3600:2018

- All roof sheeting work to comply with AS 1562.1:2018
- All skylights to comply with AS 4285:2019

- All ceramic tiling to comply with AS 3958.1-2007 & 3958.2-1992 - All glazing assemblies to comply with AS 2047-2014 & AS 1288:2021

- All construction in bushfire-prone areas to comply with AS 3959:2018

- All timber retaining walls to comply with AS 1720, AS 1170

- All retaining walls to comply with AS 3700:2018 & AS 3600:2018

THIS SET OF DRAWING SHOULD BE READ & KEPT IN ITS ENTIRETY. NO INDIVIDUAL PAGE SHOULD BE SEPARATED FROM THE REST OF THE SET. EACH NOTATION LISTED ON THIS PAGE APPLY TO ALL PAGES OF THIS SET.

#### SAFTEY NOTES

THESE NOTES MUST BE READ AND UNDERSTOOD BY ALL INVOLVED IN THE PROJECT. THIS INCLUDES (but is not excluded to): OWNER, BUILDER, SUB-CONTRACTORS, CONSULTANTS, RENOVATORS, OPERATORS, MAINTENORS, DEMOLISHERS.

#### 1. FALLS, SLIPS, TRIPS

#### a) WORKING AT HEIGHTS

#### **DURING CONSTRUCTION**

Wherever possible, components for this building should be prefabricated off-site or at ground level to minimise the risk of workers falling more than two metres. However, construction of this building will require workers to be working at heights where a fall in excess of two metres is possible and injury is likely to result from such a fall. The builder should provide a suitable barrier wherever a person is required to work in a situation where falling more than two metres is a nossibility

#### DURING OPERATION OR MAINTENANCE

For houses or other low-rise buildings where scaffolding is appropriate: Cleaning and maintenance of windows, walls, roof or other components of this building will require persons to be situated where a fall from a height in excess of two metres is possible. Where this type of activity is required, scaffolding, ladders or trestles should be used in accordance with relevant codes of practice, regulations or legislation. For buildings where scaffold, ladders, trestles are not appropriate: Cleaning and maintenance of windows, walls, roof or other components of this building will require persons to be situated where a fall from a height in excess of two metres is possible. Where this type of activity is required, scaffolding, fall barriers or Personal Protective Equipment (PPE) should be used in accordance with relevant codes of practice, regulations or legislation.

#### b) SLIPPERY OR UNEVEN SURFACES

#### FLOOR FINISHES Specified

If finishes have been specified by designer, these have been selected to minimise the risk of floors and paved areas becoming slippery when wet or when walked on with wet shoes/ feet. Any changes to the specified finish should be made in consultation with the designer or, if this is not practical, surfaces with an equivalent or better slip resistance should be chosen.

#### FLOOR FINISHES By Owner

If designer has not been involved in the selection of surface finishes, the owner is responsible for the selection of surface finishes in the pedestrian trafficable areas of this building. Surfaces should be selected in accordance with AS HB 197:1999 and AS/ NZ 4586:2004.

#### STEPS, LOOSE OBJECTS AND UNEVEN SURFACES

Due to design restrictions for this building, steps and/ or ramps are included in the building which may be a hazard to workers carrying objects or otherwise occupied. Steps should be clearly marked with both visual and tactile warning during construction, maintenance, demolition and at all times when the building operates as a workplace. Building owners and occupiers should monitor the pedestrian access ways and in particular access to areas where maintenance is routinely carried out to ensure that surfaces have not moved or cracked so that they become uneven and present a trip hazard. Spills, loose material, stray objects or any other matter that may cause a slip or trip hazard should be cleaned or removed from access ways. Contractors should be required to maintain a tidy work site during construction, maintenance or demolition to reduce the risk of trips and falls in the workplace. Materials for construction or maintenance should be stored in designated areas away from access ways and work areas.

#### 2. FALLING OBJECTS

#### LOOSE MATERIALS OR SMALL OBJECTS

Construction, maintenance or demolition work on or around this building is likely to involve persons working above ground level or above floor levels. Where this occurs one or more of the following measures should be token to ovoid objects falling from the area where the work is being carried out onto persons below.

- 1. Prevent or restrict access to areas below where the work is
- being carried out.
- 2. Provide toeboards to scaffolding or work platforms.
- 3. Provide protective structure below the work area.
- 4. Ensure that all persons below the work area have Personal

Protective Equipment (PPE).

### BUILDING COMPONENTS

During construction, renovation or demolition of this building, parts of the structure including fabricated steelwork, heavy panels and many other components will remain standing prior to or after supporting parts are in place. Contractors should ensure that temporary bracing or other required support is in place at all times when collapse which may injure persons in the area is a possibility. Mechanical lifting of materials and components during construction, maintenance or demolition presents a risk of falling objects. Contractors should ensure that appropriate lifting devices are used, that loads are properly secured and that access to areas below the load is prevented or restricted.

#### 3. TRAFFIC MANAGEMENT

For building on a major road, narrow road or steeply sloping road: Parking of vehicles or loading/ unloading of vehicles on this roadway may cause a traffic hazard. During construction, maintenance or demolition of this building designated parking for workers and loading areas should be provided. Trained traffic management personnel should be responsible for the supervision of these areas. For building where on-site loading/ unloading is restricted: Construction of this building will require loading and unloading of materials on the roadway. Deliveries should be well planned to ovoid congestion of loading areas and trained traffic management personnel should be used to supervise loading/ unloading areas. For all buildings: Busy construction and demolition sites present a risk of collision where deliveries and other traffic are moving within the site. A traffic management plan supervised by trained traffic management personnel should be adopted for the work site.

#### 4. SERVICES

#### GENERAL

Rupture of services during excavation or other activity creates a variety of risks including release of hazardous material. Existing services are located on or around this site. Where known, these ore identified on the plans but the excel location and extent of services may vary from that indicated. Services should be located using on appropriate service (such as Dial Before You Dig), appropriate excavation practice should be used and, where necessary, specialist contractors should be used. Locations with underground power: Underground power lines MAY be located in or around this site. All underground power lines must be disconnected or carefully located and adequate warning signs used prior to any construction, maintenance or demolition commencing. Locations with overhead power lines: Overhead power lines MAY be near or on this site. These pose a risk of electrocution if struck or approached by lifting devices or other plant and persons working above ground level. Where there is a danger of this occurring, power lines should be, where practical, disconnected or relocated. Where this is not practical adequate warning in the form of bright coloured tape or signage should be used or a protective barrier provided.

#### 5. MANUAL TASKS

Components within this design with a moss in excess of 25kg should be lifted by two or more workers or by mechanical lifting device. Where this is not practical, suppliers or fabricators should be required to limit the component mass. All material packaging, building and maintenance components should clearly show the total moss of packages and where practical all items should be stored on site in a way which minimises bending before lifting. Advice should be provided on safe lifting methods in all areas where lifting may occur. Construction, maintenance and demolition of this building will require the use of portable tools and equipment. These should be fully maintained in accordance with manufacturer's specifications and not used where faulty or (in the case of electrical equipment) not carrying a current electrical safety tag. All safety guards or devices should be regularly checked and Personal Protective Equipment should be used in accordance with manufacturer's specification.

#### 6. HAZARDOUS SUBSTANCES

#### **ASBESTOS**

For alterations to a building constructed prior to 1990: If this existing building was constructed prior to:

1990 - it therefore may contain asbestos

1986 - it therefore is likely to contain asbestos

either in cladding material or in fire retardant insulation material. In either case, the builder should check and, if necessary, take appropriate action before demolishing, culling, sanding, drilling or otherwise disturbing the existing structure.

#### POWDERED MATERIALS

Many materials used in the construction of this building con cause harm if inhaled in powdered form. Persons working on or in the building during construction, operational maintenance or demolition should ensure good ventilation and wear Personal Protective Equipment including protection against inhalation while using powdered material or when sanding, drilling, cutting or otherwise disturbing or creating powdered material.

#### TREATED TIMBER

The design of this building may include provision for the inclusion of treated limber within the structure. Dust or fumes from this material can be harmful. Persons working on or in the building during construction, operational maintenance or demolition should ensure good ventilation and wear Personal Protective Equipment including protection against inhalation of harmful material when sanding, drilling, cutting or using treated timber in any way that may cause harmful material to be released. Do not burn treated timber.

#### VOLATILE ORGANIC COMPOUNDS

Many types of glue, solvents, spray packs, paints, varnishes and some cleaning materials and disinfectants have dangerous emissions. Areas where these are used should be kept well ventilated while the material is being used and for a period after installation. Personal Protective Equipment may also be required. The manufacturer's recommendations for use must be carefully considered at all times.

#### SYNTHETIC MINERAL FIBRE

Fibreglass, rockwool, ceramic and other material used for thermal or sound insulation may contain synthetic mineral fibre which may be harmful if inhaled or if it comes in contact with the skin, eyes or other sensitive parts or the body. Personal Protective Equipment including protection against inhalation of harmful material should be used when installing, removing or working near bulk insulation material.

#### TIMBER FLOORS

This building may contain timber floors which have an applied finish. Areas where finishes are applied should be kept well ventilated during sanding and application and for a period after installation. Personal Protective Equipment may also be required. The manufacturer's recommendations for use must be carefully considered at all times.

#### 7. CONFINED SPACES

#### EXCAVATION

Construction of this building and some maintenance on the building will require excavation and installation of items within excavations. Where practical, installation should be carried out using methods which do not require workers to enter the excavation. Where this is not practical, adequate support for the excavated area should be provided to prevent collapse. Warning signs and barriers to prevent accidental or unauthorised access to all excavations should be provided.

#### ENCLOSED SPACES

For buildings with enclosed spaces where maintenance or other access may be required: Enclosed spaces within this building may present a risk to persons

entering for construction, maintenance or any other purpose. The design documentation calls for warning signs and barriers to unauthorised access. These should be maintained throughout the life of the building. Where workers are required to enter enclosed spaces, air testing equipment and Personal Protective Equipment should be provided.

#### SMALL SPACES

For buildings with small spaces where maintenance or other access may be required: Some small spaces within this building will require access by construction or maintenance workers. The design documentation calls for warning signs and barriers to unauthorised access. These should be maintained throughout the life of the building. Where workers are required to enter small spaces they should be scheduled so that access is for short periods. Manual lifting and other manual activity should be restricted in small spaces.

#### 8. PUBLIC ACCESS

Public access to construction and demolition sites and lo areas under maintenance causes risk to workers and public. Warning signs and secure barriers to unauthorised access should be provided. Where electrical installations, excavations, plant or loose materials are present they should be secured when not fully supervised.

#### 9. OPERATIONAL USE OF BUILDING RESIDENTIAL BUILDINGS

This building has been designed as a residential building. If it, at a later date, it is used or intended to be used as a workplace, the provisions of the Work Health and Safely Act 2011 or subsequent replacement Act should be applied to the new use.


#### NON-RESIDENTIAL BUILDINGS

For non-residential buildings where the end-use has not been identified: This building has been designed to requirements of the classification identified on the drawings. The specific, use of the building is not known at the time of the design and a further assessment of the workplace health and safety issues should be undertaken at the time of fit-out for the end-user. For non-residential buildings where the end-use is known: This building has been designed for the specific use as identified on the drawings. Where a change of use occurs at a later dale a further assessment of the workplace health and safety issues should be undertaken.

#### 10. OTHER HIGH RISK ACTIVITY

All electrical work should be carried out in accordance with Code of Practice: Managing Electrical Risks at the Workplace, AS/ NZ 3012 and all licensing requirements. All work using Plant should be carried out in accordance with Code of Practice: Managing Risks of Plant at the Workplace. All work should be carried out in accordance with Code of Practice: Managing Noise and Preventing Hearing Loss at Work. Due to the history of serious incidents it is recommended that particular care be exercised when undertaking work involving steel construction and concrete placement. All the above applies.



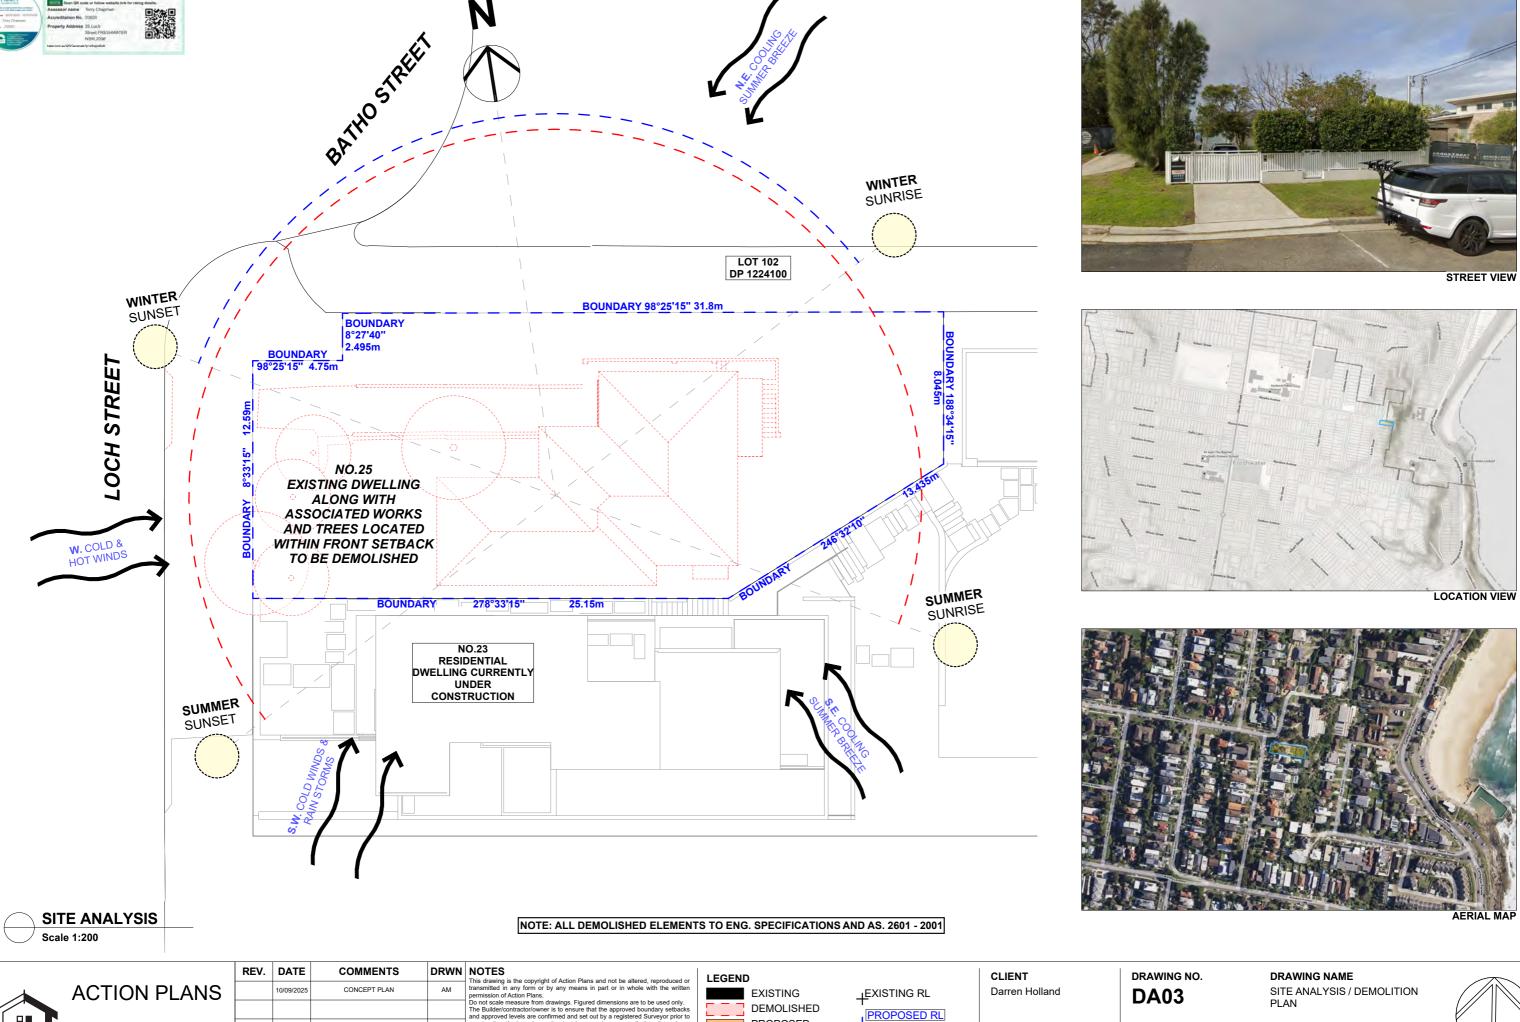



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10/09/2025	CONCEPT PLAN	AM	transmitted in any form or by any means in part or in whole with the written permission of Action Plans.
			Do not scale measure from drawings. Figured dimensions are to be used only.  The Builder/contractor/owner is to ensure that the approved boundary setbacks and approved levels are confirmed and set out by a registered Surveyor prior to
			construction, the boundary setbacks take precedence over all other dimensions. The Builder/Contractor shall check and verify ALL dimensions on site prior to commencement of any work. creation of shop drawings, or fabrication of
			components. All errors and omissions are to be verified by the Builder/Contractor/client and
			referred to the designer prior to the commencement of works.



PROPOSED RL


PROJECT ADDRESS 23 Loch Street, Freshwater NSW 2096

Monday, 22 September 2025

SCALE 1:200 @A3





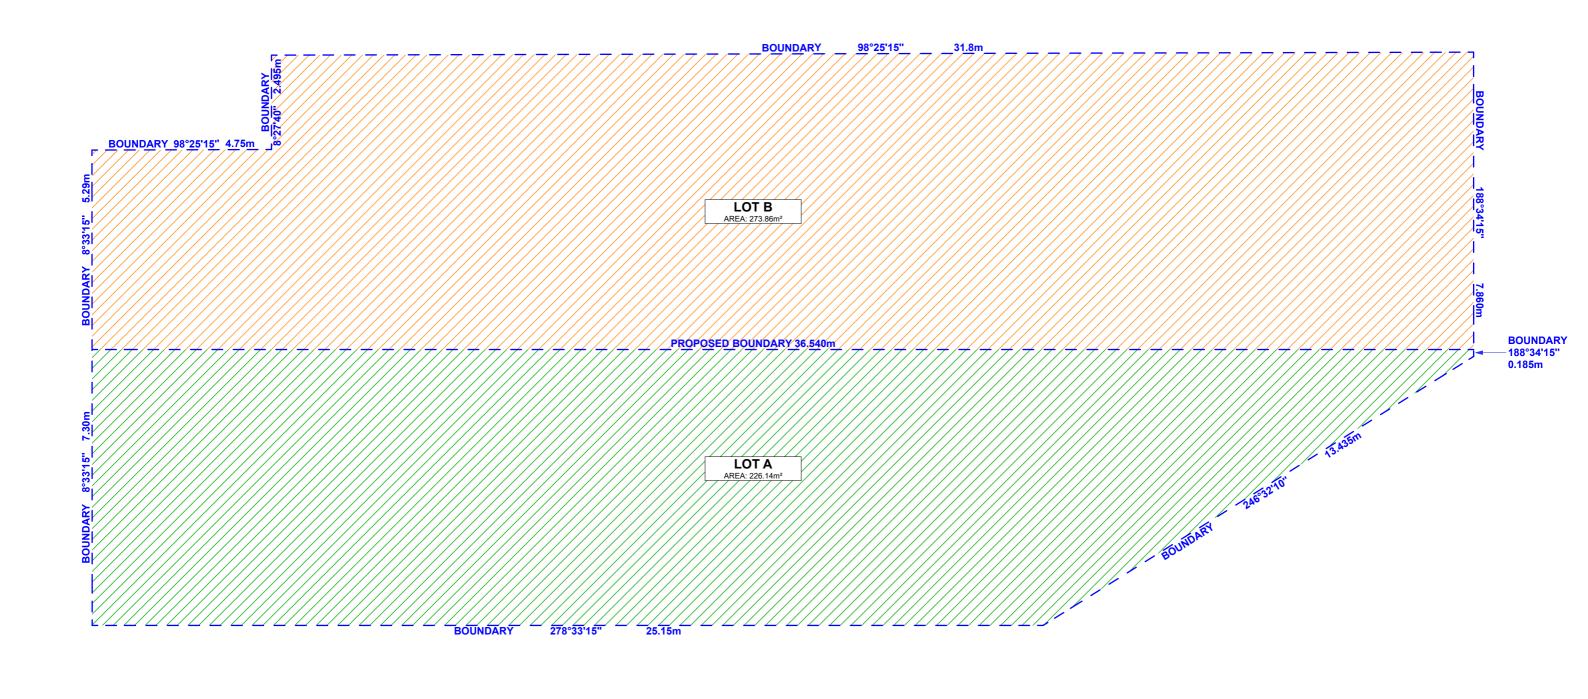






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REV.	DATE	COMMENTS	DRWN	NOTES
	10/09/2025	CONCEPT PLAN	AM	<ul> <li>This drawing is the copyright of Action Plans and not be altered, reproduced or transmitted in any form or by any means in part or in whole with the written permission of Action Plans.</li> </ul>
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				components. All errors and omissions are to be verified by the Builder/Contractor/client and
				referred to the designer prior to the commencement of works.

## **LEGEND**

EXISTING DEMOLISHED PROPOSED

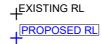

CLIENT Darren Holland

PROJECT ADDRESS 23 Loch Street, Freshwater NSW 2096

DRAWING NO. **DA04** 

2025

DRAWING NAME SUBDIVISION PLAN

SCALE Monday, 22 September 1:100 @A3




NOTE: SITE BOUNDARY IS TO BE IDENTIFIED BY A REGISTERED SURVEYOR AND CLEARLY MARKED ON SITE PRIOR TO COMMENCEMENT OF ANY CONSTRUCTION WORKS.







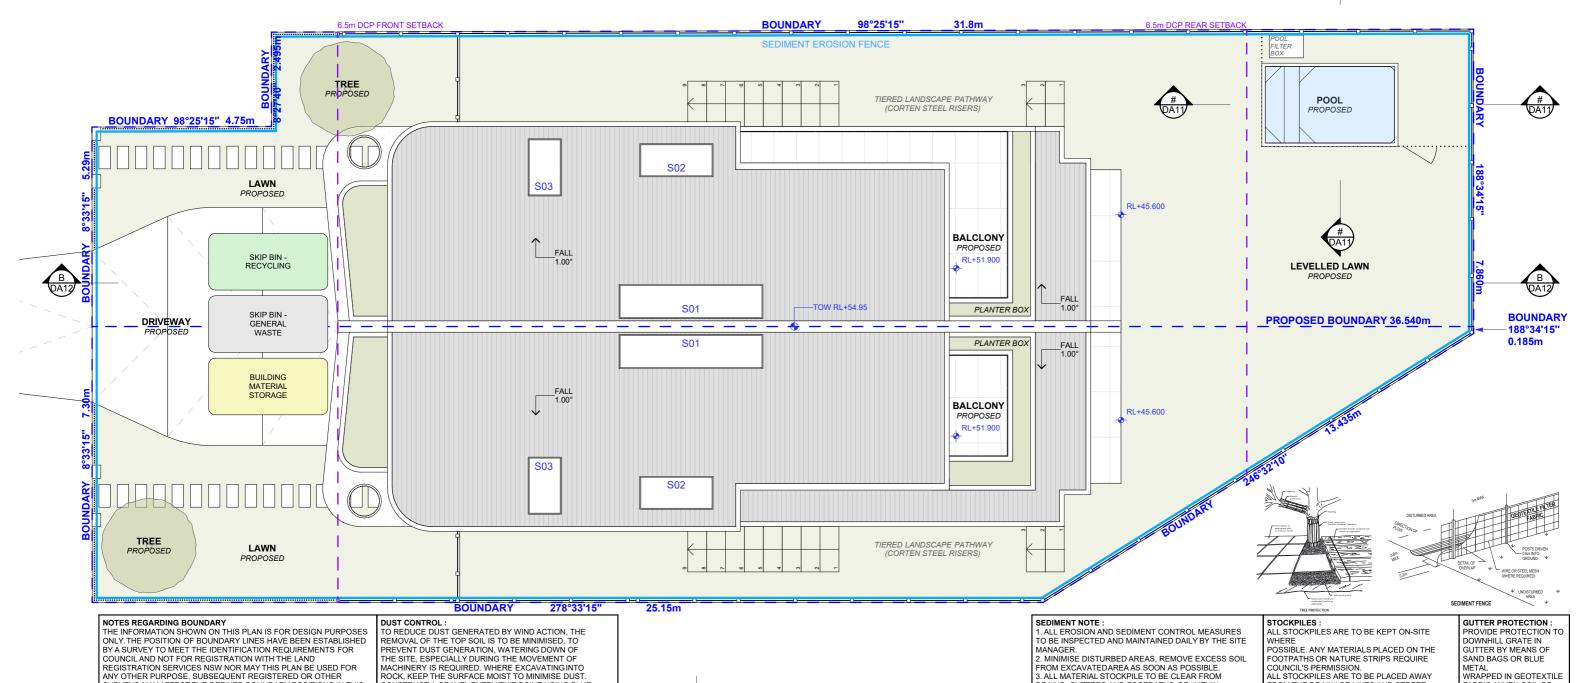

## SITE / ROOF / SEDIMENT EROSION / WASTE MANAGEMENT

SURVEYS MAY AFFECT THE DEFINED BOUNDARY POSITIONS IN THIS

AREA. ANY DIFFERENCES OF THIS NATURE ARE BEYOND THE PURPOSES OF THIS PLAN. THIS PLAN IS FOR THE ABOVE STATED

PURPOSES ONLY. RESTRICTIONS ON THE TITLE HAVE NOT BEEN INVESTIGATED. IF FURTHER DEVELOPMENT IS CONTEMPLATED OR CONSTRUCTION INTENDED THEN IT IS IMPORTANT THAT A SURVEY

Scale 1:100

NOTE: ALL PROPOSED STORMWATER TO CONNECT WITH EXISTING



# **ACTION PLANS**

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	REV.	DATE	COMMENTS	DRWN	NOTES
		10/09/2025	CONCEPT PLAN	AM	<ul> <li>This drawing is the copyright of Action Plans and not be altered, reproduced of transmitted in any form or by any means in part or in whole with the writte permission of Action Plans.</li> </ul>
					Do not scale measure from drawings. Figured dimensions are to be used only. The Builder/contractor/owner is to ensure that the approved boundary setback and approved levels are confirmed and set out by a registered Surveyor prior t
					construction, the boundary setbacks take precedence over all other dimensions The Builder/Contractor shall check and verify ALL dimensions on site prior t commencement of any work, creation of shop drawings or fabrication or
ı					components. All errors and omissions are to be verified by the Builder/Contractor/client an
					referred to the designer prior to the commencement of works.

CONSTRUCT A GRAVEL ENTRY/EXIT POINT LISING BLUE

EXISTING FENCES ARE MAINTAINED DURING THE CONSTRUCTION PHASE UNTIL NEW LANDSCAPING IS


METALAND RESTRICT ALL VEHICLE MOVEMENTS WITHIN

THE SITE TO A MINIMUM. ENSURE WIND BREAKS, SUCH AS

PROVIDED OR REINSTATED. PREVENT DUST BY COVERING

### **LEGEND**



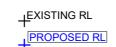

#### CLIENT Darren Holland

DRAINS, GUTTERS AND FOOTPATHS, OR WITHIN

4. DRAINAGE TO BE CONNECTED TO STORMWATERAS

SOON AS POSSIBLE. IF STORED ON SITE, IT MUST BE FILTERED BEFORE RELEASING INTO STORMWATER

5. ROADS AND FOOTPATHS TO BE SWEPT DAILY.

#### **PROJECT ADDRESS** 23 Loch Street,

Freshwater NSW 2096

SYSTEM OR WATERWAYS

## DRAWING NO. **DA05**

2025

# MANAGEMENT

AROUND STOCKPILES.

Monday, 22 September

SITE / ROOF / SEDIMENT **EROSION / WASTE** 

**DRAWING NAME** 

**SCALE** 

1:100 @A3

FROM THE DRAINAGE LINES AND STREET

GUTTERS. IT IS BEST TO LOCATE THESE ON THE

HIGHEST PART OF THE SITE IF POSSIBLE, PLACE

WATERPROOF COVERING OVER STOCKPILES. IF REQUIRED PROVIDE DIVERSION DRAIN &



FABRIC. WHEN SOIL OR SAND BUILDS UP AROUND


THIS SEDIMENT BARRIER.

THE MATERIAL SHOULD BE RELOCATED BACK TO

SITE FOR DISPOSAL





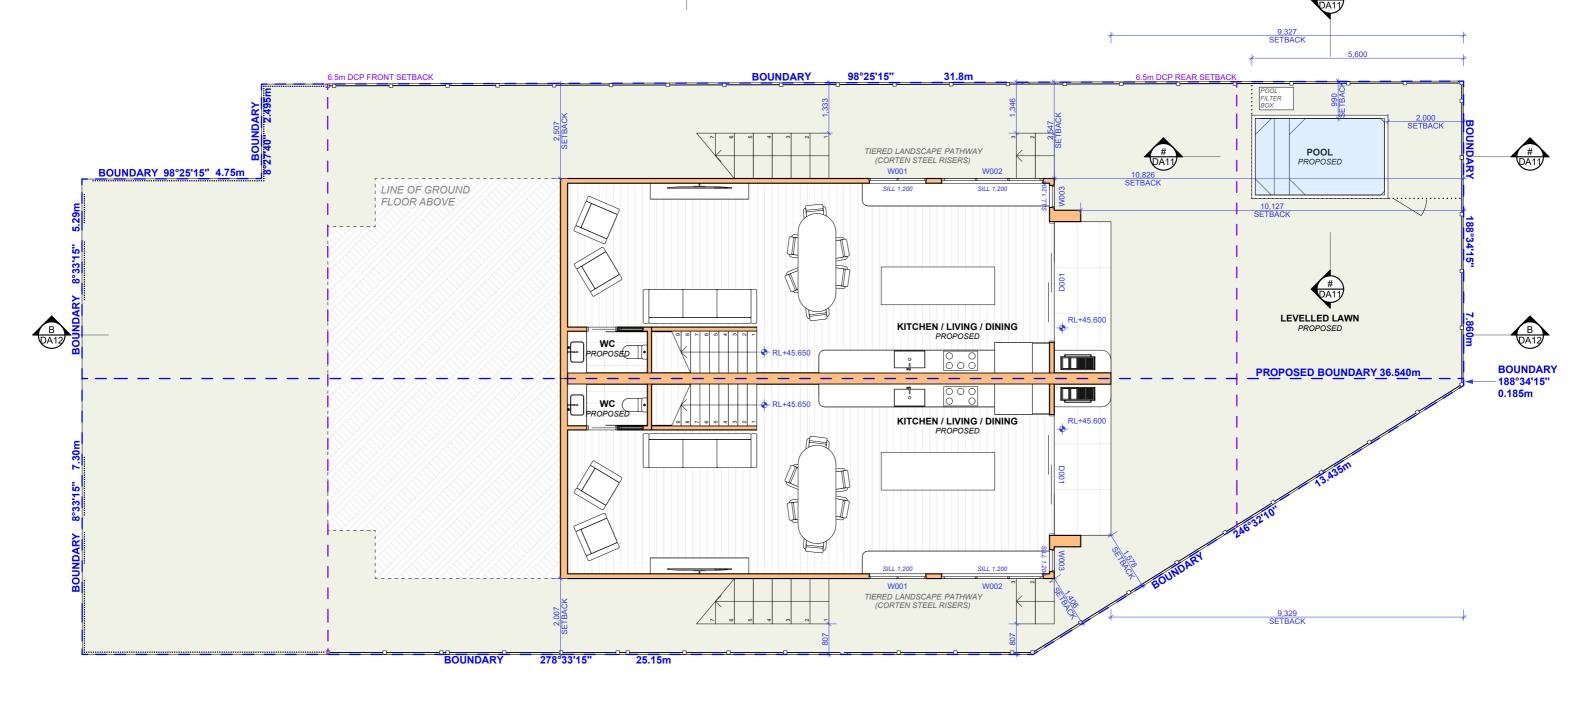



## PROPOSED LOWER GROUND FLOOR PLAN

Scale 1:100

有	r
	Л

**ACTION PLANS** 

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				referred to the designer prior to the commencement of works.





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Darren Holland	

PROJECT ADDRESS	
23 Loch Street,	

2025

Freshwater NSW 2096


DA06

DRAWING NAME

PROPOSED LOWER GROUND
FLOOR PLAN

DATE SCALE
Monday, 22 September 1:100 @A3



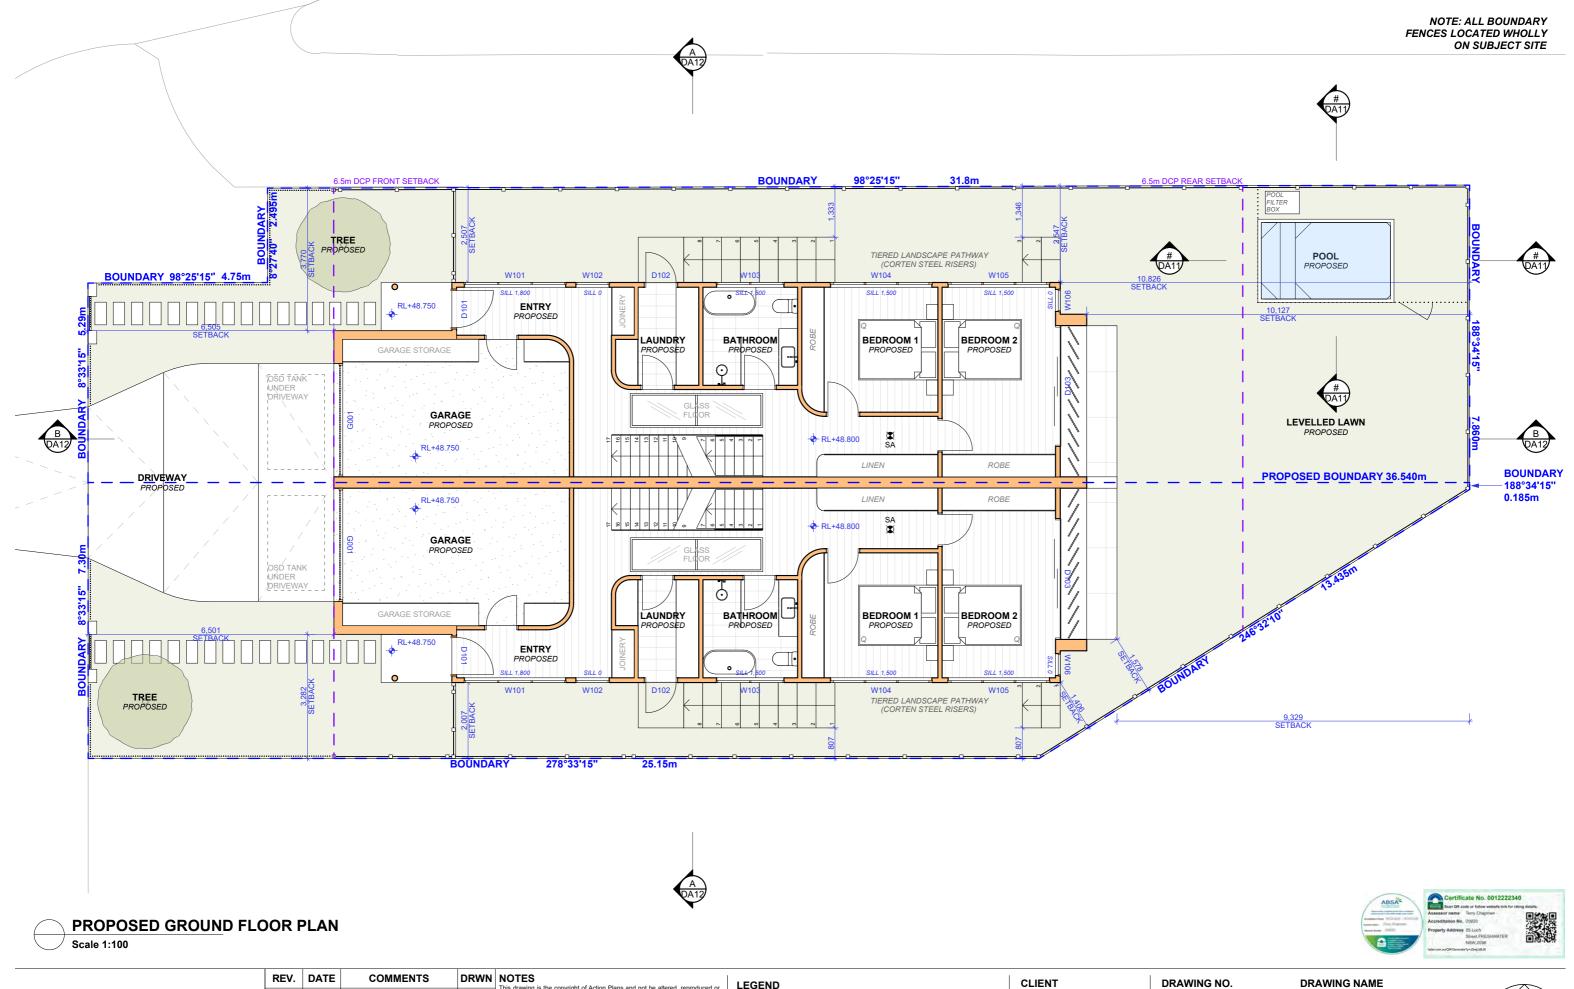



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REV. DATE

COMMENTS

DRWN

10/09/2025

CONCEPT PLAN


AM

AM

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+EXISTING RL

**CLIENT**Darren Holland

PROJECT ADDRESS 23 Loch Street, Freshwater NSW 2096 DA07

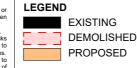2025


PROPOSED GROUND FLOOR PLAN

DATE SCALE
Monday, 22 September 1:100 @A3







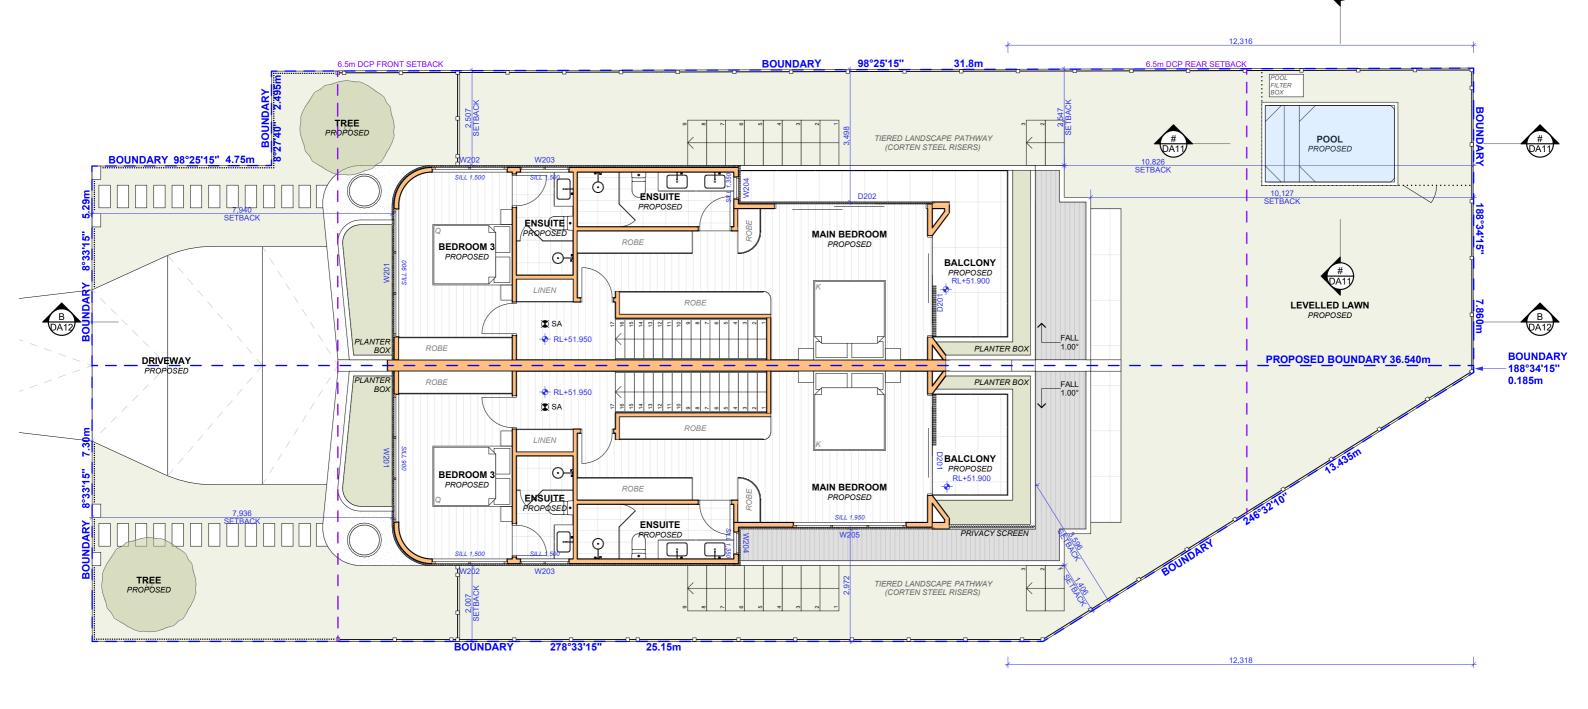






Scale 1:100


7	

## **ACTION PLANS**

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CLIENT Darren Holland

PROJECT ADDRESS 23 Loch Street, Freshwater NSW 2096

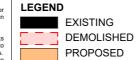DRAWING NO. DRAWING NAME **DA08** 

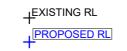Monday, 22 September 2025


PROPOSED FIRST FLOOR PLAN


SCALE 1:100 @A3







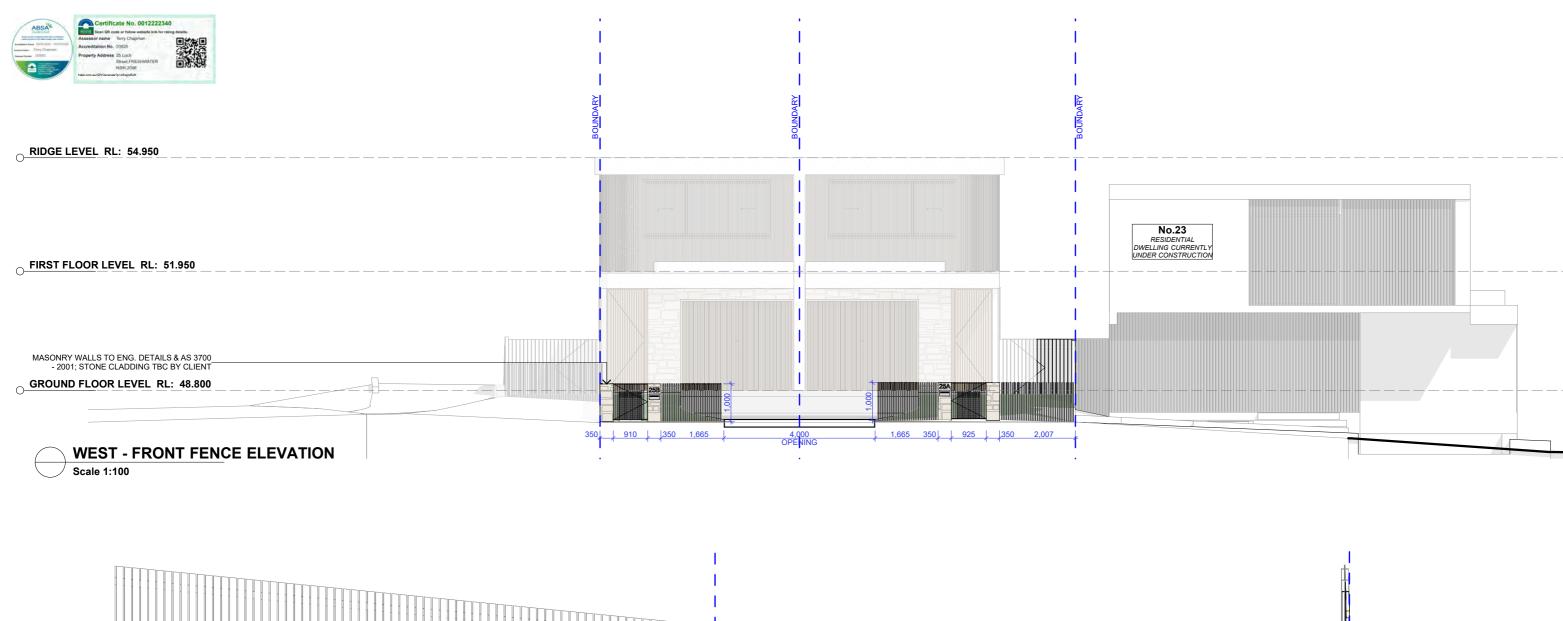

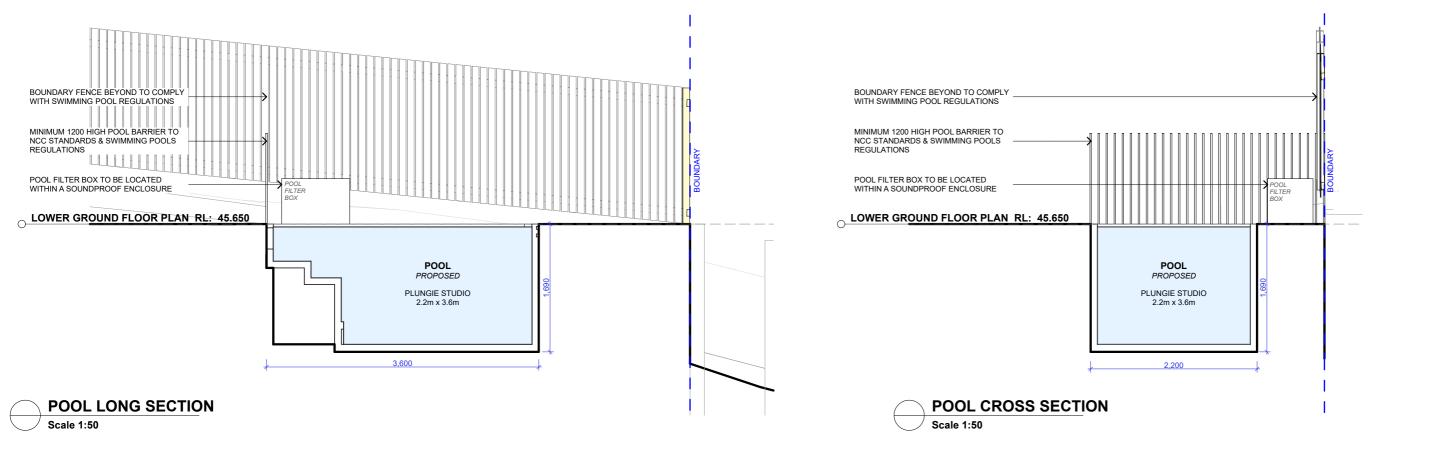



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					Do not scale m The Builder/cor and approved le construction, th The Builder/Co commencemen components. All errors and of
lU					
					referred to the

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measure from drawings. Figured dimensions are to be used only. Contractor/owner is to ensure that the approved boundary setbacks del levels are confirmed and set out by a registered Surveyor prior to 1, the boundary setbacks take precedence over all other dimensions. (Contractor shall check and verify ALL dimensions on site prior to ment of any work, creation of shop drawings, or fabrication of s.

## LEGEND EXISTING

PROPOSED - - - DEMOLISHED

## EXIST. RL ▼

PROP. RL

CLIENT Darren Holland

## PROJECT ADDRESS

23 Loch Street, Freshwater NSW 2096


## DRAWING NO. **DA11**

DRAWING NAME WEST FRONT FENCE **ELEVATION & POOL SECTIONS** 

2025

Monday, 22 September

SCALE 1:100, 1:50 @A3

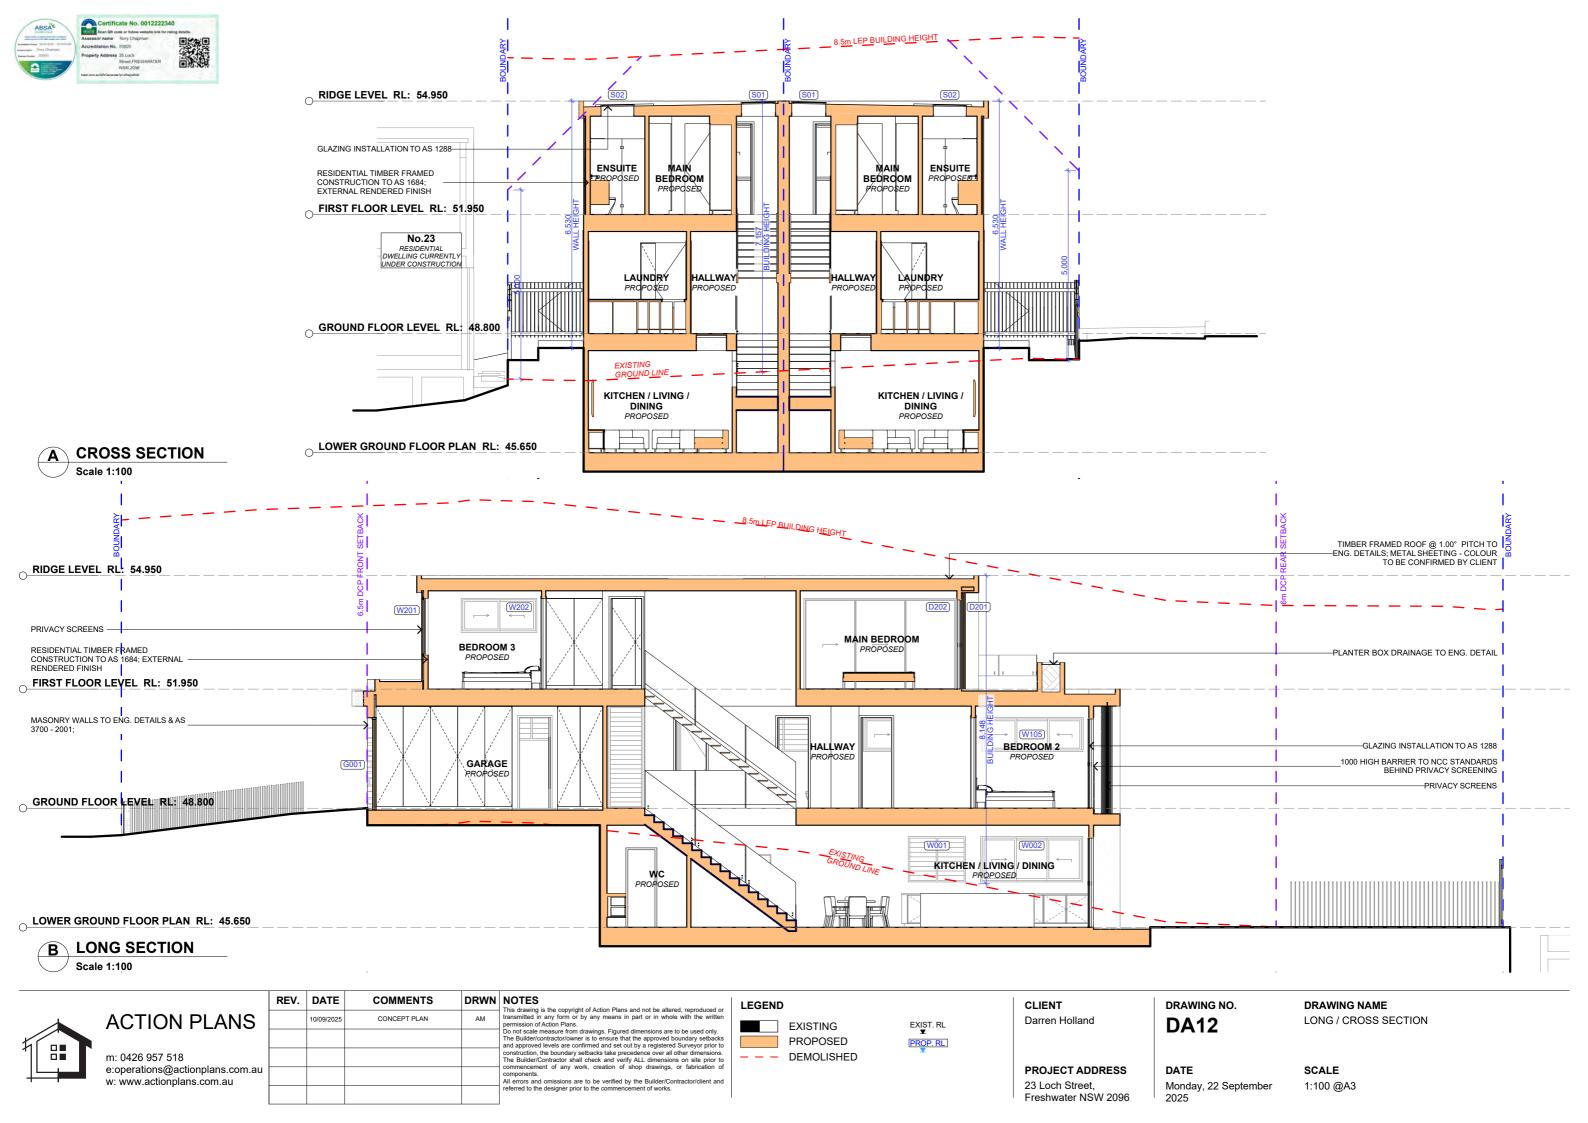



**FRONT FACADE** 



**REAR FACADE** 



TIMBER CLAD GARAGE DOORS / FRONT DOORS / SCREENS



STONE CLADDING




LIGHT COLOURED EXTERNAL RENDER



TILED / PAVED DECKS & BALCONIES



LIGHT COLOURED METAL FENCING

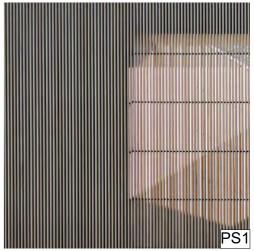

PRIVACY SCREEN



Assessor name	Terry Chapman
Accreditation No.	20920
Property Address	25 Loch Street,FRESHWATER NSW,2096
Property Address	Street,FRESHWATER NSW,2096

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LEGEND

CLIENT
Darren Holland

23 Loch Street,

Freshwater NSW 2096

PROJECT ADDRESS

DATE Monday, 22 September 2025

DRAWING NO.

**DA13** 


DRAWING NAME SAMPLE BOARD

SCALE

@A3





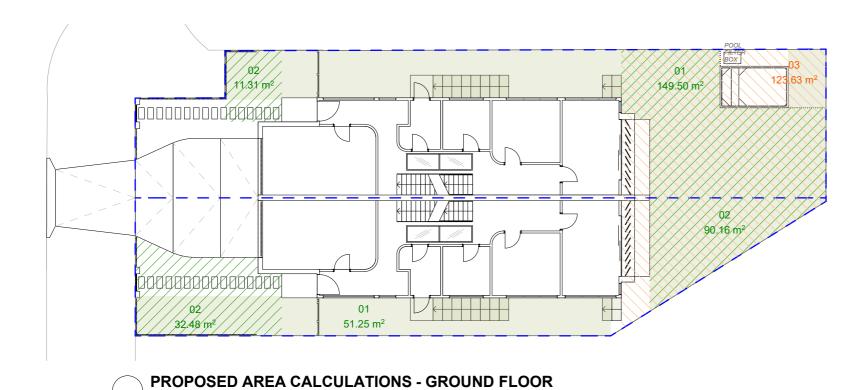

LEGEND	NO.	AREA	CONTROL	PROPOSED (m²)
	01	LANDSCAPING	40% OF SITE AREA (200)	200.75
	02	DEEP SOIL PLANTING	25% OF SITE AREA (125)	133.95
	03	PRIVATE OPEN SPACE	120	123.63

	ACTION PLANS
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Scale 1:200

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LEGEND

**CLIENT**Darren Holland

DA14


**DRAWING NAME**AREA CALCULATIONS

PROJECT ADDRESS
23 Loch Street,

Freshwater NSW 2096

DATE Monday, 22 September 2025 SCALE 1:200, 1:1 @A3



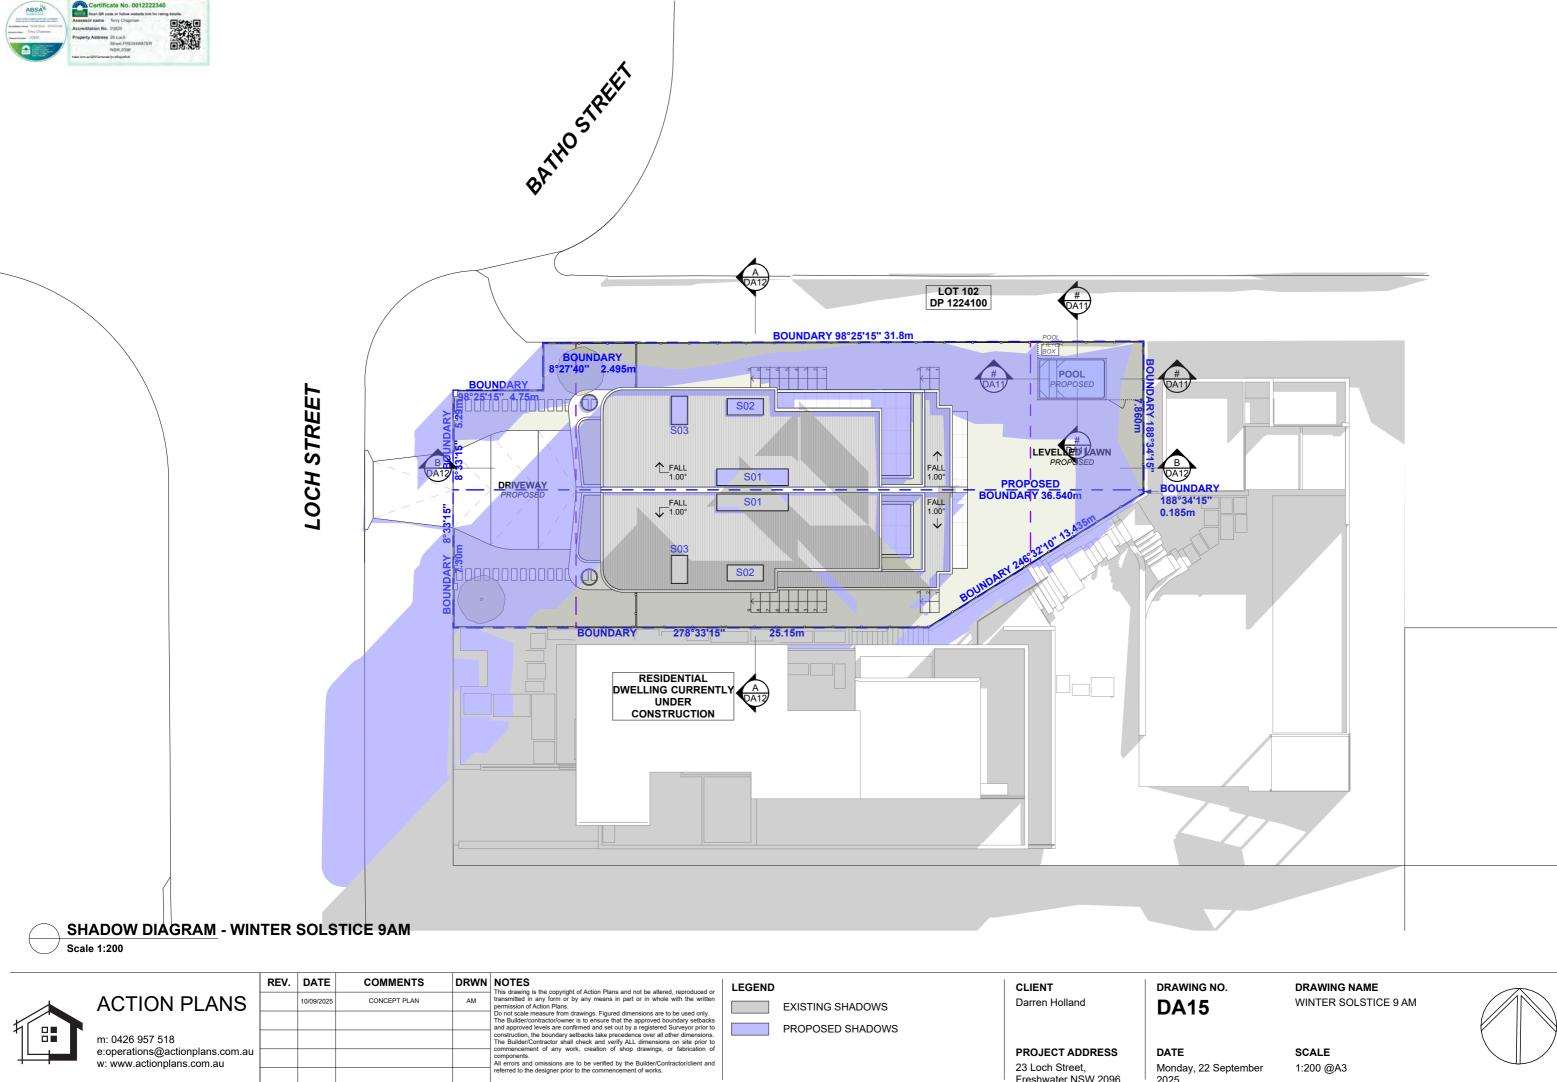



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Monday, 22 September


2025


23 Loch Street,

Freshwater NSW 2096

SCALE 1:200 @A3



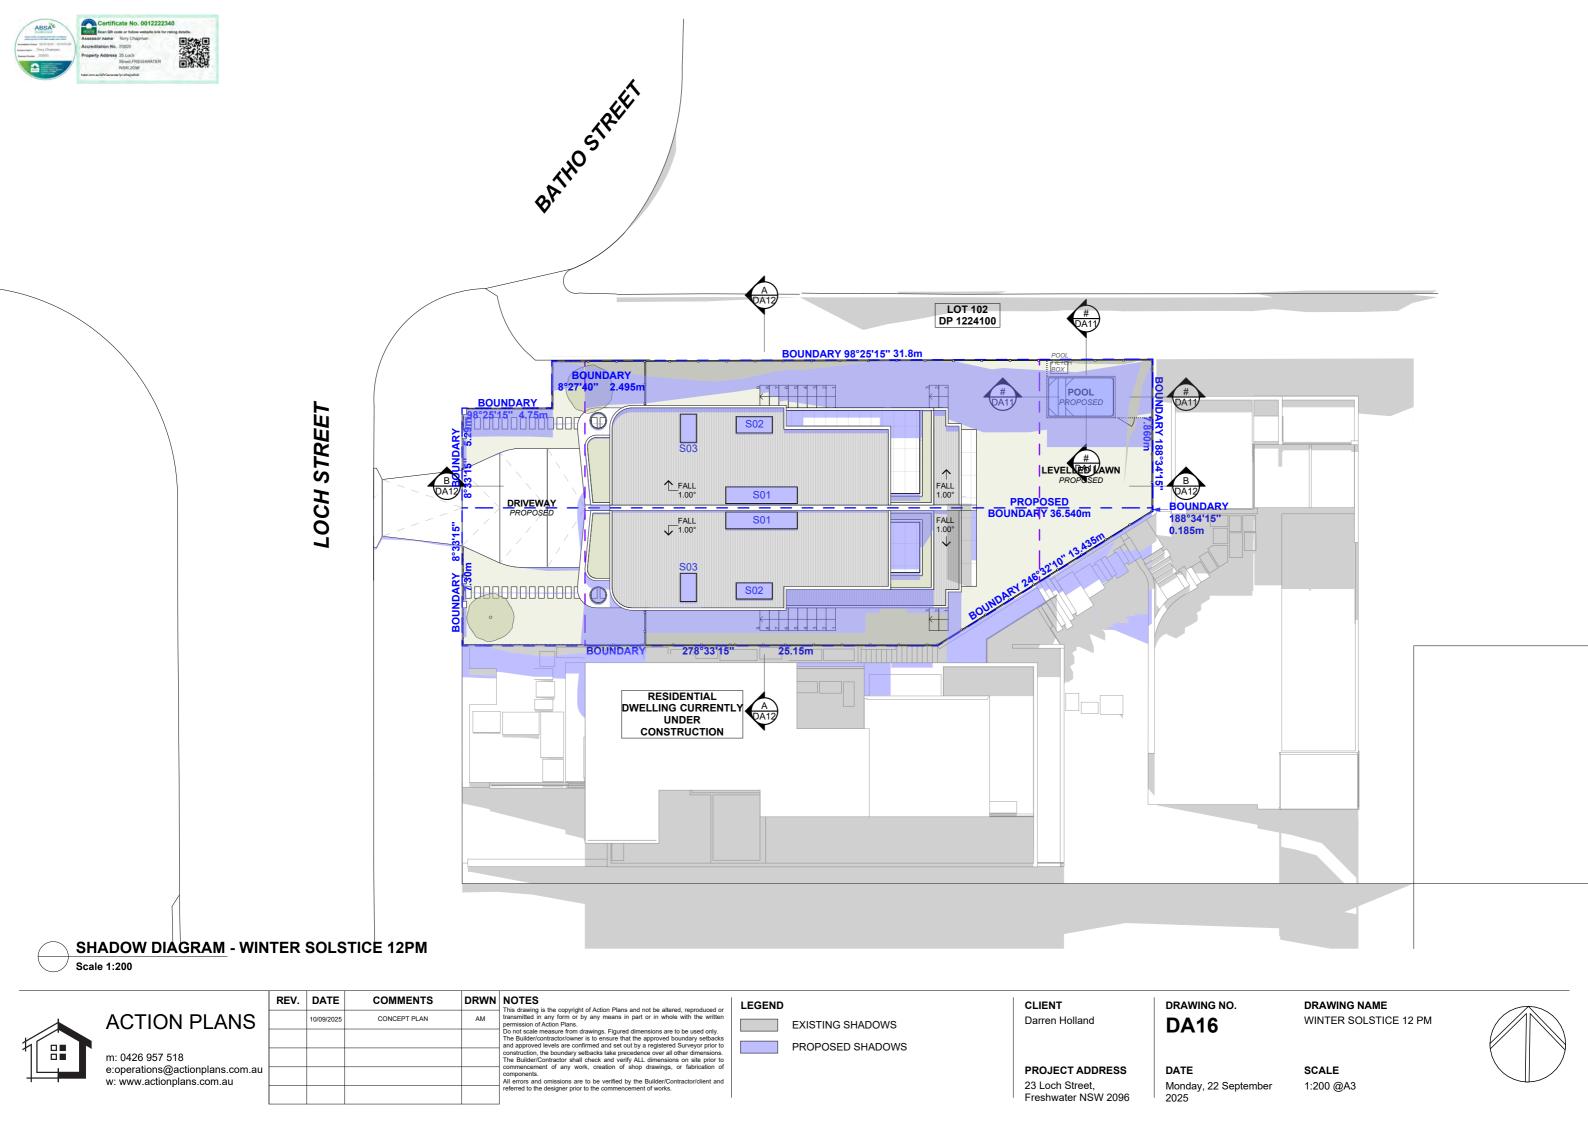

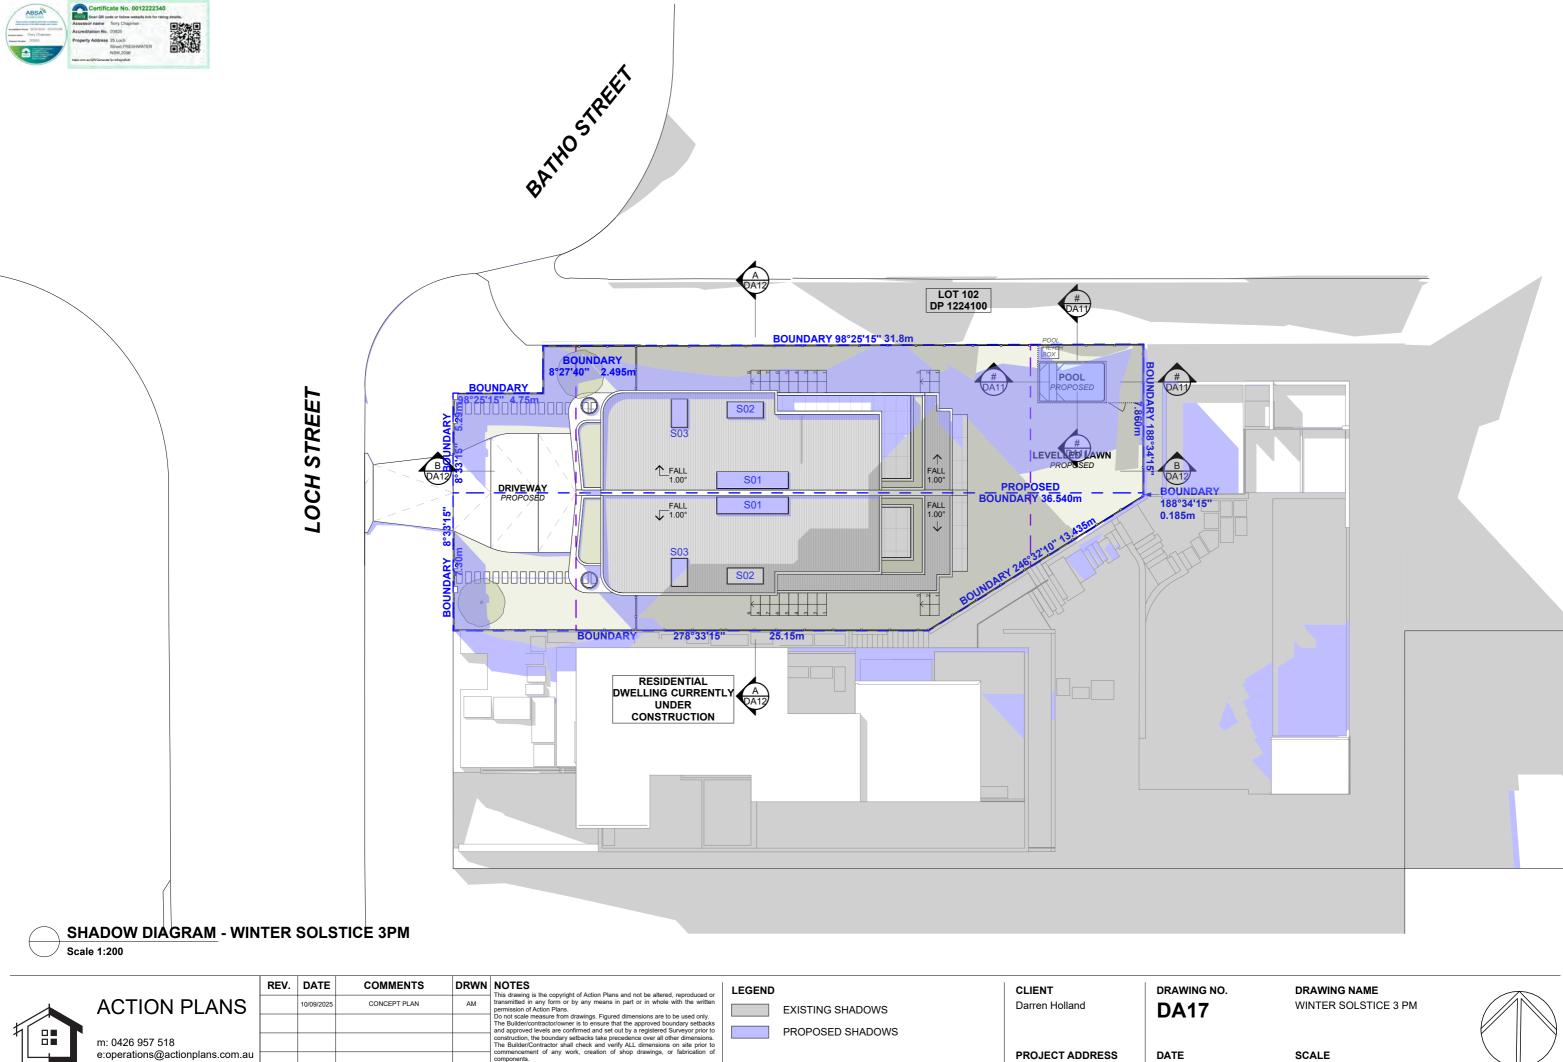



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components.

All errors and omissions are to be verified by the Builder/Contract referred to the designer prior to the commencement of works.


PROJECT ADDRESS 23 Loch Street,

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SCALE Monday, 22 September 1:200 @A3





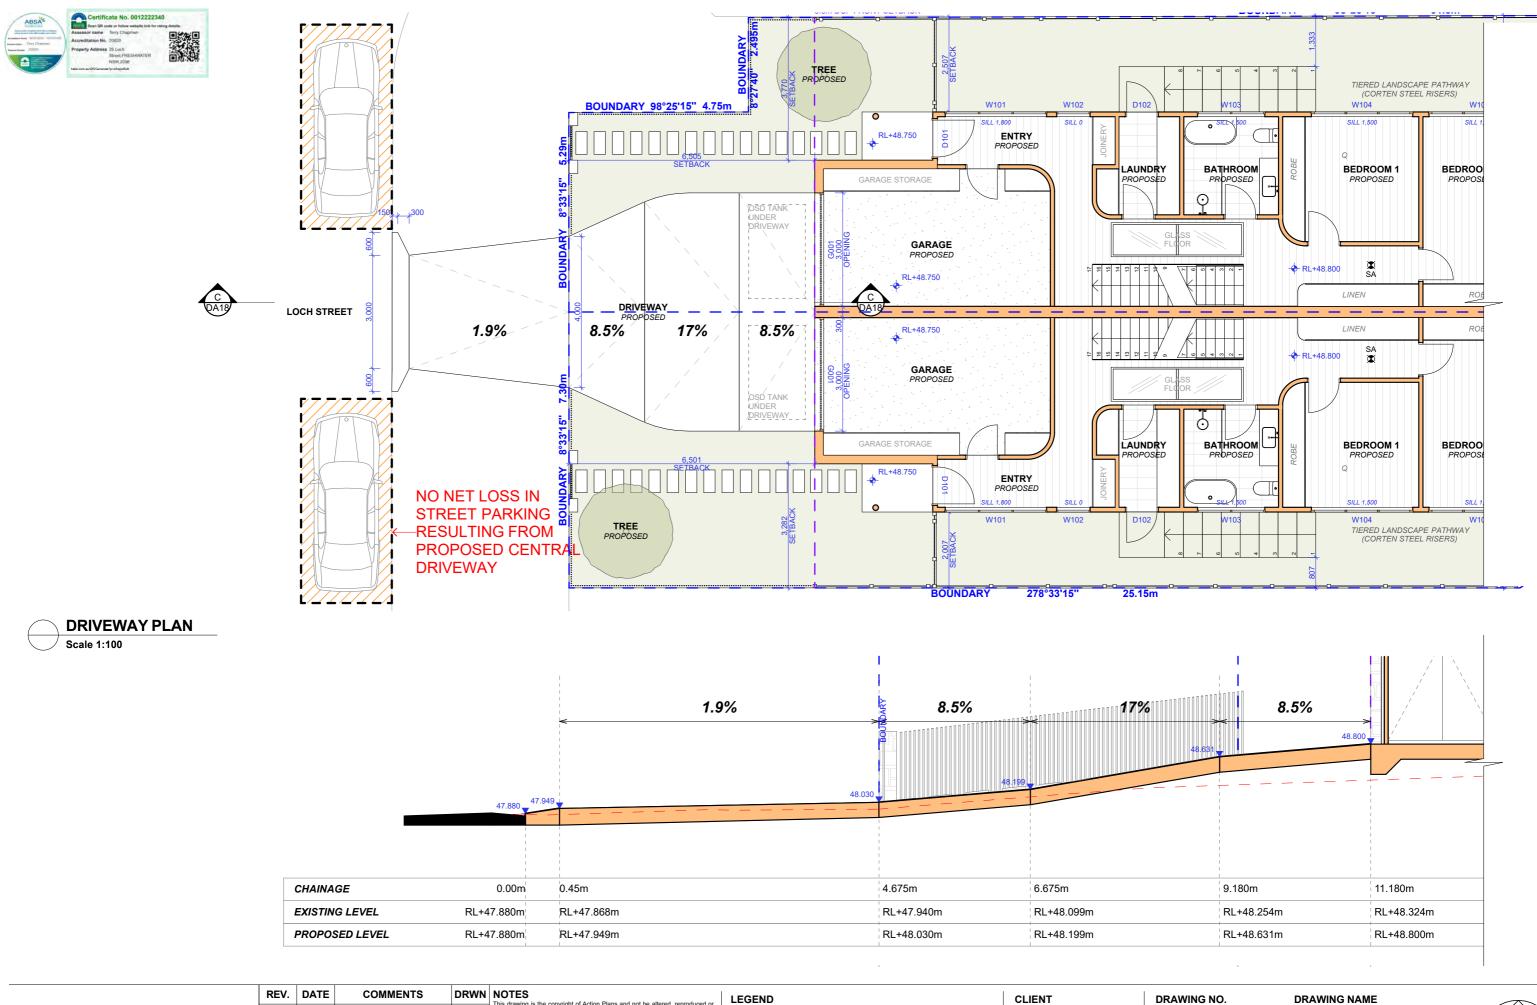

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**LEGEND** 

CLIENT Darren Holland

23 Loch Street,

PROJECT ADDRESS

Freshwater NSW 2096

**DA18** 


2025

DATE Monday, 22 September DRAWING NAME DRIVEWAY PLAN & LONG SECTION


SCALE 1:50, 1:100 @A3





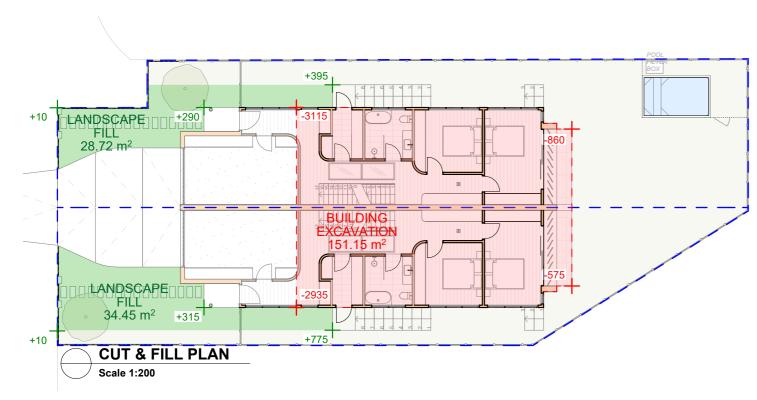

TOTAL PROPOSED FILL: 14.87m<sup>3</sup> TOTAL PROPOSED CUT: 306.46m3

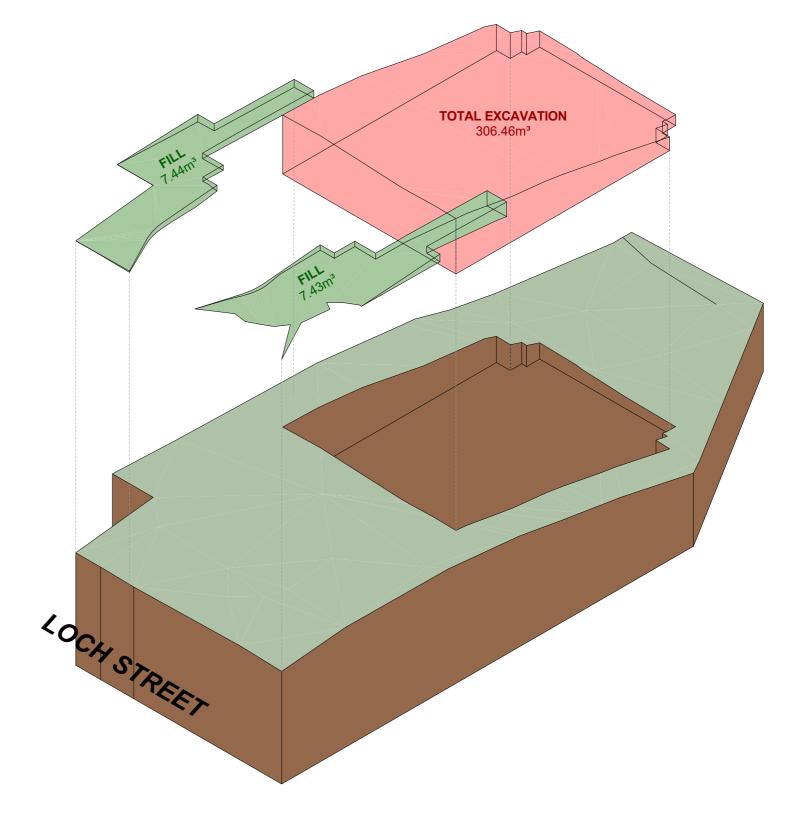



**ACTION PLAN** 

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LEGEND

CLIENT Darren Holland

PROJECT ADDRESS 23 Loch Street,


Freshwater NSW 2096

DRAWING NO. **DA19** 

DRAWING NAME CUT AND FILL PLAN

DATE SCALE Monday, 22 September 1:200 @A3 2025



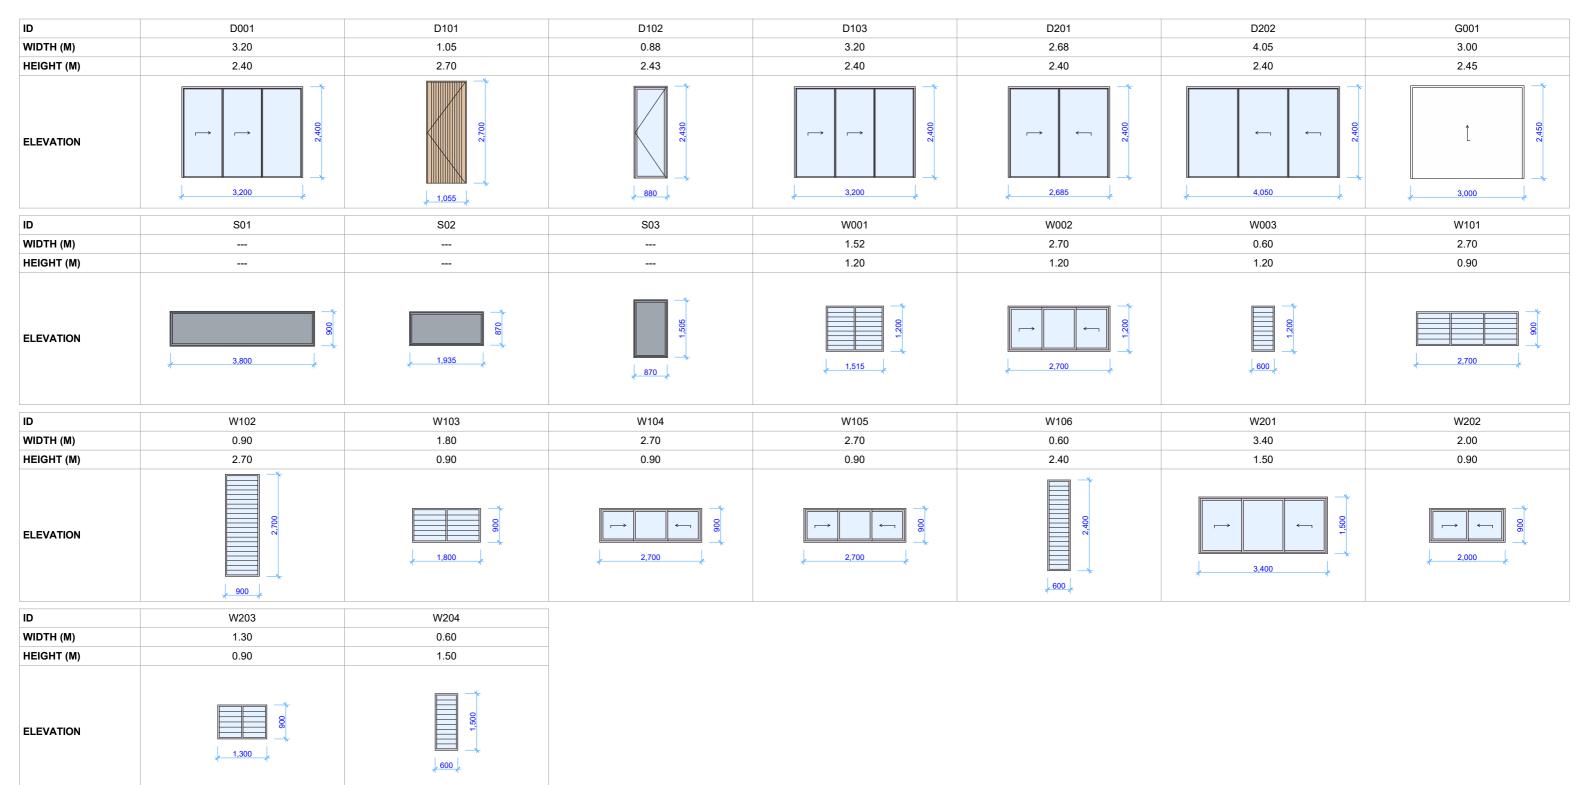





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CLIENT

Darren Holland

**PROJECT ADDRESS** 

23 Loch Street, Freshwater NSW 2096

DRAWING NO. **DA20** 

DRAWING NAME

DATE

Monday, 22 September 2025

WINDOW & DOOR SCHEDULE -NORTH LOT







REV.	DATE	COMMENTS	DRWN
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CLIENT

Darren Holland

## **PROJECT ADDRESS**

23 Loch Street, Freshwater NSW 2096

DRAWING NO. **DA21** 

DRAWING NAME WINDOW & DOOR SCHEDULE -SOUTH LOT

DATE

Monday, 22 September 2025



## **Basix Requirements Summary - Dual Occupancy**

New Dual Occupancy Prepared by Chapman Environmental Services www.cesenergy.com.au 23 Loch Street FRESHWATER NSW 2096 T: 1300 004 914



Water Target Water Score 40 Energy Score 89 **Energy Target** 72 Max H & C Loads are (MJ/m<sup>2</sup>) Actual H & C Loads are (MJ/m²) **Pass** 

			Basix Co	mmitments	;			
Landscaping	Total area of garden & la	wn (m²)	100ea		Area of indige	nous/low water use plan	nts (m²)	0
Fixtures	Shower heads	3 star (> 7	7.5 but <= 9 L/	min)	Toilets	3 star	All taps	3 star
Alternative Water	Minimum Rainwater tan Toilet connection Yes	Laundry	2000ea connection Yes		Collect e connection Yes	run off from roof area of Pool top up Yes	Spa t	68ea op up /a
Pool and Spa	Max pool volume (kL) Pool heating	8 ea Solar (gas	Pool does n boosted)	ot require a	cover	Pool pump must have a	a timer	
	Hot water system Bathroom ventilation Kitchen ventilation Laundry ventilation Cooling - living areas	Gas instantaneous Individual fan, ducted to facade or roof Individual fan, ducted to facade or roof Individual fan, ducted to facade or roof 3-phase airconditioning 3-phase airconditioning 3-phase airconditioning 3-phase airconditioning		oof	Rating 6 star with Manual switch on/off with Manual switch on/off with Manual switch on/off Rating EER 3.0 - 3.5			
Energy	Cooling - bedrooms Heating - living areas Heating - bedrooms			Rating EER 3.0 - 3 Rating EER 3.0 - 3 Rating EER 3.0 - 3	i.5 i.5	Ducted		
	Alternate Energy Gas cooktop & gas oven		oic system abl Outdoor clo	U		<b>5.0Kw each</b> peak kilow No indoor clothesline r		city

External Floor Types Sicreternal Floor Types Floor Coverings External Walls External Walls Planternal Walls Ceiling (floor above) Ceilings (roof above) Floor Graph Comments of Comments o	Thermal Performance Ass oncrete slab on ground uspended concrete slab les Wet areas arpet n/a lockwork veneer mber framed Fibro clad lasterboard lockwork Partywall oncrete above plasterboard oncrete above plasterboard mber above plasterboard. oncrete		with with with with with with with with	No insulation revolution revoluti	quired quired .iving / Bedrooms Garage tion 5 bulk insulation tion to garage internal w quired tion	Colour	Light Light
Floor Coverings  External Walls  Internal Walls  Ceiling (floor above)  Ceilings (roof above)  Control	les Wet areas arpet n/a lockwork veneer mber framed Fibro clad lasterboard lockwork Partywall oncrete above plasterboard oncrete above plasterboard mber above plasterboard. oncrete		with with with with with with	Timber L Concrete G R2.5 bulk insula Sarking and R2.5 R2.5 bulk insula No insulation rec R2.5 bulk insula R2.5 bulk insula	.iving / Bedrooms Garage tion 5 bulk insulation tion to garage internal w quired tion	Colour	
teilings (roof above)  coof  C	arpet n/a lockwork veneer mber framed Fibro clad lasterboard lockwork Partywall oncrete above plasterboard oncrete above plasterboard mber above plasterboard. oncrete		with with with with with	R2.5 bulk insula Sarking and R2.5 R2.5 bulk insula No insulation re R2.5 bulk insula R2.5 insulation	Garage tion 5 bulk insulation tion to garage internal w quired tion	Colour	
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nternal Walls  Pleiling (floor above)  Ceilings (roof above)  Color Coof  Tile  Coof	mber framed Fibro clad lasterboard lockwork Partywall oncrete above plasterboard oncrete above plasterboard mber above plasterboard. oncrete		with with with with with	Sarking and R2.5 R2.5 bulk insula No insulation re R2.5 bulk insula R2.5 insulation	5 bulk insulation tion to garage internal w quired tion	Colour	
nternal Walls Place illing (floor above) Ceilings (roof above) Color M	lasterboard lockwork Partywall oncrete above plasterboard oncrete above plasterboard mber above plasterboard. oncrete		with with with with	R2.5 bulk insula No insulation re R2.5 bulk insula R2.5 insulation	tion to garage internal w quired tion		Light
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eilings (roof above) Ti  coof  Ca	oncrete above plasterboard mber above plasterboard.		with	R2.5 insulation			
ceilings (roof above) Ti  coof  CA	oncrete above plasterboard mber above plasterboard.		with	R2.5 insulation			
oof M	mber above plasterboard. oncrete						
oof Co	oncrete		with		R3.5 bulk insulation		
pof M				No.5 bulk ilibula	tion		
М	letal 1 d		with	Waterproof men			
Al		degrees	with	R1.3 roof blanke	et	Colour	Light
	F single glazed clear - Unit A		Sliding W	AWS-001-001	U-Value 6.40 or less	SHGC 0.73 +	/- 5%
			Lourves	VAN-004-001	U-Value 6.14 or less	SHGC 0.64 +	/- 5%
			Sliding D	AWS-024-001	U-Value 6.20 or less	SHGC 0.66 +	/- 5%
			Hinged D	AWS-018-001	U-Value 5.90 or less	SHGC 0.56 +	/- 5%
Al	F single glazed Comfort Plus Glazing	g - Unit B		AWS-001-019	U-Value 4.52 or less		
indows and Doors			Lourves	VAN-004-007	U-Value 4.70 or less		
			Sliding D	AWS-024-016	U-Value 4.54 or less		
			Hinged D	AWS-018-018	U-Value 4.41 or less	SHGC 0.46 +	/- 5%
Al	F double glazed clear Skylights		Skylights	VEL-010-01 W	U-Value 2.40 or less	SHGC 0.24 +	/- 5%
Al	F = Aluminium Framed TB = Thermally	/ Broken A	luminium F	Framed T	F = Timber Framed		

Any exhaust fans noted are to be fitted with self-closing dampers or be otherwise sealed All insulation specified must be installed in accordance with Part 3.12.1.1 of the BCA

If there is a discrepancy between this document and the BASIX & Nathers Certificate, then the BASIX & Nathers Certificate shall take

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REV.	DATE	COMMENTS	DRWN
	10/09/2025	CONCEPT PLAN	AM

NOTES

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The Builder/contractor/owner is to ensure that the approved boundary setbacks and approved levels are confirmed and set out by a registered Surveyor prior to construction, the boundary setbacks take precedence over all other dimensions.

The Builder/Contractor shall check and verify ALL dimensions on site prior to commencement of any work, creation of shop drawings, or fabrication of components. All errors and omissions are to be verified by the Builder/Contractor/client and referred to the designer prior to the commencement of works. All window & door dimensions, orientation, glazing materials, opening types, frame types are to be confirmed by a suitably qualified person prior to the ordering of any such materials are to take place. U value takes precedence over glazing type/colour in all cases. all new glazing must meet the BASIX specified frame and glass type, \( QR \) meet the ecified U value and SHGC value.

CLIENT Darren Holland

PROJECT ADDRESS

23 Loch Street, Freshwater NSW 2096

DRAWING NO. **DA22** 

DRAWING NAME BASIX COMMITMENTS

DATE

Monday, 22 September 2025