1. DEMOLITION

Demolition works to be carried out in accordance with the requirements of A2601-2001 The Demolition of Structures. Also in compliance with work cover authority of NSW requirements, including but not limited to:

- Protection of site workers and the general public
- Asbestos handling and disposal where applicable

2. PEST CONTROL

Termite protection to be provided in accordance with NCC 3.1.4 and AS 3660.1

3. TIMBER FRAMING / CLADDING

All timber framing shall comply with AS1684

All external timber framed walls to be wrapped in a breathable vapour permeable membrane that complies + installed with AS/NZS 4200.1 + AS/NZS 4200.2

All external wall Claddings must be complaint with the requirements of N.C.C. 2019 Vol 2 Part 3.5.4. deemed to satisfy provisions and AS/NZS 1859.4.

4. METAL ROOF

Metal Roof Design and Installation shall be in accordance with N.C.C 2019 Vol 2 Part 3.5.1. AS/NZS 156

5 STAIRS

All stairs providing access to comply with N.C.C. 2019 Vol2 Part 3.9.1 & 3.9.2 and AS 4586 including slip resistance P3 / R10 for Dry or P4 / R11 for Wet

6. BALUSTRADES

In accordance with NCC 3.9.2 - balustrades to be at least 1m above the FFL of balconies and landings , and no less rhan 865mm above nosing line of stairs ; incorporate openings no larger than 125mm and where the fall of >4m, to have no climbable members between 150-760mm

Balustrades to comply with AS1170 AS 1288 and AS/NZS 2208

7. WINDOWS

All windows to be restricted in accordance with N.C.C 2019 Vol 2 Part 3.9.2.6 & Part 3.9.2.7. Protection of openable windows where floor below is greater than 2 meters

8. WATERPROOFING

Waterproofing shall be carrief out in accordance with NCC 3.8.1 and AS4654-2012

9. CONDENSATION

Condensation Management must be adhered to in accordance with N.C.C. 2019 Vol 2 Part 3

9. SMOKE ALARMS

Proved hardwired & interconnected smoke and fire detection devices. Smoke alarms to be installed to AS 3786 and the N.C.C. 2019 Vol 2 Part 3.7.5

10. FIRE SAFTY

An external wall of Class 1 buildings and any openings in that wall must comply with NCC 3.7.2 if the wall is less than 900mm from an allotment boundary

Eaves within 900mm of allotment boundries are to be constructed of non-combustible materials. eaves must not be within 450mm of allotment boundaries as required by part 3.7.1 of BCA

11. SEDIMENT CONTROL

Sediment & Erosion control are to be installed and maintained during the life of the project



Ironstone®

Inspired by the purple-grey hues of distant mountains, stormy skies and the natural beauty of our coastal regions, Ironstone® has captured a new mood for COLORBOND® steel colours.

ROOF COLOUR



	SHEET LIST	
Sheet Number	Sheet Name	Sheet Issue Date
A100	NOTES	20/12/2021
A101	SITE PLAN	20/12/2021
A102	DRIVEWAY	20/12/2021
A103	ROOF PLAN	20/12/2021
A104	GROUND FLOOR PLAN	20/12/2021
A105	FIRST FLOOR PLAN	20/12/2021
A106	ELEVATIONS	20/12/2021
A107	ELEVATIONS	02/23/22
A108	ELEVATIONS	20/12/2021
A109	SECTIONS	20/12/2021
A110	SECTIONS	20/12/2021
A111	WINDOW & DOOR SCHEDULE	20/12/2021
A112	DEMOLITION & WASTE MANAG.	12/20/21
A113	SHADOW DIA	20/12/2021
	+	

Do not scale from plans. All dimensions and levels shown on plan are subject to confirmation on site.

ISSUE	DATE	DESCRIPTION	DRWN	CHKD
-	28.07.2021	ENVELOPES	KM	-
	29.11.2021	CONCEPT 4	KM	
1	20.12.2021	DA ISSUE	KM	

BUILDING DESIGNS E: info@bsbd.com.au www.blueskybuildingdesigns.com.au

PROJECT TITLE: NEW BUILD PROJECT NO.: 2021014

FOR:

T: 7 SHERRY STREET, MONA VALE


REBECCA & ALEX GILLESPIE

SHEET TITLE: NOTES

SHEET NO: A100

SCALE A3:

This drawing is copyright and remains the property of Blue Sky Building Designs P/L.

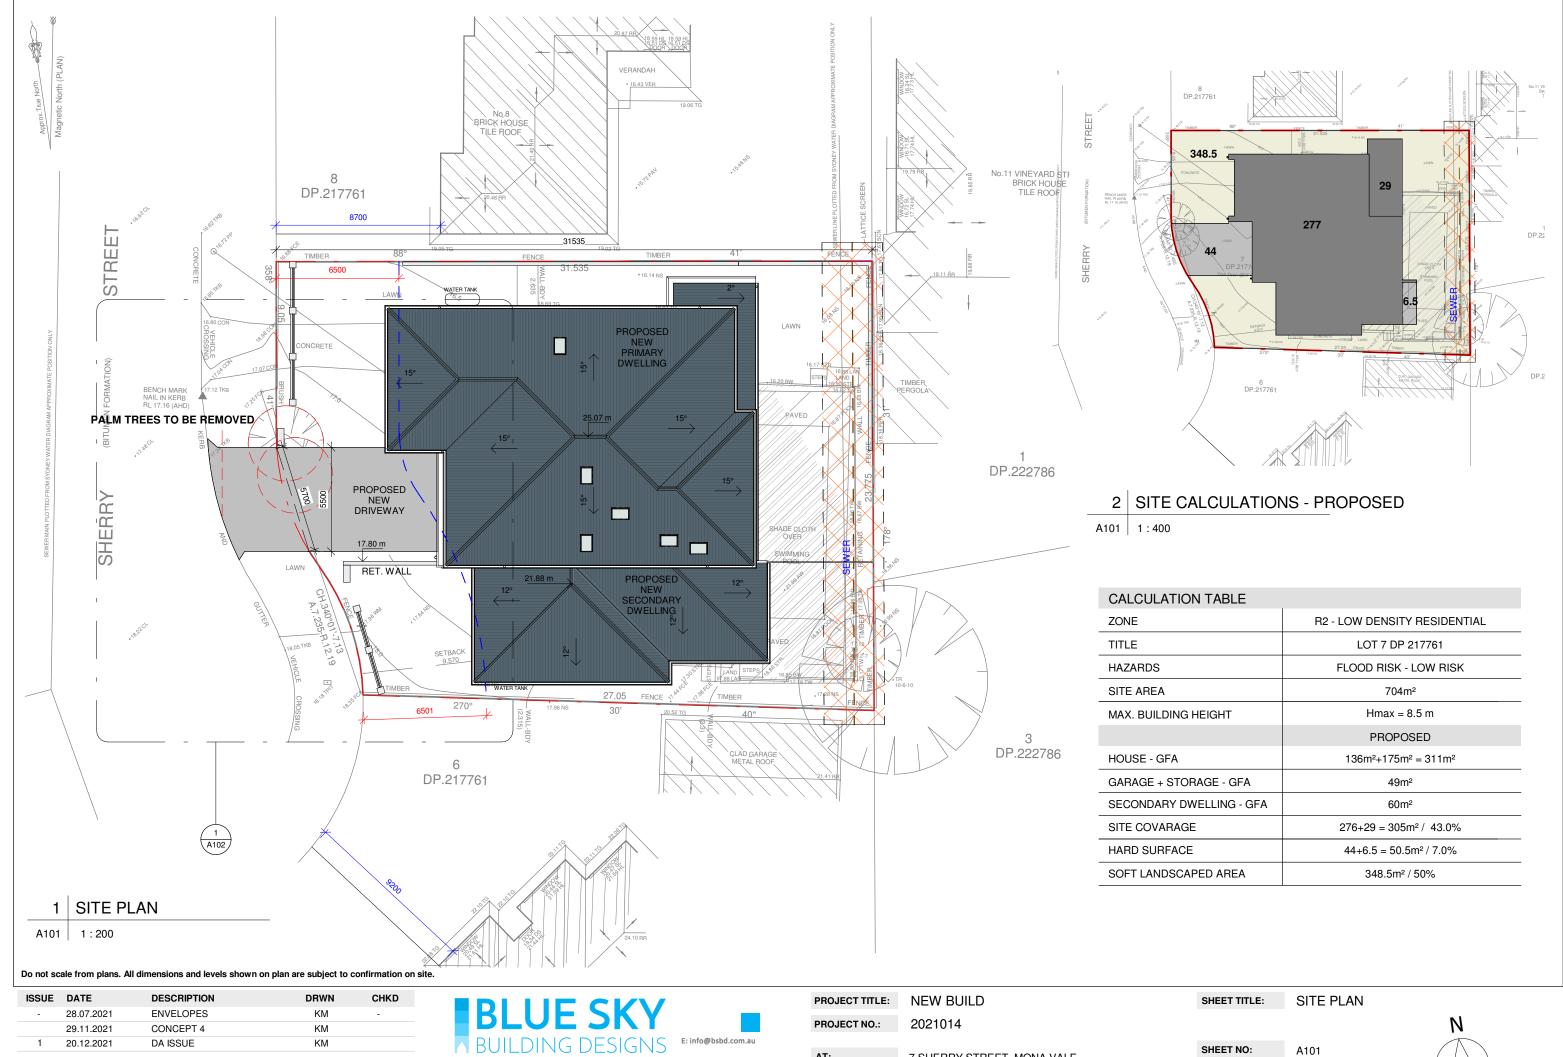


This drawing is copyright and remains the property of Blue Sky Building Designs P/L.


www.blueskybuildingdesigns.com.au

7 SHERRY STREET, MONA VALE REBECCA & ALEX GILLESPIE FOR:


SCALE A3: As indicated



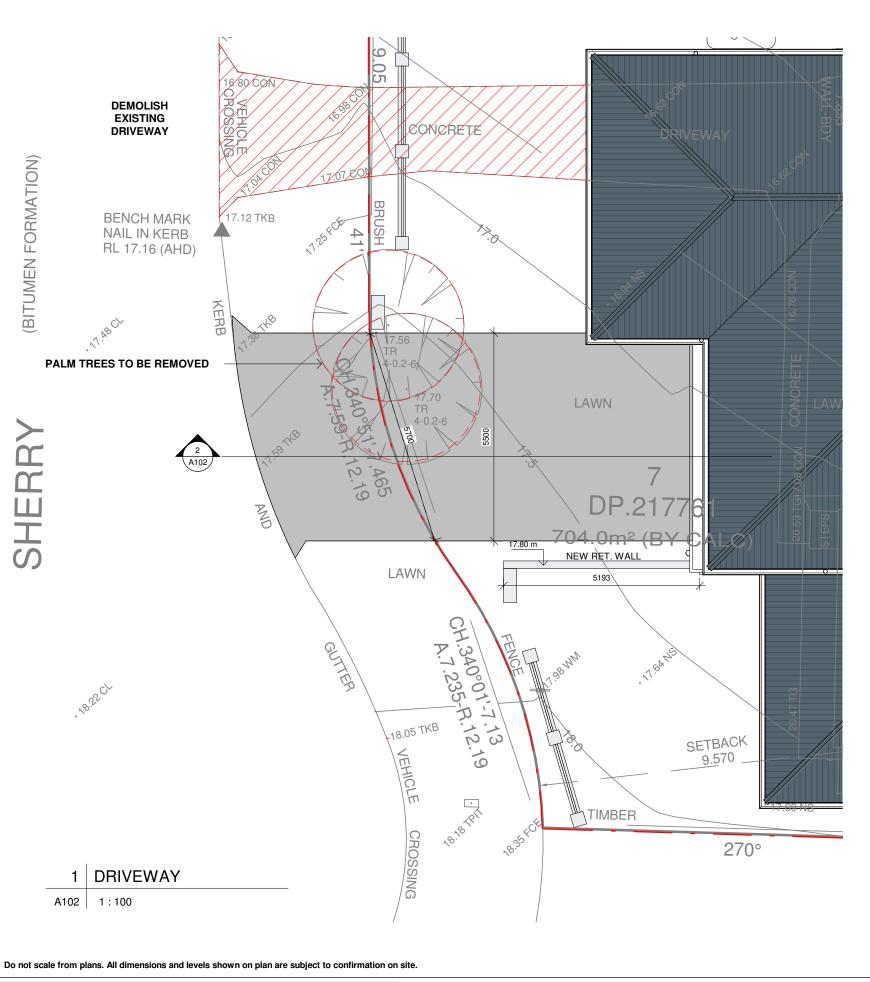

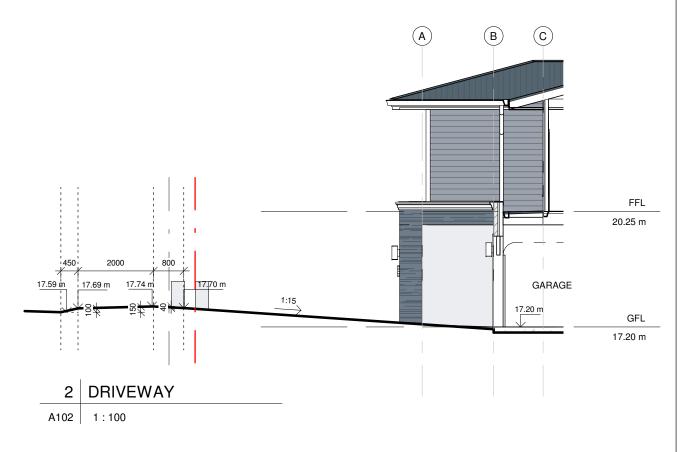

CROSS SECTION-ROAD FROM CENTRELINE TO PROPERTY BOUNDARY

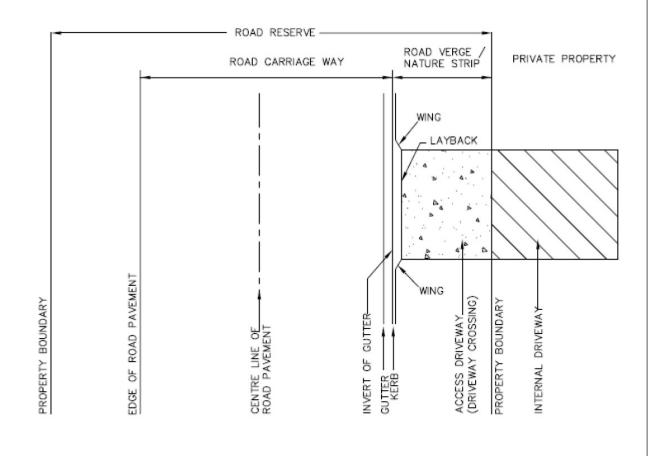


ISSUE	DATE	DESCRIPTION	DRWN	CHKD
-	28.07.2021	ENVELOPES	KM	-
	29.11.2021	CONCEPT 4	KM	
1	20.12.2021	DA ISSUE	KM	

BUILDING DESIGNS E: info@bsbd.com.au www.blueskybuildingdesigns.com.au

PROJECT TITLE:	NEW BUILD
PROJECT NO.:	2021014
AT:	7 SHERRY STREET, MONA VALE
FOR:	REBECCA & ALEX GILLESPIE

SHEET NO: A102

SCALE A3: 1:100

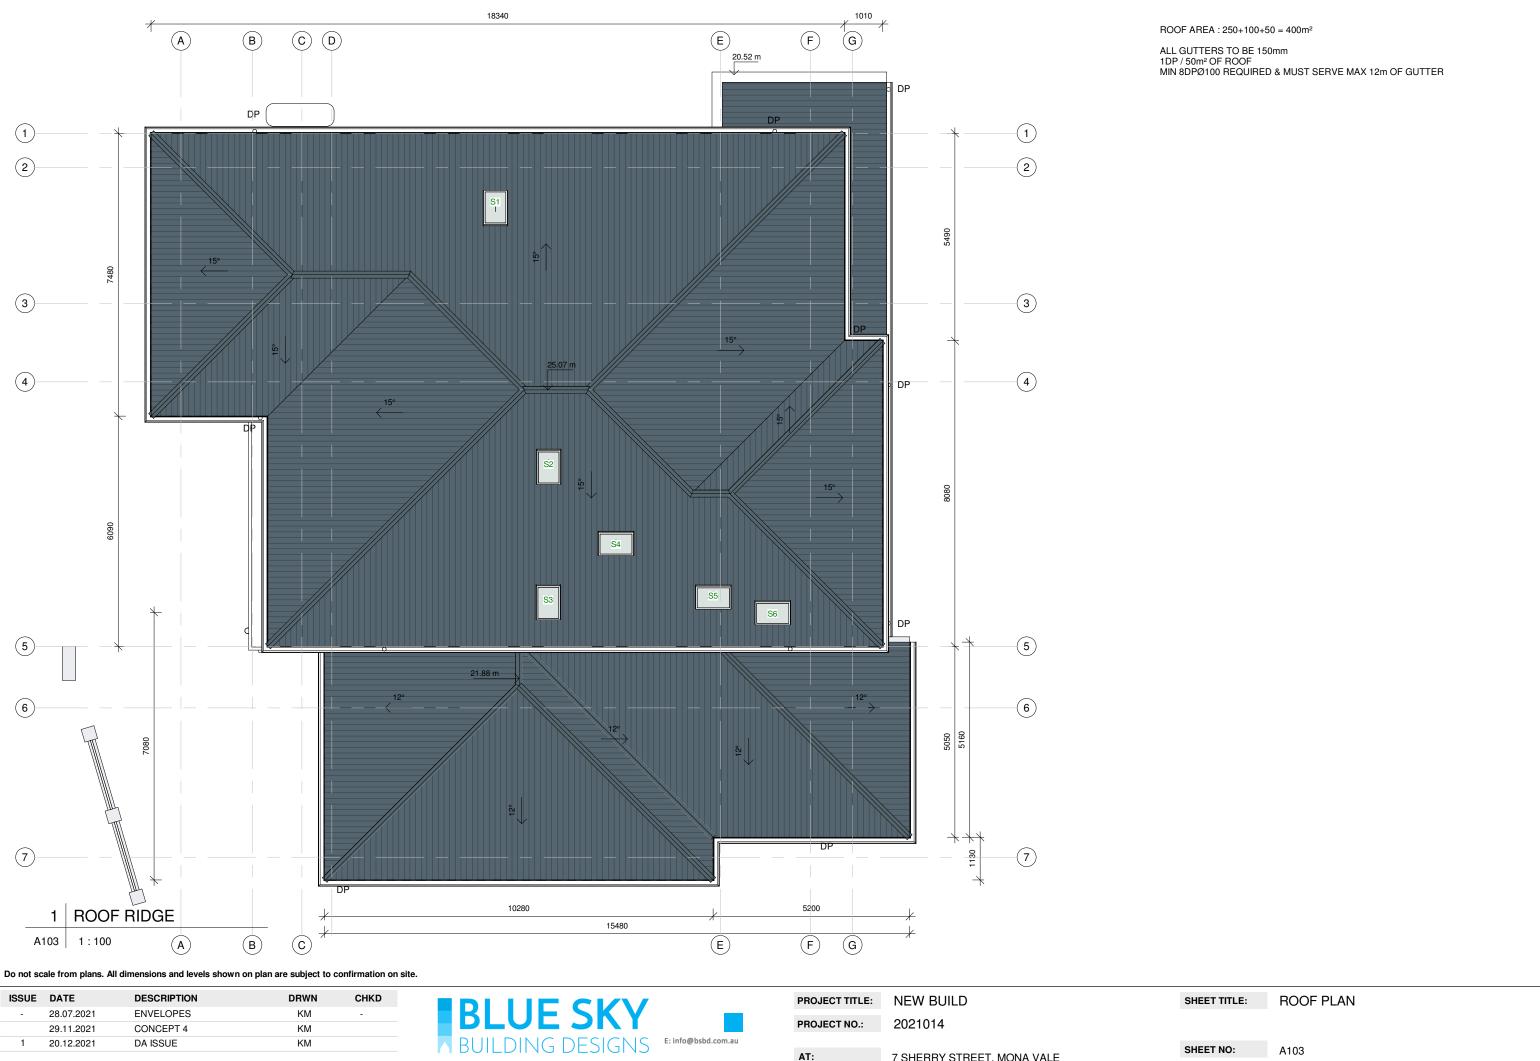



This drawing is copyright and remains the property of Blue Sky Building Designs P/L.

www.blueskybuildingdesigns.com.au

7 SHERRY STREET, MONA VALE FOR: REBECCA & ALEX GILLESPIE


SHEET NO: A103 SCALE A3:

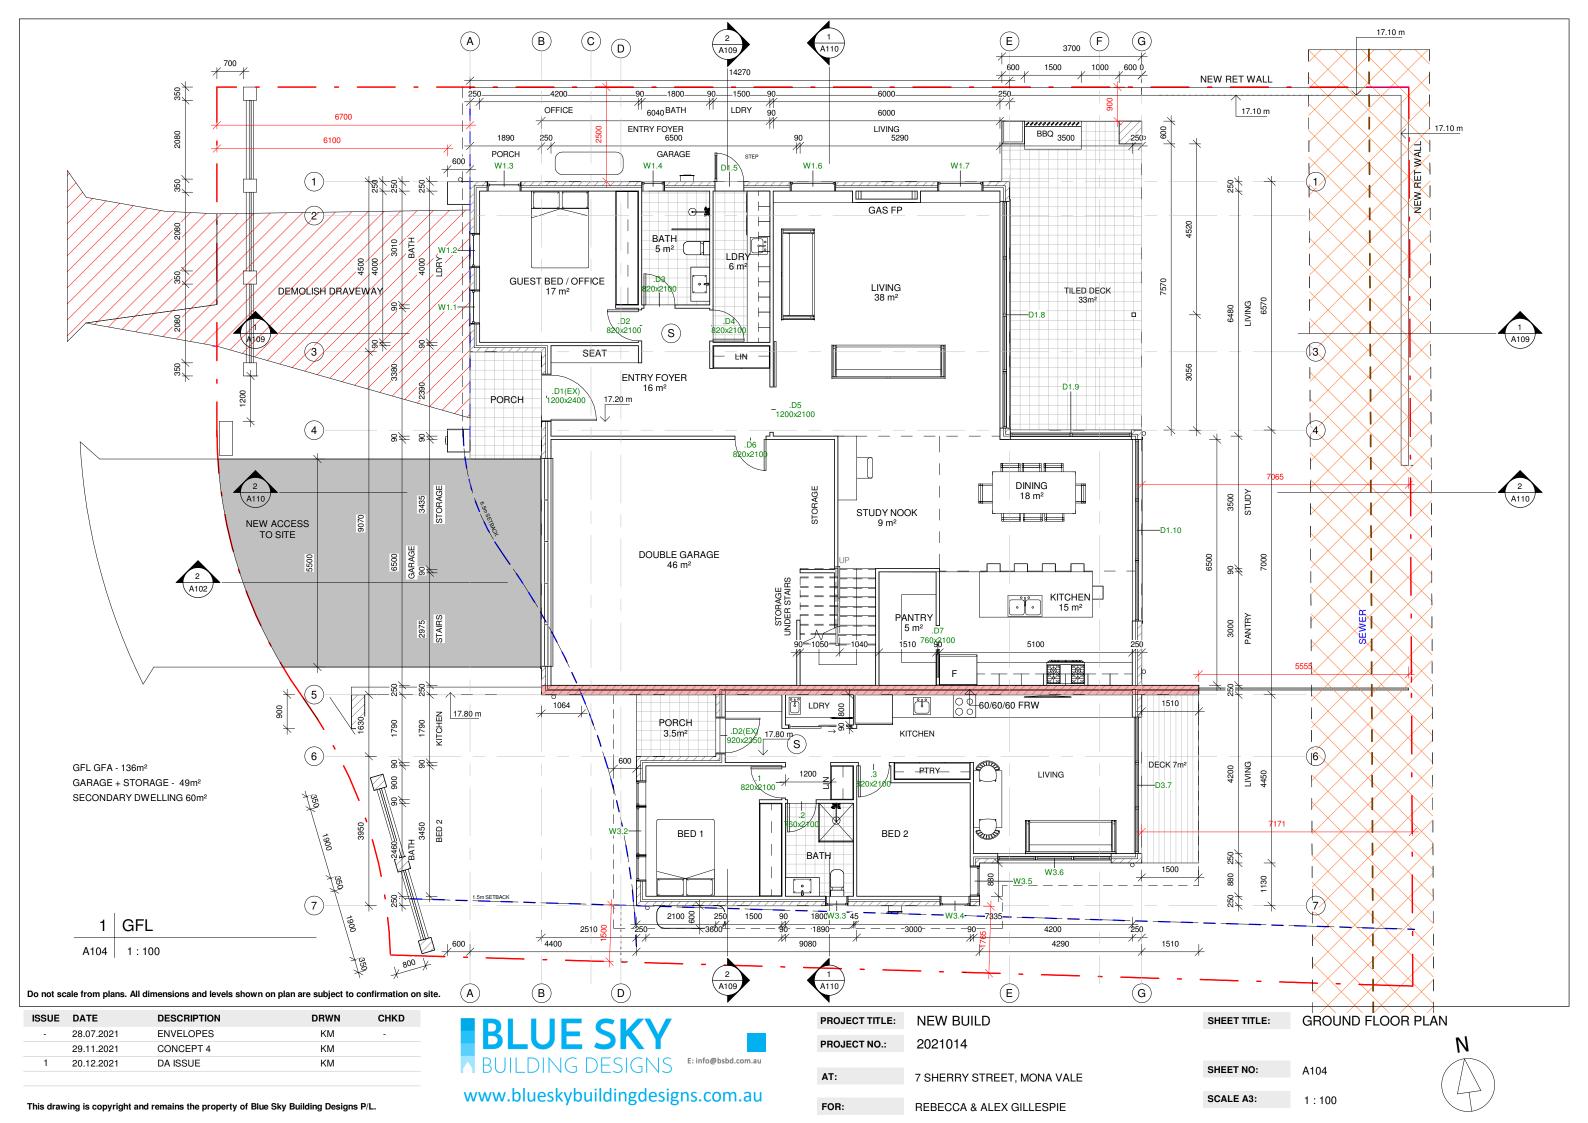

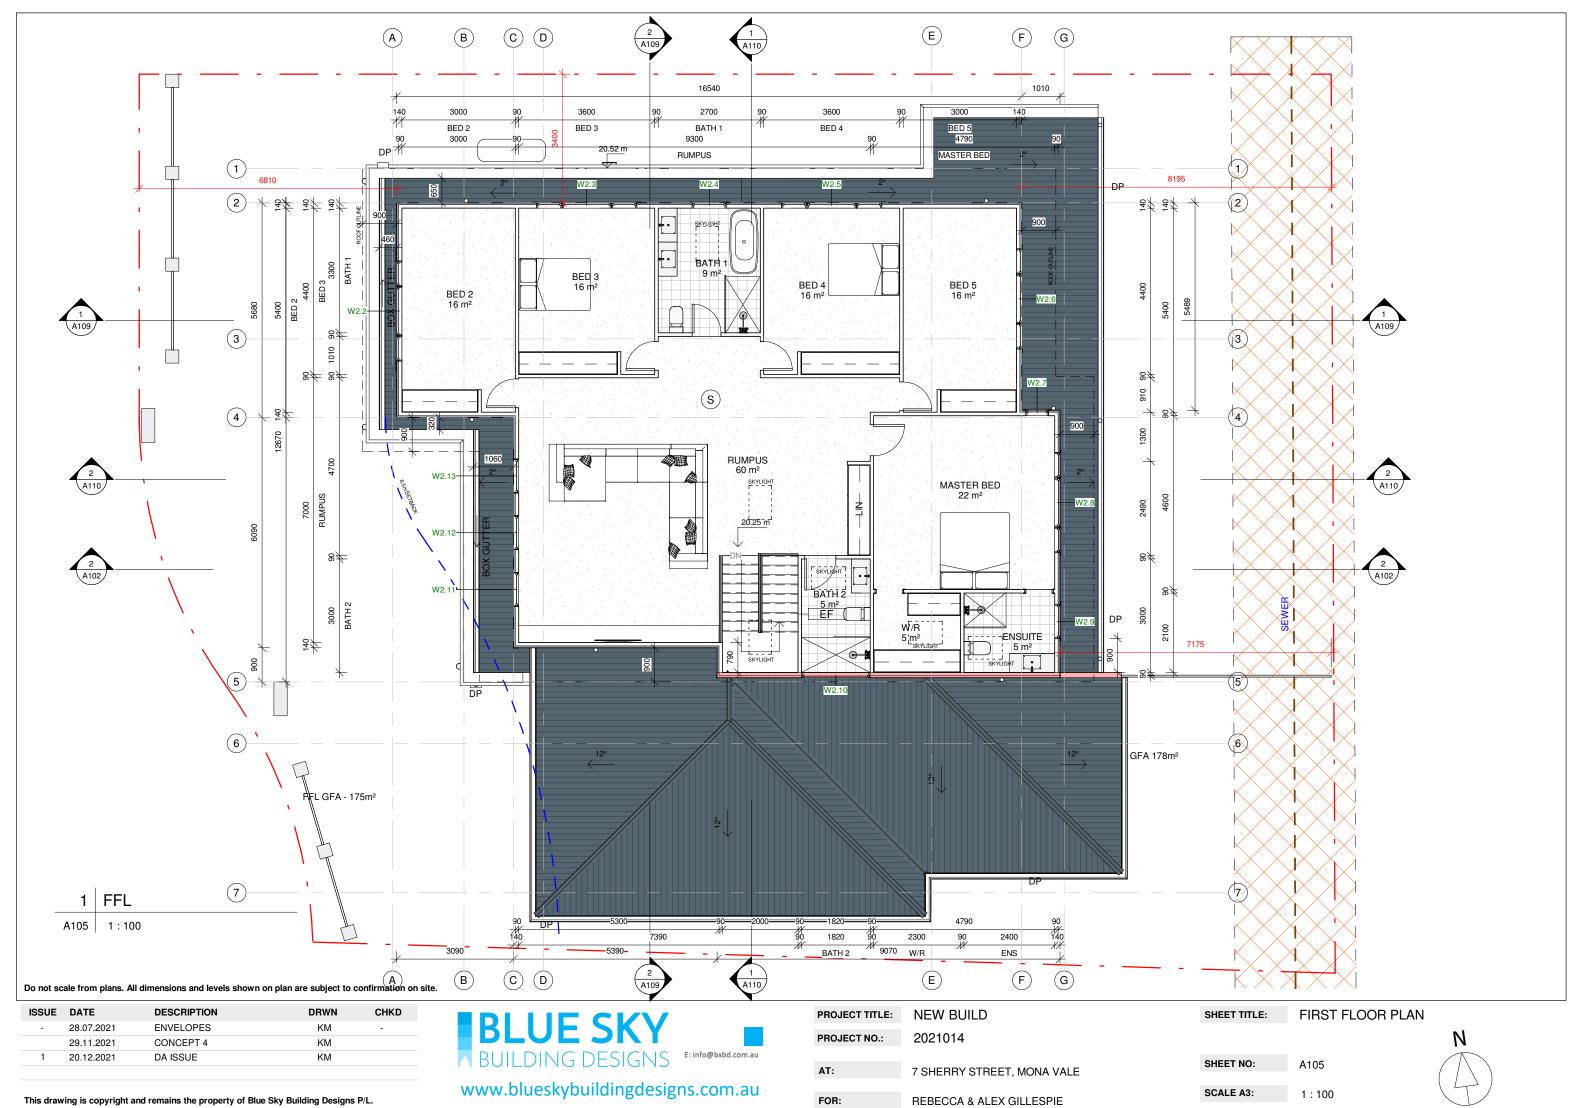

This drawing is copyright and remains the property of Blue Sky Building Designs P/L.



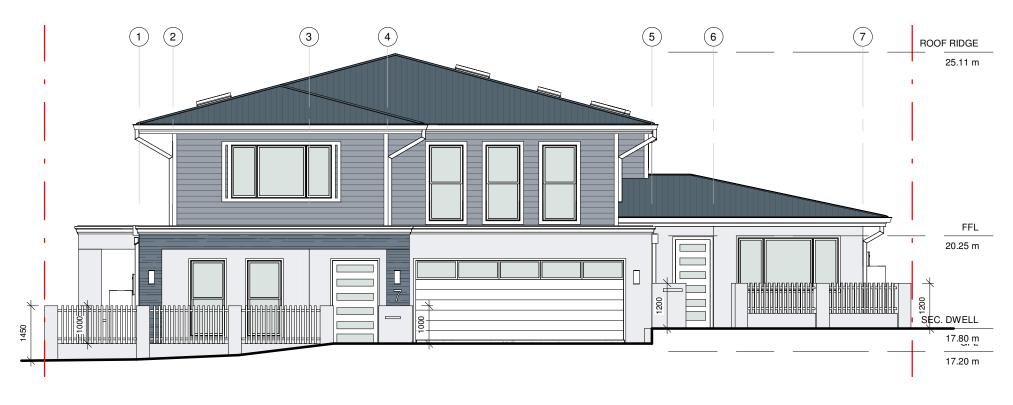

5 FRONT FENCE
A106 1:100

Do not scale from plans. All dimensions and levels shown on plan are subject to confirmation on site.

ISSUE	DATE	DESCRIPTION	DRWN	CHKD
-	28.07.2021	ENVELOPES	KM	-
	29.11.2021	CONCEPT 4	KM	
1	20.12.2021	DA ISSUE	KM	




PROJECT TITLE:	NEW BUILD
PROJECT NO.:	2021014
AT:	7 SHERRY STREET, MONA VALE
FOR:	REBECCA & ALEX GILLESPIE

SHEET TITLE: ELEVATIONS

SHEET NO: A106

SCALE A3: 1:100

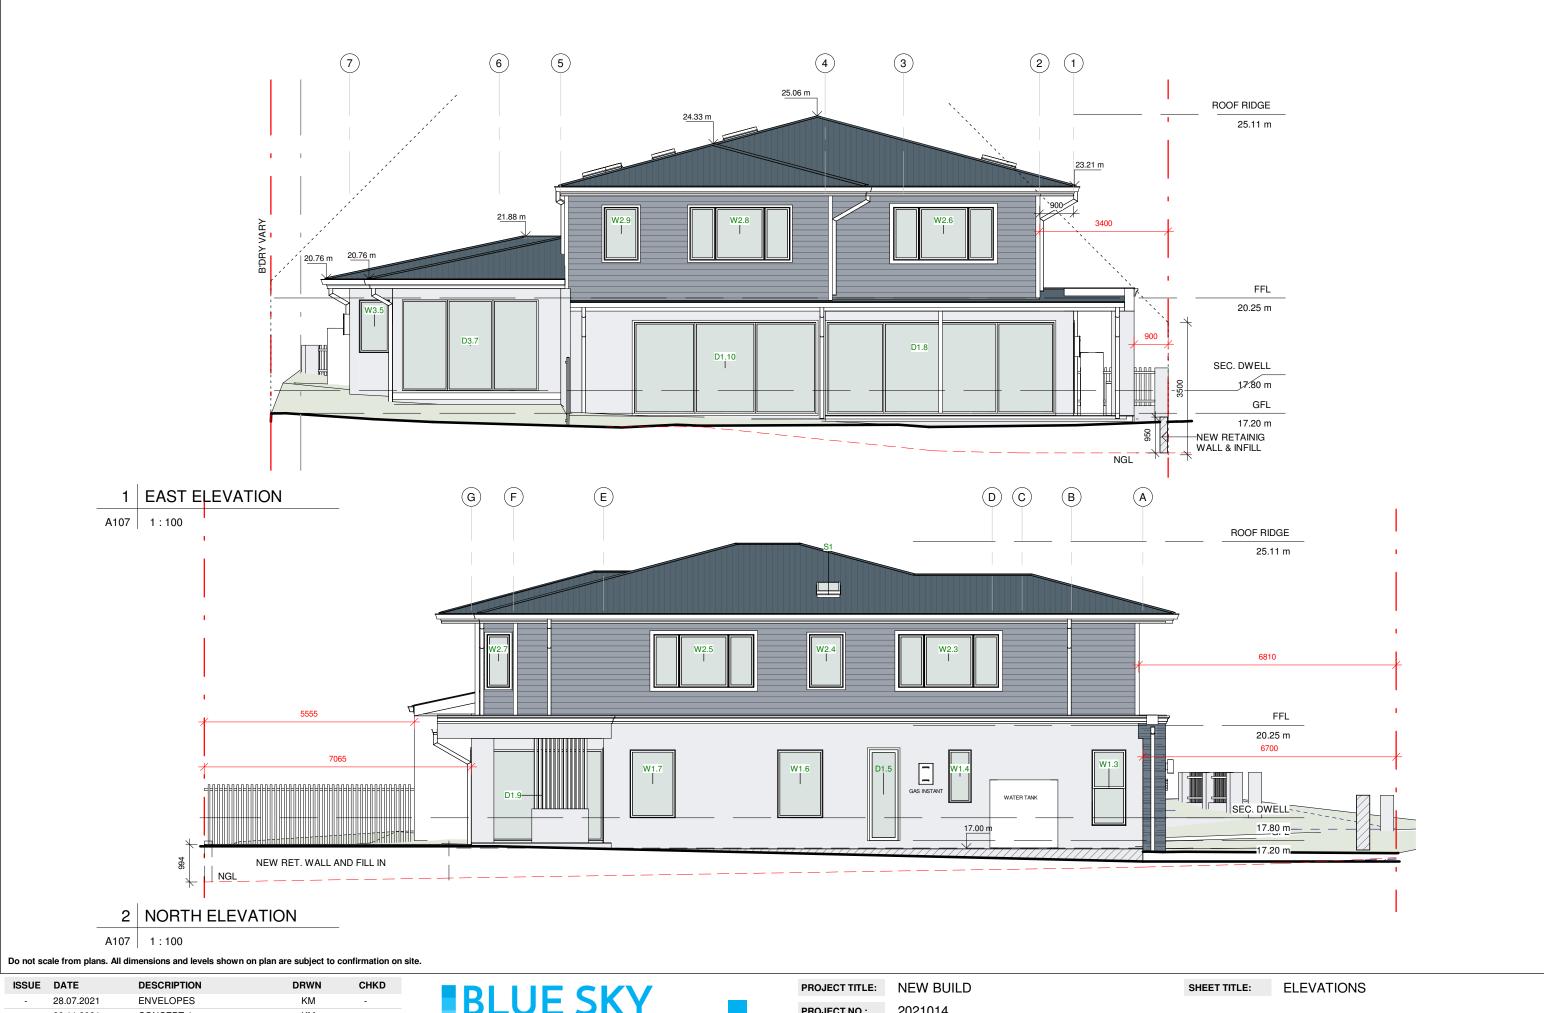

ISSUE	DATE	DESCRIPTION	DRWN	CHKD
-	28.07.2021	ENVELOPES	KM	-
	29.11.2021	CONCEPT 4	KM	
1	20.12.2021	DA ISSUE	KM	

BLUE SKY
BUILDING DESIGNS E: info@bsbd.com.au
www.blueskybuildingdesigns.com.au


PROJECT NO.: 2021014


AT: 7 SHERRY STREET, MONA VALE

FOR: REBECCA & ALEX GILLESPIE

SHEET NO: A107

SCALE A3: 1:100

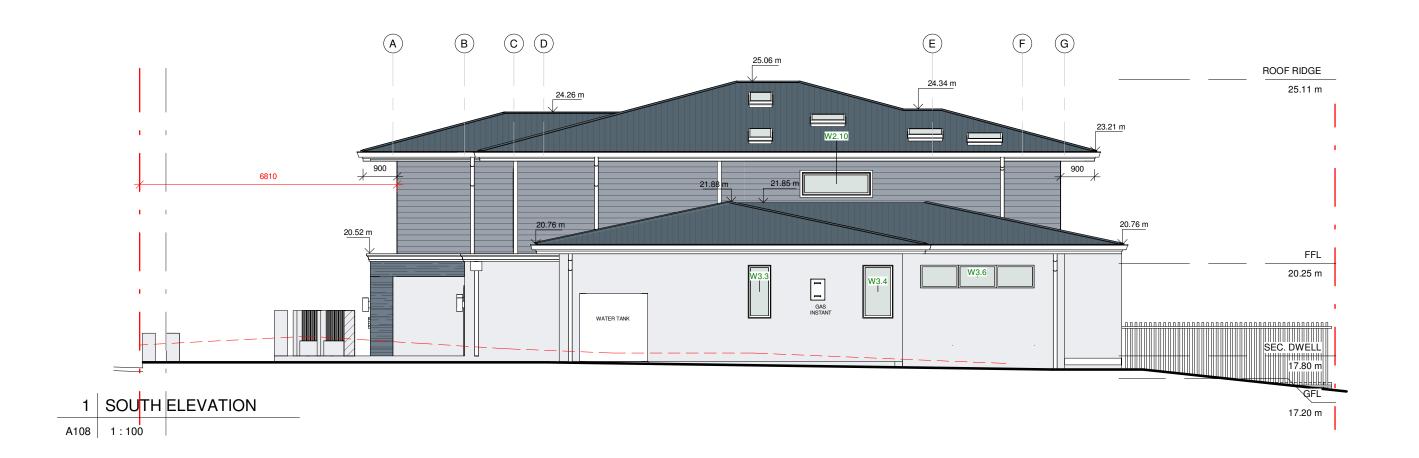

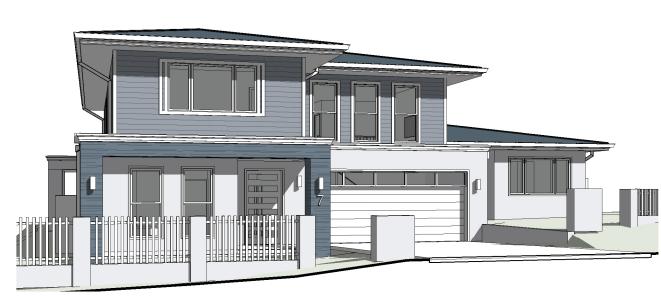

3 3D View 13

2 3D View 3

Do not scale from plans. All dimensions and levels shown on plan are subject to confirmation on site.


ISSUE	DATE	DESCRIPTION	DRWN	CHKD
-	28.07.2021	ENVELOPES	KM	-
	29.11.2021	CONCEPT 4	KM	
1	20.12.2021	DA ISSUE	KM	

BUILDING DESIGNS E: info@bsbd.com.au www.blueskybuildingdesigns.com.au

PROJECT TITLE:	NEW BUILD
PROJECT NO.:	2021014
AT:	7 SHERRY STREET, MONA VALE
FOR:	REBECCA & ALEX GILLESPIE

SHEET NO: A108

SCALE A3: 1:100

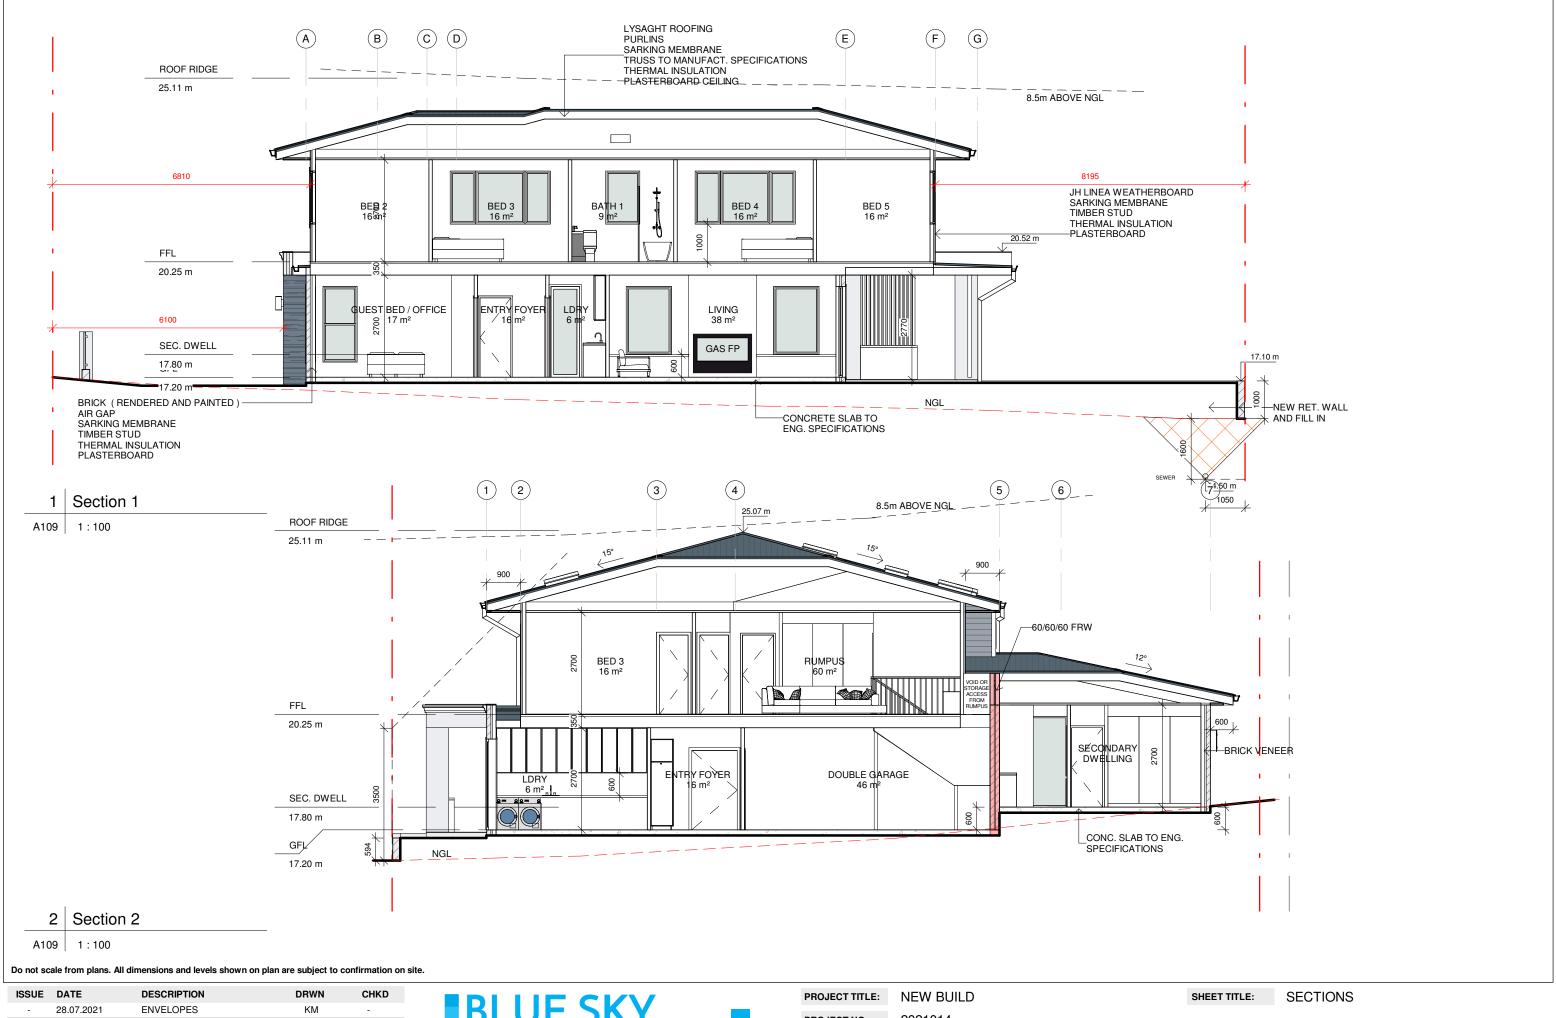

ISSUE	DATE	DESCRIPTION	DUMIN	CHRD
-	28.07.2021	ENVELOPES	KM	-
	29.11.2021	CONCEPT 4	KM	
1	20.12.2021	DA ISSUE	KM	

This drawing is copyright and remains the property of Blue Sky Building Designs $\mbox{P/L}.$

BUILDING DESIGNS E: info@bsbd.com.au www.blueskybuildingdesigns.com.au

PROJECT TITLE:	NEW BUILD	SHEET TITLE:	SECTIONS
PROJECT NO.:	2021014		
AT:	7 SHERRY STREET, MONA VALE	SHEET NO:	A109
FOR:	REBECCA & ALEX GILLESPIE	SCALE A3:	1:100



 ISSUE
 DATE
 DESCRIPTION
 DRWN
 CHKD

 28.07.2021
 ENVELOPES
 KM

 29.11.2021
 CONCEPT 4
 KM

 1
 20.12.2021
 DA ISSUE
 KM


This drawing is copyright and remains the property of Blue Sky Building Designs P/L.

BUILDING DESIGNS E: Info@bsbd.com.au www.blueskybuildingdesigns.com.au

PROJECT TITLE:	NEM BUILD
PROJECT NO.:	2021014
AT:	7 SHERRY STREET, MONA VALE
FOR:	REBECCA & ALEX GILLESPIE

SHEET NO: A110

SCALE A3: 1:100

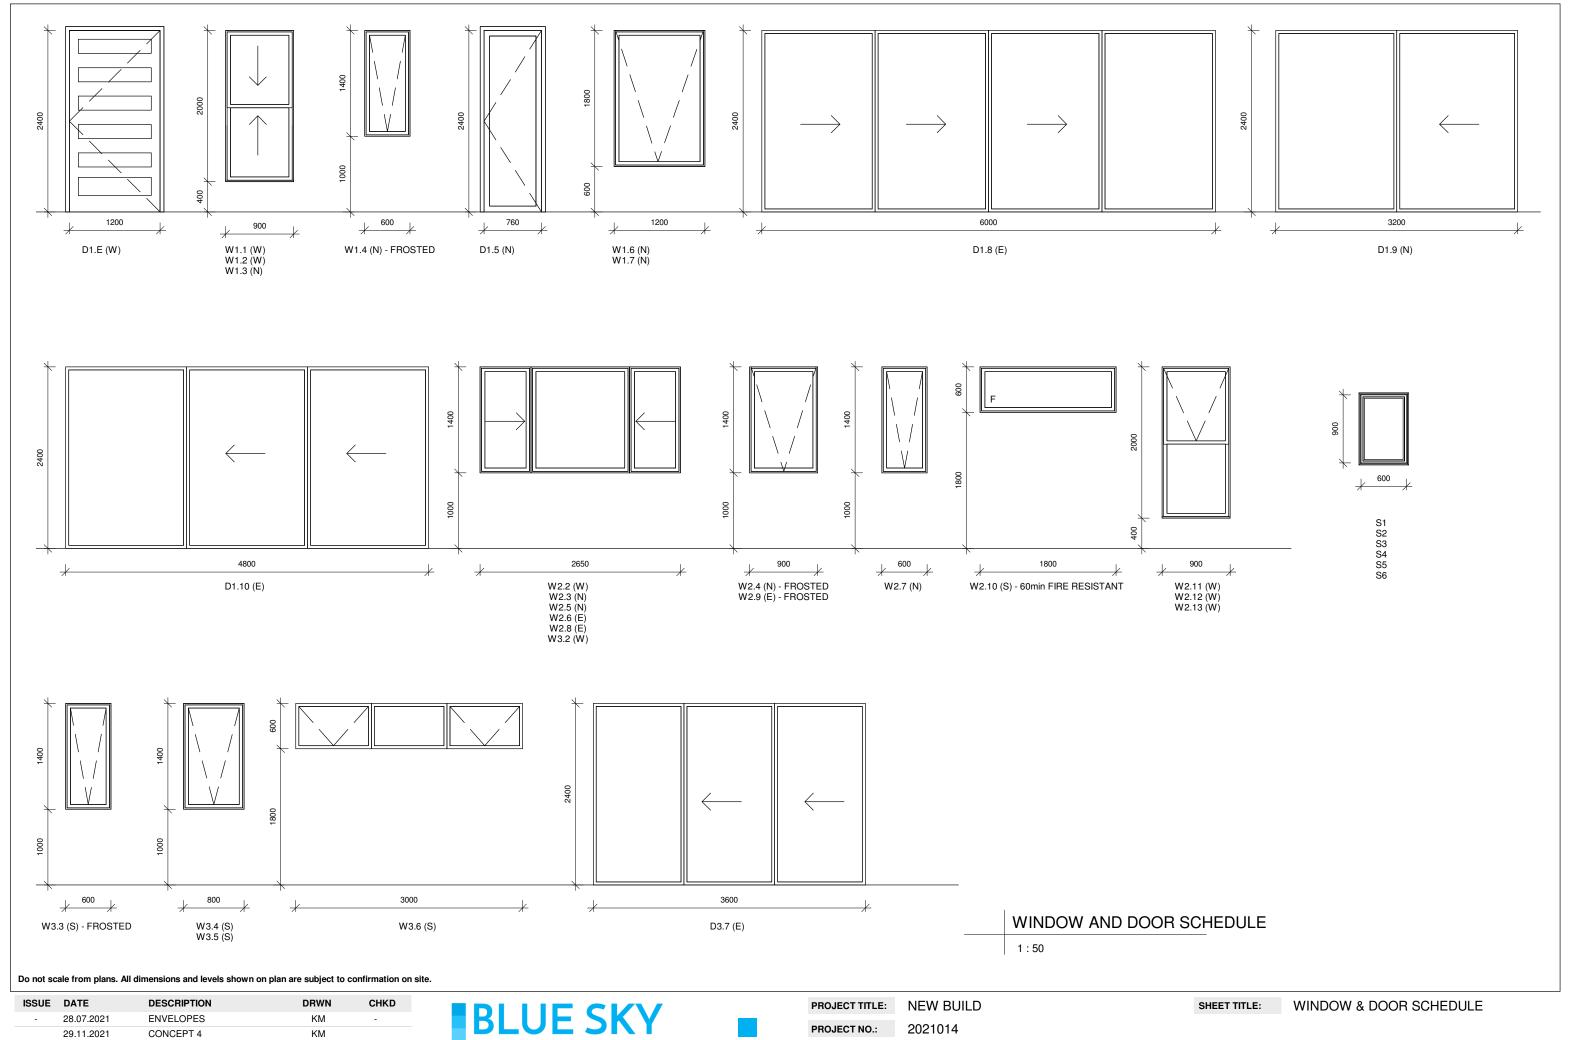

20.12.2021 DA ISSUE KM

This drawing is copyright and remains the property of Blue Sky Building Designs $\mbox{P/L}.$


7 SHERRY STREET, MONA VALE

REBECCA & ALEX GILLESPIE

FOR:

SHEET NO: A111 SCALE A3: 1:50

www.blueskybuildingdesigns.com.au

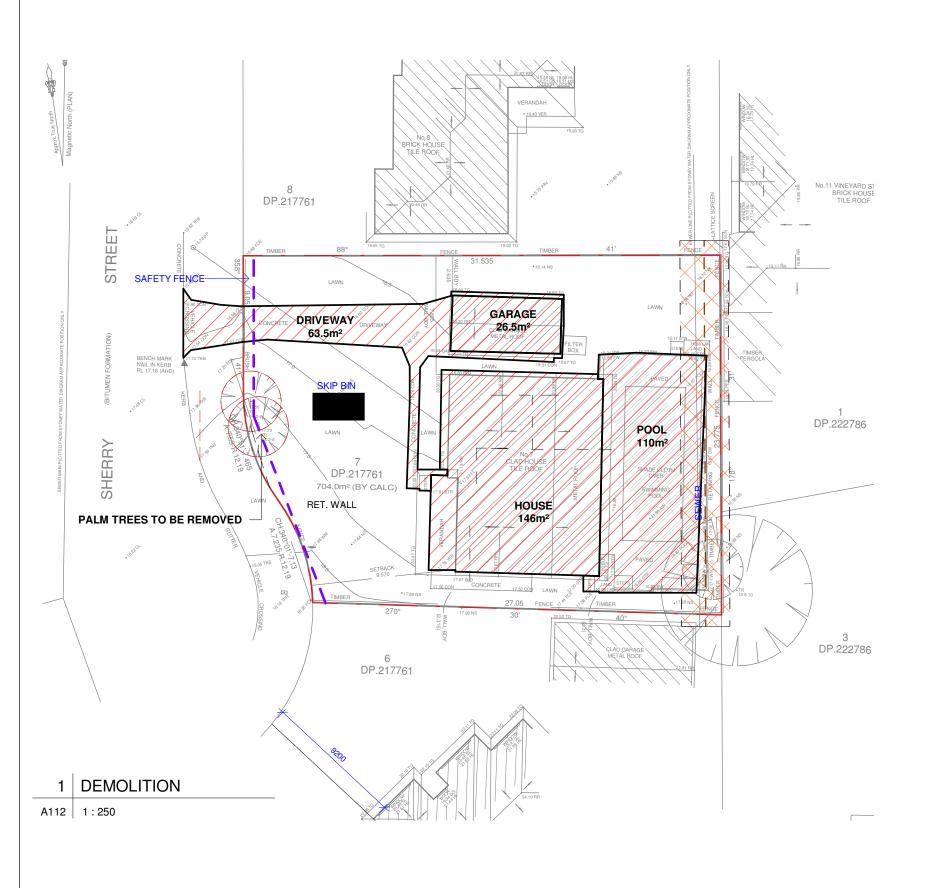

	WA	STE MANAGE	EMENT PLAN		
MATERIAL ON SITE			DESTINATION		
TYPE OF MATERIAL	ESTIMATED VOLUME		REUSE OR RECYCLING		DISPOSAL
	DEMOLITION	CONSTRUCTION	ON-SITE	OFF-SITE	
EXCAVATION MATERIAL	100m³		DISPOSED ON SITE (FILL IN)		
GREEN WASTE	30m³		DISPOSED ON SITE (FILL IN)		
BRICKS	5t			KIMBRIKI RECYCLE	
CONCRETE	3t			KIMBRIKI RECYCLE	
TIMBER	100m³	2m³		KIMBRIKI RECYCLE	
PLASTER BOARDS	50m³	1 m³			KIMBRIKI BY BUILDER
ASBESTOS	TBC PRIOR DEMO.				ASBESTOS REMOVALIST
ROOF TILES	5t				
METALS	10m³	0.1 m ³		KIMBRIKI RECYCLE	
GLASS	20m³			KIMBRIKI RECYCLE	
PLASTIC					
OTHERS	10m³	1m³			KIMBRIKI BY BUILDER

WASTE MANAGEMENT PLAN

CONTRACTORS WILL BE RESPONSIBLE FOR ENSURING:

- 1. Dedicated safe pedestrian access is, at all times, to be provided in front of the site.
- 2. Demolition and construction will be minimised and separation, reuse and recycling of materials will be maximised.
- 3. Demolition will be managed to ensure air and water borne pollutants such as, dust, odour, liquids and the like are minimised.
- 4. Demolition will be managed to minimise site disturbance to the surrounding

KEY ACTIONS :

- 1. Install Sediment Barrier on downslope side of property
- Stock pile demolition materials on level sections at rear and front of existing dwelling .Separate waste, from reuse and recycle materials
- 3. Clean and Clear footpath and roadway as required
- 4. Limit Disturbance when clearing
- 5. Wash Equipment in Designated area
- 6. Store all hard waste & litter in a designed area
- 7. Restrict vehicle movements and use the driveway only when possible.
- 8. Preserve as much grassed area as possible.

2 WASTE MANAGEMENT PLAN

A112 1:65

7 SHERRY STREET, MONA VALE

Do not scale from plans. All dimensions and levels shown on plan are subject to confirmation on site.

ISSUE	DATE	DESCRIPTION	DRWN	CHKD
-	28.07.2021	ENVELOPES	KM	-
	29.11.2021	CONCEPT 4	KM	
1	20.12.2021	DA ISSUE	KM	

BUILDING DESIGNS E: info@bsbd.com.au

PROJECT NO.: NEW BUILD 2021014

SHEET NO: A112

As indicated


DEMOLITION & WASTE MANAG.

SHEET TITLE:

SCALE A3:

www.blueskybuildingdesigns.com.au

FOR: REBECCA & ALEX GILLESPIE

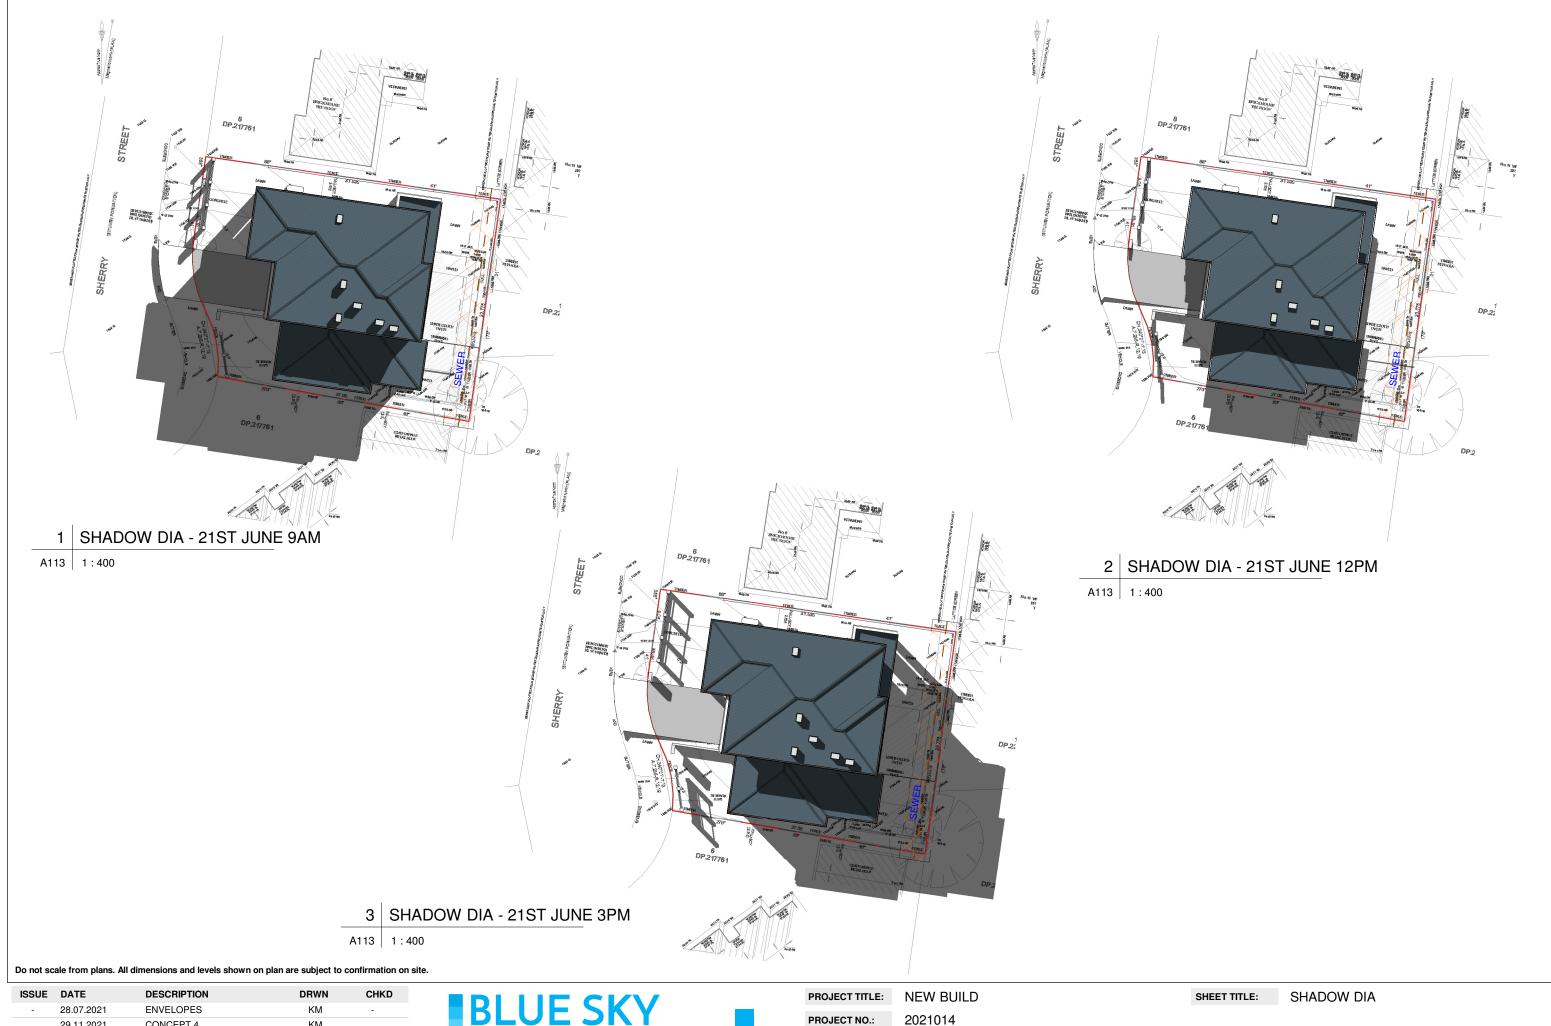

KM 29.11.2021 CONCEPT 4 20.12.2021 DA ISSUE

BLUE SKY
BUILDING DESIGNS www.blueskybuildingdesigns.com.au

FOR:

7 SHERRY STREET, MONA VALE REBECCA & ALEX GILLESPIE

SHEET NO: A113 SCALE A3:

1:400

This drawing is copyright and remains the property of Blue Sky Building Designs $\mbox{P/L}.$



Current Street View of property.



Aerial View of property



Proposed Dwelling Render by Blue Sky Building Designs

Drawing List

1	Cover Page
2	Plan Proposed New Dwelling Site F
2a	Concept
3	Plan-Softscape
4	Plan-Hardscape
5	Sections
6	Material Finish Schedule
7	Planting Plan
8	Plant Examples

Site Information

Site Location: 7 Sherry Street Mona Vale 2103 . NSW

Wind Region: A2

Climate Region: Warm Temperate Site Aspect: West Facing Block

Site topography: Sloping Block from South to North.

Site Information: The site is a sloping block from South to north. The proposed dwelling will consist of a main house and a Secondary wing along the southern boundary. These two seperate dwellings will be seperated

accordignyl with the use of Boundary fences and screening plants.

Planting schemes will be considered thoughtfully too match in with the Local council DCP and LEP and Take into

consideration the desires of the client.



py the Building Code of Australia and relevant Australian Standards. Designer is to be notified immediately of any discrepancies to

Landscaping and Design
5) All Site RLS are for Viewing purposes only. They must be read in conjuction with the Most recent site survey plan. All RLS will be adjusted as per the most recent site survey.


To Be Specified

All Elements of the plan that need structural engineer specifications must be sought prior to the commencement of any construction works. Engineer plans must be supplied to the contractor and all approval bodies. These are not engineer plans and do not specify any structural elements of the project. it is a Concept only.

Cover Page


Sherry Street.

7 Sherry Street Mona Vale NSW 2103

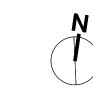

For Approval **SCALE**

OF 9

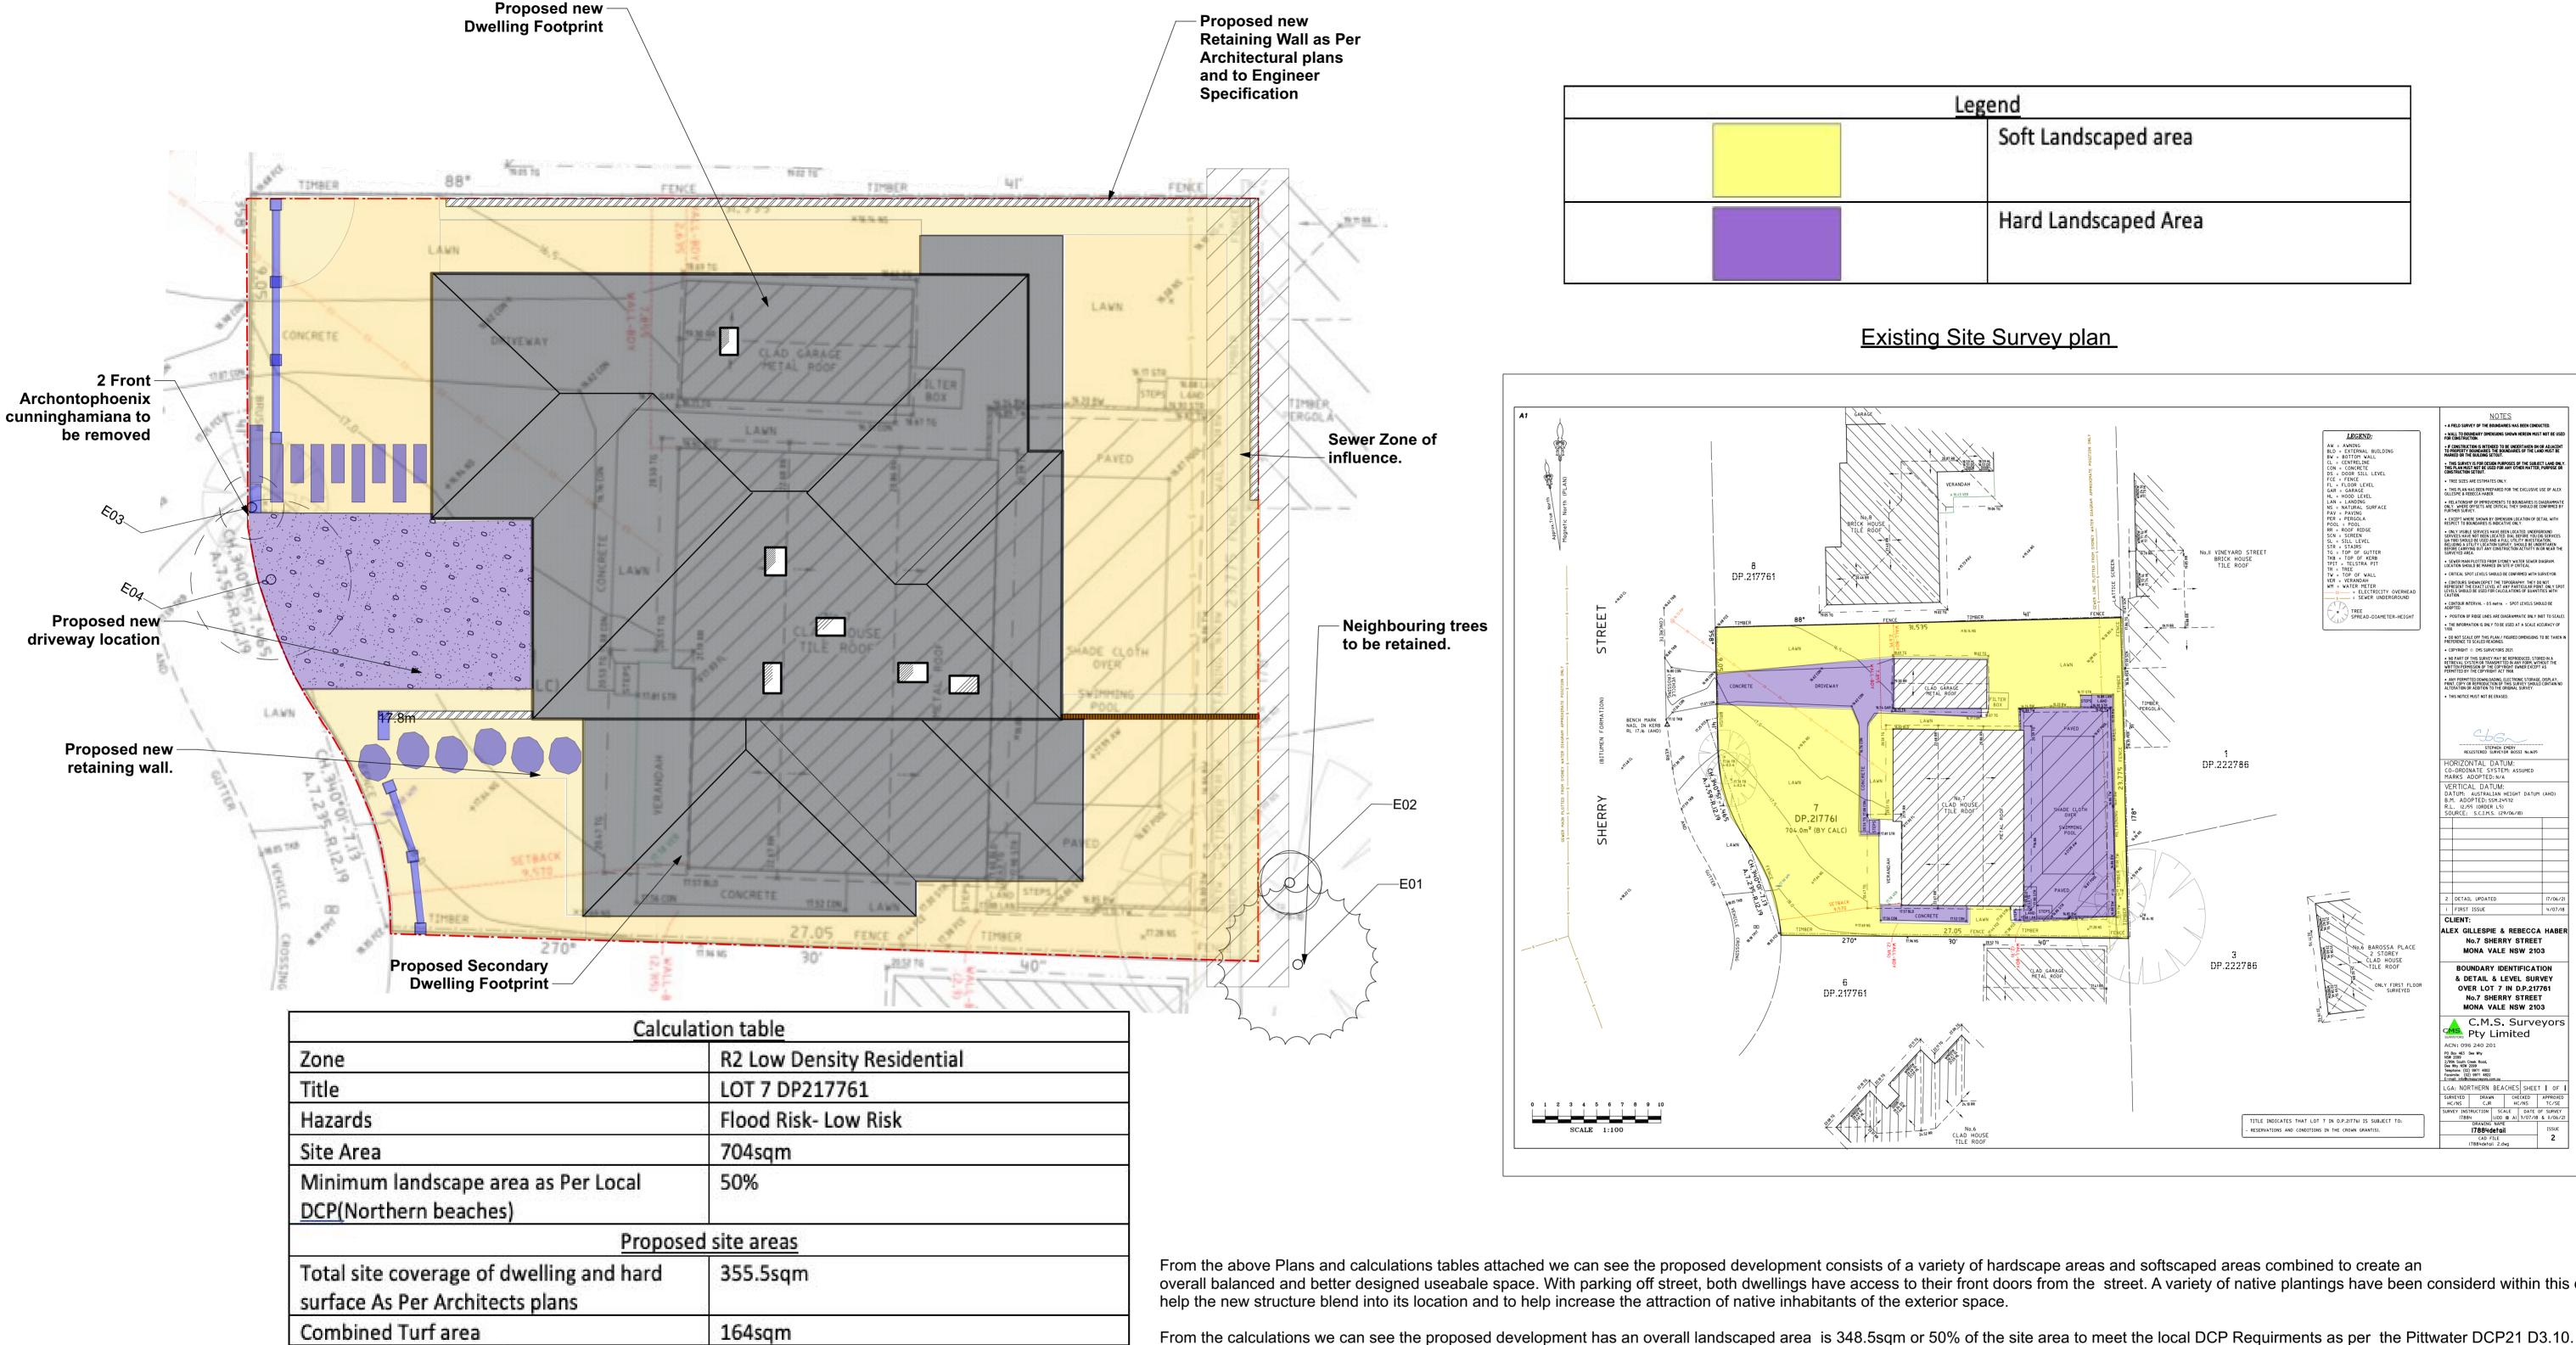

overall balanced and better designed useabale space. With parking off street, both dwellings have access to their front doors from the street. A variety of native plantings have been considerd within this design to

I see no adverse affects for this development and it will only enrich the natural integrity of the local area.

Actions for installation of Landscaped Area:

- 1. Install Sediment Barrier on Downward slope of site
- 2. Limit Disturbance during construction
- 3. Store materials on site, safely. 4. Store waste in designated areas
- 5. Reuse any fspoil created during construction onsite where possible
- 6. All works are to be installed by a licensed contractor
- 7. Keep road and front path Clear and clean of dirt at all times
- 8. Recycle materials where possible

For more information Refer to Waste management plan on Architectural drawings or local Council Guidelines.

blue sky

1) Do not scale from drawing, use marked dimensions and levels. To be read in conjunction with all consultants' documentation.

Blue Sky Landscaping and Designs. is to be immediately notified of any discrepancies.
2) Contractor to verify all dimensions, coordinate services and prior to commencement of site work or off-site fabrication and 3) All construction must be built to minimum requirement set outs by the Building Code of Australia and relevant Australian Standards. Designer is to be notified immediately of any discrepancies to Landscaping and Design
5) All Site RLS are for Viewing purposes only. They must be read in conjuction with the Most recent site survey plan. All RLS will be adjusted as per the most recent site survey.

Total Softscape Area

Combined Garden bed area

Combined Pebbled area

Total Softscape area

Total Hardscape Area

Total landscaped Area

Area as a Percentage in relation to DCP

Total Hardscape Coverage inc Pool

Dwelling and garage Site Coverage Approx

Structural Engineer: To Be Specified

Existing Site areas

86.5sgm

282.5sqm

348.5sqm

32sqm

66sqm

46sqm

38.5sqm


619.5sgm.

All Elements of the plan that need structural engineer specifications must be sought prior to the commencement of any construction works. Engineer plans must be supplied to the contractor and all approval bodies. These are not engineer plans and do not specify any structural elements of the project. it is a Concept only.

Plan Proposed New Dwelling Site Plan

Sherry Street.

7 Sherry Street Mona Vale NSW 2103

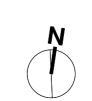


For Approval **SCALE** 1:100 A4 REDUCTION: 35.35%.

Rebecca Gillespie

2022/SY

OF 9

© 2021 Blue Sky Landscaping and Designs Blue Sky Landscaping and Designs This work is not to be copied or reproduced in any form without the prior written permission of the author. Noraville 2263 E:Rich@blueskylandscaping.co

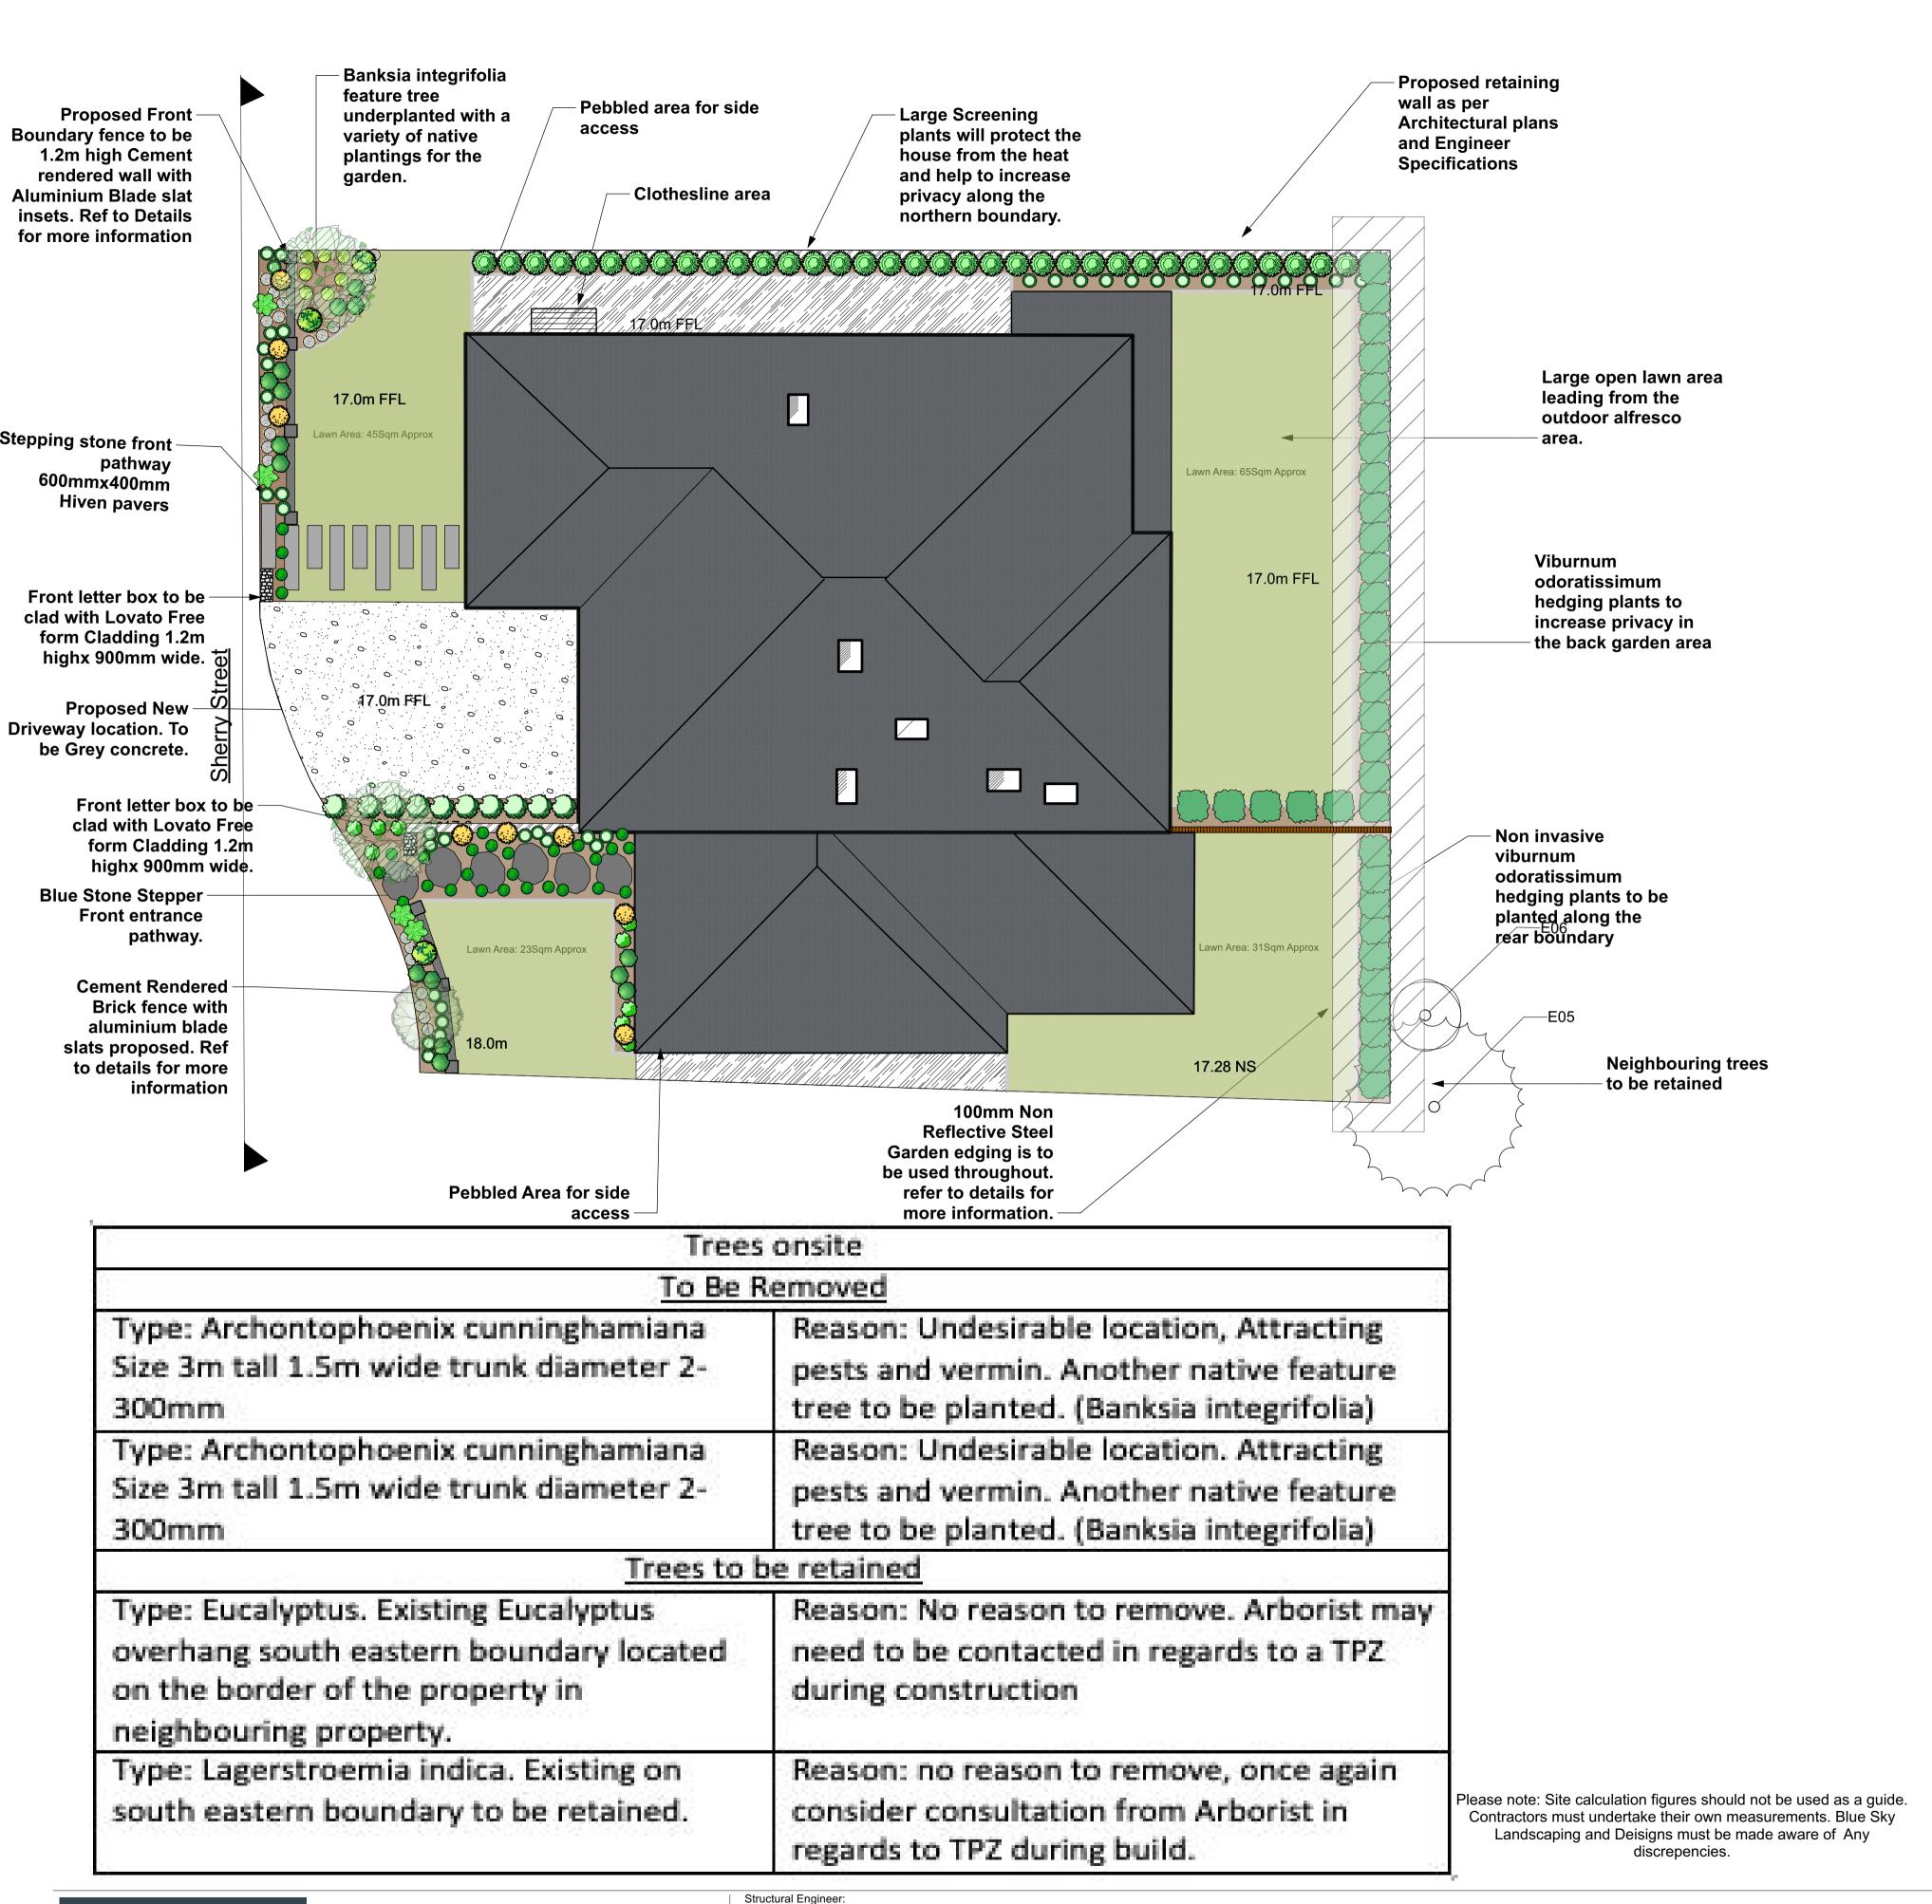

Legend		
Blue Stone Steppers		
Hiven 600400 paver		
Concrete Areas		
Feature stone walls		
Cement rendered walls		
100mm Steel Garden edging		
Garden bed areas		
Turf areas		
Tree to be retained		
Proposed retaining walls as Per engineers specifications. Material yet to be specified		
Sewer zone of influence.		
Pebbled areas		

· · · · · · · · · · · · · · · · · · ·	lation table
Zone	R2 Low Density Residential
Title	LOT 7 DP217761
Hazards	Flood Risk- Low Risk
Site Area	704sqm
Minimum landscape area as Per Local DCP(Northern beaches)	50%
Propos	ed site areas
Total site coverage of dwelling and hard surface As Per Architects plans	355.5sqm
Combined Turf area	164sqm
Combined Garden bed area	86.5sqm
Combined Pebbled area	32sqm
Total Softscape area	282.5sqm
Total Hardscape Area	66sqm
Total landscaped Area	348.5sqm
Area as a Percentage in relation to DCP	50%
Dwellin	g 1 site areas
Approx. site area	510.3sqm
Turf area	110sqm
Garden bed area	70sqm
Pebbled area	22sqm
Total Softscape area	202
Total hardscape area	59sqm
Total Landscaped area	261sqm
Area as a Percentage in relation to DCP	51%
Dwellin	g 2 Site areas
Approx. Site Area	193.7sqm
Turf area	54sqm
Garden bed area	16.5sqm
Pebbled area	10sqm
Total Softscape area	80.5sqm
Total hardscape area	7sqm
Total landscaped area	87.5sqm.
Area as a Percentage in relation to DCP	45%

blue sky

1) Do not scale from drawing, use marked dimensions and read in conjunction with all consultants' documentation Blue Sky Landscaping and Designs. is to be immediately notified Contractor to verify all dimensions, coordinate services and Building Code of Australia and relevant Australian Standards.

Copyright on this drawing and design retained by Blue Sky Landscaping and Design 5) All Site RLS are for Viewing purposes only. They must be read

n conjuction with the Most recent site survey plan. All RLS will

be adjusted as per the most recent site survey.

To Be Specified

All Elements of the plan that need structural engineer specifications must be sought prior to the commencement of any construction works. Engineer plans must be supplied to the contractor and all approval bodies. These are not engineer plans and do not specify any structural elements of the project. it is a Concept only.

Concept

Sherry Street.

7 Sherry Street Mona Vale NSW 2103

For Approval **SCALE** A4 REDUCTION: 35.35%.

Rebecca Gillespie

2a

OF 9


© 2021 Blue Sky Landscaping and Designs

This work is not to be copied or reproduced in any form without the prior written permission of the author.

Blue Sky Landscaping and Designs


Noraville 2263

T:0401653557

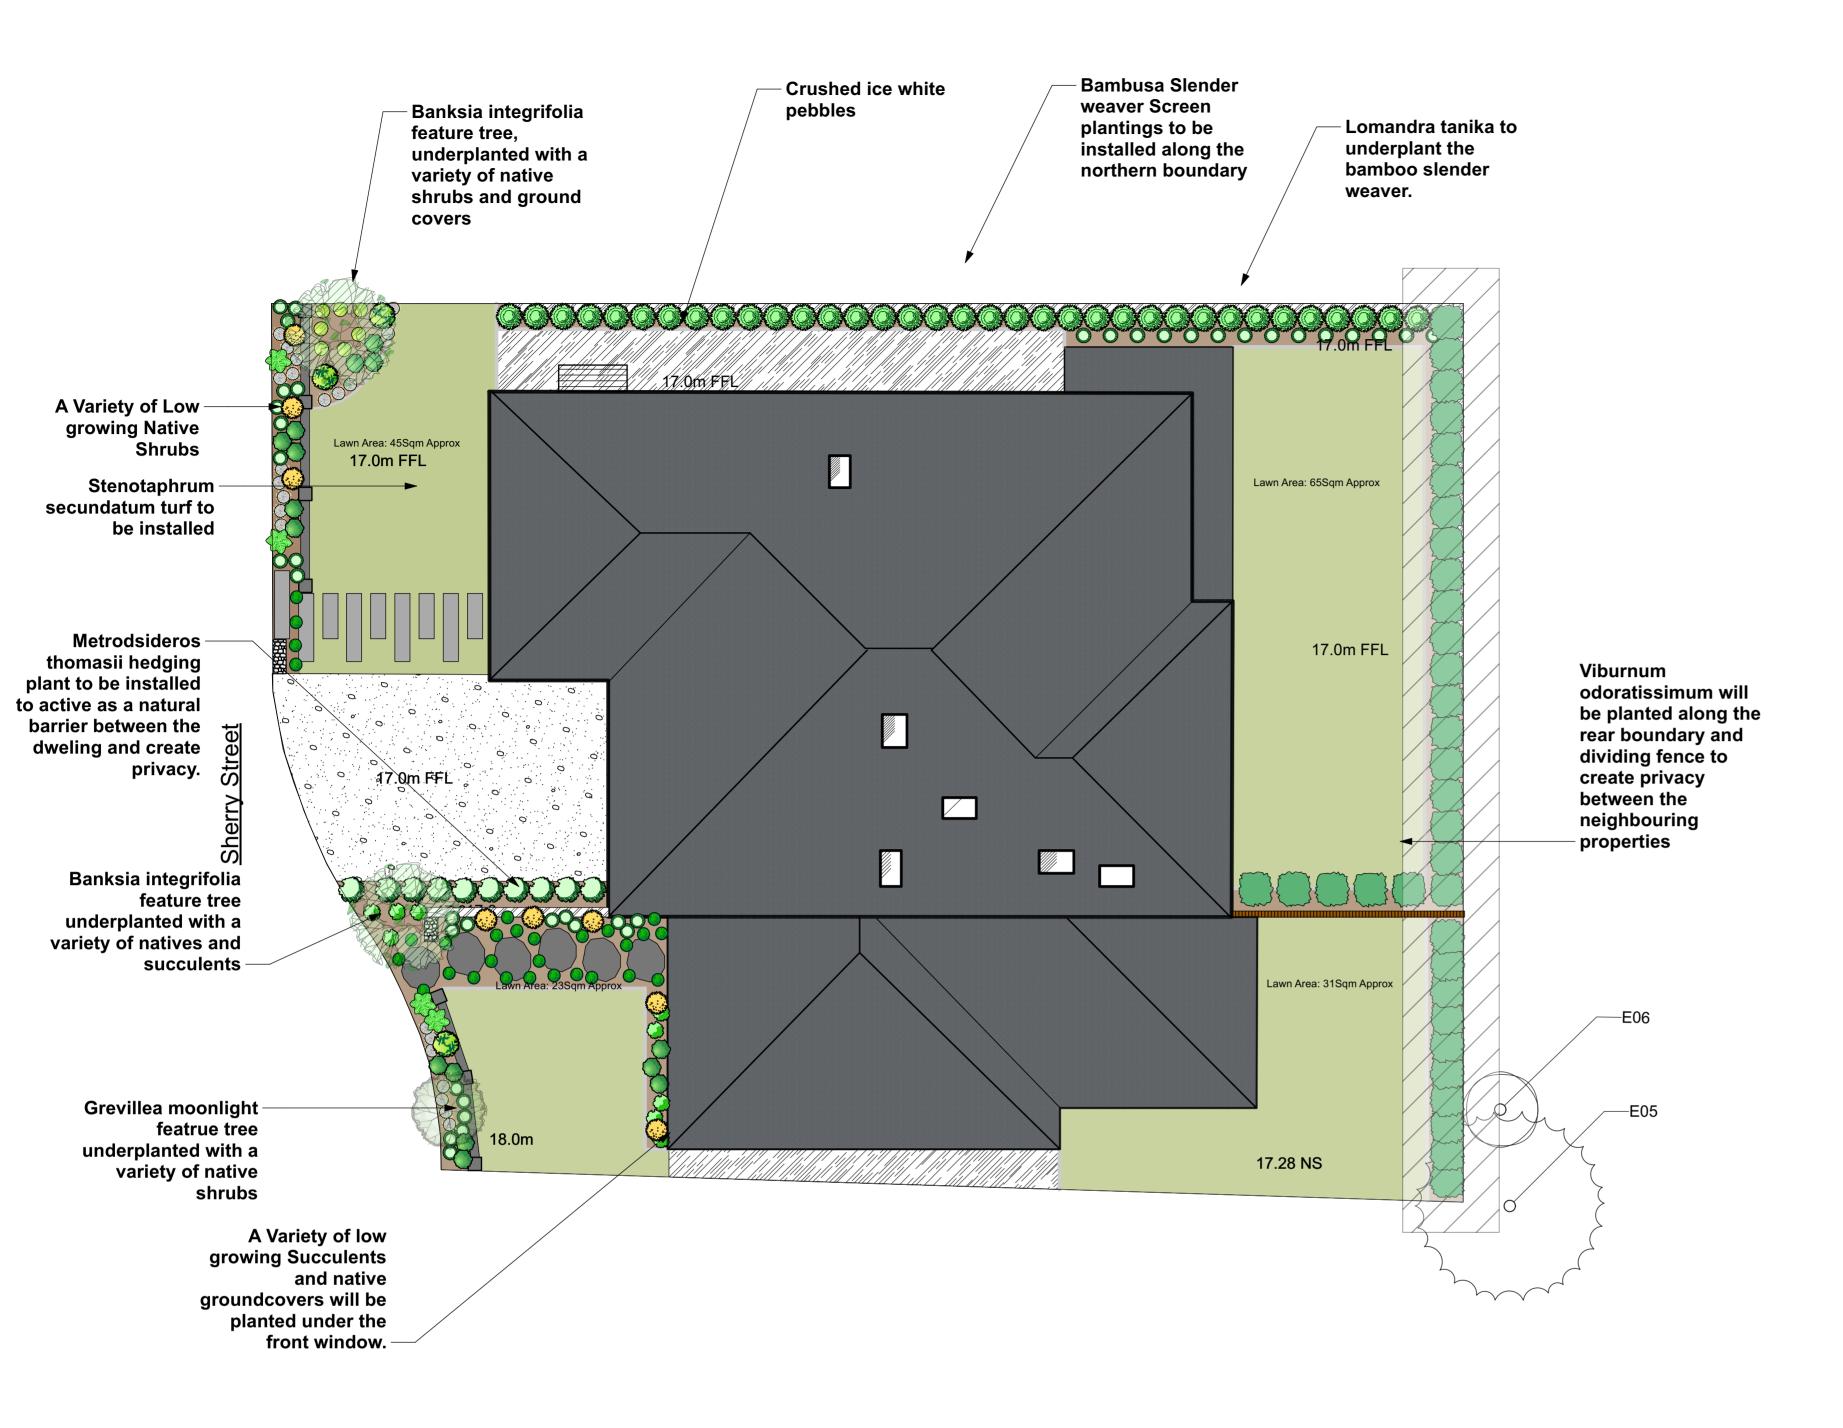

Please contact Blue sky landscaping and Designs immediately if any discrepncencies are noted.

If certain plants are not available seek alternatives reccomended by the supplier or call Blue sky landscaping to dsicuss other alternative plantings.

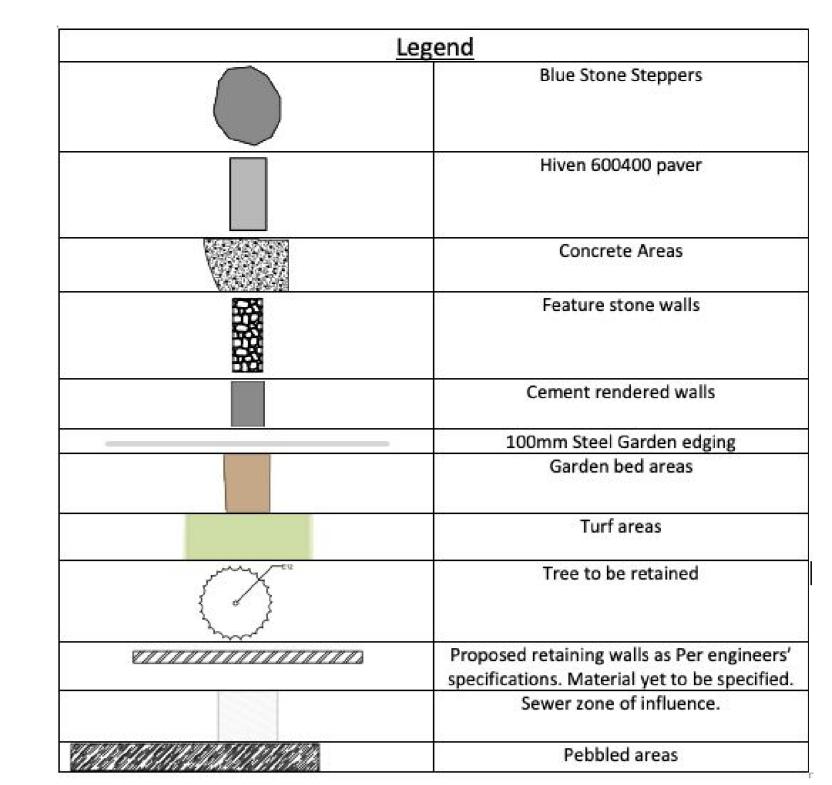

Plant Schedule

<u>Type</u>	Botanical	Common	Size	Quantity	Mature
200	Name	names			Size
Trees	300 300 3		ii ii	- 8	100
	Bambusa Slender weaver	Bamboo slender	300mm	32	4-8m
5	Banksia integrifolia	Coastal banksia	100ltr	2	4-8m
	Grevillea moon light	Grevillea moonlight	45ltr	1	3-4m
Shrubs	Contract Con	or to 1			and the state of
344	Agave attenuata	Agave	300mm	4	500mm 1m
	Banksia spinulosa	Candle sticks banksia	300mm	3	1-2m
	Kalanchoe copper spoons	Copper spoons	300mm	7	500mm
	Metrosideros excelsa	NZ Christmas bush	300mm	10	500mm
	Viburnum odoratissimum	Viburnum	200mm	34	1m
	Westringia fruticosa	Coastal rosemary	300mm	16	500mm
Ground cover/grasses					
	Carpobrotus	Pigface	140mm	10	1m-5m
	Lomandra tanika	Lomandra tanika	140mm	40	400mm
	Miscanthus sinensis	Chinese winter grass	200mm	7	500mm 1m
	Senecio mandraliscae	Chalksticks	140mm	25	500mm
	Zoysia tenuifolium	Zoysia no mow	140mm (if possible get the squares/tiles of it)	29	500mm

blue sky

1) Do not scale from drawing, use marked dimensions and levels. To be read in conjunction with all consultants' documentation.
Blue Sky Landscaping and Designs. is to be immediately notified 2) Contractor to verify all dimensions, coordinate services and prior to commencement of site work or off-site fabrication and 3) All construction must be built to minimum requirement set outs by the Building Code of Australia and relevant Australian Standards.

Copyright on this drawing and design retained by Blue Sky

Landscaping and Design
5) All Site RLS are for Viewing purposes only. They must be read in conjuction with the Most recent site survey plan. All RLS will be adjusted as per the most recent site survey.

Structural Engineer:

To Be Specified

All Elements of the plan that need structural engineer specifications must be sought prior to the commencement of any construction works. Engineer plans must be supplied to the contractor and all approval bodies. These are not engineer plans and do not specify any structural elements of the project. it is a Concept only.

Plan-Softscape

Sherry Street.

7 Sherry Street Mona Vale NSW 2103



Noraville 2263

For Approval SCALE 1:100 ORIGINAL DRAWING AT A1 SIZE. A4 REDUCTION: 35.35%.

2022/SY


Rebecca Gillespie


E:Rich@blueskylandscaping.co

© 2021 Blue Sky Landscaping and Designs This work is not to be copied or reproduced in any form without the prior written permission of the author. Blue Sky Landscaping and Designs

T:0401653557

OF 9

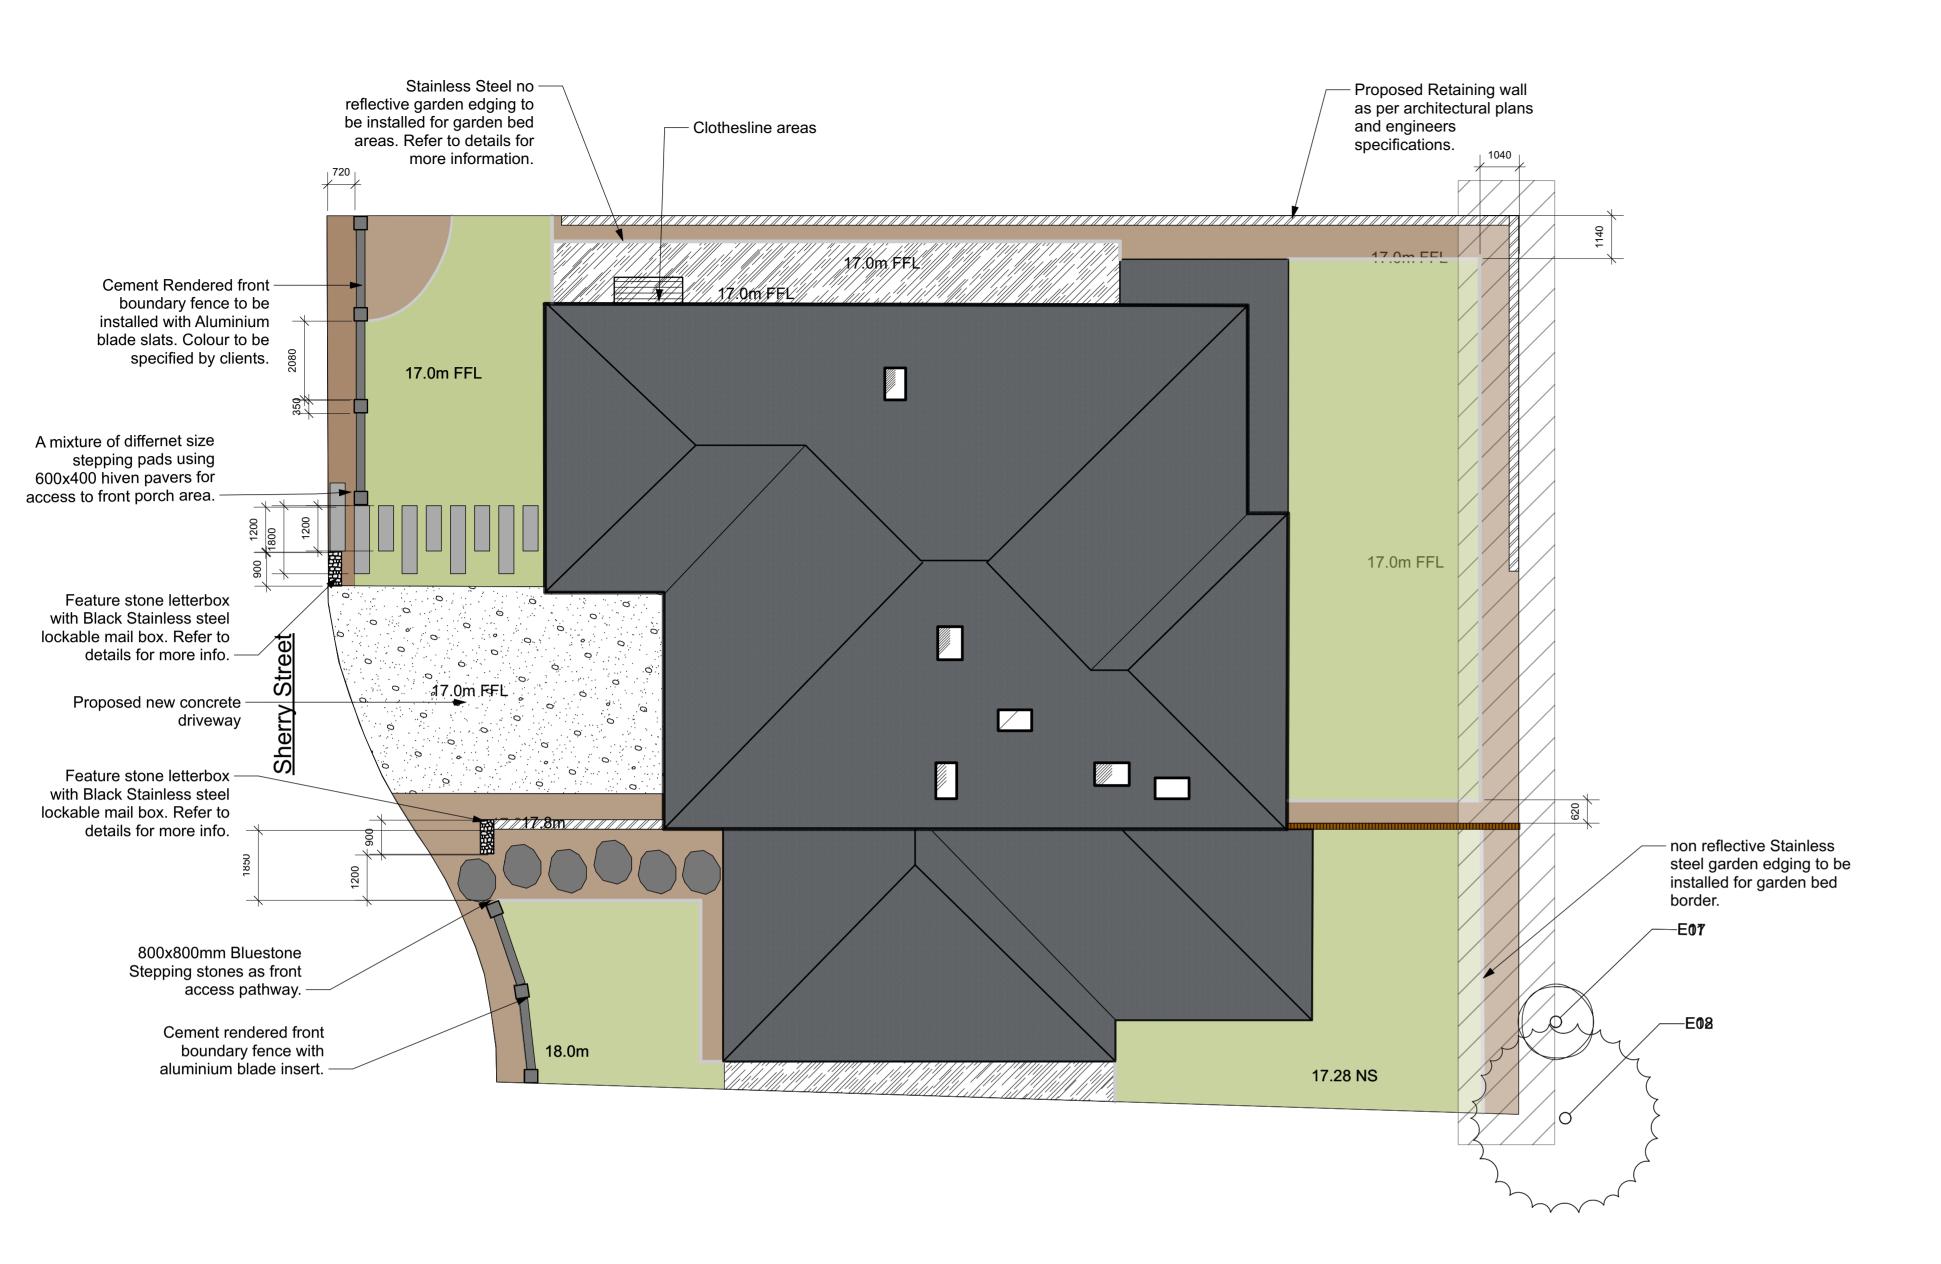

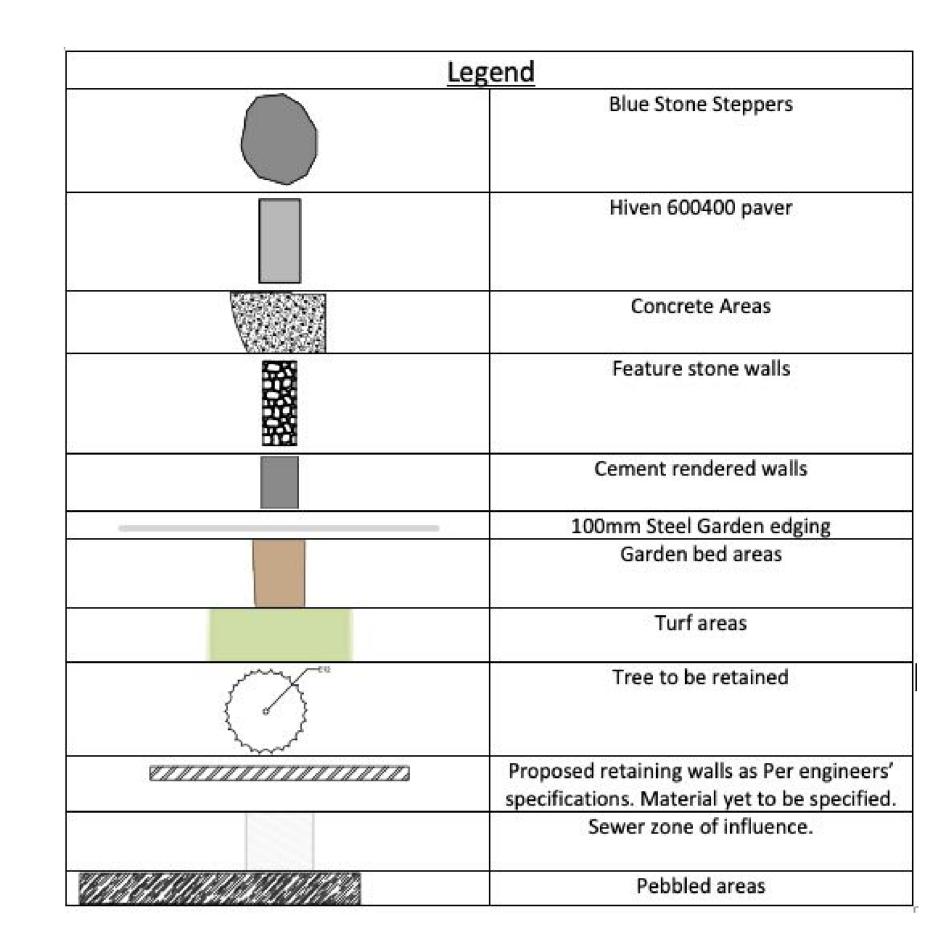

bue sky

1) Do not scale from drawing, use marked dimensions and levels. To be read in conjunction with all consultants' documentation.
Blue Sky Landscaping and Designs. is to be immediately notified of any discrepancies. of any discrepancies.
2) Contractor to verify all dimensions, coordinate services and components prior to commencement of site work or off-site fabrication and 3) All construction must be built to minimum requirement set outs by the Building Code of Australia and relevant Australian Standards. Designer is to be notified immediately of any discrepancies to 4) Copyright on this drawing and design retained by Blue Sky Landscaping and Design
5) All Site RLS are for Viewing purposes only. They must be read in conjuction with the Most recent site survey plan. All RLS will be adjusted as per the most recent site survey.

Structural Engineer: To Be Specified

All Elements of the plan that need structural engineer specifications must be sought prior to the commencement of any construction works. Engineer plans must be supplied


specify any structural elements of the project. it is a Concept only.

to the contractor and all approval bodies. These are not engineer plans and do not

Plan-Hardscape

Sherry Street.

7 Sherry Street Mona Vale NSW 2103

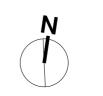

CAD File Name

For Approval SCALE 1:100 ORIGINAL DRAWING AT A1 SIZE. A4 REDUCTION: 35.35%. Drawn By Dwg Date:

T:0401653557

Rebecca Gillespie.

Project No. 2022/SY OF 9


E:Rich@blueskylandscaping.co

© 2021 Blue Sky Landscaping and Designs This work is not to be copied or reproduced in any form without the prior written permission of the author. Blue Sky Landscaping and Designs

Noraville 2263



Street Scape View. Westerly Elevation

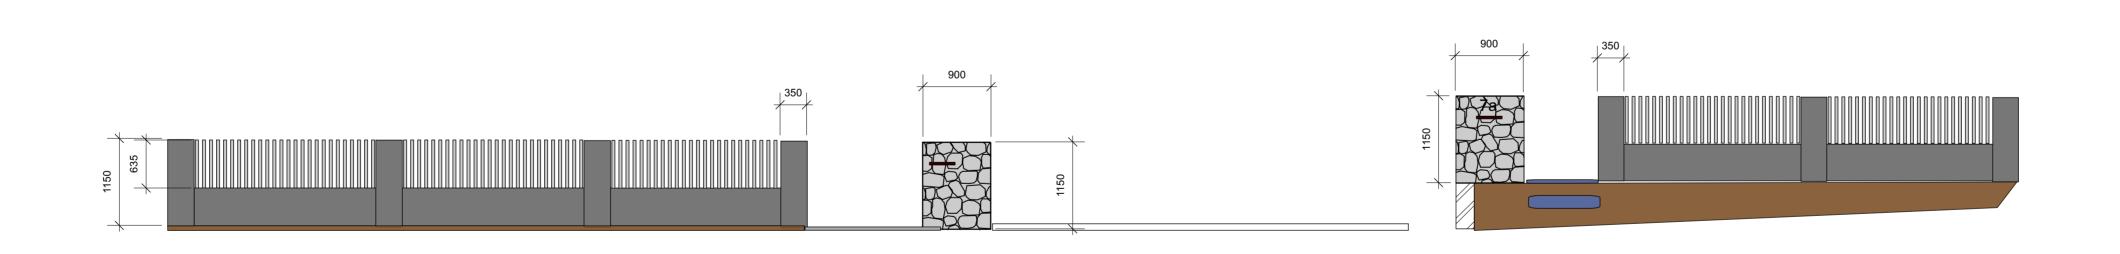

Front Boundary Fence



Notes:

1) Do not scale from drawing, use marked dimensions and levels. To be read in conjunction with all consultants' documentation. Blue Sky Landscaping and Designs. is to be immediately notified of any discrepancies.

2) Contractor to verify all dimensions, coordinate services and components prior to commencement of site work or off-site fabrication and installation.

3) All construction must be built to minimum requirement set outs by the Building Code of Australia and relevant Australian Standards. Designer is to be notified immediately of any discrepancies to the above, and confirmation sought.

4) Copyright on this drawing and design retained by Blue Sky Landscaping and Design

5) All Site RLS are for Viewing purposes only. They must be read in conjuction with the Most recent site survey plan. All RLS will be adjusted as per the most recent site survey.

Structural Engineer:


To Be Specified

All Elements of the plan that need structural engineer specifications must be sought prior to the commencement of any construction works. Engineer plans must be supplied to the contractor and all approval bodies. These are not engineer plans and do not specify any structural elements of the project. it is a Concept only.

Sherry Street.

Sections

7 Sherry Street Mona Vale NSW 2103

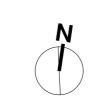

For Approval

SCALE

ORIGINAL DRAWING AT A1 SIZE.

Drawn By

RW

Dwg Date: 25/10/21

Checked By

EP

Plot Date:

Rebecca Gillespie.

T:0401653557

Project No.

2022/SYD31

Drawing No. Rev #

5

OF 9

© 2021 Blue Sky Landscaping and Designs

This work is not to be copied or reproduced in any form without the prior written permission of the author.







Hiven Paving 600x400x30mm. Supplier: Artisan Exterior



Supplier: ANL



Black mulch





Aluminium Blade Fence Supplier: MV Welding

Blue Stone Steppers
Supplier: ACM Landscape supplies



blue sky

Notes:
1) Do not scale from drawing, use marked dimensions and levels. To be read in conjunction with all consultants' documentation.
Blue Sky Landscaping and Designs. is to be immediately notified of any discrepancies.
2) Contractor to verify all dimensions, coordinate services and components prior to commencement of site work or off-site fabrication and installation.
3) All construction must be built to minimum requirement set outs by the

3) All construction must be built to minimum requirement set outs by the Building Code of Australia and relevant Australian Standards. Designer is to be notified immediately of any discrepancies to the above, and confirmation sought.

4) Copyright on this drawing and design retained by Blue Sky Landscaping and Design

5) All Site RLS are for Viewing purposes only. They must be read in conjuction with the Most recent site survey plan. All RLS will be adjusted as per the most recent site survey.

Structural Engineer: To Be Specified

All Elements of the plan that need structural engineer specifications must be sought prior to the commencement of any construction works. Engineer plans must be supplied to the contractor and all approval bodies. These are not engineer plans and do not specify any structural elements of the project. it is a Concept only.

Material Finish Schedule

Sherry Street.

7 Sherry Street Mona Vale NSW 2103



For Approval SCALE A4 REDUCTION: 35.35%.


T:0401653557


Rebecca Gillespie. Mona Vale .vwx

1:100

2022/SYD31

OF 9

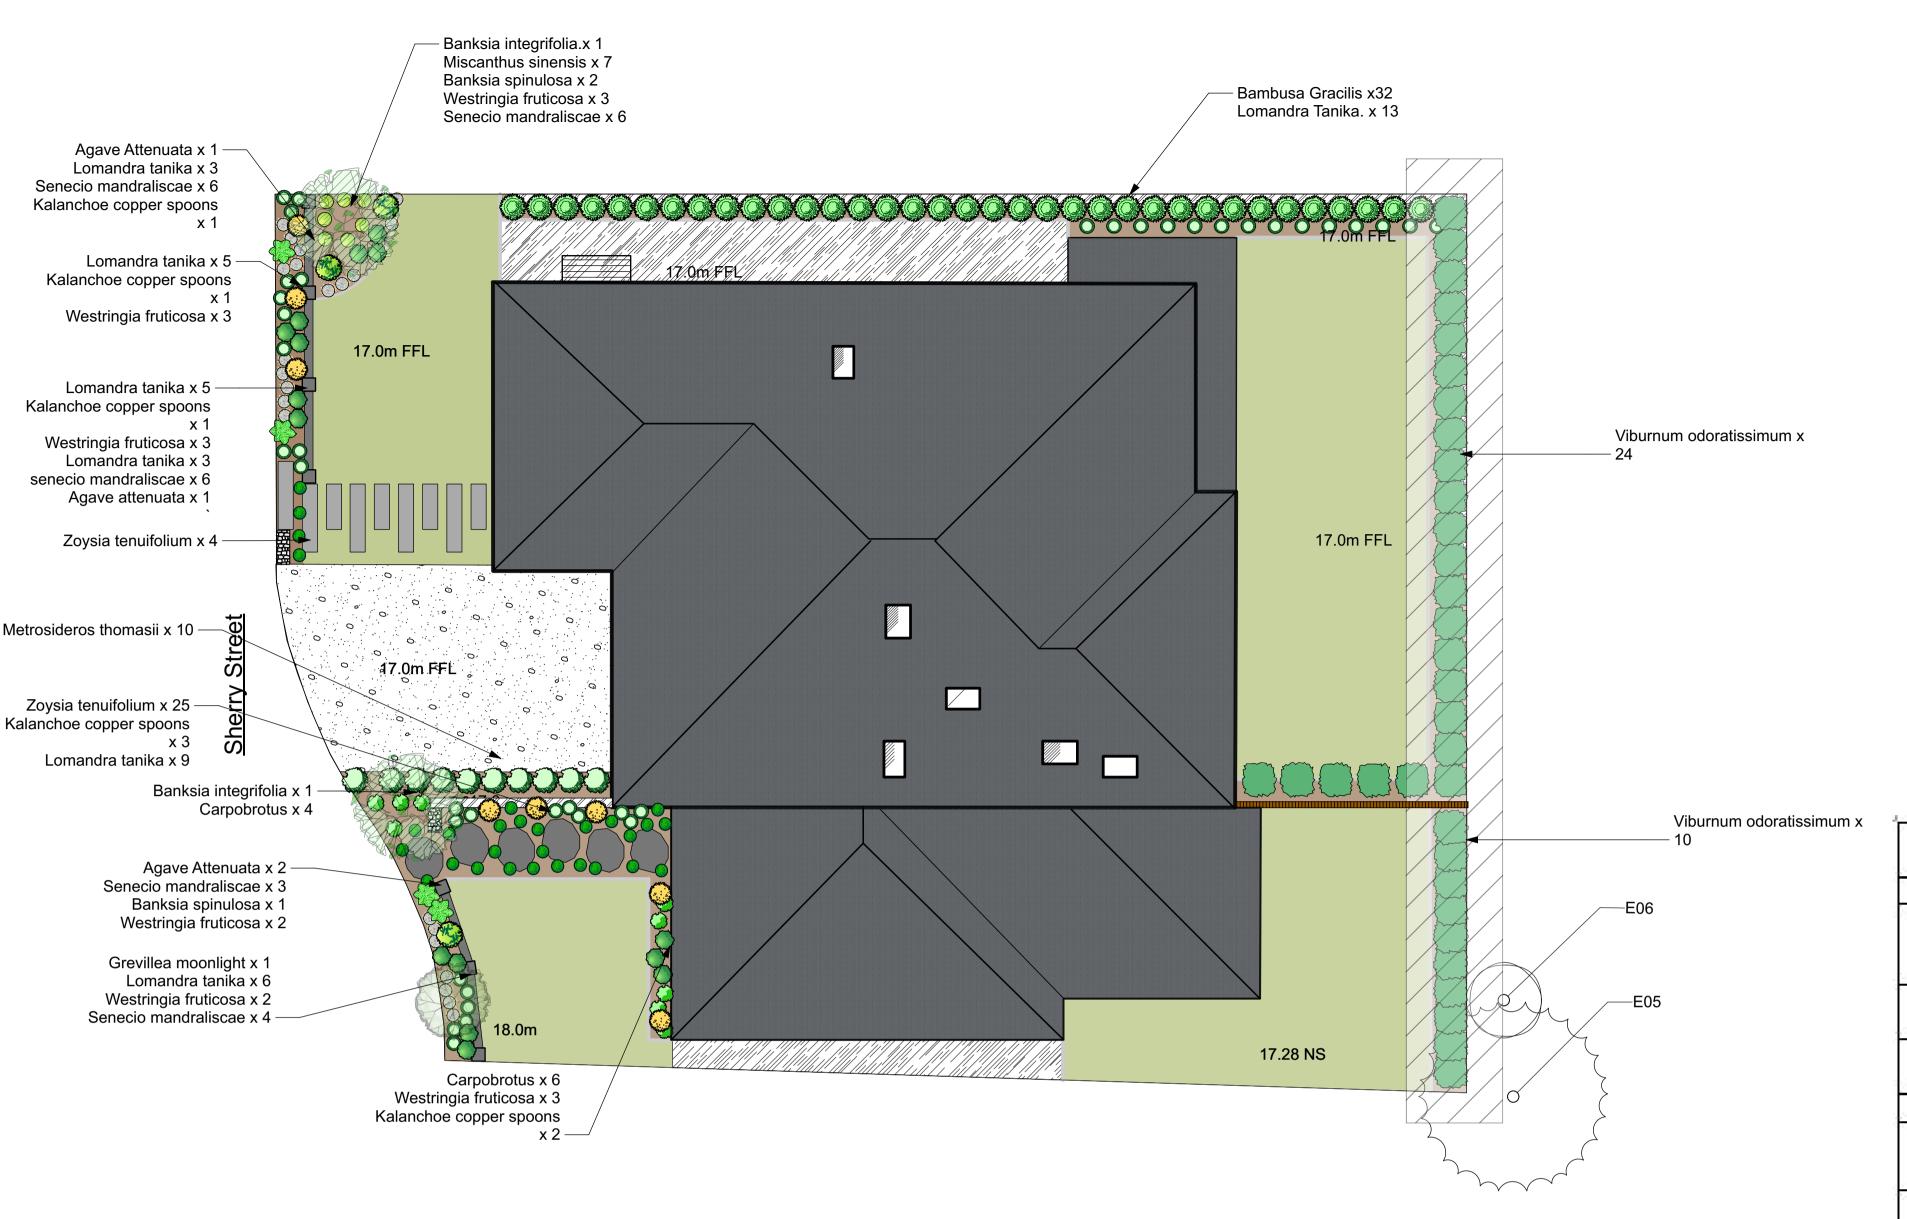

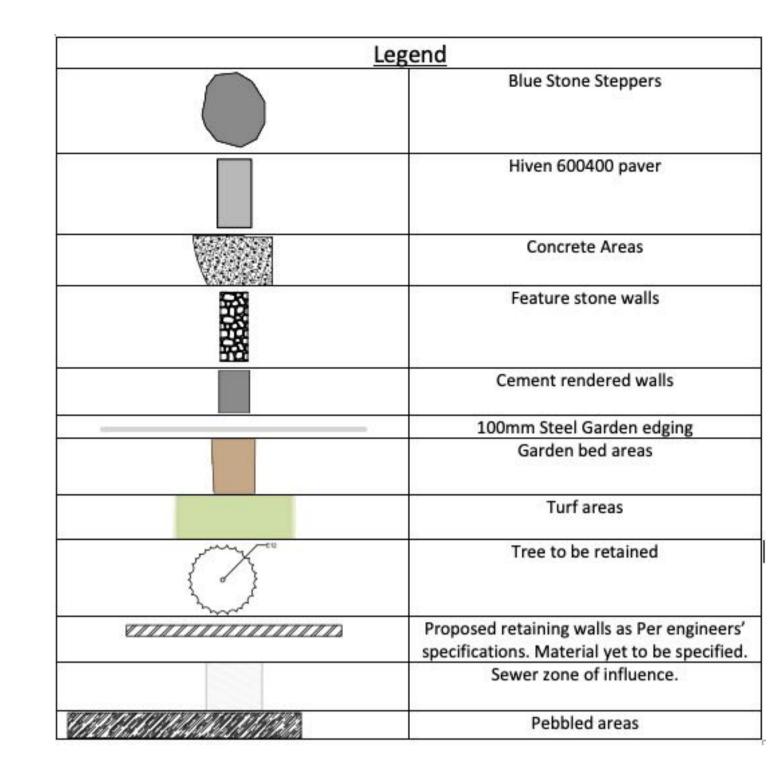

Plant Schedule

Type	Botanical	Common	Size	Quantity	Mature
100	<u>Name</u>	names		3	Size
Trees	. 152		ii ii		
	Bambusa Slender weaver	Bamboo slender	300mm	32	4-8m
	Banksia integrifolia	Coastal banksia	100ltr	2	4-8m
	Grevillea moon light	Grevillea moonlight	45ltr	1	3-4m
Shrubs	Section 2	G-1955		Grand In	And the Autoria
200	Agave attenuata	Agave	300mm	4	500mm- 1m
	Banksia spinulosa	Candle sticks banksia	300mm	3	1-2m
	Kalanchoe copper spoons	Copper spoons	300mm	7	500mm
	Metrosideros excelsa	NZ Christmas bush	300mm	10	500mm
	Viburnum odoratissimum	Viburnum	200mm	34	1m
	Westringia fruticosa	Coastal rosemary	300mm	16	500mm
Ground cover/grasses					
	Carpobrotus	Pigface	140mm	10	1m-5m
	Lomandra tanika	Lomandra tanika	140mm	40	400mm
	Miscanthus sinensis	Chinese winter grass	200mm	7	500mm- 1m
	Senecio mandraliscae	Chalksticks	140mm	25	500mm
	Zoysia tenuifolium	Zoysia no mow	140mm (if possible get the squares/tiles of it)	29	500mm

Please contact Blue sky landscaping and Designs immediately if any discrepncencies are noted.

If certain plants are not available seek alternatives reccomended by the supplier or call Blue sky landscaping to dsicuss other alternative plantings.

blue sky

Notes:
1) Do not scale from drawing, use marked dimensions and levels. To be read in conjunction with all consultants' documentation.

Blue Sky Landscaping and Designs. is to be immediately notified of any discrepancies.
2) Contractor to verify all dimensions, coordinate services and installation. 3) All construction must be built to minimum requirement set out

by the
Building Code of Australia and relevant Australian Standards.
Designer is to be notified immediately of any discrepancies to the above,
and confirmation sought.
4) Copyright on this drawing and design retained by Blue Sky
Landscaping and Design Landscaping and Design

5) All Site RLS are for Viewing purposes only. They must be read in conjuction with the Most recent site survey plan. All RLS will be adjusted as per the most recent site survey.

Structural Engineer: To Be Specified

All Elements of the plan that need structural engineer specifications must be sought prior to the commencement of any construction works. Engineer plans must be supplied to the contractor and all approval bodies. These are not engineer plans and do not specify any structural elements of the project. it is a Concept only.

Planting Plan

Sherry Street.

7 Sherry Street Mona Vale NSW 2103

Blue Sky Landscaping and Designs


SCALE

1:100 A4 REDUCTION: 35.35%.

For Approval

OF 9

Rebecca Gillespie. T:0401653557

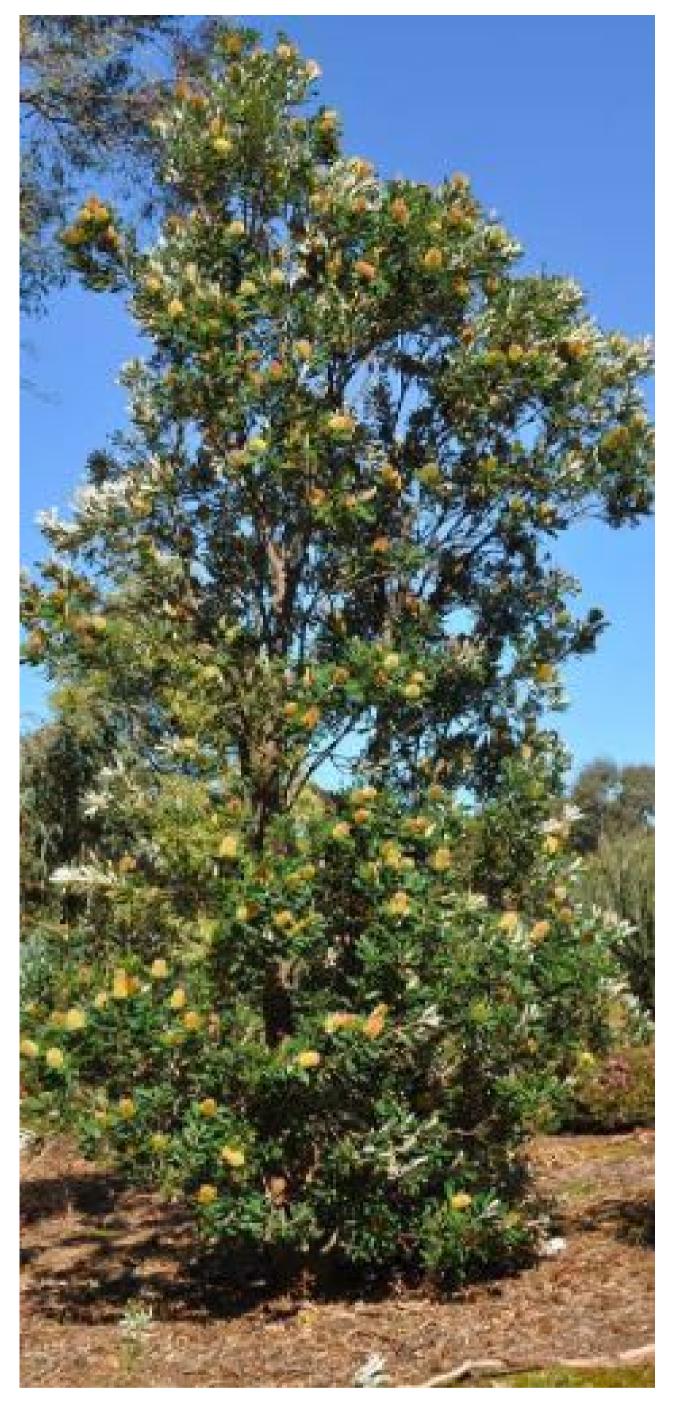

Botanical Name: Banksia integrifolia Common name: Coastal Banksia



Notes:
1) Do not scale from drawing, use marked dimensions and levels. To be read in conjunction with all consultants' documentation.
Blue Sky Landscaping and Designs. is to be immediately notified of any discrepancies.

of any discrepancies.
2) Contractor to verify all dimensions, coordinate services and

components prior to commencement of site work or off-site fabrication and

by the
Building Code of Australia and relevant Australian Standards.
Designer is to be notified immediately of any discrepancies to the above,
and confirmation sought.
4) Copyright on this drawing and design retained by Blue Sky
Landscaping and Design

Landscaping and Design

5) All Site RLS are for Viewing purposes only. They must be read in conjuction with the Most recent site survey plan. All RLS will be adjusted as per the most recent site survey.

installation. 3) All construction must be built to minimum requirement set outs

Botanical name: Lomandra tanika Common Name: Lomandra













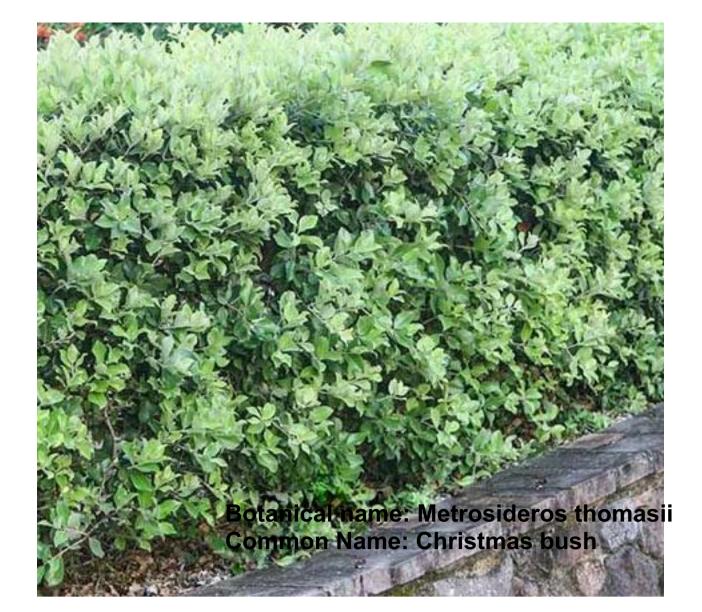



Botanical name: Viburnum odoratissumum **Common Name: Viburnum**

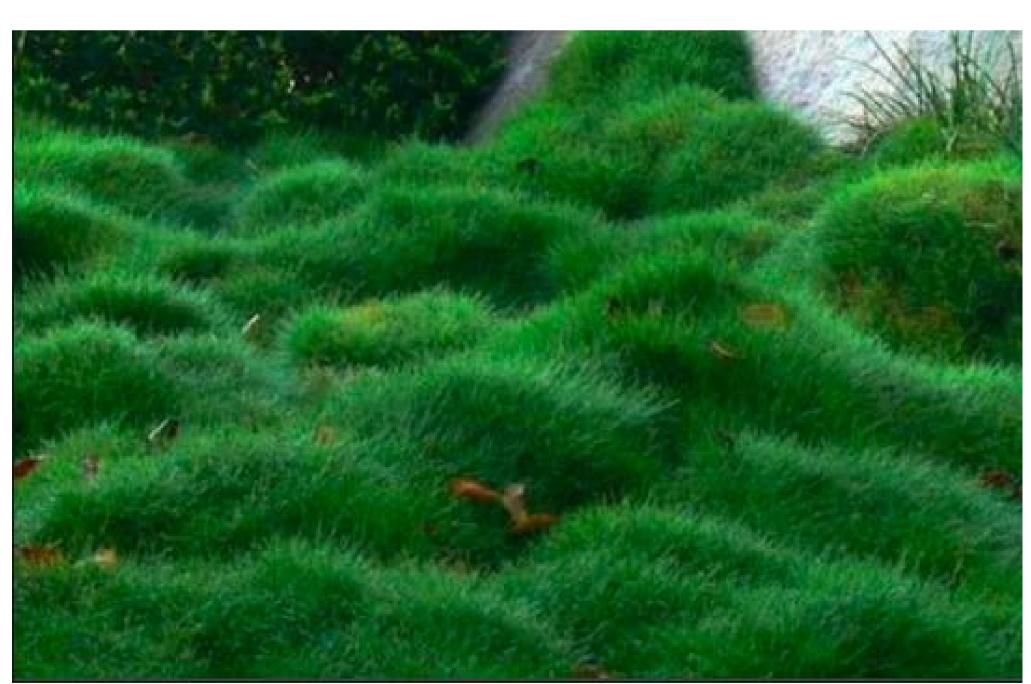

Botanical name: Zoysia tenuifolium Common Name: Zoysia Groundcover



All Elements of the plan that need structural engineer specifications must be sought prior to the commencement of any construction works. Engineer plans must be supplied to the contractor and all approval bodies. These are not engineer plans and do not specify any structural elements of the project. it is a Concept only.



Botanical Name: Westringia fruticosa Common name: **©**Coastal rosemary

Botanical Name: Agave attenuata Common name: agave



Botanical name: Banksia Spinulosa Common Name:candle stick banksia



Structural Engineer: To Be Specified

7 Sherry Street Mona Vale NSW 2103

Plant Examples

Sherry Street.



For Approval SCALE

2022/SYD31

OF 9