

ACTION PLANS

m: 0426 957 518

e: operations@actionplans.com.au

w: www.actionplans.com.au

DEVELOPMENT APPLICATION

These plans are for Development Approval only.

ITEM DETAILS	DEVELOPMENT APPLICATION				
ADDRESS	122 PITTWATER ROAD, MANLY NSW 2095				
LOT & DP/SP	LOT 1 DP 88475				
COUNCIL	NORTHERN BEACHES COUNCIL (MANLY)				
SITE AREA	215.3m²				
FRONTAGE	6.16m				
CONTROLS	PERMISSIBLE / REQUIRED	EXISTING	PROPOSED	COMPLIANCE	
	m / m² / %	m / m² / %	m / m² / %		
<u>LEP</u>					
LAND ZONING	R3 – LOW DENSITY RESIDENTIAL	R3	R3	YES	
MINIMUM LOT SIZE	250m²	215.3m²	UNCHANGED	UNDERSIZED	
FLOOR SPACE RATIO	0:6 : 1 (129.18m²)	0.53 : 1 (115.44m²)	0.77 : 1 (166.06m²)	NO	
MAXIMUM BUILDING HEIGHT	8.5m	5.66m	6.749m	YES	
<u>HAZARDS</u>					
ACID SULFATE SOILS	CLASS 4				
SEPP - COASTAL MANAGEMENT	IDENTIFEID			PLEASE READ IN CONJUNCTION WITH	
FLOOD HAZARD	MEDIUM RISK PRECINCT			STATEMENT OF	
FORESHORE SCENIC PRO. AREA	IDENTIFEID			ENVIRONMENTAL EFFECTS AND RELEVANT REPORTS	
HERITAGE CONSERVATION AREA	IDENTIFEID				
HERITAGE MAP	ITEM GENERAL - ADJACENT TO ITEM				
DCP					
RESIDENTIAL OPEN SPACE	AREA OS3				
TOTAL OPEN SPACE (TOS)	55% (118.41m²)	57.10m² (26.5%)	UNCHANGED	NO (EXISTING)	
LANDSCAPE AREA	35% OF TOS (55%): 41.44m ²	36.69m² (30.9%)	UNCHANGED	NO (EXISTING)	
OPEN SPACE ABOVE GROUND	MAX. 40% OF TOS (55%) : 47.36m ²	N/A	UNCHANGED	N/A	
PRINCIPAL PRIVATE OPEN SPACE	18m²	20.4m²	UNCHANGED	YES	
FRONT SETBACK	PREVALING BULDING LINE: 2.3m	GF: 0m FF: 1.88m	UNCHANGED	NO (EXISTING)	
REAR SETBACK	8.0m	HOUSE: 9.06m DECK: 5.92	UNCHANGED	YES	
SIDE SETBACKS	1/3 WALL HEIGHT: 1.5m	N: 1.152m S: 0m	N: UNCHANGED S: UNCHANGED	NO (EXISTING)	


SHEET NUMBER	SHEET NAME	DATE PUBLISHED
DA00	COVER	12-Jun-20
DA01	SITE ANALYSIS	12-Jun-20
DA02	${\tt SITE/ROOF/SEDIMENT\ EROSION/WASTE\ MANAGEMENT/STORMWATER\ CONCEPT\ PLAN}$	12-Jun-20
DA03	EXISTING FLOOR PLANS	12-Jun-20
DA04	PROPOSED FLOOR PLANS	12-Jun-20
DA05	NORTH / EAST ELEVATION	12-Jun-20
DA06	SOUTH / WEST ELEVATION	12-Jun-20
DA07	LONG / CROSS SECTION	12-Jun-20
DA08	AREA CALCULATIONS	12-Jun-20
DA09	SAMPLE BOARD	12-Jun-20
DA10	WINTER SOLSTICE 9 AM	12-Jun-20
DA11	WINTER SOLSTICE 12 PM	12-Jun-20
DA12	WINTER SOLSTICE 3 PM	12-Jun-20
DA13	BASIX COMMITMENTS	12-Jun-20
DA14	LONG SECTION	12-Jun-20
DA15	0900 - 21 JUNE	12-Jun-20
DA16	1200 - 21 JUNE	12-Jun-20
DA17	1500 - 21 JUNE	12-Jun-20
DA18	0900 - 21 JUNE	12-Jun-20
DA19	1200 - 21 JUNE	12-Jun-20
DA20	1500 - 21 JUNE	12-Jun-20


122 PITTWATER ROAD, MANLY 2095



NCC & AS COMPLIANCES SPECIFICATIONS

- EARTHWORKS PART 3.1.1 OF NCC
- EARTH RETAINING STRUCTURES PART 3.1.2 OF NCC
- DRAINAGE PART 3.1.3 OF NCC
- TERMITE-RISK MANAGEMENT PART 3.1.4 OF NCC
- FOOTINGS & SLAB PART 3.2 OF NCC INCLUDING AS2870
- MASONRY PART 3.3 OF NCC INCLUDING AS3700
- FRAMING PART 3.4 OF NCC
- SUB FLOOR VENTILATION PART 3.4.1 OF NCC
- ROOF CLADDING AND WALL-CLADDING PART 3.5 OF NCC
- GLAZING PART 3.6 OF NCC INCLUDING AS1288
- FIRE SAFETY PART 3.7 OF NCC
- FIRE SEPERATION PART 3.7.2 OF NCC
- FIRE PROTECTION OF SEPERATING WALLS AND FLOORS- PART 3.7.3 OF NCC
- SMOKE ALARMS PART 3.7.5 OF NCC
- WET AREAS AND EXTERNAL WATERPROOFING PART 3.8.1 OF NCC
- ROOM HEIGHTS PART 3.8.2 OF NCC
- FACILITIES PART 3.8.3 OF NCC
- LIGHT PART 3.8.4 OF NCC
- VENTILATION PART 3.8.5 OF NCC
- SOUND INSULATION PART 3.8.6 OF NCC
- STAIRWAYAND RAMP CONSTRUCTION PART 3.9.1 OF NCC
- BARRIERS AND HANDRAILS PART 3.9.2 OF NCC
- SWIMMING POOLS PART 3.10.1 OF NCC
- CONSTRUCTION IN BUSHFIRE PRONE AREAS PART 3.10.5 OF NCC
- FENCING & OTHER PROVISIONS REGS & AS1926
- DEMOLITION WORKS AS2601-1991 THE DEMOLITION OF STRUCTURES.
- ALL WATERPROOF MEMBRANES TO COMPLY WITH WITH AS 3740-2010
- ALL PLUMBING & DRAINAGE WORK TO COMPLY WITH AS 3500
- SITE CLASSIFICATION AS TO AS 2870
- ALL PLASTERBOARD WORK TO COMPLY WITH AS 2588-1998
- ALL STRUCTURAL STEEL WORK TO COMPLY WITH AS 4100 & AS 1554
- ALL CONCRETE WORK TO COMPLY WITH AS 3600
- ALL ROOF SHEETING WORK TO COMPLY WITH AS 1562-1992
- ALL SKYLIGHTS TO COMPLY WITH WITH AS 4285-2007
- ALL CERAMIC TILING TO COMPLY WITH AS 3958.1-2007 & 3958.2-1992
- ALL GLAZING ASSEMBLIES TO COMPLY WITH AS2047 & 1288
- ALL TIMBER RETAINING WALLS ARE TO COMPLY WITH AS 1720.1-2010, AS 1720.2-2006, AS 1720.4-2006, AS 1170.1-1989 & AS 1170.4-2007
- ALL RETAINING WALLS ARE TO COMPLY WITH 3700 2011 & AS 3600 -2009
- ALL CONSTRUCTION TO COMPLY TO AS3959- 2009

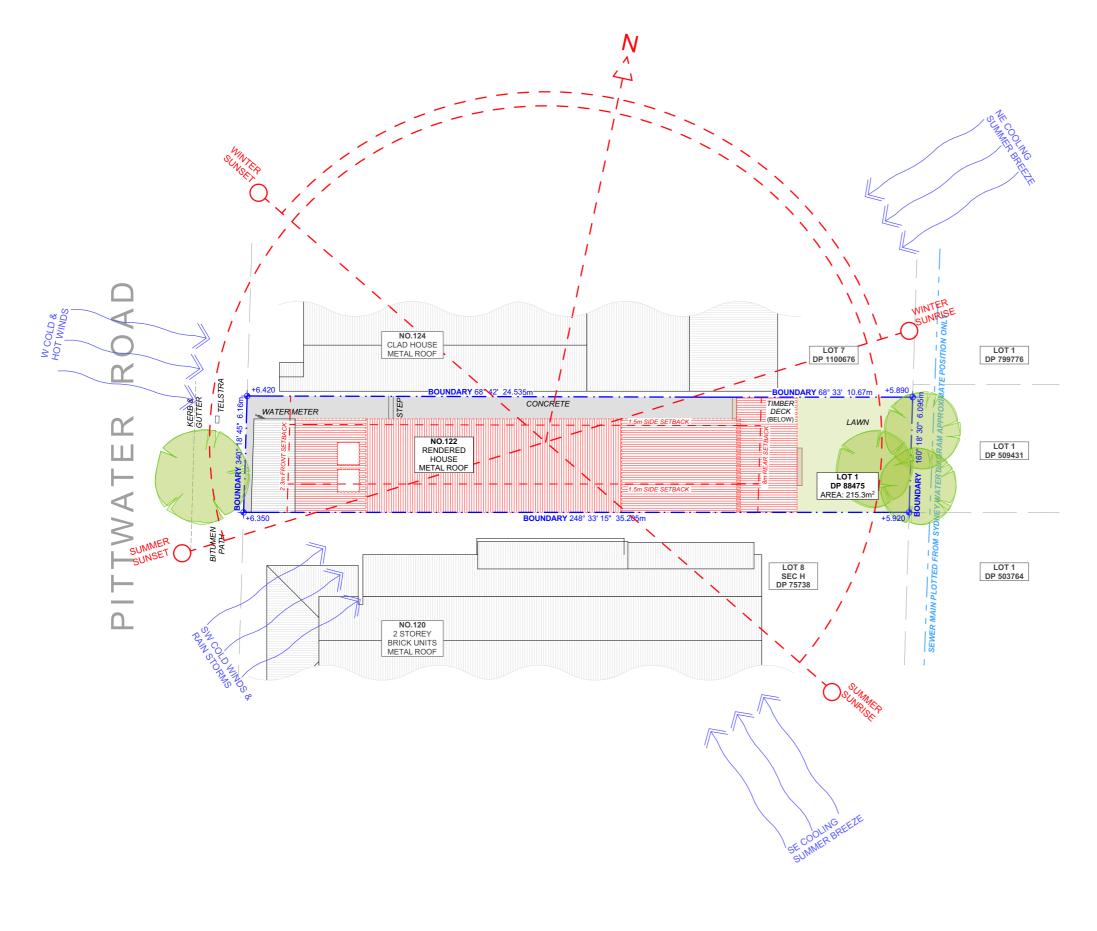

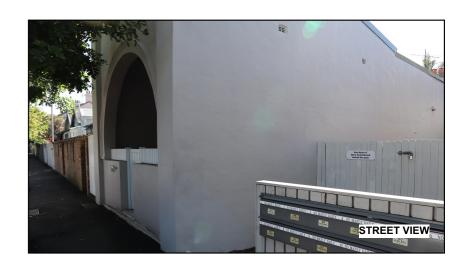





1 SITE ANALYSIS 1:200

NOTE: ALL DEMOLISHED ELEMENTS TO ENG. SPECIFICATIONS AND AS. 2601 - 2001



ACTION PLANS

m: 0426 957 518 e:operations@actionplans.com.au w: www.actionplans.com.au

	REV.	DATE	COMMENTS	DRWN	NOTES This drawing is the copyright of Action Plans and not be
u	А	05/05/2020	DA DOCUMENTATION	EAS	altered, reproduced or transmitted in any form or by any means in part or in whole with the written permission of
					Action Plans. Do not scale measure from drawings. Figured dimensions
					are to be used only. The Builder/Contractor shall check and verify all levels and
					dimensions on site prior to commencement of any work, creation of shop drawings, or fabrication of components.
					All errors and omissions are to be verified by the Builder/Contractor and referred to the designer prior to the
					commencement of works.

LEGEND

SOFT LANDSCAPE
HARD LANDSCAPE
PROPOSED
EXISTING

- DEMOLISHED

EX. EXISTING
DP. DOWNPIPE
PROP. PROPOSED
DP. DOWNPIPE

CLIENT

DANNY & NICOLE
CARTER

PROJECT ADDRESS 122 PITTWATER ROAD, MANLY 2095 DRAWING NO.

DA01


NO1


DATE


Friday, June 12, 2020

DRAWING NAME
SITE ANALYSIS

SCALE 1:200 @A3

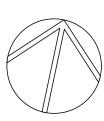

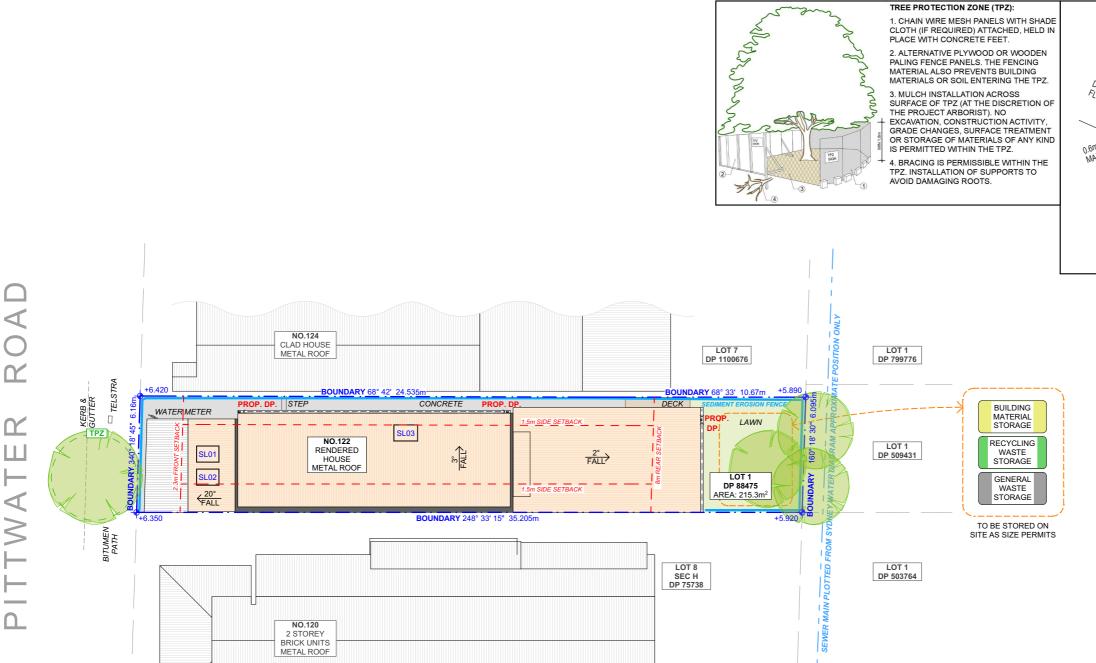

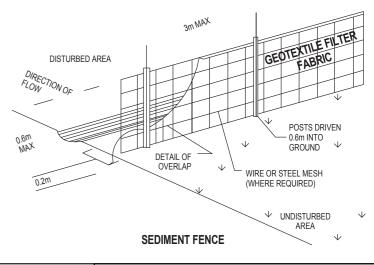

DUST CONTROL:

TO REDUCE DUST GENERATED BY WIND ACTION, THE REMOVAL OF THE TOP SOIL IS TO BE MINIMISED. TO PREVENT DUST GENERATION, WATERING DOWN OF THE SITE, ESPECIALLY DURING THE MOVEMENT OF MACHINERY IS REQUIRED. WHERE EXCAVATING INTO ROCK, KEEP THE SURFACE MOIST TO MINIMISE DUST. CONSTRUCT A GRAVEL ENTRY/EXIT POINT USING BLUE METAL AND RESTRICT ALL VEHICLE MOVEMENTS WITHIN THE SITE TO A MINIMUM. ENSURE WIND BREAKS, SUCH AS EXISTING FENCES ARE MAINTAINED DURING THE CONSTRUCTION PHASE UNTIL NEW LANDSCAPING IS PROVIDED OR REINSTATED. PREVENT DUST BY COVERING STOCKPILES

SEDIMENT NOTE:

1. ALL EROSION AND SEDIMENT CONTROL MEASURES TO BE INSPECTED AND MAINTAINED DAILY BY THE SITE MANAGER.

2. MINIMISE DISTURBED AREAS, REMOVE EXCESS SOIL FROM EXCAVATEDAREA AS SOON AS POSSIBLE. 3. ALL MATERIAL STOCKPILE TO BE CLEAR FROM DRAINS, GUTTERS AND FOOTPATHS, OR WITHIN SEDIMENT FENCE AREA.

4. DRAINAGE TO BE CONNECTED TO STORMWATER AS SOON AS POSSIBLE. IF STORED ON SITE, IT MUST BE FILTERED BEFORE RELEASING INTO STORMWATER SYSTEM OR WATERWAYS

5. ROADS AND FOOTPATHS TO BE SWEPT DAILY.

STOCKPILES:

ALL STOCKPILES ARE TO BE KEPT ON-SITE WHERE POSSIBLE. ANY MATERIALS PLACED ON THE FOOTPATHS OR NATURE STRIPS REQUIRE COUNCIL'S PERMISSION

ALL STOCKPILES ARE TO BE PLACED AWAY FROM THE DRAINAGE LINES AND STREET GUTTERS. IT IS BEST TO LOCATE THESE ON THE HIGHEST PART OF THE SITE IF POSSIBLE. PLACE WATERPROOF COVERING OVER STOCKPILES.

IF REQUIRED PROVIDE DIVERSION DRAIN & BANK AROUND STOCKPILES.

GUTTER PROTECTION:

PROVIDE PROTECTION TO DOWNHILL GRATE IN GUTTER BY MEANS OF SAND BAGS OR BLUE METAL WRAPPED IN GEOTEXTILE FABRIC. WHEN SOIL OR SAND BUILDS UP AROUND THIS SEDIMENT BARRIER, THE MATERIAL SHOULD BE RELOCATED BACK TO THE SITE FOR DISPOSAL.

NOTE: ALL PROPOSED STORMWATER TO CONNECT WITH EXISTING

SITE / ROOF / SEDIMENT EROSION / WASTE MANAGEMENT / STORMWATER CONCEPT PLAN


DOWN NOTES



DEV DATE

COMMENTS

	REV.	DAIL	COMMENTS	DKWN	NUIES
ı	A	05/05/2020	DA DOCUMENTATION	EAS	This drawing is the copyright of Action Plans and not be altered, reproduced or transmitted in any form or by any means in part or in whole with the written permission of
					Action Plans. Do not scale measure from drawings. Figured dimensions
					are to be used only. The Builder/Contractor shall check and verify all levels and
					dimensions on site prior to commencement of any work, creation of shop drawings, or fabrication of components.
					All errors and omissions are to be verified by the Builder/Contractor and referred to the designer prior to the commencement of works.

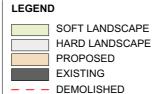

EX. **EXISTING** DP. DOWNPIPE PROP. PROPOSED DP. DOWNPIPE

DANNY & NICOLE CARTER

CLIENT

1:200

PROJECT ADDRESS 122 PITTWATER ROAD. MANI Y 2095

DRAWING NO. **DA02**

DATE


Friday, June 12, 2020

DRAWING NAME

SITE / ROOF / SEDIMENT EROSION / WASTE MANAGEMENT / STORMWATER CONCEPT PLAN


SCALE

1:200 @A3

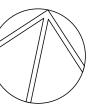



EXISTING MEZZANINE FLOOR PLAN 1:100

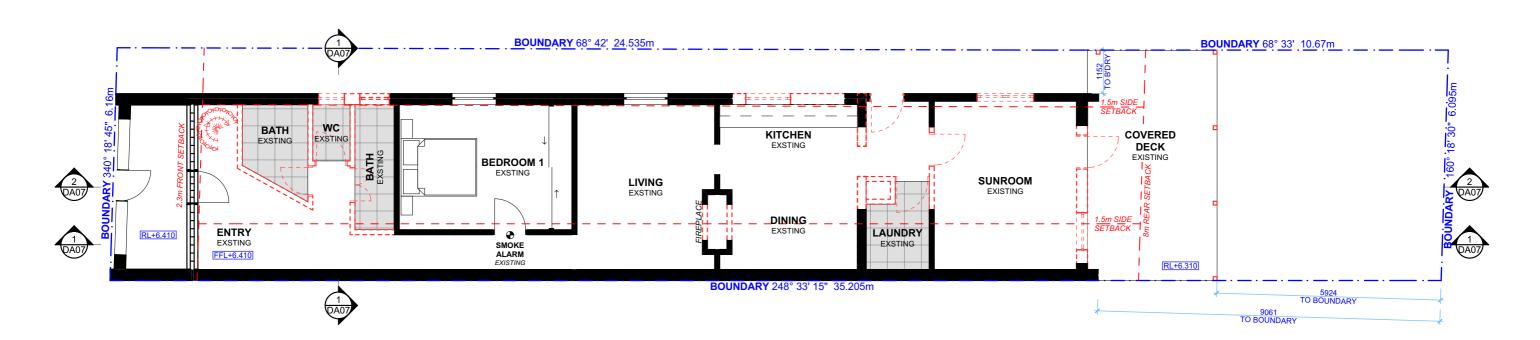


EXISTING GROUND FLOOR PLAN 1:100

NOTE: ALL DEMOLISHED ELEMENTS TO ENG. SPECIFICATIONS AND AS. 2601 - 2001



	REV.	DATE	COMMENTS	DRWN	NOTES
	Α	05/05/2020	DA DOCUMENTATION	EAS	This drawing is the copyright of Action Plans and not be altered, reproduced or transmitted in any form or by any means in part or in whole with the written permission of
					Action Plans. Do not scale measure from drawings. Figured dimensions
					are to be used only. The Builder/Contractor shall check and verify all levels and
ı		dimensions on site creation of shop draw	dimensions on site prior to commencement of any work, creation of shop drawings, or fabrication of components.		
					All errors and omissions are to be verified by the Builder/Contractor and referred to the designer prior to the

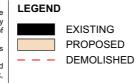

CLIENT
DANNY & NICOLE CARTER

PROJECT ADDRESS
122 PITTWATER ROAD,
MANLY 2095

DRAWING NO.	DRAWING NAME
DA03	EXISTING FLOOR

Friday, June 12, 2020


DATE

EXISTING FLOO	R PLAN

SCALE


1:100 @A3



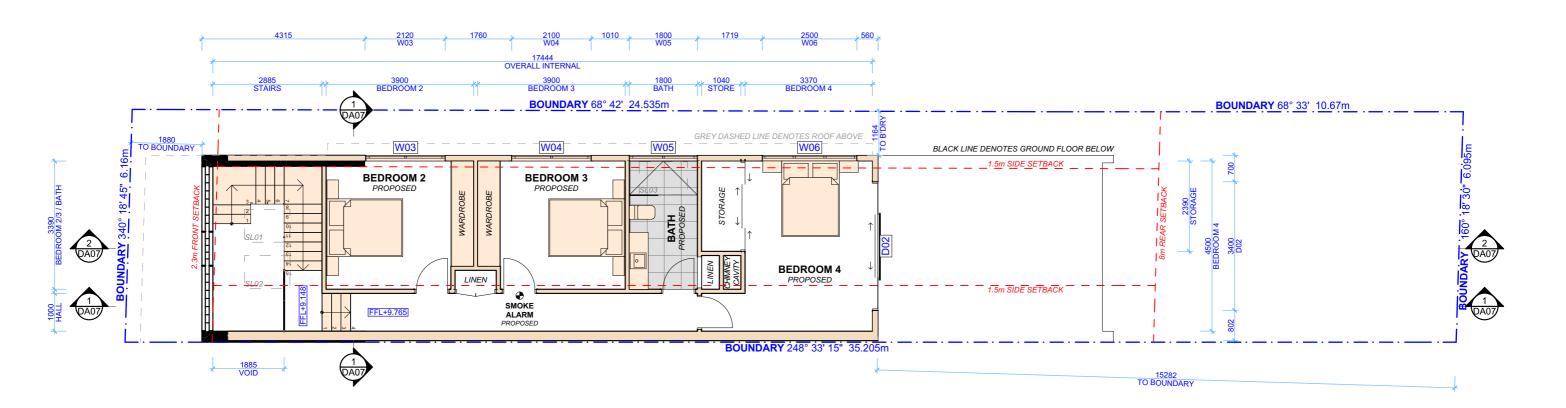

PROPOSED FIRST FLOOR PLAN 1:100

NOTE: SMOKE ALARMS TO COMPLY WITH PART 3.7.2 OF NCC

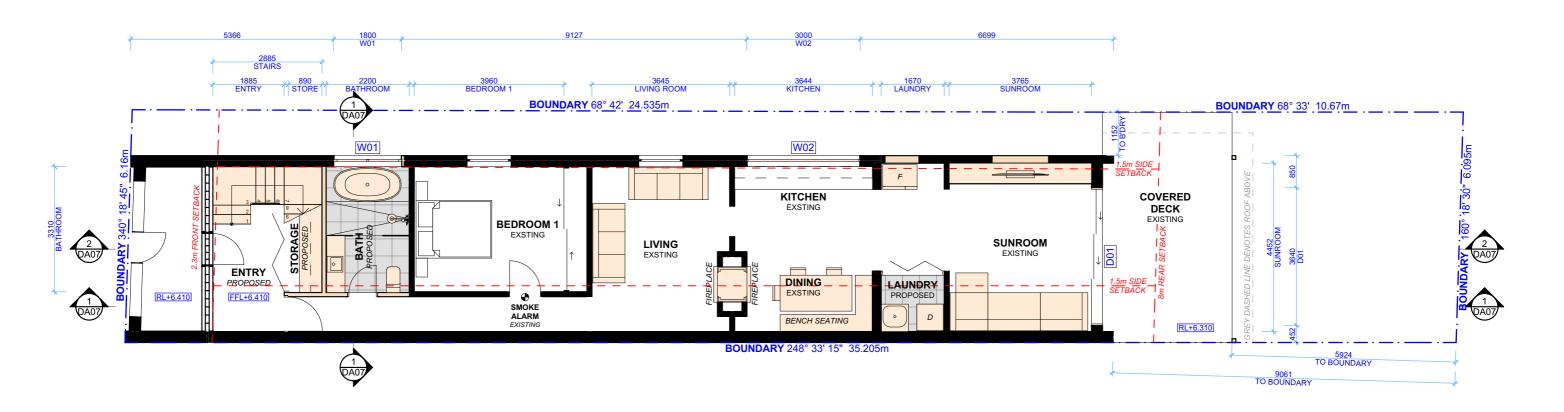

1 PROPOSED GROUND FLOOR PLAN 1:100

NOTE: EXTERNAL WALL LESS THAN 900mm FROM BOUNDARY TO COMPLY WITH NCC VOL 2 - 3.7.2.4 AND MEET FRL 60/60/60

ACTION PLANS
m: 0426 957 518 e:operations@actionplans.com.au w: www.actionplans.com.au

	REV.	DATE	COMMENTS	DRWN	NOTES This drawing is the copyright of Action Plans and not be
	Α	05/05/2020	DA DOCUMENTATION	EAS	altered, reproduced or transmitted in any form or by any means in part or in whole with the written permission of
					Action Plans. Do not scale measure from drawings. Figured dimensions
					are to be used only. The Builder/Contractor shall check and verify all levels and
ı					dimensions on site prior to commencement of any work, creation of shop drawings, or fabrication of components.
					All errors and omissions are to be verified by the Builder/Contractor and referred to the designer prior to the





CLIENT
DANNY & NICOLE CARTER
DDO IECT ADDDESS

PROJECT ADDRESS	
122 PITTWATER ROAD, MANLY 2095	


DRAWING NO.	DRAWING NAME
DA04	PROPOSED FLOOR PLANS

	DATE		
D,	Friday, June 12, 2020	SCALE	
		1:100 @A3	

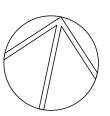

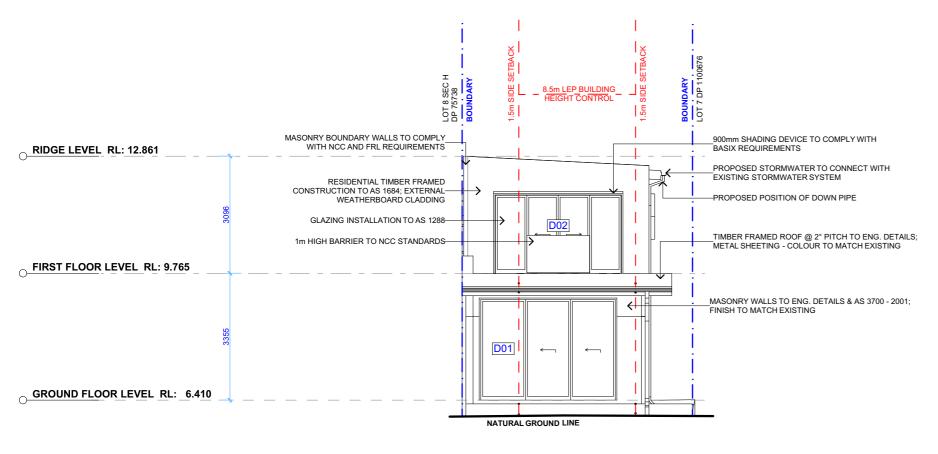

EAST ELEVATION 1:100

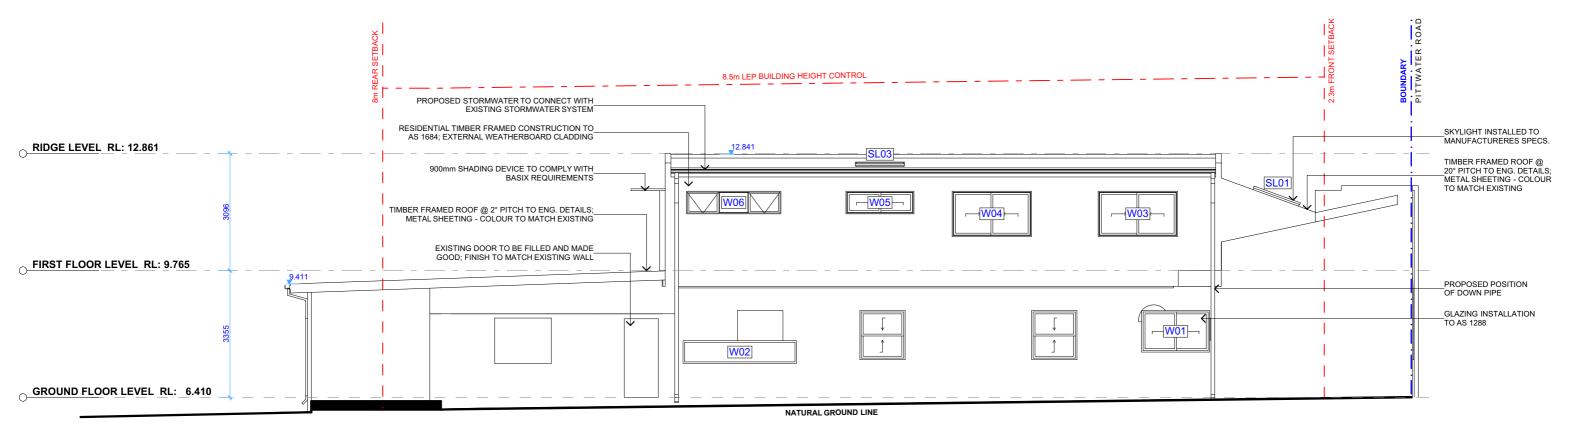

NORTH ELEVATION 1:100

NOTE: EXTERNAL WALL LESS THAN 900mm FROM BOUNDARY TO COMPLY WITH NCC VOL 2 - 3.7.2.4 AND MEET FRL 60/60/60

ACTION PLANS
m: 0426 957 518 e:operations@actionplans.com.au w: www.actionplans.com.au

	REV.	DATE	COMMENTS	DRWN	NOTES
	A	05/05/2020	DA DOCUMENTATION	EAS	This drawing is the copyright of Action Plans and not be altered, reproduced or transmitted in any form or by any means in part or in whole with the written permission of
					Action Plans. Do not scale measure from drawings. Figured dimensions
					are to be used only. The Builder/Contractor shall check and verify all levels and
u					dimensions on site prior to commencement of any work, creation of shop drawings, or fabrication of components.
					All errors and omissions are to be verified by the Builder/Contractor and referred to the designer prior to the
					commencement of works.



CLIENT DANNY & NICOLE CARTER

DA05 DATE


DRAWING NO. DRAWING NAME NORTH / EAST ELEVATION


PROJECT ADDRESS 122 PITTWATER ROAD, MANLY 2095

Friday, June 12, 2020


SCALE

1:100 @A3

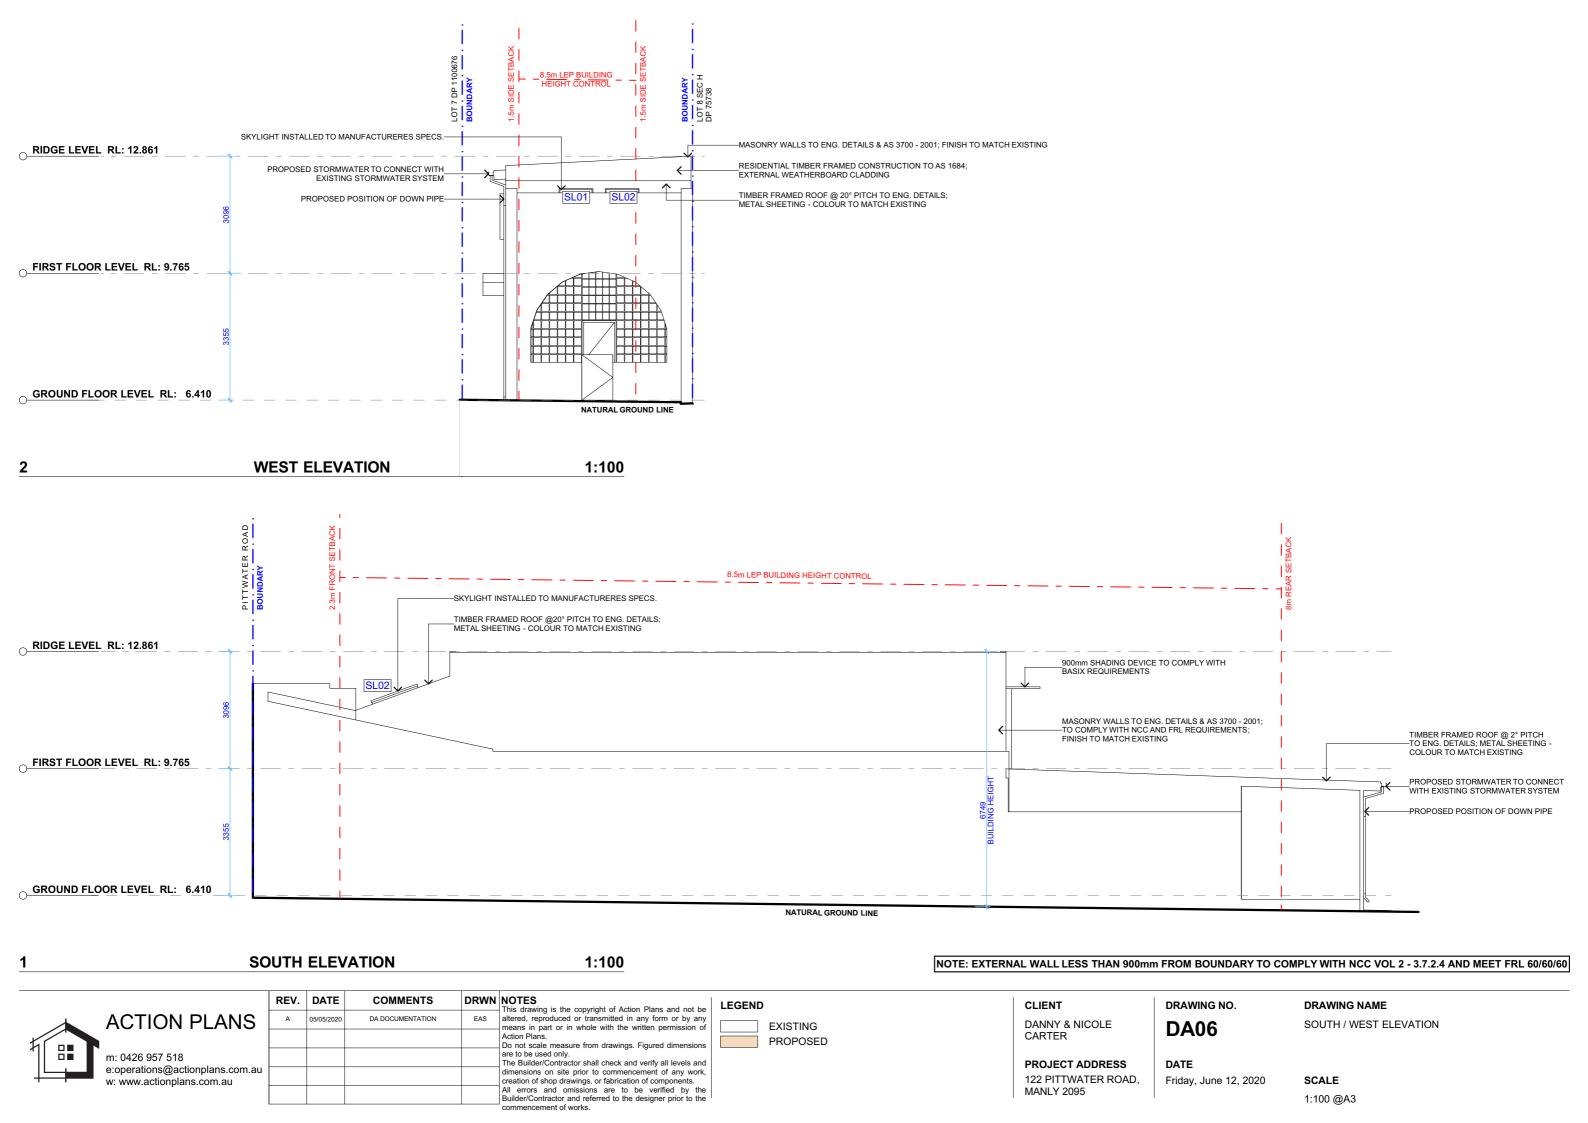

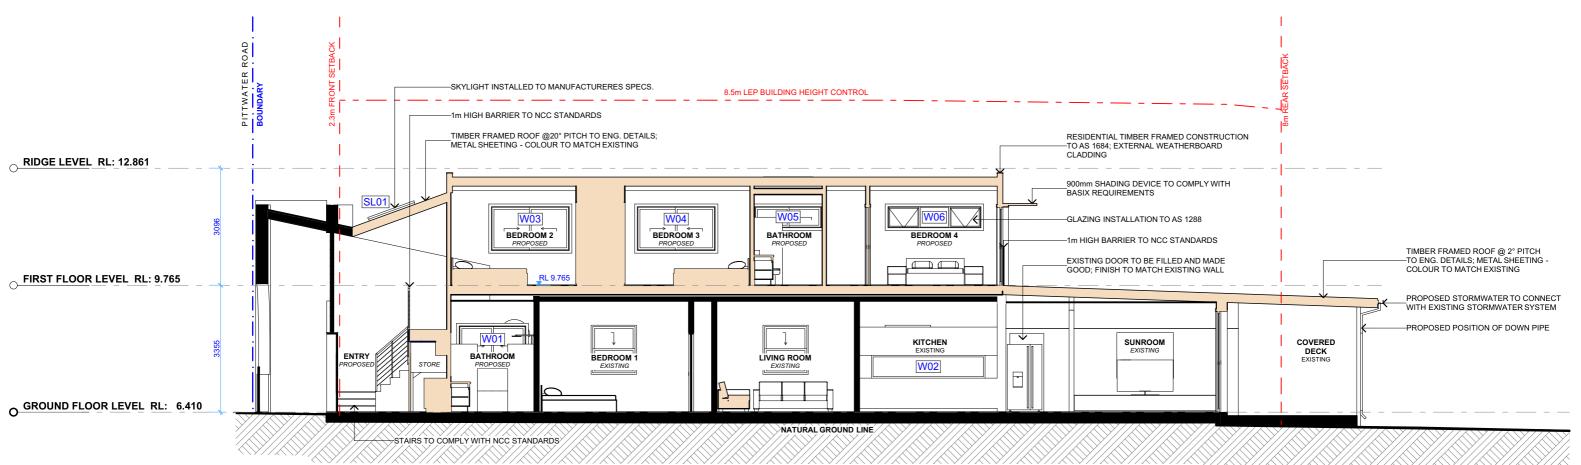

LONG SECTION 1:100

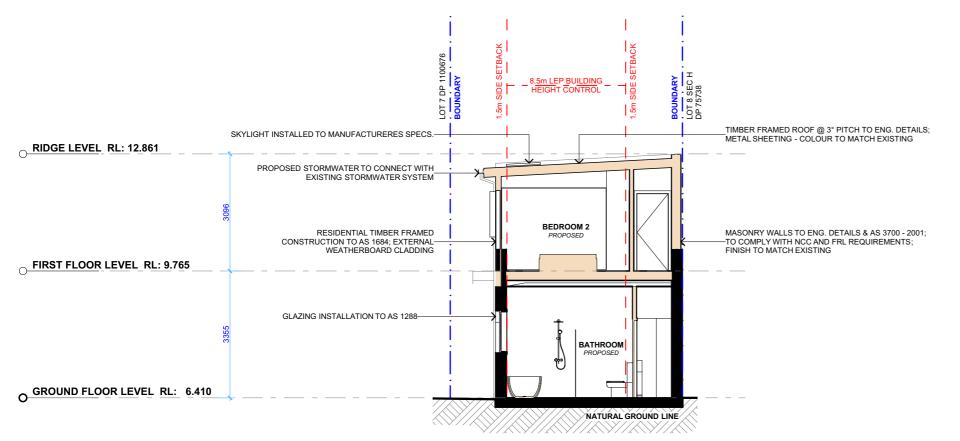


CROSS SECTION 1:100

NOTE: EXTERNAL WALL LESS THAN 900mm FROM BOUNDARY TO COMPLY WITH NCC VOL 2 - 3.7.2.4 AND MEET FRL 60/60/60

ACTION PLANS
m: 0426 957 518 e:operations@actionplans.com.au w: www.actionplans.com.au

REV.	DATE	COMMENTS	DRWN	NOTES This drawing is the copyright of Action Plans and not be
Α	05/05/2020	DA DOCUMENTATION	EAS	altered, reproduced or transmitted in any form or by any means in part or in whole with the written permission of
				Action Plans. Do not scale measure from drawings. Figured dimensions
				are to be used only. The Builder/Contractor shall check and verify all levels and
				dimensions on site prior to commencement of any work, creation of shop drawings, or fabrication of components.
				All errors and omissions are to be verified by the Builder/Contractor and referred to the designer prior to the

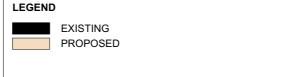

CLIENT

DANNY & NICOLE

CARTER

DA07


DRAWING NO.


DRAWING NAME LONG / CROSS SECTION


PROJECT ADDRESS 122 PITTWATER ROAD, MANLY 2095

Friday, June 12, 2020

SCALE 1:100 @A3

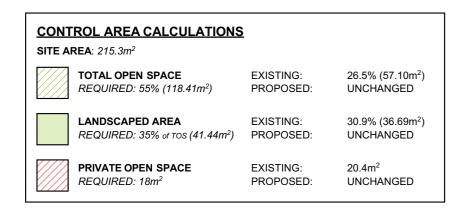

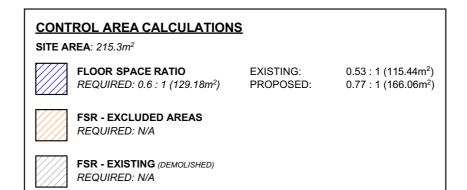

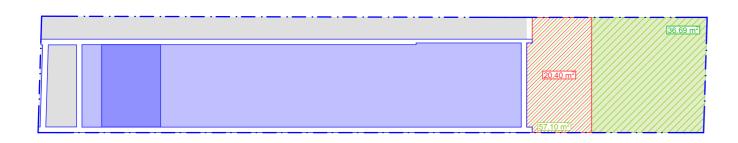

[54,19 m²]

2 EXISTING AREA CALCULATIONS 1:200

FSR: FIRST FLOOR



101.87 m²

1 PROPOSED AREA CALCULATIONS 1:200 3 FSR: GROUND FLOOR 1:200

M: 0426 957 518
e:operations@actionplans.com.au
w: www.actionplans.com.au

REV. DATE COMMENTS DRWN

A 05/05/2020 DA DOCUMENTATION EAS

This drawing is the copyright of Action Plans and not be altered, reproduced or transmitted in any form or by any means in part or in whole with the written permission of Action Plans.

Do not scale measure from drawings. Figured dimensions are to be used only.

The Builder/Contractor shall check and verify all levels and dimensions on site prior to commencement of any work, creation of shop drawings, or fabrication of components.

All errors and omissions are to be verified by the Builder/Contractor and referred to the designer prior to the commencement of works.

LEGEND

DANNY & NICOLE CARTER

CLIENT

PROJECT ADDRESS

PROJECT ADDRESS 122 PITTWATER ROAD, MANLY 2095 DA08

A08 AREA CALCULATIONS

DRAWING NAME

SCALE

1:200 @A3

DATE Friday Jun

Friday, June 12, 2020

1:200



PROTUDING ALUMINIUM FRAMED WINDOWS
BY STEGBAR OR OTHER

SAMPLE BOARD

m: 0426 957 518
e:operations@actionplans.com.au
w: www.actionplans.com.au

	REV.	DATE	COMMENTS	DRWN	NOTES
,	A	05/05/2020	DA DOCUMENTATION	EAS	This drawing is the copyright of Action Plans and not be altered, reproduced or transmitted in any form or by an means in part or in whole with the written permission of
					Action Plans. Do not scale measure from drawings. Figured dimension
					are to be used only. The Builder/Contractor shall check and verify all levels an
au					dimensions on site prior to commencement of any work creation of shop drawings, or fabrication of components.
					All errors and omissions are to be verified by th Builder/Contractor and referred to the designer prior to th
					commencement of works.

LEGEND

DANNY & NICOLE CARTER

CLIENT

PROJECT ADDRESS 122 PITTWATER ROAD, MANLY 2095 DRAWING NO.


DATEFriday, June 12, 2020

-

SCALE @A3

DRAWING NAME

SAMPLE BOARD

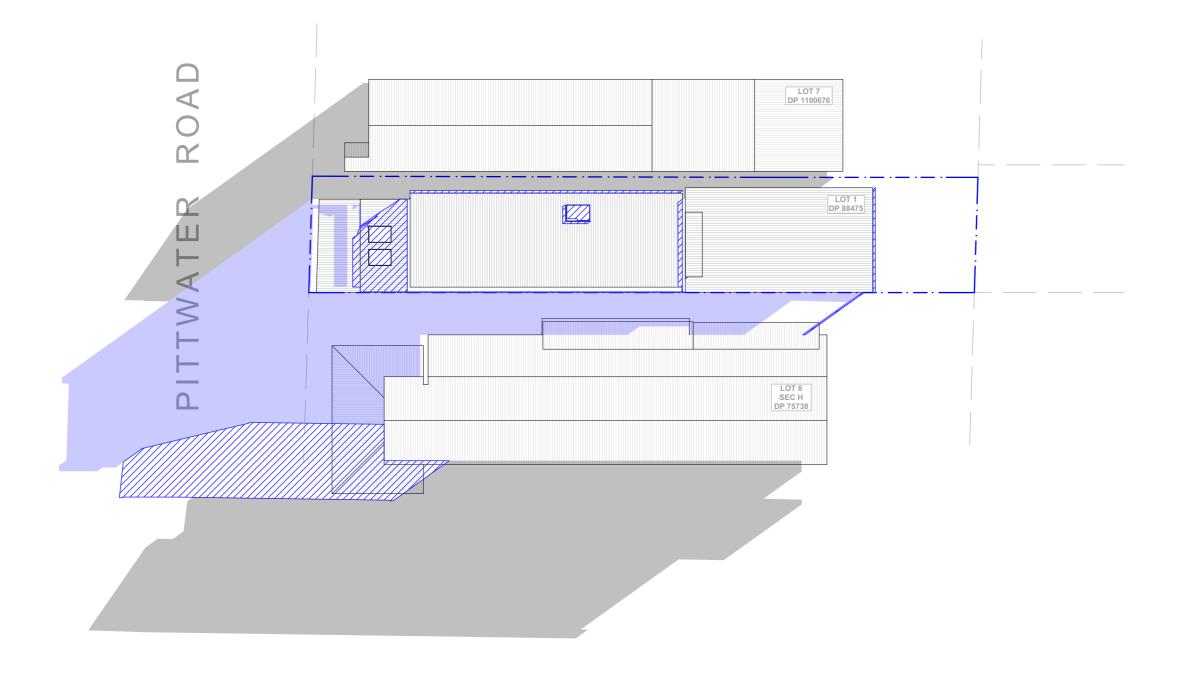

1 WINTER SOLSTICE 9AM 1:200



REV.	DATE	COMMENTS	DRWN	NOTES This drawing is the copyright of Action Plans and not be
Α	05/05/2020	DA DOCUMENTATION	EAS	altered, reproduced or transmitted in any form or by an means in part or in whole with the written permission or
				Action Plans. Do not scale measure from drawings. Figured dimensions
				are to be used only. The Builder/Contractor shall check and verify all levels and
				dimensions on site prior to commencement of any work creation of shop drawings, or fabrication of components.
				All errors and omissions are to be verified by the Builder/Contractor and referred to the designer prior to the commencement of works.



CLIENT

DANNY & NICOLE
CARTER

PROJECT ADDRESS 122 PITTWATER ROAD, MANLY 2095 DRAWING NO.

DA10


DATEFriday, June 12, 2020

DRAWING NAMEWINTER SOLSTICE 9 AM

SCALE 1:200 @A3



PITTWATER ROAD

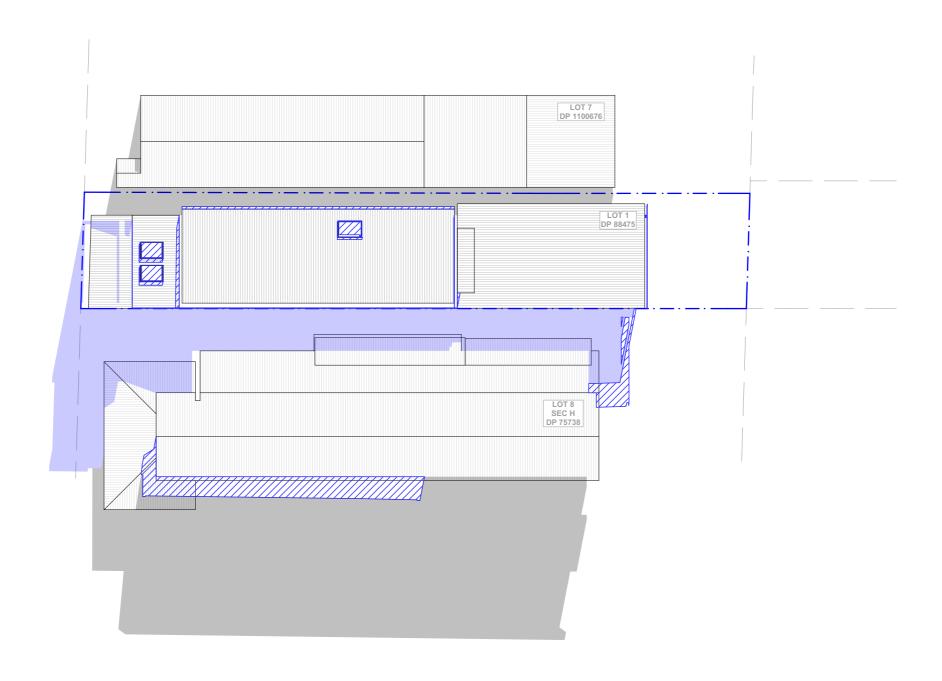

WINTER SOLSTICE 12PM 1:200



	REV.	DATE	COMMENTS	DRWN	This drawing is the copyright of Action Plans and not be	L
,	А	05/05/2020	DA DOCUMENTATION	EAS	altered, reproduced or transmitted in any form or by any means in part or in whole with the written permission of	
					Action Plans. Do not scale measure from drawings. Figured dimensions	2
					are to be used only. The Builder/Contractor shall check and verify all levels and	
u					dimensions on site prior to commencement of any work, creation of shop drawings, or fabrication of components.	
					All errors and omissions are to be verified by the Builder/Contractor and referred to the designer prior to the	
					commencement of works.	



CLIENT

DANNY & NICOLE
CARTER

PROJECT ADDRESS 122 PITTWATER ROAD, MANLY 2095 DRAWING NO.


DA11

DATE


Friday, June 12, 2020 **SCALE** 1:200 @A3

DRAWING NAME

WINTER SOLSTICE 12 PM

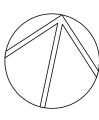


PITTWATER ROAD

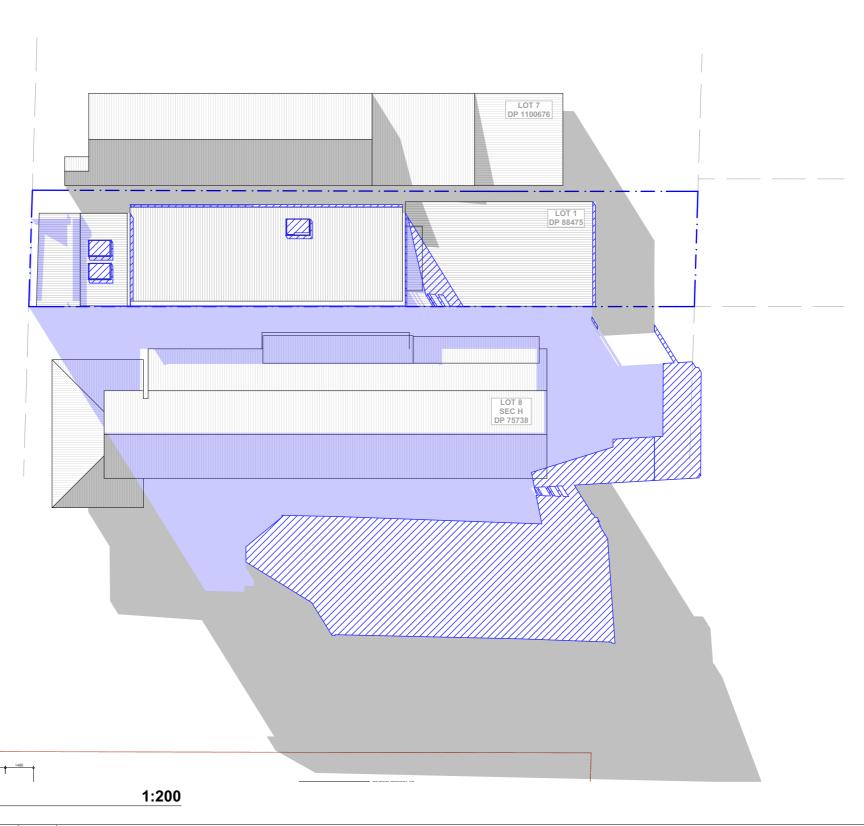

WINTER SOLSTICE 3PM

m: 0426 957 518
e:operations@actionplans.com.au
w: www.actionplans.com.au

	REV.	DATE	COMMENTS	DRWN	NOTES This drawing is the copyright of Action Plans and not be
	А	05/05/2020	DA DOCUMENTATION	EAS	altered, reproduced or transmitted in any form or by any means in part or in whole with the written permission of
					Action Plans.
					Do not scale measure from drawings. Figured dimensions are to be used only.
					The Builder/Contractor shall check and verify all levels and
u					dimensions on site prior to commencement of any work,
					creation of shop drawings, or fabrication of components. All errors and omissions are to be verified by the
					Builder/Contractor and referred to the designer prior to the
					commencement of works.

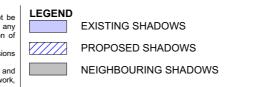

CLIENT

DANNY & NICOLE
CARTER


PROJECT ADDRESS 122 PITTWATER ROAD, MANLY 2095 DRAWING NO.

DA12

DATEFriday, June 12, 2020

DRAWING NAME
WINTER SOLSTICE 3 PM

SCALE 1:200 @A3

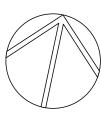

BASIX Certificate

Building Sustainability Index www.basix.nsw.gov.au

Alterations and Additions

Certificate number: A376411_02

This certificate confirms that the proposed development will meet the NSW government's requirements for sustainability, if it is built in accordance with the commitments set out below. Terms used in this certificate, or in the commitments, have the meaning given by the document entitled "BASIX Alterations and Additions Definitions" dated 06/10/2017 published by the Department. This document is available at www.basix.nsw.gov.au

Secretary
Date of issue: Friday, 15, May 2020
To be valid, this certificate must be lodged within 3 months of the date of issue.



Project name	122 Pittwater Road Manly_02
Street address	122 Pittwater Road Manly 2095
Local Government Area	Northern Beaches Council
Plan type and number	Deposited Plan 88475
Lot number	1
Section number	
Project type	
Dwelling type	Separate dwelling house
Type of alteration and addition	My renovation work is valued at \$50,000 or more and does not include a pool (and/or spa).

Certificate Prepared by (please complete before submitting to Council or PCA)					
Name / Company Name: Action Plans					
ABN (if applicable): 17118297587					

Fixtures and systems			Show on DA Plans	Show on CC/CDC Plans & specs	Certifier Check	
Lighting				•	•	
The applicant must ensure a minimum of 40% light-emitting-diode (LED) lamps.	of new or altered light fixtures are fitted with fluo	orescent, compact fluorescent, or		~	~	
Fixtures						
The applicant must ensure new or altered show	verheads have a flow rate no greater than 9 litre	es per minute or a 3 star water rating.		✓	✓	
The applicant must ensure new or altered toilet	s have a flow rate no greater than 4 litres per a	verage flush or a minimum 3 star water rating.		✓	✓	
The applicant must ensure new or altered taps	have a flow rate no greater than 9 litres per min	nute or minimum 3 star water rating.		✓		
Construction	Show on DA Plans	Show on CC/CDC Plans & specs	Certifier Check			
Insulation requirements						
the table below, except that a) additional insula	The applicant must construct the new or altered construction (floor(s), walls, and ceilings/roofs) in accordance with the specifications listed in the table below, except that a) additional insulation is not required where the area of new construction is less than 2m2, b) insulation specified is not required for parts of altered construction where insulation already exists.					
Construction	Additional insulation required (R-value)	Other specifications				
floor above existing dwelling or building.	nil					
external wall: brick veneer	external wall: brick veneer R1.16 (or R1.70 including construction)					
external wall: framed (weatherboard, fibro, metal clad)	R1.30 (or R1.70 including construction)					
external wall: other/undecided	R1.70 (including construction)					
flat ceiling, pitched roof	ceiling: R2.50 (up), roof: foil/sarking	medium (solar absorptance 0.475 - 0.70)				
flat ceiling, flat roof: framed	ceiling: R2.50 (up), roof: foil/sarking	medium (solar absorptance 0.475 - 0.70)				

metal clad)	,					
external wall: other/undecided	R1.70 (including construction)					
flat ceiling, pitched roof	ceiling: R2.50 (up), roof: foil/sarking	medium (solar absorptance 0.475 - 0.70)				
flat ceiling, flat roof: framed	ceiling: R2.50 (up), roof: foil/sarking	medium (solar absorptance 0.475 - 0.70)				
In these commitments, "applicant" mean	s the person carrying out the development.					
Commitments identified with a "\sqrt{"}" in the "Show on DA plans" column must be shown on the plans accompanying the development application for the proposed development (if a development application is to be lodged for the proposed development).						
Commitments identified with a "\rightarrow" in the "Show on CC/CDC plans & specs" column must be shown in the plans and specifications accompanying the application for a construction sertificate / complying development certificate for the proposed development.						

Commitments identified with a "\" in the "Certifier check" column must be certified by a certifying authority as having been fulfilled, before a final occupation certificate for the

Glazing requ	uirements							Show on DA Plans	Show on CC/CDC Plans & specs	Certifier Check
Windows and	d glazed do	ors								
					shading devices, in accordance or each window and glazed do		he specifications listed in the table below.	✓	✓	~
The following r	requirements	must also	be satisf	ied in relatio	on to each window and glazed	d door:			~	✓
have a U-value	Each window or glazed door with standard aluminium or timber frames and single clear or toned glass may either match the description, or have a U-value and a Solar Heat Gain Coefficient (SHGC) no greater than that listed in the table below. Total system U-values and SHGC must be calculated in accordance with National Fenestration Rating Council (NFRC) conditions.								✓	✓
have a U-value must be calcula	e and a Solar ated in accord	Heat Gai dance wit	n Coeffici h Nationa	ent (SHGC) I Fenestratio	no greater than that listed in	the table	r glazing, or toned/air gap/clear glazing must below. Total system U-values and SHGCs The description is provided for information		~	✓
					of each eave, pergola, verand than 2400 mm above the sill.		ony or awning must be no more than 500 mm	~	✓	✓
Pergolas with p	polycarbonate	roof or s	imilar trar	nslucent mat	terial must have a shading co	efficient	of less than 0.35.		✓	~
							h they are situated, unless the pergola also		~	✓
	g buildings or	vegetatio	on must b	e of the heig	tens must not be more than 5 tht and distance from the cent		he base of the window and glazed door, as	~	✓	✓
Windows a	nd glazed	doors g	lazing r	equireme	ents					
Window / door		Area of		adowing	Shading device		Frame and glass type			
no.		glass inc. frame (m2)	Height (m)	Distance (m)						
W1	N	1.98	2.65	1.46	eave/verandah/pergola/ba >=450 mm	lcony	standard aluminium, single clear, (or U-value: 7.63, SHGC: 0.75)			
W2	N	1.8	2.97	1.46	eave/verandah/pergola/ba >=450 mm	lcony	standard aluminium, single clear, (or U-value: 7.63, SHGC: 0.75)			
W3	N	2.52	0	0	eave/verandah/pergola/ba >=450 mm	lcony	standard aluminium, single pyrolytic low-e, (U-value: 5.7, SHGC: 0.47)			
W4	N	2.52	0	0	eave/verandah/pergola/ba >=450 mm	lcony	standard aluminium, single pyrolytic low-e, (U-value: 5.7, SHGC: 0.47)			
W5	N	1.08	0	0	eave/verandah/pergola/ba >=450 mm	lcony	standard aluminium, single pyrolytic low-e, (U-value: 5.7, SHGC: 0.47)			
W6	N	1.5	0	0	eave/verandah/pergola/ba >=450 mm	lcony	standard aluminium, single pyrolytic low-e, (U-value: 5.7, SHGC: 0.47)			
D1	E	9.82	0	0	eave/verandah/pergola/ba >=900 mm	lcony	standard aluminium, single clear, (or U-value: 7.63, SHGC: 0.75)			
D2	E	7.14	0	0	eave/verandah/pergola/ba >=900 mm	lcony	standard aluminium, single clear, (or U-value: 7.63, SHGC: 0.75)			
Skylights										
	must install th	e skyligh	ts in acco	rdance with	the specifications listed in the	e table b	elow.	~	~	✓
The following r	requirements	must also	be satisf	ied in relatio	on to each skylight:				~	~
Each skylight r		itch the d	escription	, or, have a	U-value and a Solar Heat Ga	in Coeff	icient (SHGC) no greater than that listed in		~	✓
		s must fu	ılly shade	the skylight	above which they are situate	ed when	fully drawn or closed.		~	_
Skylights g					<u>-</u>			1		_
Skylight numb		glazing		g device	Fran	me and	glass type			
S1	1.109	, _	externa	l adjustable		minium, 1, SHGC	moulded plastic single clear, (or U-value:			

Glazing require	Show on DA Plans	Show on CC/CDC Plans & specs	Certifier Check			
Skylight number	Area of glazing inc. frame (m2)	Shading device	Frame and glass type			
S2	1.109	external adjustable awning or blind	aluminium, moulded plastic single clear, (or U-value: 6.21, SHGC: 0.808)			
S3	1.109	external adjustable awning or blind	aluminium, moulded plastic single clear, (or U-value: 6.21, SHGC: 0.808)			

ACTION PLANS
m: 0426 957 518 e:operations@actionplans.com. w: www.actionplans.com.au

development may be issued.

	REV.	DATE	COMMENTS	DRWN	NOTES This drawing is the copyright of Action Plans and not be altered, reproduced or transmitted in any form or by any means in part or in	
	А	05/05/2020	DA DOCUMENTATION	EAS	I has drawing is the copyright of Action Plans and not be aftered, reproduced or transmitted in any form or by any means in part or in whole with the written permission of Action Plans. Do not scale measure from drawings. Figured dimensions are to be used only.	
					The Builder/Contractor shall check and verify all levels and dimensions on site prior to commencement of any work, creation of shop drawings, or fabrication of components.	(
					All errors and omissions are to be verified by the Builder/Contractor and referred to the designer prior to the commencement of works. All window & door dimensions, orientation, glazing materials, opening types, frame types are to be confirmed by a suitably qualified	F
ı					person prior to the ordering of any such materials are to take place. U value takes precedence over glazing type/colour in all cases. all new glazing must meet the BASIX specified frame and glass type, <i>QR</i> meet the certified U value and SHGC value.	1
					all new glazing must meet the BAOK specified frame and glass type, OK meet the certified o value and office value.	l IV

CLIENT DANNY & NICOLE CARTER


PROJECT ADDRESS 122 PITTWATER ROAD, MANLY 2095

DRAWING NO. **DA13**

DRAWING NAME BASIX COMMITMENTS

Friday, June 12, 2020

DATE

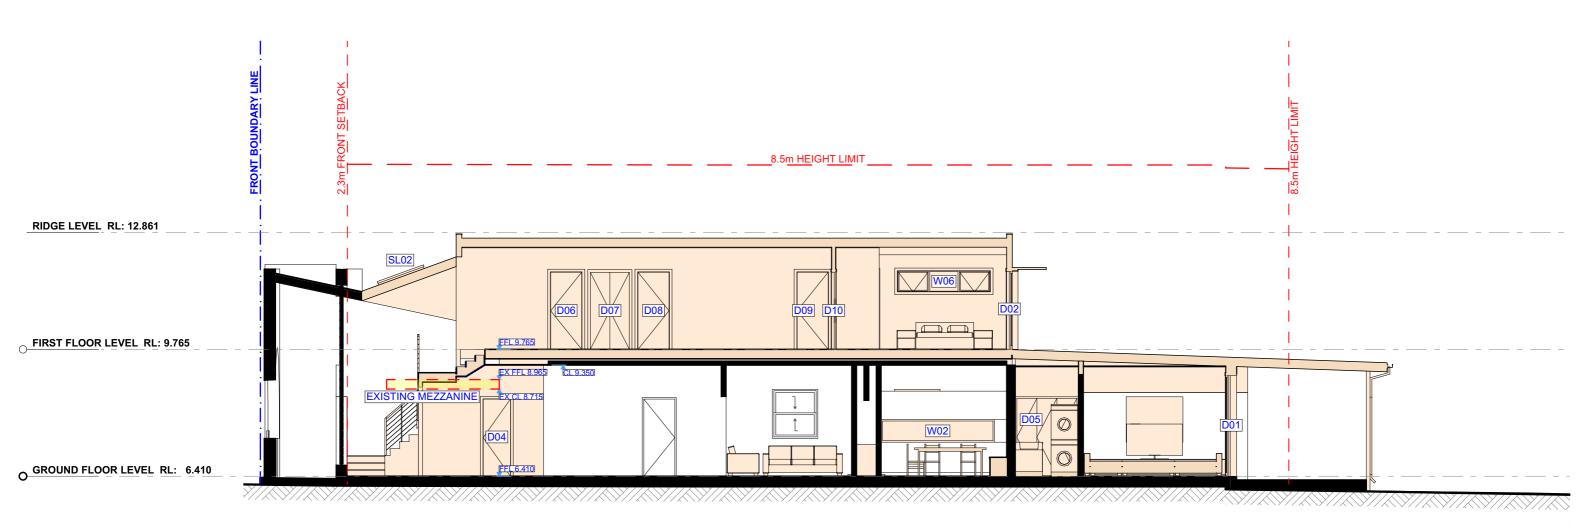


LONG SECTION 1:100

NOTE: EXTERNAL WALL LESS THAN 900mm FROM BOUNDARY TO COMPLY WITH NCC VOL 2 - 3.7.2.4 AND MEET FRL 60/60/60



	REV.	DATE	COMMENTS	DRWN	NOTES This drawing is the copyright of Action Plans and not be
	Α	05/05/2020	DA DOCUMENTATION	EAS	altered, reproduced or transmitted in any form or by any means in part or in whole with the written permission of
					Action Plans. Do not scale measure from drawings. Figured dimensions are to be used only. The Builder/Contractor shall check and verify all levels and
ı					dimensions on site prior to commencement of any work, creation of shop drawings, or fabrication of components. All errors and omissions are to be verified by the
					Builder/Contractor and referred to the designer prior to the commencement of works.

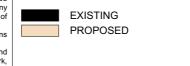

LEGEND

DRAWING NO. CLIENT DANNY & NICOLE CARTER PROJECT ADDRESS


DA14 DATE

DRAWING NAME LONG SECTION

122 PITTWATER ROAD, MANLY 2095

Friday, June 12, 2020

SCALE 1:100 @A3

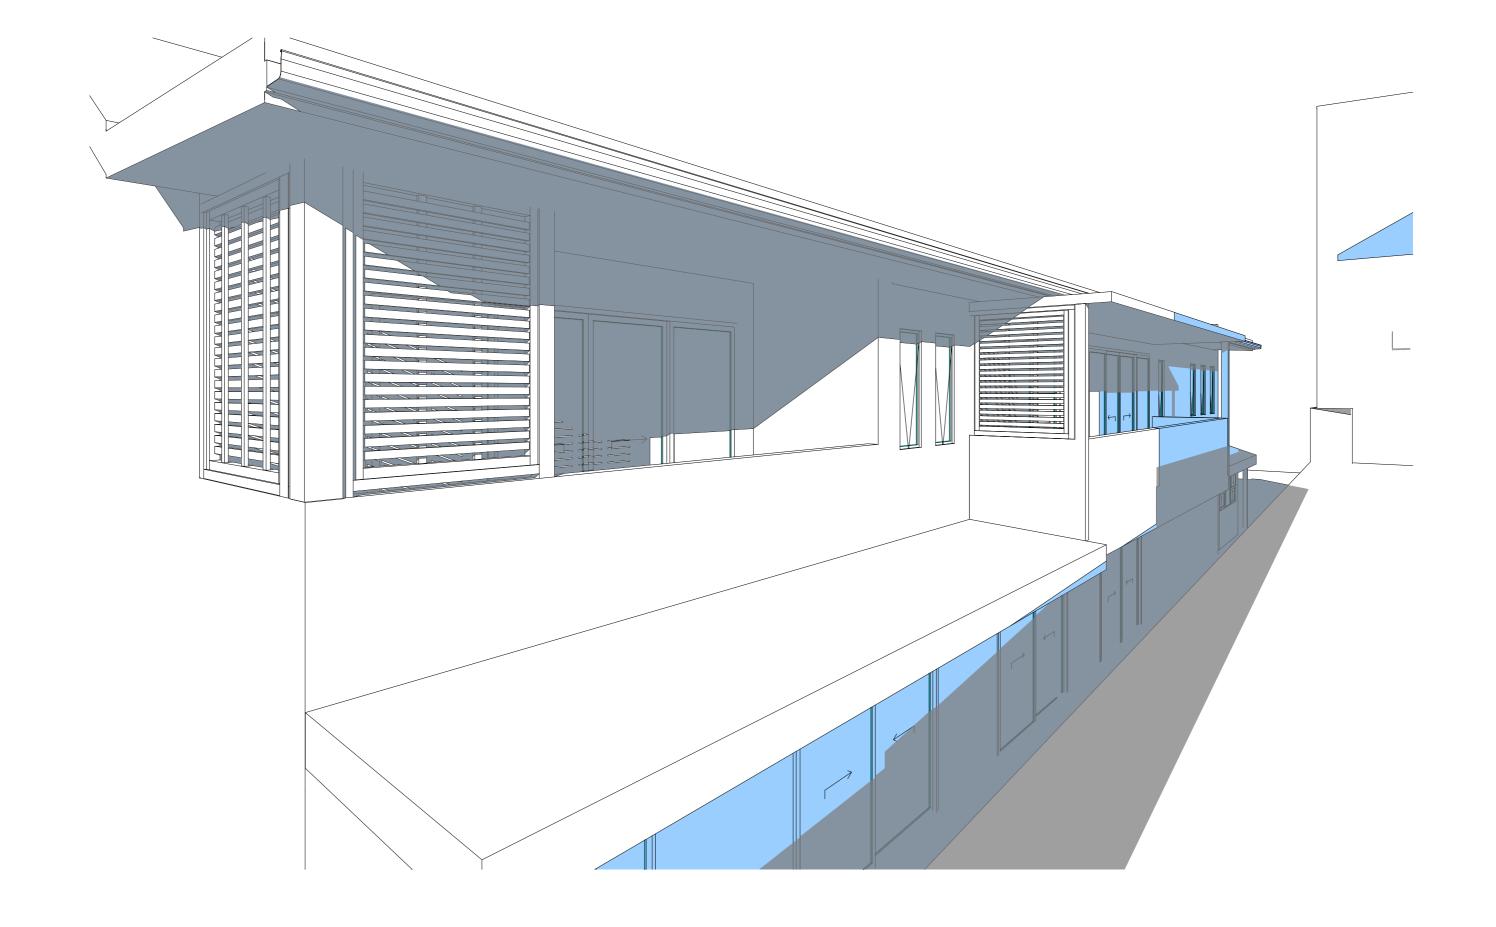



REV.	DATE	COMMENTS	DRWN	NOTES This drawing is the copyright of Action Plans and not be
A	05/05/2020	DA DOCUMENTATION	EAS	altered, reproduced or transmitted in any form or by any means in part or in whole with the written permission of Action Plans.
				Do not scale measure from drawings. Figured dimensions are to be used only.
				The Builder/Contractor shall check and verify all levels and dimensions on site prior to commencement of any work, creation of shop drawings, or fabrication of components.
				All errors and omissions are to be verified by the Builder/Contractor and referred to the designer prior to the commencement of works.

LEGEND

DANNY & NICOLE CARTER

CLIENT

PROJECT ADDRESS 122 PITTWATER ROAD, MANLY 2095 DRAWING NO.


DA15

DATE

0900 - 21 JUNE

DRAWING NAME

Friday, June 12, 2020

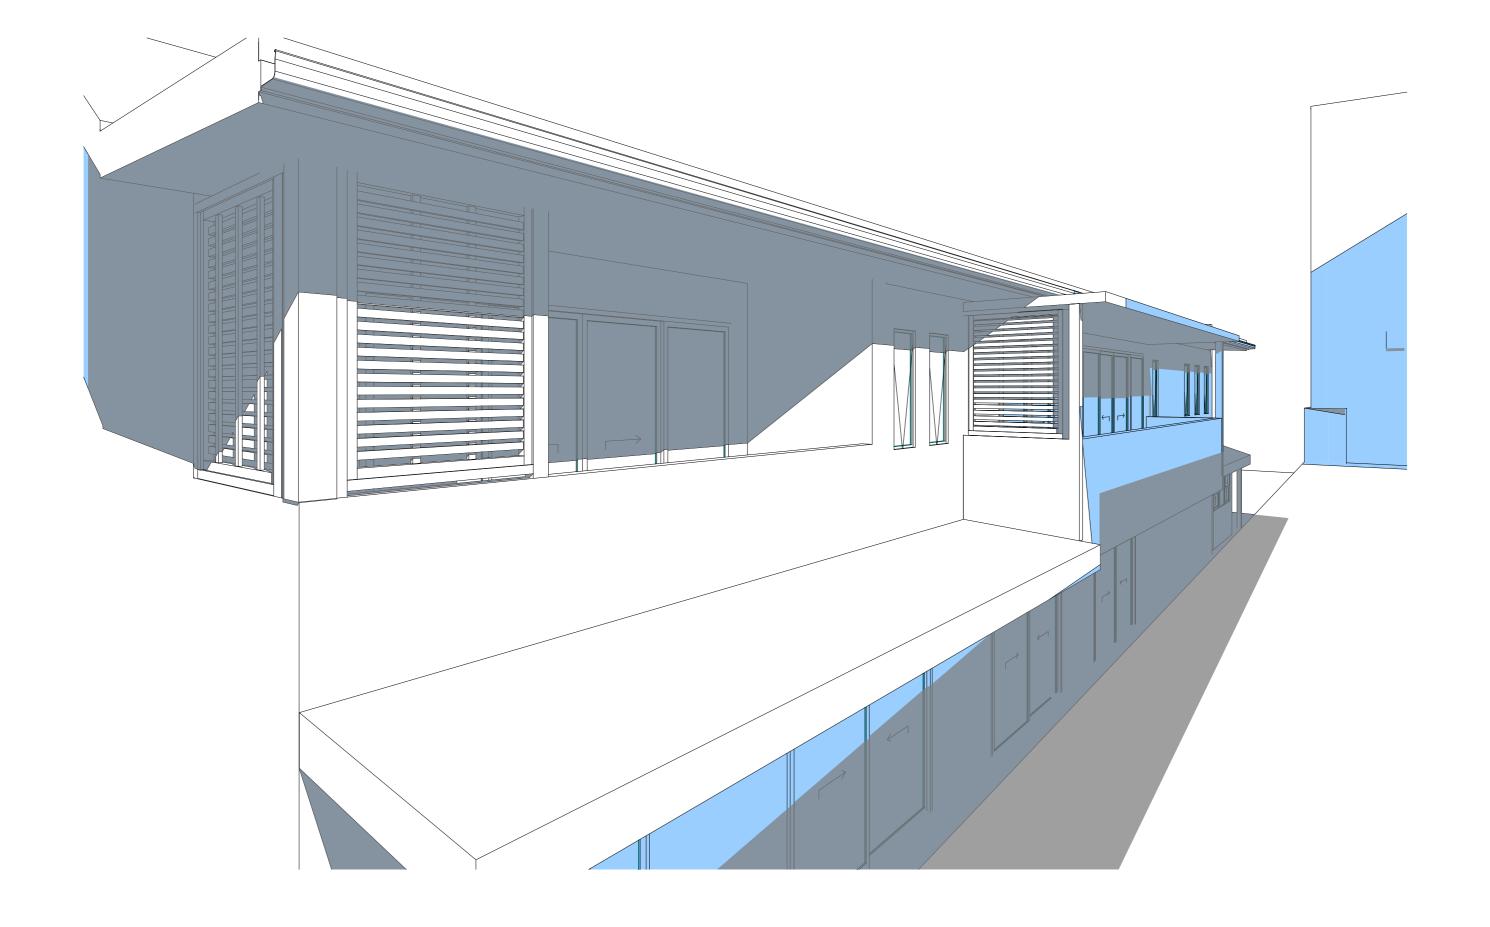



REV.	DATE	COMMENTS	DRWN	NOTES
A	05/05/2020	DA DOCUMENTATION	EAS	This drawing is the copyright of Action Plans and not be altered, reproduced or transmitted in any form or by any means in part or in whole with the written permission of Action Plans. Do not scale measure from drawings. Figured dimensions are to be used only.
				The Builder/Contractor shall check and verify all levels dimensions on site prior to commencement of any creation of shop drawings, or fabrication of component All errors and omissions are to be verified by Builder/Contractor and referred to the designer prior tommencement of works.

LEGEND

DANNY & NICOLE CARTER

CLIENT


PROJECT ADDRESS 122 PITTWATER ROAD, MANLY 2095 DRAWING NO.

DA16

DATE

DRAWING NAME 1200 - 21 JUNE

Friday, June 12, 2020

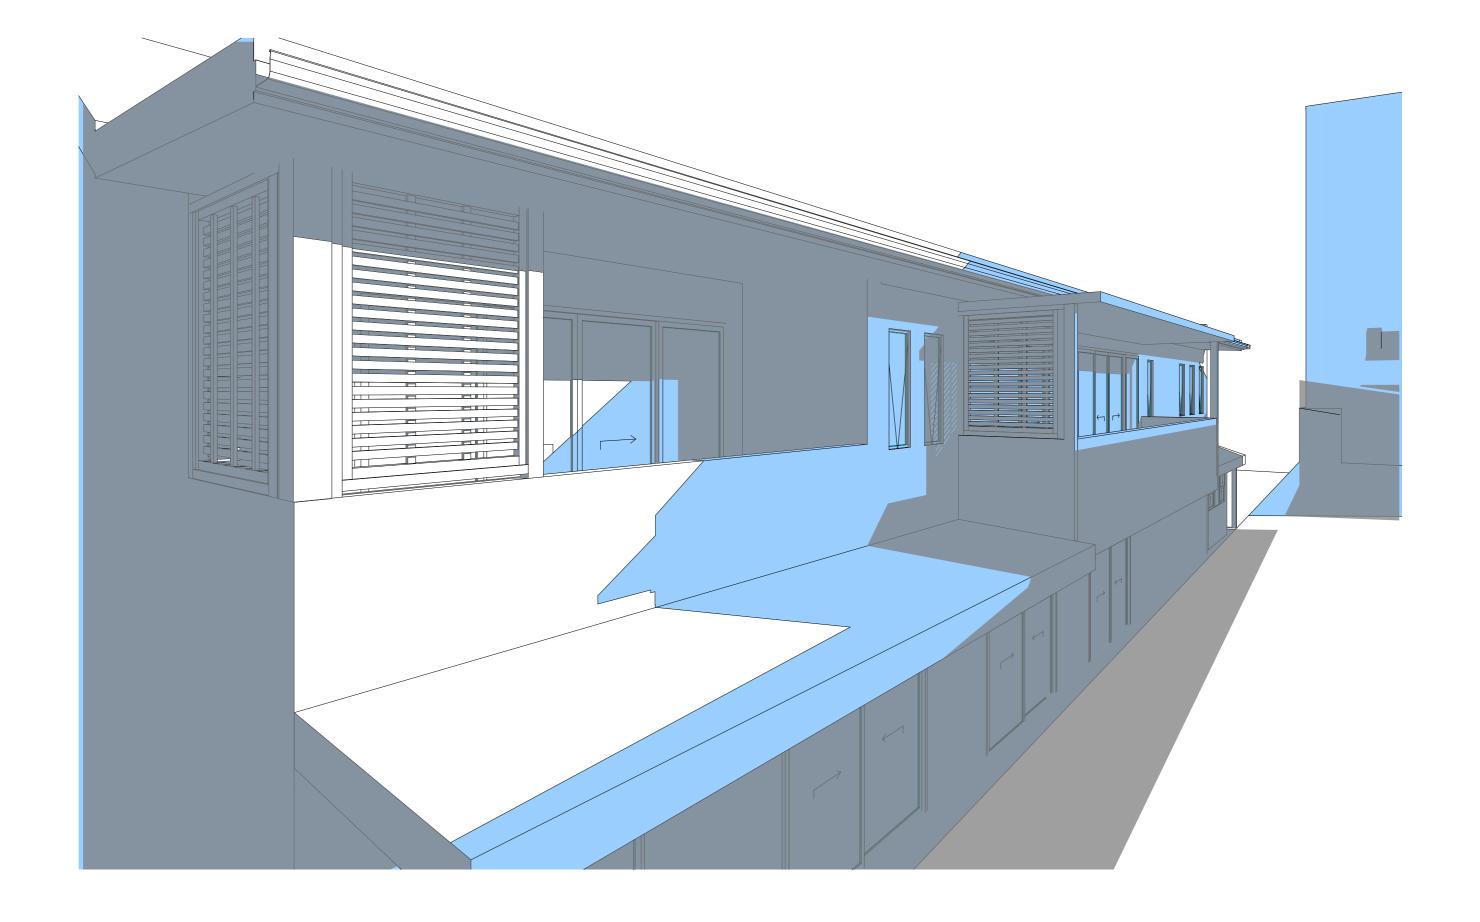



REV.	DATE	COMMENTS	DRWN	NOTES This drawing is the copyright of Action Plans and not
А	05/05/2020	DA DOCUMENTATION	EAS	altered, reproduced or transmitted in any form or by a means in part or in whole with the written permission
				Action Plans. Do not scale measure from drawings. Figured dimensio are to be used only.
				The Builder/Contractor shall check and verify all levels a dimensions on site prior to commencement of any wo creation of shop drawings, or fabrication of components.
				All errors and omissions are to be verified by t Builder/Contractor and referred to the designer prior to t commencement of works.

LEGEND

DANNY & NICOLE CARTER

CLIENT

PROJECT ADDRESS 122 PITTWATER ROAD, MANLY 2095 DRAWING NO.

DA17

DATE


Friday, June 12, 2020

SCALE

DRAWING NAME

1500 - 21 JUNE

@A3

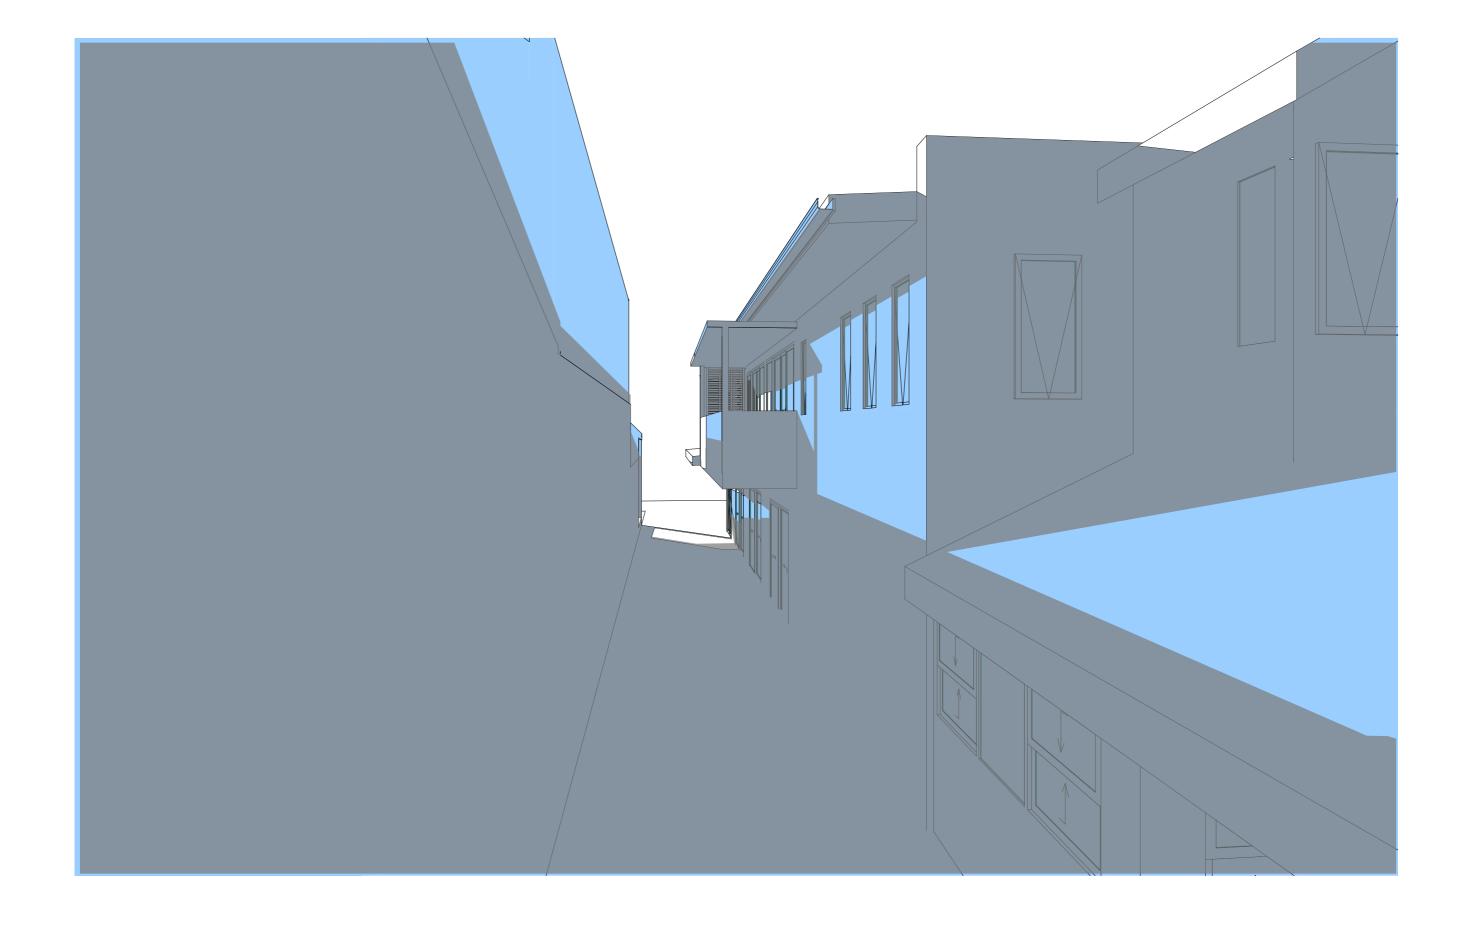



REV.	DATE	COMMENTS	DRWN	NOTES
А	05/05/2020	DA DOCUMENTATION	EAS	This drawing is the copyright of Action Plans and not be altered, reproduced or transmitted in any form or by any means in part or in whole with the written permission of
				Action Plans. Do not scale measure from drawings. Figured dimensions
				are to be used only. The Builder/Contractor shall check and verify all levels and
				dimensions on site prior to commencement of any work, creation of shop drawings, or fabrication of components.
				All errors and omissions are to be verified by the Builder/Contractor and referred to the designer prior to the
				commencement of works.

LEGEND

DANNY & NICOLE CARTER

CLIENT

PROJECT ADDRESS 122 PITTWATER ROAD, MANLY 2095 DRAWING NO.


DA18

DATE

0900 - 21 JUNE

DRAWING NAME

Friday, June 12, 2020

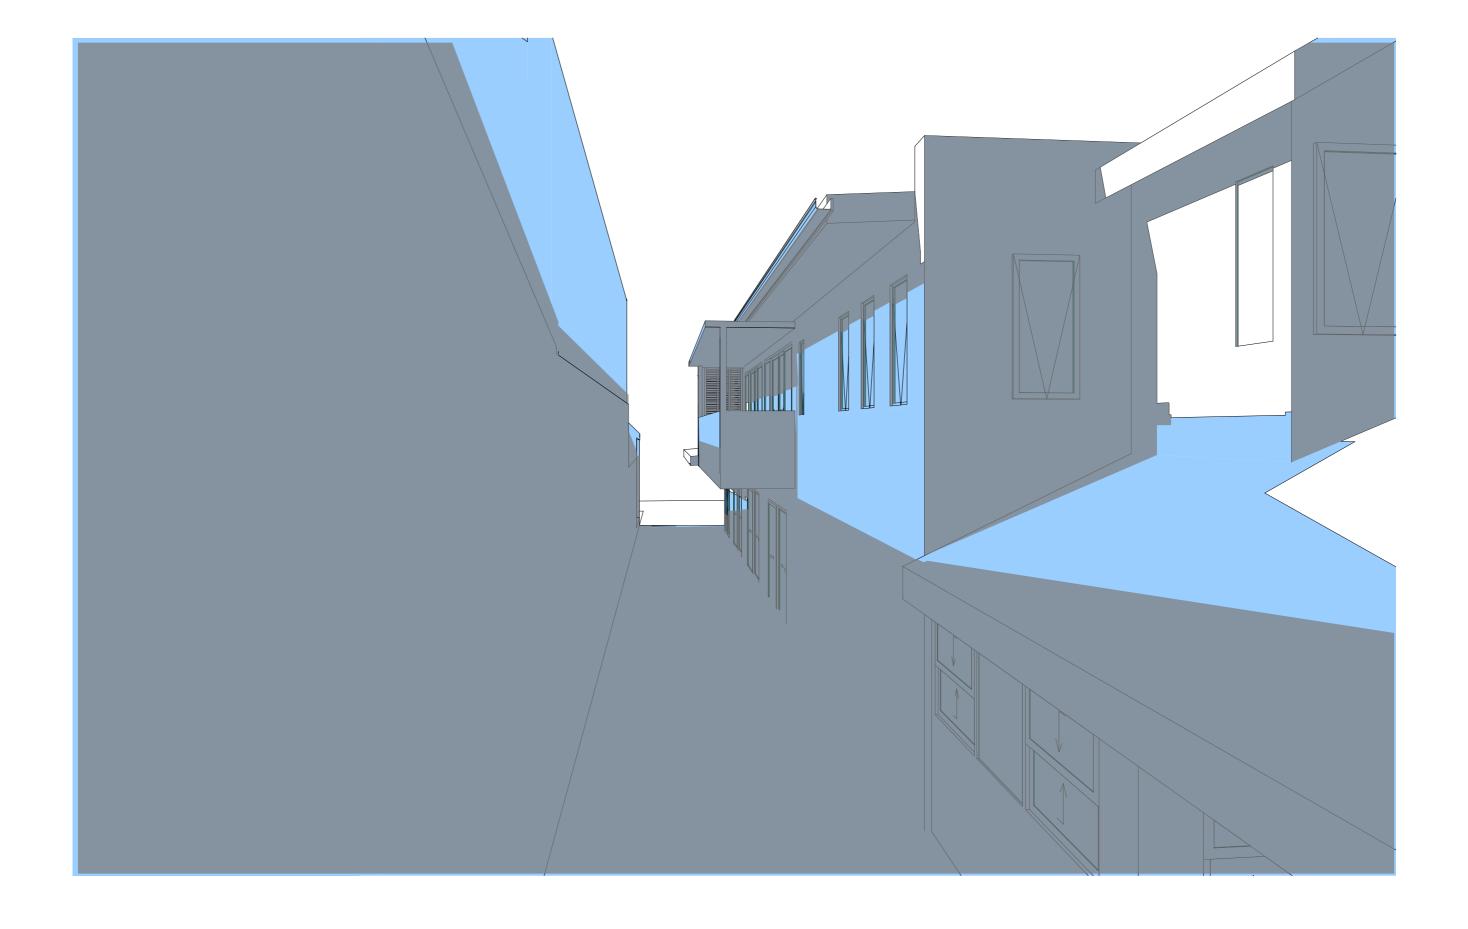



REV.	DATE	COMMENTS	DRWN	NOTES
А	05/05/2020	DA DOCUMENTATION	EAS	This drawing is the copyright of Action Plans and not be altered, reproduced or transmitted in any form or by any means in part or in whole with the written permission of Action Plans. Do not scale measure from drawings. Figured dimensions are to be used only. The Builder/Contractor shall check and verify all levels and dimensions on site prior to commencement of any work, creation of shop drawings, or fabrication of components. All errors and omissions are to be verified by the Builder/Contractor and referred to the designer prior to the
				commencement of works.

LEGEND

DANNY & NICOLE CARTER

CLIENT

PROJECT ADDRESS 122 PITTWATER ROAD, MANLY 2095 DRAWING NO.


DA19

DATE

1200 - 21 JUNE

DRAWING NAME

Friday, June 12, 2020

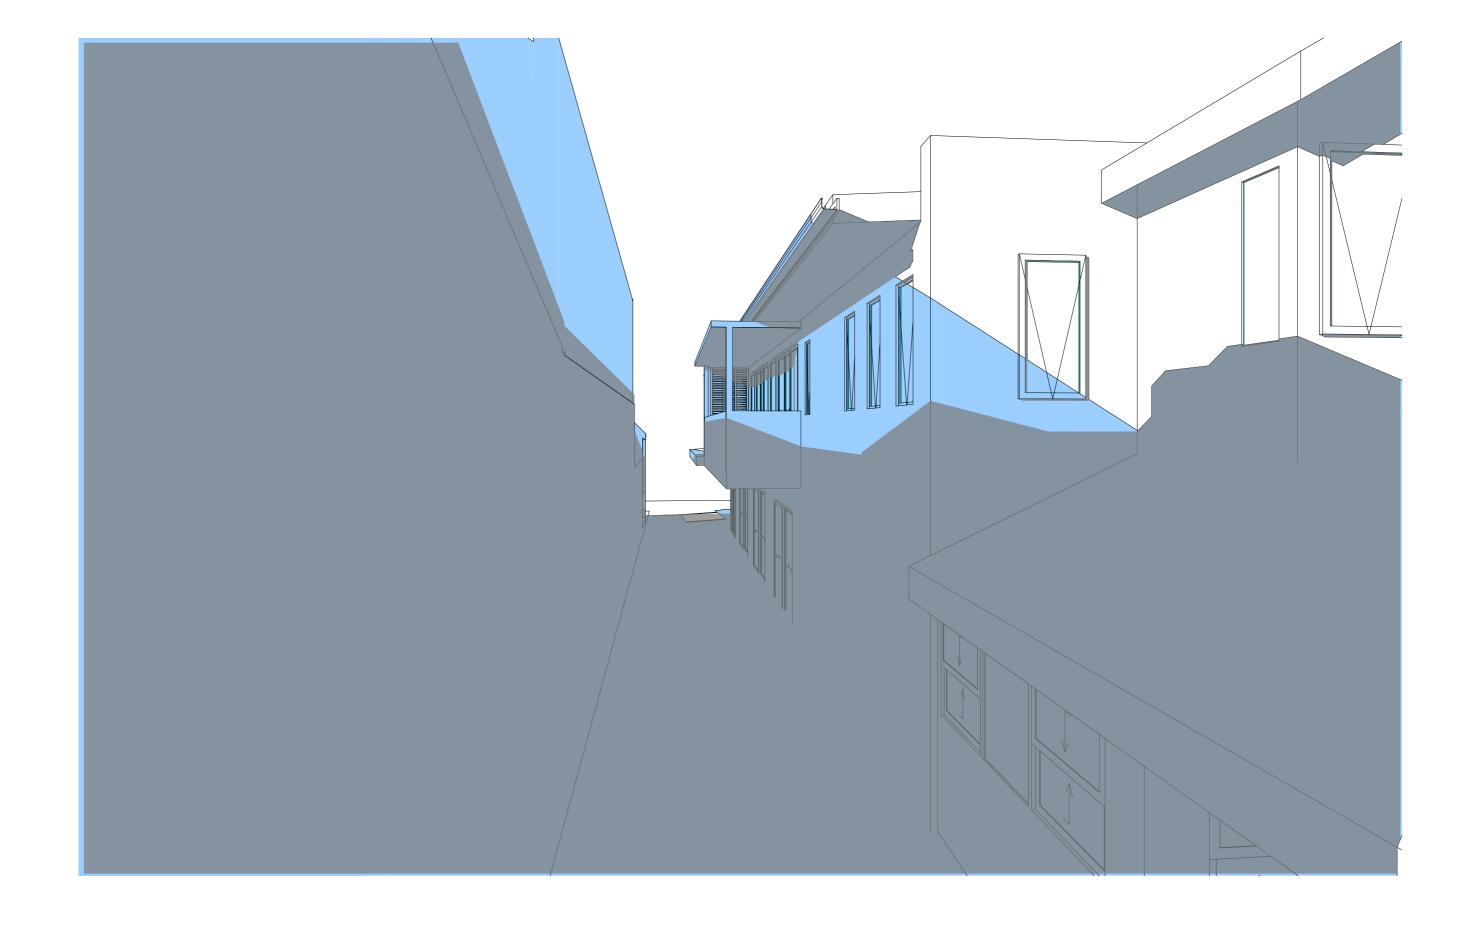

1:170.60



REV.	DATE	COMMENTS	DRWN	NOTES
A	05/05/2020	DA DOCUMENTATION	EAS	This drawing is the copyright of Action Plans and not be altered, reproduced or transmitted in any form or by any means in part or in whole with the written permission of Action Plans. Do not scale measure from drawings. Figured dimensions are to be used only. The Builder/Contractor shall check and verify all levels and dimensions on site prior to commencement of any work, creation of shop drawings, or fabrication of components. All errors and omissions are to be verified by the Builder/Contractor and referred to the designer prior to the commencement of works.

LEGEND

DANNY & NICOLE CARTER

CLIENT

PROJECT ADDRESS 122 PITTWATER ROAD, MANLY 2095 DRAWING NO.

DA20

DATE

Friday, June 12, 2020

DRAWING NAME 1500 - 21 JUNE

SCALE

@A3