


specifications. 
• All workmanship & materials shall be in accordance with the requirements of current editions


 All working amendments of the National Construction Code, relevant Australian Standards & local council requirements.
 New materials are to be used throughout unless otherwise noted.
 Concrete footings, slab, structural beams or any other structural members are to be designed. by a practicing engineer.

Division of JJ DRAFTING AUSTRALIA PTY LTD

П	REV:	DATE:	DESCRIPTION:
	Α	28.10.2021	AMENDMENTS TO PRELIM DRAWINGS
	В	10.12.2021	DA DRAWINGS ISSUED
	С	30.05.2022	RAINWATER PIPE UPDATED
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┑	PROJECT DETAILS: PROPOSED ALTERATIONS AND ADDITIONS 5 CAMBRIDGE AVE, NARRAWEENA.	DATE: MAR./21	DRAWN BY:	SCALE: 1:100 @ A3
	DRAWING TITLE: PROPOSED EAST & WEST ELEVATIONS	JOB No: 885/21	CHECKED BY:	DRAWING No: DA.10



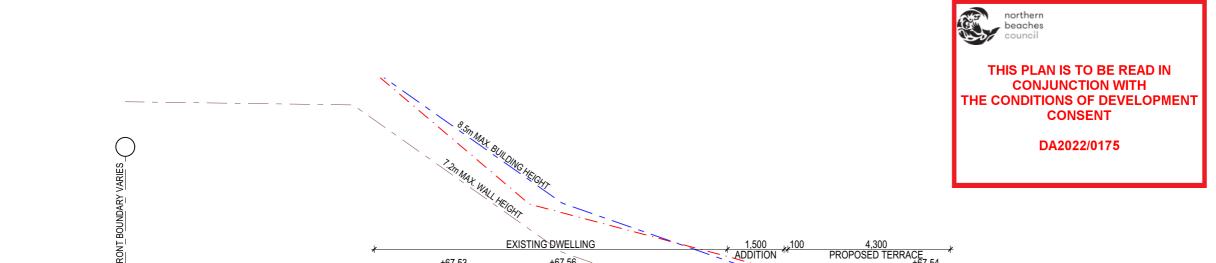
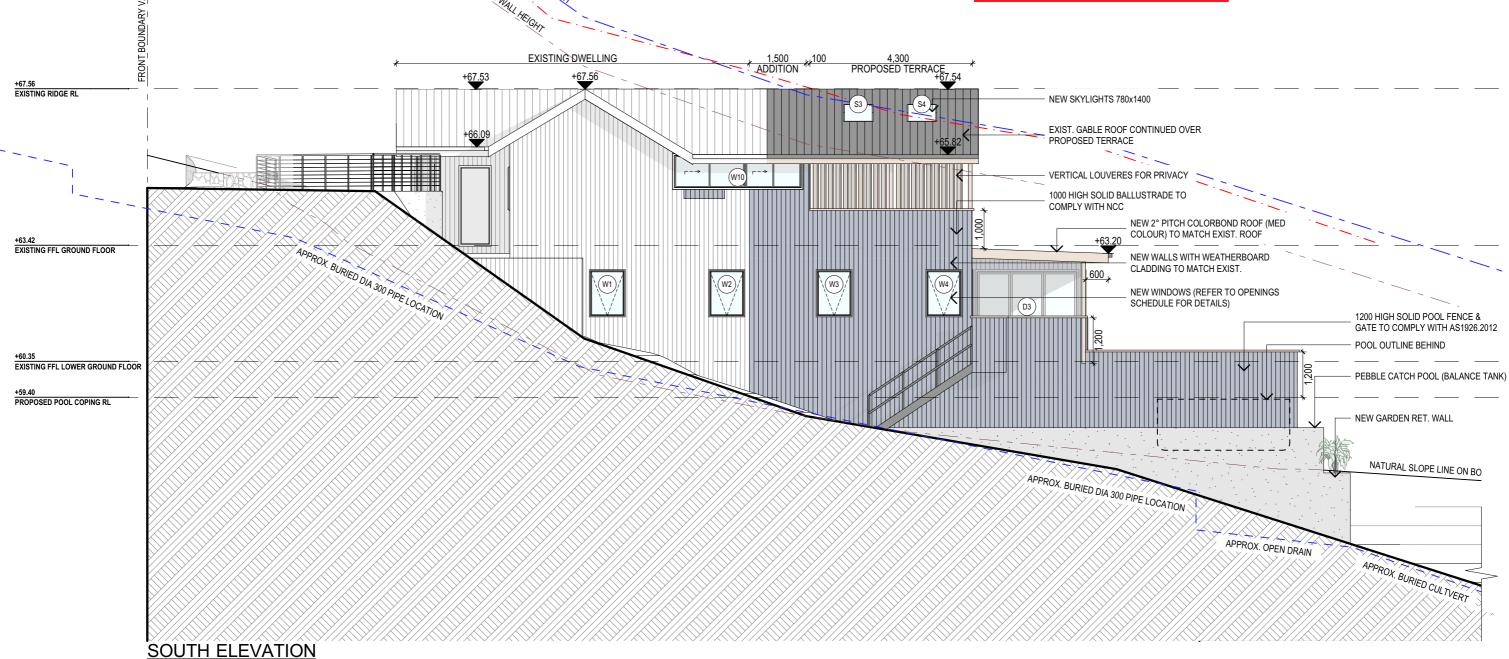
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- All structures including stormwater & drainage to engineer's details.

  Do not obtain dimensions by scaling drawings.

  All dimensions are to be checked on site prior to starting work.

  These drawings are to be read in conjunction with all other consultant's drawings and specifications.
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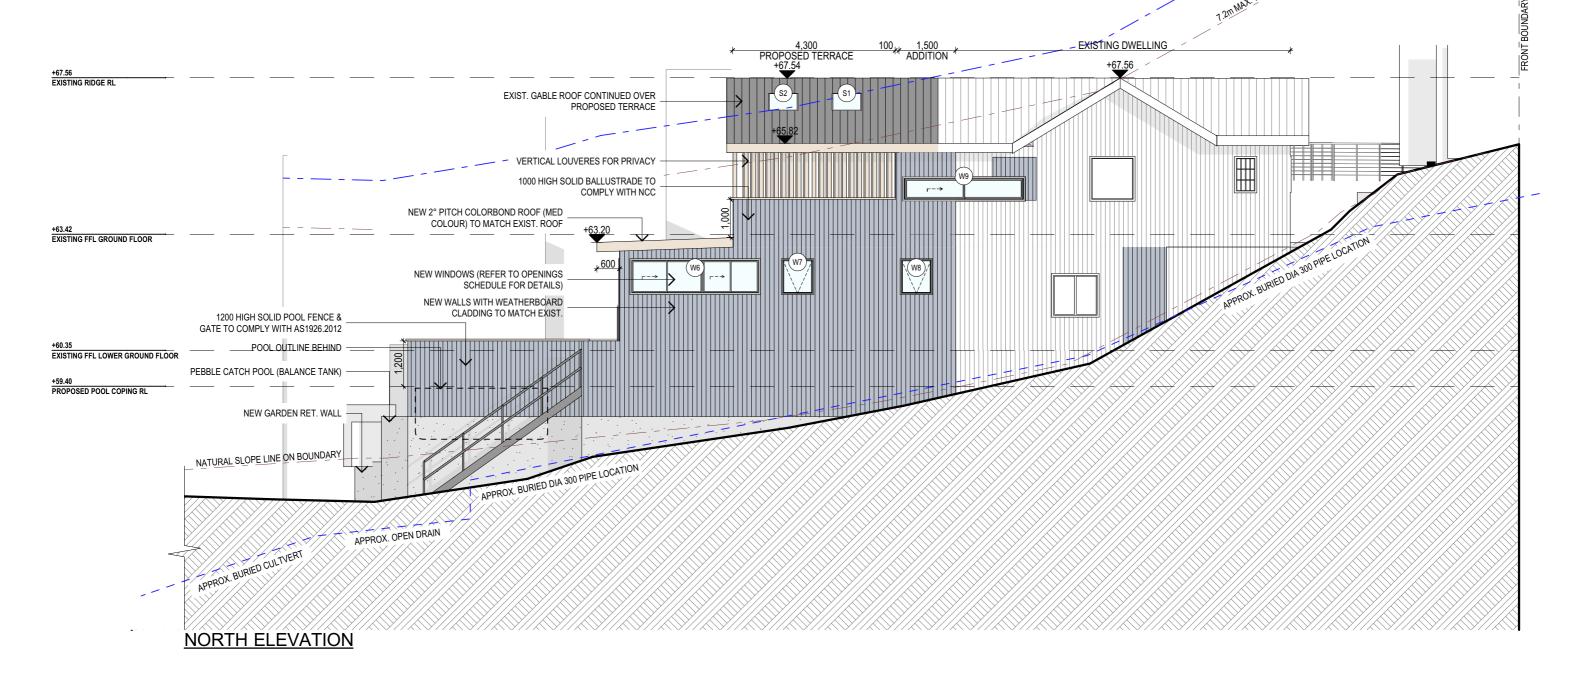
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# $\overline{JJ}$ Drafting

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1	PROJECT DETAILS: PROPOSED ALTERATIONS AND ADDITIONS 5 CAMBRIDGE AVE, NARRAWEENA.	DATE: MAR./21	DRAWN BY:	SCALE: 1:100 @ A3
	DRAWING TITLE: PROPOSED SOUTH ELEVATION	JOB No: 885/21	CHECKED BY:	DRAWING No:  DA.11





NOTES (E & OE)

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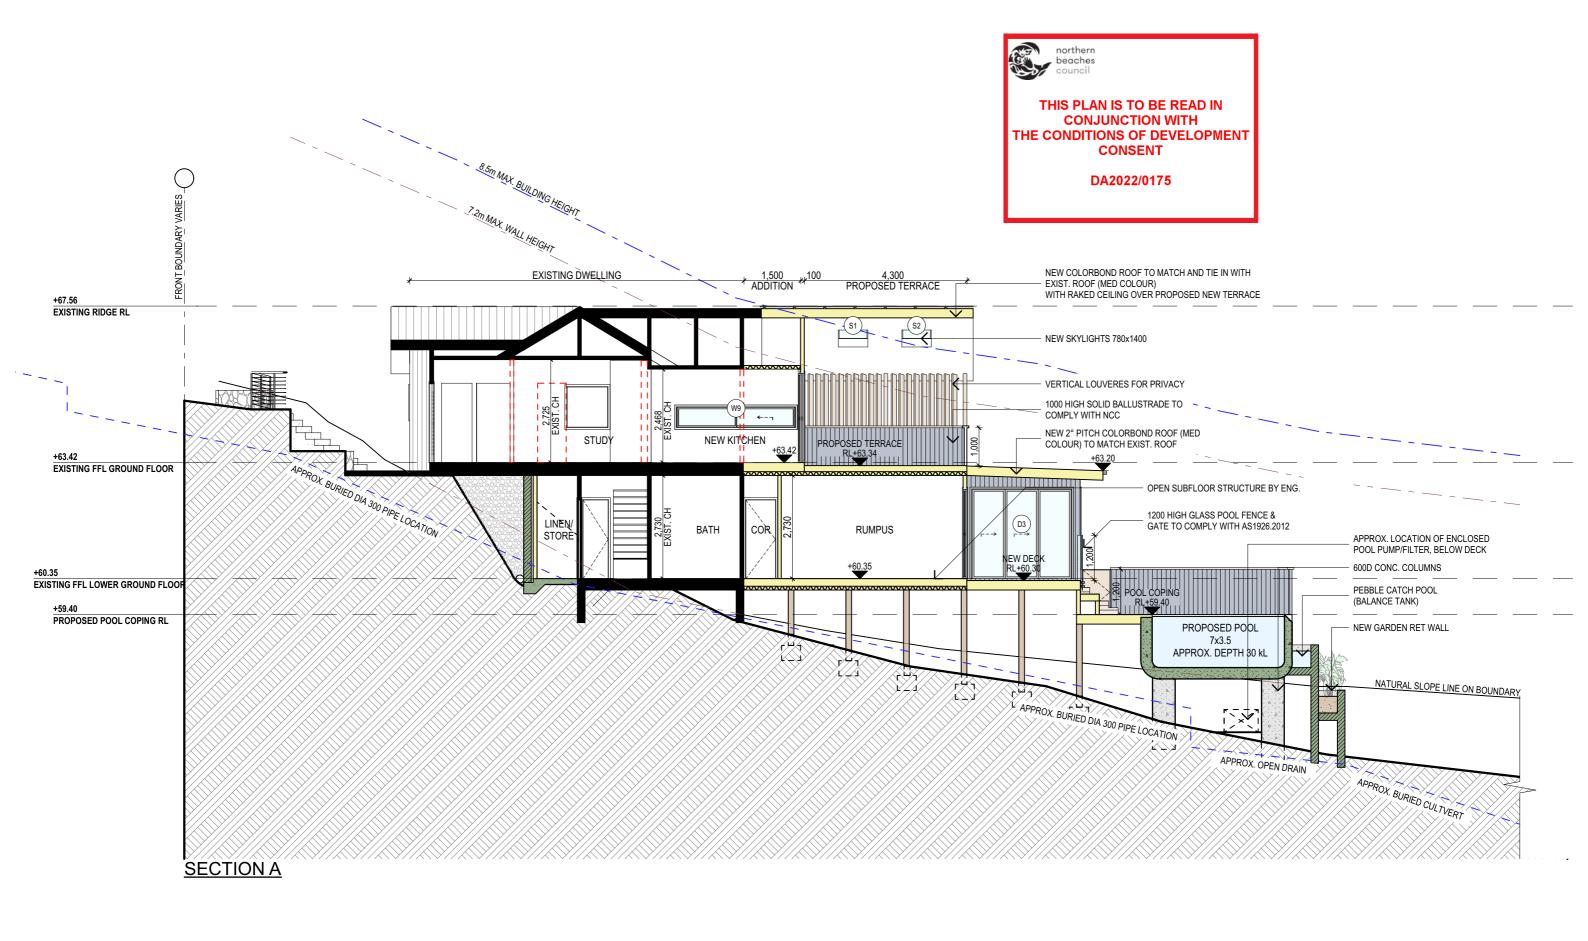
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DRAWING TITLE: PROPOSED NORTH ELEVATION	JOB No: 885/21	CHECKED BY:	DRAWING No: DA.12







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PROJECT DETAILS:	DATE:	DRAWN BY:	SCALE:	
PROPOSED ALTERATIONS AND ADDITIONS 5 CAMBRIDGE AVE, NARRAWEENA.	MAR./21	CA	1:100 @ A3	
DRAWING TITLE: SECTION A	JOB No: 885/21	CHECKED BY:	DRAWING No:	
	003/21	33	DA.13	

# **BASIX REQUIREMENTS**

# BASIX INCLUSIONS FOR 5 CAMBRIDGE AVE. NARRAWEENA

# **SWIMMING POOL**

- POOL MUST BE OUTDOOR - POOL MUST NOT HAVE A CAPACITY GREATER THAN 36KL

- POOL MUST HAVE A POOL COVER

- MUST INSTALL A POOL PUMP TIMER FOR THE POOL - MUST NOT INCORPORATE ANY HEATING SYSTEM FOR THE POOL

40% OF NEW OR ALTERED LIGHT FIXTURES TO BE FITTED WITH FLUORESCENT, COMPACT FLUORESCENT, OR LIGHT-EMITTING-DIODE (LED) LAMPS.

# WATER

SHOWER RATING TAP RATING MIN. 3 STARS MIN. 3 STARS WC RATING MIN. 3 STARS

### INSULATION

CONSTRUCTION ADDITIONAL INSULATION REQUIRED (R-VALUE)

uspended floor with open subfloor: framed (R0.7)\ R0.8 (down) (or R1.50 including construction)

Floor above existing dwelling or building

External wall: Framed (Weatherboard, fibro, Metal clad) R1.30 (or R1.70 including construction)

Flat ceiling, pitched roof Ceiling: R1.95 (up), Roof: foil backed blanket (55mm). Medium solar absorptanced 0.475 - 0.70)

Flat ceiling, flat roof; framed Ceiling: R2.08(up), Roof: foil backed blanket (55mm). Medium solar

### **GLAZING - DOORS & WINDOWS**

Standard aluminium, single clear, (or U-value: 7.63, SHGC: 0.75)

W1, W2, W3, W4, W7, D1, D2, D3, D4, D5

Standard aluminium, single pyrolytic low-e, (or U-value: 5.7, SHGC: 0.47)

W5. W6. W8. W9.

Timber, low-E internal/argon fill/clear external, (or U-value: 2.5, SHGC: 0.47)

S1, S2, S3, S4,

THE CONDITIONS OF DEVELOPMENT CONSENT BOUNDARY VARIES ( DA2022/0175 1200 HIGH GLASS POOL FENCE & GATE TO COMPLY WITH AS1926.2012 (W5)+60.35 600D CONC. COLUMNS EXISTING FFL LOWER GROUND FLOOR APPROX. LOCATION OF ENCLOSED POOL PUMP/FILTER, BELOW DECK PROPOSED POOL COPING RL PROPOSED POOL 7x3.5 APPROX. DEPTH 30 kL

# **SPECIFICATION NOTES**

PROVIDE PLASTERBOARD LINING

- INSTALL TO MANUFACTURERS SPECIFICATIONS & AS 2589

- BRICK VENEER WALLS WITH SELECTED BRICKS TO DWELLING.

- LIGHTWEIGHT TIMBER CLADDING OR SIMILAR TO SINGLE GARAGE/GYM.

# GROUND FLOOR TO BE REINFORCED CONCRETE SLAB IN ACCORDANCE WITH AS2870.

- FIRST FLOOR TO BE TIMBER FRAMED FINISHED WITH T&G HARDWOOD FLOORING

# - ALL WATERPROOFING TO AS 3740

- PROVIDE A GUARANTEED FLEXIBLE WATERPROOF MEMBRANE TO ALL WET AREA FLOORS & SHOWERS WALLS TO MANUFACTURES INSTRUCTIONS

SHALL BE INSTALLED TO COMPLY WITH AS1684 AS AMENDED FOR TIMBER COMPONENTS OR AS3620 FOR LIGTHWEIGHT STEEL FRAMING SECTIONS OR AS PER THE NASH ALTERNATIVES TO AS 3623.

- SHALL BE INSTALLED IN ACCORDANCE WITH AS3660.

# PROFILED STEEL ROOF:

NCC VOL 2 PART 3.5.1

- DESIGN AND INSTALLATION SHALL BE IN ACCORDANCE WITH AS/NZS 1562.

ROOFING:
- COLORBOND ROOF CLADDING

- SHALL BE IN ACCORDANCE WITH NCC VOL.1 PART B1.4 OR VOL.2 PART 3.2.3.

- ALL WORKMANSHIP AND MATERIALS SHALL BE IN ACCORDANCE WITH CURRENT EDITIONS OF THE

FOOTINGS TO BE IN ACCORDANCE WITH AS1480.

- FOOTINGS TO BE IN ACCORDANCE WITH NCC VOL.2 PARTS 3.2.3, 3.2.4 AND 3.2.5

# - ALL REINFORCEMENTS SHALL CONFORM TO AS1302, AS1303 AND AS1304

northern beaches

THIS PLAN IS TO BE READ IN **CONJUNCTION WITH** 

BRICK AND BLOCKWORK:
- CONSTRUCTION OF MASONRY BUILDINGS SHALL BE AS PER AS3700 OR AS4773.

TIMBER TO COMPLY WITH AS1170.2 OR AS4055.

- ALL WORKMANSHIP AND MATERIALS SHALL BE IN ACCORDANCE WITH AS1684 AND 1720 AS APPLICABLE.

- TO COMPLY WITH NCC VOL 2 PART 3 4

- GROUND FLOOR TIMBERS SHALL BE ONLY OF HARDWOOD, CYPRESS PINE OR PRESSURE TREATED RADIATA OR CANADA PINE BELOW A HEIGHT OF 300mm ABOVE FINISHED GROUND LEVEL AND MUST NOT BE BUILT INTO BRICKWORK.

- SUBFLOOR VENTILATION SHALL CONFORM TO NCC VOL.2 PART 3.4.1.
- IN BUSHFIRE PRONE AREAS SPECIAL CONDITIONS APPLY.
- WHERE TERMITE BARRIERS NEED TO BE INSPECTED, 400mm CLEARANCE IS REQUIRED BETWEEN THE UNDERSIDE OF BEARER AND GROUND SURFACE.
- USE TREATED TIMBER WHERE REQUIRED FOR DURABILITY.
- DO NOT USE TIMBER UNSUITABLE FOR EXPOSURE TO MOISTURE IN EXPOSED LOCATION. PROVIDE STRUCTURE BRACING IN ACCORDANCE WITH AS1684
- PROVIDE STRUCTURE TIEDOWN IN ACCORDANCE WITH AS1684
- USE GALVANISED FIXINGS WHERE EXPOSED TO WEATHER.

# TERMITE CONTROL:

TO BE IN ACCORDANCE WITH TO AS3660 1

SHALL BE IN ACCORDANCE WITH NCC VOL.2 PART 3.1.3 OR VOL.1 PART B1.4.

# FLASHING AND CAPPINGS:

- SELECTION AND INSTALLATION OF METAL RAINWATER GOODS REFER TO AS2180

- FLASH PROJECTIONS ABOVE THE ROOF WITH TWO PART FLASHINGS CONSISTING OF AN APRON

FLASHING AND OVER FLASHING, WITH AT LEAST 100mm OVERLAP. PROVIDE FOR INDEPENDENT MOVEMENT BETWEEN ROOF AND PROJECTION.

# CONCRETE BLOCKS OR BRICKS:

TO COMPLY WITH TO AS4455 MANSORY BUILDING BLOCKS/PAVER.

SECTION B - POOL

- 40% OF NEW OR ALTERED LIGHT FIXTURES TO BE FITTED WITH FLUORESCENT, COMPACT

# DOOR & WINDOWS:

- ALL FRAMED WINDOWS SHALL BE INSTALLED IN ACCORDANCE WITH AS2047-48 FOR ALUMINIUM WINDOWS AND AS2047 FOR TIMBER WINDOWS.

ALUMINIUM FRAMED WINDOWS AND DOORS

- WEATHER STRIPPING IS TO BE PROVIDED TO ALL EXTERNAL WINDOWS AND DOORS.

# STAIRS, HANDRAILS AND BALUSTRADES:

- NCC VOL.2 PARTS 3.9.1 AND 3.9.2

RELATIONSHIP OF RISER TO GOING SHALL BE BETWEEN 1:2 AND 1:1.35 UNLESS OTHERWISE DIRECTED TO GOING SHALL BE BETWEEN 1:2 AND 1:1.35 UNLESS OTHERWISE DIRECTED OR AS PERMITTED IN

BALUSTRADES SHALL BE PROVIDED TO ALL LANDINGS, RAMPS, DECKS, ROOFS AND OTHER ELEVATED PLATFORMS WHERE THE VERTICAL DISTANCE FROM THAT LEVEL IS MORE THAN 1m ABOVE THE ADJOINING FLOOR OR FINISHED GROUND LEVEL.

- THE HEIGHT OF BALUSTRADE MUST BE A MINIMUM OF 1m HIGH ABOVE LANDING AND NOT LESS THAN 865mm ABOVE THE NOSINGS OF ANY STAIR TREADS OR FLOOR RAMP AND HAVE NO OPENING GREATER THAN 125mm

THE HEIGHT OF BALUSTRADE TO THE NEW STAIR CASES IS TO BE MEASURED A MINIMUM 865mm ABOVE THE NOSING LINE AND HAVE NO OPENING GREATER NO OPENING GREATER THAN 125mm

- MATERIALS TO BE USED FOR SURFACES OF FLOORS, STAIR LANDING, STEPS AND NOSINGS SHALL BE IN ACCORDANCE WITH THE CLASSIFICATIONS FOR SLIP RESISTANCE AS APPLY IN AS4586 AND HB198

# STORMWATER:

# EAVES GUTTERS, VALLEY GUTTERS AND DOWPIPES

- TO COMPLY WITH AS/NZS 2179 FOR METAL AND AS1273 FOR UPVC COMPONENTS.
- NEW DOWNPIPES TO BE CONNECTED INTO EXISTING STORMWATER LINE

- COLORBOND GUTTERS AND DOWNPIPES
- MINIMUM SLOPE OF FAVES AND GUTTERS 1:200

- NCC VOL.1 PARTS B 1.4, D 3.12, F1.13 OR NCC VOL.2 PART 3.6

# SMOKE DETECTORS/ALARMS:

ONCE VOL 2 PART 3.7.2, FIRE/SMOKE DETECTORS COMPLYING WITH THE REQUIREMENTS OF THE LOCAL GOVERNMENT ACT AND/OR STATE OR TERRITORY REGULATIONS MUST BE FITTED IN THE LOCATIONS REQUIRED AND APPROVED BY THE AUTHORITY AND SHALL BE INSTALLED IN ACCORDANCE WITH AS3786. - INSTALLATIONS IN BUILDINGS OTHER THAN CLASS 1 AND 10 MUST BE INSTALLED AND MANAGED TO COMPLY WITH NCC SPEC. E2.2a.

- MULTIPLE ALARMS WITHIN HOUSES AND SOLE OCCUPANCY UNITS MUST BE HARD WIRED AND INTERCONNECTED.

# WASTE MANAGEMENT:

SEDIMENT CONTROL:

- ALL WASTE SHALL BE TAKEN AWAY BY TRUCKS TO A SUITABLE LANDFILL OR RECYCLE DEPOT. - ALL WASTE SHALL BE COVERED DURING TRANSPORTATION.

- WASTE GENERATED DURING CONSTRUCTION SHALL BE PLACED IN STEEL BINS AND TAKEN AWAY BY AN APPROVED CONTRACTOR TO A APPROVED LANDFILL SITE.

# STORMWATER SYSTEM

- A FILTER CLOTH SYSTEM SHALL BE INSTALLED TO STOP ANY SEDIMENT ENTERING COUNCILS

# NOTE:

ALL PLANS ARE TO BE READ IN CONJUNCTION AND COMPLY WITH THE BASIX CERTIFICATE. BUSHFIRE AND GEOTECH REPORTS.

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