

ACTION PLANS

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PLANS PUBLISHED 10 December 2021

DEVELOPMENT APPLICATION

These plans are for Council Approval only.

SHEET NUMBER	SHEET NAME	DATE PUBLISHED
DA00	COVER	10/12/2021
DA01	NOTATION	10/12/2021
DA02	SAFTEY NOTES	10/12/2021
DA03	SITE ANALYSIS	10/12/2021
DA04	SITE / ROOF / SEDIMENT EROSION / WASTE MANAGEMENT / STORMWATER CONCEPT PLAN	10/12/2021
DA05	EXISTING LOWER GROUND FLOOR PLAN	10/12/2021
DA06	EXISTING GROUND FLOOR PLAN	10/12/2021
DA07	EXISTING FIRST FLOOR PLAN	10/12/2021
DA08	PROPOSED LOWER GROUND FLOOR PLAN	10/12/2021
DA09	PROPOSED GROUND FLOOR PLAN	10/12/2021
DA10	PROPOSED FIRST FLOOR PLAN	10/12/2021
DA11	NORTH / EAST ELEVATION	10/12/2021
DA12	SOUTH / WEST ELEVATION	10/12/2021
DA13	LONG / CROSS SECTION	10/12/2021
DA14	AREA CALCULATIONS / SAMPLE BOARD	10/12/2021
DA15	FLOOR AREA CALCULATIONS	10/12/2021
DA16	WINTER SOLSTICE 9 AM	10/12/2021
DA17	WINTER SOLSTICE 12 PM	10/12/2021
DA18	WINTER SOLSTICE 3 PM	10/12/2021
DA19	BASIX COMMITMENTS	10/12/2021

ITEM DETAILS	DEVELOPMENT APPLICATION									
ADDRESS	19 WEST STREET, BALGOWLAH 2093									
LOT & DP/SP	LOT B DP 401309									
COUNCIL	NORTHERN BEACHS COUNCIL (MANLY)	NORTHERN BEACHS COUNCIL (MANLY)								
SITE AREA	682.9m²									
FRONTAGE	15.24m									
CONTROLS	PERMISSIBLE / REQUIRED	EXISTING	PROPOSED	COMPLIANCE						
CONTROLS	m / m² / %	m / m² / %	m / m² / %							
<u>LEP</u>										
LAND ZONING	R1 – GENERAL RESIDENTIAL	R1	R1	YES						
MINIMUM LOT SIZE	500m²	682.9m²	UNCHANGED	YES						
FLOOR SPACE RATIO	0.45: 1 (307.30m²)	0.35: 1 (239m²)	0.39:1 (263.74m²)	YES						
MAXIMUM BUILDING HEIGHT	8.5m	8.475m	UNCHANGED	YES						
HAZARDS										
ACID SULFATE SOILS	NOT IDENTIFIED	N/A	N/A	N/A						
DCP										
RESIDENTIAL OPEN SPACE	AREA OS3									
TOTAL OPEN SPACE	55% (375.59m²)	56.22% (383.96m²)	58.7% (401.18m²)	YES						
OPEN SPACE ABOVE GROUND	MAX. 25% OF TOS (55%): 93.89m ²	-	33.84m²	YES						
LANDSCAPE AREA	35% OF TOS ACTUAL: 121.83m ²	89.66% (344.27m²)	66% (229.85m²)	YES						
PRINCIPAL PRIVATE OPEN SPACE	18m²	239.80m²	UNCHANGED	YES						
FRONT SETBACK	PREVALING BULDING LINE: 6m	10.721m	10.671m	YES						
REAR SETBACK	8.0m	15.234m	UNCHANGED	YES						
SIDE SETBACKS	1/3 WALL HEIGHT	N: 1.187m S: 0.900m	UNCHANGED	YES						

19 WEST STREET, BALGOWLAH NSW 2093



NCC & AS COMPLIANCES SPECIFICATIONS

- EARTHWORKS PART 3.1.1 OF NCC
- EARTH RETAINING STRUCTURES PART 3.1.2 OF NCC
- DRAINAGE PART 3.1.3 OF NCC
- TERMITE-RISK MANAGEMENT PART 3.1.4 OF NCC
- FOOTINGS & SLAB PART 3.2 OF NCC INCLUDING AS 2870-2011
- MASONRY PART 3.3 OF NCC INCLUDING AS 3700:2018
- FRAMING PART 3.4 OF NCC
- SUB FLOOR VENTILATION PART 3.4.1 OF NCC
- ROOF CLADDING AND WALL-CLADDING PART 3.5 OF NCC GLAZING PART 3.6 OF NCC INCLUDING AS 1288
- FIRE SAFETY PART 3.7 OF NCC
- FIRE SEPARATION OF EXTERNAL WALLS PART 3.7.2 OF NCC
- FIRE PROTECTION OF SEPARATING WALLS AND FLOORS- PART 3.7.3 OF NCC
- SMOKE ALARMS PART 3.7.5 OF NCC
- WET AREAS AND EXTERNAL WATERPROOFING PART 3.8.1 OF NCC
- ROOM HEIGHTS PART 3.8.2 OF NCC
- FACILITIES PART 3.8.3 OF NCC
- LIGHT PART 3.8.4 OF NCC
- VENTILATION PART 3.8.5 OF NCC - SOUND INSULATION - PART 3.8.6 OF NCC
- STAIRWAYAND RAMP CONSTRUCTION PART 3.9.1 OF NCC
- BARRIERS AND HANDRAILS PART 3.9.2 OF NCC
- SWIMMING POOLS PART 3.10.1 OF NCC
- CONSTRUCTION IN BUSHFIRE PRONE AREAS PART 3.10.5 OF NCC FENCING & OTHER PROVISIONS REGS & AS1926.1 2012
- DEMOLITION WORKS AS2601-2001 THE DEMOLITION OF STRUCTURES.
- WATERPROOFING OF WET AREAS TO COMPLY WITH AS 3740-2010
- WATERPROOFING OF WET AREAS TO COMPLY WITH AS 3740-2010
 ALL PLUMBING & DRAINAGE WORK TO COMPLY WITH AS 3500:2018
- ALL PLASTERBOARD WORK TO COMPLY WITH AS 2588:2018
- ALL STRUCTURAL STEEL WORK TO COMPLY WITH AS 4100-1992 & AS 1554
- ALL CONCRETE WORK TO COMPLY WITH AS 3600:2018
- ALL ROOF SHEETING WORK TO COMPLY WITH AS 1562.1-2018
- ALL SKYLIGHTS TO COMPLY WITH AS 4285-2019
- ALL CERAMIC TILING TO COMPLY WITH AS 3958.1-2007 & 3958.2-1992
- ALL GLAZING ASSEMBLIES TO COMPLY WITH AS 2047-2014 & 1288
- ALL TIMBER RETAINING WALLS ARE TO COMPLY WITH AS 1720.1-2010, AS 1720.2-2006, AS 1720.4-2006, AS 1170.1-2002 & AS 1170.4-2007
- ALL RETAINING WALLS ARE TO COMPLY WITH 3700:2018 & AS 3600:2018
- ALL CONSTRUCTION TO COMPLY WITH AS 3959:2018

IMPORTANT NOTATION FOR BUILDERS

- All dimensions are to be confirmed on-site by the builder/subcontractor, any incongruencies must be reported to the Designer in writing before the commencement of any work.
- No Survey has been made on the boundaries, all bearings, distances, and areas have been taken from the contour survey plan. A Survey must be carried out to confirm the exact boundary locations - No construction work shall commence until a site survey confirming the site boundaries has been
- completed. The contractor is to ensure that the approved boundary setbacks are confirmed and used, the boundary setbacks take precedence over all other dimensions. The Survey work must be performed by a registered Surveyor.
- In the event of encountering any discrepancies on these drawings, specification, or subsequent instructions issued, the Builder/Subcontractor shall contact the designer in writing before proceeding further
- The builder/subcontractor is responsible to ensure that all materials installed on-site are fit for purpose and comply with the NCC and relevant Australian standards. The builder is to get written confirmation of material selection by the client prior to ordering
- All construction, control joints, and expansion joints in the wall. floors, other locations shall be in strict accordance with the Structural Engineering details. No joints or breaks other than specified are allowed without written permission from the Engineer
- Measurements for the fabrication of secondary components such as windows, doors, internal frames structural steel components, and the like, are not to be taken from these documents. Measurements must be taken on-site to suit the work as constructed.
- All structural components shall be in strict accordance with details and specifications as prepared by a structural engineer.
- All existing structures need to be examined for structural adequacy, and it is the Contractor's responsibility to ensure that a certificate of structural adequacy is obtained prior to the start of any work.

SPECIFICATION

- "Approval" obtained by either an 'Accredited Certifying Authority' or 'Local Council'.
- The Owner will directly pay all fees associated with the following:
- Building approval from council or accredited certifier, any footpath and kerb deposits with the local council, insurance fees to Building Services Corporation, Long Service Leave levy fees and approval fees by water
- sewerage authority. All other fees are to be paid by the builder. The amount of any local authority deposits which are forfeited due to damage or other causes, will be deducted from payments due to the builder. -The Builder is to provide at his/her own expense adequate Public Risk Insurance and arrange indemnification under the Workers Compensation Act. Works insurance to be as stated in the contract conditions.
- All tenderers are to visit the site to satisfy themselves as to the nature and extent of the Works, facilities available and difficulties entailed in the works as Variations will not be allowed due to work arising owing to neglect of this clause.
- These drawings shall be read in conjunction with all structural and other consultant's drawings and specifications and with any such written instructions as may be issued during the course of the contract. - Set out dimensions shown on this drawing shall be verified by the builder on site before commencement of any work. Dimensions shall not be obtained by scaling the drawings. Use only figured dimensions. All dimensions are in millimetres
- The Builder is to ensure all construction, levels and other items comply with the conditions of the Building Approval.
- Any detailing in addition to what is supplied shall be resolved between the Owner and the Builder to the Owner's approval, except for any structural details or design which is to be supplied by the Engineer. - All work to be carried out in a tradesman like manner and in accordance with the standards, codes and regulations of the Standards Association of Australia, National construction Code of Australia and any statutory authority having jurisdiction over the works.
- All structural work is to be in accordance with the structural details prepared by a suitably qualified structural engineer. Including but not limited to all piers, footings, concrete slabs, retaining walls, steelworks, formwork, underpinning, additional structural loads, timber framing, wind bracing and associated connections. Builder to obtain, prior to finalising the tender unless previously obtained by
- All brickwork is to be selected by owner and is to comply with AS 1640. All masonry is to comply with AS
- Provide all metalwork and flashings necessary to satisfactorily complete the works.
- All timber construction to be in accordance with AS 1684 "Timber Framing Code". Level & Grade where necessary under timber floors to provide a minimum clearance of 300mm under bearers or 400mm under joists. Adequate precautions shall be taken to ensure that the surface &/or seepage water does not collect or remain under floor area.
- Sustainable timbers and not rainforest or old growth timber will be use. Recycled timber or second hand timbers are to be sourced and used in preference to plantation timbers, if available and suitable. - All glazing installed is to comply with AS 1288, 2047 and in accordance with manufacturers
- recommendations. - All wall and ceiling linings to be plasterboard and villaboard or equal in wet areas. A breathable wall wrap
- is to be provided to all external walls. Timber cladding is to be battened out from timber frame to provide an 'air' gap to prevent condensation. Workmanship is to comply with the relevant Australian Standards or installed In accordance with manufacturer's specification. All bathrooms and wet areas to be waterproofed with a flexible membrane to manufacturer's specification and to AS 3740 and Part 3.8.1 of the Building Code of Australia Housing Provisions
- All Architraves and skirtings to the profile as selected by owner, and painted or stain finish as selected. - All plumbing and drainage work to be installed and completed by a licensed tradesman and in accordance with the statutory body having authority over the works. Connect all waste to Sydney Water sewer line. - Connect all stormwater to existing system or street drainage system in accordance with AS 3500 and part
- 3.1.2 Drainage of the Building Code of Australia Housing Provisions. - Smoke detector alarms to be installed in accordance with AS3786 and the Building Code of Australia/
- NCC clause 3.7.2.2. - If a member which provides structural support to the work is subject to attack by Termites protection measures are to comply with AS3660 and be installed to manufacturer's specification

- Stairs and Balustrades to comply with part 3.9.1 & 3.9.2 of the Building Code of Australia Housing Provisions. Provide a handrail along the full length of the flight and a slip resistant finish to the edge of the nosings to comply with 3.9.1 and 3.9.2 of the NCC. No horizontal elements to facilitate climbing between 150mm and 760mm where floor to level below in more than 4m.
- Electrical works to be in accordance with SAA wiring rules and be done by a licenced tradesperson Obtain electrical layout prior to proceeding. All electrical power (GPO's) and light outlets to be determined
- Painting: All paints or other coatings shall be of the best quality materials & of approved manufacture. All priming materials shall be of an approved brand acceptable to the manufacturer of the finishing coats to be
- used. External joinery intended to be painted shall be primed on all faces at the place of assembly. Where new work or alteration work adjoins existing painted surfaces allow for repainting existing surfaces to provide uniform appearance.
- ZERO-VOC or LOW-VOC paints and primers only are to be used.
- Any work indicated on the plans but not specified and any item not shown on the plans which is obviously necessary as part of proper construction and/or finish, is to be considered as shown and specified and is to

undertaken at the Builder's expense

- Variations will not be permitted without prior written approval by the owners.
- The Builder shall provide sediment and siltration control measures as required by Council and maintain them throughout the duration of the works.
- A legible copy of the plans bearing approval stamps, must be maintained on the job site at all times. Hours of construction shall be restricted to the times as required by the building approval
- The Builder is to arrange for all inspections required by the relevant authorities and/or lending institutions. to their requirements.
- The Builder is to obtain approval for interruptions to existing services and minimise the duration and number ofinterruptions. Any interruptions to existing services and equipment is to be undertaken by appropriately qualified tradespersons.
- The Builder shall restore, reinstate or replace any damage to existing structures or landscaping caused by the construction works or workmen.
- Provide protection to existing trees to remain, or as required by the Approval Conditions.

GENERAL NOTATION

- Approved means by the 'relevant local authority' or council
- The owner will directly pay the fees associated with the following:
- building approval from council, footpath and kerb deposits with the local council, insurance fee to building services corporation, long service leave service levy fee and approval fee by water and sewerage authority. all other fees are to be paid by the builder. the amount of any local authority deposits which are forfeited due to damage or other cause will be deducted from the payments due to the builder.
- The builder is to provide at his/her own expense adequate public risk insurance and arrange indemnification under the workers compensation act, works insurance to be stated in the contract conditions.
- All work to be carried out in a tradesmen like manner and in accordance with the standards codes and regulations of the standards association of Australia, building code of Australia and any statutory authority having jurisdiction over the work.
- All tenderers are to visit the site to satisfy themselves as to the nature and extent of the works, facilities available and difficulties entailed in the works as variations will not be allowed due to work arising owing to neglect of this clause.
- All work and materials to comply with the current Australian standards at the time of commencement were applicable.
- These drawings shall be read in conjunction with all structural and other consultants drawings and specifications and with any such written instructions as may be issued during the course of the contract. Set out dimensions shown on this drawing shall be verified by the builder on site before commencement of any work, dimensions should not be obtained by scaling the drawings, use only figured dimensions, all dimensions are in millimetres.
- The builder is to ensure all construction, levels and other items comply with the conditions of the building approval
- The builder is to comply with all ordinances, local authority regulations and the requirements of all services supply authorities having jurisdiction over the works.
- All plumbing and drainage work to be installed and completed by a licenced tradesman and in accordance with the statutory body having authority over the works. connect all waste to Sydney water sewer line
- All new downpipes are to be connected to the existing storm water system. - All power and stormwater outlet locations shall be determined onsite by the owner.
- Smoke detector alarm to be installed in accordance with as 3786 and the building code of Australia. Electrical work to be in accordance with SAA wiring rules and be done by a licenced tradesman
- Any detailing in addition to what is supplied shall be resolved between the owner and the builder to the owner's approval, except for any structural details or design which is supplied by the engineer.
- All timber sizes and concrete details to be confirmed by the builder prior to commencement of any work - All structural work is to be in accordance with the structural details prepared by a structural engineer(i.e.) piers, footings, concrete slabs, retaining walls, steelwork, formwork, underpinning, additional structural loads, timber framing, wind bracing and associated connections. builder to obtain prior to finalising tender. - Any work indicated on the plans but not specified, and any item not shown on the plan which is obviously necessary as a part of construction and/or finish is to be considered as shown and specified, and is to be done as part of the contract. variations will not be permitted without the written consent of the owner. - The builder shall provide sediment and siltration control measures as required by council and maintain
- them through the duration of the works. - A legible copy of the plans bearing approval stamps must be maintained on the job at all times. hours of construction will be restricted to the times as required by the building approval
- The builder is to arrange for all inspections required by the authorities and lending institutions to their
- The builder is to obtain approval for interruptions to existing services and minimise the duration and number of interruptions, any interruptions with existing services and equipment to be attended to by the appropriately skilled tradesmen.
- The builder shall restore, reinstate or replace any damage caused to existing structures or landscaping by construction work or workmen, provide protection to existing trees to remain as required by approval

- All brickwork is to be selected by owner and is to comply with as 1640
- All masonry to comply with as3700
- All metalwork and flashing items necessary to satisfactory complete work shall be provided.
- All gutters, downpipes to be colorbond. All timber construction to be in accordance with the Australian standard 1684 "timber framing code"
- All glazing installed to comply with as1288, 2047 and in accordance with manufacturers recommendation
- All wall and ceiling linings to be plasterboard or cement render as selected and villa board in wet areas, to comply with the relevant Australian standards or installed in accordance with manufacturers specification.
- All bathrooms and wet areas to be adequately waterproofed to manufacturers speciation and as3740 and part 3.8.1 of the building code of Australia housing provisions
- Stairs and balustrades to comply with part 3.9.1 & 3.9.2 of the building code of Australia housing provision
- Termite protection measures to comply with as 3660 and be installed to manufacturers specification Any detailing additional to that supplied, shall be resolved between the owner and the builder to the owners approval, except for any structural details or design which is to be supplied by the structural

NCC & AS COMPLIANCE SPECIFICATIONS

- Farthworks part 3.1.1 of NCC
- Earth retaining structures part 3.1.2 of NCC
- Drainage part 3.1.3 of NCC
- Termite-risk management part 3.1.4 of NCC
- Footings & slab part 3.2 of NCC including as 2870-2011 Masonry - part 3.3 of ncc including as 3700:2018
- Framing part 3.4 of NCC
- Sub floor ventilation part 3.4.1 of NCC
- Roof cladding and wall-cladding part 3.5 of NCC
- Glazing part 3.6 of NCC including as 1288
- Fire safety part 3.7 of NCC
- Fire separation of external walls part 3.7.2 of NCC - Fire protection of separating walls and floors- part 3.7.3 of NCC
- Smoke alarms part 3.7.5 of NCC
- Wet areas and external waterproofing part 3.8.1 of NCC
- Room heights part 3.8.2 of NCC - Facilities - part 3.8.3 of NCC
- Light part 3.8.4 of NCC
- Ventilation part 3.8.5 of NCC
- Sound insulation part 3.8.6 of NCC
- Stairway and ramp construction part 3.9.1 of NCC Barriers and handrails - part 3.9.2 of NCC
- Swimming pools part 3.10.1 of NCC - Construction in bushfire prone areas - part 3.10.5 of NCC
- Fencing & other provisions regs & AS 1926 1 2012
- Demolition works AS 2601-2001 the demolition of structures
- Waterproofing of wet areas to comply with AS 3740-2010 All plumbing & drainage work to comply with AS 3500:2018
- All plasterboard work to comply with AS 2588:2018 - All structural steel work to comply with AS 4100-1992 & AS 1554
- All concrete work to comply with AS 3600:2018
- All roof sheeting work to comply with AS 1562.1-2018
- All skylights to comply with AS 4285-2019
- All ceramic tiling to comply with AS 3958.1-2007 & 3958.2-1992
- All glazing assemblies to comply with AS 2047-2014 & 1288
- All timber retaining walls are to comply with AS 1720.1-2010.
- AS 1720.2-2006, AS 1720.4-2006, AS 1170.1-2002 & AS 1170.4-2007 All retaining walls are to comply with 3700:2018 & AS 3600:2018
- All construction to comply with AS 3959:2018

THIS SET OF DRAWING SHOULD BE READ & KEPT IN ITS ENTIRETY. NO INDIVIDUAL PAGE SHOULD BE SEPARATED FROM THE REST OF THE SET. EACH NOTATION LISTED ON THIS PAGE APPLY TO ALL PAGES OF THIS SET.

SAFTEY NOTES

THESE NOTES MUST BE READ AND UNDERSTOOD BY ALL INVOLVED IN THE PROJECT. THIS INCLUDES (but is not excluded to): OWNER, BUILDER, SUB-CONTRACTORS, CONSULT ANTS, RENOVATORS, OPERATORS, MAINTENORS, DEMOLISHERS.

1. FALLS, SLIPS, TRIPS

a) WORKING AT HEIGHTS

DURING CONSTRUCTION

Wherever possible, components for this building should be prefabricated off-site or at ground level to minimise the risk of workers falling more than two metres. However, construction of this building will require workers to be working at heights where a fall in excess of two metres is possible and injury is likely to result from such a fall. The builder should provide a suitable barrier wherever a person is required to work in a situation where falling more than two metres is a possibility.

DURING OPERATION OR MAINTENANCE

For houses or other low-rise buildings where scaffolding is appropriate: Cleaning and maintenance of windows, walls, roof or other components of this building will require persons to be situated where a fall from a height in excess of two metres is possible. Where this type of activity is required, scaffolding, ladders or trestles should be used in accordance with relevant codes of practice, regulations or legislation. For buildings where scaffold, ladders, trestles are not appropriate: Cleaning and maintenance of windows, walls, roof or other components of this building will require persons to be situated where a fall from a height in excess of two metres is possible. Where this type of activity is required, scaffolding, fall barriers or Personal Protective Equipment (PPE) should be used in accordance with relevant codes of practice, regulations or legislation.

b) SLIPPERY OR UNEVEN SURFACES

FLOOR FINISHES Specified

If finishes have been specified by designer, these have been selected to minimise the risk of floors and paved areas becoming slippery when wet or when walked on with wet shoes/ feet. Any changes to the specified finish should be made in consultation with the designer or, if this is not practical, surfaces with an equivalent or better slip resistance should be chosen.

FLOOR FINISHES By Owner

If designer has not been involved in the selection of surface finishes. the owner is responsible for the selection of surface finishes in the pedestrian trafficable areas of this building. Surfaces should be selected in accordance with AS HB 197:1999 and AS/ NZ 4586:2004.

STEPS, LOOSE OBJECTS AND UNEVEN SURFACES

Due to design restrictions for this building, steps and/ or ramps are included in the building which may be a hazard to workers carrying objects or otherwise occupied. Steps should be clearly marked with both visual and tactile warning during construction, maintenance, demolition and at all times when the building operates as a workplace. Building owners and occupiers should monitor the pedestrian access ways and in particular access to areas where maintenance is routinely carried out to ensure that surfaces have not moved or cracked so that they become uneven and present a trip hazard. Spills, loose material, stray objects or any other matter that may cause a slip or trip hazard should be cleaned or removed from access ways. Contractors should be required to maintain a tidy work site during construction, maintenance or demolition to reduce the risk of trips and falls in the workplace. Materials for construction or maintenance should be stored in designated areas away from access ways and work areas.

2. FALLING OBJECTS

LOOSE MATERIALS OR SMALL OBJECTS

Construction, maintenance or demolition work on or around this building is likely to involve persons working above ground level or above floor levels. Where this occurs one or more of the following measures should be token to ovoid objects falling from the area where the work is being carried out onto persons below.

1. Prevent or restrict access to areas below where the work is

- being carried out.

 2. Provide toeboards to scaffolding or work pla
- 2. Provide toeboards to scaffolding or work platforms.3. Provide protective structure below the work area.
- 4. Ensure that all persons below the work area have Personal
- Protective Equipment (PPE).

 BUILDING COMPONENTS

During construction, renovation or demolition of this building, parts of the structure including fabricated steelwork, heavy panels and many other components will remain standing prior to or after supporting parts are in place. Contractors should ensure that temporary bracing or other required support is in place at all times when collapse which may injure persons in the area is a possibility. Mechanical lifting of materials and components during construction, maintenance or demolition presents a risk of falling objects. Contractors should ensure that appropriate lifting devices are used, that loads are properly secured and that access to areas below the load is prevented or restricted.

3. TRAFFIC MANAGEMENT

For building on a major road, narrow road or steeply sloping road: Parking of vehicles or loading/ unloading of vehicles on this roadway may cause a traffic hazard. During construction, maintenance or demolition of this building designated parking for workers and loading areas should be provided. Trained traffic management personnel should be responsible for the supervision of these areas. For building where onsite loading/ unloading is restricted: Construction of this building will require loading and unloading of materials on the roadway. Deliveries should be well planned to ovoid congestion of loading areas and trained traffic management personnel should be used to supervise loading/ unloading areas. For all buildings: Busy construction and demolition sites present a risk of collision where deliveries and other traffic are moving within the site. A traffic management plan supervised by trained traffic management personnel should be adopted for the work site.

4. SERVICES

GENERAL

Rupture of services during excavation or other activity creates a variety of risks including release of hazardous material. Existing services are located on or around this site. Where known, these ore identified on the plans but the excel location and extent of services may vary from that indicated. Services should be located using on appropriate service (such as Dial Before You Dig), appropriate excavation practice should be used and, where necessary, specialist contractors should be used. Locations with underground power: Underground power lines MAY be located in or around this site. All underground power lines must be disconnected or carefully located and adequate warning signs used prior to any construction, maintenance or demolition commencing. Locations with overhead power lines: Overhead power lines MAY be near or on this site. These pose a risk of electrocution if struck or approached by lifting devices or other plant and persons working above ground level. Where there is a danger of this occurring, power lines should be, where practical, disconnected or relocated. Where this is not practical adequate warning in the form of bright coloured tape or signage should be used or a protective barrier provided.

5. MANUAL TASKS

Components within this design with a moss in excess of 25kg should be lifted by two or more workers or by mechanical lifting device. Where this is not practical, suppliers or fabricators should be required to limit the component mass. All material packaging, building and maintenance components should clearly show the total moss of packages and where practical all items should be stored on site in a way which minimises bending before lifting. Advice should be provided on safe lifting methods in all areas where lifting may occur. Construction, maintenance and demolition of this building will require the use of portable tools and equipment. These should be fully maintained in accordance with manufacturer's specifications and not used where faulty or (in the case of electrical equipment) not carrying a current electrical safety tag. All safety guards or devices should be regularly checked and Personal Protective Equipment should be used in accordance with manufacturer's specification.

6. HAZARDOUS SUBSTANCES

ASBESTOS

For alterations to a building constructed prior to 1990:

- If this existing building was constructed prior to: 1990 it therefore may contain asbestos
- 1986 it therefore is likely to contain asbestos
- either in cladding material or in fire retardant insulation material. In either case, the builder should check and, if necessary, take appropriate action before demolishing, culling, sanding, drilling or otherwise disturbing the existing structure.

POWDERED MATERIALS

Many materials used in the construction of this building con cause harm if inhaled in powdered form. Persons working on or in the building during construction, operational maintenance or demolition should ensure good ventilation and wear Personal Protective Equipment including protection against inhalation while using powdered material or when sanding, drilling, cutting or otherwise disturbing or creating powdered material.

TREATED TIMBER

The design of this building may include provision for the inclusion of treated limber within the structure. Dust or fumes from this material can be harmful. Persons working on or in the building during construction, operational maintenance or demolition should ensure good ventilation and wear Personal Protective Equipment including protection against inhalation of harmful material when sanding, drilling, cutting or using treated timber in any way that may cause harmful material lo be released. Do not burn treated timber.

VOLATILE ORGANIC COMPOUNDS

Many types of glue, solvents, spray packs, paints, varnishes and some cleaning materials and disinfectants have dangerous emissions. Areas where these are used should be kept well ventilated while the material is being used and for a period after installation. Personal Protective Equipment may also be required. The manufacturer's recommendations for use must be carefully considered at all times.

YNTHETIC MINERAL FIBRE

Fibreglass, rockwool, ceramic and other material used for thermal or sound insulation may contain synthetic mineral fibre which may be harmful if inhaled or if it comes in contact with the skin, eyes or other sensitive parts or the body. Personal Protective Equipment including protection against inhalation of harmful material should be used when installing, removing or working near bulk insulation material.

TIMBER FLOORS

This building may contain timber floors which have an applied finish. Areas where finishes are applied should be kept well ventilated during sanding and application and for a period after installation. Personal Protective Equipment may also be required. The manufacturer's recommendations for use must be carefully considered at all times.

7. CONFINED SPACES

EXCAVATION

Construction of this building and some maintenance on the building will require excavation and installation of items within excavations. Where practical, installation should be carried out using methods which do not require workers to enter the excavation. Where this is not practical, adequate support for the excavated area should be provided to prevent collapse. Warning signs and barriers to prevent accidental or unauthorised access to all excavations should be provided.

ENCLOSED SPACES

For buildings with enclosed spaces where maintenance or other access may be required: Enclosed spaces within this building may present a risk to persons

entering for construction, maintenance or any other purpose. The design documentation calls for warning signs and barriers to unauthorised access. These should be maintained throughout the life of the building. Where workers are required to enter enclosed spaces, air testing equipment and Personal Protective Equipment should be provided.

SMALL SPACES

For buildings with small spaces where maintenance or other access may be required: Some small spaces within this building will require access by construction or maintenance workers. The design documentation calls for warning signs and barriers to unauthorised access. These should be maintained throughout the life of the building. Where workers are required to enter small spaces they should be scheduled so that access is for short periods. Manual lifting and other manual activity should be restricted in small spaces.

8. PUBLIC ACCESS

Public access to construction and demolition sites and lo areas under maintenance causes risk to workers and public. Warning signs and secure barriers to unauthorised access should be provided. Where electrical installations, excavations, plant or loose materials are present they should be secured when not fully expensived.

9. OPERATIONAL USE OF BUILDING RESIDENTIAL BUILDINGS


This building has been designed as a residential building. If it, at a later date, it is used or intended to be used as a workplace, the provisions of the Work Health and Safely Act 2011 or subsequent replacement Act should be applied to the new use.

NON-RESIDENTIAL BUILDINGS


For non-residential buildings where the end-use has not been identified: This building has been designed to requirements of the classification identified on the drawings. The specific, use of the building is not known at the time of the design and a further assessment of the workplace health and safety issues should be undertaken at the time of fit-out for the end-user. For non-residential buildings where the end-use is known: This building has been designed for the specific use as identified on the drawings. Where a change of use occurs at a later dale a further assessment of the workplace health and safety issues should be undertaken.

10. OTHER HIGH RISK ACTIVITY

All electrical work should be carried out in accordance with Code of Practice: Managing Electrical Risks at the Workplace, AS/ NZ 3012 and all licensing requirements. All work using Plant should be carried out in accordance with Code of Practice: Managing Risks of Plant at the Workplace. All work should be carried out in accordance with Code of Practice: Managing Noise and Preventing Hearing Loss at Work. Due to the history of serious incidents it is recommended that particular care be exercised when undertaking work involving steel construction and concrete placement. All the above applies.

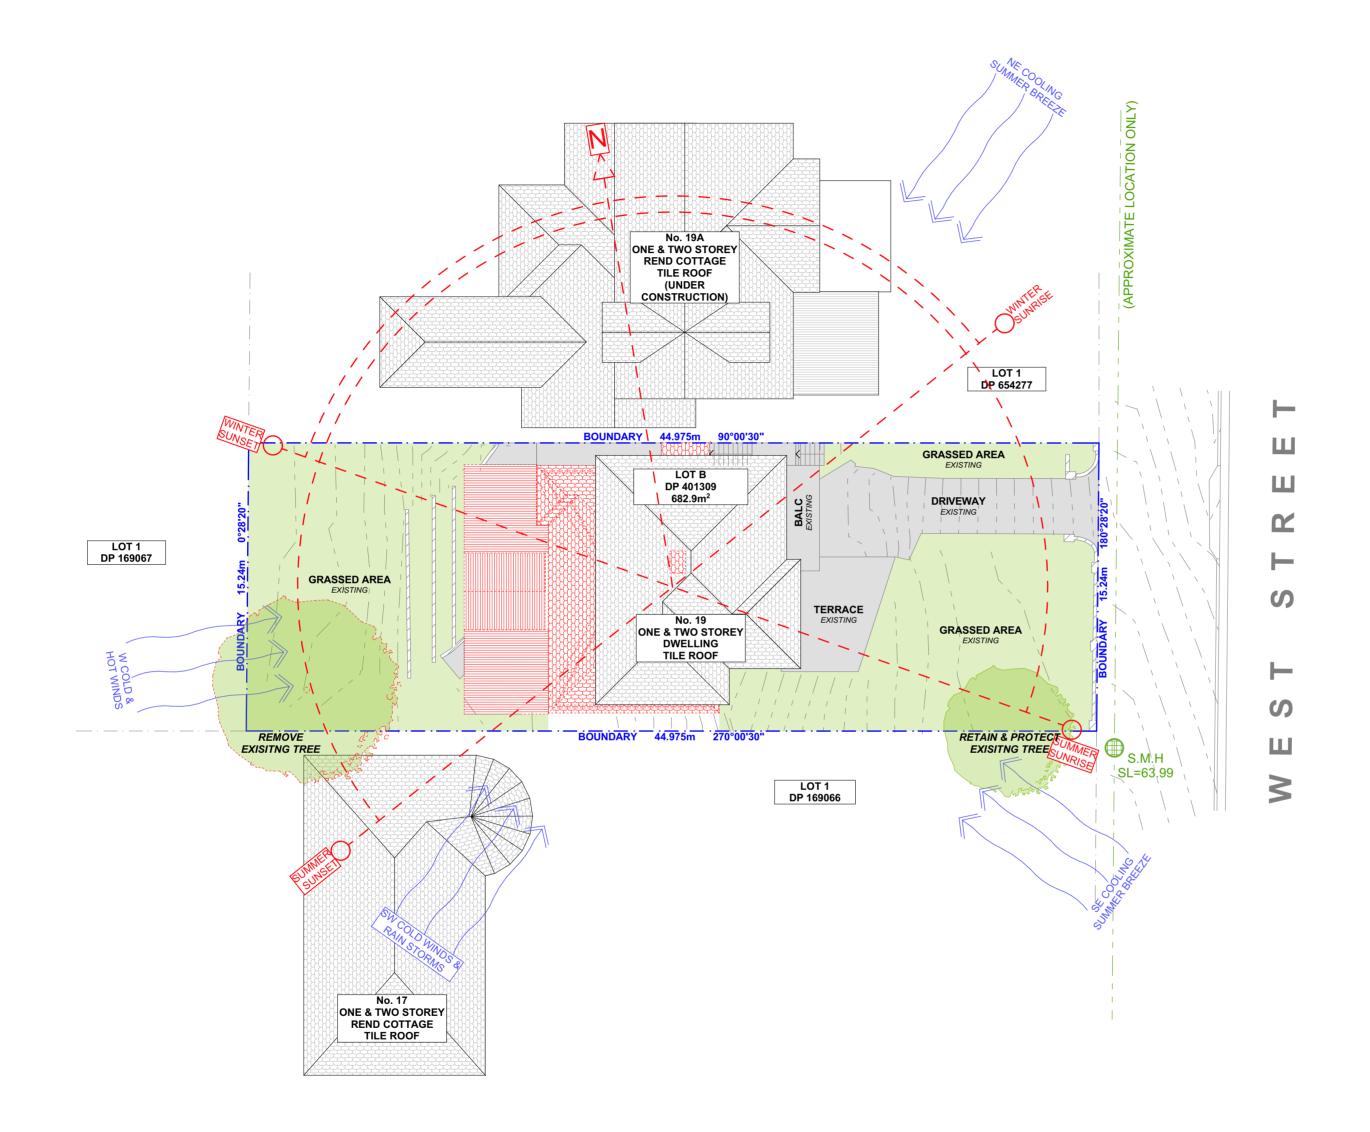



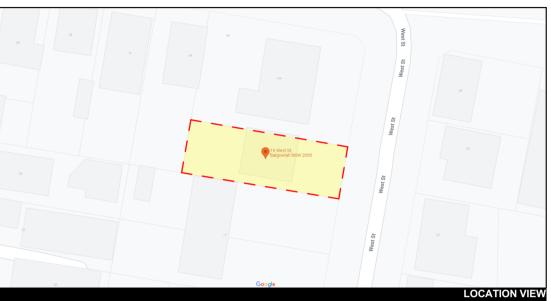



SITE ANALYSIS 1:200

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EXISTING
PROPOSED
DEMOLISHED

NOTE: ALL DEMOLISHED ELEMENTS TO ENG. SPECIFICATIONS AND AS. 2601 - 2001

CLIENT
JO & JEAN OLIVER

DA03

DRAWING NAME SITE ANALYSIS


PROJECT ADDRESS

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2093

DATE
Friday, 10 December
2021

SCALE 10 December 1:200 @A2



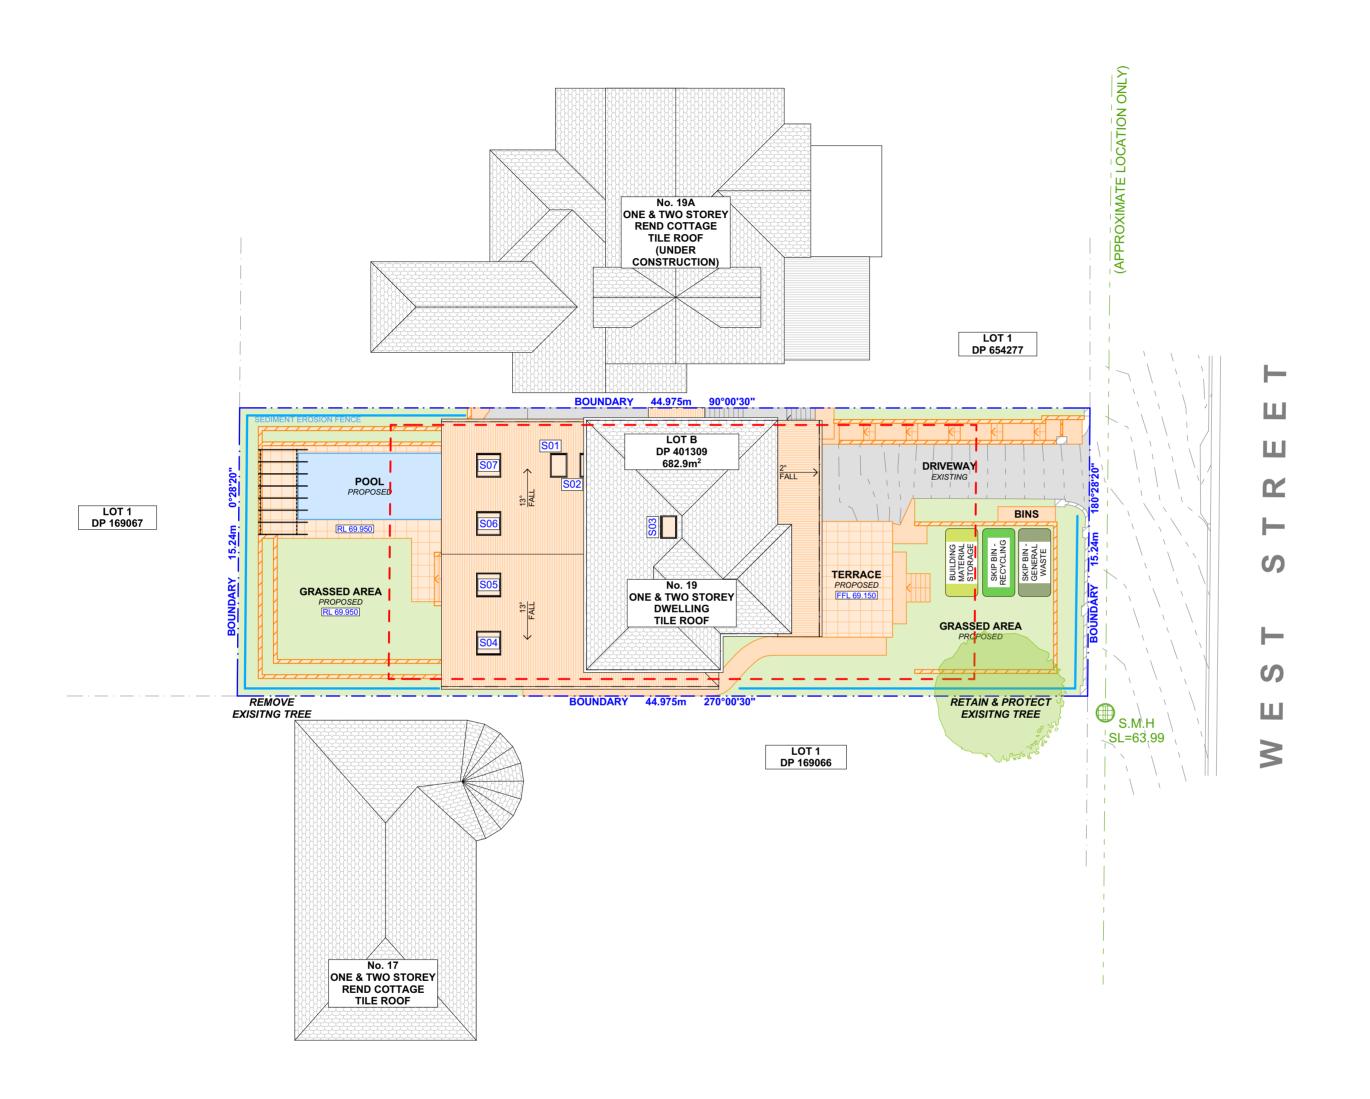

DISTURBED AREA OVERLAP WIRE OR STEEL MESH SEDIMENT FENCE

NOTES REGARDING BOUNDARY

THE INFORMATION SHOWN ON THIS PLAN IS FOR DESIGN PURPOSES ONLY. THE POSITION OF BOUNDARY LINES HAVE BEEN ESTABLISHED BY A SURVEY TO MEET THE IDENTIFICATION REQUIREMENTS FOR COUNCIL AND NOT FOR REGISTRATION WITH THE LAND REGISTRATION SERVICES NSW NOR MAY THIS PLAN BE USED FOR ANY OTHER PURPOSE. SUBSEQUENT REGISTERED OR OTHER SURVEYS MAY AFFECT THE DEFINED BOUNDARY POSITIONS IN THIS AREA. ANY DIFFERENCES OF THIS NATURE ARE BEYOND THE PURPOSES OF THIS PLAN. THIS PLAN IS FOR THE ABOVE STATED PURPOSES ONLY. RESTRICTIONS ON THE TITLE HAVE NOT BEEN INVESTIGATED. IF FURTHER DEVELOPMENT IS CONTEMPLATED OR

CONSTRUCTION INTENDED THEN IT IS IMPORTANT

THAT A SURVEY SET OUT IS CARRIED OUT.

DUST CONTROL: TO REDUCE DUST GENERATED BY WIND ACTION, THE REMOVAL OF THE TOP SOIL IS TO BE MINIMISED. TO PREVENT DUST GENERATION, WATERING DOWN OF THE SITE, ESPECIALLY DURING THE MOVEMENT OF MACHINERY IS REQUIRED. WHERE EXCAVATING INTO ROCK, KEEP THE SURFACE MOIST TO MINIMISE DUST. CONSTRUCT A GRAVEL ENTRY/EXIT POINT USING BLUE METAL AND RESTRICT ALL VEHICLE MOVEMENTS WITHIN THE SITE TO A MINIMUM. ENSURE WIND BREAKS, SUCH AS EXISTING FENCES ARE MAINTAINED DURING THE CONSTRUCTION PHASE UNTIL NEW LANDSCAPING IS PROVIDED OR REINSTATED. PREVENT DUST BY COVERING STOCKPILES

SEDIMENT NOTE:

1. ALL EROSION AND SEDIMENT CONTROL MEASURES TO BE INSPECTED AND MAINTAINED DAILY BY THE SITE MANAGER.

2. MINIMISE DISTURBED AREAS, REMOVE EXCESS SOIL FROM EXCAVATEDAREA AS SOON AS POSSIBLE. 3. ALL MATERIAL STOCKPILE TO BE CLEAR FROM DRAINS, GUTTERS AND FOOTPATHS, OR WITHIN SEDIMENT FENCE AREA. 4. DRAINAGE TO BE CONNECTED TO STORMWATER AS

SOON AS POSSIBLE. IF STORED ON SITE, IT MUST BE FILTERED BEFORE RELEASING INTO STORMWATER SYSTEM OR WATERWAYS. 5. ROADS AND FOOTPATHS TO BE SWEPT DAILY.

STOCKPILES:


ALL STOCKPILES ARE TO BE KEPT ON-SITE WHERE POSSIBLE. ANY MATERIALS PLACED ON THE FOOTPATHS OR NATURE STRIPS REQUIRE COUNCIL'S

ALL STOCKPILES ARE TO BE PLACED AWAY FROM THE DRAINAGE LINES AND STREET GUTTERS. IT IS BEST TO LOCATE THESE ON THE HIGHEST PART OF THE SITE IF POSSIBLE. PLACE WATERPROOF COVERING OVER STOCKPILES.

IF REQUIRED PROVIDE DIVERSION DRAIN & BANK AROUND STOCKPILES.

GUTTER PROTECTION :

PROVIDE PROTECTION TO DOWNHILL GRATE IN GUTTER BY MEANS OF SAND BAGS OR BLUE METAL WRAPPED IN GEOTEXTILE FABRIC. WHEN SOIL OR SAND BUILDS UP AROUND THIS SEDIMENT BARRIER, THE MATERIAL SHOULD BE RELOCATED BACK TO THE SITE FOR DISPOSAL.

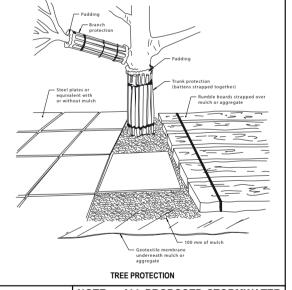

NOTE: ALL PROPOSED STORMWATER TO CONNECT WITH EXISTING

SITE PLAN

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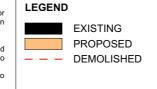
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1:200



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CLIENT JO & JEAN OLIVER

PROJECT ADDRESS

19 WEST STREET,

BALGOWLAH NSW

DRAWING NO. DA04


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DRAWING NAME

SITE / ROOF / SEDIMENT EROSION / WASTE MANAGEMENT / STORMWATER CONCEPT PLAN





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CLIENT
JO & JEAN OLIVER

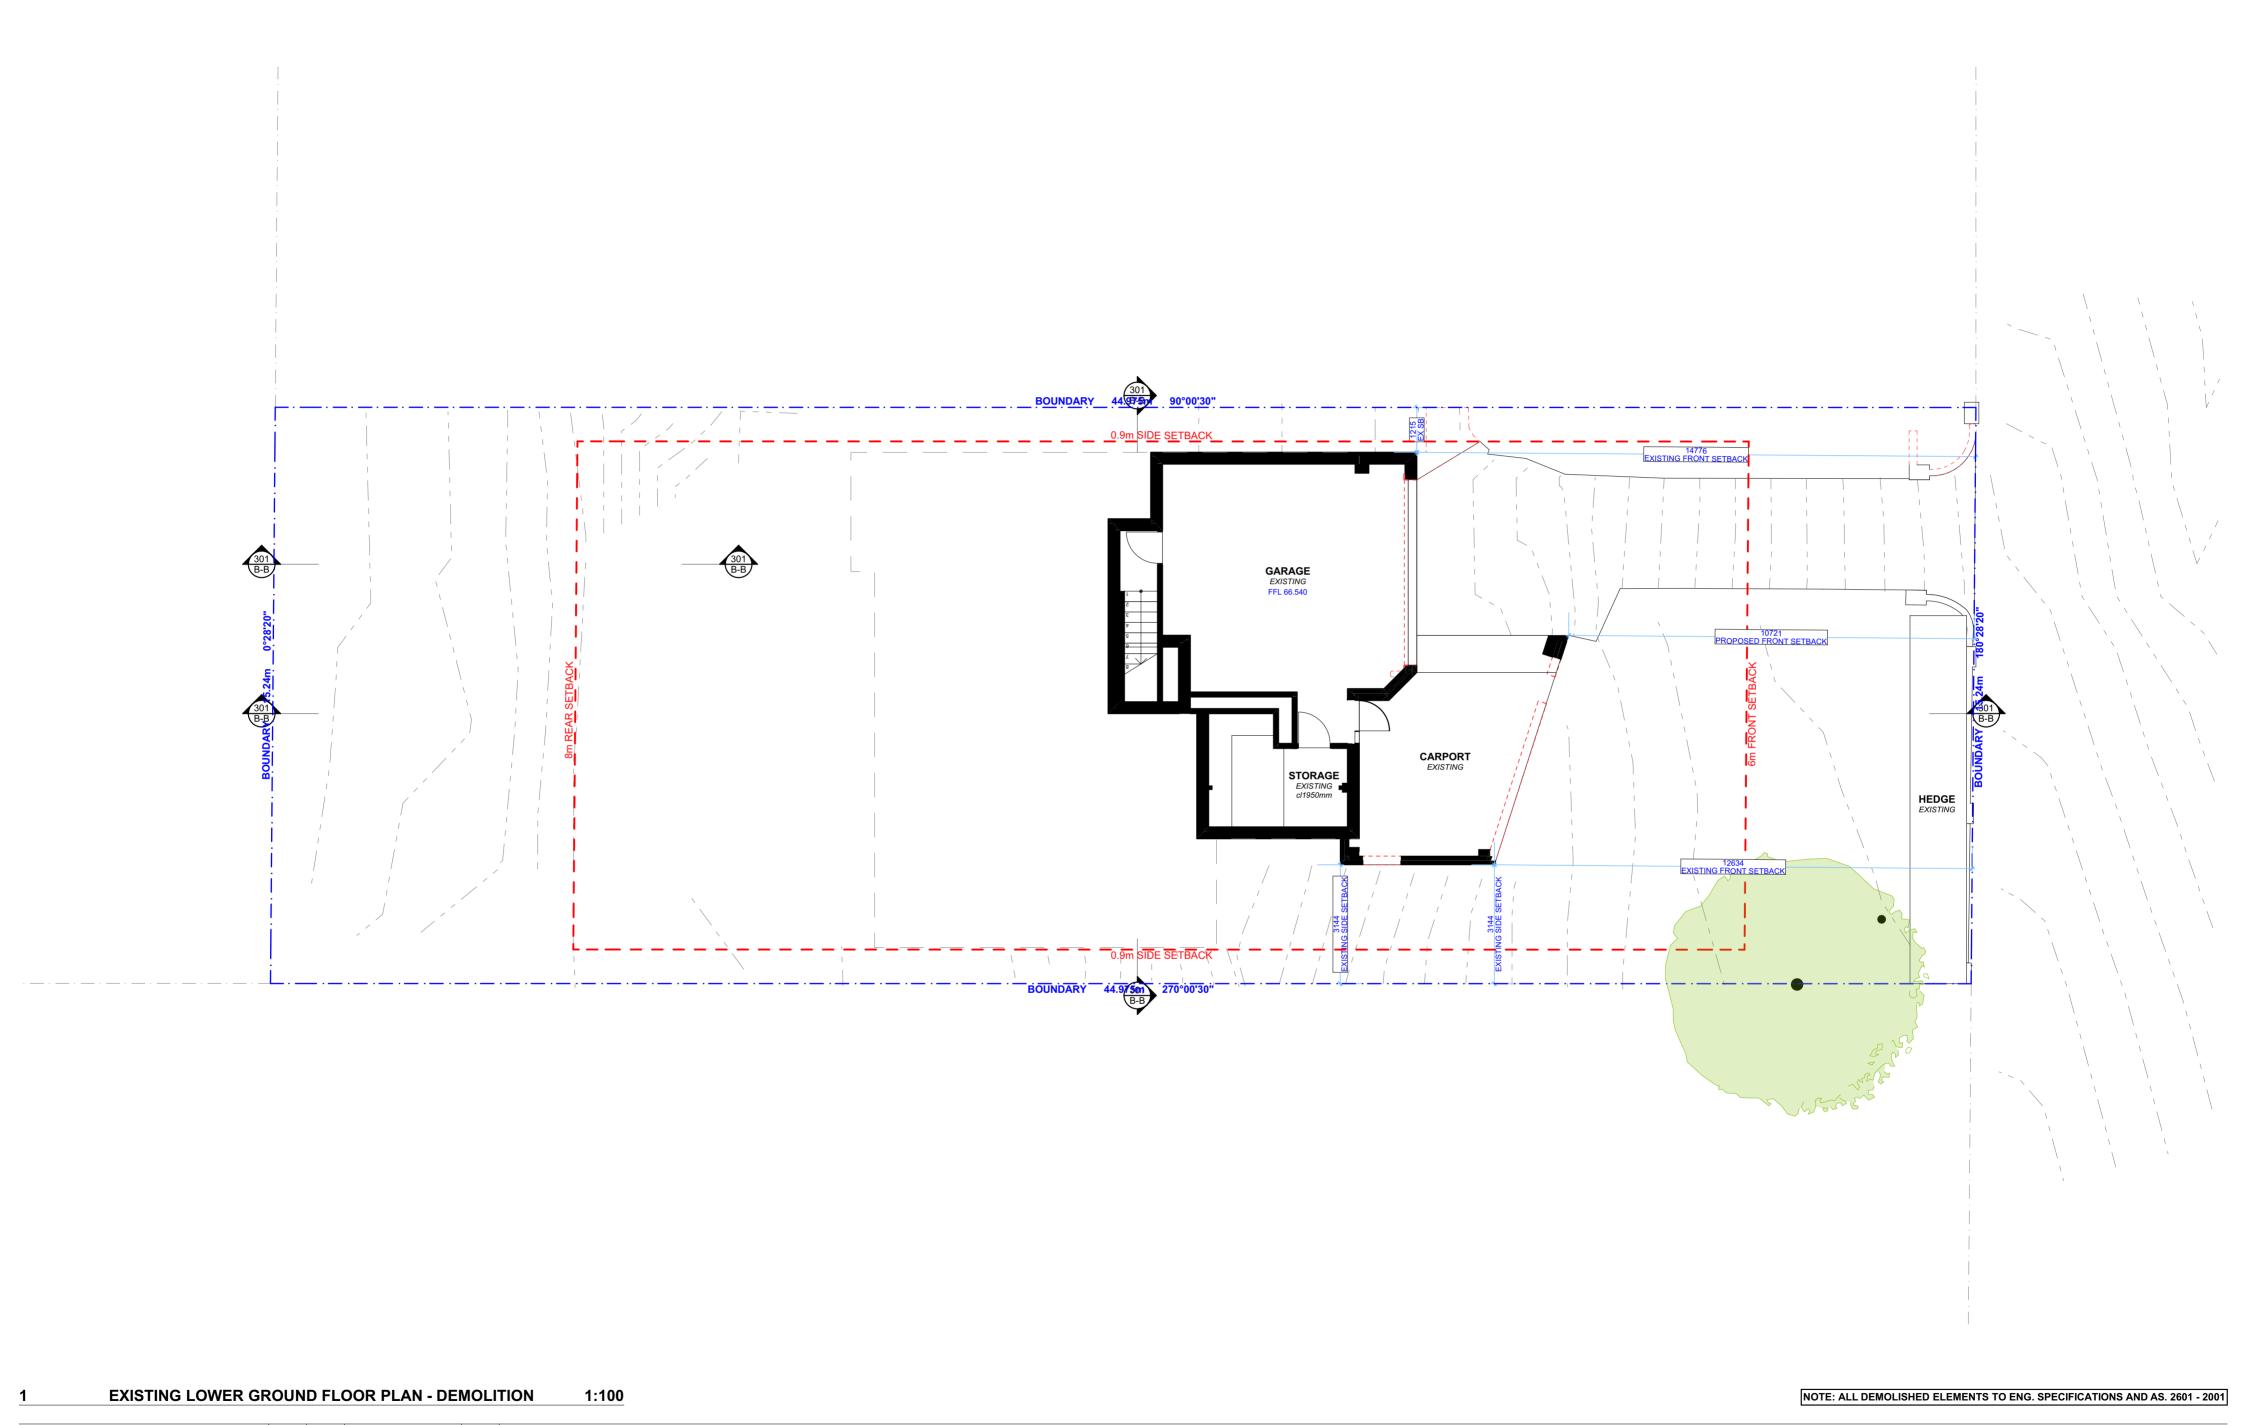PROJECT ADDRESS

19 WEST STREET,

BALGOWLAH NSW 2093 DA05

DRAWING NAME


EXISTING LOWER GROUND FLOOR
PLAN

 DATE
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 Friday, 10 December 2021
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SCALE






EXISTING GROUND FLOOR PLAN - DEMOLITION
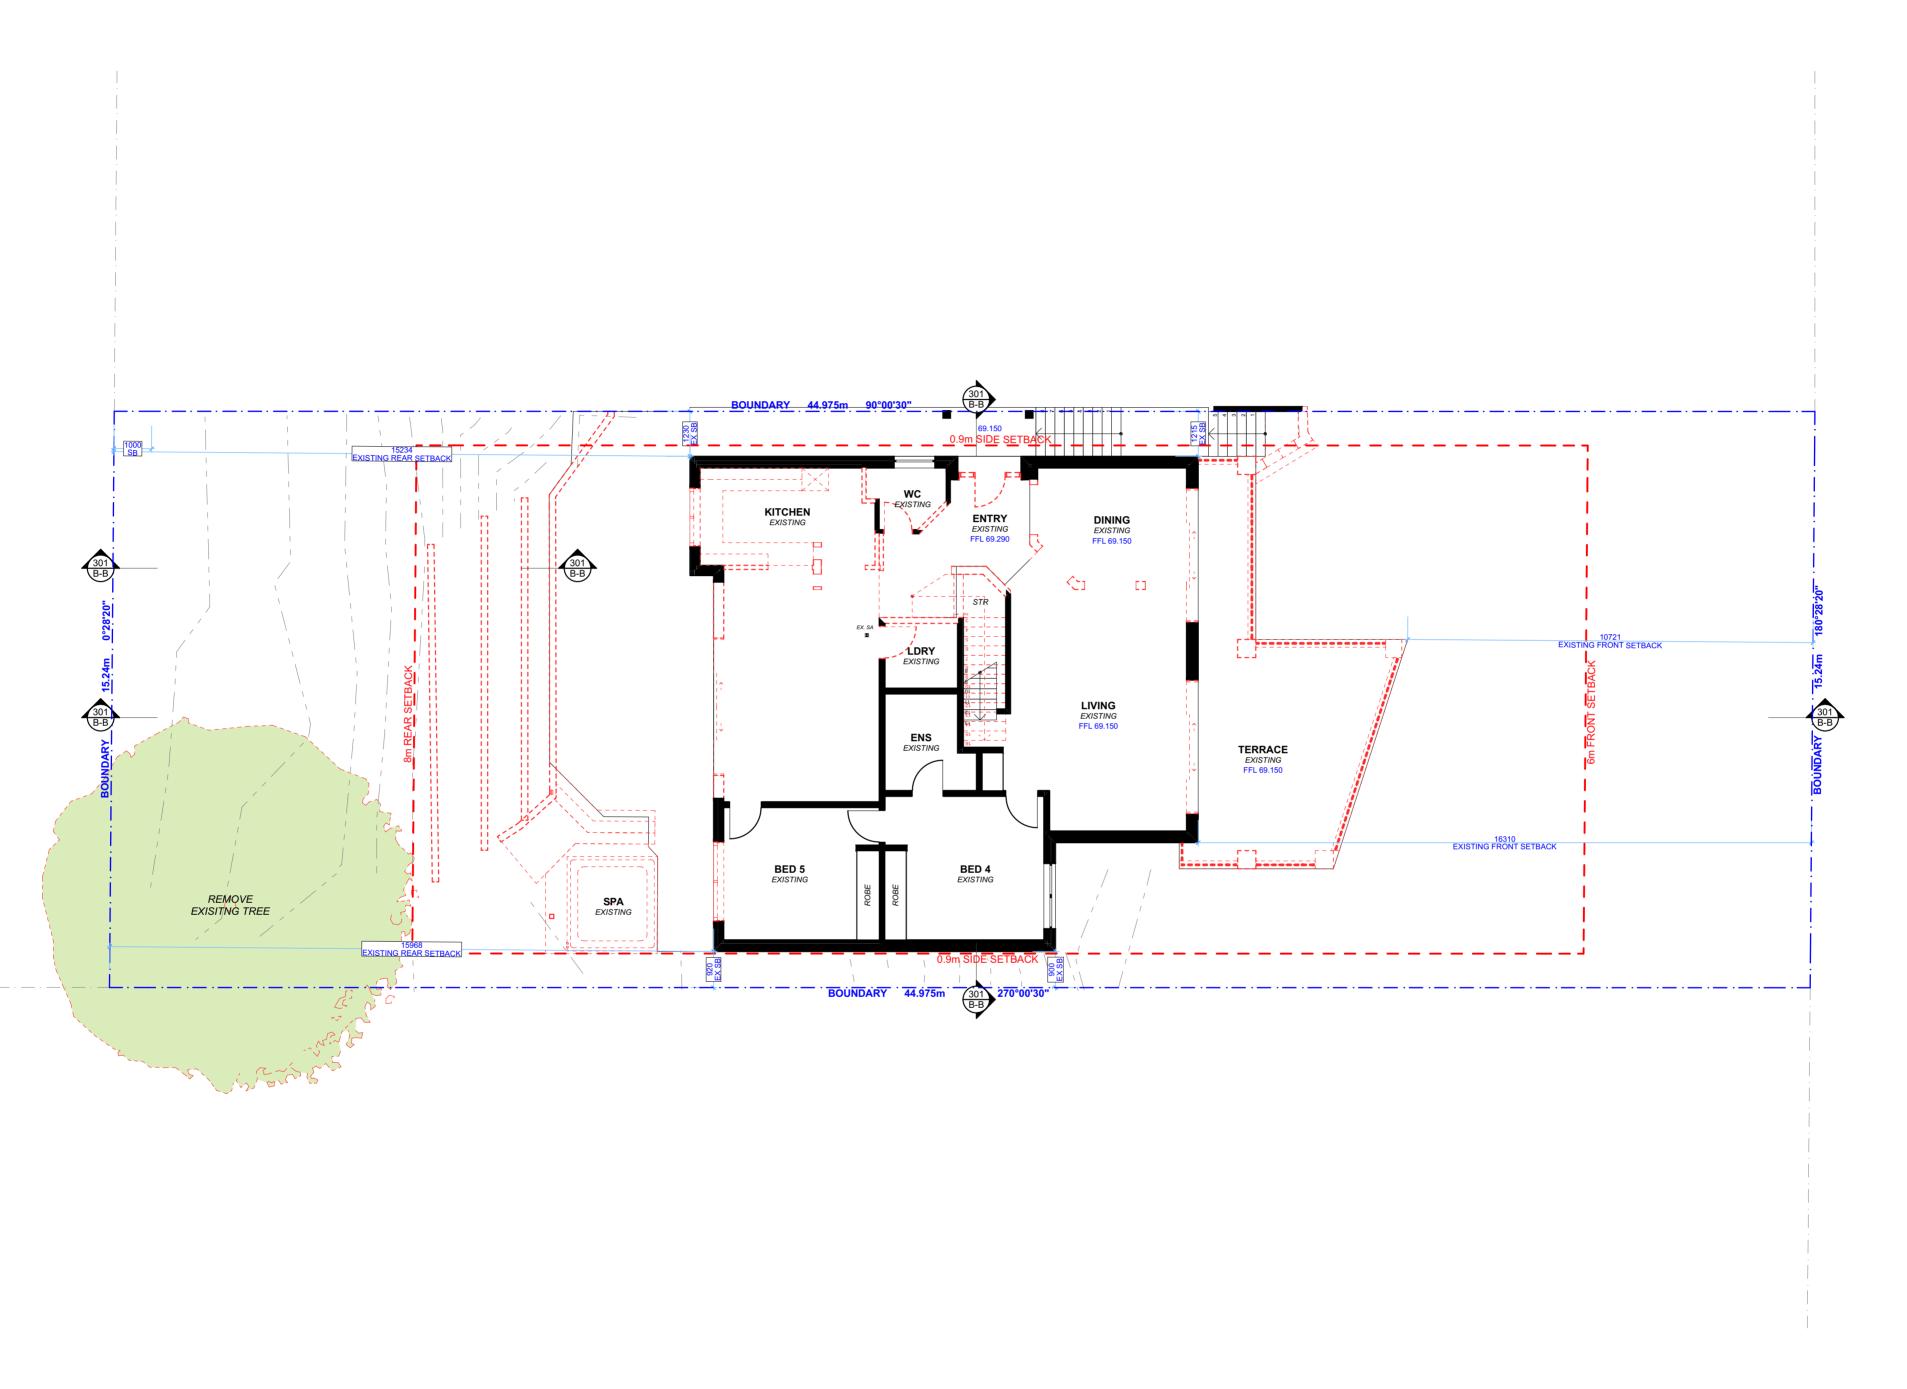
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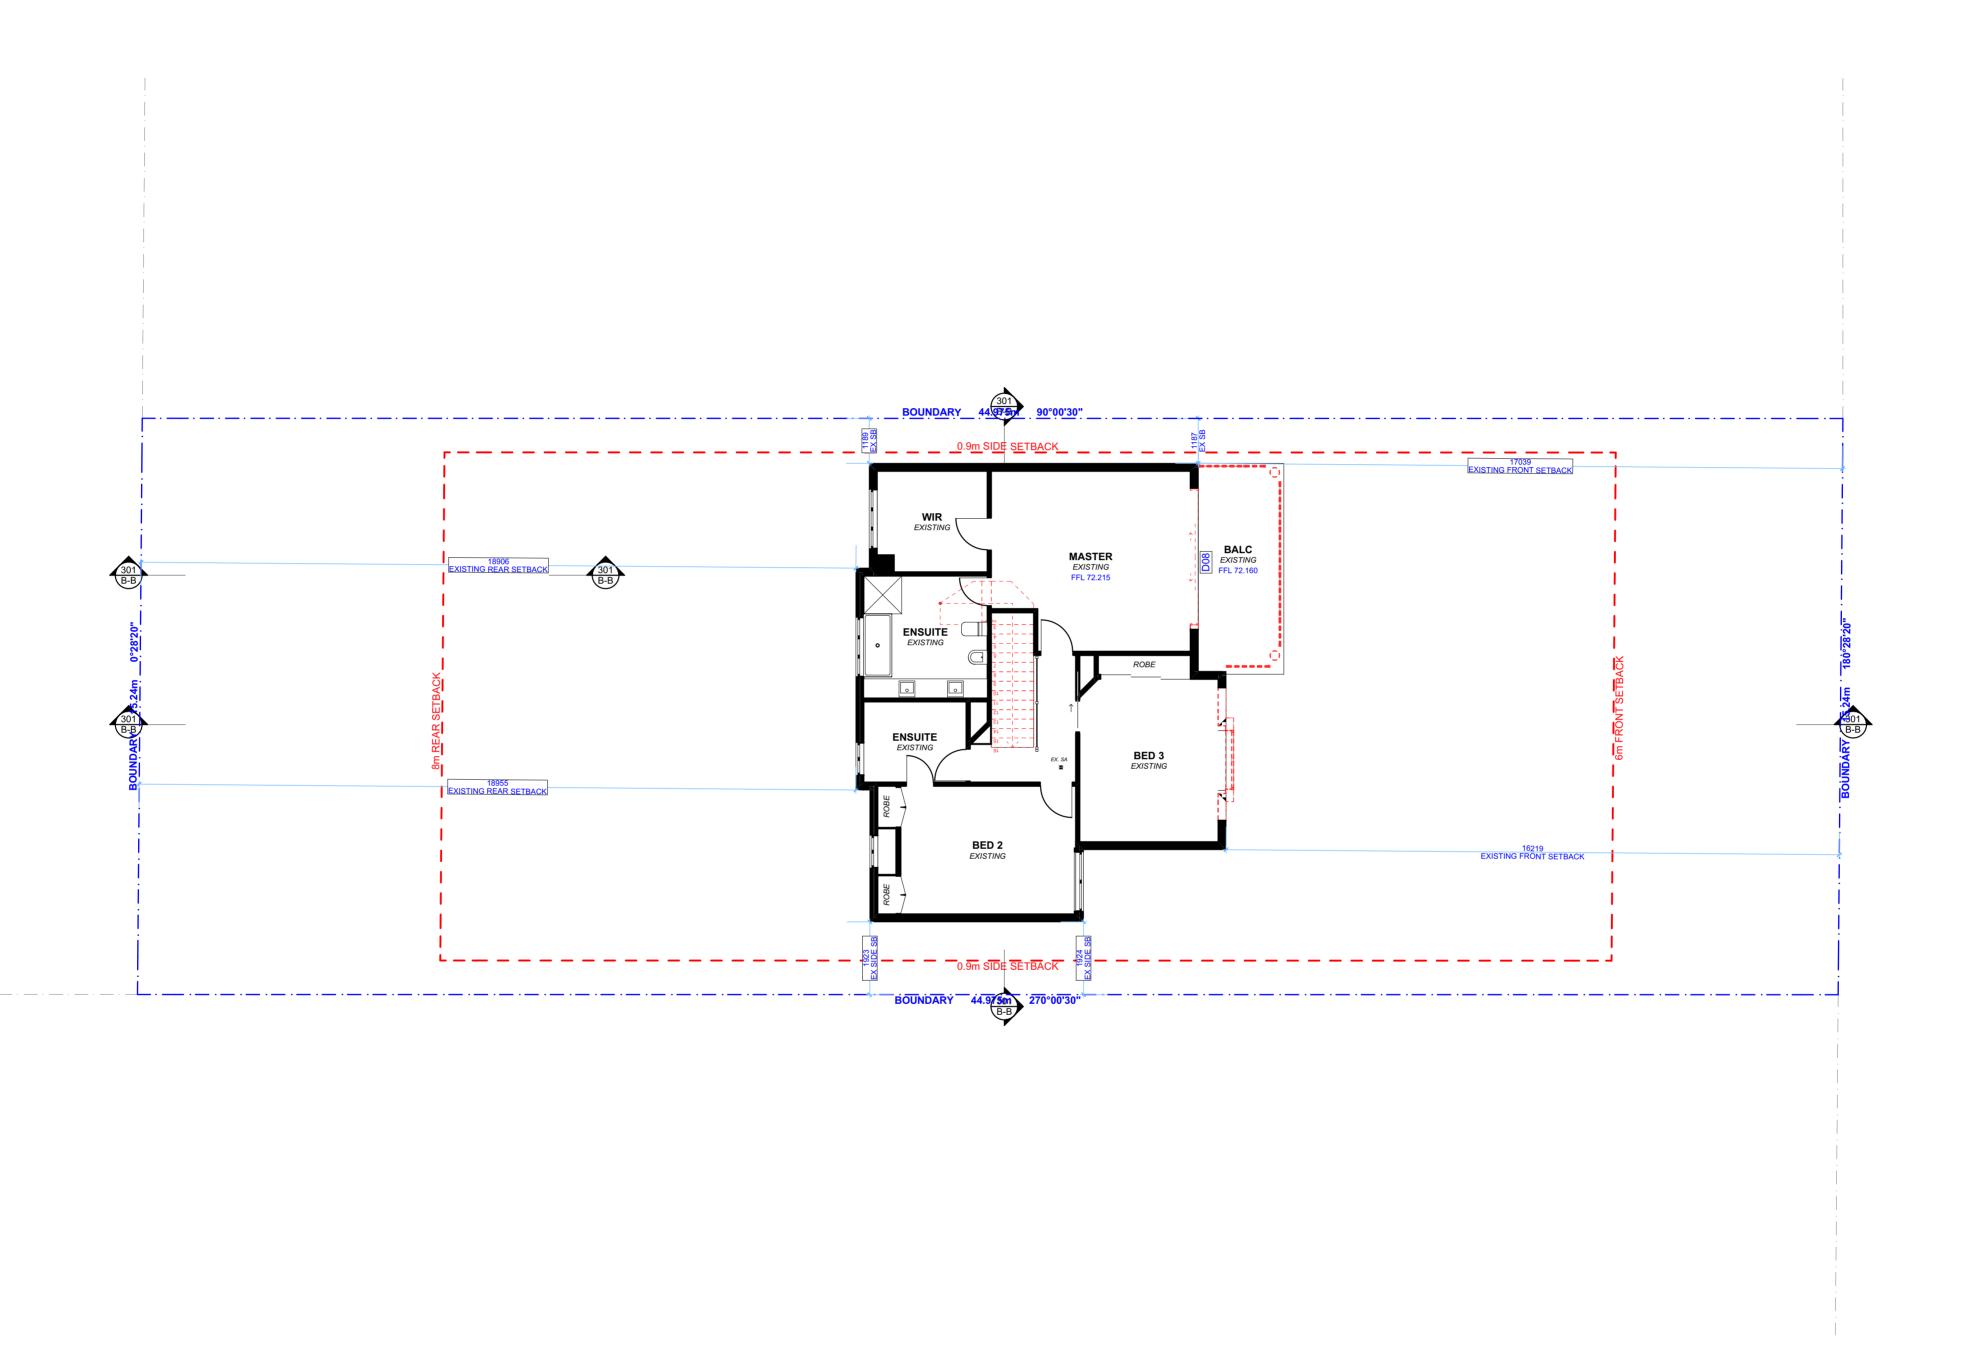
DRAWING NAME EXISTING GROUND FLOOR PLAN

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EXISTING FIRST FLOOR PLAN - DEMOLITION


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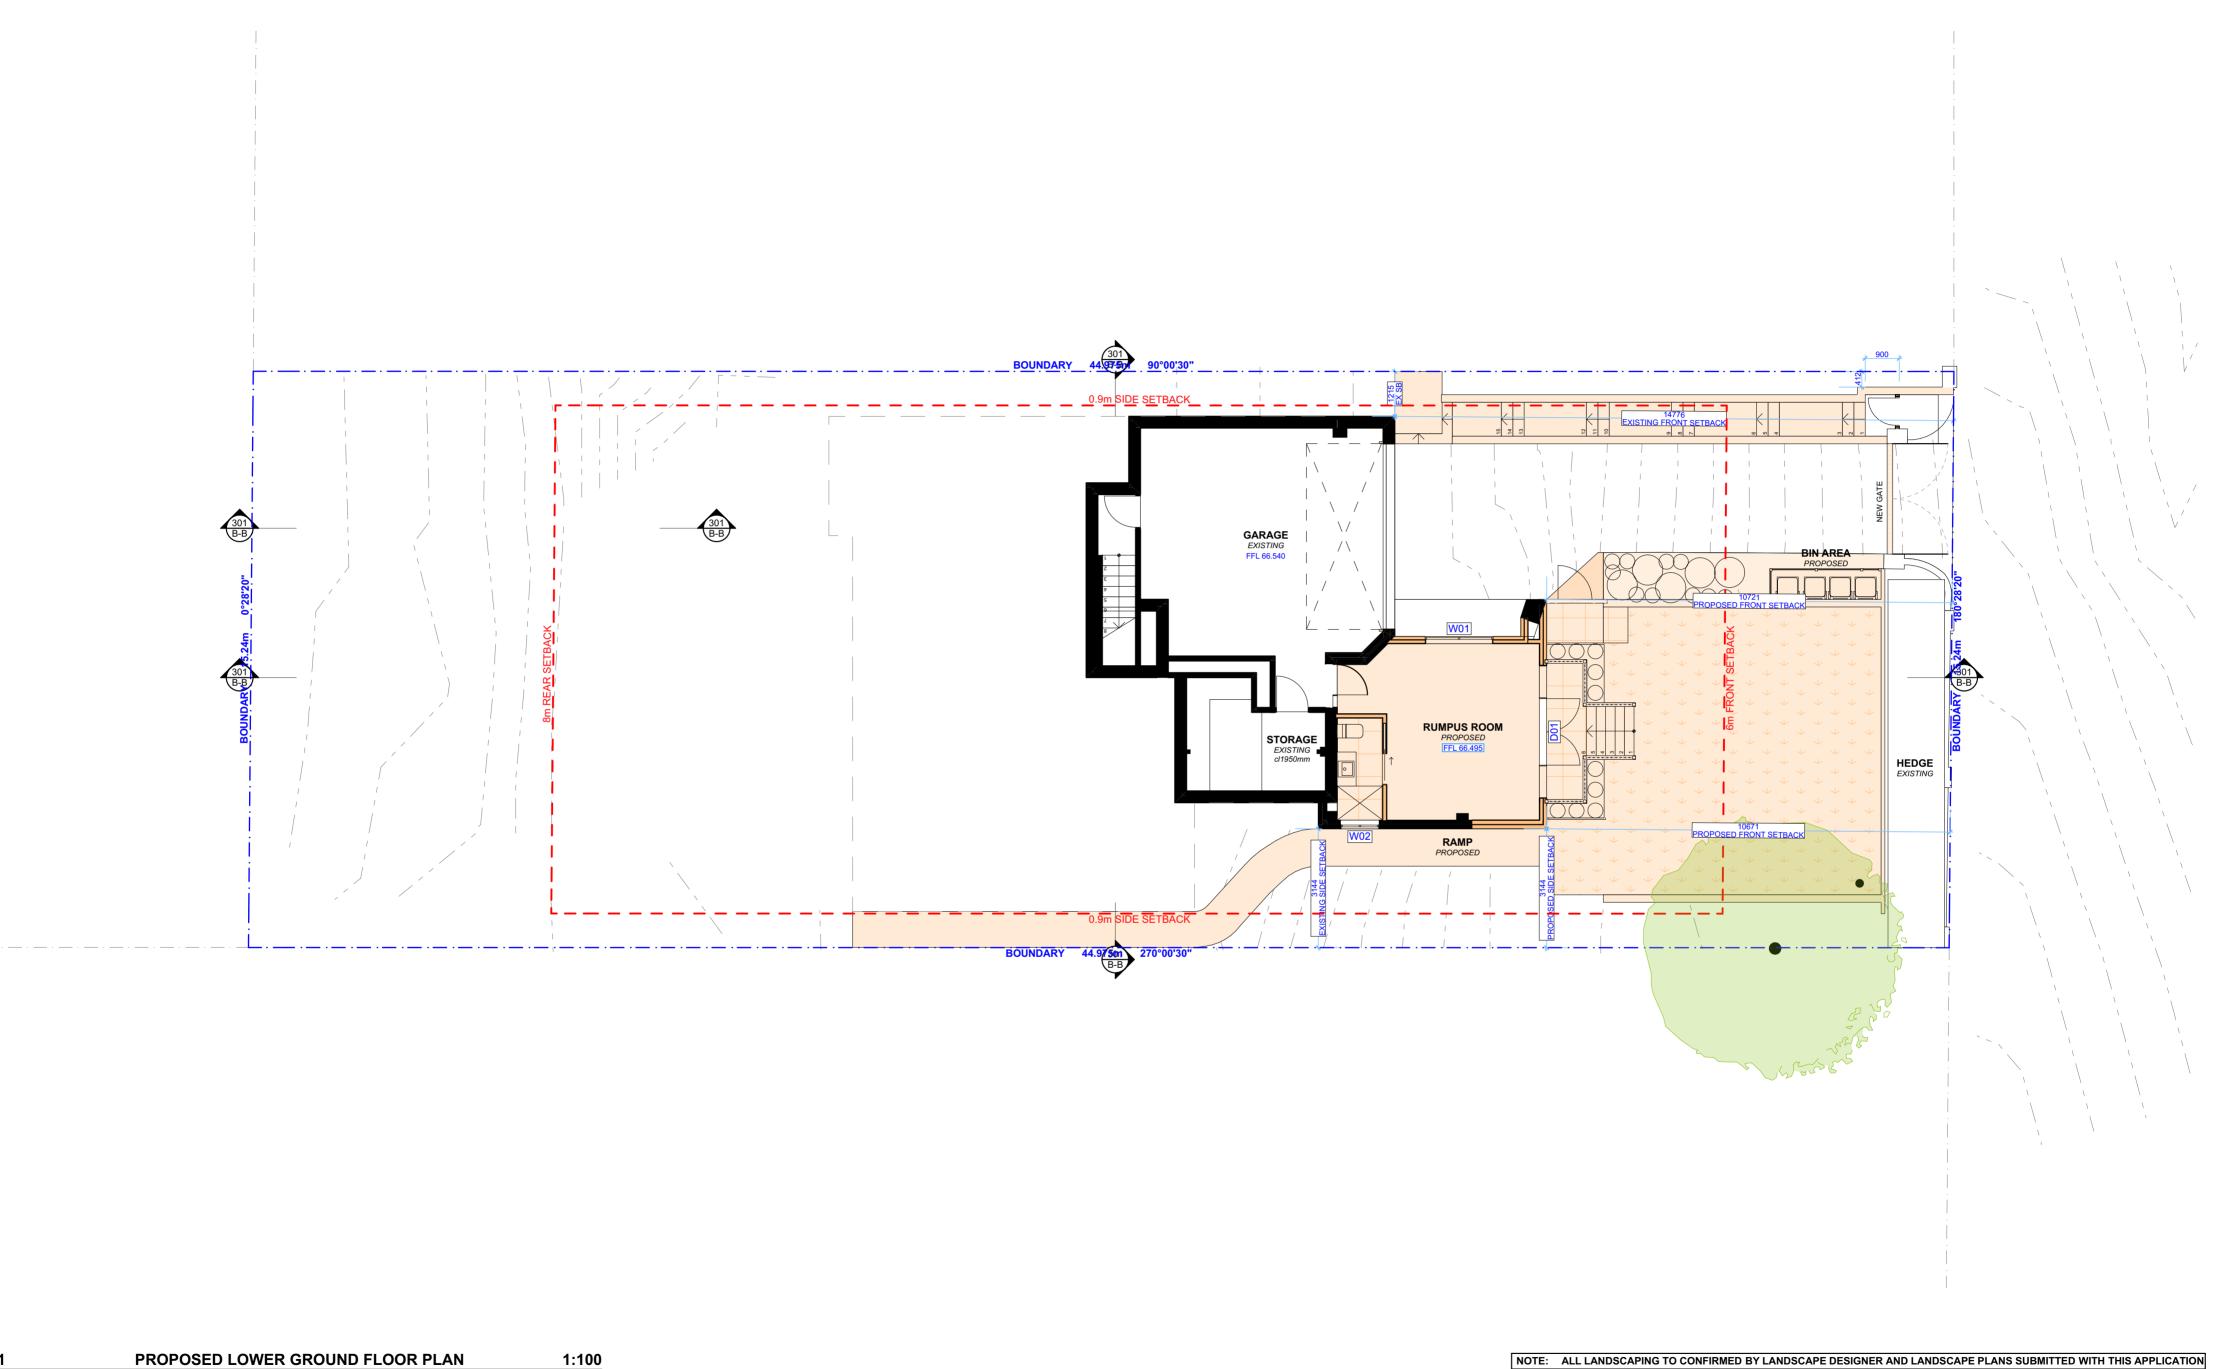
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PROPOSED LOWER GROUND FLOOR PLAN

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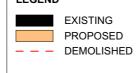
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CLIENT JO & JEAN OLIVER DRAWING NO. **DA08**

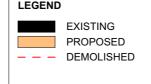DRAWING NAME PROPOSED LOWER GROUND FLOOR PLAN

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PROPOSED GROUND FLOOR PLAN

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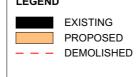
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JO & JEAN OLIVER

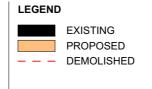CLIENT

DA09

DRAWING NAMEPROPOSED GROUND FLOOR PLAN

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DATE
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2021

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PROPOSED FIRST FLOOR PLAN

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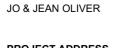
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CLIENT

DA10

DRAWING NAMEPROPOSED FIRST FLOOR PLAN

PROJECT ADDRESS


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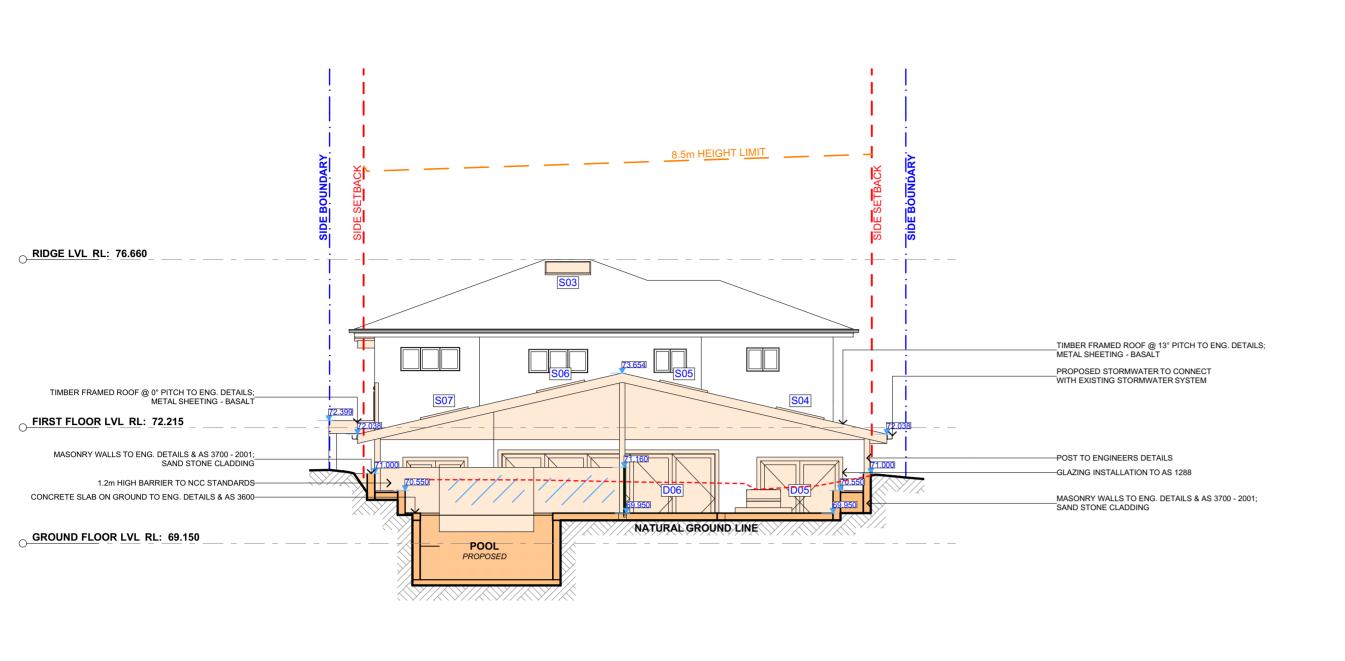
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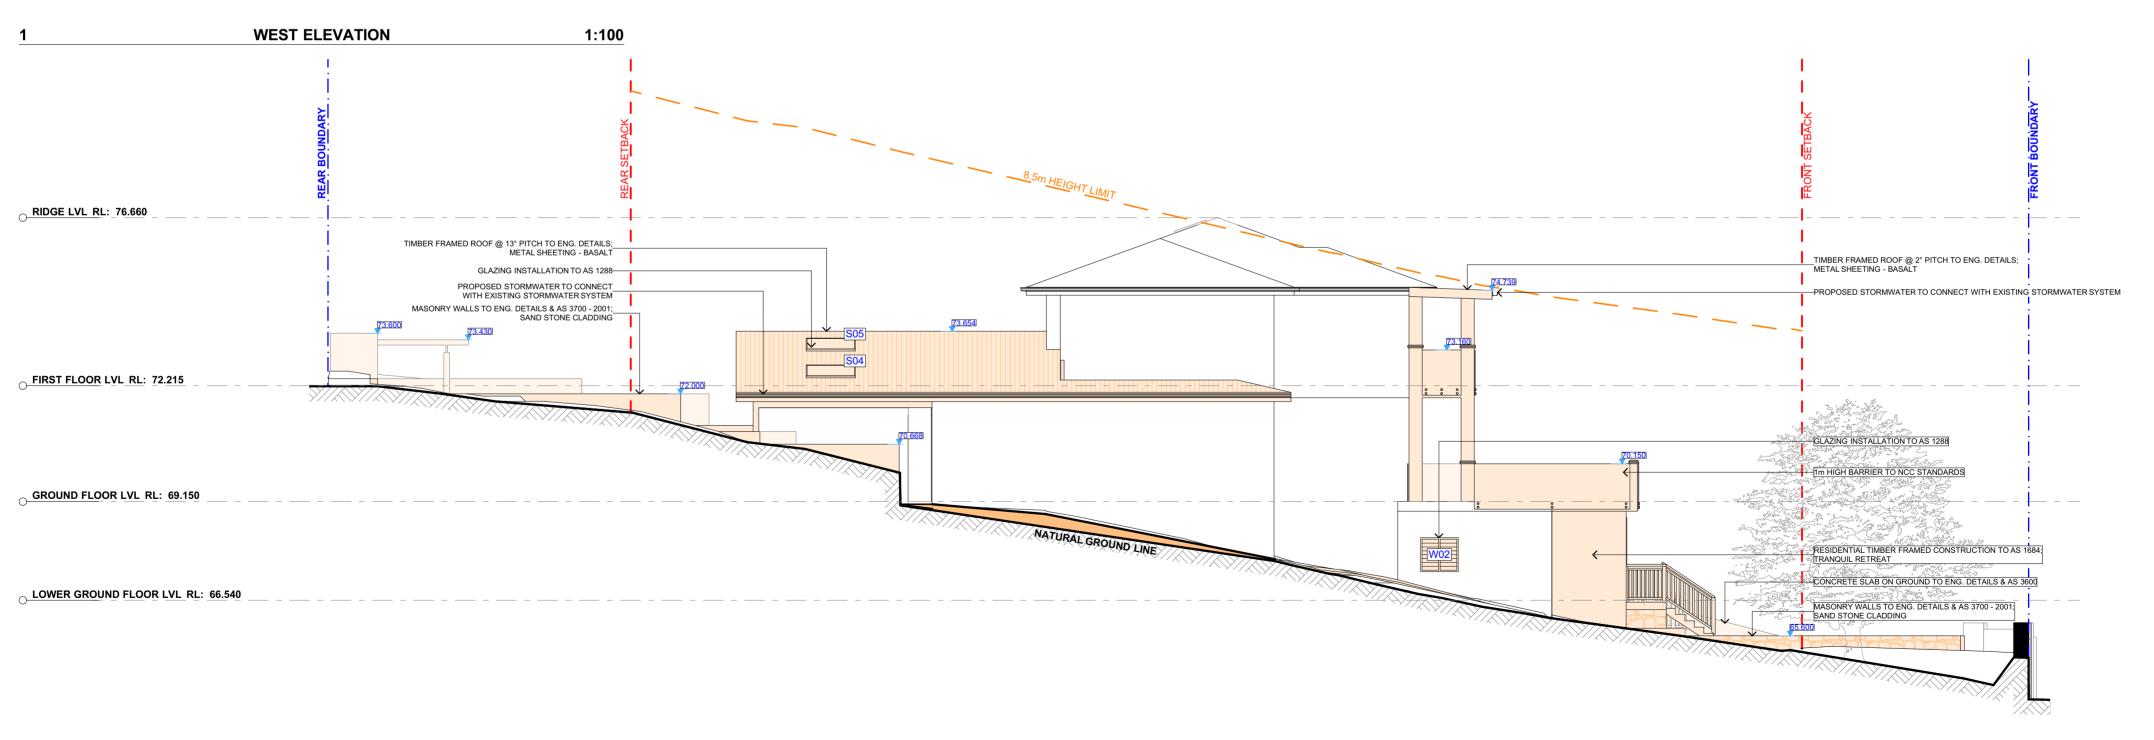






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SOUTH ELEVATION 1:100 NOTE: ALL LANDSCAPING TO CONFIRMED BY LANDSCAPE DESIGNER AND LANDSCAPE PLANS SUBMITTED WITH THIS APPLICATION REV. DATE COMMENTS DRWN NOTES NOTES

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PROJECT ADDRESS

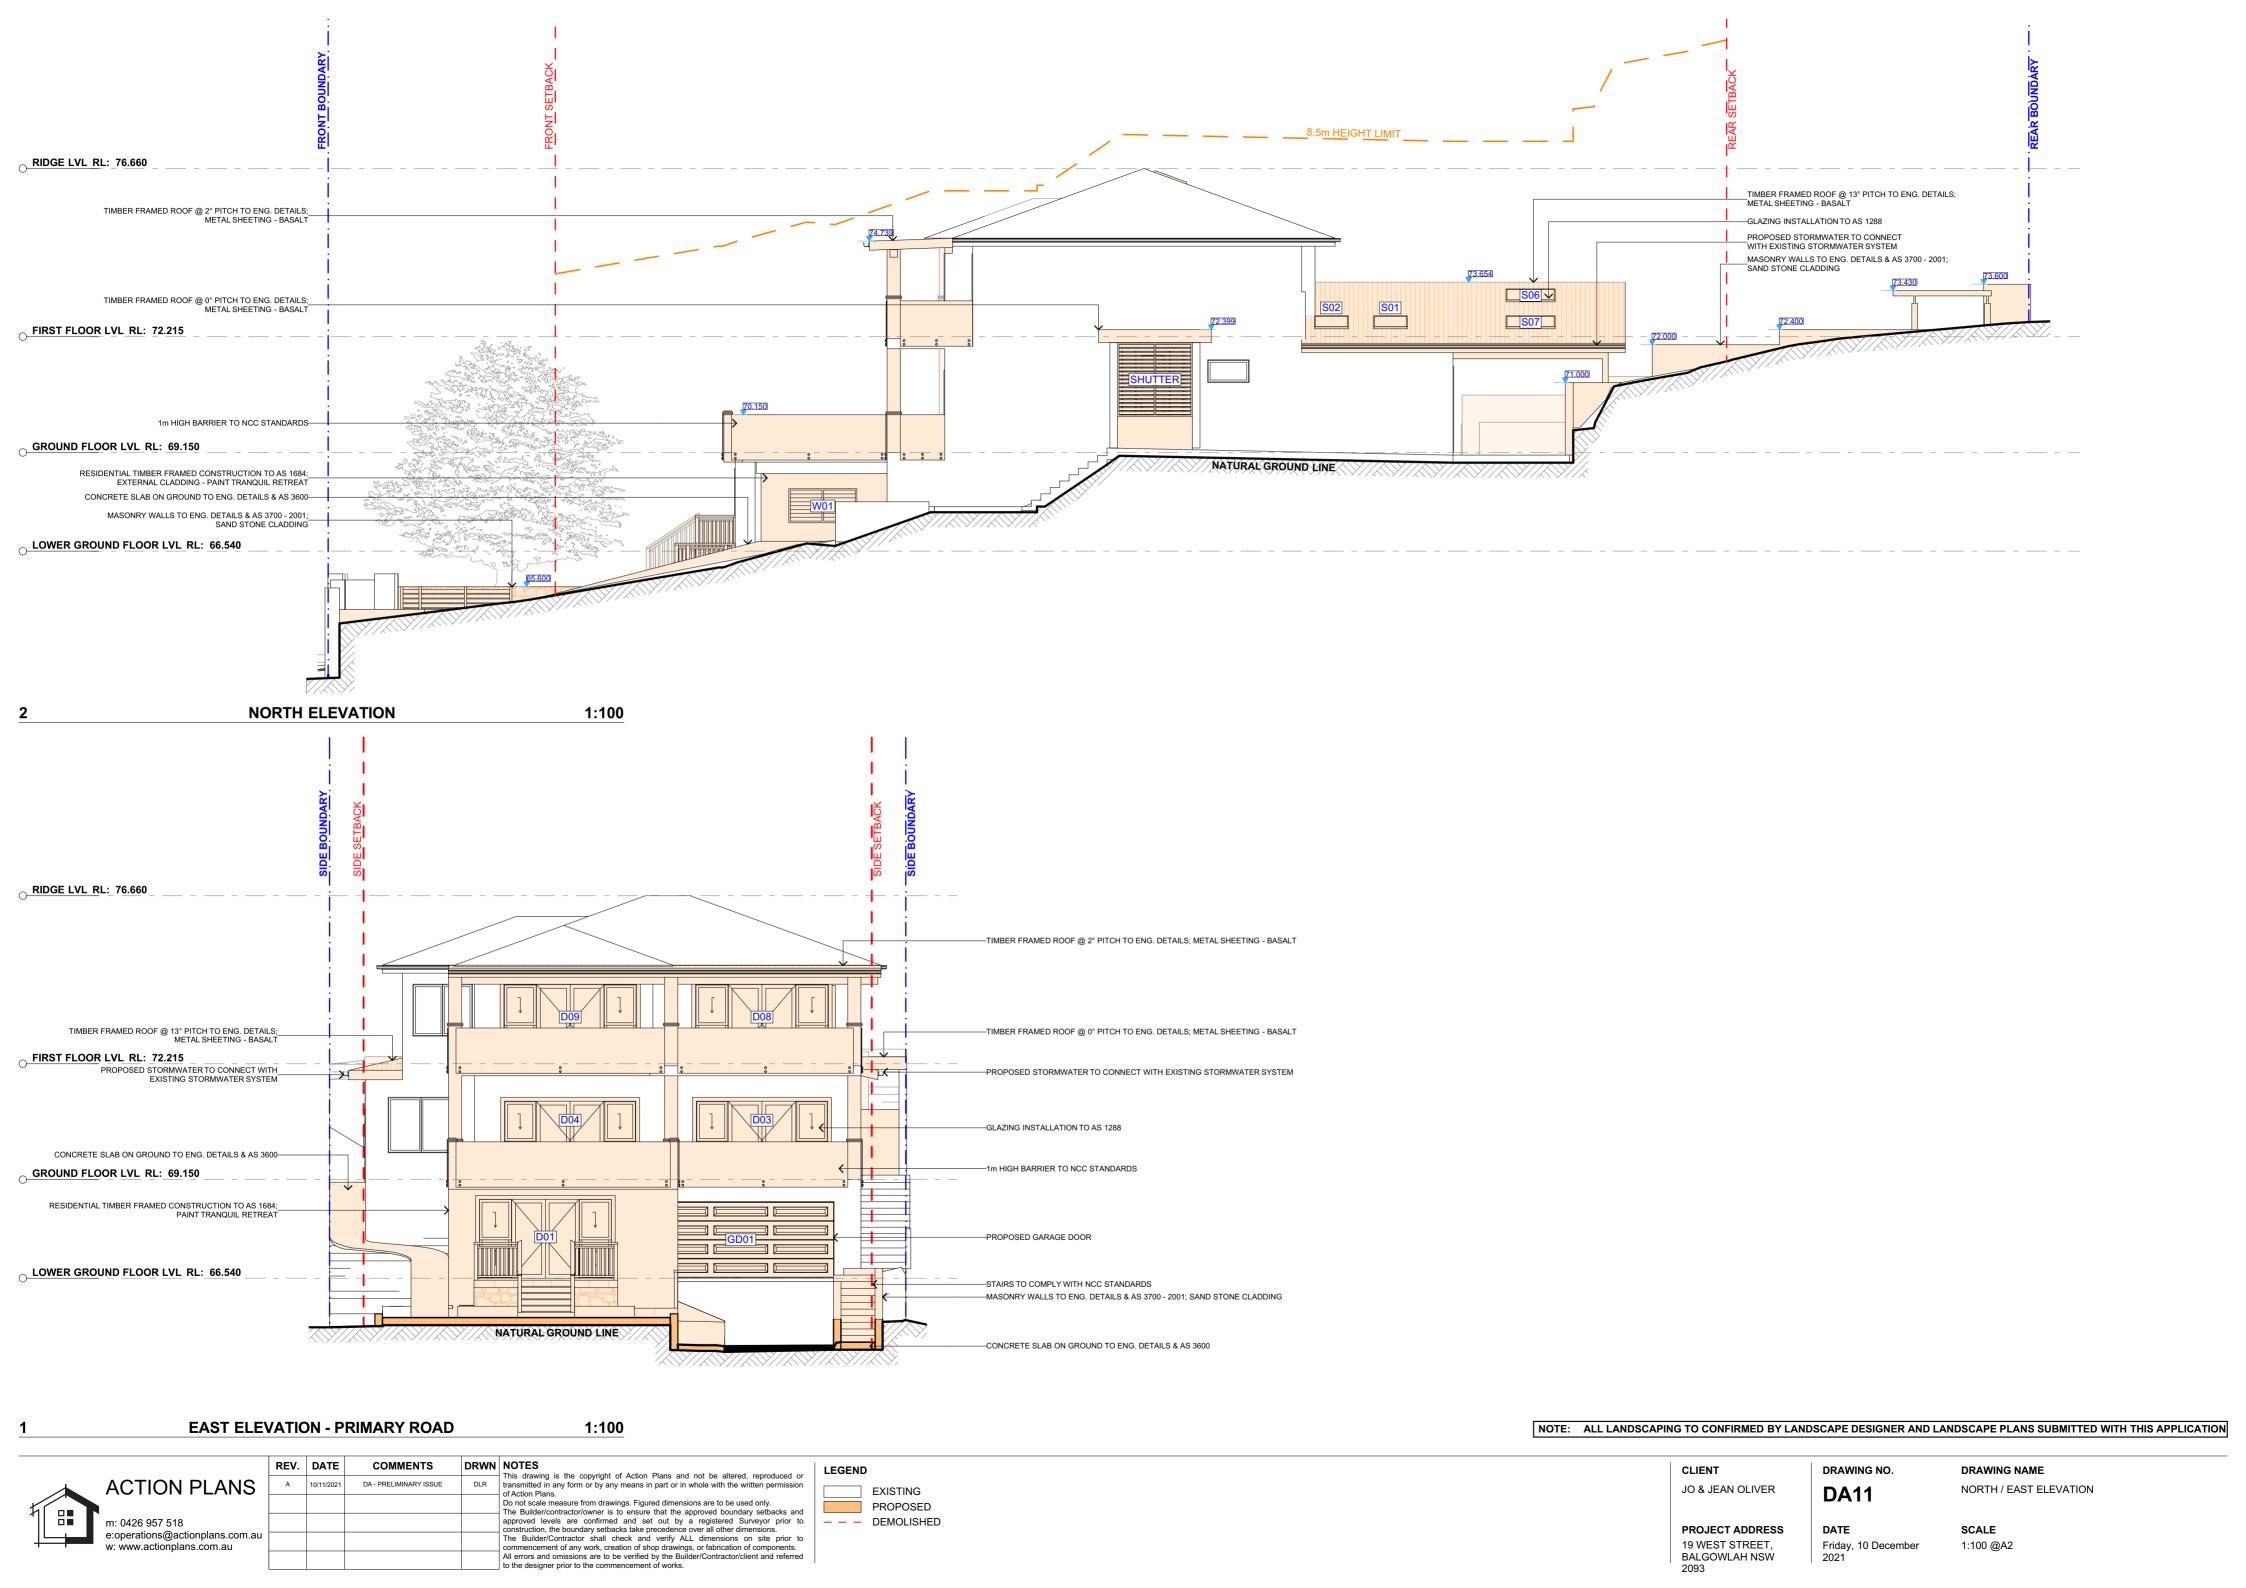
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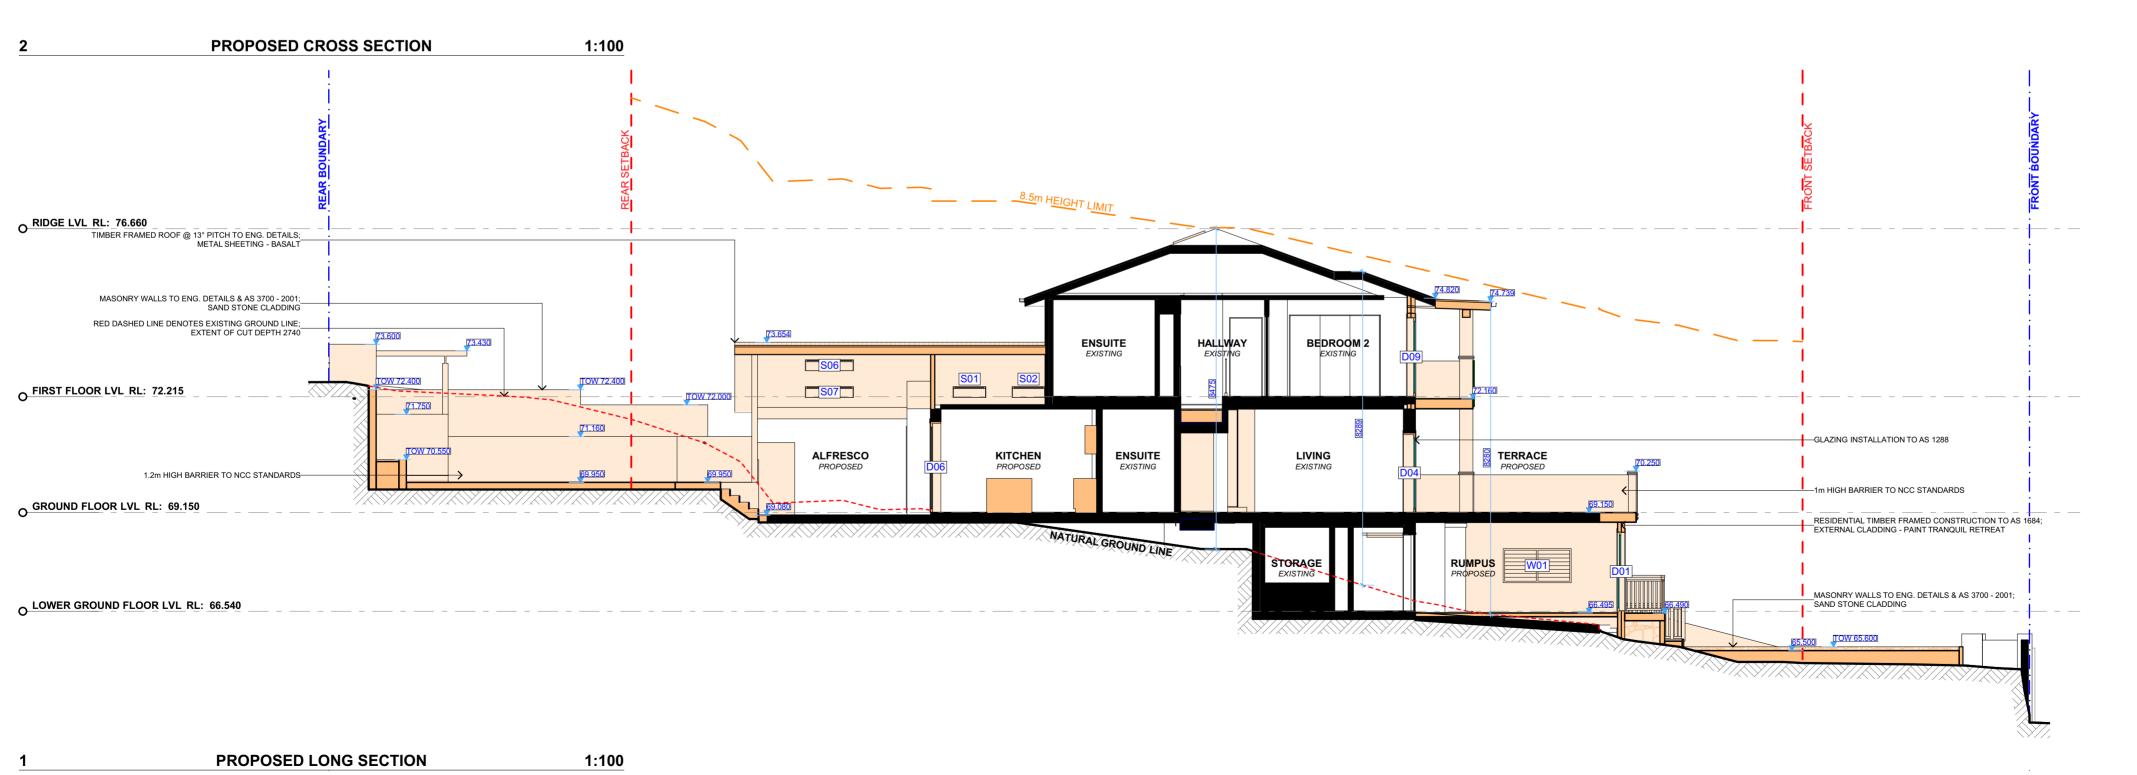
BALGOWLAH NSW

Friday, 10 December

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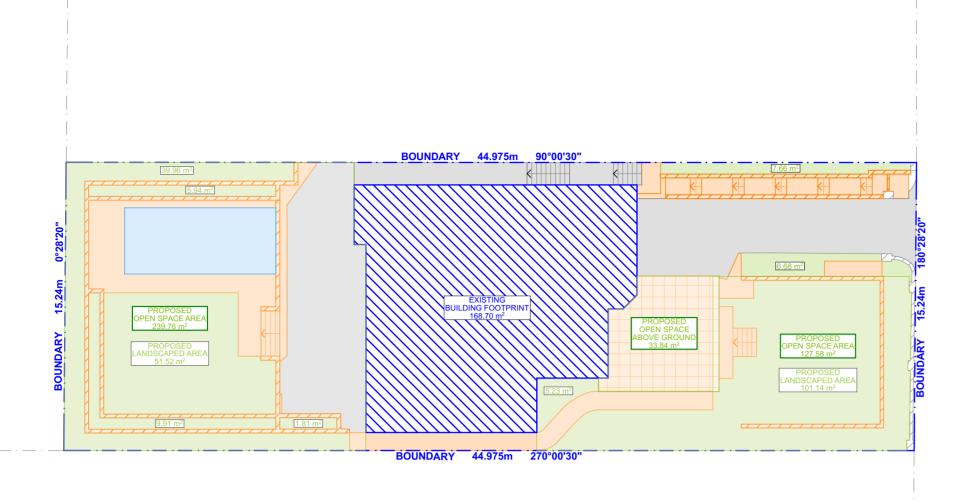
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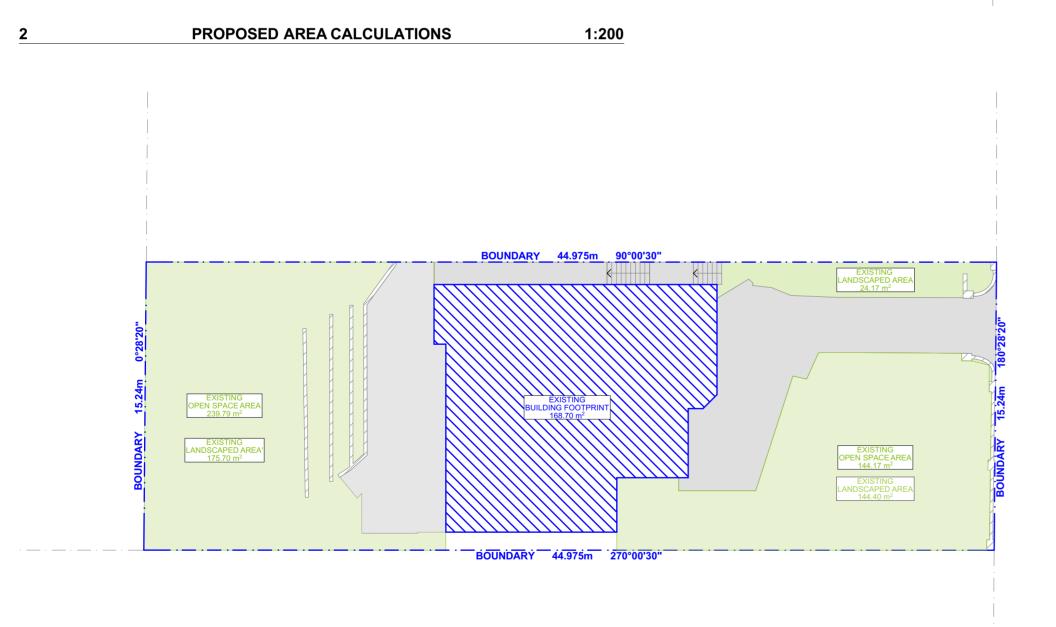
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EXISTING AREA CALCULATIONS


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	m: 0426 957 518					approved levels are confirmed and set out by a registered Surveyor prior to construction, the boundary setbacks take precedence over all other dimensions.	
	e:operations@actionplans.com.au w: www.actionplans.com.au					The Builder/Contractor shall check and verify ALL dimensions on site prior to commencement of any work, creation of shop drawings, or fabrication of components.	
	·					All errors and omissions are to be verified by the Builder/Contractor/client and referred to the designer prior to the commencement of works	

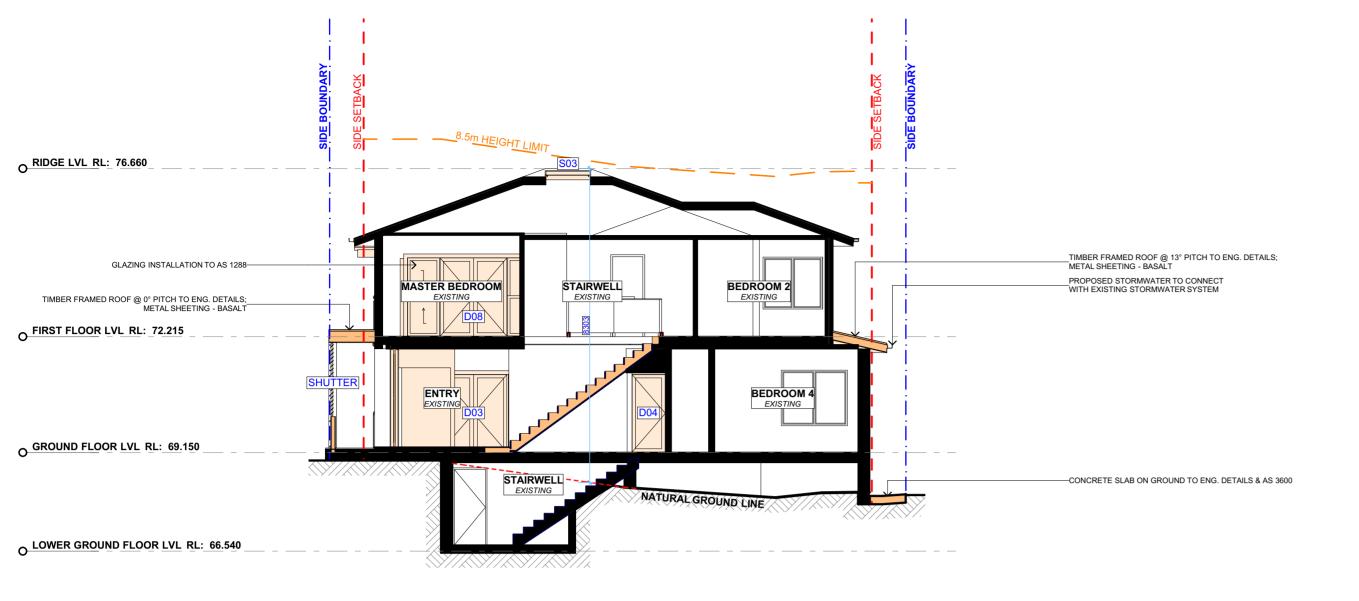

EXISTING SITE COVERAGE
PROPOSED SITE COVERAGE

CONTROL TABLE SITE AREA 682.9m² **PROPOSED** REQUIRED **EXISTING** TOTAL OPEN SPACE OS3 ABOVE GROUND 25% (93.89m²) 33.84m² **TOTAL OPEN SPACE OS3** 55% (375.59m²) 58.7% (401.18m²) 56.22% (383.96m²) LANDSCAPED AREA 35% (121.83m²) 89.66% (344.27m²) 66% (229.85m²)

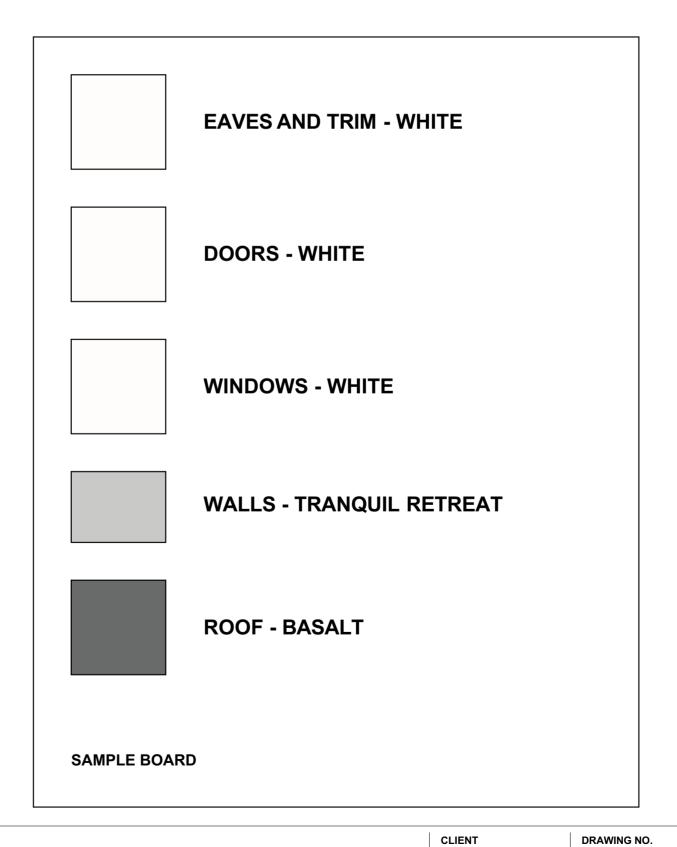

CLIENT
JO & JEAN OLIVER

PROJECT ADDRESS

19 WEST STREET, BALGOWLAH NSW 2093 DA14

DATE

Friday, 10 December 2021


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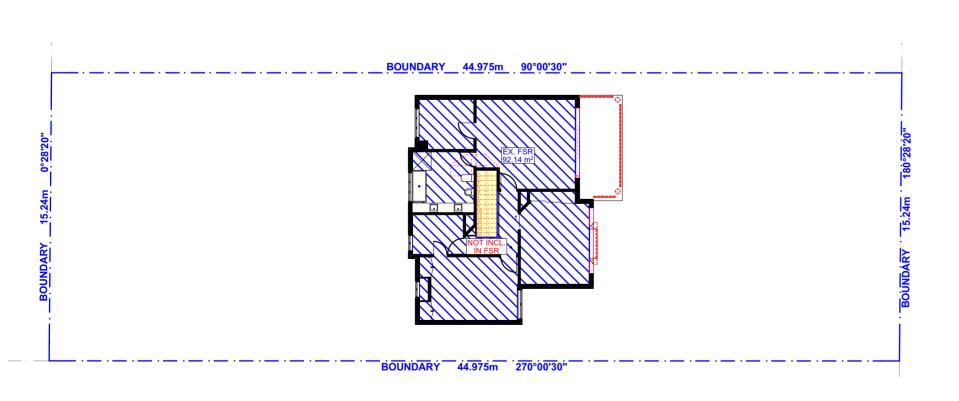
DRAWING NAME

AREA CALCULATIONS /
SAMPLE BOARD

SCALE 1:200 @A2





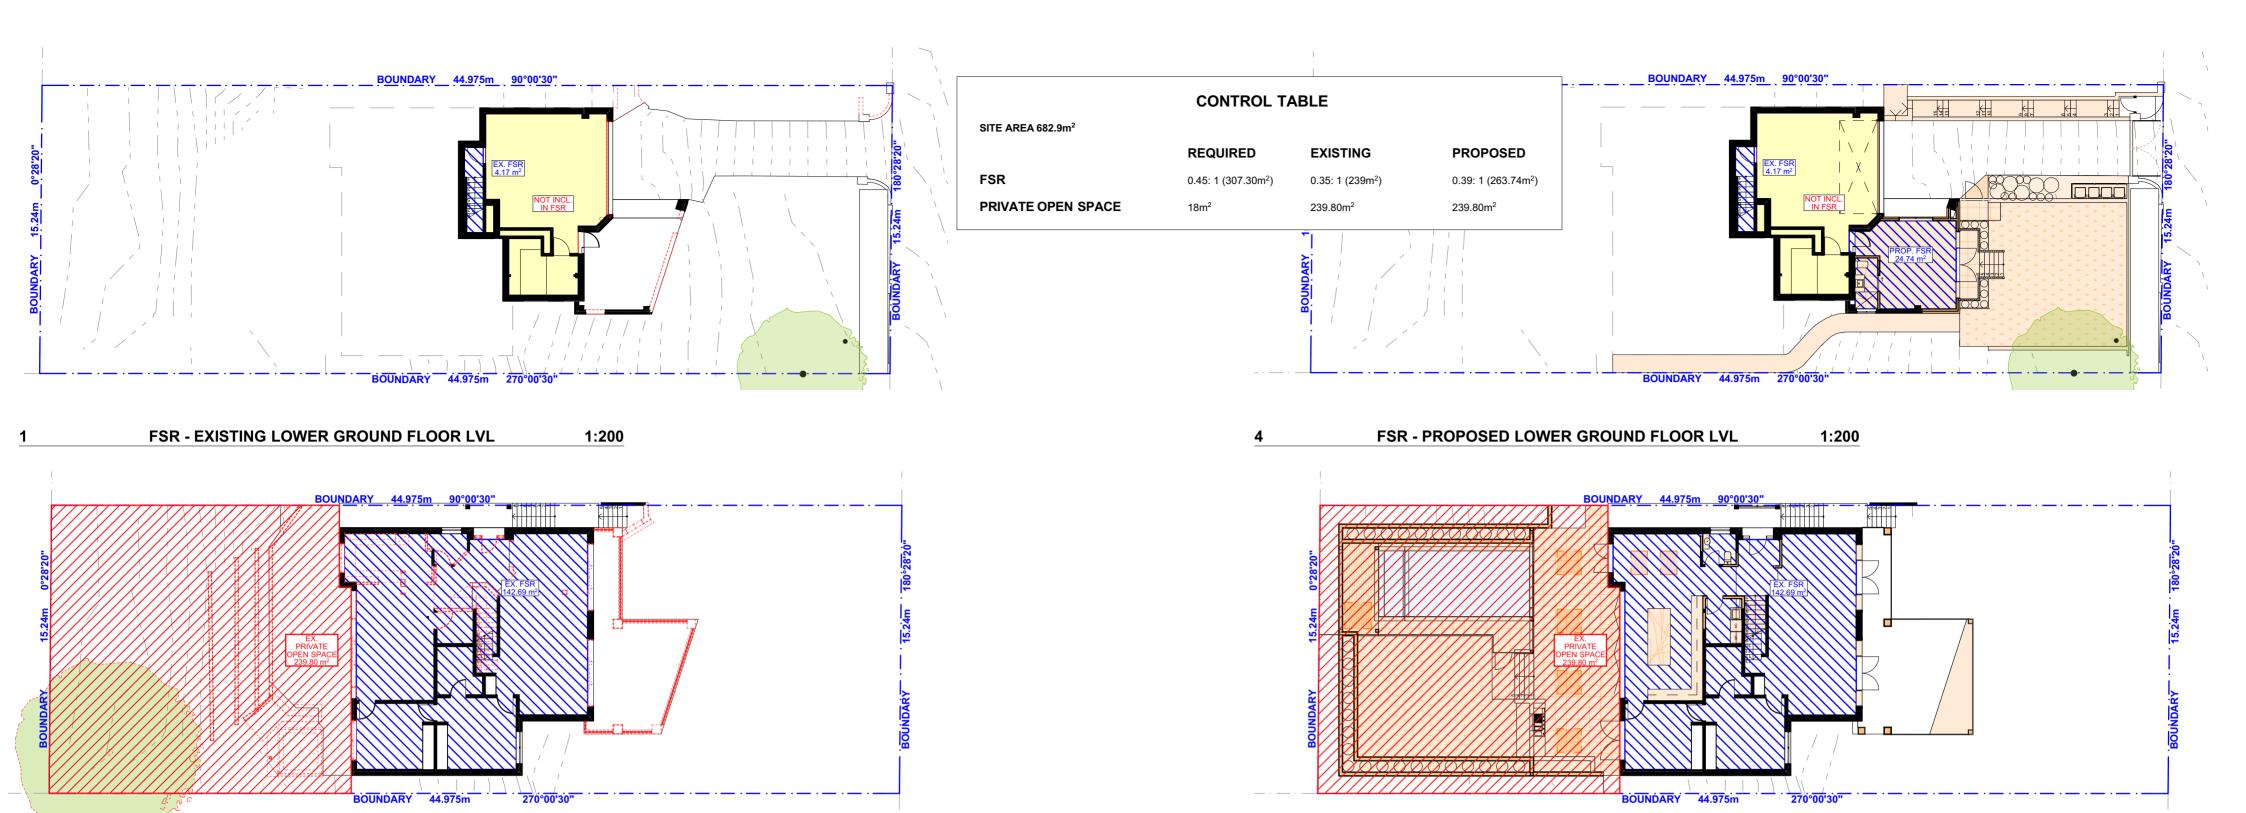

FSR - EXISTING GROUND FLOOR LVL

FSR - EXISTING FIRST FLOOR LVL

BOUNDARY 44.975m 90°00'30" BOUNDARY 44.975m '270°00'30"

FSR - PROPOSED GROUND FLOOR LVL

FSR - PROPOSED FIRST FLOOR LVL

		REV.	DATE	COMMENTS	DRWN	NOTES This drawing is the copyright of Action Plans and not be altered, reproduced or	LEGEND
	ACTION PLANS	Α	10/11/2021	DA - PRELIMINARY ISSUE	DLR	transmitted in any form or by any means in part or in whole with the written permission of Action Plans.	EXISTING FLOOR AREA
	l					Do not scale measure from drawings. Figured dimensions are to be used only. The Builder/contractor/owner is to ensure that the approved boundary setbacks and	PROPOSED FLOOR AREA
	m: 0426 957 518					approved levels are confirmed and set out by a registered Surveyor prior to construction, the boundary setbacks take precedence over all other dimensions.	PRIVATE OPEN SPACE
	e:operations@actionplans.com.au w: www.actionplans.com.au					The Builder/Contractor shall check and verify ALL dimensions on site prior to commencement of any work, creation of shop drawings, or fabrication of components.	AREA EXCLUDED FROM CALCULATIONS
						All errors and omissions are to be verified by the Builder/Contractor/client and referred to the designer prior to the commencement of works.	

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JO & JEAN OLIVER PROJECT ADDRESS 19 WEST STREET, BALGOWLAH NSW 2093

CLIENT

DRAWING NO. **DA15**

DATE


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DRAWING NAME FLOOR AREA CALCULATIONS

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1 WINTER SOLSTICE 9AM 1:200

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					Do not scale measure from drawings. Figured dimensions are to be used only. The Builder/contractor/owner is to ensure that the approved boundary setbacks and	1
					approved levels are confirmed and set out by a registered Surveyor prior to construction, the boundary setbacks take precedence over all other dimensions.	L
ı.au					The Builder/Contractor shall check and verify ALL dimensions on site prior to commencement of any work, creation of shop drawings, or fabrication of components.	
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JO & JEAN OLIVER

DA16

DRAWING NAMEWINTER SOLSTICE 9 AM

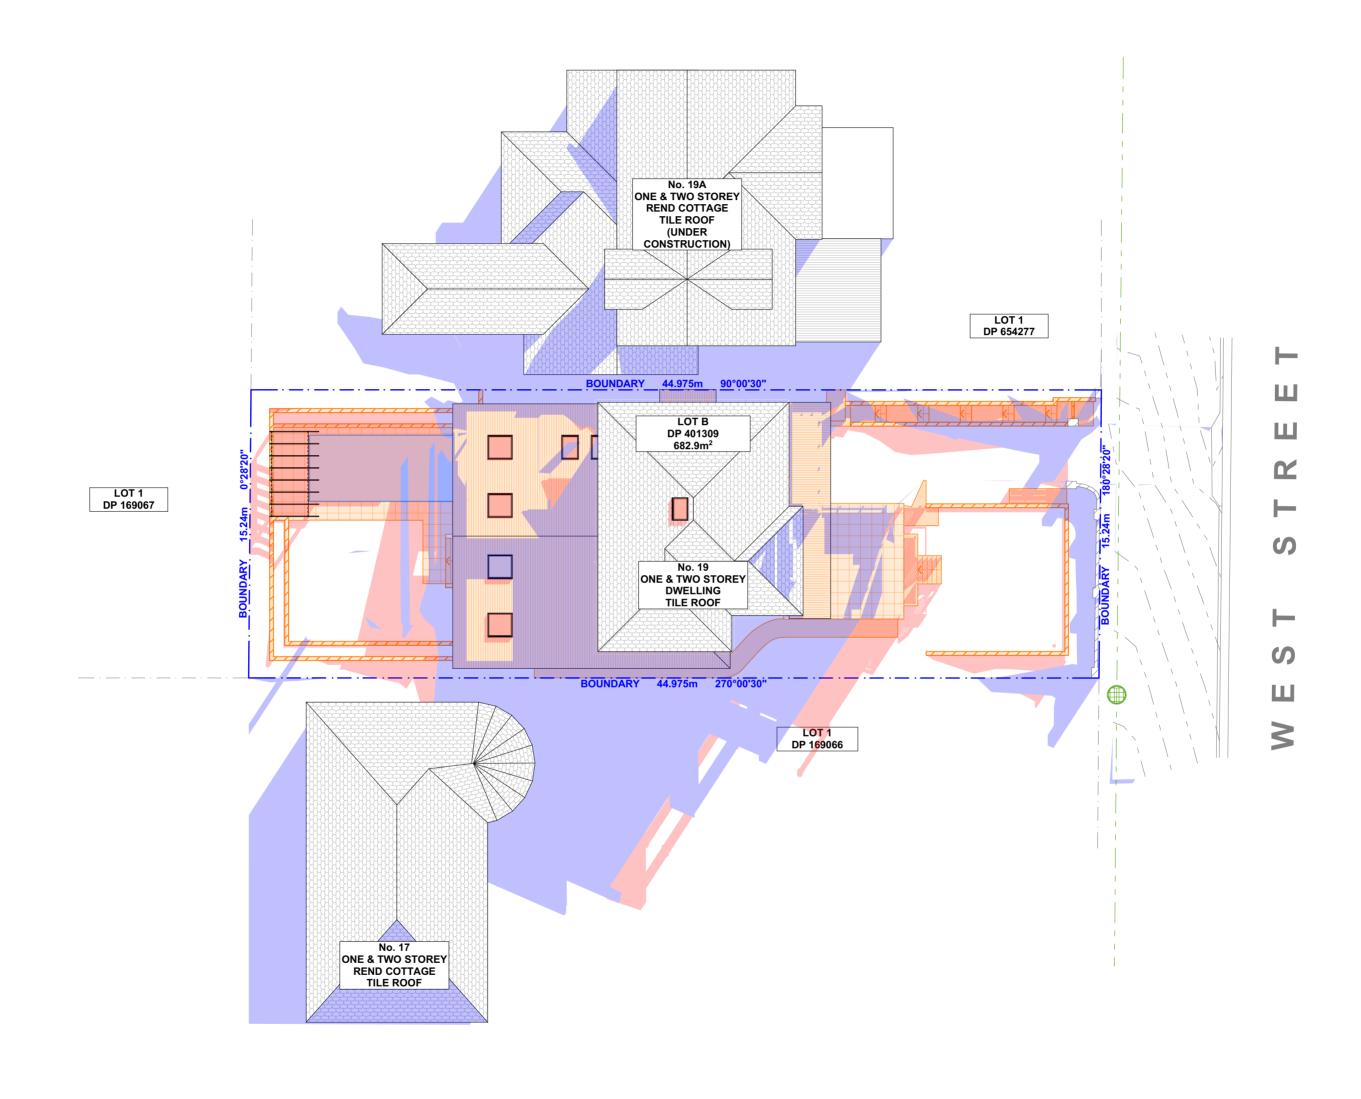
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DATE
Friday, 10 December
2021

SCALE 1:200 @A2





WINTER SOLSTICE 12PM

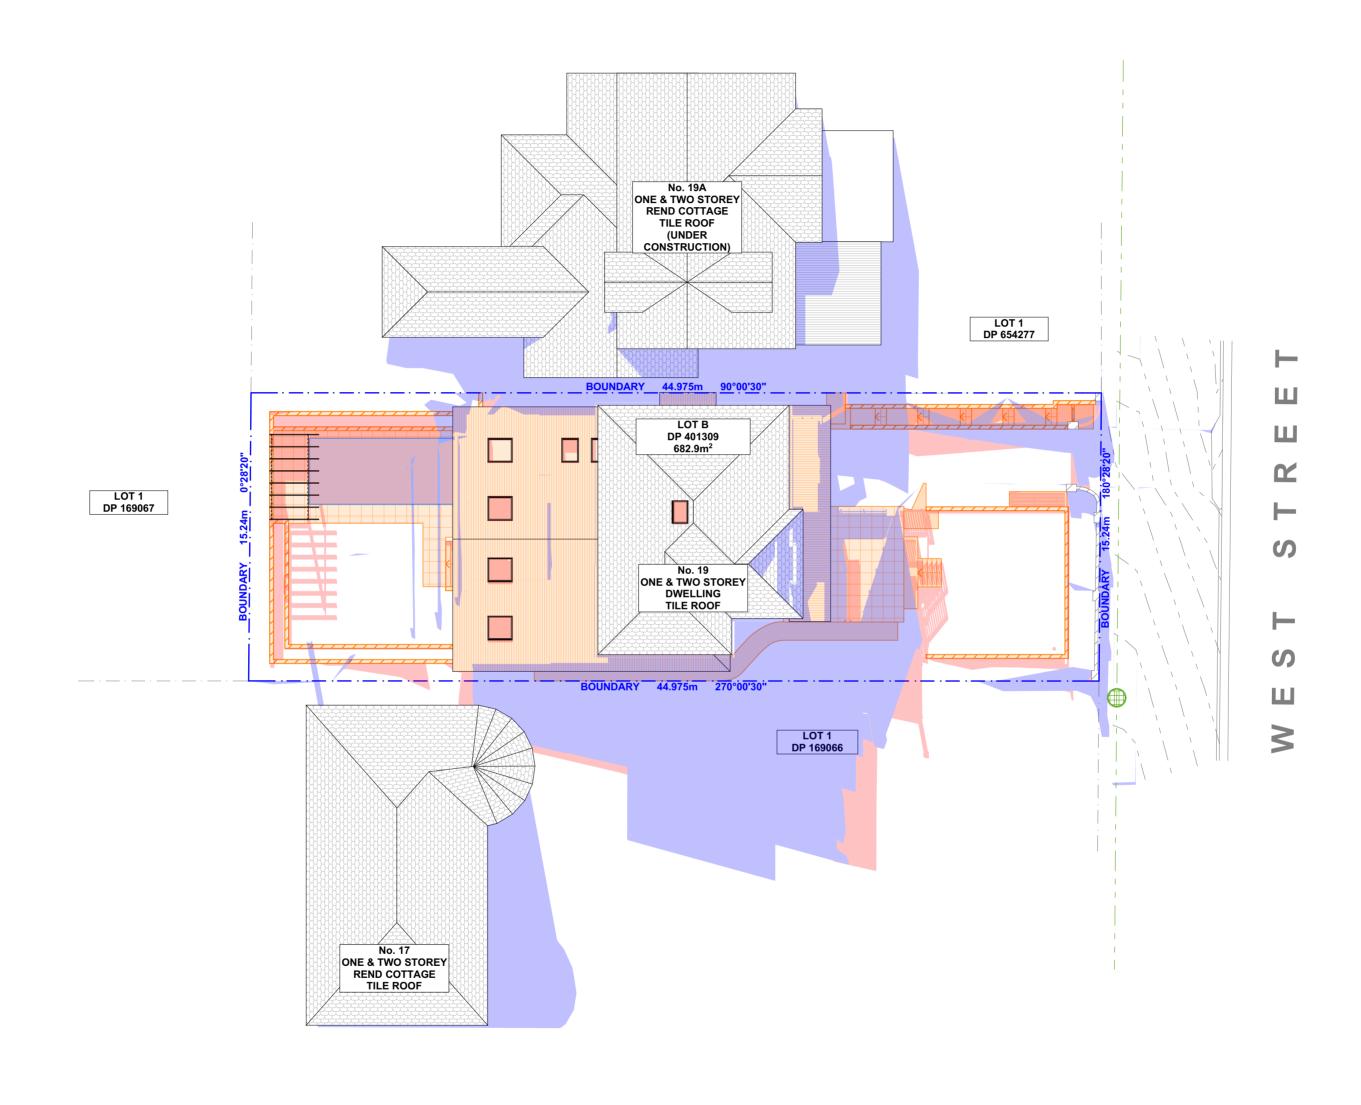1:200

		REV.	DATE	COMMENTS	DRWN	NOTES	
	ACTION PLANS	A	10/11/2021	DA - PRELIMINARY ISSUE	DLR	 This drawing is the copyright of Action Plans and not be altered, reproduced or transmitted in any form or by any means in part or in whole with the written permission of Action Plans. 	
1						Do not scale measure from drawings. Figured dimensions are to be used only. The Builder/contractor/owner is to ensure that the approved boundary setbacks and	
1 5	m: 0426 957 518					approved levels are confirmed and set out by a registered Surveyor prior to construction, the boundary setbacks take precedence over all other dimensions.	
	e:operations@actionplans.com.au w: www.actionplans.com.au					The Builder/Contractor shall check and verify ALL dimensions on site prior to commencement of any work, creation of shop drawings, or fabrication of components.	
						All errors and omissions are to be verified by the Builder/Contractor/client and referred to the designer prior to the commencement of works.	

r	LEGEND	
1		EXISTING SHADOWS
i		PROPOSED SHADOWS
)		

CLIENT JO & JEAN OLIVER

PROJECT ADDRESS

19 WEST STREET, BALGOWLAH NSW 2093


DRAWING NO. **DA17**

DATE

DRAWING NAME WINTER SOLSTICE 12 PM

SCALE Friday, 10 December 2021 1:200 @A2



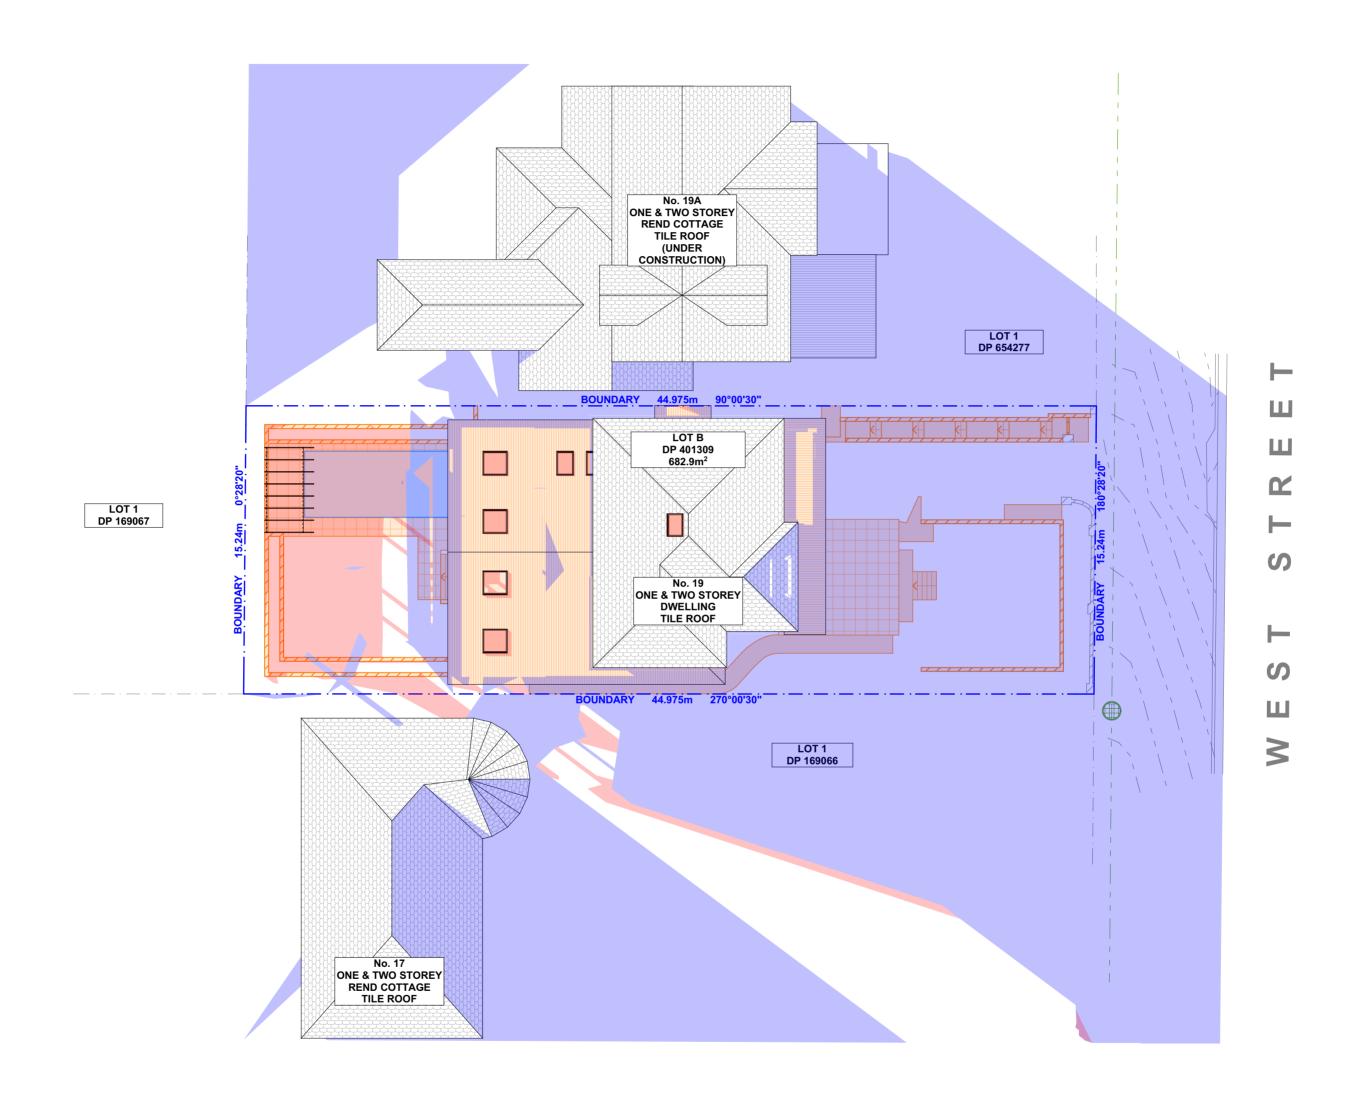

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	ACTION PLANS	
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	REV.	DAIL	COMMENTS	DUANIA	NOTES	
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.au					The Builder/Contractor shall check and verify ALL dimensions on site prior to commencement of any work, creation of shop drawings, or fabrication of components.	
					All errors and omissions are to be verified by the Builder/Contractor/client and referred to the designer prior to the commencement of works.	



CLIENT
JO & JEAN OLIVER
PROJECT ADDRESS

19 WEST STREET, BALGOWLAH NSW 2093 DA18

DATE

Friday, 10 December 2021

DRAWING NAMEWINTER SOLSTICE 3 PM

SCALE 1:200 @A2






Building Sustainability Index www.basix.nsw.gov.au

Alterations and Additions

Certificate number: A439466

This certificate confirms that the proposed development will meet the NSW government's requirements for sustainability, if it is built in accordance with the commitments set out below. Terms used in this certificate, or in the commitments, have the meaning given by the document entitled "BASIX Alterations and Additions Definitions" dated 06/10/2017 published by the Department. This document is available at www.basix.nsw.gov.au

Secretary Date of issue: Tuesday, 09, November 2021 To be valid, this certificate must be lodged within 3 months of the date of issue.

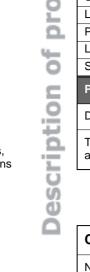

D : .	2000 40 WEST ST. BALGOW! ALL
Project name	0863_19 WEST ST, BALGOWLAH
Street address	19 WEST Street WEST PENNANT HILLS 2093
Local Government Area	Northern Beaches Council
Plan type and number	Deposited Plan 401309
Lot number	В
Section number	
Project type	
Dwelling type	Separate dwelling house
Type of alteration and addition	My renovation work is valued at \$50,000 or more and includes a pool (and/or spa).

Certificate Prepared by (please complete before submitting to Council or PCA)
Name / Company Name: Action Plans
ABN (if applicable): 17118297587

i o be valid, t	inis certificate must be lodged within 3 month	is of the date of issue.	Continuate i repared by (piease comple	to before submit	ing to council of	i i OA)	
			Name / Company Name: Action Plans				
NSW GOVERNMENT	Planning, Industry & Environment		ABN (if applicable): 17118297587				
Pool and S	Spa			Show on DA Plans	Show on CC/CDC Plans & specs	Certifier Check	
Rainwater	tank						
	nt must install a rainwater tank of at juirements of all applicable regulato	least 1476 litres on the site. This rainwater tank rry authorities.	must meet, and be installed in accordance	✓	✓	~	
The applicar	nt must configure the rainwater tank	to collect rainwater runoff from at least 70 square	e metres of roof area.		~	✓	
The applicar	nt must connect the rainwater tank t	o a tap located within 10 metres of the edge of th	e pool.		✓	✓	
Outdoor sv	wimming pool			-			
The swimmi	ng pool must be outdoors.			✓	✓	✓	
The swimmi	ng pool must not have a capacity gr	reater than 36.29 kilolitres.		✓	~	✓	
The applicar	nt must install a pool pump timer for	the swimming pool.			~	✓	
The applicar	nt must not incorporate any heating	system for the swimming pool that is part of this	development.		✓	✓	
Fixtures a	nd systems			Show on DA Plans	Show on CC/CDC Plans & specs	Certifier Check	
Lighting							
	nt must ensure a minimum of 40% og-diode (LED) lamps.	of new or altered light fixtures are fitted with fluore	scent, compact fluorescent, or		✓	~	
Fixtures							
The applicar	nt must ensure new or altered show	erheads have a flow rate no greater than 9 litres p	per minute or a 3 star water rating.		✓	✓	
The applicar	nt must ensure new or altered toilets	s have a flow rate no greater than 4 litres per aver	rage flush or a minimum 3 star water rating.		✓	✓	
The applicar	nt must ensure new or altered taps	have a flow rate no greater than 9 litres per minut	e or minimum 3 star water rating.		✓		
Constructi	ion			Show on DA Plans	Show on CC/CDC Plans & specs	Certifier Check	
Insulation i	requirements			'			
the table bel		construction (floor(s), walls, and ceilings/roofs) ir tion is not required where the area of new constru where insulation already exists.		~	✓	~	
Constructio	on	Additional insulation required (R-value)	Other specifications				
concrete sla	ab on ground floor.	nil					
external wa	all: brick veneer	R1.16 (or R1.70 including construction)					
external wa metal clad)	all: framed (weatherboard, fibro,	R1.30 (or R1.70 including construction)					
flat ceiling,	pitched roof	ceiling: R0.95 (up), roof: foil backed blanket (75 mm)	medium (solar absorptance 0.475 - 0.70)				
flat ceiling,	flat roof: framed	ceiling: R1.08 (up), roof: foil backed blanket (75 mm)	medium (solar absorptance 0.475 - 0.70)				

ACTION PLANS	
m: 0426 957 518 e:operations@actionplans.com.au w: www.actionplans.com.au	

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,	А	10/11/2021	DA - PRELIMINARY ISSUE	DLR
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DRWN NOTES

NOTES

This drawing is the copyright of Action Plans and not be altered, reproduced or transmitted in any form or by any means in part or in whole with the written permission of Action Plans. Do not scale measure from drawings. Figured dimensions are to be used only.

The Builder/contractor/owner is to ensure that the approved boundary setbacks and approved levels are confirmed and set out by a registered Surveyor prior to construction, the boundary setbacks take precedence over all other dimensions.

The Builder/Contractor shall check and verify ALL dimensions on site prior to commencement of any work, creation of shop drawings, or fabrication of components. All errors and omissions are to be verified by the Builder/Contractor/client and referred to the designer prior to the commencement of works. All window & door dimensions, orientation, glazing materials, opening types, frame types are to be confirmed by a suitably qualified person prior to the ordering of any such materials are to take place. U value takes precedence over glazing type/colour in all cases. all new glazing must meet the BASIX specified frame and glass type, OR meet the ecified U value and SHGC value.

must be calculated in accordance with National Fenestration Rating Council (NFRC) conditions. The description is provided for information	Glazing requii	rements							Show on DA Plans	Show on CC/CDC Plans & specs	Certifier Check
Reflexent overshandwing specifications must be satisfied for each vindow and glazaed door. Each vindow or glazaed door with standard aluminium or tember ferance and single clear or toned glass may either match the description, or have a U-value and a Solar Heat Gain Coefficient (SHCI) or genetic than that listed in the table below. Total system U-values and SHCIs amust be calculated in accordance with National Forestation Rating, Council (NFRC) conditions. A solar heat Gain Coefficient (SHCI) or genetic than that listed in the table below. Total system U-values and SHCIs and the solar process of the solar pro											
Each window or glacued door with Landard aluminium, or tembor farmers and unique face or to rood glacs may office match the description, or was a U-value and a Solar Head Can Coefficient (SHCI) or greater than that listed in the slabe below. Total system U-values and SHCIS must be calculated in accordance with National Ferentiation Refining Council (NFRC) conditions. A consideration of the state of the Coefficient (SHCI) to greater than that listed in the slabe below. Total system U-values and SHCIS must be calculated in accordance with National Ferentiations (Stering Council (NFRC) conditions. The receiption is provided to information and accordance with National Ferentiations (Stering Council (NFRC) conditions. The receiption is provided to information and accordance with National Ferentiations (Stering Council (NFRC) conditions. The receiption is provided to information in the stering Council (NFRC) conditions. The receiption is provided to information in the stering Council (NFRC) conditions. The receiption is provided to information in the stering Council (NFRC) conditions. The receiption is provided to information in the stering Council (NFRC) conditions. The receiption is provided to information in the stering Council (NFRC) conditions. The receiption is provided to information in the stering Council (NFRC) conditions. The receiption of the stering Council (NFRC) conditions. The receiption c								the specifications listed in the table below.	✓	~	~
have a U-value and a Solar Heat Gain Coefficient (SHGC) no greater than that listed in the table fellow. Total system U-values and SHGCs with the control of	The following red	quirements	must also	be satisfie	ed in relation	to each window and gla	azed door:			✓	~
have a Unable and a Solar Fleat Cain Coefficient (SHGC) no greater than that fised in the table below. Total system U-values and SHGCs must be calculated an accordance with National Fehrestration Rating Council (SHCC) conditions. The description is provided for information only, Alternative systems with complying U-values and SHGC may be substituted. For propictions described in milliments, the leading agoing deart earny, perglas, verandah, balloony or awning must be no more than 500 mm above the sill. For propictions described in milliments, the leading agoing deart earny begrade and the sill of the window or glazed door above which they are situated, unless the pergola also shades a perpendicular window. The spaning between batterial must have a barding coefficient of less than 0.35. Frame and glazed doors of a very dearn of glazed door above which they are situated, unless the pergola also shades a perpendicular window. The spaning between batterial must have a barding certificient of less than 0.35. Windows and glazed doors of a very dearn of glazed door above which they are situated, unless the pergola also shades a perpendicular window. The spaning between batterial must have a barding certificient of less than 0.35. Frame and glazed doors of a very dearn of glazed door above which they are situated, unless the pergola also shades a perpendicular window. The spaning between batterial must have a barding certificient of less than 0.35. Frame and glazed doors of a very dearn of glazed door above which they are situated, unless the pergola also shades a perpendicular window. The spaning certificial must have a shade and performance of glazed door above which they are situated and unless the pergola also shades a permeasing certificated and unless the pergola dearn of U-value. 7.63. SHGC. 0.75) The performance of glazed doors of the percentage of glazed doors and the glazed and unless the pergola dearn of U-value. 7.63. SHGC. 0.75) Story of the state of glazed doors of glazed doors and glazed doors an	have a U-value a	and a Solar	Heat Gair	n Coefficie	nt (SHGC) no	greater than that liste	ed in the table	e below. Total system U-values and SHGCs		~	~
showe the head of the vindov or glazed door and no more than 2400 mm above the sill. Pergolas with productionate roof or similar translucent material must have a shading coefficient of less than 0.35. Pergolas with fixed batterns must have batteris parallel to the vindov or glazed door above which they are situated, unless the pergola also where the discovered production of the product	Each window or glazed door with improved frames, or pyrolytic low-e glass, or clear/air gap/clear glazing, or toned/air gap/clear glazing must have a U-value and a Solar Heat Gain Coefficient (SHGC) no greater than that listed in the table below. Total system U-values and SHGCs must be calculated in accordance with National Fenestration Rating Council (NFRC) conditions. The description is provided for information only. Alternative systems with complying U-value and SHGC may be substituted.						e below. Total system U-values and SHGCs		~	✓	
Pergolas with polycarbonate roof or similar translucent material must have a shading coefficient of less than 0.35. Pergolas with fixed batters must have batters parallel to the window or glazed door above which they are situated, unless the pergola also dands appropriate without whose parallel to the window or glazed door above which they are situated, unless the pergola also dands and parallel to the window or glazed door above which they are situated, unless the pergola also dands and parallel to the window or glazed door above which they are situated, unless the pergola also dands and parallel to the window or glazed door above which they are situated, unless the pergola also dands and parallel to the window or glazed door above which they are situated, unless the pergola also dands and parallel to the window or glazed door above which they are situated, unless the pergola also dands and parallel to the window or glazed door above which they are situated, unless the pergola also dands and parallel to the window or glazed door above which they are situated, unless the pergola also dands and parallel to the window or glazed door above which they are situated unless the pergola also dands and parallel to the window of glazed door and glass type. Window / door Orental and parallel to the window of glazed door and glass type.							✓	✓	~		
shades a propendicular window. The spacing between batters must not be more than 50 mm. Windows and glazed doors glazzing requirements Window door Orientation Area of Overhation Area			•					t of less than 0.35.		~	✓
Window / door Orentation Area of Overshaudowing Shading device Frame and glass type								ch they are situated, unless the pergola also		✓	✓
								F			
D01		Orientation	glass inc. frame	Height	Distance	Shading device		Frame and glass type			
D02	D01	E	` '	0	0		la/balcony				
D03	D02	N	4.24	0	0	eave/verandah/pergol	la/balcony	standard aluminium, single clear, (or			
D04	D03	E	7.41	0	0	eave/verandah/pergol	la/balcony	standard aluminium, single clear, (or			
D05	D04	E	7.41	0	0	eave/verandah/pergol	la/balcony	standard aluminium, single clear, (or			
D06	D05	W	4.57	0	0	eave/verandah/pergol	la/balcony	standard aluminium, single clear, (or			
D07 W 3.36 0 0 eave/verandah/pergola/balcony b=900 mm	D06	W	13.68	0	0	eave/verandah/pergol	la/balcony	standard aluminium, single clear, (or			
D08 E	D07	W	3.36	0	0	eave/verandah/pergol	la/balcony	standard aluminium, single clear, (or			
D09 E 7.4 0 0 0 seave/verandah/pergola/balcony standard aluminium, single clear, (or U-value: 7.63, SHGC: 0.75) W01 N 1.62 0 0 eave/verandah/pergola/balcony standard aluminium, single clear, (or U-value: 7.63, SHGC: 0.75) W02 S 0.9 0 0 none standard aluminium, single clear, (or U-value: 7.63, SHGC: 0.75) Skylights The applicant must install the skylights in accordance with the specifications listed in the table below. The following requirements must also be satisfied in relation to each skylight: Each skylight may either match the description, or, have a U-value and a Solar Heat Gain Coefficient (SHGC) no greater than that listed in the table below. Skylights glazing requirements Show on DA Plans Skylight number Area of glazing inc. frame (m2) Skylight number Inc. frame (m2) Skylight number Inc. frame (m2) Shading device Frame and glass type Skylight number Inc. frame (m2) Show on DA Plans Inc. frame (m2) Show on DA Plans Inc. frame (m2) Skylight number Inc. frame (m2) Skylight number Inc. frame (m2) Shading timber, low-E internal/argon fill/clear external, (or U-value: 2.5, SHGC: 0.456) W02 Inc. provided the search of the sear	D08	E	7.41	0	0	eave/verandah/pergol	la/balcony	standard aluminium, single clear, (or			
W01	D09	E	7.4	0	0	eave/verandah/pergol	la/balcony	standard aluminium, single clear, (or			
W02 S 0.9 0 0 none standard aluminium, single clear, (or U-value: 7.63, SHGC: 0.75) Skylights The applicant must install the skylights in accordance with the specifications listed in the table below. The following requirements must also be satisfied in relation to each skylight: Each skylight may either match the description, or, have a U-value and a Solar Heat Gain Coefficient (SHGC) no greater than that listed in the table below. Skylights glazing requirements Show on DA Plans Show on DA Plans & Show on C/C/DDC Plans & specs Skylight number Area of glazing inc. frame (m2) Skylight number I 1.109 no shading imber, low-E internal/argon fill/clear external, (or U-value: 2.5, SHGC: 0.456) So2 1.109 no shading imber, low-E internal/argon fill/clear external, (or	W01	N	1.62	0	0	eave/verandah/pergol	la/balcony	standard aluminium, single clear, (or			
The applicant must install the skylights in accordance with the specifications listed in the table below. The following requirements must also be satisfied in relation to each skylight: Each skylight may either match the description, or, have a U-value and a Solar Heat Gain Coefficient (SHGC) no greater than that listed in the table below. Skylights glazing requirements Glazing requirements Show on DA Plans Skylight number Area of glazing inc. frame (m2) Shading device Frame and glass type (C/CDC Plans & specs) Skylight number Line Lin	W02	S	0.9	0	0	none		standard aluminium, single clear, (or			
The following requirements must also be satisfied in relation to each skylight: Each skylight may either match the description, or, have a U-value and a Solar Heat Gain Coefficient (SHGC) no greater than that listed in the table below. Skylights glazing requirements Show on DA Plans Show on DC/CDC Plans & specs Skylight number Area of glazing inc. frame (m2) Show on DA Plans inc. frame and glass type Check Plans & specs Show on DA Plans inc. frame (m2) Show on DA Plans	Skylights									1	
Each skylight may either match the description, or, have a U-value and a Solar Heat Gain Coefficient (SHGC) no greater than that listed in the table below. Skylights glazing requirements Show on DA Plans Show on CC/CDC Plans & specs Skylight number Area of glazing inc. frame (m2) Skylight number Inc. frame (m2) No shading timber, low-E internal/argon fill/clear external, (or U-value: 2.5, SHGC: 0.456) Solating requirements Show on CC/CDC CPlans & specs Certifier Check Show on CC/CDC CPlans & specs Check Internal/argon fill/clear external, (or U-value: 2.5, SHGC: 0.456) Solating requirements Show on CC/CDC CPlans & specs Certifier Check Show on CC/CDC CPlans & specs Check Chec						•	n the table b	pelow.	✓	✓	✓
Glazing requirements Show on DA Plans Skylight number Area of glazing inc. frame (m2) Skylight number Inc. frame (m2) Show on CC/CDC Plans & specs Frame and glass type timber, low-E internal/argon fill/clear external, (or U-value: 2.5, SHGC: 0.456) Solution 1.109 No shading timber, low-E internal/argon fill/clear external, (or U-value: 2.5, SHGC: 0.456)	Each skylight ma	•					at Gain Coef	ficient (SHGC) no greater than that listed in		~	<i>✓</i>
Skylight number Area of glazing inc. frame (m2) Shading device Frame and glass type Sol 1.109 no shading timber, low-E internal/argon fill/clear external, (or U-value: 2.5, SHGC: 0.456) Sol 1.109 no shading timber, low-E internal/argon fill/clear external, (or U-value: 2.5, SHGC: 0.456)		zing requ	uiremen	ts					-		
inc. frame (m2) S01 1.109 no shading timber, low-E internal/argon fill/clear external, (or U-value: 2.5, SHGC: 0.456) S02 1.109 no shading timber, low-E internal/argon fill/clear external, (or	Glazing requii	rements								CC/CDC Plans &	
S01 1.109 no shading timber, low-E internal/argon fill/clear external, (or U-value: 2.5, SHGC: 0.456) S02 1.109 no shading timber, low-E internal/argon fill/clear external, (or	Skylight number			Shading	device		Frame and	glass type			
S02 1.109 no shading timber, low-E internal/argon fill/clear external, (or	S01			no shadii	ng						
	S02	1.109		no shadii	ng		timber, low-	-E internal/argon fill/clear external, (or			
								· · · · · · · · · · · · · · · · · · ·			

Glazing require	ements			Show on DA Plans	Show on CC/CDC Plans & specs	Certifier Check
Skylight number	Area of glazing inc. frame (m2)	Shading device	Frame and glass type			
S01	1.109	no shading	timber, low-E internal/argon fill/clear external, (or U-value: 2.5, SHGC: 0.456)			
S02	1.109	no shading	timber, low-E internal/argon fill/clear external, (or U-value: 2.5, SHGC: 0.456)			

In these commitments, "applicant" means the person carrying out the development.

Commitments identified with a "
" in the "Show on DA plans" column must be shown on the plans accompanying the development application for the proposed development (if a development application is to be lodged for the proposed development).

Commitments identified with a "\scrip" in the "Show on CC/CDC plans & specs" column must be shown in the plans and specifications accompanying the application for a construction certificate / complying development certificate for the proposed development.

Commitments identified with a "
" in the "Certifier check" column must be certified by a certifying authority as having been fulfilled, before a final occupation certificate for the development may be issued.

> CLIENT JO & JEAN OLIVER

DRAWING NO. **DA19**

DRAWING NAME BASIX COMMITMENTS

PROJECT ADDRESS 19 WEST STREET, BALGOWLAH NSW

DATE Friday, 10 December 2021