

Energy@greenchoiceconsulting.com.au 1300 864 944

Energy Efficiency Report

Address:

60 Hudson Place, Clareville, NSW, 2107

Building Classification:

Class 1

Commissioned By:

Brook Lane

GC Consulting Job Number:

ER1-T1752

Client Job Number:

2130

Compliance achieved?

Yes

Date of Report:

24/07/2024



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Home Performance

Target Proposed


Heating (MJ/m^2) 40 Heating (MJ/m^2) 39.9 Cooling (MJ/m^2) 26 Cooling (MJ/m^2) 14.6 Total Energy (MJ/m^2) - Total Energy (MJ/m^2) 54.5 NatHERS Climate Zone: 56

5.8 Stars

Compliance is achieved when the following conditions are met:

- 1. The proposed heating load must be lower than the target heating load.
- 2. The proposed cooling load must be lower than the target cooling load.

ZONED ENERGY LOAD DISTRIBUTION TOTALS (MJ)

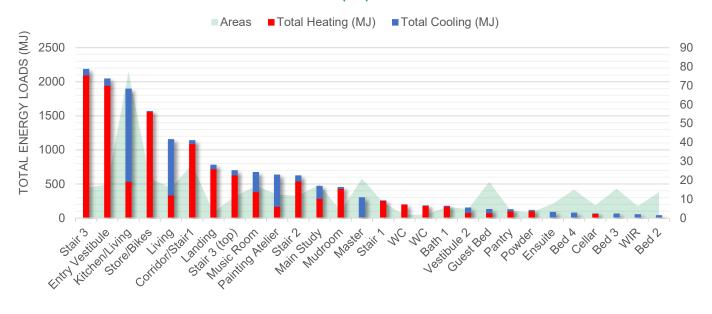

Building Specifications

External Wall Construction	Insulation	Notes
Concrete Blockwork	None	External Retaining
Reverse Brick Veneer	R2.5 Insulation	L'dry & WC in the Ground external walls; as per drawings
60 Hudson Walls	140mm concrete + 25mm Foilboard	Living; as per drawings

Internal Wall Construction	Insulation	Notes
Single Brick	None	As per drawings
Concrete Blockwork	None	As per drawings
Double Brick	None	Some of the Ground internal walls

Floor Construction Type/s	Insulation	Notes
Concrete Slab on Ground	50mm XPS Board	As per drawings
Suspended Concrete	50mm XPS Board	To all floors above outdoor areas

Floor coverings as per drawings/client notes (NatHERS Defaults modelled if not specified)

Ceiling Construction Type	Insulation	Notes	
Plasterboard	R6.0 Insulation	Throughout (excl. Garage)	
Roof Construction Type	Insulation	Notes	Colour
Metal	None	As per drawings	Medium
Green Roof Slab (100mm substrate)	None	As per drawings	Not nominated

No additional notes

Glazing Supplier Not Nominated (Software Default Codes)

Window Type	Material	U-Value	SHGC	Glass	Notes
Casement Windows	Aluminium	6.70	0.57	Single Glazed	L'dry & Mudroom
Fixed Windows	Aluminium	6.70	0.70	Single Glazed	ENS, Pantry
Double-Hung Windows	Aluminium	6.70	0.70	Single Glazed	WIR
Sliding Windows	Aluminium	6.70	0.70	Single Glazed	Bath 2
Awning Windows	Aluminium	4.50	0.50	Double Glazed	Bed 2 & Bed 3
Sliding Windows	Aluminium	4.50	0.61	Double Glazed	Bed 2 & Bed 3
Fixed Windows	Aluminium	4.50	0.61	Double Glazed	Bed 3
Sliding Doors	Aluminium	3.10	0.49	DG + Low-E	Painting Atelier, Living, Kitchen/Living/Dining
Sliding Windows	Aluminium	3.10	0.49	DG + Low-E	Living, Main Study, Master, Guest Bed, Bed 4, Music Room & Kitchen/Living/Dining
Fixed Windows	Aluminium	3.10	0.49	DG + Low-E	Master, Stair 3, Entry Vestibule, Stair 3 (top floor), Bed 4, Landing, Music Room & Kitchen/Living/Dining

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Double-Hung Windows	Aluminium	3.10	0.49	DG + Low-E	Music Room & Kitchen
Awning Windows	Aluminium	3.10	0.39	DG + Low-E	Main Study
Casement Windows	Aluminium	3.10	0.39	DG + Low-E	Corridor/Stair 1, Stair 3, Guest Bed, Landing, Stair 2, Vestibule 2 & Kitchen/Living/Dining

If the window type is default A the values apply to the following window/door types: Awning, Bi-Fold, Casement, hinged, French and Tilt'n'turn windows.

If the window type is default B the values apply to the following window/door types: Fixed, Double-Hung, Louvre, Sliding, and stacker.

A 5% tolerance is allowed to the nominated SHGC values. The U-Value must be the same or lower than the nominated values.

 $Your \ NatHERS \ Certificate \ may show \ codes \ for \ other \ suppliers. \ In \ some \ instances, \ suppliers \ do \ not \ have \ all \ their \ windows \ available \ in \ the \ database.$

Please contact us if your supplier does not meet the values noted above.



Declaration of Compliance

I certify that the details provided within this energy efficiency report are true, correct, and reflective of the plans and specifications of this dwelling. I certify that I am a specialist in the relevant discipline and compliance has been demonstrated with the requirements of the National Construction Code (NCC) as outlined in this report.

Name of assessor: Albert Burton

Qualification: CPP41212 Certificate IV in NatHERS Assessment

Accreditation number: DMN/21/2045

Signature: Albert Burton

Company Name: Green Choice Consulting Pty Ltd (ABN 63 658 893 415)

Green Choice Consulting Pty Ltd (ACN 658 893 415) holds no responsibility if the project is not constructed in accordance with the requirements of the current National Construction Code (NCC) or and/or the requirements detailed in this report. Any changes to the design elements of the building may void this assessment and require the project to be recertified to confirm compliance.

Provisions for this assessment

This assessment demonstrates compliance Part 2.6.1 & Part 2.6.2 of the NCC. Calculations have been done using FirstRate5 and the Chenath Engine (v3.13). Insulation to be installed as per NCC 3.12.1.1

Construction elements to be sealed as per NCC 3.12.3

Hot water systems must be installed as per NCC 3.12.5.

All metal roof framing must have a thermal break, consisting of a material with an R-Value of greater than or equal to 0.2, installed between the metal sheet roofing and its supporting metal purlins, metal rafters or metal battens.

All metal wall framing must have a thermal break, consisting of a material with an R-Value greater than or equal to 0.2, installed between the external cladding and the metal frame.

QLD only provisions (to apply if this project is in QLD)

This report satisfies performance requirement P2.6.1 of the BCA 2020 (Volume 2) as per Part 1 in the QLD Development Code MP4.1 "Sustainable Buildings". Artificial lighting must comply with performance requirement P2.6.2(a) of BCA 2010 (Volume 2)

Hot water must be supplied by a hot water system.

Shower roses and all tapware must have a minimum 3-star WELS rating.

Toilet cisterns must have a dual flush function, minimum 4-star WELS rating and be compatible with the size of the toilet bowl to allow for proper functioning of

WA only provisions (to apply if this project is in WA)

All tap fittings other than bath outlets and garden taps must be a minimum of 4 stars WELS rated.

All showerheads must be a minimum of 3 stars WELS rated.

All sanitary flushing systems must be a minimum of 4 stars WELS rated dual flush.

An outdoor private swimming pool or spa associated with a Class 1 building must be supplied with a cover, blanket or the like that is designed to reduce water evaporation and is accredited under the Smart Approved Watermark Scheme governed by the Australian Water Association, the Irrigation Association of Australia, the Nursery and Garden Industry Australia and the Water Services Association of Australia.

All internal heated water outlets (such as taps, showers and washing machine water supply fittings) must be connected to a heated water system or a recirculating heated water system with pipes installed and insulated in accordance with AS/NZS 3500: Plumbing and Drainage, Part 4 Heated Water Services. The pipe from the heated water system or re-circulating heated water system to the furthest heated water outlet must not be more than 20 m in length or 2 liters of internal volume.

NSW only provisions (to apply if this project is in NSW)

All requirements in this report are in accordance with the BASIX requirements.

All insulation must be installed as per NSW P2.6.1(a)

Building must be sealed as per NSW P2.6.1(b)

Domestic services must be selected and have features as per NSW P2.6.2. $\label{eq:pomestic} % \begin{center} \begin{center}$

All buildings must comply with the BCA provisions as per NSW 3.12.1.1.

The building must be sealed as per NSW Part 3.12.3.

Energy Efficiency Report



Nationwide House Energy Rating Scheme NatHERS Certificate No. BFIGQAULGO-03

Generated on 24 Jul 2024 using FirstRate5: 5.3.2b (3.21)

Property

Address 60 Hudson Parade, Clareville, NSW, 2107

Lot/DP -/

NCC Class* Class 1a

Type New Home

Plans

Main plan 2130/28.08.2023

Prepared by Bennett Murada Architects

Construction and environment

Exposure type

Conditioned* 364.4 exposed

Unconditioned* 65 NatHERS climate zone

Total 429.4 56 Mascot AMO

Garage 49.2

Assessed floor area (m2)*

Accredited assessor

Name Albert Burton

Business name Green Choice Consulting

Email Albert@greenchoiceconsulting.com.au


 Phone
 0452191324

 Accreditation No.
 DMN/21/2045

Assessor Accrediting Organisation

Design Matters National

Declaration of interestDeclaration completed: no conflicts

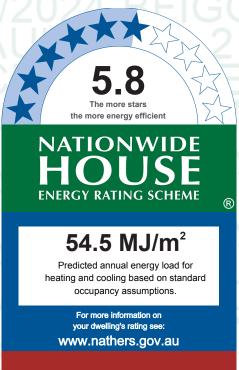

Thermal performance

Heating Cooling

39.9 14.6

MJ/m² MJ/m²

About the rating

NatHERS software models the expected thermal energy loads using information about the design and construction, climate and common patterns of household use. The software does not take into account appliances, apart from the airflow impacts from ceiling fans

Verification

To verify this certificate, scan the QR code or visit https://www.fr5.com.au /QRCodeLanding?PublicId=BFIGQAULGO-03 When using either link, ensure you are visiting www.FR5.com.au.



National Construction Code (NCC) requirements

The NCC's requirements for NatHERS-rated houses are detailed in 3.12.0(a)(i) and 3.12.5 of the NCC Volume Two. For apartments the requirements are detailed in J0.2 and J5 to J8 of the NCC Volume One.

In NCC 2019, these requirements include minimum star ratings and separate heating and cooling load limits that need to be met by buildings and apartments through the NatHERS assessment. Requirements additional to the NatHERS assessment that must also be satisfied include, but are not limited to: insulation installation methods, thermal breaks, building sealing, water heating and pumping, and artificial lighting requirements. The NCC and NatHERS Heating and Cooling Load Limits (Australian Building Codes Board Standard) are available at www.abcb.gov.au.

State and territory variations and additions to the NCC may also apply.

* Refer to glossary. Page 1 of 13



Certificate Check

Ensure the dwelling is designed and then built as per the NatHERS Certificate. While you need to check the accuracy of the whole Certificate, the following spot check covers some important items impacting the dwelling's rating.

Genuine certificate

Does this Certificate match the one available at the web address or QR code in the verification box on the front page? Does the set of NatHERS-stamped plans for the dwelling have a Certificate number on the stamp that matches this Certificate?

Ceiling penetrations*

Does the 'number' and 'type' of ceiling penetrations (e.g. downlights, exhaust fans, etc) shown on the stamped plans or installed, match what is shown in this Certificate?

Windows

Does the installed window meet the substitution tolerances (SHGC and U-value) and window type, of the window shown on this Certificate? Substituted values must be based on the Australian Fenestration Rating Council (AFRC) protocol.

Apartment entrance doors

Does the 'External Door Schedule' show apartment entrance doors? Please note that an "external door" between the modelled dwelling and a shared space, such as an enclosed corridor or foyer, should not be included in the assessment (because it overstates the possible ventilation) and would invalidate the Certificate.

Exposure*

Has the appropriate exposure level (terrain) been applied? For example, it is unlikely that a ground-floor apartment is "exposed" or a top floor high-rise apartment is "protected".

Provisional* values

Have provisional values been used in the assessment and, if so, noted in "additional notes" below?

Additional Notes

Window and glazed door type and performance

Default* windows

			Substitution tolerance ranges		
Window description	Maximum U-value*	SHGC*	SHGC lower limit	SHGC upper limit	
Al Thermally Broken B DG Air Fill High Solar Gain low-E -Clear	3.1	0.49	0.47	0.51	
Aluminium A SG Clear	6.7	0.57	0.54	0.6	
Al Thermally Broken A DG Air Fill High Solar Gain low-E -Clear	3.1	0.39	0.37	0.41	
Aluminium B SG Clear	6.7	0.7	0.66	0.74	
Aluminium A DG Argon Fill Clear-Clear	4.5	0.5	0.48	0.53	
Aluminium B DG Argon Fill Clear-Clear	4.5	0.61	0.58	0.64	
	Al Thermally Broken B DG Air Fill High Solar Gain low-E -Clear Aluminium A SG Clear Al Thermally Broken A DG Air Fill High Solar Gain low-E -Clear Aluminium B SG Clear Aluminium A DG Argon Fill Clear-Clear	Window description Al Thermally Broken B DG Air Fill High Solar Gain low-E -Clear Aluminium A SG Clear Al Thermally Broken A DG Air Fill High Solar Gain low-E -Clear Aluminium B SG Clear Aluminium B SG Clear Aluminium A DG Argon Fill Clear-Clear 4.5	Window descriptionU-value*SHGC*Al Thermally Broken B DG Air Fill High Solar Gain low-E -Clear3.10.49Aluminium A SG Clear6.70.57Al Thermally Broken A DG Air Fill High Solar Gain low-E -Clear3.10.39Aluminium B SG Clear6.70.7Aluminium A DG Argon Fill Clear-Clear4.50.5	Window descriptionMaximum U-value*SHGC*SHGC lower limitAl Thermally Broken B DG Air Fill High Solar Gain low-E -Clear3.10.490.47Aluminium A SG Clear6.70.570.54Al Thermally Broken A DG Air Fill High Solar Gain low-E -Clear3.10.390.37Aluminium B SG Clear6.70.70.66Aluminium A DG Argon Fill Clear-Clear4.50.50.48	

Custom* windows

				Substitution tolerance ranges		
Window ID	Window description	Maximum U-value*	SHGC*	SHGC lower limit	SHGC upper limit	
No Data Availa	phlo					

Window and glazed door Schedule

* Refer to glossary. Page 2 of 13



			Height	Width				Window shading
Location	Window ID	Window no.	(mm)	(mm)	Window type	Opening %	Orientation	device*
Painting Atelier	ATB-004-03 B	wlg2 DOOR	2400	3000	sliding	45.0	N	No
Painting Atelier	ATB-004-03 B	wlg1 DOOR	2400	2400	sliding	45.0	W	No
Laundry	ALM-001-01 A	wlg6	2400	1620	other	90.0	N	No
Living	ATB-004-03 B	wlg5	2400	2400	sliding	45.0	Е	No
Living	ATB-004-03 B	wlg4	2400	3000	sliding	45.0	N	No
Living	ATB-004-03 B	wlg3 DOOR	2400	5200	sliding	60.0	W	No
Main Study	ATB-004-03 B	Opening 60	2100	3600	sliding	45.0	N	No
Main Study	ATB-003-03 B	w1.1	2100	2800	awning	45.0	W	No
Ensuite	ALM-002-01 A	Opening 61	2100	800	fixed	0.0	N	No
Master	ATB-004-03 B	w1.5	2530	740	fixed	0.0	E	No
Master	ATB-004-03 B	w1.4	2100	3600	fixed	0.0	N	No
Master	ATB-004-03 B	w1.3	2100	5600	sliding	30.0	W	No
WIR	ALM-002-01 A	w1.6	1500	900	double_hung	45.0	NNE	No
Bed 2	ALM-005-01 A	w1.8a	1500	900	awning	90.0	N	No
Bed 2	ALM-006-01 A	w1.7	1500	3197	sliding	30.0	N	No
Bed 3	ALM-005-01 A	w1.10	1500	1416	awning	0.0	Е	No
Bed 3	ALM-006-01 A	w1.9 fixed	1500	1000	fixed	0.0	N	No
Bed 3	ALM-006-01 A	w1.9	1500	2800	sliding	30.0	N	No
Bed 3	ALM-005-01 A	w1.8b	1500	900	awning	90.0	N	No
Stair 3	ATB-004-03 B	w3.2	2530	1540	fixed	0.0	WNW	No
Stair 3	ATB-003-03 B	w3.6	2530	1082	casement	90.0	WNW	No
Corridor/Stair1	ATB-003-03 B	Opening 122	1400	690	casement	90.0	W	No
Corridor/Stair1	ATB-003-03 B	Opening 120	1400	790	casement	90.0	S	No
Corridor/Stair1	ATB-003-03 B	Opening 121	1400	790	casement	90.0	S	No
Corridor/Stair1	ATB-003-03 B	Opening 123	1400	780	casement	90.0	S	No
Corridor/Stair1	ATB-003-03 B	Opening 124	1400	780	casement	90.0	S	No
Kitchen/Living	ATB-004-03 B	w2.2	1800	3900	fixed	0.0	W	No
Kitchen/Living	ATB-004-03 B	w2.1	1800	1100	fixed	0.0	S	No
Kitchen/Living	ATB-003-03 B	w2.18	1800	670	casement	10.0	WNW	No
Kitchen/Living	ATB-003-03 B	w2.15	1800	785	casement	10.0	S	No
Kitchen/Living	ATB-003-03 B	Opening 129	1800	764	casement	10.0	S	No
Kitchen/Living	ATB-004-03 B	w2.10	1200	800	fixed	0.0	E	No
Kitchen/Living	ATB-004-03 B	w2.8	1200	4200	sliding	30.0	N	No
Kitchen/Living	ATB-004-03 B	w2.7	1200	800	fixed	0.0	W	No
Kitchen/Living	ATB-004-03 B	w2.6	1200	385	double_hung	45.0	W	No
Kitchen/Living	ATB-004-03 B	w2.4 slid door	2300	4800	sliding	30.0	N	No
Kitchen/Living	ATB-004-03 B	w2.5	1200	500	fixed	0.0	N	No
Kitchen/Living	ATB-004-03 B	w2.3	1800	4800	sliding	30.0	N	No
Pantry	ALM-002-01 A	w2.11	1400	400	fixed	0.0	N	No

BFIGQAULGO-03	NatHERS	Certificate

5.8 Star Rating as of 24 Jul 2024



Music Room ATB-004-03 B w2.13 1700 1934 double_hung 22.0 E No Music Room ATB-004-03 B w2.12b 1200 2788 sliding 30.0 N No Music Room ATB-004-03 B w2.12c 1200 1100 fixed 0.0 N No Music Room ATB-004-03 B Opening 110 1800 550 fixed 0.0 N No Music Room ATB-004-03 B w2.9 1200 800 fixed 0.0 W No Vestibule 2 ATB-003-03 B w2.17 1800 785 casement 10.0 S No Stair 2 ATB-003-03 B w2.16 1800 785 casement 10.0 S No Bed 4 ATB-004-03 B w4.5 DOOR 2700 2500 sliding 45.0 N No Bed 4 ATB-004-03 B w4.4 1600 1100 fixed 0.0 N No Entry Vestibule ATB-004-03 B Opening 130 2700 1100									
Music Room ATB-004-03 B w2.12c 1200 1100 fixed 0.0 N No Music Room ATB-004-03 B Opening 110 1800 550 fixed 0.0 N No Music Room ATB-004-03 B w2.9 1200 800 fixed 0.0 W No Vestibule 2 ATB-003-03 B w2.17 1800 785 casement 10.0 S No Stair 2 ATB-003-03 B w2.16 1800 785 casement 10.0 S No Bed 4 ATB-004-03 B w4.5 DOOR 2700 2500 sliding 45.0 N No Bed 4 ATB-004-03 B w4.4 1600 1100 fixed 0.0 N No Bed 4 ATB-004-03 B w4.3 1600 1100 fixed 0.0 W No Entry Vestibule ATB-004-03 B Opening 130 2700 1100 fixed 0.0 S No Bath 2 ALM-002-01 A w4.7 1450 1400 sliding 45.0	Music Room	ATB-004-03 B	w2.13	1700	1934	double_hung	22.0	E	No
Music Room ATB-004-03 B Opening 110 1800 550 fixed 0.0 N No Music Room ATB-004-03 B w2.9 1200 800 fixed 0.0 W No Vestibule 2 ATB-003-03 B w2.17 1800 785 casement 10.0 S No Stair 2 ATB-003-03 B w2.16 1800 785 casement 10.0 S No Bed 4 ATB-004-03 B w4.5 DOOR 2700 2500 sliding 45.0 N No Bed 4 ATB-004-03 B w4.4 1600 1100 fixed 0.0 N No Bed 4 ATB-004-03 B w4.3 1600 1100 fixed 0.0 W No Entry Vestibule ATB-004-03 B Opening 130 2700 1100 fixed 0.0 S No Bath 2 ALM-002-01 A w4.7 1450 1400 sliding 45.0 NNE No	Music Room	ATB-004-03 B	w2.12b	1200	2788	sliding	30.0	N	No
Music Room ATB-004-03 B w2.9 1200 800 fixed 0.0 W No Vestibule 2 ATB-003-03 B w2.17 1800 785 casement 10.0 S No Stair 2 ATB-003-03 B w2.16 1800 785 casement 10.0 S No Bed 4 ATB-004-03 B w4.5 DOOR 2700 2500 sliding 45.0 N No Bed 4 ATB-004-03 B w4.4 1600 1100 fixed 0.0 N No Bed 4 ATB-004-03 B w4.3 1600 1100 fixed 0.0 N No Entry Vestibule ATB-004-03 B Opening 130 2700 1100 fixed 0.0 S No Bath 2 ALM-002-01 A w4.7 1450 1400 sliding 45.0 NNE No Mudroom ALM-001-01 A w4.8 1450 900 casement 90.0 N No Guest Bed ATB-004-03 B w4.10 2700 1100 casement 100.0 W No	Music Room	ATB-004-03 B	w2.12c	1200	1100	fixed	0.0	N	No
Vestibule 2 ATB-003-03 B w2.17 1800 785 casement 10.0 S No Stair 2 ATB-003-03 B w2.16 1800 785 casement 10.0 S No Bed 4 ATB-004-03 B w4.5 DOOR 2700 2500 sliding 45.0 N No Bed 4 ATB-004-03 B w4.4 1600 1100 fixed 0.0 N No Bed 4 ATB-004-03 B w4.3 1600 1100 fixed 0.0 W No Entry Vestibule ATB-004-03 B Opening 130 2700 1100 fixed 0.0 S No Bath 2 ALM-002-01 A w4.7 1450 1400 sliding 45.0 NNE No Mudroom ALM-001-01 A w4.8 1450 900 casement 90.0 N No Guest Bed ATB-004-03 B w4.6 1600 2900 sliding 10.0 N No </td <td>Music Room</td> <td>ATB-004-03 B</td> <td>Opening 110</td> <td>1800</td> <td>550</td> <td>fixed</td> <td>0.0</td> <td>N</td> <td>No</td>	Music Room	ATB-004-03 B	Opening 110	1800	550	fixed	0.0	N	No
Stair 2 ATB-003-03 B w2.16 1800 785 casement 10.0 S No Bed 4 ATB-004-03 B w4.5 DOOR 2700 2500 sliding 45.0 N No Bed 4 ATB-004-03 B w4.4 1600 1100 fixed 0.0 N No Bed 4 ATB-004-03 B w4.3 1600 1100 fixed 0.0 W No Entry Vestibule ATB-004-03 B Opening 130 2700 1100 fixed 0.0 S No Bath 2 ALM-002-01 A w4.7 1450 1400 sliding 45.0 NNE No Mudroom ALM-001-01 A w4.8 1450 900 casement 90.0 N No Guest Bed ATB-004-03 B w4.6 1600 2900 sliding 10.0 N No Landing ATB-004-03 B w2.28 1700 550 fixed 0.0 E No	Music Room	ATB-004-03 B	w2.9	1200	800	fixed	0.0	W	No
Bed 4 ATB-004-03 B w4.5 DOOR 2700 2500 sliding 45.0 N No Bed 4 ATB-004-03 B w4.4 1600 1100 fixed 0.0 N No Bed 4 ATB-004-03 B w4.3 1600 1100 fixed 0.0 W No Entry Vestibule ATB-004-03 B Opening 130 2700 1100 fixed 0.0 S No Bath 2 ALM-002-01 A w4.7 1450 1400 sliding 45.0 NNE No Mudroom ALM-001-01 A w4.8 1450 900 casement 90.0 N No Guest Bed ATB-004-03 B w4.6 1600 2900 sliding 10.0 N No Landing ATB-004-03 B w2.28 1700 550 fixed 0.0 E No Landing ATB-004-03 B w2.29 2550 920 casement 90.0 N No	Vestibule 2	ATB-003-03 B	w2.17	1800	785	casement	10.0	S	No
Bed 4 ATB-004-03 B w4.4 1600 1100 fixed 0.0 N No Bed 4 ATB-004-03 B w4.3 1600 1100 fixed 0.0 W No Entry Vestibule ATB-004-03 B Opening 130 2700 1100 fixed 0.0 S No Bath 2 ALM-002-01 A w4.7 1450 1400 sliding 45.0 NNE No Mudroom ALM-001-01 A w4.8 1450 900 casement 90.0 N No Guest Bed ATB-004-03 B w4.6 1600 2900 sliding 10.0 N No Guest Bed ATB-003-03 B w4.10 2700 1100 casement 100.0 W No Landing ATB-004-03 B w2.28 1700 550 fixed 0.0 E No Stair 3 (top) ATB-004-03 B w4.1 1500 550 fixed 0.0 W No	Stair 2	ATB-003-03 B	w2.16	1800	785	casement	10.0	S	No
Bed 4 ATB-004-03 B w4.3 1600 1100 fixed 0.0 W No Entry Vestibule ATB-004-03 B Opening 130 2700 1100 fixed 0.0 S No Bath 2 ALM-002-01 A w4.7 1450 1400 sliding 45.0 NNE No Mudroom ALM-001-01 A w4.8 1450 900 casement 90.0 N No Guest Bed ATB-004-03 B w4.6 1600 2900 sliding 10.0 N No Guest Bed ATB-003-03 B w4.10 2700 1100 casement 100.0 W No Landing ATB-004-03 B w2.28 1700 550 fixed 0.0 E No Stair 3 (top) ATB-004-03 B w4.1 1500 550 fixed 0.0 W No	Bed 4	ATB-004-03 B	w4.5 DOOR	2700	2500	sliding	45.0	N	No
Entry Vestibule ATB-004-03 B Opening 130 2700 1100 fixed 0.0 S No Bath 2 ALM-002-01 A w4.7 1450 1400 sliding 45.0 NNE No Mudroom ALM-001-01 A w4.8 1450 900 casement 90.0 N No Guest Bed ATB-004-03 B w4.6 1600 2900 sliding 10.0 N No Guest Bed ATB-003-03 B w4.10 2700 1100 casement 100.0 W No Landing ATB-004-03 B w2.28 1700 550 fixed 0.0 E No Landing ATB-003-03 B w2.29 2550 920 casement 90.0 N No Stair 3 (top) ATB-004-03 B w4.1 1500 550 fixed 0.0 W No	Bed 4	ATB-004-03 B	w4.4	1600	1100	fixed	0.0	N	No
Bath 2 ALM-002-01 A w4.7 1450 1400 sliding 45.0 NNE No Mudroom ALM-001-01 A w4.8 1450 900 casement 90.0 N No Guest Bed ATB-004-03 B w4.6 1600 2900 sliding 10.0 N No Guest Bed ATB-003-03 B w4.10 2700 1100 casement 100.0 W No Landing ATB-004-03 B w2.28 1700 550 fixed 0.0 E No Landing ATB-003-03 B w2.29 2550 920 casement 90.0 N No Stair 3 (top) ATB-004-03 B w4.1 1500 550 fixed 0.0 W No	Bed 4	ATB-004-03 B	w4.3	1600	1100	fixed	0.0	W	No
Mudroom ALM-001-01 A w4.8 1450 900 casement 90.0 N No Guest Bed ATB-004-03 B w4.6 1600 2900 sliding 10.0 N No Guest Bed ATB-003-03 B w4.10 2700 1100 casement 100.0 W No Landing ATB-004-03 B w2.28 1700 550 fixed 0.0 E No Landing ATB-003-03 B w2.29 2550 920 casement 90.0 N No Stair 3 (top) ATB-004-03 B w4.1 1500 550 fixed 0.0 W No	Entry Vestibule	ATB-004-03 B	Opening 130	2700	1100	fixed	0.0	S	No
Guest Bed ATB-004-03 B w4.6 1600 2900 sliding 10.0 N No Guest Bed ATB-003-03 B w4.10 2700 1100 casement 100.0 W No Landing ATB-004-03 B w2.28 1700 550 fixed 0.0 E No Landing ATB-003-03 B w2.29 2550 920 casement 90.0 N No Stair 3 (top) ATB-004-03 B w4.1 1500 550 fixed 0.0 W No	Bath 2	ALM-002-01 A	w4.7	1450	1400	sliding	45.0	NNE	No
Guest Bed ATB-003-03 B w4.10 2700 1100 casement 100.0 W No Landing ATB-004-03 B w2.28 1700 550 fixed 0.0 E No Landing ATB-003-03 B w2.29 2550 920 casement 90.0 N No Stair 3 (top) ATB-004-03 B w4.1 1500 550 fixed 0.0 W No	Mudroom	ALM-001-01 A	w4.8	1450	900	casement	90.0	N	No
Landing ATB-004-03 B w2.28 1700 550 fixed 0.0 E No Landing ATB-003-03 B w2.29 2550 920 casement 90.0 N No Stair 3 (top) ATB-004-03 B w4.1 1500 550 fixed 0.0 W No	Guest Bed	ATB-004-03 B	w4.6	1600	2900	sliding	10.0	N	No
Landing ATB-003-03 B w2.29 2550 920 casement 90.0 N No Stair 3 (top) ATB-004-03 B w4.1 1500 550 fixed 0.0 W No	Guest Bed	ATB-003-03 B	w4.10	2700	1100	casement	100.0	W	No
Stair 3 (top) ATB-004-03 B w4.1 1500 550 fixed 0.0 W No	Landing	ATB-004-03 B	w2.28	1700	550	fixed	0.0	E	No
	Landing	ATB-003-03 B	w2.29	2550	920	casement	90.0	N	No
Stair 3 (top) ATB-004-03 B W4.2 2700 1100 fixed 0.0 N No	Stair 3 (top)	ATB-004-03 B	w4.1	1500	550	fixed	0.0	W	No
	Stair 3 (top)	ATB-004-03 B	W4.2	2700	1100	fixed	0.0	N	No

Roof window type and performance value

Default* roof windows

				Substitution tolerance ranges		
Window ID	Window description	Maximum U-value*	SHGC*	SHGC lower limit	SHGC upper limit	
No Data Available						

No Data Available

Custom* roof windows

				Substitution to	lerance ranges
		Maximum		CLICC lower limit	CHCC upper limit
Window ID	Window description	U-value*	SHGC*	SHGC lower limit	Shoc upper limit

No Data Available

Roof window schedule

				Area		Outdoor	Indoor
Location	Window ID	Window no.	Opening %	(m²)	Orientation	shade	shade
No Data Available				•	-		

Skylight type and performance

Skylight ID **Skylight description** GEN-04-004a DC: Double Clear

Skylight schedule

		Skylight	Skylight shaft	Area Orien	- Outdoor	•	Skylight shaft
Location	Skylight ID	No.	length (mm)	(m²) ation	shade	Diffuser	reflectance



Entry Vestibule GEN-04-004a Element 1 980 1.1 N None No 0.75

External door schedule

Location	Height (mm)	Width (mm)	Opening %	Orientation	
Store/Bikes	2040	1382	100.0	N	
Garage	2530	7470	100.0	N	
Stair 3	2040	1300	100.0	E	
Entry Vestibule	2700	1300	100.0	E	
Landing	2340	1300	100.0	E	

External wall type

		Solar	Wall shad	le	Reflective
Wall ID	Wall type	absorptance	e (colour)	Bulk insulation (R-value)	wall wrap*
1	60HUD - 140mm Concrete + 25mm Foilboard	0.5	Medium	Polystyrene expanded (k = 0.039) (R0.6)	Yes
2	RBV - Reverse Brick Veneer - R2.5 Batts	0.5	Medium	Glass fibre batt: R2.5 (R2.5)	No
3	FR5 - Internal Plasterboard Stud Wall	0.5	Medium		No

External wall schedule

	Wall	Height	Width		Horizontal shading feature* maximum	Vertical shading feature
Location	ID	(mm)	(mm)	Orientation	projection (mm)	(yes/no)
Painting Atelier	1	2625	3219	S	0	No
Painting Atelier	1	2625	441	Е	0	Yes
Painting Atelier	1	2625	3219	N	472	Yes
Painting Atelier	1	2625	3889	W	387	No
Cellar	1	2625	1945	S	0	Yes
Cellar	1	2625	497	E	0	Yes
Cellar	1	2625	1046	N	471	Yes
Stair 1	1	2625	4451	S	0	Yes
Laundry	2	2625	2228	E	0	Yes
Laundry	2	2625	3439	N	966	Yes
Living	1	2625	4280	E	0	Yes
Living	1	2625	3043	N	1044	Yes
Living	1	2625	5234	W	416	Yes
WC	1	2625	1056	S	0	Yes
WC	2	2625	1747	E	0	Yes
Main Study	1	2730	3507	N	889	Yes
Main Study	1	2730	2726	W	1145	Yes
Main Study	1	2730	268	S	0	Yes
Main Study	1	2730	1569	W	1412	Yes
Main Study	1	2730	3247	S	0	Yes
Main Study	1	2730	499	Е	0	Yes

* Refer to glossary. Page 5 of 13

BFIGQAULGO-03 NatHERS Certificate	5.8 Star		HOUSE			
Main Study	1	2730	2158	S	0	Yes
Ensuite	1	2730	370	W	0	Yes
Ensuite	1	2730	1163	N	0	Yes
Master	1	2730	4506	Е	1087	Yes
Master	1	2730	3257	N	1046	Yes
Master	1	2730	5687	W	1213	Yes
Master	3	2730	244	S	0	Yes
WIR	1	2730	1680	NNE	939	Yes
Bed 2	1	2730	1069	N	851	Yes
Bed 2	1	2730	896	Е	1889	Yes
Bed 2	1	2730	3283	N	870	Yes
WC	1	600	1116	Е	0	Yes
WC	1	800	1116	E	0	No
Bed 3	1	800	411	Е	0	No
Bed 3	1	600	411	E	0	Yes
Bed 3	1	2730	3405	E	896	Yes
Bed 3	1	2730	3669	N	845	Yes
Bed 3	1	2730	889	W	1879	Yes
Bed 3	1	2730	1150	N	861	Yes
Store/Bikes	1	2730	2190	SSW	0	No
Store/Bikes	1	2730	1623	N	0	Yes
Store/Bikes	1	2730	160	Е	0	Yes
Garage	1	2730	8511	S	0	No
Garage	1	2730	5810	Е	0	No
Garage	1	2730	8449	N	1528	Yes
Stair 3	1	2730	1467	Е	0	Yes
Stair 3	1	2400	3850	N	0	Yes
Stair 3	1	2730	4780	WNW	765	Yes
Stair 3	1	2730	2755	WNW	0	Yes
Stair 3	1	2730	3173	S	0	No
Corridor/Stair1	1	2730	1141	W	0	Yes
Corridor/Stair1	1	2730	13139	S	0	No
Corridor/Stair1	1	2730	1379	Е	0	Yes
Kitchen/Living	1	2410	3701	W	1541	No
Kitchen/Living	1	2410	1299	S	1854	Yes
Kitchen/Living	1	2410	1414	W	2840	Yes
Kitchen/Living	1	2410	3244	S	441	No
Kitchen/Living	1	2410	465	E	0	Yes
Kitchen/Living	1	2410	2472	SSW	0	Yes
Kitchen/Living	1	2410	1085	WNW	0	Yes
Kitchen/Living	1	2410	6424	S	0	No

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Kitchen/Living	1	2410	1499	E	1899	Yes
Kitchen/Living	1	2410	3884	N	95	Yes
Kitchen/Living	1	2410	1405	W	11775	Yes
Kitchen/Living	1	2410	10234	N	1509	Yes
Pantry	1	2410	1422	N	1594	Yes
Music Room	1	2410	2055	E	1303	Yes
Music Room	1	2410	714	S	1746	Yes
Music Room	1	2410	2027	E	593	No
Music Room	1	2410	4390	N	80	Yes
Music Room	1	2410	1512	W	1879	Yes
Music Room	1	2410	603	N	1592	Yes
Vestibule 2	1	2410	2741	S	0	No
Stair 2	1	2410	3677	S	0	No
Bed 4	1	2700	3754	N	2473	Yes
Bed 4	1	2700	1225	W	2076	Yes
Entry Vestibule	1	2700	7180	S	0	No
Entry Vestibule	1	2700	1521	E	1750	Yes
Bath 2	1	2700	2484	E	288	Yes
Bath 2	1	2700	1777	NNE	94	Yes
Mudroom	1	2700	2157	E	952	No
Mudroom	1	2700	1687	N	458	Yes
Mudroom	1	2700	134	S	0	Yes
Mudroom	1	2700	663	SSW	2288	Yes
Guest Bed	1	2700	780	E	319	Yes
Guest Bed	1	2700	4283	N	901	Yes
Guest Bed	1	2700	1572	W	5937	Yes
Landing	1	3380	3021	E	0	Yes
Landing	1	3380	971	N	4261	Yes
Landing	1	3380	971	S	0	No
Stair 3 (top)	1	2700	4455	W	731	Yes
Stair 3 (top)	1	2700	5089	S	0	No
Stair 3 (top)	1	2700	1278	N	0	Yes

Internal wall type

Wal	II ID	Wall type	Area (m²)	Bulk insulation
1	1	B - Double Brick	23.6	
2	2	C - Concrete Blockwork 400mm	7.7	
3	3	B - Internal Single Brick	295.6	
4	4	60HUD - 140mm Concrete + 25mm Foilboard	6.5	Polystyrene expanded (k = 0.039) (R0.6)

Floor type

* Refer to glossary. Page 7 of 13

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Location	Construction		Sub-floor ventilation	Added insulation (R-value)	Covering
Painting Atelier	CSOG - CSOG: Slab on Ground with 50mm XPS Board	12.5	Enclosed	R1.5	none
Cellar	CSOG - CSOG: Slab on Ground with 50mm XPS Board	6.7	Enclosed	R1.5	Timber
Stair 1	CSOG - CSOG: Slab on Ground with 50mm XPS Board	8.2	Enclosed	R1.5	Timber
Laundry	CSOG - CSOG: Slab on Ground with 50mm XPS Board	9.3	Enclosed	R1.5	Tiles
Living	CSOG - CSOG: Slab on Ground with 50mm XPS Board	15.9	Enclosed	R1.5	Timber
WC	CSOG - CSOG: Slab on Ground with 50mm XPS Board	1.8	Enclosed	R1.5	Tiles
Main Study	SuspConc - 200mm concrete slab + 50mm XPS	1.9	Elevated	R1.5	Timber
Main Study	FR5 - 200mm concrete slab	15.9	Enclosed	R0.0	Timber
Ensuite	SuspConc - 200mm concrete slab + 50mm XPS	0.4	Elevated	R1.5	Tiles
Ensuite	FR5 - 200mm concrete slab	7.1	Enclosed	R0.0	Tiles
Master	SuspConc - 200mm concrete slab + 50mm XPS	4.2	Elevated	R1.5	Timber
Master	FR5 - 200mm concrete slab	12.8	Enclosed	R0.0	Timber
Master	FR5 - 200mm concrete slab	3.7	Enclosed	R0.0	Timber
Master	SuspConc - 200mm concrete slab + 50mm XPS	0.1	Elevated	R1.5	Timber
WIR	SuspConc - 200mm concrete slab + 50mm XPS	0.6	Elevated	R1.5	Timber
WIR	SuspConc - 200mm concrete slab + 50mm XPS	0.6	Elevated	R1.5	Timber
WIR	FR5 - 200mm concrete slab	5.1	Enclosed	R0.0	Timber
Bath 1	CSOG - CSOG: Slab on Ground with 50mm XPS Board	5.9	Enclosed	R1.5	Tiles
Bed 2	SuspConc - 200mm concrete slab + 50mm XPS	2.4	Elevated	R1.5	Timber
Bed 2	FR5 - 200mm concrete slab	5.5	Enclosed Disconnected	R0.0	Timber
Bed 2	FR5 - 200mm concrete slab	2	Enclosed	R0.0	Timber
Bed 2	FR5 - 200mm concrete slab	3.8	Enclosed	R0.0	Timber
WC	CSOG - CSOG: Slab on Ground with 50mm XPS Board	2.7	Enclosed	R1.5	Tiles
Bed 3	CSOG - CSOG: Slab on Ground with 50mm XPS Board	15.5	Enclosed	R1.5	Timber
Store/Bikes	CSOG - CSOG: Slab on Ground with 50mm XPS Board	21.1	Enclosed	R1.5	none
Garage	CSOG - CSOG: Slab on Ground with 50mm XPS Board	8.1	Enclosed	R1.5	none
Garage	CSOG - CSOG: Slab on Ground with 50mm XPS Board	2.5	Enclosed	R1.5	none
Garage	CSOG - CSOG: Slab on Ground with 50mm XPS Board	38.5	Enclosed	R1.5	none
Stair 3	CSOG - CSOG: Slab on Ground with 50mm XPS Board	16.1	Enclosed	R1.5	Timber



Corridor/Stair1	CSOG - CSOG: Slab on Ground with 50mm XPS Board	20.6	Enclosed	R1.5	Timber
Corridor/Stair1	FR5 - 200mm concrete slab	7.8	Enclosed	R0.0	Timber
Kitchen/Living	SuspConc - 200mm concrete slab + 50mm XPS	2.1	Elevated	R1.5	Timber
Kitchen/Living	SuspConc - 200mm concrete slab + 50mm XPS	7.1	Elevated	R1.5	Timber
Kitchen/Living	FR5 - 200mm concrete slab	68.2	Enclosed	R0.0	Timber
Powder	FR5 - 200mm concrete slab	3.1	Enclosed	R0.0	Tiles
Pantry	FR5 - 200mm concrete slab	4	Enclosed	R0.0	Timber
Music Room	SuspConc - 200mm concrete slab + 50mm XPS	3	Elevated	R1.5	Timber
Music Room	FR5 - 200mm concrete slab	13.9	Enclosed	R0.0	Timber
Vestibule 2	FR5 - 200mm concrete slab	4.7	Enclosed	R0.0	Timber
Stair 2	FR5 - 200mm concrete slab	11.8	Enclosed	R0.0	Timber
Bed 4	FR5 - 200mm concrete slab	15	Enclosed	R0.0	Timber
Entry Vestibule	FR5 - 200mm concrete slab	0.9	Enclosed	R0.0	Timber
Entry Vestibule	FR5 - 200mm concrete slab	16.8	Enclosed	R0.0	Timber
Bath 2	SuspConc - 200mm concrete slab + 50mm XPS	0.5	Elevated	R1.5	Tiles
Bath 2	FR5 - 200mm concrete slab	6	Enclosed	R0.0	Tiles
Mudroom	FR5 - 200mm concrete slab	3.6	Enclosed	R0.0	Timber
Guest Bed	SuspConc - 200mm concrete slab + 50mm XPS	4.7	Elevated	R1.5	Timber
Guest Bed	FR5 - 200mm concrete slab	14.4	Enclosed	R0.0	Timber
Landing	SuspConc - 200mm concrete slab + 50mm XPS	2.9	Very open	R1.5	Timber
Stair 3 (top)	FR5 - 200mm concrete slab	11.4	Enclosed	R0.0	Timber

Ceiling type

		Bulk insulation R-value (may	Reflective
Location	Construction material/type	include edge batt values)	wrap*
Painting Atelier	FR5 - 200mm concrete slab	R0.0	No
Cellar	FR5 - 200mm concrete slab	R0.0	No
Stair 1	FR5 - 200mm concrete slab	R0.0	No
Laundry	FR5 - 200mm concrete slab	R0.0	No
Living	FR5 - 200mm concrete slab	R0.0	No
WC	FR5 - 200mm concrete slab	R0.0	No
Main Study	FR5 - 200mm concrete slab	R0.0	No
Main Study	FR5 - 200mm concrete slab	R0.0	No
Ensuite	FR5 - 200mm concrete slab	R0.0	No
Ensuite	FR5 - 200mm concrete slab	R0.0	No
Master	Plasterboard	R6.0	No
Master	Plasterboard	R6.0	No
Master	FR5 - 200mm concrete slab	R0.0	No
Master	FR5 - 200mm concrete slab	R0.0	No
WIR	Plasterboard	R6.0	No
WIR	FR5 - 200mm concrete slab	R0.0	No

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Bath 1 FR5 - 200mm concrete slab R0.0 No Bed 2 FR5 - 200mm concrete slab R0.0 No Bed 2 FR5 - 200mm concrete slab R0.0 No Bed 2 FR5 - 200mm concrete slab R0.0 No Bed 2 FR5 - 200mm concrete slab R0.0 No WC FR5 - 200mm concrete slab R0.0 No Bed 3 FR5 - 200mm concrete slab R0.0 No Store/Bikes FR5 - 200mm concrete slab R0.0 No Garage FR5 - 200mm concrete slab R0.0 No Garage Plasterboard R0.0 No Garage Plasterboard R0.0 No Garage FR5 - 200mm concrete slab R0.0 No Stair 3 FR6 - 200mm concrete slab R0.0 No Stair 3 PR6 - 200mm concrete slab R0.0 No Corridor/Stair1 FR5 - 200mm concrete slab R0.0 No Kitchen/Living Plasterboard R6.0 No <td< th=""><th>WIR</th><th>FR5 - 200mm concrete slab</th><th>R0.0</th><th>No</th></td<>	WIR	FR5 - 200mm concrete slab	R0.0	No
Bed 2 FR5 - 200mm concrete slab R0.0 No Bed 2 FR5 - 200mm concrete slab R0.0 No Bed 2 FR5 - 200mm concrete slab R0.0 No WC FR5 - 200mm concrete slab R0.0 No Bed 3 FR5 - 200mm concrete slab R0.0 No Store/Bikes FR5 - 200mm concrete slab R0.0 No Garage FR5 - 200mm concrete slab R0.0 No Garage Plasterboard R0.0 No Garage Plasterboard R0.0 No Garage Plasterboard R0.0 No Stair 3 FR5 - 200mm concrete slab R0.0 No Stair 3 P185 - 200mm concrete slab R0.0 No Corridor/Stair1 FR5 - 200mm concrete slab R0.0 No Corridor/Stair1 FR5 - 200mm concrete slab R0.0 No Kitchen/Living Plasterboard R6.0 No Kitchen/Living Plasterboard R6.0 No Kitche	Bath 1	FR5 - 200mm concrete slab	R0.0	No
Bed 2 FR5 - 200mm concrete slab R0.0 No Bed 2 FR5 - 200mm concrete slab R0.0 No WC FR5 - 200mm concrete slab R0.0 No Bed 3 FR5 - 200mm concrete slab R0.0 No Store/Bikes FR5 - 200mm concrete slab R0.0 No Garage FR5 - 200mm concrete slab R0.0 No Garage Plasterboard R0.0 No Garage Plasterboard R0.0 No Garage FR5 - 200mm concrete slab R0.0 No Stair 3 FR5 - 200mm concrete slab R0.0 No Stair 3 Plasterboard R0.0 No Corridor/Stair1 FR5 - 200mm concrete slab R0.0 No Kitchen/Living Plasterboard R0.0 No Kitchen/Living Plasterboard R6.0 No Kitchen/Living Plasterboard R6.0 No Powder Plasterboard R6.0 No Music Room Plast	Bed 2	FR5 - 200mm concrete slab	R0.0	No
Bed 2 FR5 - 200mm concrete slab R0.0 No WC FR5 - 200mm concrete slab R0.0 No Bed 3 FR5 - 200mm concrete slab R0.0 No Store/Bilkes FR5 - 200mm concrete slab R0.0 No Garage FR5 - 200mm concrete slab R0.0 No Garage Plasterboard R0.0 No Garage Plasterboard R0.0 No Garage FR5 - 200mm concrete slab R0.0 No Stair 3 FR5 - 200mm concrete slab R0.0 No Stair 3 Plasterboard R0.0 No Corridor/Stair1 FR5 - 200mm concrete slab R0.0 No Corridor/Stair1 FR5 - 200mm concrete slab R0.0 No Kitchen/Living Plasterboard R6.0 No Kitchen/Living Plasterboard R6.0 No Kitchen/Living Plasterboard R6.0 No Powder Plasterboard R6.0 No Powder <t< td=""><td>Bed 2</td><td>FR5 - 200mm concrete slab</td><td>R0.0</td><td>No</td></t<>	Bed 2	FR5 - 200mm concrete slab	R0.0	No
WC FR5 - 200mm concrete slab R0.0 No Bed 3 FR5 - 200mm concrete slab R0.0 No Store/Bikes FR5 - 200mm concrete slab R0.0 No Garage FR5 - 200mm concrete slab R0.0 No Garage Plasterboard R0.0 No Garage Plasterboard R0.0 No Garage FR5 - 200mm concrete slab R0.0 No Stair 3 FR5 - 200mm concrete slab R0.0 No Stair 3 Plasterboard R0.0 No Corridor/Stair1 FR5 - 200mm concrete slab R0.0 No Corridor/Stair1 FR5 - 200mm concrete slab R0.0 No Kitchen/Living Plasterboard R6.0 No Kitchen/Living Plasterboard R6.0 No Kitchen/Living Plasterboard R6.0 No Powder Plasterboard R6.0 No Powder Plasterboard R6.0 No Music Room Plaster	Bed 2	FR5 - 200mm concrete slab	R0.0	No
Bed 3 FR5 - 200mm concrete slab R0.0 No Store/Bikes FR5 - 200mm concrete slab R0.0 No Garage FR5 - 200mm concrete slab R0.0 No Garage Plasterboard R0.0 No Garage Plasterboard R0.0 No Garage FR5 - 200mm concrete slab R0.0 No Stair 3 FR5 - 200mm concrete slab R0.0 No Stair 3 Plasterboard R0.0 No Corridor/Stair1 FR5 - 200mm concrete slab R0.0 No Corridor/Stair1 FR5 - 200mm concrete slab R0.0 No Kitchen/Living Plasterboard R6.0 No Powder Plasterboard R6.0 No Pantry Plas	Bed 2	FR5 - 200mm concrete slab	R0.0	No
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	Stair 3 (top)	Plasterboard	R6.0	No

Ceiling penetrations*

Location	Quantity	Туре	Diameter (mm)	Sealed/unsealed
Ensuite	1	Exhaust Fans	250	Sealed
Bath 1	1	Exhaust Fans	250	Sealed
WC	1	Exhaust Fans	250	Sealed

BFIGQAULGO-03 NatHERS Certificate

5.8 Star Rating as of 24 Jul 2024



Kitchen/Living	1	Exhaust Fans	250	Sealed
Powder	1	Exhaust Fans	250	Sealed
Bath 2	1	Exhaust Fans	250	Sealed

Ceiling fans

Location Quantity Diameter (mm)

No Data Available

Roof type

Construction	Added insulation (R-value)	Solar absorptance	Roof shade
Framed:Flat - Flat Framed (Metal Deck)	0.0	0.5	Medium
GreenRoofExtensive:Slab - 100mm Substrate : 200mm:200mm Slab - 100mm Substrate	0.0	0.5	Medium
Slab:Slab - Suspended Slab : 200mm: 200mm Suspended Slab	0.0	0.5	Medium
Cont:Attic-Continuous	0.0	0.5	Medium

* Refer to glossary. Page 11 of 13



Explanatory Notes

About this report

A NatHERS rating is a comprehensive, dynamic computer modelling evaluation of a home, using the floorplans, elevations and specifications to estimate an energy load. It addresses the building layout, orientation and fabric (i.e. walls, windows, floors, roofs and ceilings), but does not cover the water or energy use of appliances or energy production of solar panels.

Ratings are based on a unique climate zone where the home is located and are generated using standard assumptions, including occupancy patterns and thermostat settings. The actual energy consumption of a home may vary significantly from the predicted energy load, as the assumptions used in the rating will not match actual usage patterns. For example, the number of occupants and personal heating or cooling preferences will vary.

While the figures are an indicative guide to energy use, they can be used as a reliable guide for comparing different dwelling designs and to demonstrate that the design meets the energy efficiency requirements in the National Construction Code. Homes that are energy efficient use less energy, are warmer on cool days, cooler on hot days and cost less to run. The higher the star rating the more thermally efficient the dwelling is.

Accredited assessors

To ensure the NatHERS Certificate is of a high quality, always use an accredited or licenced assessor. NatHERS accredited assessors are members of a professional body called an Assessor Accrediting Organisation (AAO).

Australian Capital Territory (ACT) licensed assessors may only produce assessments for regulatory purposes using software for which they have a licence endorsement. Licence endorsements can be confirmed on the ACT licensing register

AAOs have specific quality assurance processes in place, and continuing professional development requirements, to maintain a high and consistent standard of assessments across the country.

Non-accredited assessors do not have this level of quality assurance or any ongoing training requirements.

Any questions or concerns about this report should be directed to the assessor in the first instance. If the assessor is unable to address these questions or concerns, the AAO specified on the front of this certificate should be contacted.

Disclaimer

The format of the NatHERS Certificate was developed by the NatHERSAdministrator. However the content of each individual certificate is entered and created by the assessor to create a NatHERS Certificate. It is the responsibility of the assessor who prepared this certificate to use NatHERS accredited software correctly and follow the NatHERS Technical Notes to produce a NatHERS Certificate.

The predicted annual energy load in this NatHERS Certificate is an estimate based on an assessment of the building by the assessor. It is not a prediction of actual energy use, but may be used to compare how other buildings are likely to perform when used in a similar way. Information presented in this report relies on a range of standard assumptions (both embedded in NatHERS accredited software and made by the assessor who prepared this report), including assumptions about occupancy, indoor air temperature and local climate.

Not all assumptions that may have been made by the assessor while using the NatHERS accredited software tool are presented in this report and further details or data files may be available from the assessor.

Glossary

Annual energy load	the predicted amount of energy required for heating and cooling, based on standard occupancy assumptions.
Assessed floor area	the floor area modelled in the software for the purpose of the NatHERS assessment. Note, this may not be consistent with the floor area in the design documents.
Ceiling penetrations	features that require a penetration to the ceiling, including downlights, vents, exhaust fans, rangehoods, chimneys and flues. Excludes fixtures attached to the ceiling with small holes through the ceiling for wiring, e.g. ceiling fans; pendant lights, and heating and cooling ducts.
Conditioned	a zone within a dwelling that is expected to require heating and cooling based on standard occupancy assumptions. In some circumstances it will include garages.
Custom windows	windows listed in NatHERS software that are available on the market in Australia and have a WERS (Window Energy Rating Scheme) rating.
Default windows	windows that are representative of a specific type of window product and whose properties have been derived by statistical methods.
Entrance door	these signify ventilation benefits in the modelling software and must not be modelled as a door when opening to a minimally ventilated corridor in a Class 2 building.
Exposure category - exposed	terrain with no obstructions e.g. flat grazing land, ocean-frontage, desert, exposed high-rise unit (usually above 10 floors).
Exposure category - open	terrain with few obstructions at a similar height e.g. grasslands with few well scattered obstructions below 10m, farmland with scattered sheds, lightly vegetated bush blocks, elevated units (e.g. above 3 floors).
Exposure category - suburban	terrain with numerous, closely spaced obstructions below 10m e.g. suburban housing, heavily vegetated bushland areas.
Exposure category - protected	terrain with numerous, closely spaced obstructions over 10 m e.g. city and industrial areas.
Horizontal shading feature	provides shading to the building in the horizontal plane, e.g. eaves, verandahs, pergolas, carports, or overhangs or balconies from upper levels.

BFIGQAULGO-03 NatHERS Certificate

5.8 Star Rating as of 24 Jul 2024



National Construction Code (NCC) Class	the NCC groups buildings by their function and use, and assigns a classification code. NatHERS software models NCC Class 1, 2 or 4 buildings and attached Class 10a buildings. Definitions can be found at www.abcb.gov.au.
Opening Percentage	the openability percentage or operable (moveable) area of doors or windows that is used in ventilation calculations.
Provisional value	an assumed value that does not represent an actual value. For example, if the wall colour is unspecified in the documentation, a provisional value of 'medium' must be modelled. Acceptable provisional values are outlined in the NatHERS Technical Note and can be found at www.nathers.gov.au
Reflective wrap (also known as foil)	can be applied to walls, roofs and ceilings. When combined with an appropriate airgap and emissivity value, it provides insulative properties.
Roof window	for NatHERS this is typically an operable window (i.e. can be opened), will have a plaster or similar light well if there is ar attic space, and generally does not have a diffuser.
Shading device	a device fixed to windows that provides shading e.g. window awnings or screens but excludes eaves.
Shading features	includes neighbouring buildings, fences, and wing walls, but excludes eaves.
Solar heat gain coefficient (SHGC)	the fraction of incident solar radiation admitted through a window, both directly transmitted as well as absorbed and subsequently released inward. SHGC is expressed as a number between 0 and 1. The lower a window's SHGC, the less solar heat it transmits.
Skylight (also known as roof lights)	for NatHERS this is typically a moulded unit with flexible reflective tubing (light well) and a diffuser at ceiling level.
U-value	the rate of heat transfer through a window. The lower the U-value, the better the insulating ability.
Unconditioned	a zone within a dwelling that is assumed to not require heating and cooling based on standard occupancy assumptions.
Vertical shading features	provides shading to the building in the vertical plane and can be parallel or perpendicular to the subject wall/window. Includes privacy screens, other walls in the building (wing walls), fences, other buildings, vegetation (protected or listed heritage trees).

SCHEDULE OF KEY AMENDMENTS: SOUTHERN ELEVATION WINDOW ARRANGEMENT & WALL SETBACK LOCATION GALLERY LOCATION AND ROOF ORIENTATION

DRIVEWAY AND ENTRY PATH CONFIGURATION. INCLUDING NEW SCREEN.

BIN STORE LOCATION

PAVILION ROOF FORM

LOWER GROUND FLOOR ARRANGEMENT & STAIR LOCATION

GENERAL DOOR & WINDOW RECONFIGURATIONS



POOL STORE AND PLANT ROOM



PAVILION GROUND FLOOR ARRANGMENT & ENTRY RECONIFIGURATION



LANDSCAPE BETWEEN GAMES ROOM & NORTHERN BOUNDARY REVERTED BACK TO APPROXIMATE EXISTING GROUND LEVEL



EXTENSION OF APPROVED TERRACE PRIVACY SCREEN & NEW BALUSTRADE



MINOR INCIDENTAL PLANNING ARRANGEMENT



CHANGES




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SECTION 4.55 (S4.55) AMENDMENTS TO DA APPROVAL DA2022/1715 SHOWN BUBBLED IN


PROJECT, AND FOR THE PURPOSE SHOWN AT "STATUS."

REVISION SCHEDULE Rev. Date Issued By Revision Notes A 26/4/24 CONSULTANT ISSUE THIS DRAWING IS PART OF A SET, AND SHOULD BE READ IN CONJUNCTION WITH ALL OTHER DOCUMENTS. VERIFY ALL DIMENSIONS ON SITE PRIOR TO COMMENCING B 1/5/24 STRUCTURAL ISSUE CONSTRUCTION OR FABRICATION. REPORT ANY DISCREPANCIES TO THE ARCHITECT FOR VERIFICATION DO NOT SCALE DRAWINGS. FIGURED DIMENSIONS TAKE PRECEDENCE OVER SCALED DIMENSIONS. THIS DRAWING AND THE DESIGNS CONTAINED HEREIN ARE PROTECTED BY COPYRIGHT. THE ARCHITECT GRANTS THE COPYRIGHT LICENCE ONLY FOR THE SPECIFIC

LEGEND / KEY

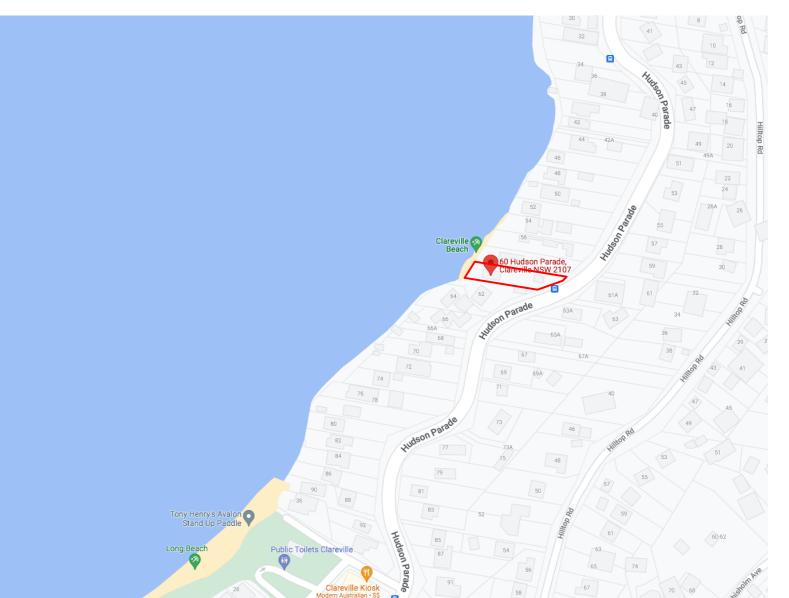

LOCATION MAP NTS

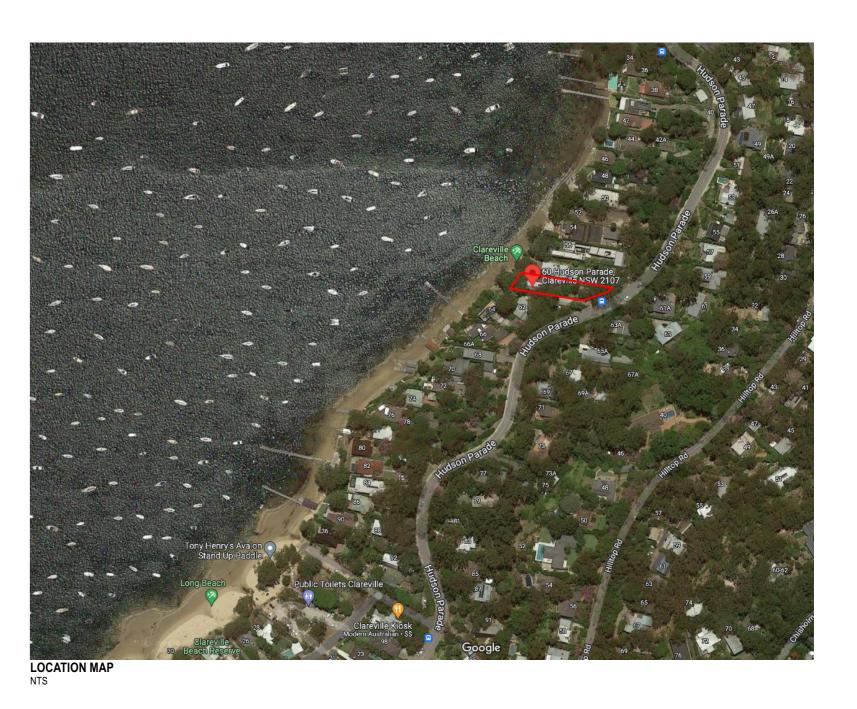

60 HUDSON PRD, AVALON BEACH, NSW 2170 ALTERATIONS & ADDITIONS TO EXISTING RESIDENCE

ARCHITECTURAL DRAWING LIST				
DWG NO.	TITLE			
DA_000	COVER SHEET			
DA_001	BASIX COMMITMENTS			
DA_002	SITE ANALYSIS PLAN			
DA_003	SITE PLAN			
DA_004	DEMOLITION PLANS _ LOWER GROUND + GROUND FLOOR			
DA_005	DEMOLITION PLANS _ LEVEL 01 + ROOF			
DA_100	PROPOSED LOWER GROUND FLOOR PLAN			
DA_101	PROPOSED GROUND FLOOR PLAN			
DA_102	PROPOSED FIRST FLOOR PLAN			
DA_103	PROPOSED ROOF PLAN			
DA_112	CUT AND FILL PLAN			
DA_200	EAST + WEST ELEVATIONS			
DA_201	NORTH + SOUTH ELEVATIONS			
DA_210	LONGITUDINAL SECTION			
DA_211	CROSS SECTIONS			
DA_301	SHADOW DIAGRAMS - SUN'S EYE VIEW			
DA_302	SHADOW DIAGRAMS - SUN'S EYE VIEW			
DA_400	CALCULATIONS - LANDSCAPE AREAS			
DA_500	SCHEDULE OF COLOURS AND MATERIALS			





Project:	
ALTS & ADS TO EXISTING HOUSE	
60 HUDSON PDE, CLAREVILLE NSW 2107	

OLIVER & NICOLA HARTLEY


Drawing Name: **COVER SHEET**

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Plot Date:
28/8/23
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Drawing No:

Job Number:

2130

Scale: Drawn By: LR Revision: Drawing No: **DA_000**

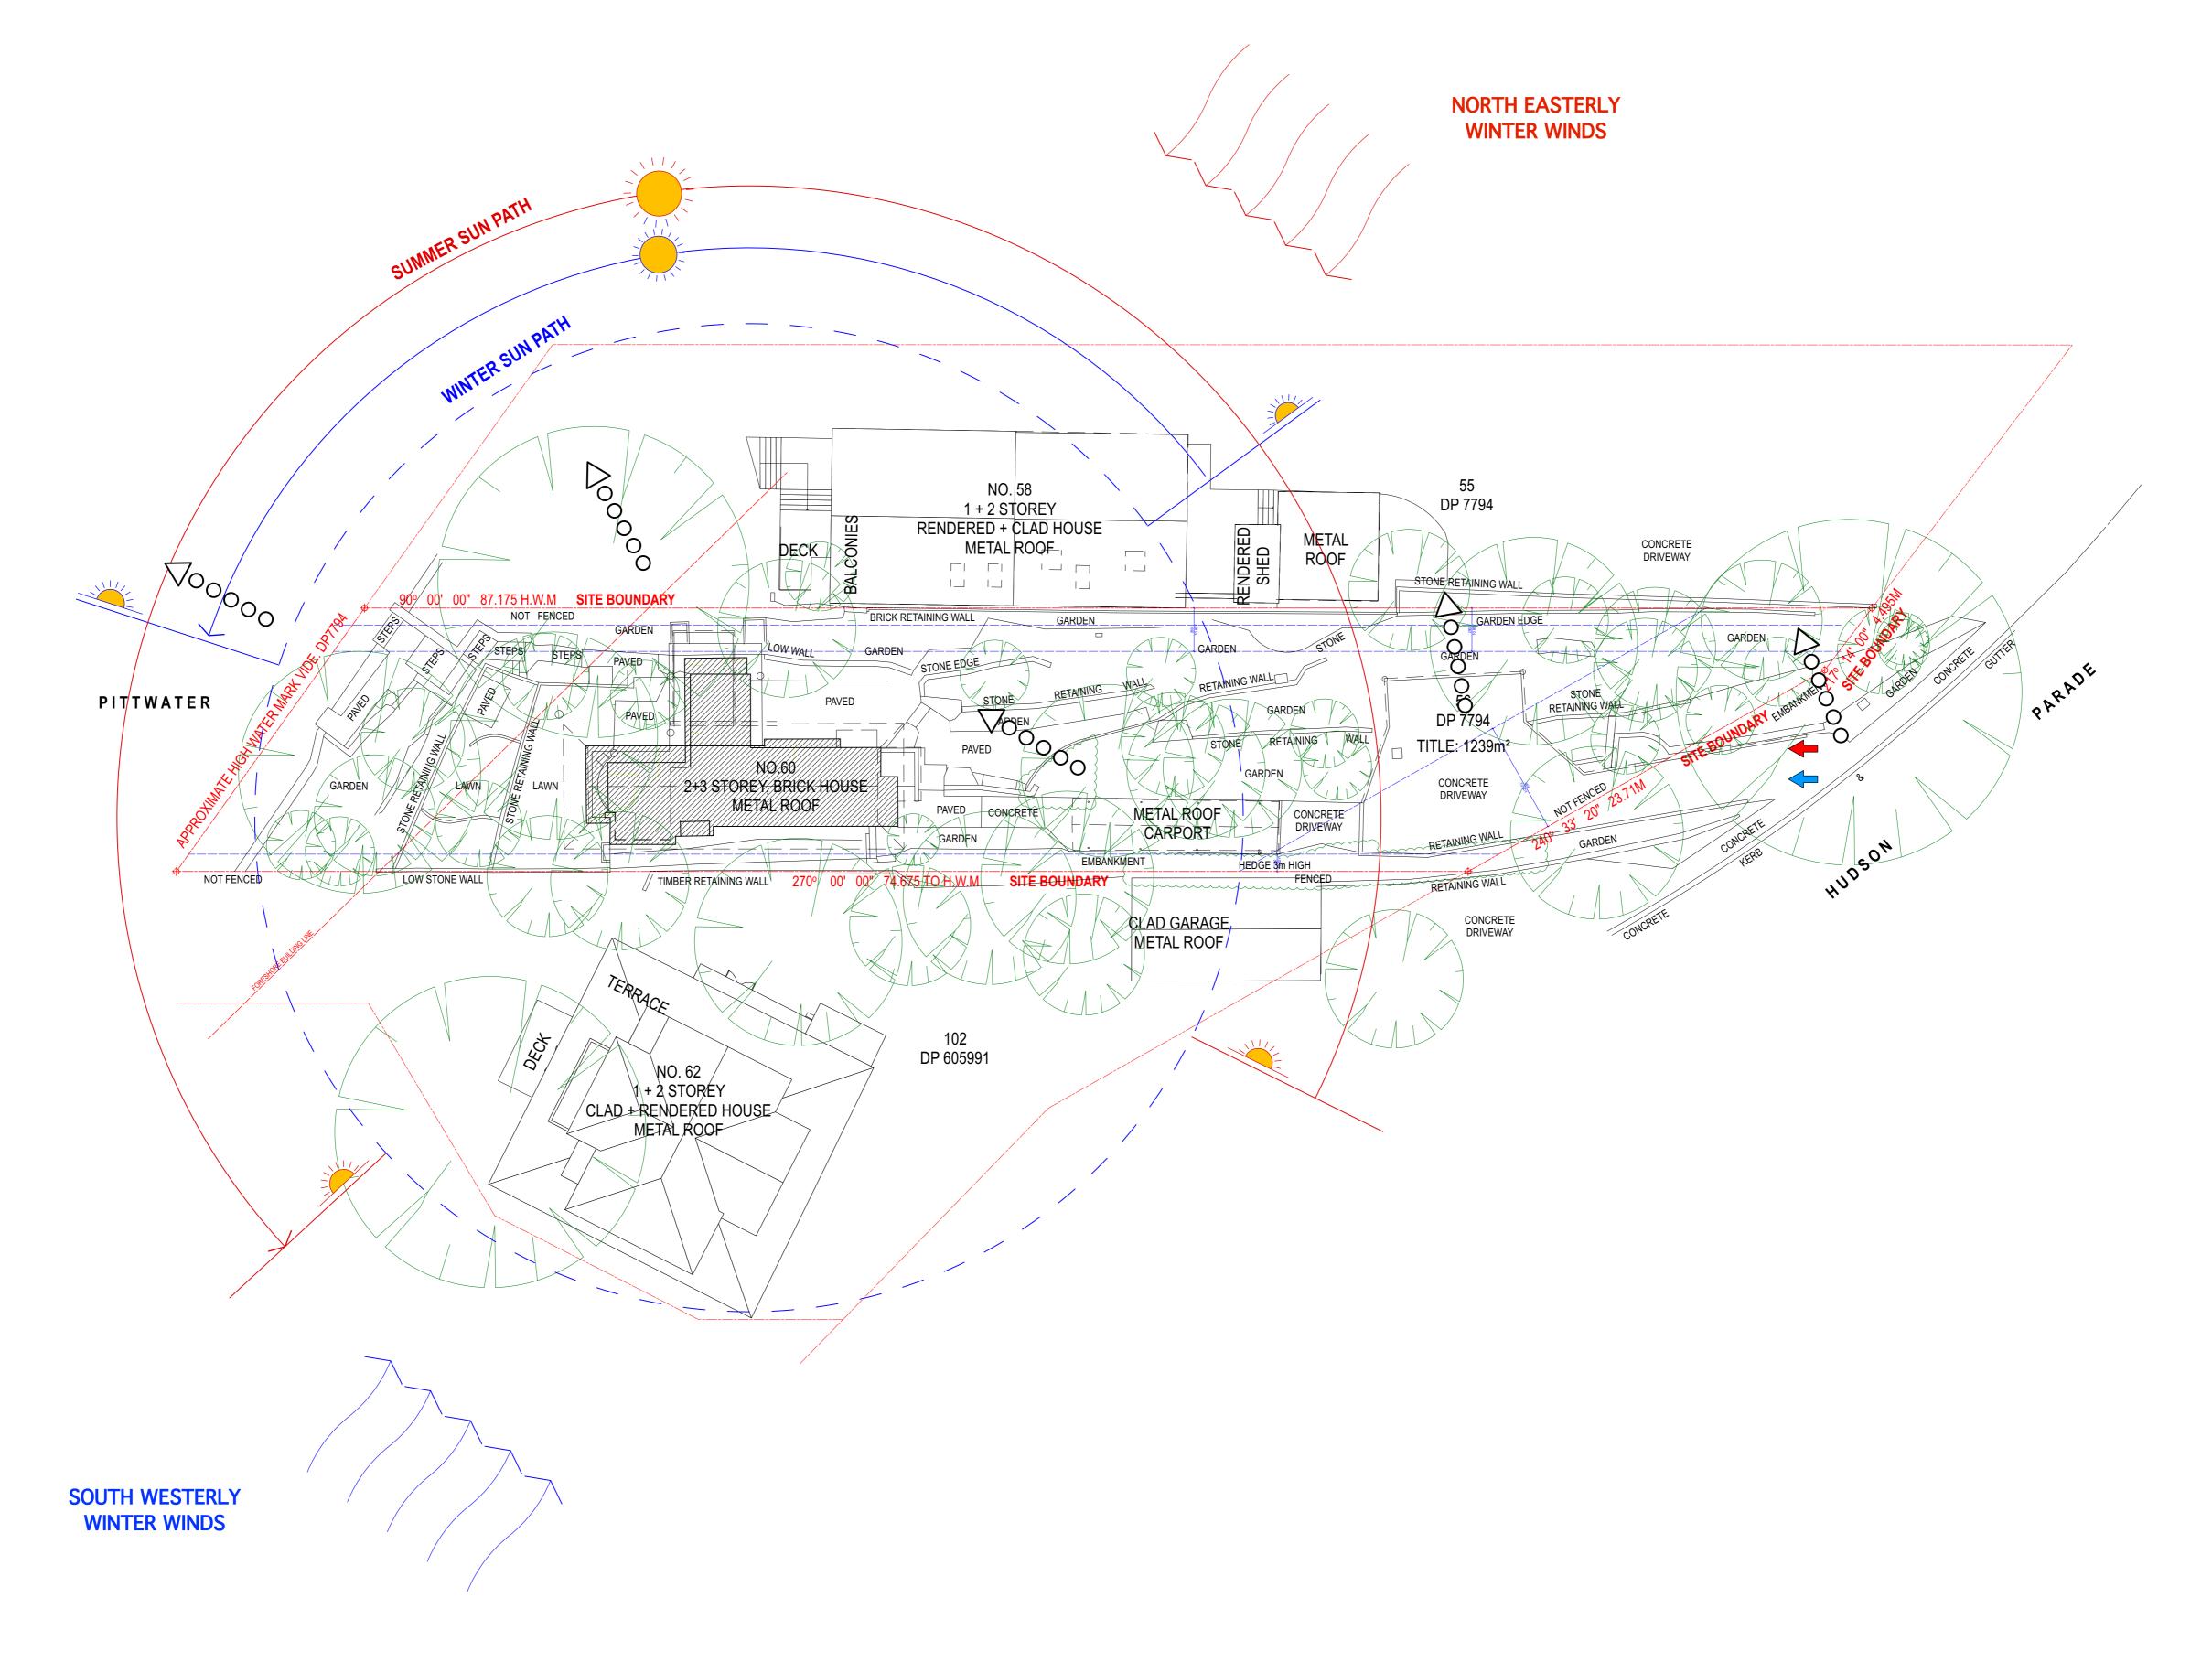



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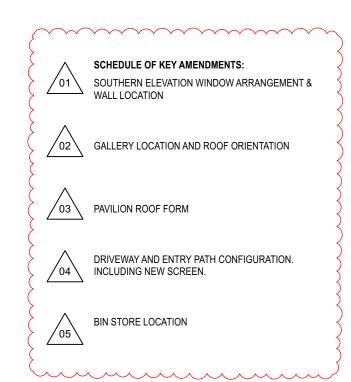
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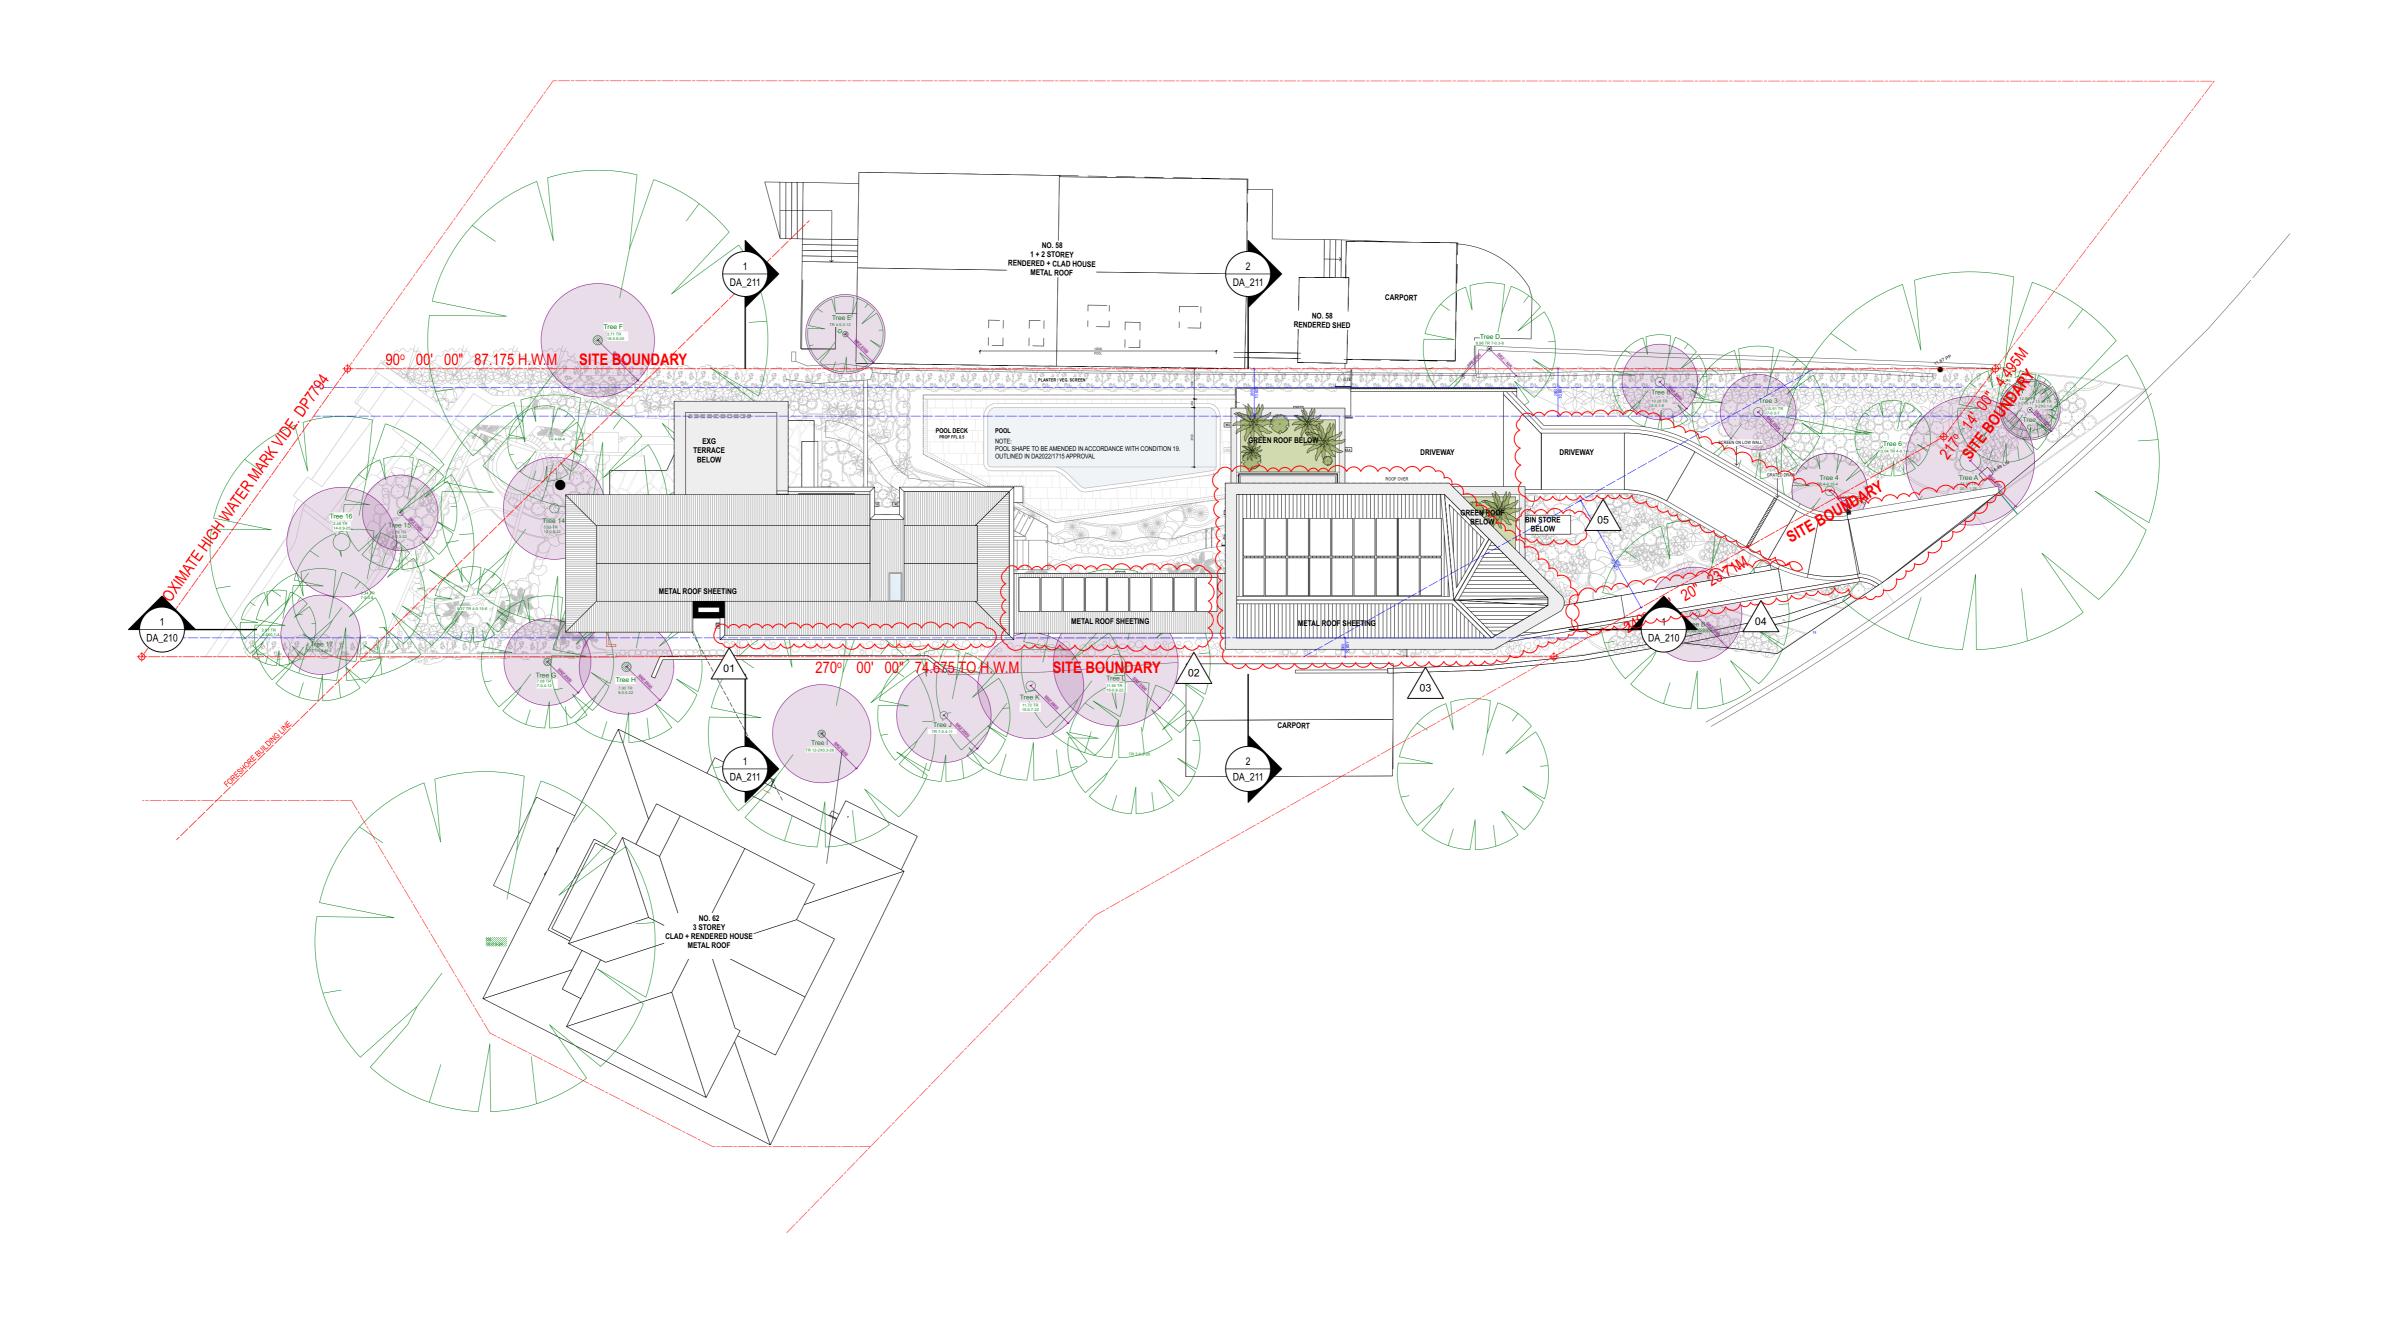
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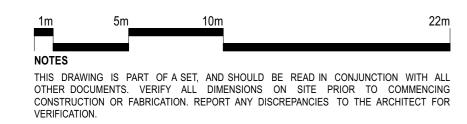
Project: ALTS & ADS TO EXISTING HOUSE 60 HUDSON PDE, CLAREVILLE NSW 2107	
Client:	
OLIVER & NICOLA HARTLEY	
Drawing Name: SITE ANALYSIS PLAN	

Job Number:	-4
2130	7
Scale:	
1:200	
Plot Date:	
28/8/23	
Drawing Status:	Drawn By:
DA	LR
Drawing No:	Revision:
DA_002	В





SECTION 4.55 (S4.55) AMENDMENTS TO DA
APPROVAL DA2022/1715 SHOWN BUBBLED IN
RED.




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PROJECT, AND FOR THE PURPOSE SHOWN AT "STATUS."	

REVIS	ION SCHEDULE			LEGEN) / KEY
Rev.	Date	Issued By	Revision Notes		DEMOLISHED
С	7/5/24	SC	CONSULTANT ISSUE		SETBACK
D	13/5/24	SC	CONSULTANT ISSUE		OL IBROR
Е	23/7/2024	SC	ISSUED FOR S4.55		DEMOLISHED TREE
			_		
				≤ 72	EXISTING TREE
				Kuny	LAIGHING INLL



	S TO EXISTING HO I PDE, CLAREVILL	
Client:		
OLIVER & I	IICOLA HARTLEY	

	QAULD
Job Number: 2130	17
Scale: 1:200	
Plot Date: 28/8/23	
Drawing Status:	Drawn By:
DA	LR
Drawing No:	Revision:
DA 003	F

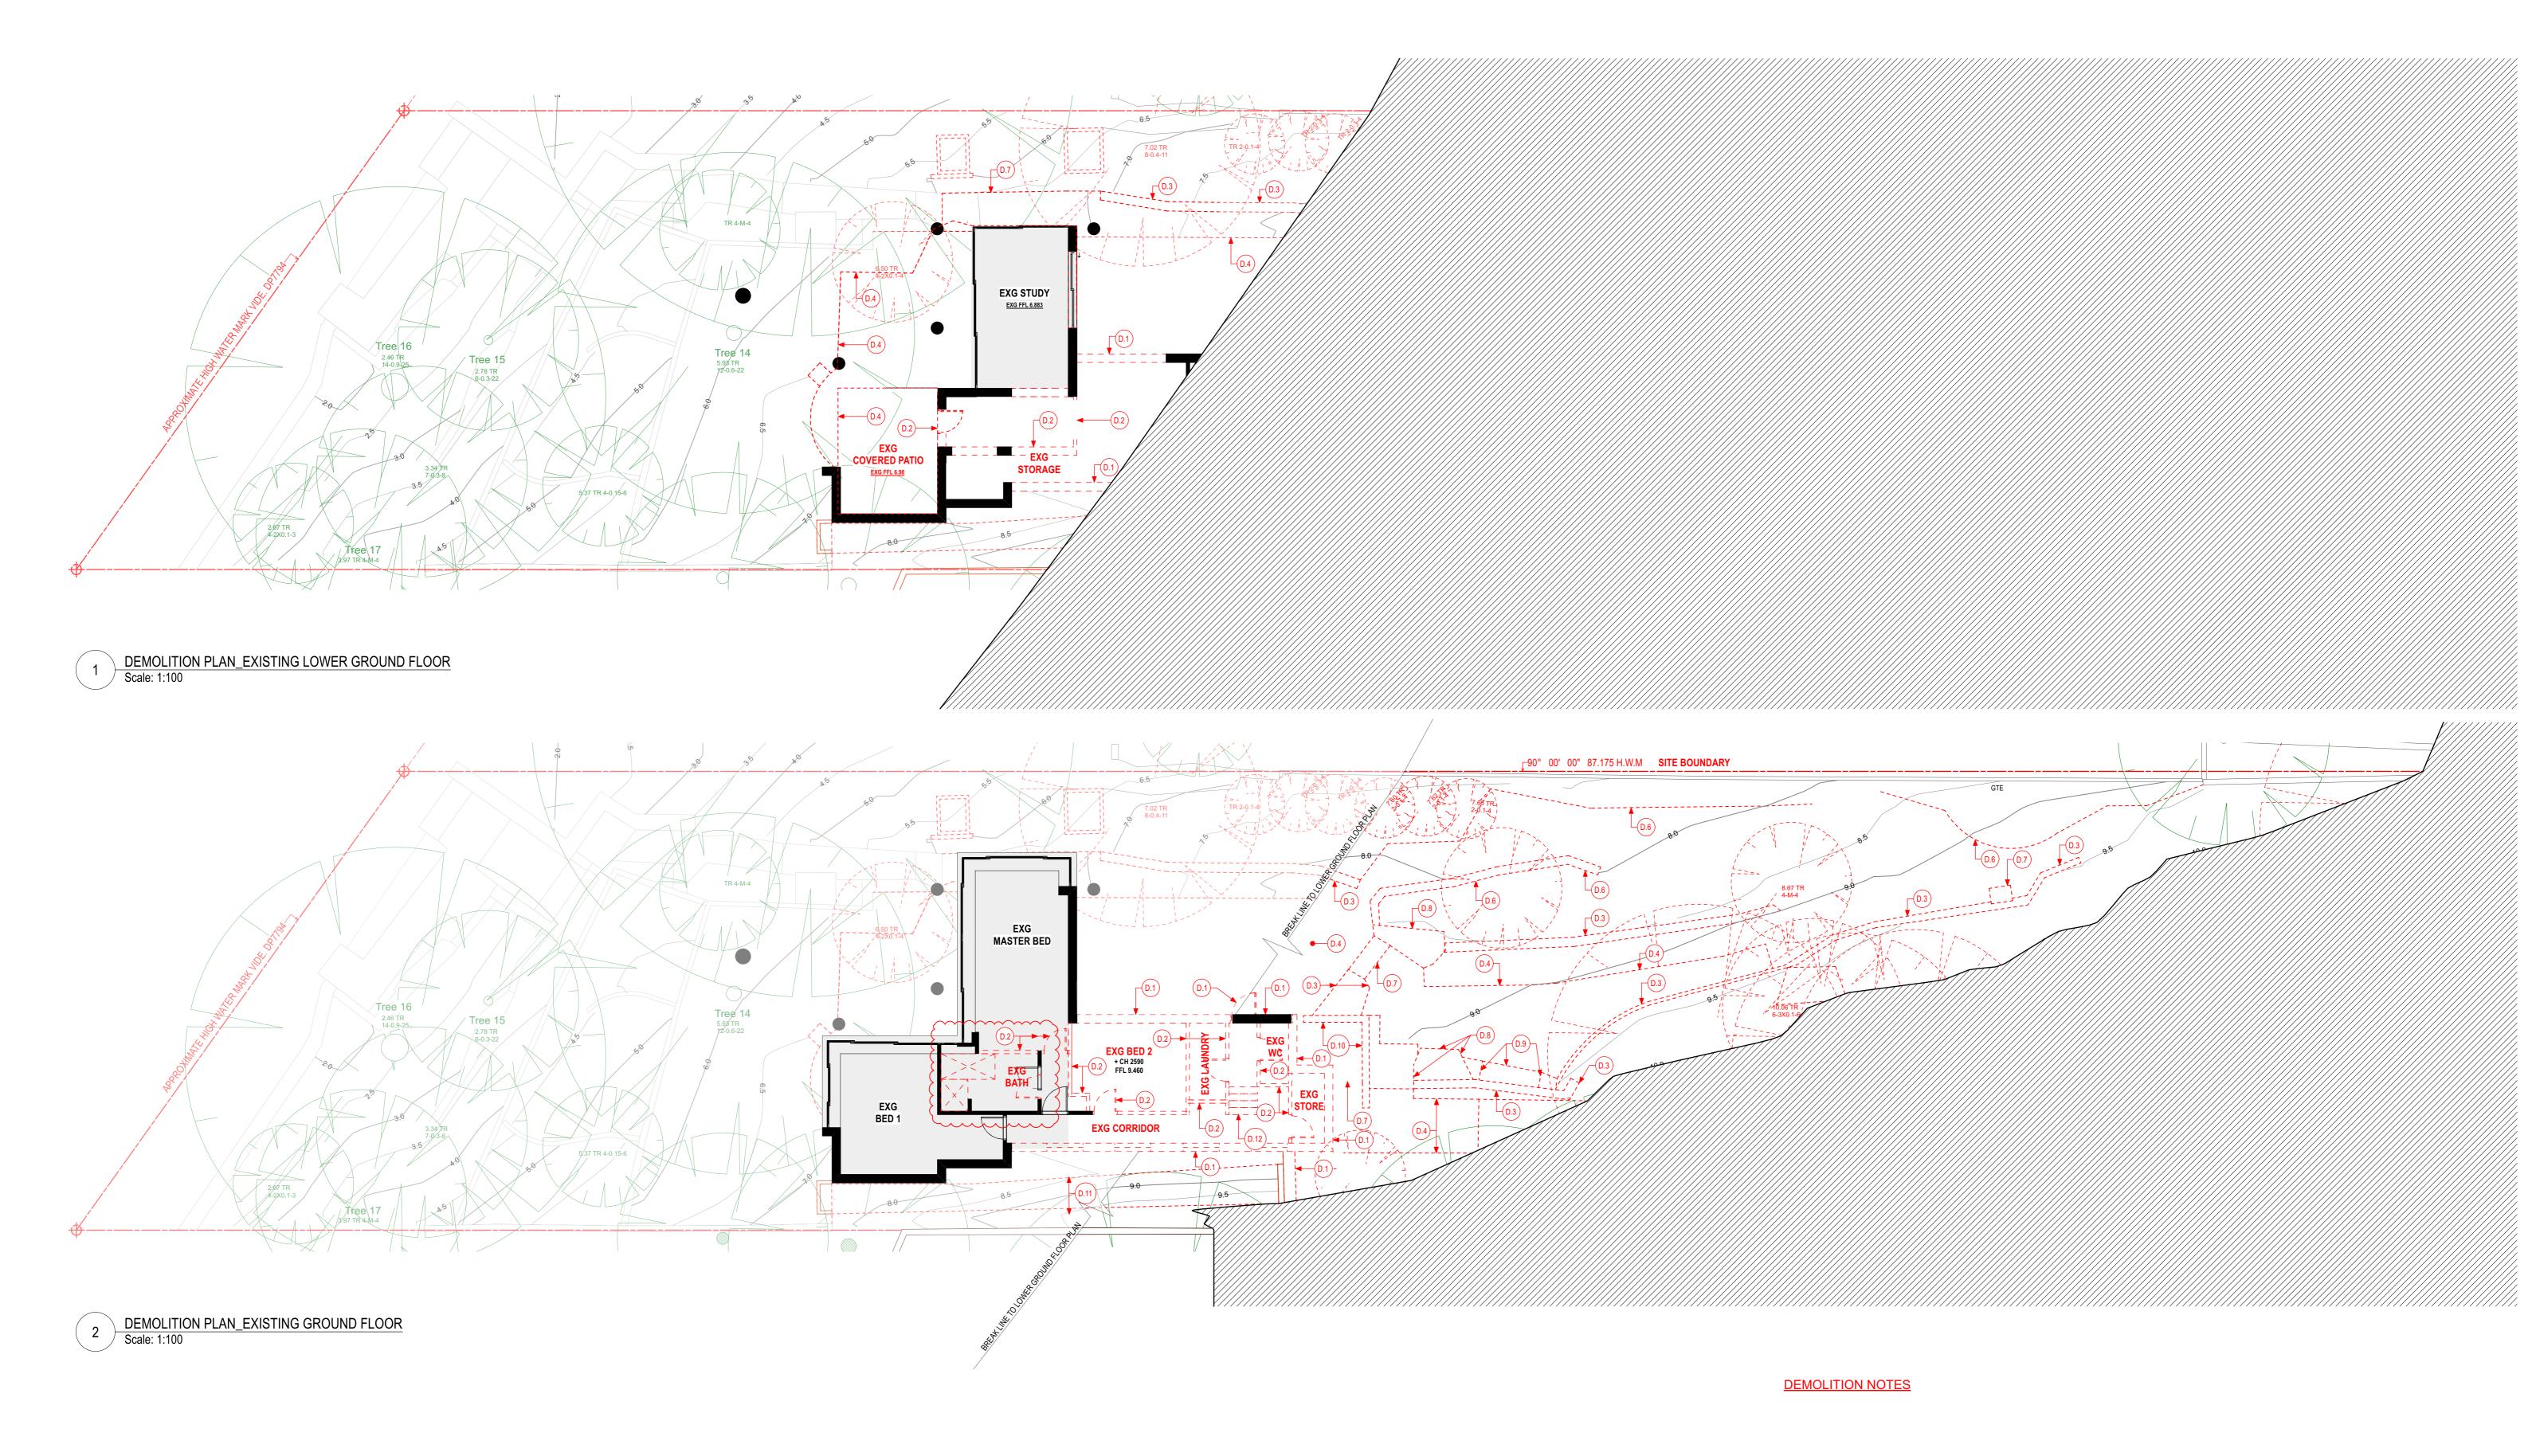

SECTION 4.55 (S4.55) AMENDMENTS TO DA
APPROVAL DA2022/1715 SHOWN BUBBLED IN RED.



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NOTES					
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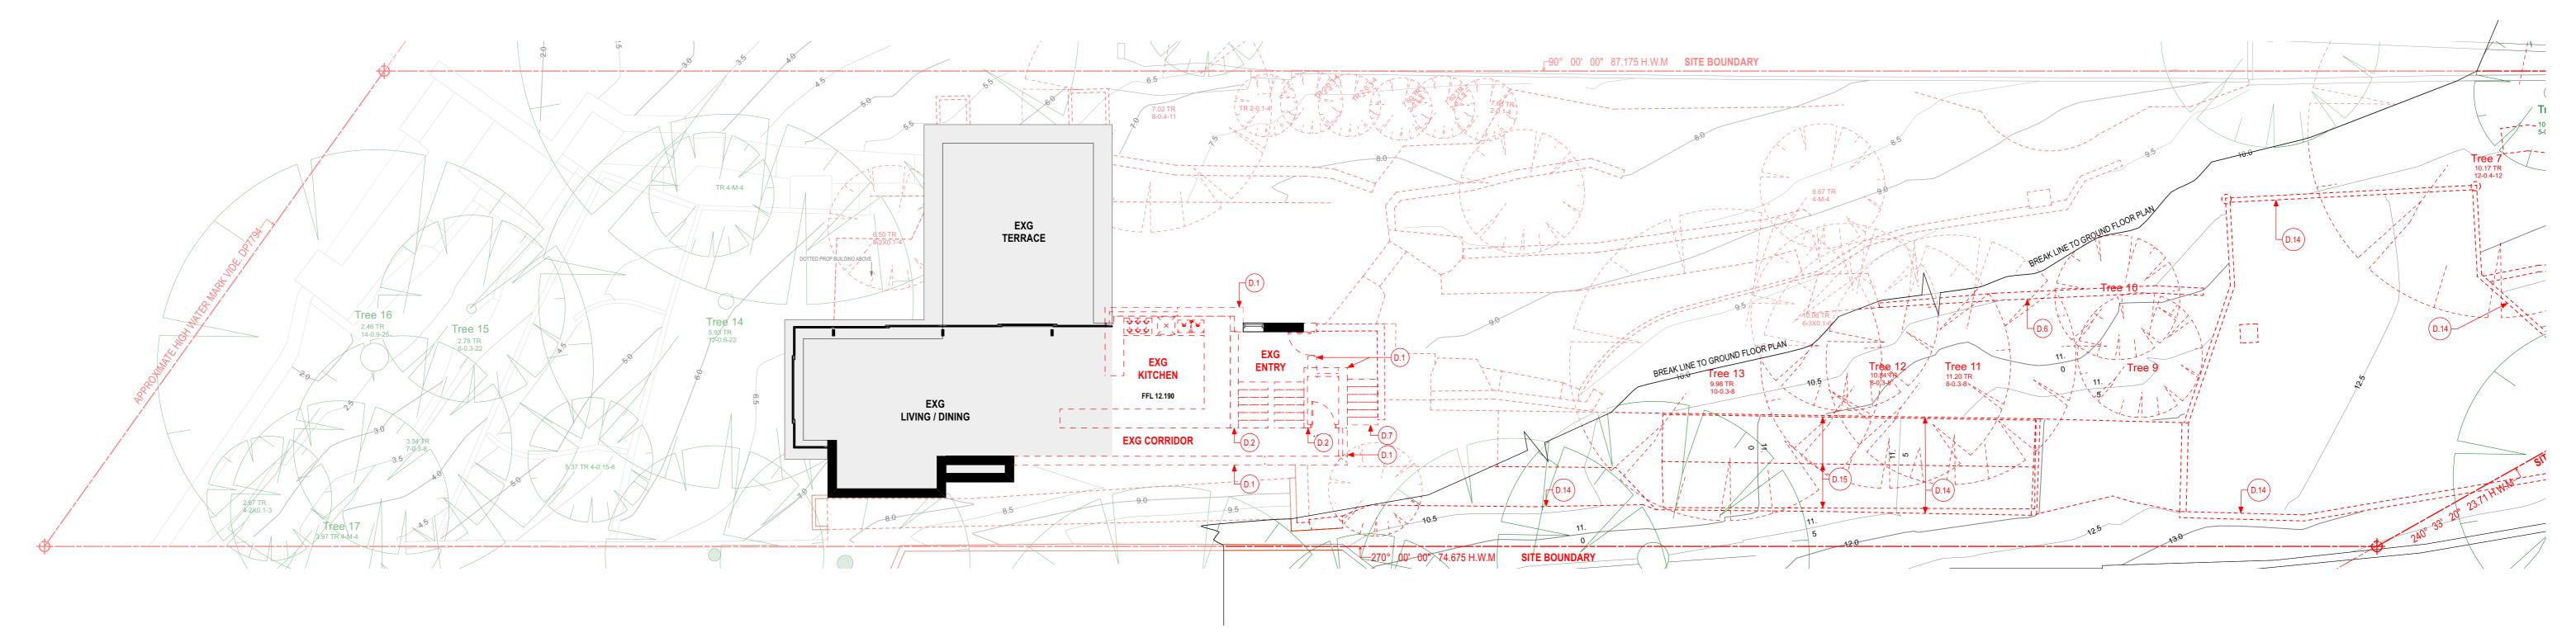
Rev.	Date	Issued By	Revision Notes	EXISTING WALL
A	26/4/24	SC	CONSULTANT ISSUE	
В	1/5/24	SC	STRUCTURAL ISSUE	DEMOLISHED WAL
С	23/7/2024	SC	ISSUED FOR S4.55	




Project: ALTS & ADS TO EXISTING HOUSE	Job Number: 2130
60 HUDSON PDE, CLAREVILLE NSW 2107 Client:	Scale: 1:100
OLIVER & NICOLA HARTLEY	Plot Date: 28/8/23

Client:	1:100
	Plot Da
OLIVER & NICOLA HARTLEY	28/8/2
	Drawin
Drawing Name:	DA
DEMOLITION PLANS - LOWER GROUND + GROUND	Drowin

2130	Z
Scale:	
1:100	
Plot Date:	
28/8/23	
Drawing Status:	Drawn By:
DA	LR
Drawing No:	Revision:
DA 004	^



1 DEMOLITION PLAN_EXISTING FIRST FLOOR
Scale: 1:100

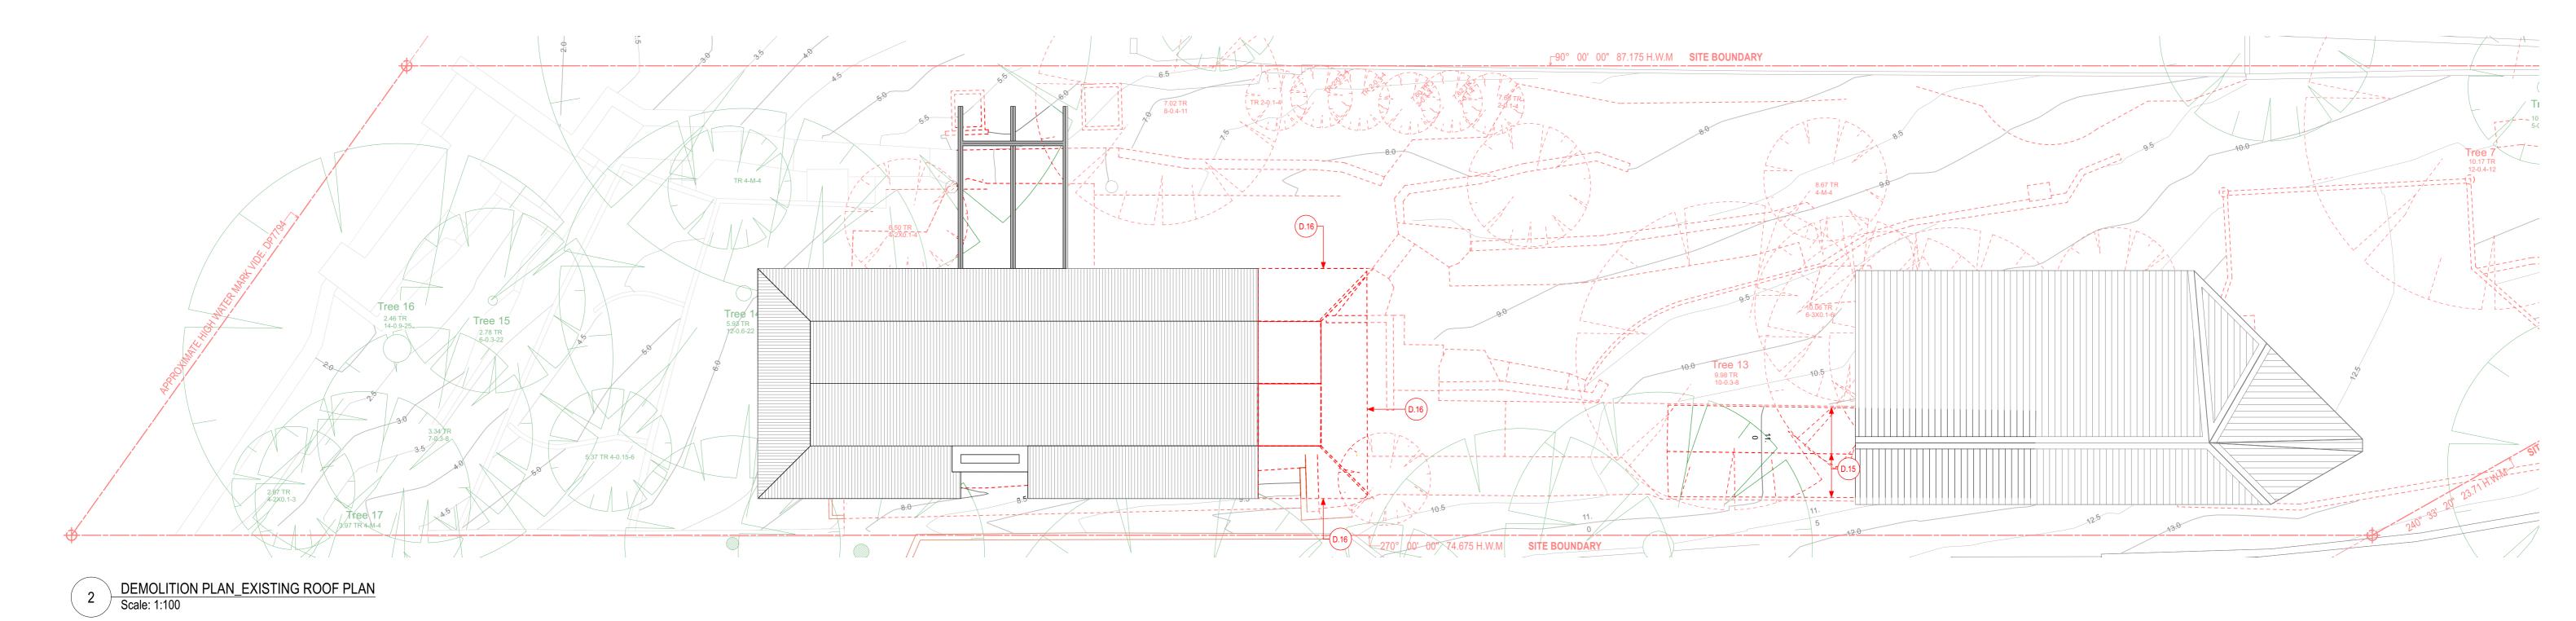

DEMOLITION NOTES

SECTION 4.55 (S4.55) AMENDMENTS TO DA APPROVAL DA2022/1715 SHOWN BUBBLED IN RED.



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DO NOT SCALE DRAWINGS. FIGURED DIMENSIONS TAKE PRECEDENCE OVER SCALED
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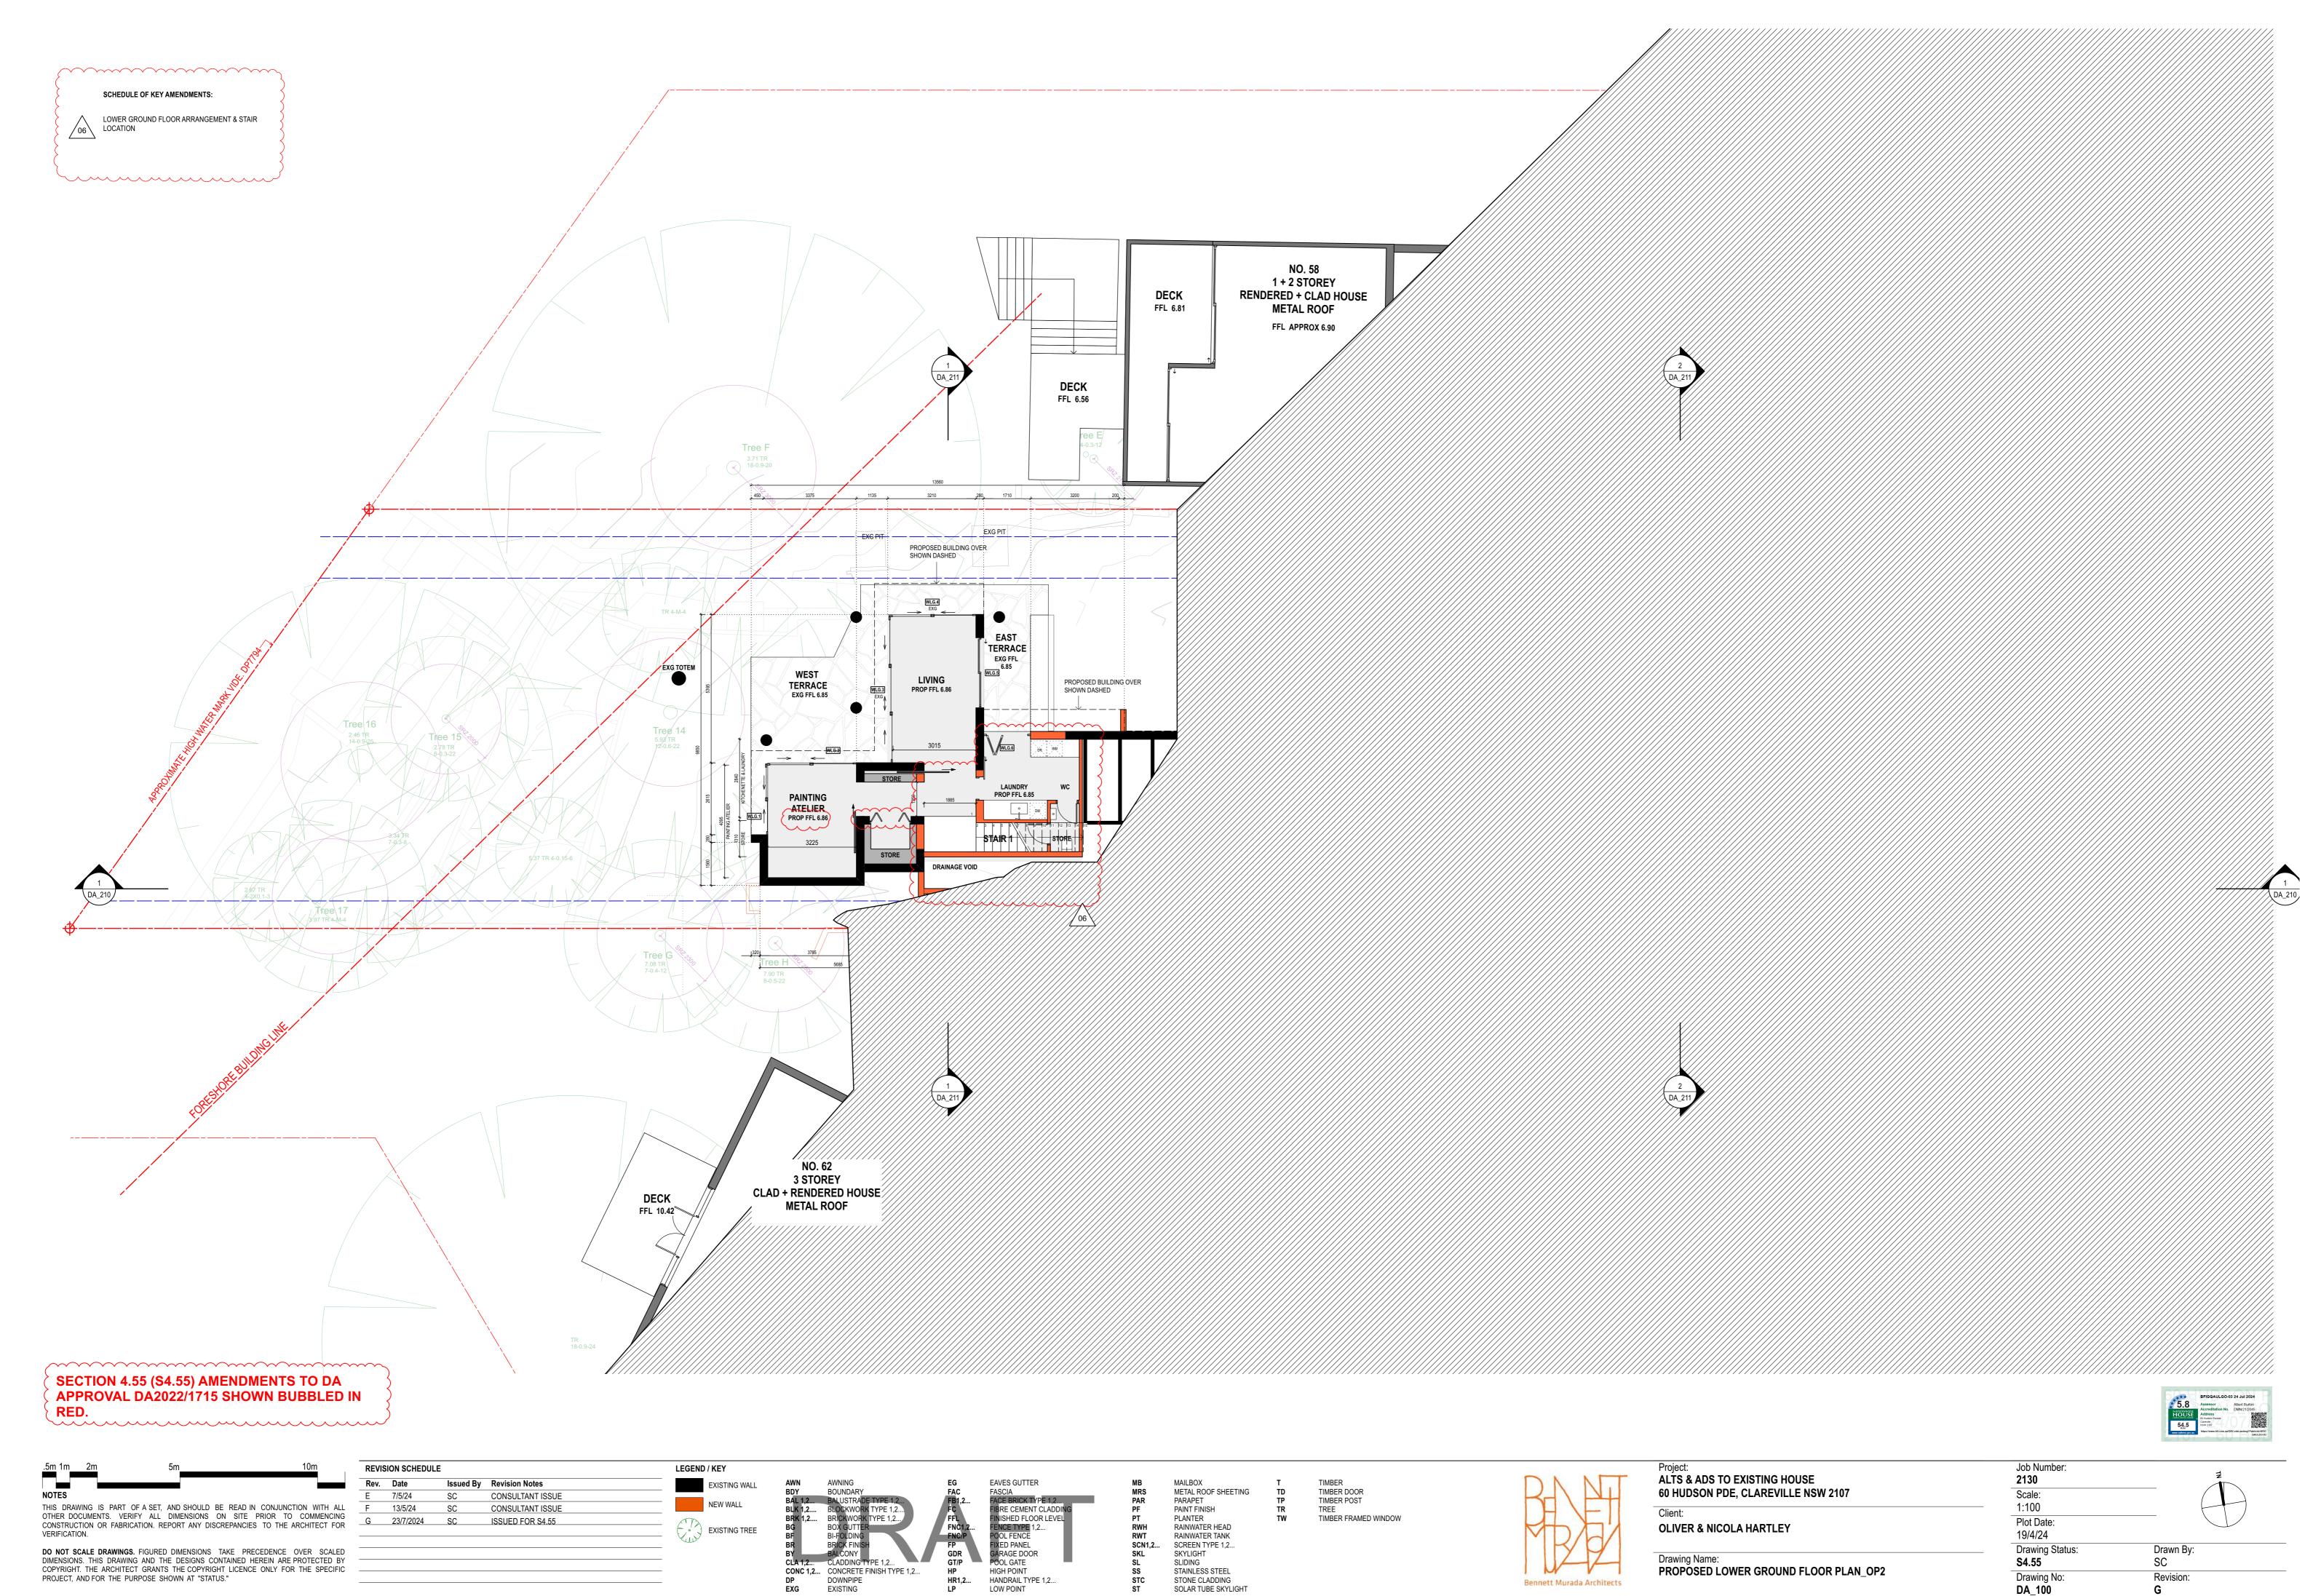
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Rev.	Date	Issued By	Revision Notes	EXISTING WALL
Α	26/4/24	SC	CONSULTANT ISSUE	
В	1/5/24	SC	STRUCTURAL ISSUE	DEMOLISHED WALL
С	23/7/2024	SC	ISSUED FOR S4.55	


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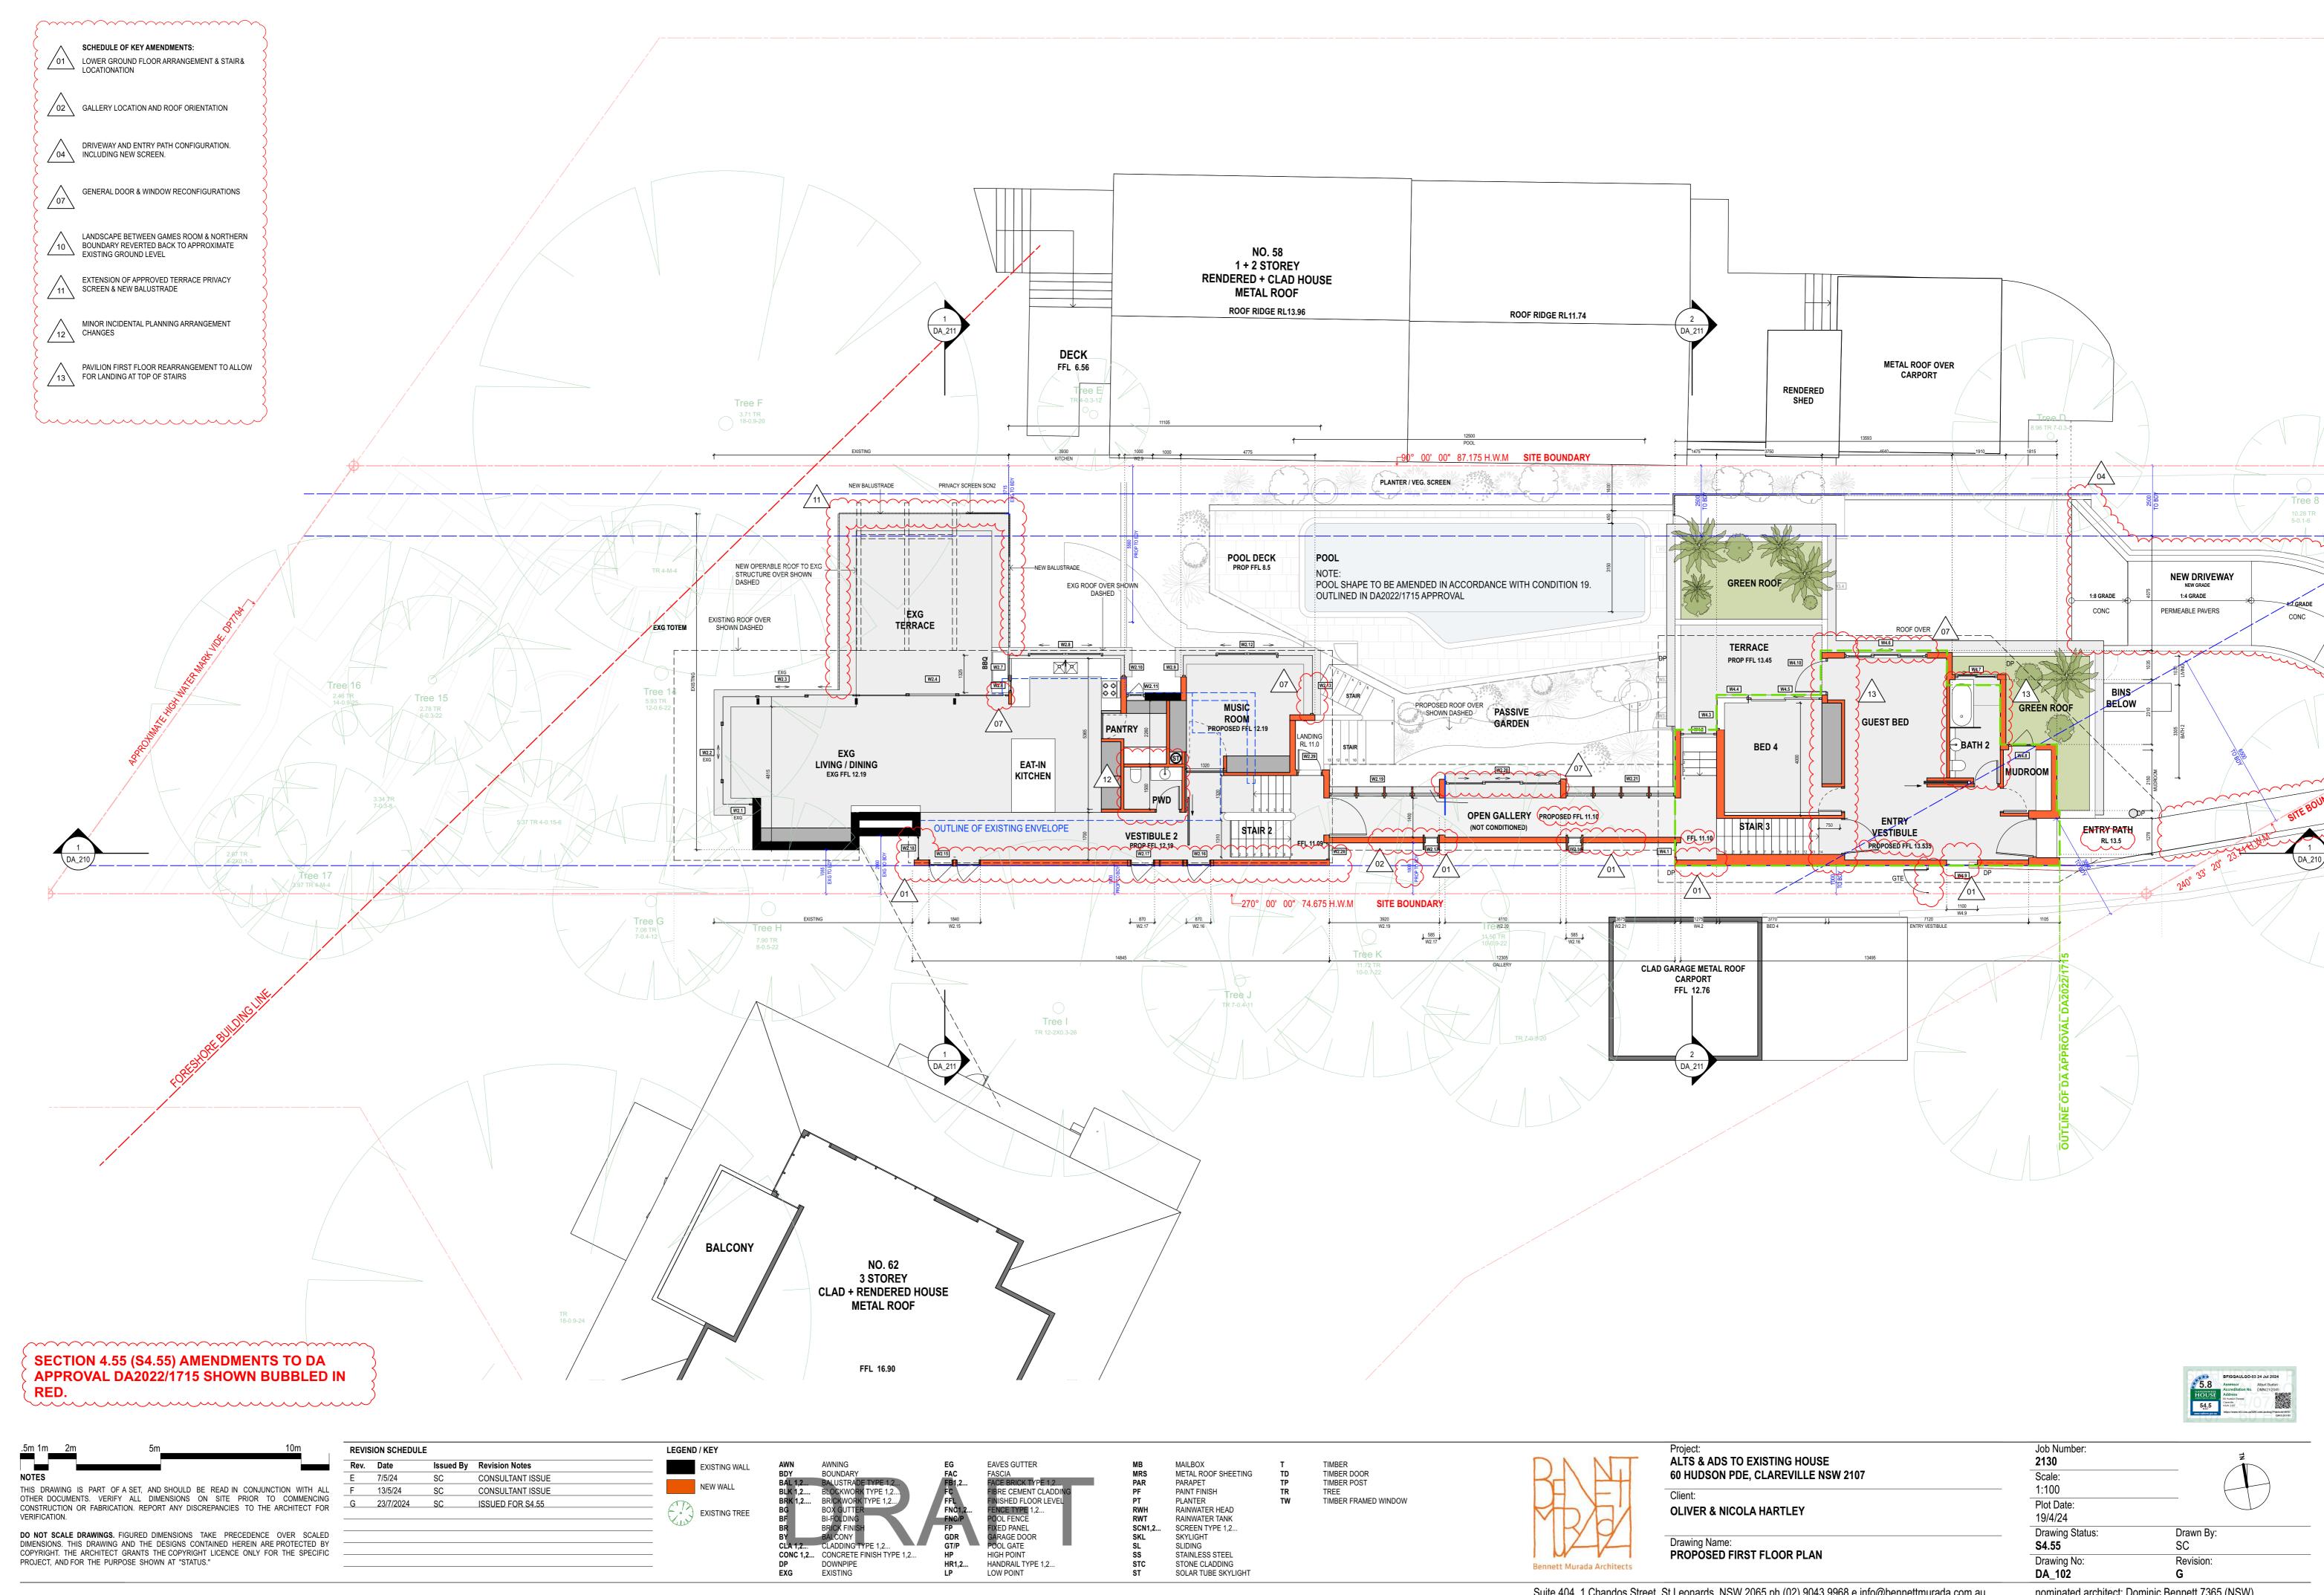
Project: ALTS & ADS TO EXISTING HOUSE 60 HUDSON PDE, CLAREVILLE NSW 2107	
Client:	_
OLIVER & NICOLA HARTLEY	! :


LIVER & NICOLA HARTLEY	
rawing Name: EMOLITION PLANS - LEVEL 01 + ROOF	


2130 Scale:	
1:100	
Plot Date:	
28/8/23	
Drawing Status:	Drawn By:
DA	LR
Drawing No:	Revision:
DA_005	C





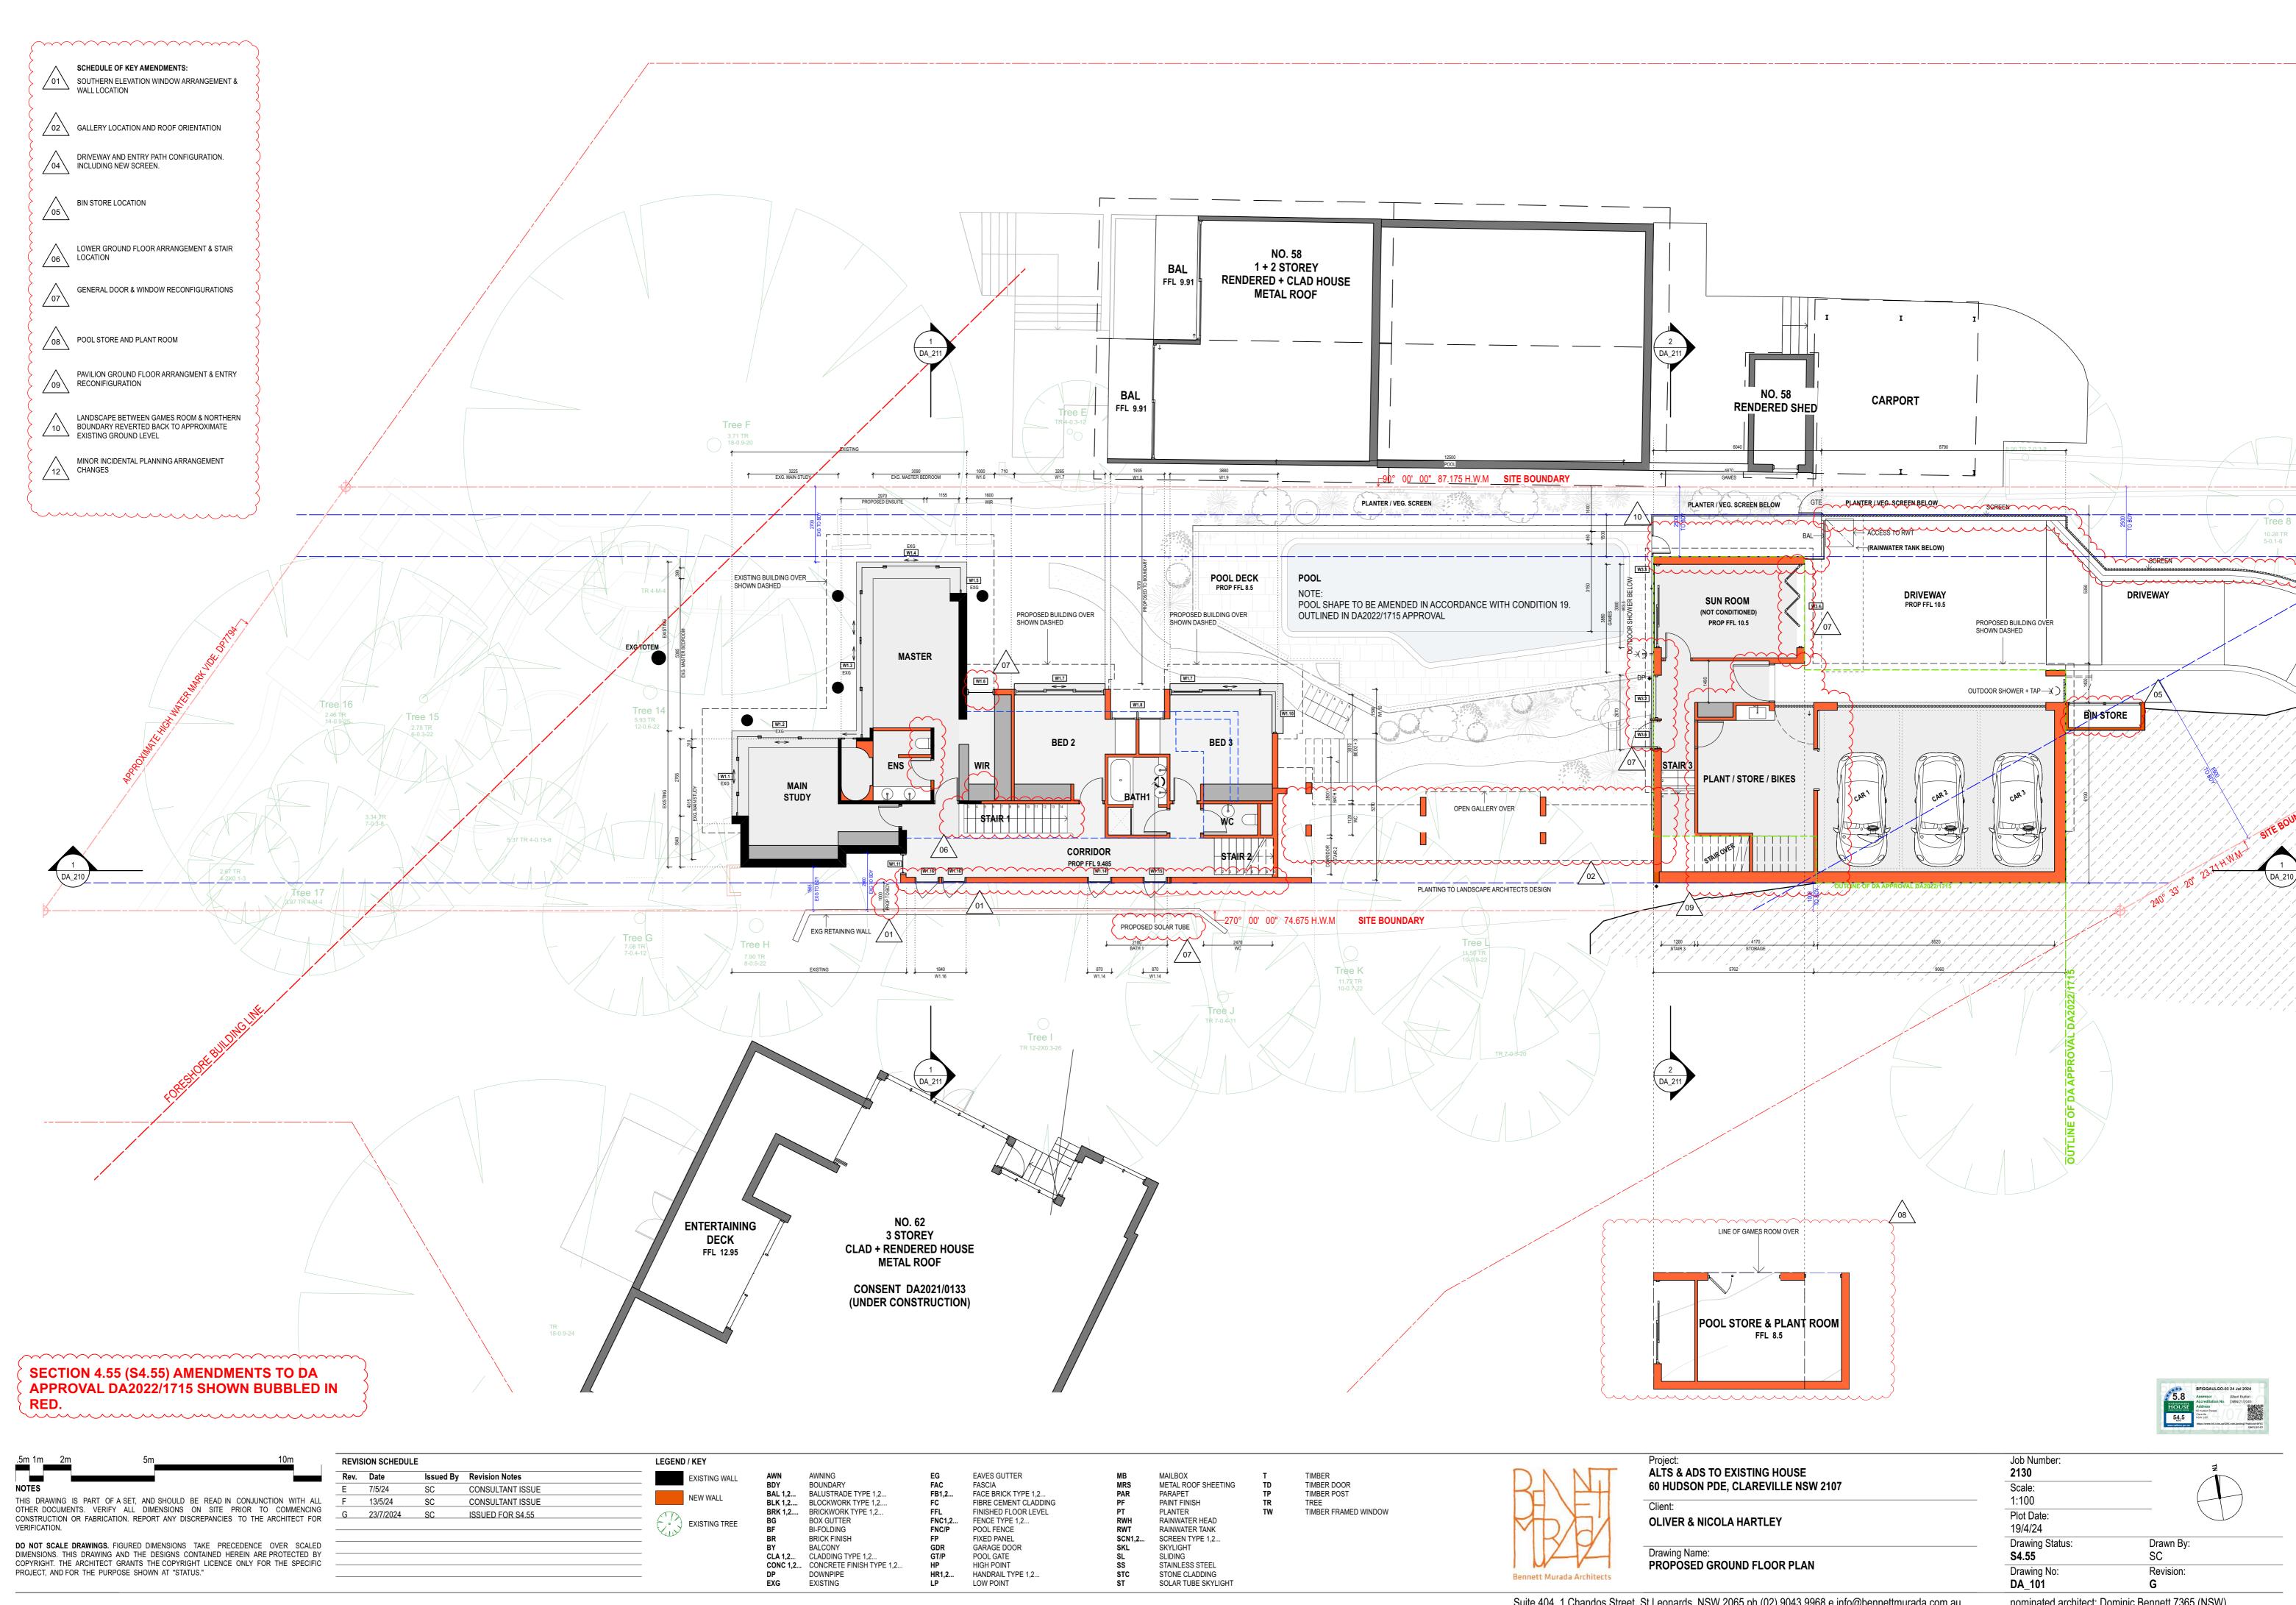

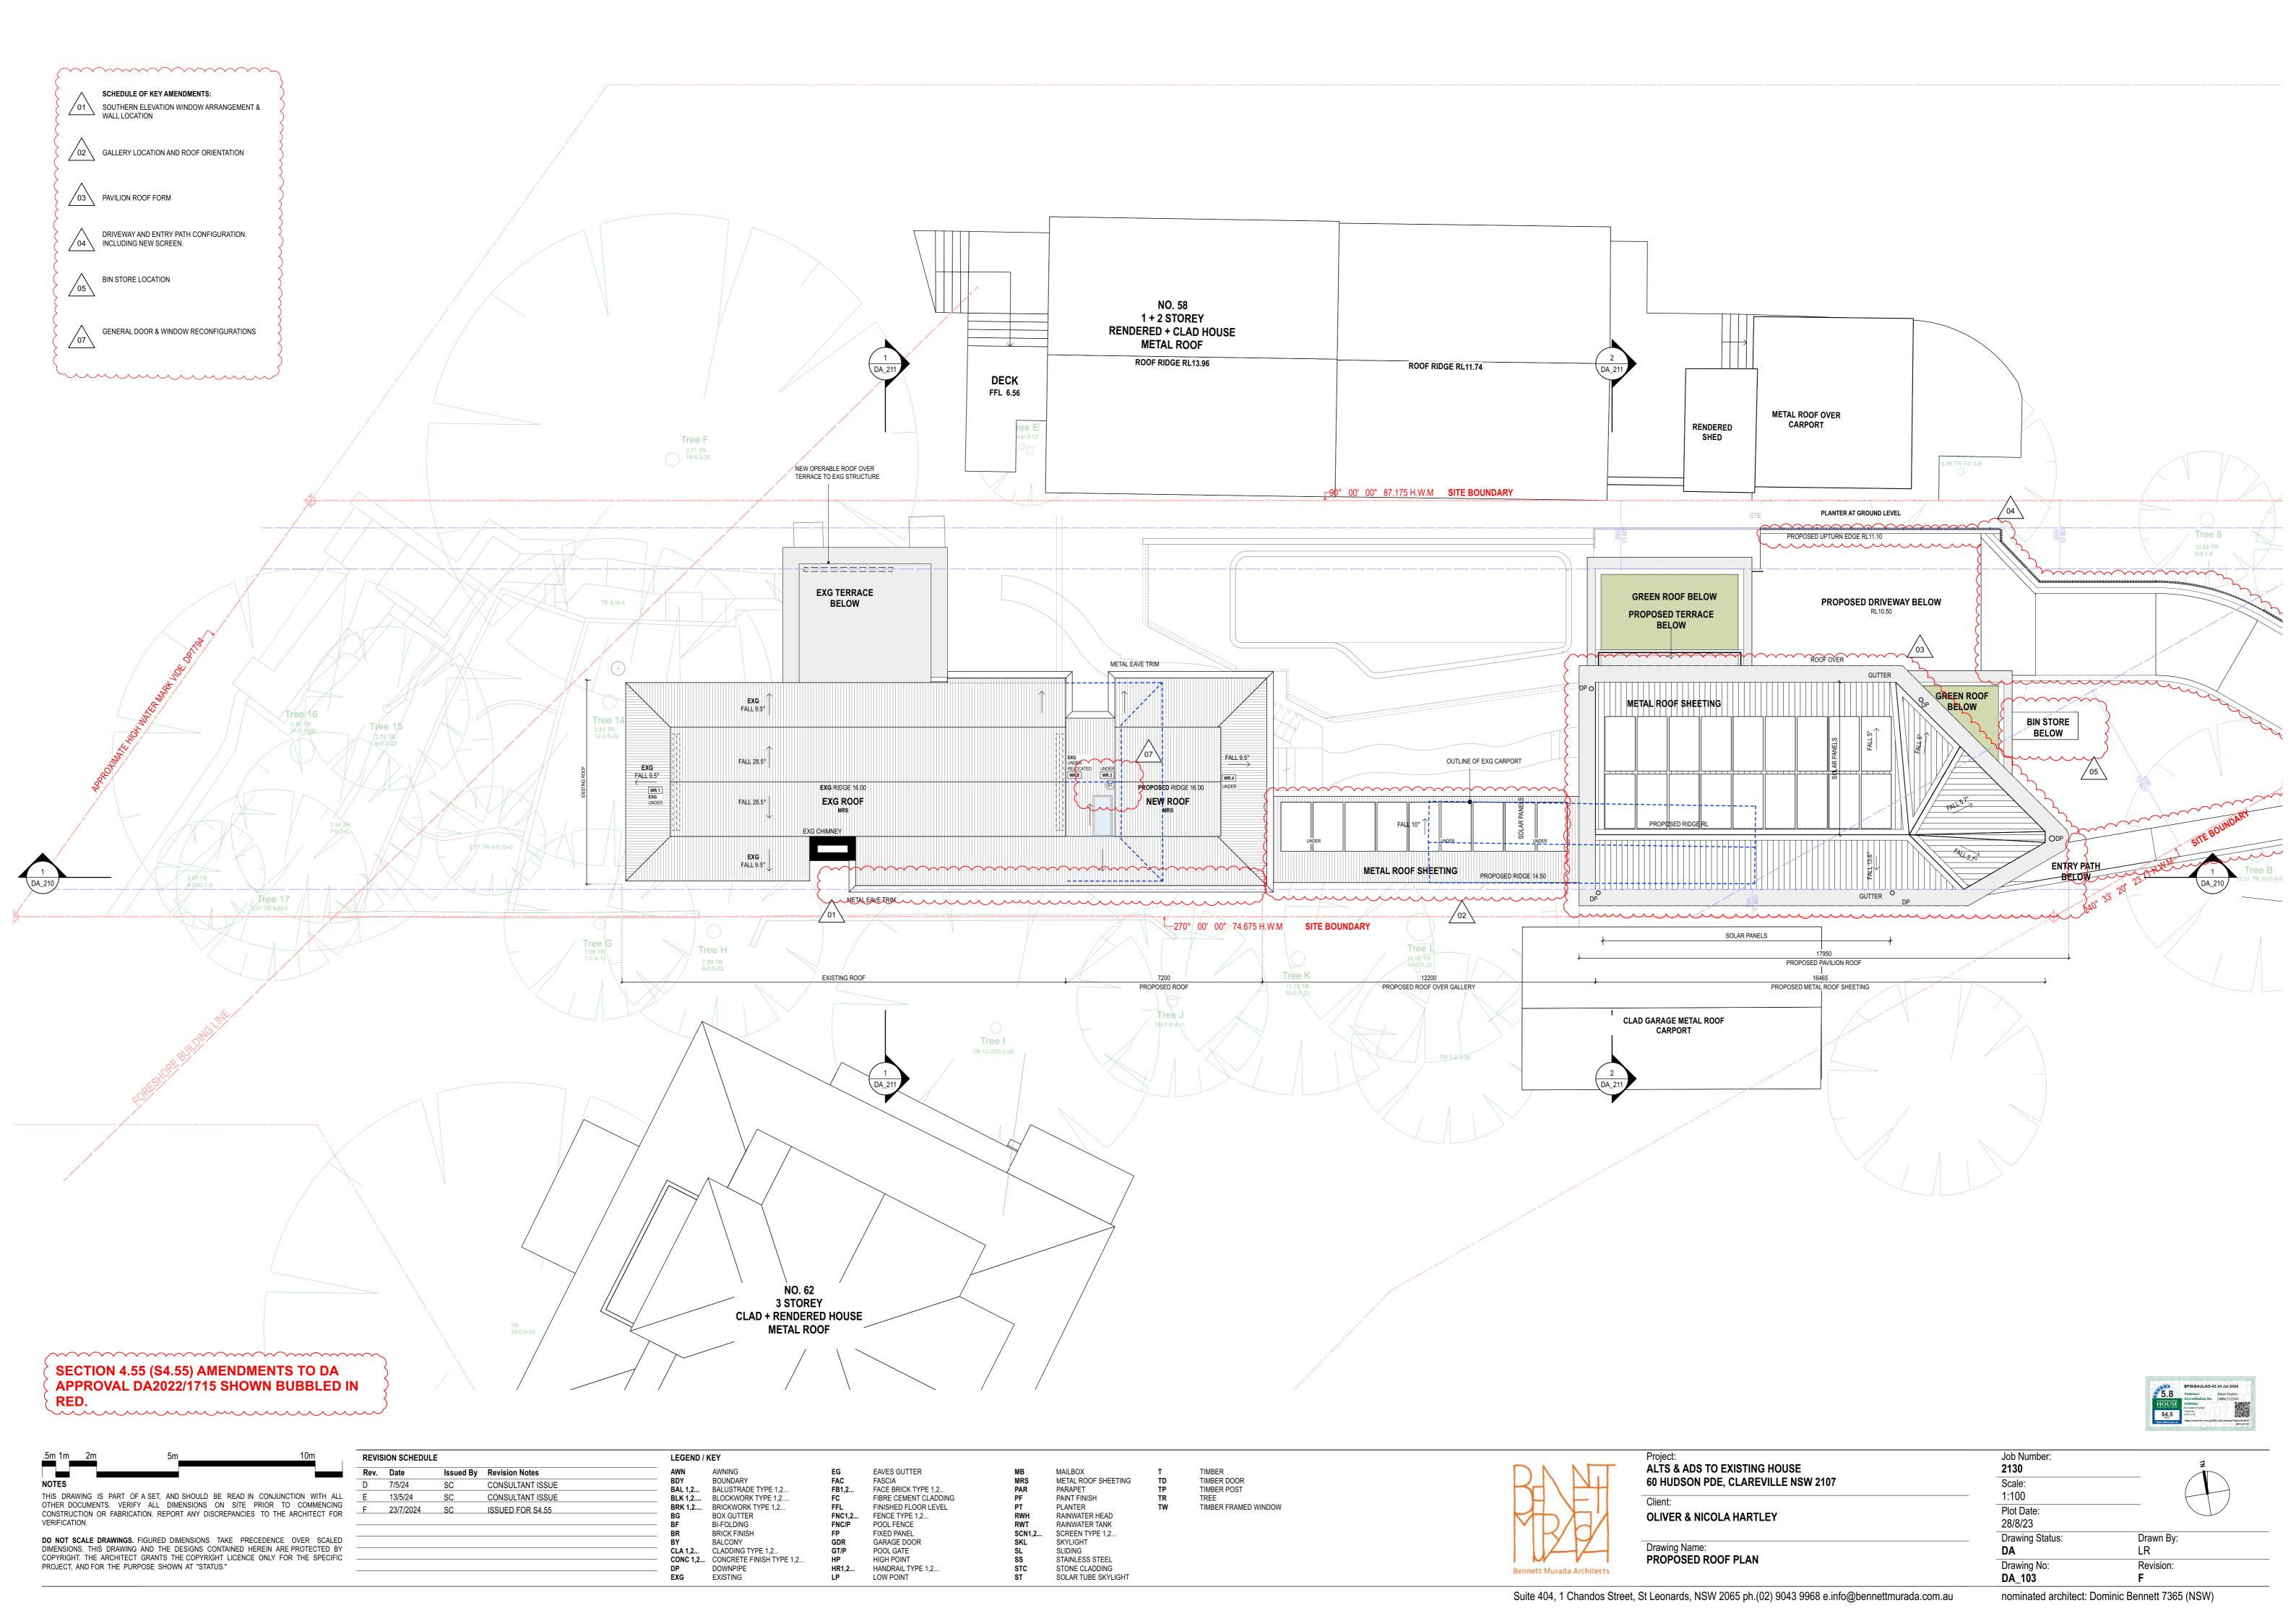

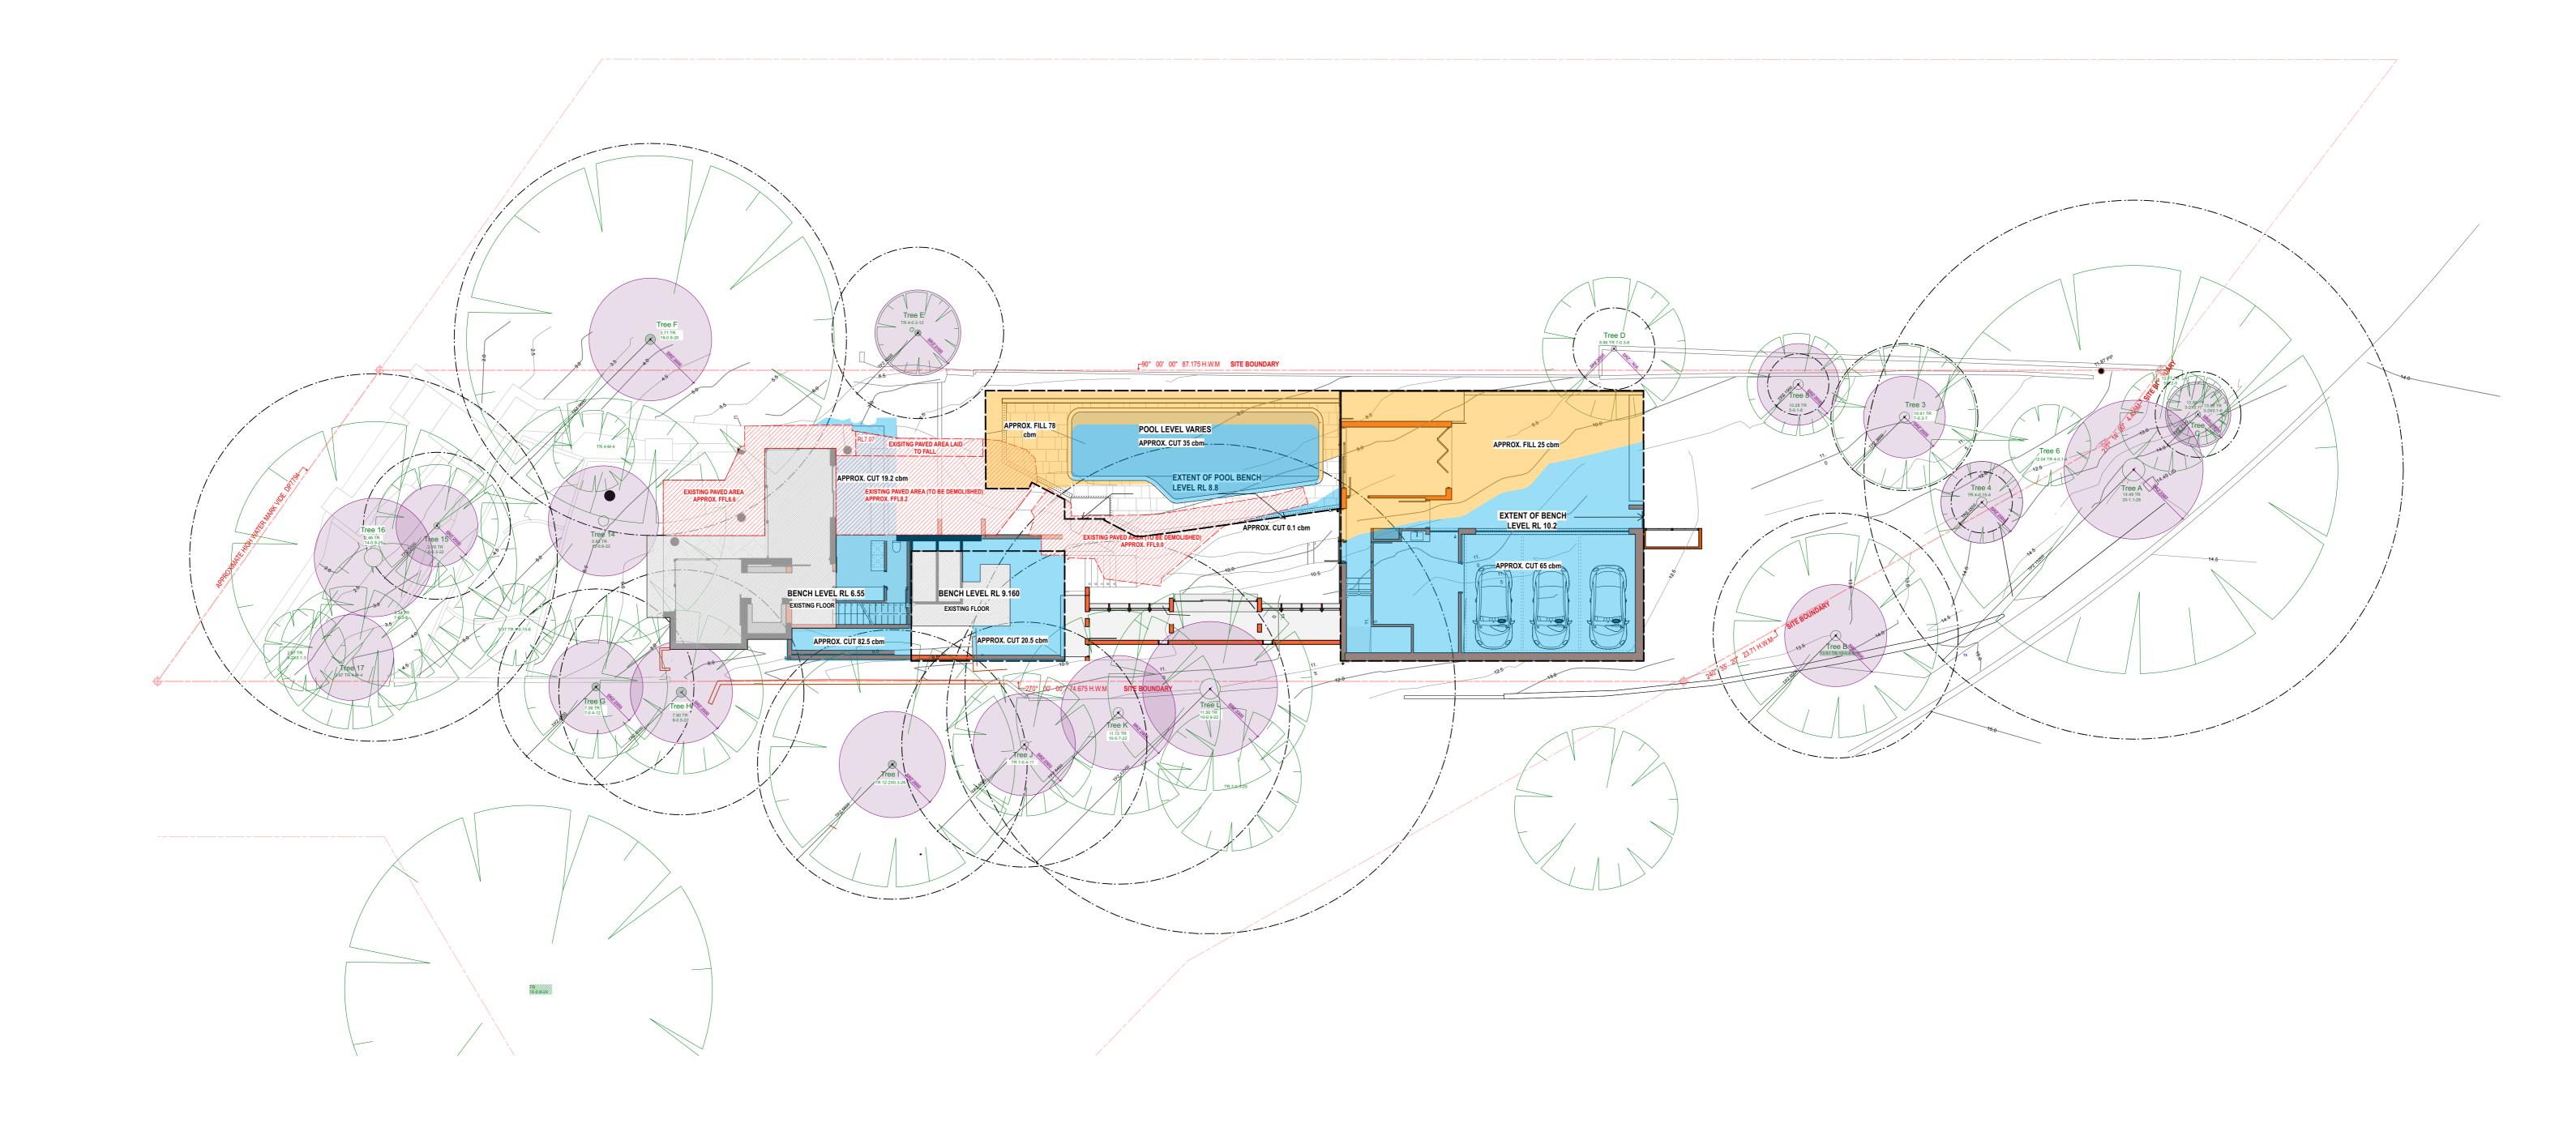



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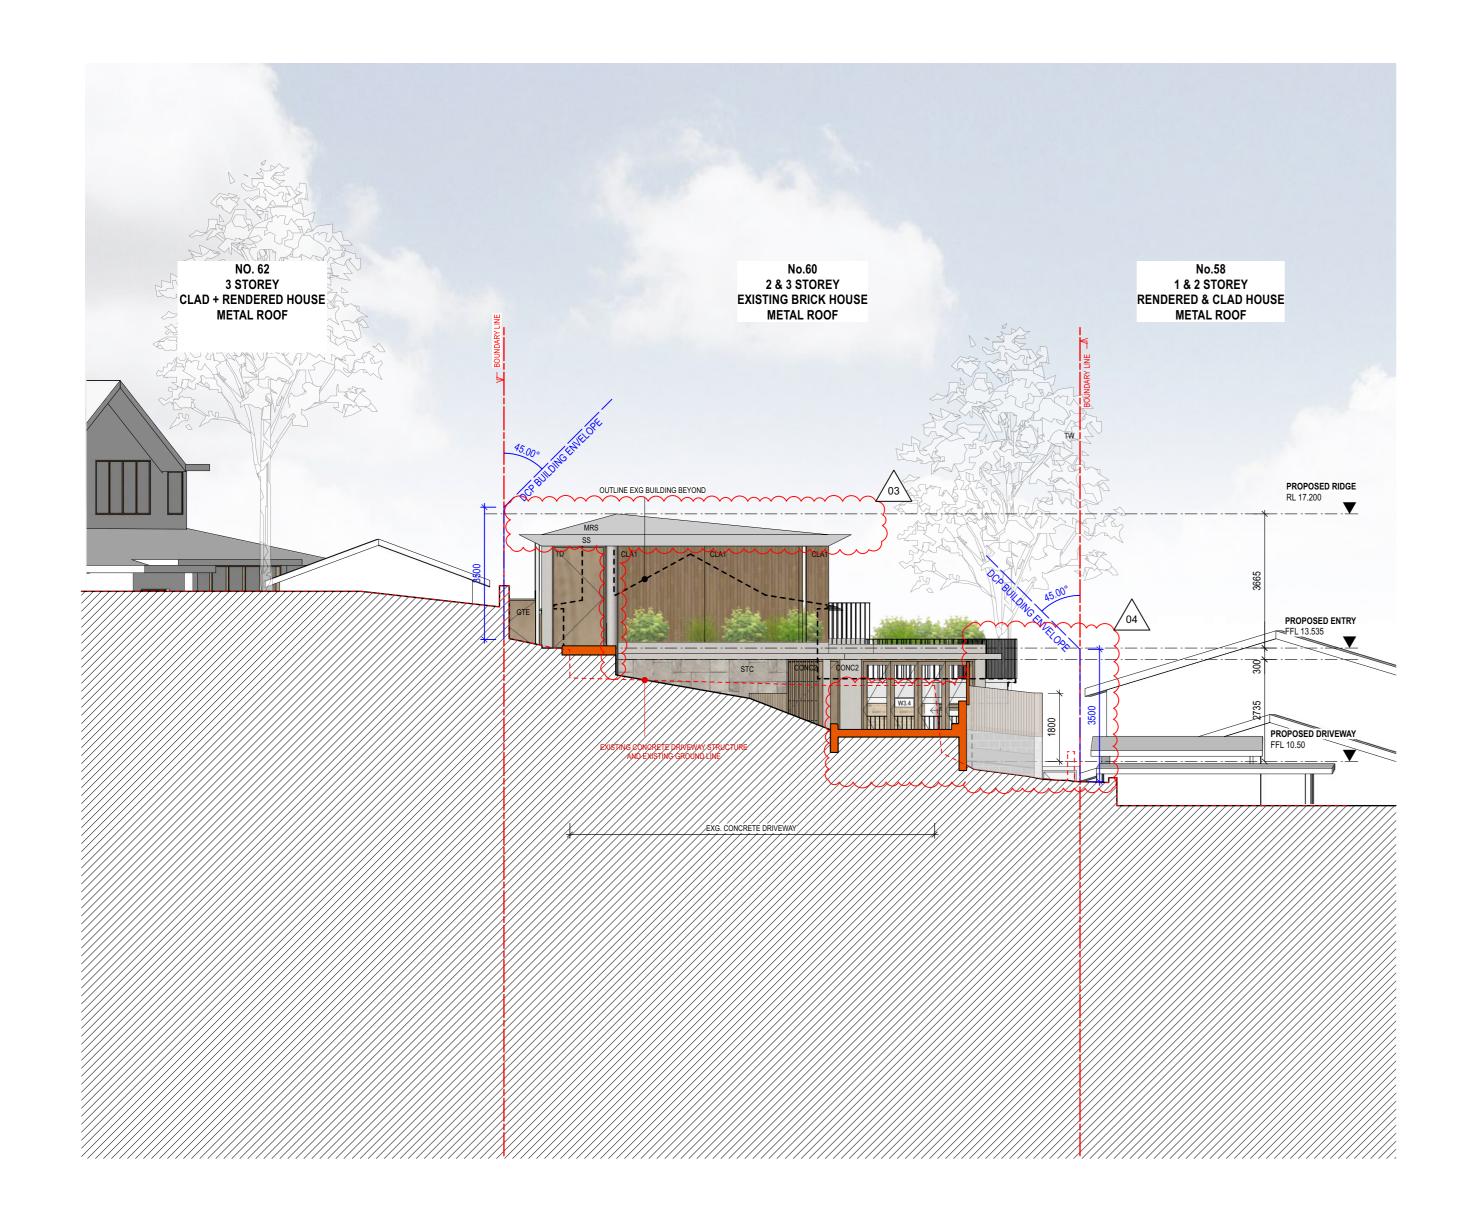
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Rev.	Date	Issued By	Revision Notes	PROPOSED CUT		
Α	26/4/24	SC	CONSULTANT ISSUE			
В	23/7/2024	SC	ISSUED FOR S4.55	PROPOSED FILL		
				EXISTING PAVED AREA TO BE REMOVED		
				EXISTING FLOOR LEVEL TO BE RETAINED		
				TPZ		
				SRZ		
				TPZ		


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Project: ALTS & ADS TO EXISTING HOUSE	
60 HUDSON PDE, CLAREVILLE NS	W 2107
OLIVER & NICOLA HARTLEY	

Client: OLIVER & NICOLA HARTLEY	
Drawing Name: CUT AND FILL PLAN	

Job Number: 2130	7
 Scale: 1:100	
Plot Date: 28/8/23	
 Drawing Status:	Drawn By:
DA	LR
Drawing No:	Revision:





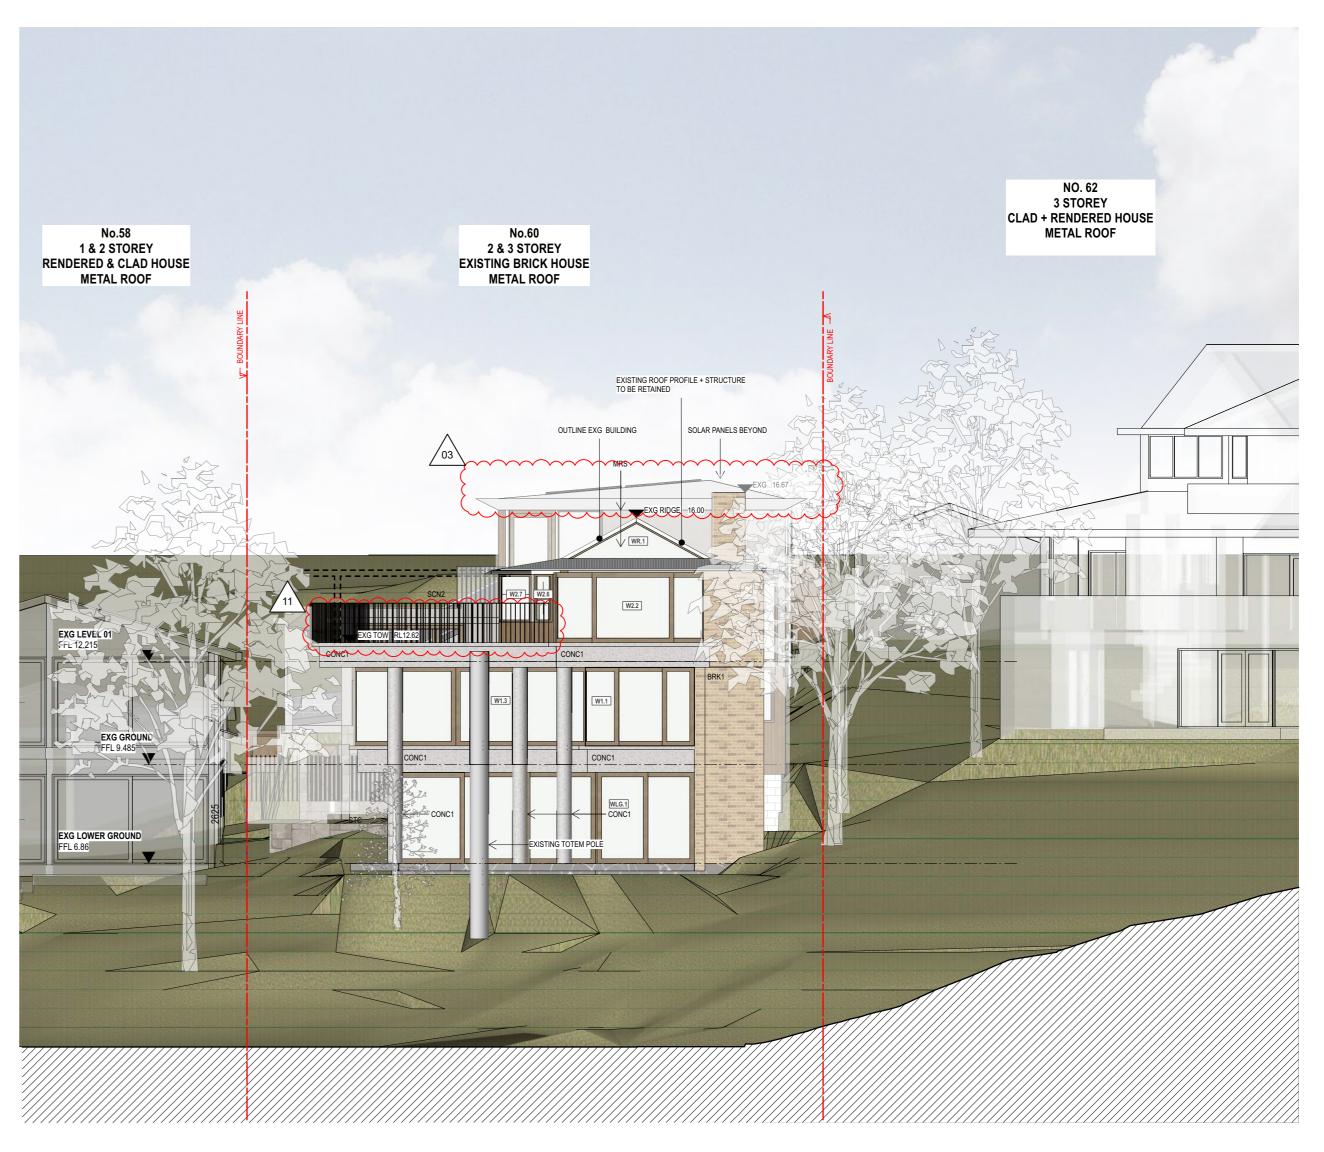

SECTION 4.55 (S4.55) AMENDMENTS TO DA APPROVAL DA2022/1715 SHOWN BUBBLED IN RED.

NOTE: REFER TO LANDSCAPE DRAWINGS FOR LANDSCAPING AND SITE GRADING DETAILS



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PROJECT, AND FOR THE PURPOSE SHOWN AT "STATUS."

Rev.	Date	Issued By	Revision Notes
В	1/5/24	SC	STRUCTURAL ISSUE
С	13/5/24	SC	CONSULTANT ISSUE
D	23/7/2024	SC	ISSUED FOR S4.55

DUL	E		LEGEND /	KEY		
	Issued By	Revision Notes	AWN	AWNING	EG	EAVES GL
	SC	STRUCTURAL ISSUE	BDY	BOUNDARY BALUSTRADE TYPE 1.2	FAC	FASCIA
	SC	CONSULTANT ISSUE	————— BAL 1,2 BLK 1,2	BLOCKWORK TYPE 1,2	FB1,2 FC	FACE BRI
4	SC	ISSUED FOR S4.55	BRK 1,2	BRICKWORK TYPE 1,2	FFL	FINISHED
			BG	BOX GUTTER	FNC1,2	FENCE TY
			BF BR	BI-FOLDING BRICK FINISH	FNC/P FP	POOL FEN
			BY	BALCONY	GDR	GARAGE
			CLA 1,2	CLADDING TYPE 1,2	GT/P	POOL GAT
			CONC 1,2	,	HP	HIGH POI
			DP EXG	DOWNPIPE EXISTING	HR1,2 LP	HANDRAII LOW POIN

G	EAVES GUTTER	MB
AC	FASCIA	MRS
B1,2	FACE BRICK TYPE 1,2	PAR
C	FIBRE CEMENT CLADDING	PF
FL	FINISHED FLOOR LEVEL	PT
NC1,2	FENCE TYPE 1,2	RWH
NC/P	POOL FENCE	RWT
P	FIXED PANEL	SCN1,2.
DR	GARAGE DOOR	SKL
T/P	POOL GATE	SL
P	HIGH POINT	SS
R1,2	HANDRAIL TYPE 1,2	STC
P	LOW POINT	ST

MAILBOX METAL ROOF SHEETING PARAPET PAINT FINISH PLANTER RAINWATER HEAD RAINWATER TANK SCREEN TYPE 1,2 SKYLIGHT SLIDING STAINLESS STEEL STONE CLADDING SOLAR TUBE SKYLIGHT	T TD TP TR TW	TIMBER TIMBER DOOR TIMBER POST TREE TIMBER FRAMED WINDOW




Project: ALTS & ADS TO EXISTING HOUSE	Job Number: 2130
60 HUDSON PDE, CLAREVILLE NSW 2107 Client:	Scale: 1:100
OLIVER & NICOLA HARTLEY	Plot Date: 28/8/23
Drawing Name: EAST + WEST ELEVATIONS	Drawing Status:
EAST + WEST ELEVATIONS	Drawing No: DA_200

Drawn By: LR

Revision:



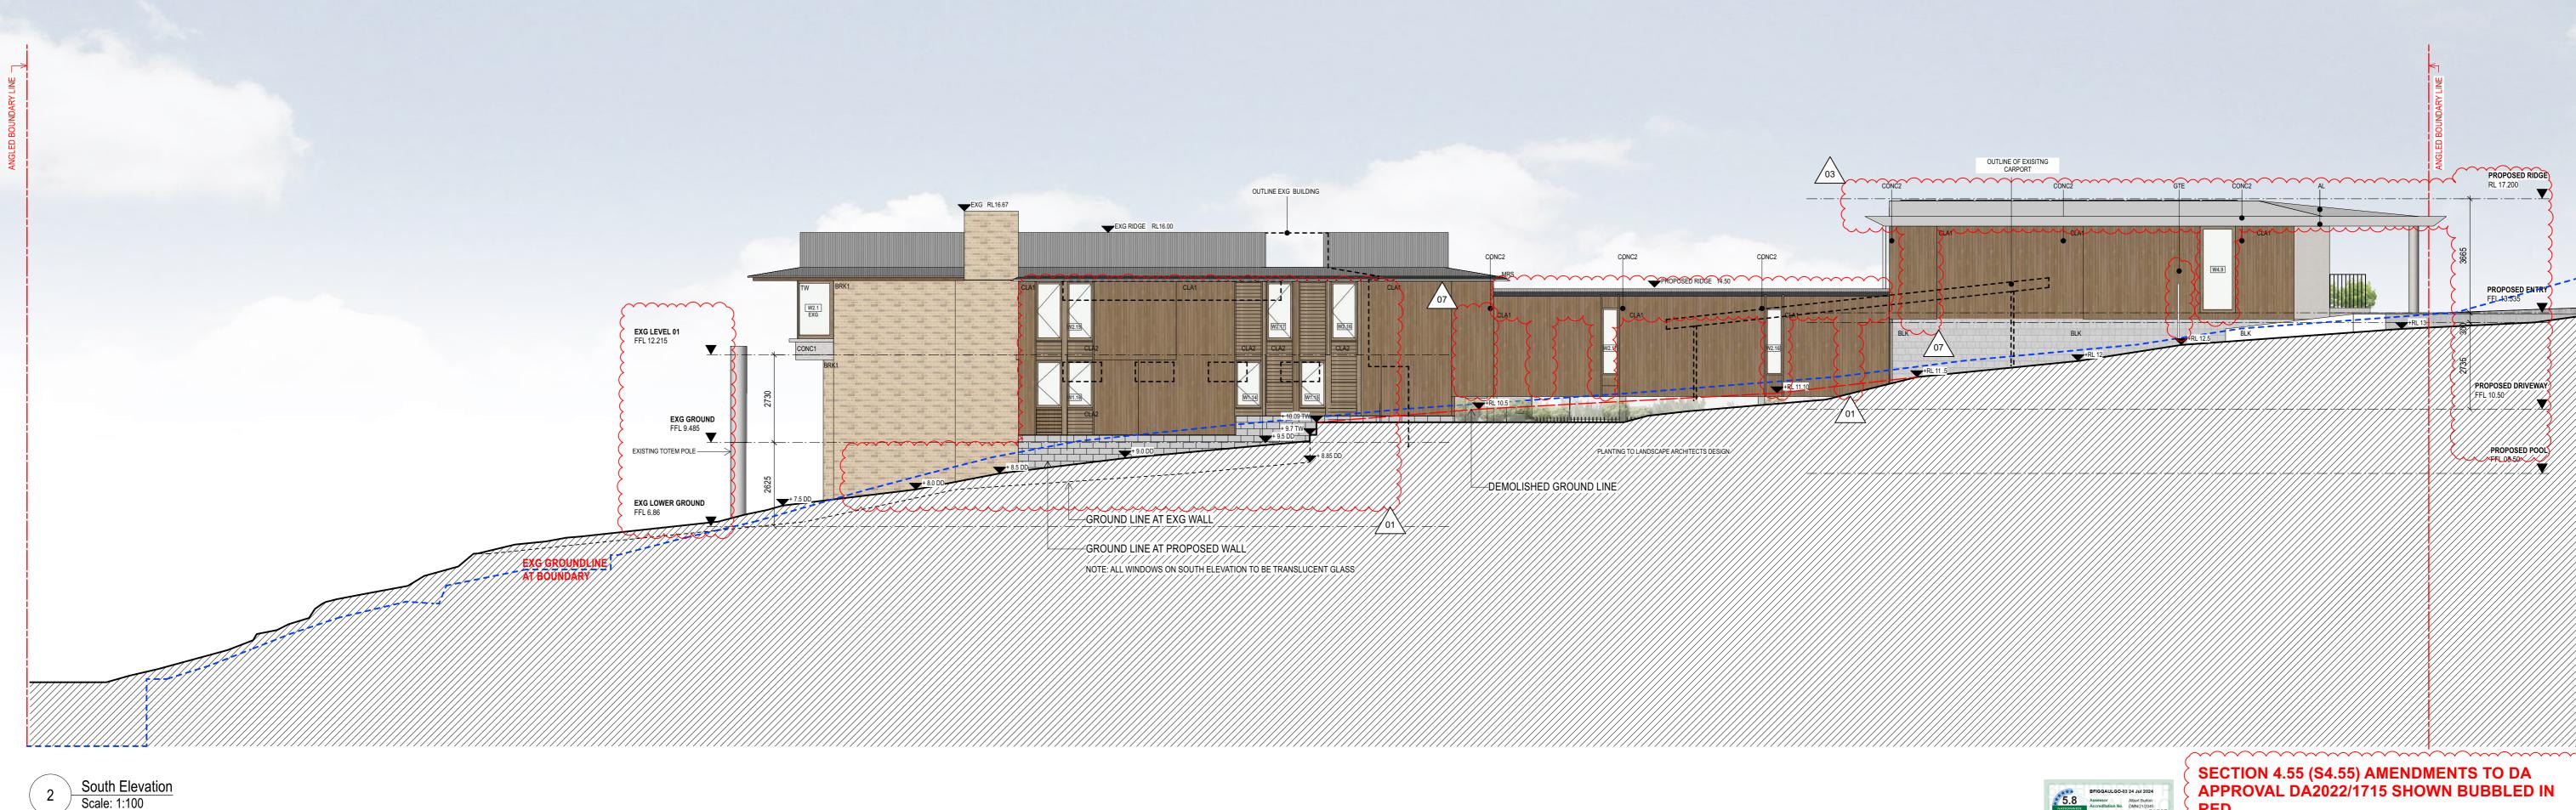

NOTES

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REVISION SCHEDULE				LEGEND / KEY
Rev.	Date	Issued By	Revision Notes	EXISTING WALL
D	1/5/24	SC	STRUCTURAL ISSUE	
Е	13/5/24	SC	CONSULTANT ISSUE	NEW WALL
F	23/7/2024	SC	ISSUED FOR S4.55	

L	CONC 1,2 DP	AWNING BOUNDARY BALUSTRADE TYPE 1,2 BLOCKWORK TYPE 1,2 BRICKWORK TYPE 1,2 BOX GUTTER BI-FOLDING BRICK FINISH BALCONY CLADDING TYPE 1,2 CONCRETE FINISH TYPE 1,2 DOWNPIPE	EG FAC FB1,2 FC FFL FNC1,2 FNC/P FP GDR GT/P HP HR1,2
	EXG	EXISTING	LP

EAVES GUTTER
FASCIA

2... FACE BRICK TYPE 1,2...
FIBRE CEMENT CLADDING
FINISHED FLOOR LEVEL

1,2... FENCE TYPE 1,2...
POOL FENCE
FIXED PANEL
GARAGE DOOR
POOL GATE
HIGH POINT
LOW POINT

MB MAILBOX
MRS METAL ROOF SHEETING
PAR PARAPET
PF PAINT FINISH
PT PLANTER
RWH RAINWATER HEAD
RWT RAINWATER TANK
SCN1,2... SCREEN TYPE 1,2...
SKL SKYLIGHT
SL SLIDING
SS STAINLESS STEEL
STC STONE CLADDING

SOLAR TUBE SKYLIGHT

TIMBER
TIMBER DOOR
TIMBER POST
TREE
TIMBER FRAMED WINDOW



Project:
ALTS & ADS TO EXISTING HOUSE
60 HUDSON PDE, CLAREVILLE NSW 2107

Scale:

 Project:
 Job Number

 ALTS & ADS TO EXISTING HOUSE
 2130

 60 HUDSON PDE, CLAREVILLE NSW 2107
 Scale:

 Client:
 1:100

 Plot Date:
 19/4/24

 Drawing Name:
 S4.55

2130
Scale:
1:100
Plot Date:
19/4/24
Drawing Status: Drawn By:
S4.55 SC
Drawing No: Revision:
DA_201 F

NORTH + SOUTH ELEVATIONS






SECTION 4.55 (S4.55) AMENDMENTS TO DA APPROVAL DA2022/1715 SHOWN BUBBLED IN

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Rev.	Date	Issued By	Revision Notes	EXISTING WALI
Α	24/4/24	SC	FOR INFORMATION	
В	26/4/24	SC	CONSULTANT ISSUE	NEW WALL
С	1/5/24	SC	STRUCTURAL ISSUE	
D	23/7/2024	SC	ISSUED FOR S4.55	



MB MRS PAR PF PT RWH RWT SCN1,2... EAVES GUTTER FASCIA FACE BRICK TYPE 1,2... BRE CEMENT CLADDING HIGH POINT HANDRAIL TYPE 1,2... LOW POINT

MAILBOX METAL ROOF SHEETING PARAPET PAINT FINISH PLANTER
RAINWATER HEAD
RAINWATER TANK
SCREEN TYPE 1,2...
SKYLIGHT SLIDING STAINLESS STEEL STONE CLADDING SOLAR TUBE SKYLIGHT TIMBER
TIMBER DOOR
TIMBER POST
TREE
TIMBER FRAMED WINDOW

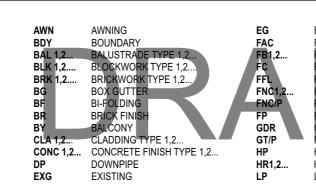



Project: ALTS & ADS TO EXISTING HOUSE	J g
60 HUDSON PDE, CLAREVILLE NSW 2107	
·	
Client: OLIVER & NICOLA HARTLEY	- P 2
Drawing Name: LONGITUDINAL SECTION	<u> </u>

Job Number: 2130 Scale: 1:100 Plot Date: 28/8/23 Drawing Status: DA LR Drawing No: Revision: DA 210 D Scale: 1:100 Revision:		** Color **	FIG
1:100 Plot Date: 28/8/23 Drawing Status: Drawn By: DA LR Drawing No: Revision:			_
28/8/23 Drawing Status: Drawn By: DA LR Drawing No: Revision:			
DA LR Drawing No: Revision:			
•			
5/1_210	Drawing No: DA_210	Revision: D	

nominated architect: Dominic Bennett 7365 (NSW)



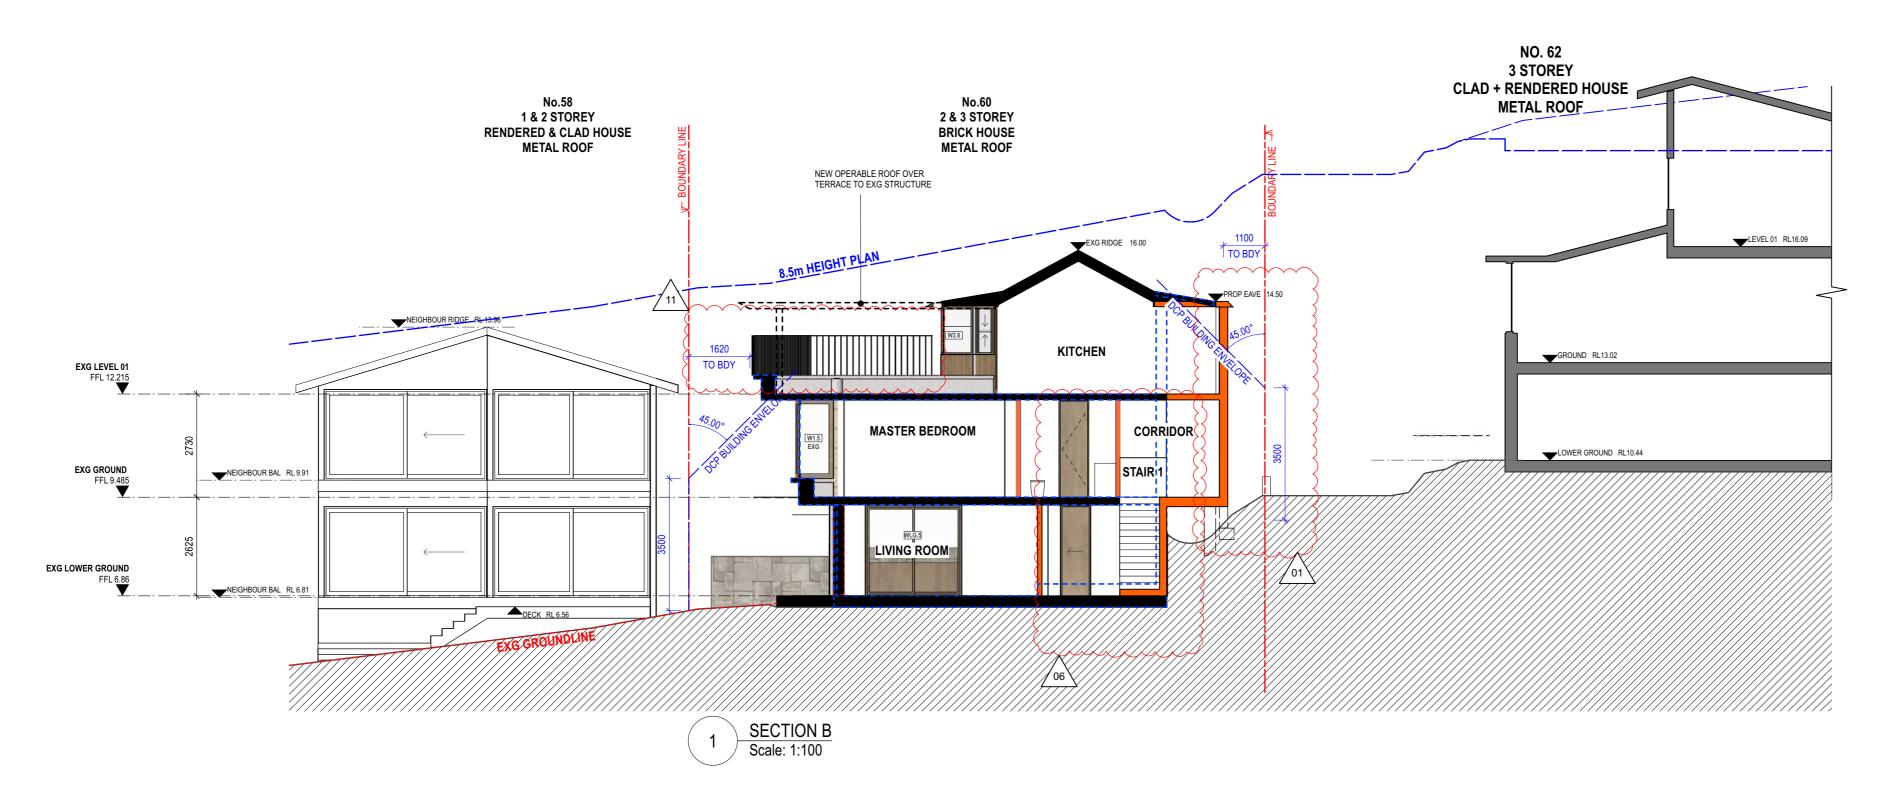

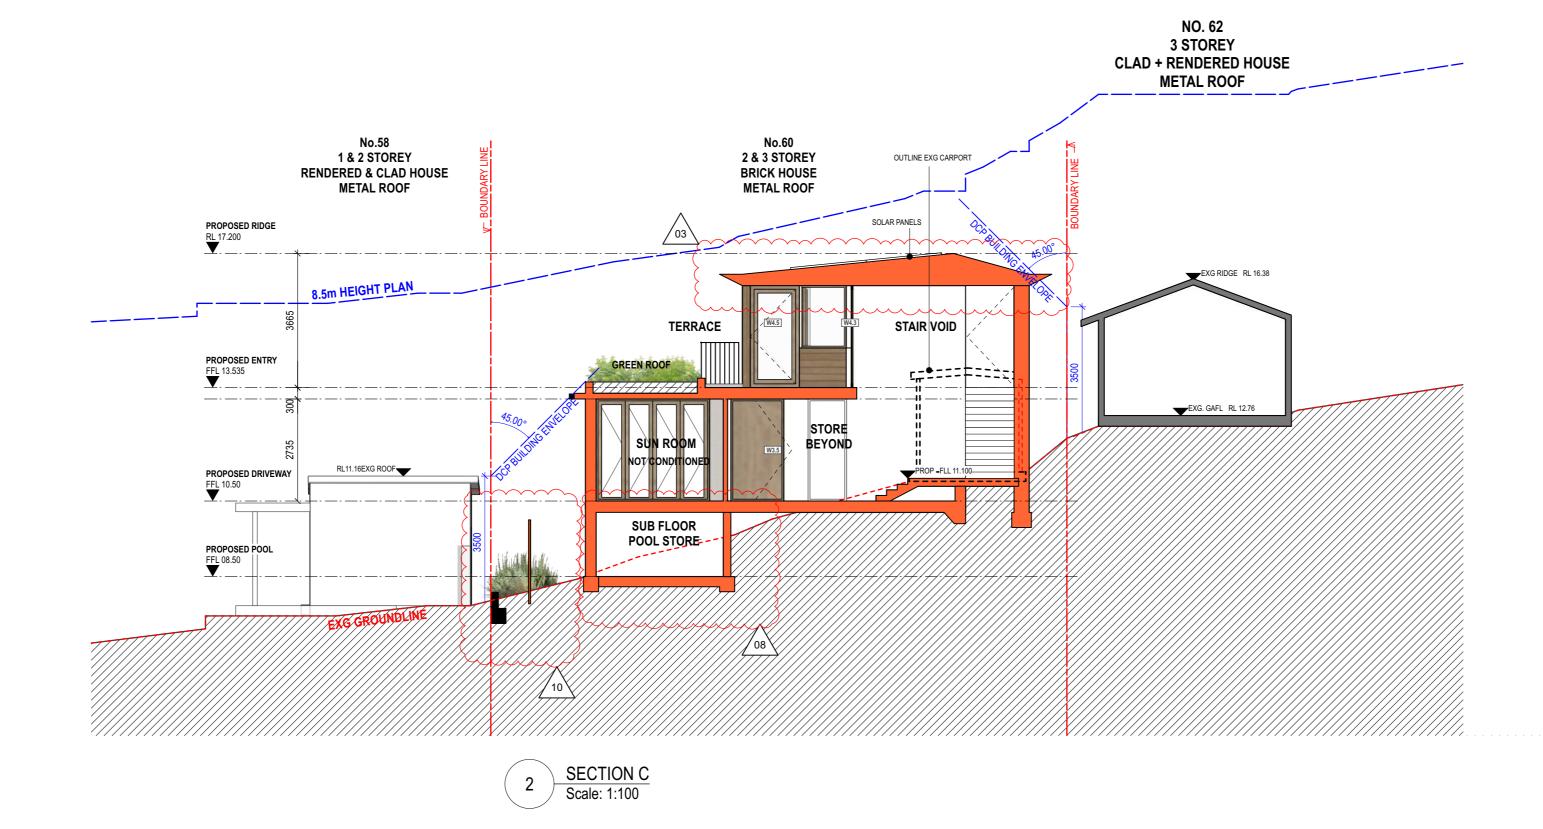

SECTION 4.55 (S4.55) AMENDMENTS TO DA
APPROVAL DA2022/1715 SHOWN BUBBLED IN RED.

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Assessor Abort Burton
Accreditation No. DNN/21/2045
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Rev.	Date	Issued By	Revision Notes	
Α	24/4/24	SC	FOR INFORMATION	
В	26/4/24	SC	CONSULTANT ISSUE	
С	1/5/24	SC	STRUCTURAL ISSUE	
D	23/7/2024	SC	ISSUED FOR S4.55	

AWN	AWNING	EG	EAVES GUTTER
BDY	BOUNDARY	FAC	FASCIA
BAL 1,2	BALUSTRADE TYPE 1,2	FB1,2	FACE BRICK TYPE 1,2
BLK 1,2	BLOCKWORK TYPE 1,2	FC	FIBRE CEMENT CLADDING
BRK 1,2	BRICKWORK TYPE 1,2	FFL	FINISHED FLOOR LEVEL
BG	BOX GUTTER	FNC1,2	FENCE TYPE 1,2
BF	BI-FOLDING	FNC/P	POOL FENCE
BR	BRICK FINISH	FP	FIXED PANEL
BY	BALCONY	GDR	GARAGE DOOR
CLA 1,2	CLADDING TYPE 1,2	GT/P	POOL GATE
CONC 1,2	CONCRETE FINISH TYPE 1,2	HP	HIGH POINT
DP	DOWNPIPE	HR1,2	HANDRAIL TYPE 1,2
EXG	EXISTING	LP	LOW POINT

LEGEND / KEY

GUTTER	MB	MAILBOX
A	MRS	METAL ROOF SHEETING
BRICK TYPE 1,2	PAR	PARAPET
CEMENT CLADDING	PF	PAINT FINISH
IED FLOOR LEVEL	PT	PLANTER
TYPE 1,2	RWH	RAINWATER HEAD
FENCE	RWT	RAINWATER TANK
PANEL	SCN1,2	SCREEN TYPE 1,2
GE DOOR	SKL	SKYLIGHT
GATE	SL 📉	SLIDING
POINT	SS	STAINLESS STEEL
RAIL TYPE 1,2	STC	STONE CLADDING
OINT	ST	SOLAR TUBE SKYLIGHT

TREE TIMBER FRAMED WINDOW	==	
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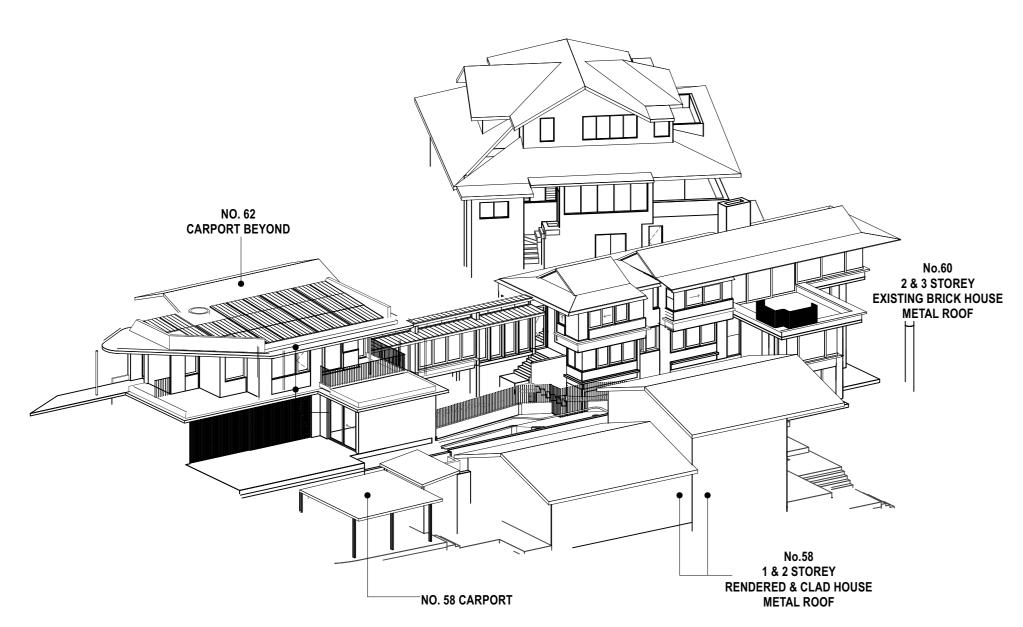
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Project: ALTS & ADS TO EXISTING HOUSE	Job Number: 2130
60 HUDSON PDE, CLAREVILLE NSW 2107 Client:	Scale: 1:100
OLIVER & NICOLA HARTLEY	Plot Date: 28/8/23
Drawing Name: CROSS SECTIONS	Drawing Status:
CRU33 SECTIONS	Drawing No: DA_211

Drawn By: LR


Revision:

NO. 62 3 STOREY CLAD + RENDERED HOUSE METAL ROOF



9AM - JUNE 21 - EXISTING (APPROVAL DA2022/1715) Scale: NTS


NO. 62 3 STOREY CLAD + RENDERED HOUSE METAL ROOF

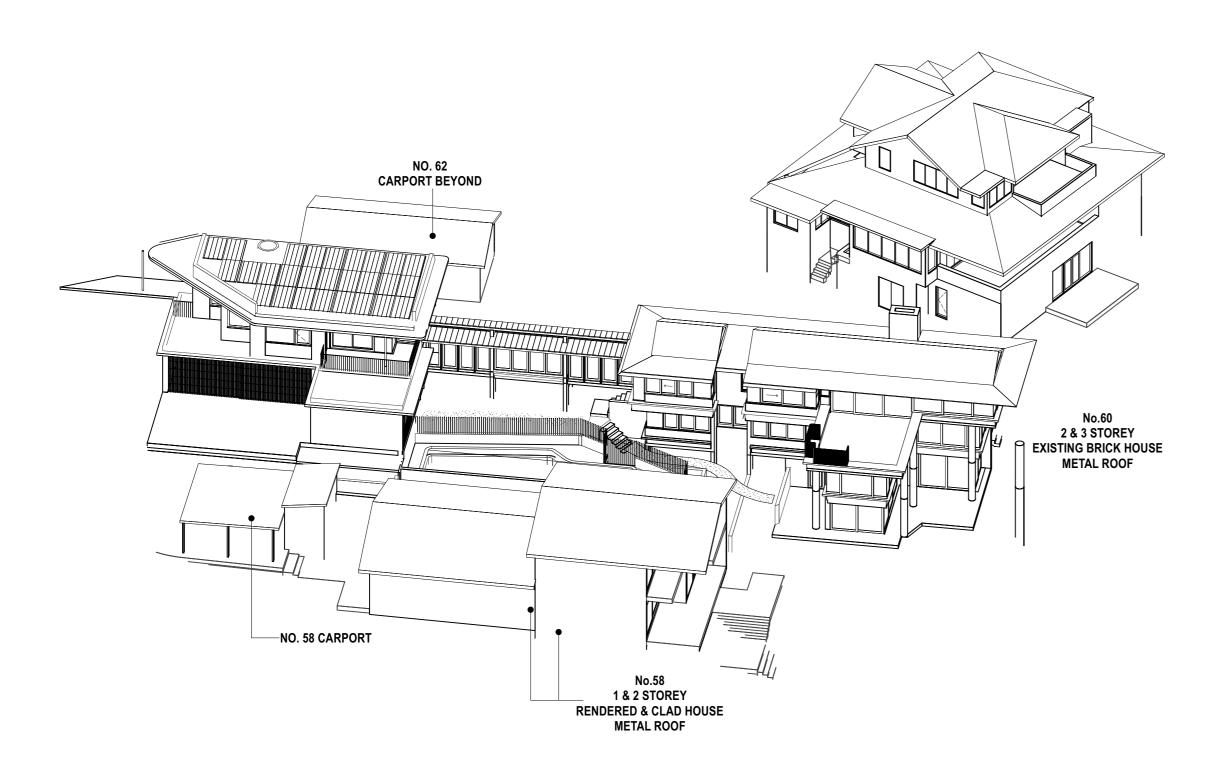

LEGEND / KEY

12PM - JUNE 21 - EXISTING (APPROVAL DA2022/1715) Scale: NTS

REVISION SCHEDULE

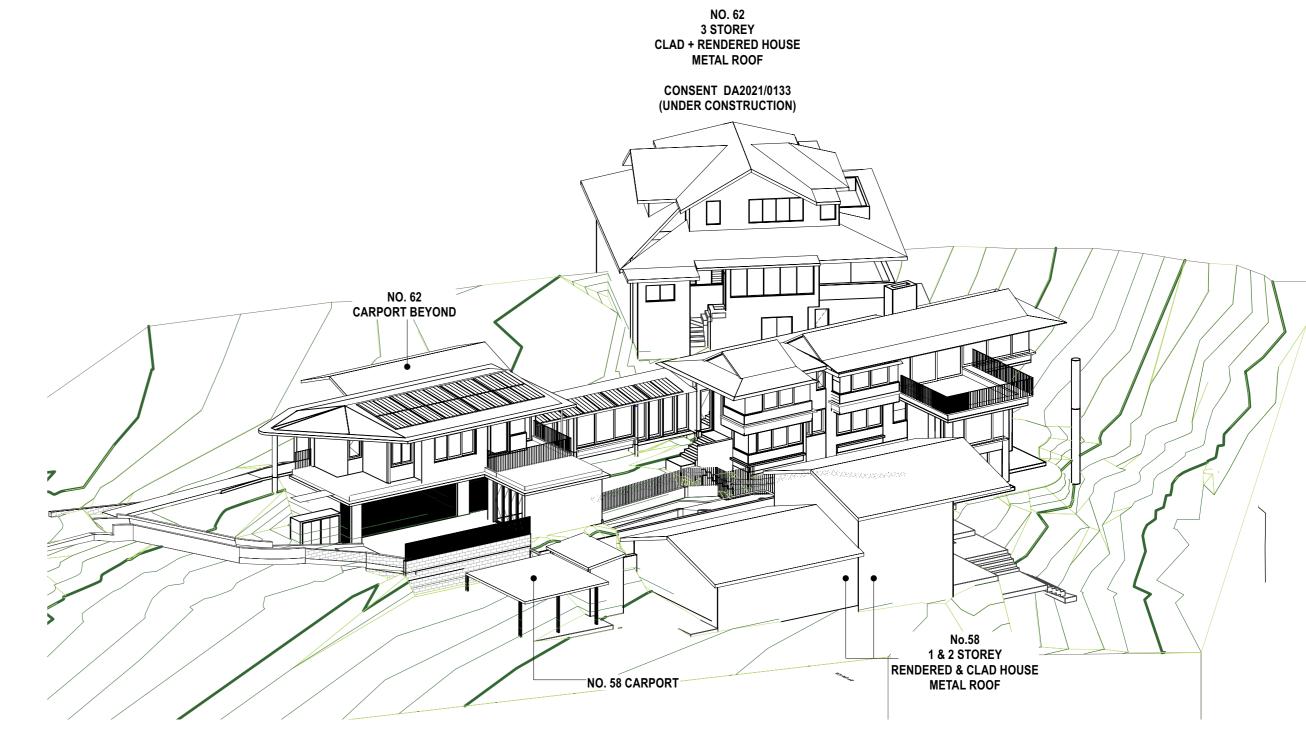

9AM - 21ST JUNE - PROPOSED Scale: NTS

CONSENT DA2021/0133 (UNDER CONSTRUCTION) NO. 62 CARPORT BEYOND NO. 58 CARPORT 1 & 2 STOREY
RENDERED & CLAD HOUSE
METAL ROOF 12PM - JUNE 21 - PROPOSED Scale: NTS

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Rev.	Date	Issued By	Revision Notes
Α	26/4/24	SC	CONSULTANT ISSUE
В	23/7/2024	SC	ISSUED FOR S4.55


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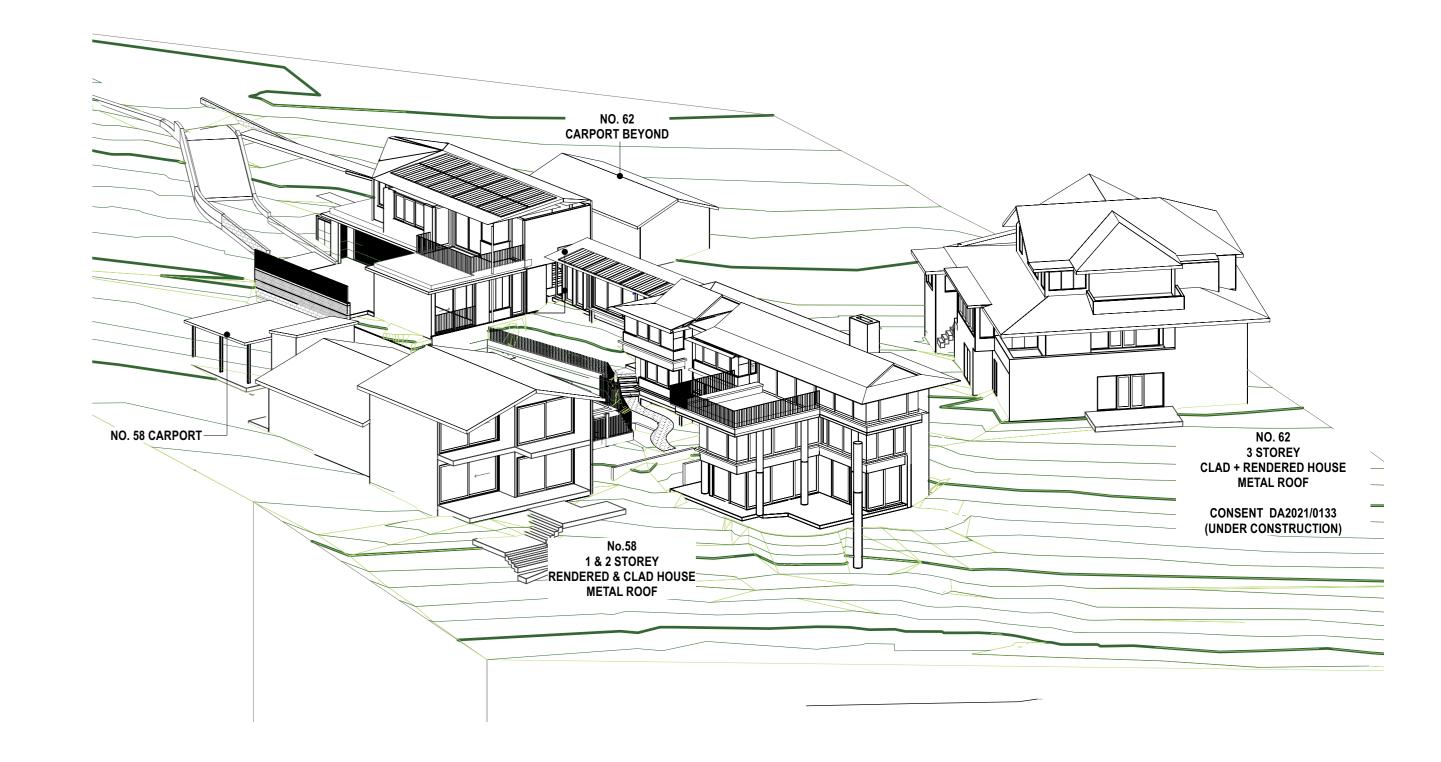
Project: ALTS & ADS TO EXISTING HOUSE	Job Number: 2130
60 HUDSON PDE, CLAREVILLE NSW 2107 Client:	Scale: NTS
OLIVER & NICOLA HARTLEY	Plot Date: 28/8/23

NO. 62 3 STOREY CLAD + RENDERED HOUSE METAL ROOF

SHADOW DIAGRAMS - SUN'S EYE VIEW

Drawing Name:



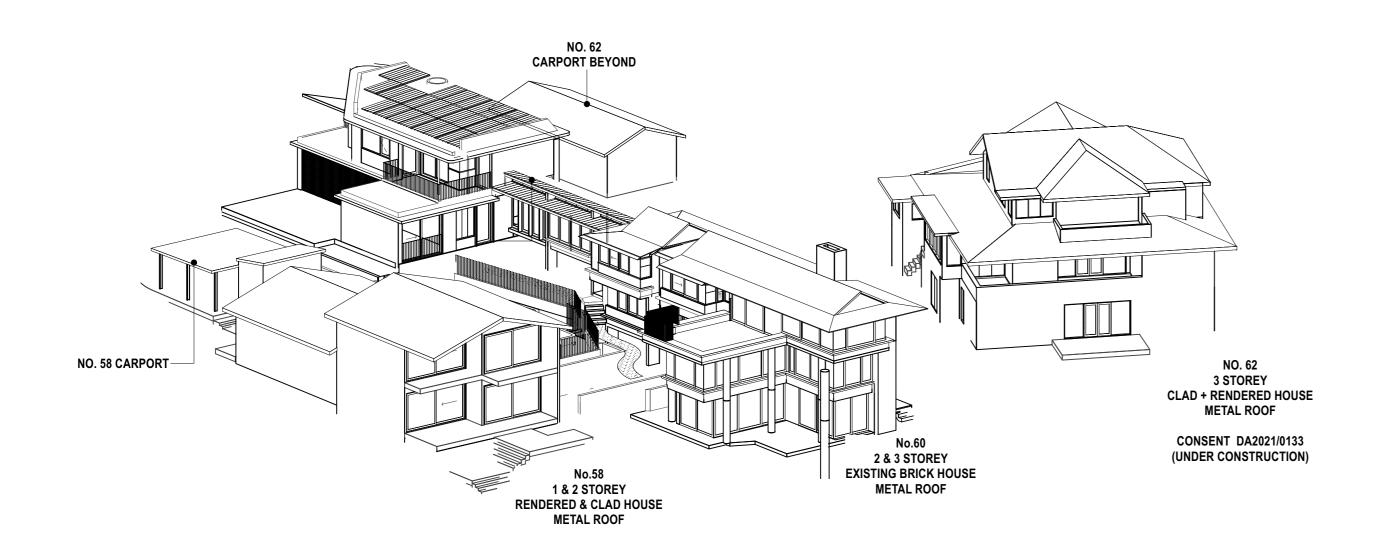

1 3pm - JUNE 21 - EXISTING (APPROVAL DA2022/1715)
Scale: NTS

LEGEND / KEY

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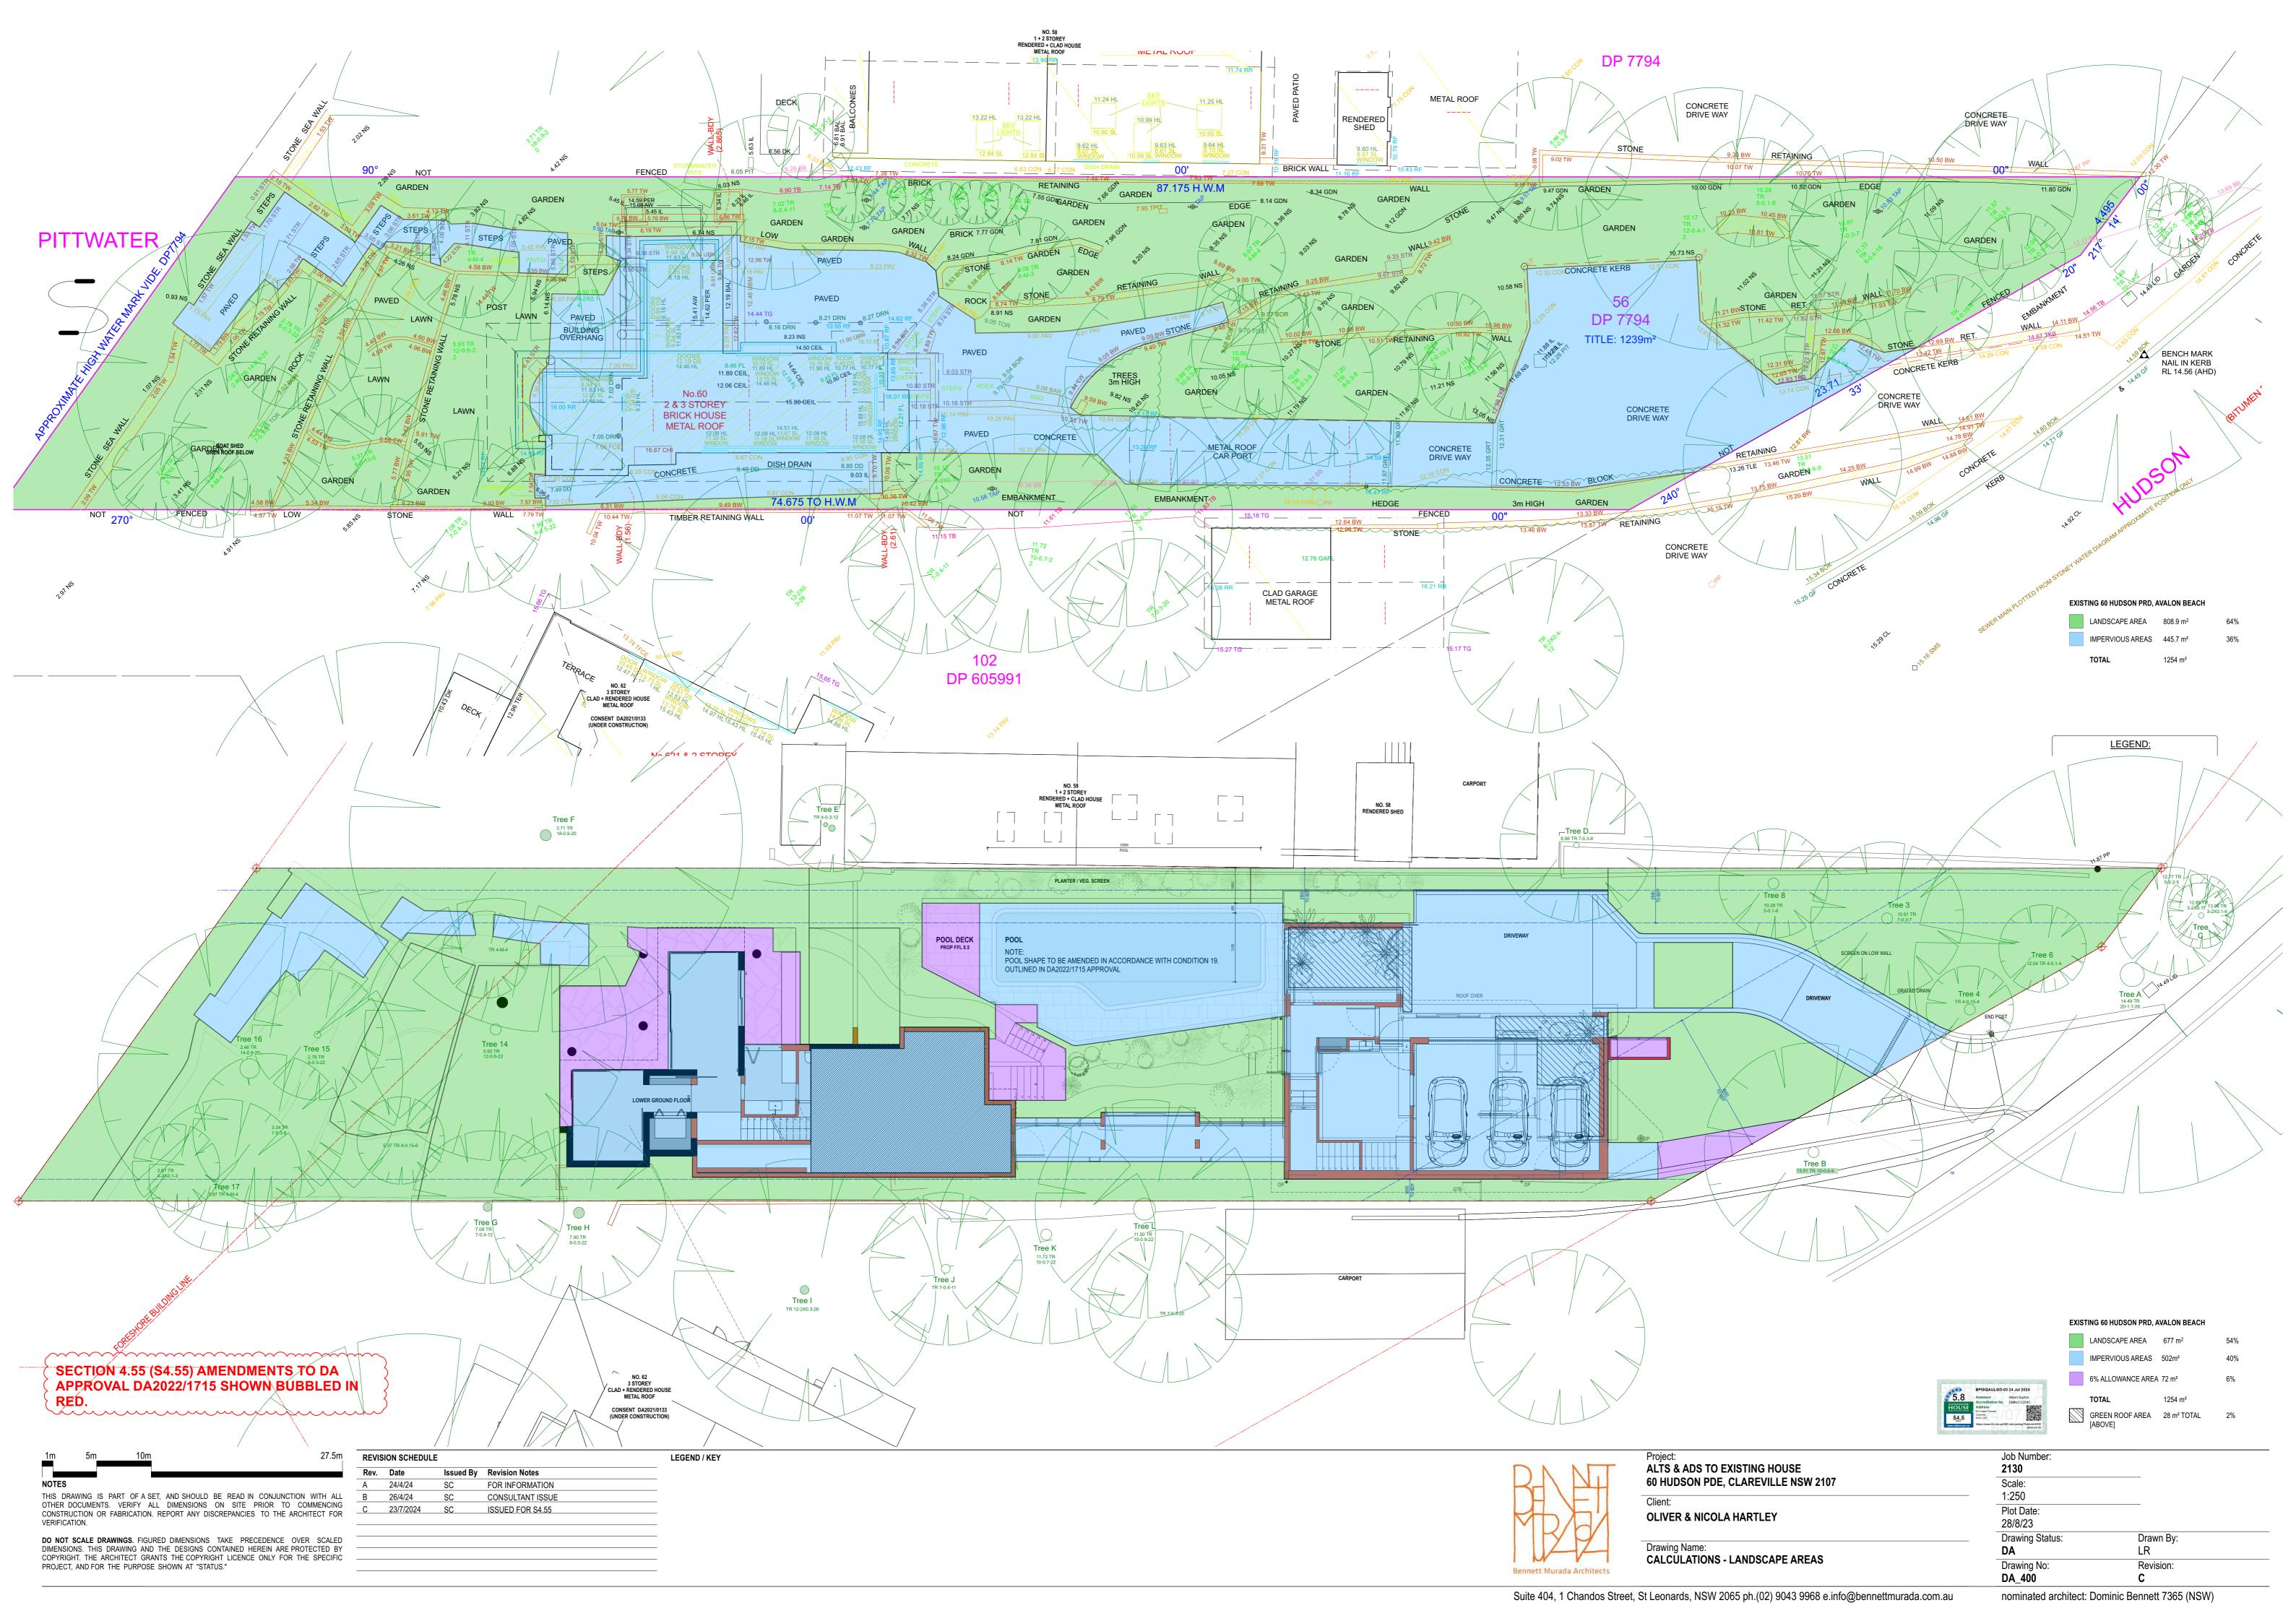
Rev.	Date	Issued By	Revision Notes
Α	26/4/24	SC	CONSULTANT ISSUE
В	23/7/2024	SC	ISSUED FOR S4.55


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Project:	Job Number:
ALTS & ADS TO EXISTING HOUSE	2130
60 HUDSON PDE, CLAREVILLE NSW 2107	Scale:
Client:	NTS
OLIVER & NICOLA HARTLEY	Plot Date:
	28/8/23
	Drawing Status:


SHADOW DIAGRAMS - SUN'S EYE VIEW

Drawing Name:





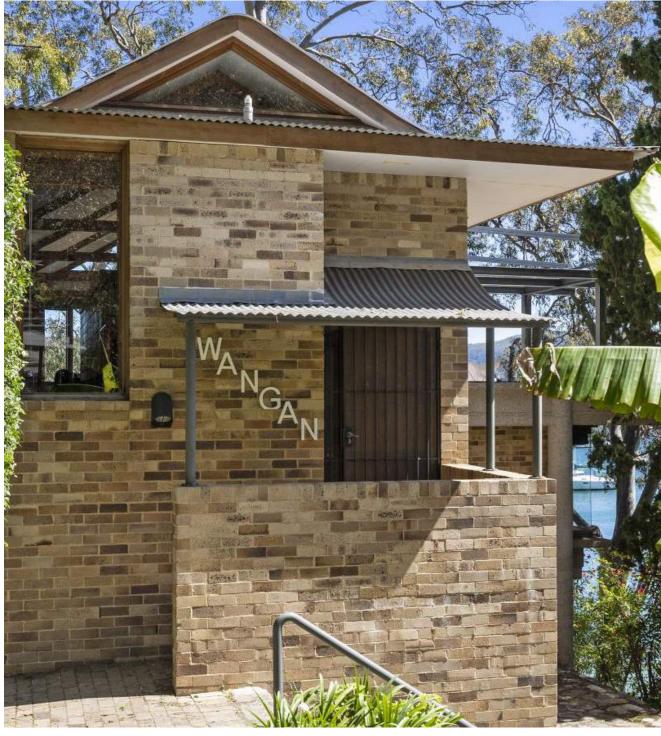

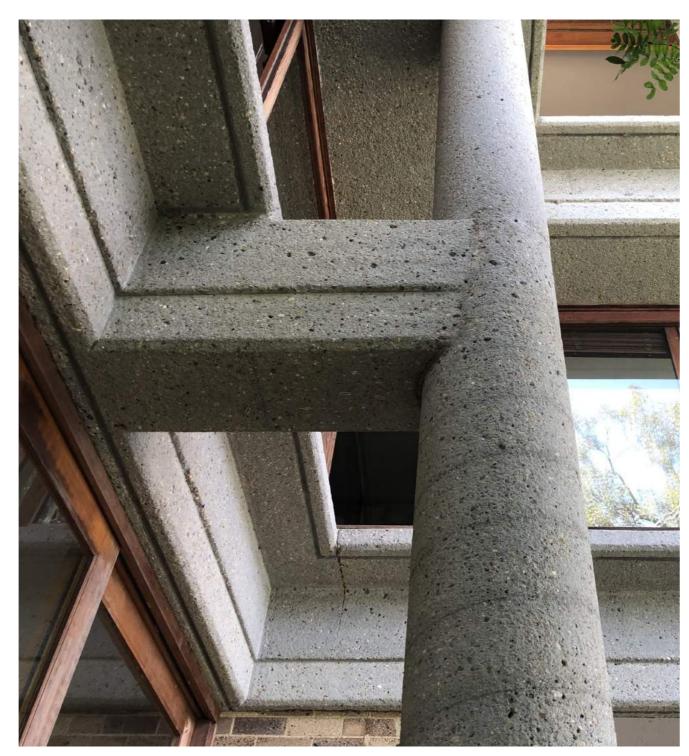


CONC1 _ EXISTING CONCRETE



 $\mathbf{MRS1} \,_\, \mathbf{METAL}\,\, \mathbf{ROOF}\,\, \mathbf{SHEETING}$



CLA1 _ TIMBER CLADDING

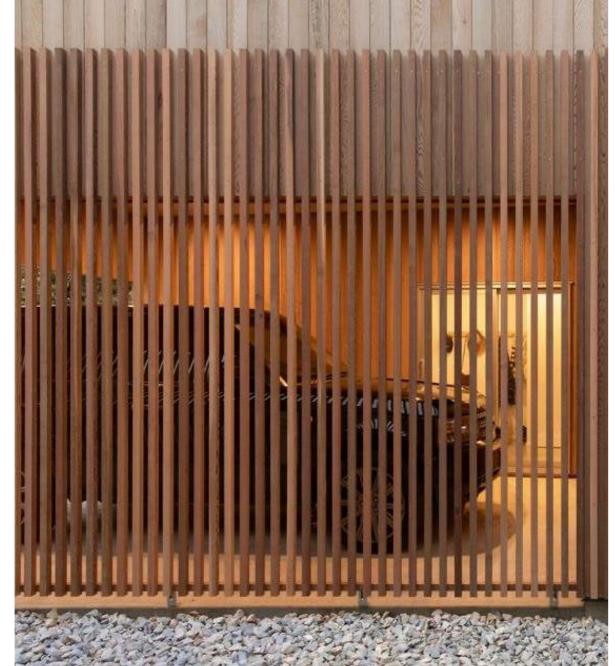


LEGEND / KEY

SCN 1 _ TIMBER SCREENS

REVISION SCHEDULE





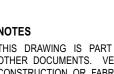

THIS DRAWING IS PART OF A SET, AND SHOULD BE READ IN CONJUNCTION WITH ALL OTHER DOCUMENTS. VERIFY ALL DIMENSIONS ON SITE PRIOR TO COMMENCING CONSTRUCTION OR FABRICATION. REPORT ANY DISCREPANCIES TO THE ARCHITECT FOR VERIFICATION.

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Rev.	Date	Issued By	Revision Notes
Α	26/4/24	SC	CONSULTANT ISSUE
В	23/7/2024	SC	ISSUED FOR S4.55



Project:
ALTS & ADS TO EXISTING HOUSE
60 HUDSON PDE, CLAREVILLE NSW 2107

OLIVER & NICOLA HARTLEY

Drawing Name: SCHEDULES OF COLOURS AND MATERIALS

		2101 001101
	Job Number: 2130	
_	Scale: NTS	_
-	Plot Date: 28/8/23	_
_	Drawing Status: DA	Drawn By: LR
	Drawing No: DA_500	Revision: B

CONC2 _ NEW OFF-FORM CONCRETE

Suite 404, 1 Chandos Street, St Leonards, NSW 2065 ph.(02) 9043 9968 e.info@bennettmurada.com.au

GL2 _ TRANSLUCENT / PRIVACY GLASS